



ROOF DECK FLOOR FRAMING PLAN

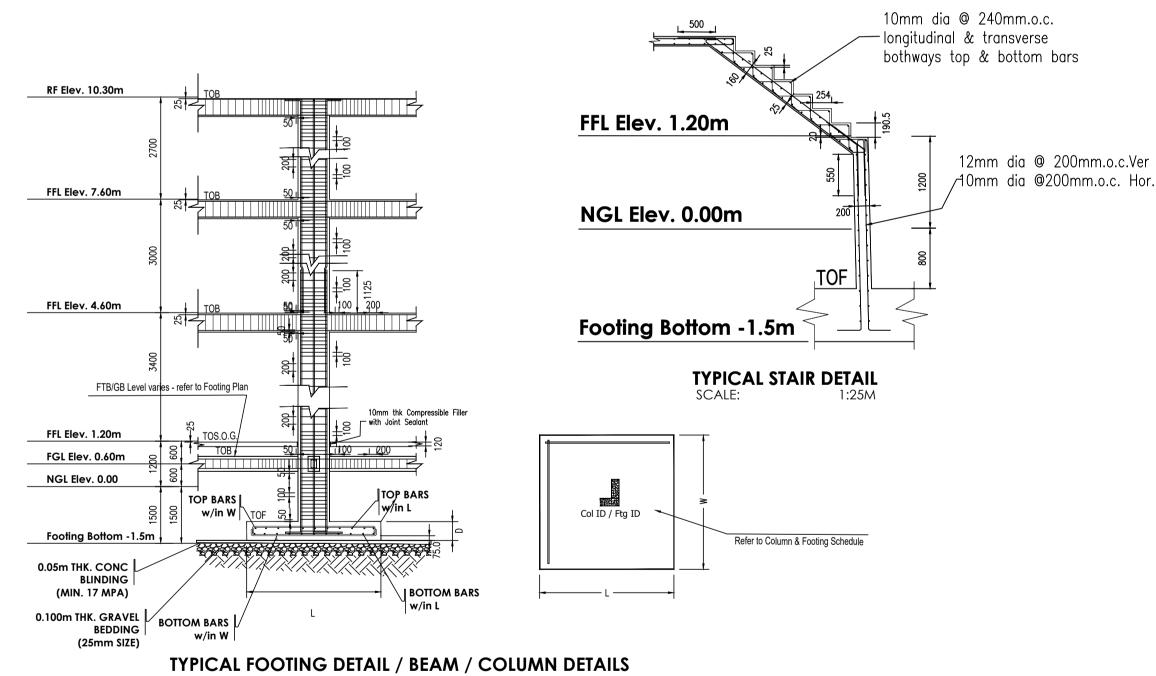

	SCHEDULE OF GII	REMARKS			
	G-1 GIRDER	3-16mmØ Top 2-12mmØ Side 3-16mmØ Bot. 10mmØ STIRRUP	8200m: 10 mm Ø STIRRUP 1@50, 20@100, REST @ 200 GB CLEAR LENGTH=5000 to <7000m: 10 mm Ø STIRRUP 1@50, 15@100, REST @ 200	GB CLEAR LENGTH=3000 to <5000mm: 10 mm Ø STIRRUP 1@50, 10@100, REST @ 200 GB CLEAR LENGTH=2000-<3000mm: 10 mm Ø STIRRUP 1@50, 5@100, REST @ 200	
	G-2 GIRDER	2x2-16mmØ Top 2-12mmØ Side 2x2-16mmØ Bot. 10mmØ STIRRUP	8200m: 10 mm Ø STIRRUP 1@50, 20@100, REST @ 200 GB CLEAR LENGTH=5000 to <7000m: 10 mm Ø STIRRUP 1@50, 15@100, REST @ 200	GB CLEAR LENGTH=3000 to <5000mm: 10 mm Ø STIRRUP 1@50, 10@100, REST @ 200 GB CLEAR LENGTH=2000-<3000mm: 10 mm Ø STIRRUP 1@50, 5@100, REST @ 200	
	B-1 BEAM	2-16mmØ Top 2-16mmØ Bot. 10mmØ STIRRUP	BEAM CLEAR LENGTH=3000 to <5000mm: 10 mm Ø STIRRUP 1@50, 10@100, REST @ 200	LENGTH=2000-<3000mm:	
	SR-1 SHEAR REINFORCEMENT WITHIN SLAB	10mmØ STIRRUP	10 mm Ø STIRRUP @ 200mm.o.c.		SHEAR REINFORCEMENT SUPPORTING HOLLOW BLOCKS INTERNAL WALLS
	COLUMN TIES (plus refer to above)	10mmØ TIES @200	10mmØ TIES @200	10mmØ TIES @200	
er or.	COLUMNS (TOP OF 2F FFL TO TOP OF ROOF DECK FFL)	VERTICAL BARS: 8-16mmØ Solution C-1	VERTICAL BARS: 6-16mm@ SW-1	VERTICAL BARS: 12-16mmØ C-3	

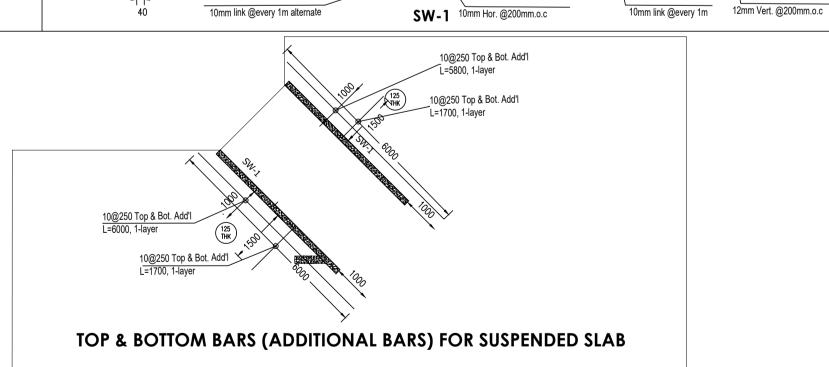

OWNER REPRESENTATIVE:

01 ROOF DECK FRAMING PLAN & DETAILS SCALE: 1:100 m

SHEAR WALL

(TOP OF 2F FFL TO TOP OF

ROOF DECK FFL)

FOR BUILDING PERMIT



ESIGNER & IN-CHARGE OF CONSTRUCTION:			DESIGNER & IN-CHARGE OF CONSTRUCTION:		PROJECT NAME:
HILARIO A. CUEVA Civil Engineer					
RC NO.:	0054094	DATE: 12/22/1987	PRC NO.:	DATE :	
TR NO.:	BCE6439752	DATE: 1/03/2020	PTR NO.:	DATE:	
N:	902-986-429-000	PLACE: PASIG CITY	TIN:	PLACE:	
				_	

CALINGA RESIDENCE HOME RENOVATION

NIA ROAD, BAYANAN, BACOOR CITY, CAVITE

MRS. JUANITA C. CALINGA
OWNER
168 NIA ROAD, BAYANAN, BACOOR CITY, CAVITE

REVISIONS					CON.
REV.No	DATE	DESCRIPTION	PREPARED	CHECKED	ROOI
REV00	10/04/	20BULDING_PERMIT	FP	НС	

4-16mm dia Vert. corner bars

CONTENTS:

ROOF_DECK_FRAMING_PLANS_&_DETAILS

NOTES:

LEGENDS:

1. ALL DIMENSIONS ARE IN MILLIMETERS, LEVELS IN METERS UNLESS NOTED OTHERWISE.
2. CONCRETE STRENGTH - 28 MPA (4000 PSI) AT 28th-DAY STRENGTH.
3. REINFORCEMENT BARS - 275 MPA (GR. 40) - 12mm diameter or less 413 MPA (GR. 60) - 16mm diameter or more

CONCRETECHB

ELEV. 0.80 - LEVEL ASSIGNMENT

REFERENCES:

- FOOTING THICKNESS

GRID ASSIGNMENT

1. ST-101 - GENERAL NOTES & SPECIFICATIONS
2. ST-102 - FOUNDATION PLAN, SCHEDULE & DET.
3. ST-103 - 2ND ROOF FLOOR FRAMING/DETAILS
4. ST-104 - ROOF DECK FRAMING & DETAILS
5. ST-105 - UPPER ROOF FRAMING & DETAILS

TOP OF FOOTINGTOP OF TIE OR GROUND BEAM

- TOP OF CONCRETE SLAB

ST-104

SHEET NO.