



First Floor Plan

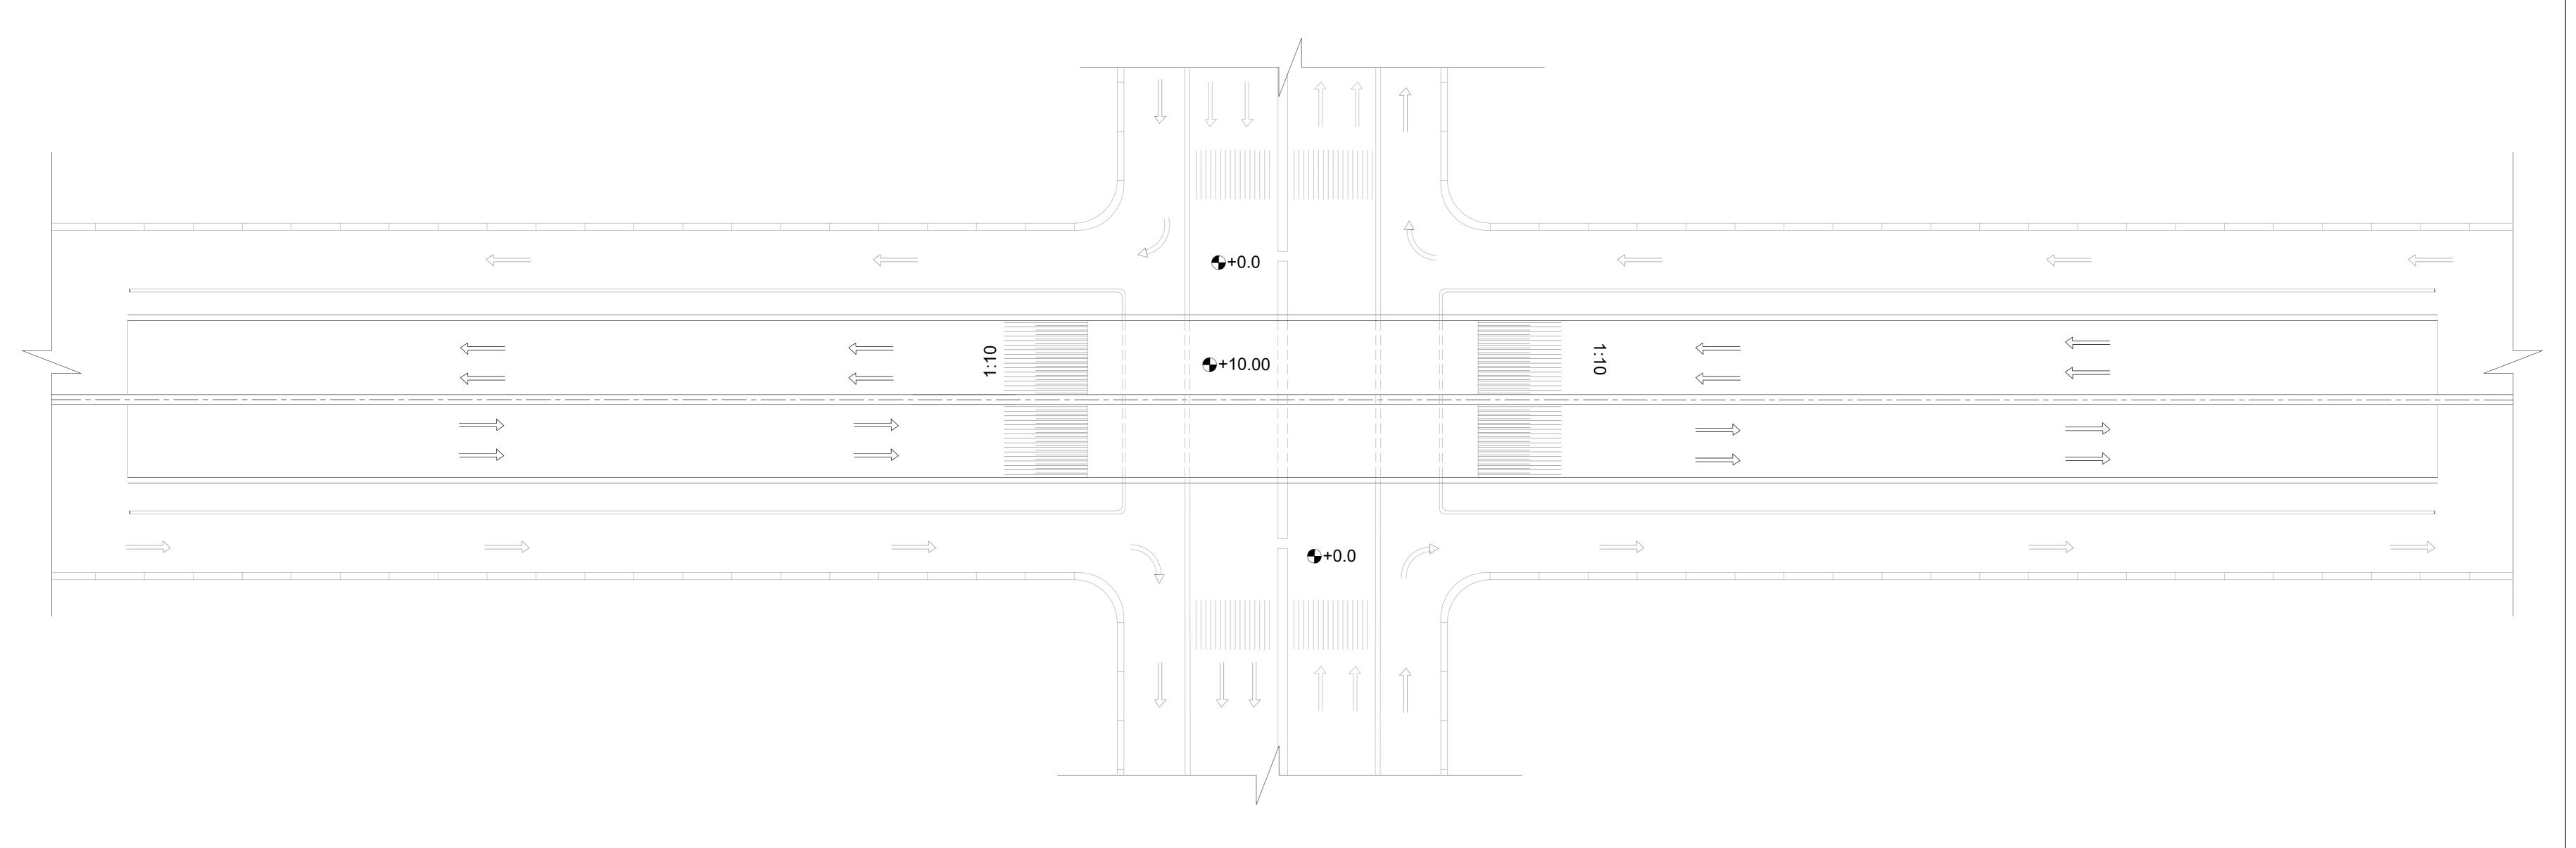

Site Plan

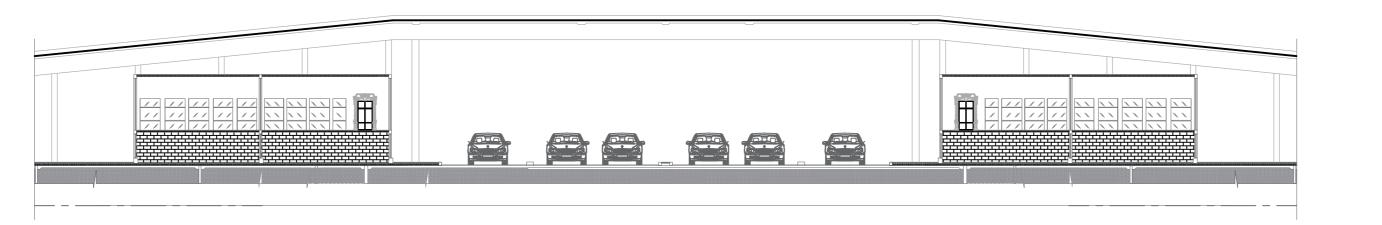

Side View A-A

GENERAL NOTES

1) ALL DIM. AND AXES MUST BE CHECKED WITH ARCH DRAWINGS.

2) ALL DIMENSIONS ARE IN meter UNLESS INDICATED OTHERWISE.

3) STEEL USED ARE STRUCTURAL STEEL 52 with Fu = 5.2 t/cm2 and Fy = 3.6 t/cm2.

4) ALL DWGs. MUST BE REVISED BY THE EQUIPMENT SUPPLIER

5) STRUCTURAL DESIGN FOR STEEL BUILDINGS IS IN ACCORDANCE WITH

THE WORKING STRESS METHOD AS PER EGYPTIAN CODE OF PRACTICE FOR

STEEL CONSTRUCTIONS AND BRIDGES.

6) ALL STEEL ELEMENTS MUST BE BLASTED WITH SAND BEFORE PAINTING

7) ALL STEEL ELEMENTS MUST BE PAINTED WITH TWO COATS OF PRIMER FOLLOWED BY TWO COATS OF FINAL PAINT WITH REQUIRED COLOR

8) IN CASE OF ANY PROBLEMS KINDLY REFER TO THE DESIGNER



PHAROS UNIVERSITY

FACULTY OF ENGINEERING

CONSTRUCTION ENG. & MANAGEMENT Department

STEEL PROJECT (2022-2023) ROADWAY STEEL BRIDGE

PREPARED BY/

AHMED YASSER
MAHMOUD GAMAL
MOHAMED ABDALLAH

DRAWING TITLE

Architecture Layout

DRAWING NO. 2 SCALE 1:270

Supervised BY/

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