

# Golden Gate Bridge, Highway and Transportation District


# LARKSPUR FERRY TERMINAL MATERIALS STORAGE FACILITIES

Contract No. 2002 - FT-6

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- SITE PLAN
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#### **DETAIL / SECTION DESIGNATION**



- LETTER INDICATES SECTION, ELEVATION, OR PLAN
- -INDICATES SHEET NUMBER WHERE SECTION, ELEVATION, OR PLAN IS SHOWN
- -INDICATES SHEET NUMBER WHERE SECTION, ELEVATION, OR PLAN IS REFERENCED

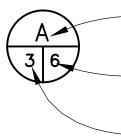NUMBER INDICATES DETAIL -INDICATES SHEET NUMBER

WHERE DETAIL IS SHOWN INDICATES SHEET NUMBER WHERE DETAIL IS REFERENCED

#### **ABBREVIATIONS**

AC ASPHALT C BLDG BUILDING CLR CLEAR C CONDUIT CO CONDUIT O CONC CONCRETE CONT CONTINUOU Ø DIAMETER DET DETAIL DI DROP INLE DIP DUCTILE IRO DWG DRAWING (E) EXISTING EL ELEVATION ELEC ELECTRICAL EW EACH WAY FH FIRE HYDRA FL GALV GALVANIZED GRND GROUND G GROUNDING GFI GROUND FA	NLY S TON PIPE	MH (N) OC OGL PMB PVMT R WD RCP REQD SHT SS SIM STD SQ TOT TYP UON	MANHOLE NEW ON CENTER ORIGINAL GROUND PLATE PREFABRICATED METAL BUILDI PAVEMENT RADIUS REDWOOD REINFORCED CONCRETE PIPE REQUIRED SHEET SANITARY SEWER SCHEDULE SIMILAR STANDARD SQUARE TOP OF CONCRETE TOTAL TYPICAL UNLESS OTHERWISE NOTED
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#### **PROJECT NOTES**

HEIGHT

INVERT ELEVATION


LIGHT WEIGHT AGGREGATE


LINEAR FEET

MAXIMUM MINIMUM


1. ALL CONTRACT WORK IS CONTAINED WITHIN THE EXISTING GOLDEN GATE BRIDGE, HIGHWAY AND TRANSPORTATION DISTRICT'S PROPERTY.

THE CONTRACTOR SHALL POSSESS THE CLASS (OR 2. CLASSES) OF LICENSE AS SPECIFIED IN THE SPECIAL PROVISIONS.

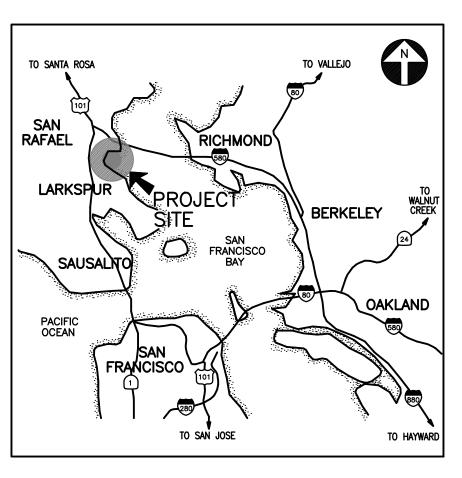

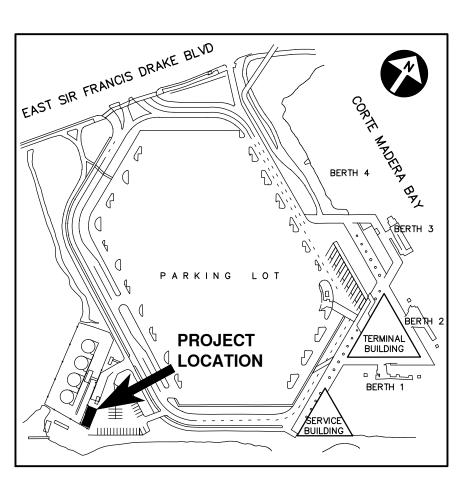



LOCATION PLAN NO SCALE

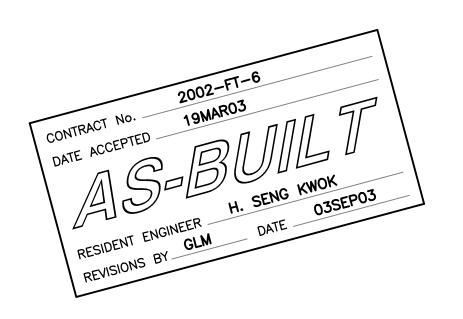


	APPROVED BY	Á				APPROVED BY		OLDE	N GATE	BRIDO	GE, HIGHWAY
	PROFESSIONAL O BY D. FAY	$\bigwedge$				PROFESSIONA S N. MUVA					ON DISTRICT
	10 S					Maria Maria	L	ARKSI	PUR FE	RRY TE	ERMINAL
	No. 27069 Exp.3/31/05	$\square$				No. 39793 Exp.12/31/05	4				FACILITIES
	CIVIL	M				CIVIL					
	OF CALIFO					OF CALIFO			TITLE	SHEE	ĒΤ
GRAPHIC SCALE SHOWN IN FULL SIZE VERIFY SCALE FOR REDUCED PLANS	PROJECT ENGINEER	NO.	REVISIONS	BY	DATE	DISTRICT ENGINEER					
	06-18-02	CON	TRACT NO. 2002-FT-6	S	HEET	06-18-02	DESIGNED (	BY S.K.	CHECKED	BY J.K.	DRAWN BY G.M.
CM 1 2 3 4 5 6 7	DATE	CAD	D FILE 02F06C001AB.DWG	· '	<b>T</b> 1	DATE	SCALE	AS NOT	ED	DATE	14JUN02



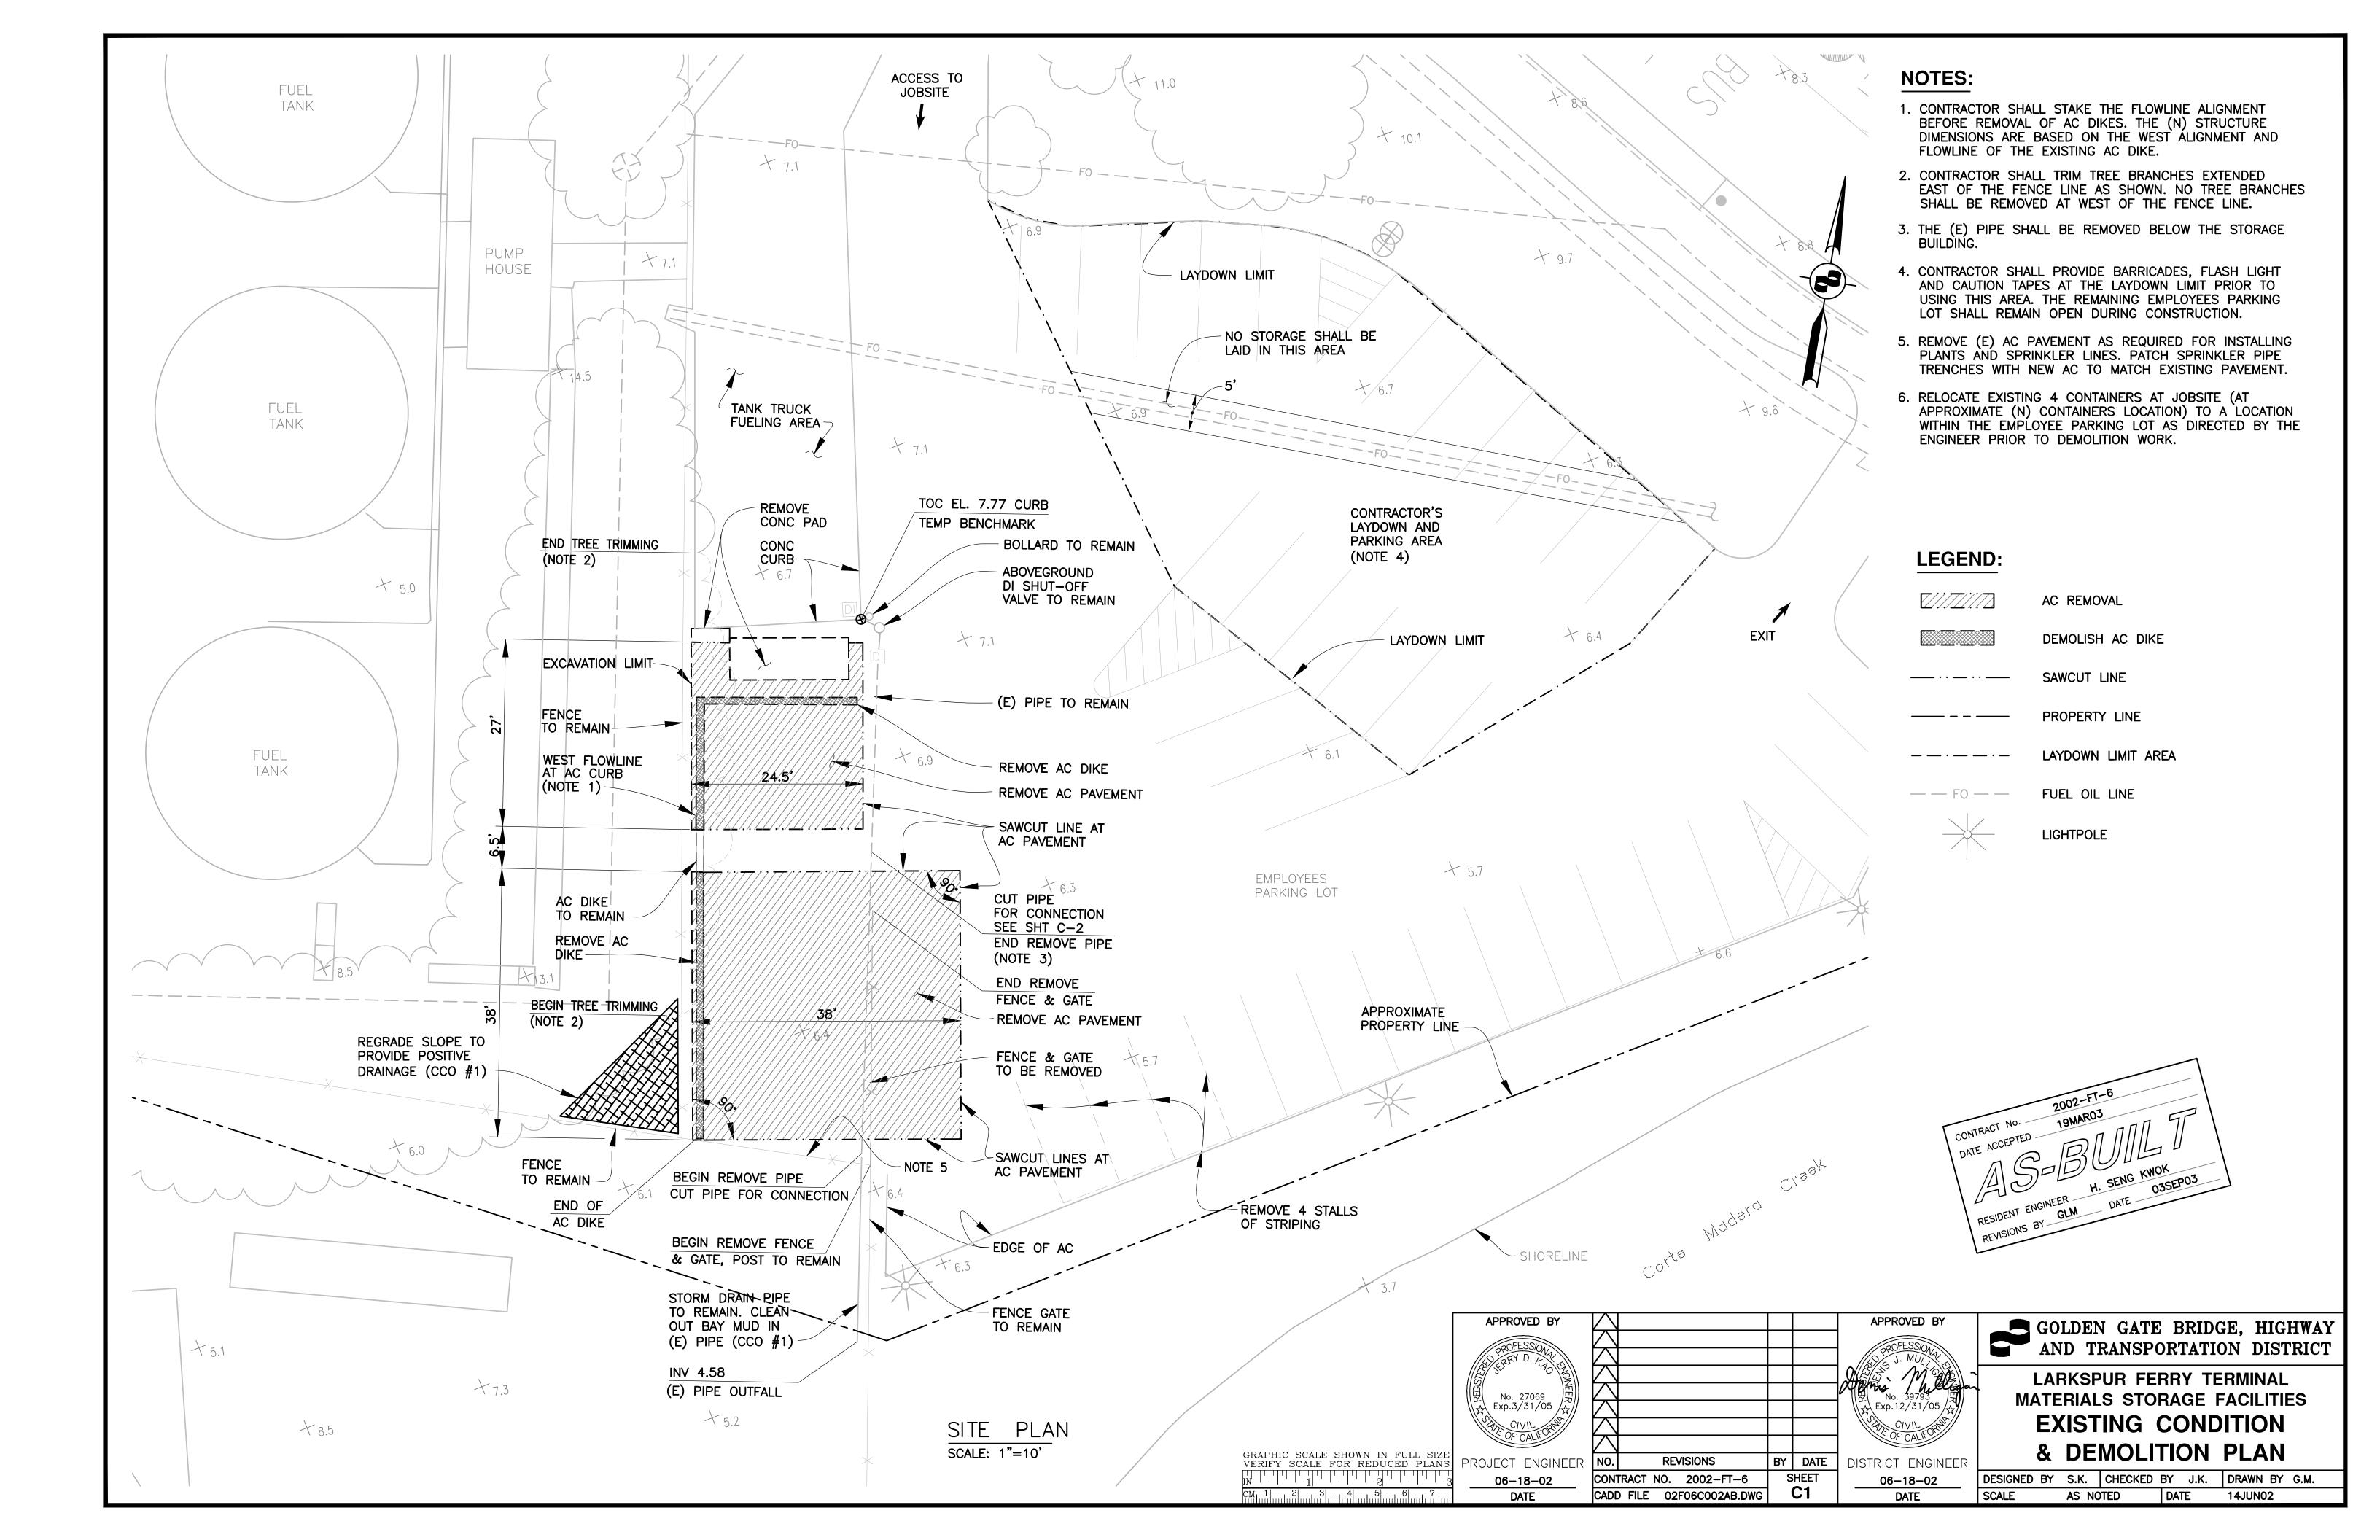


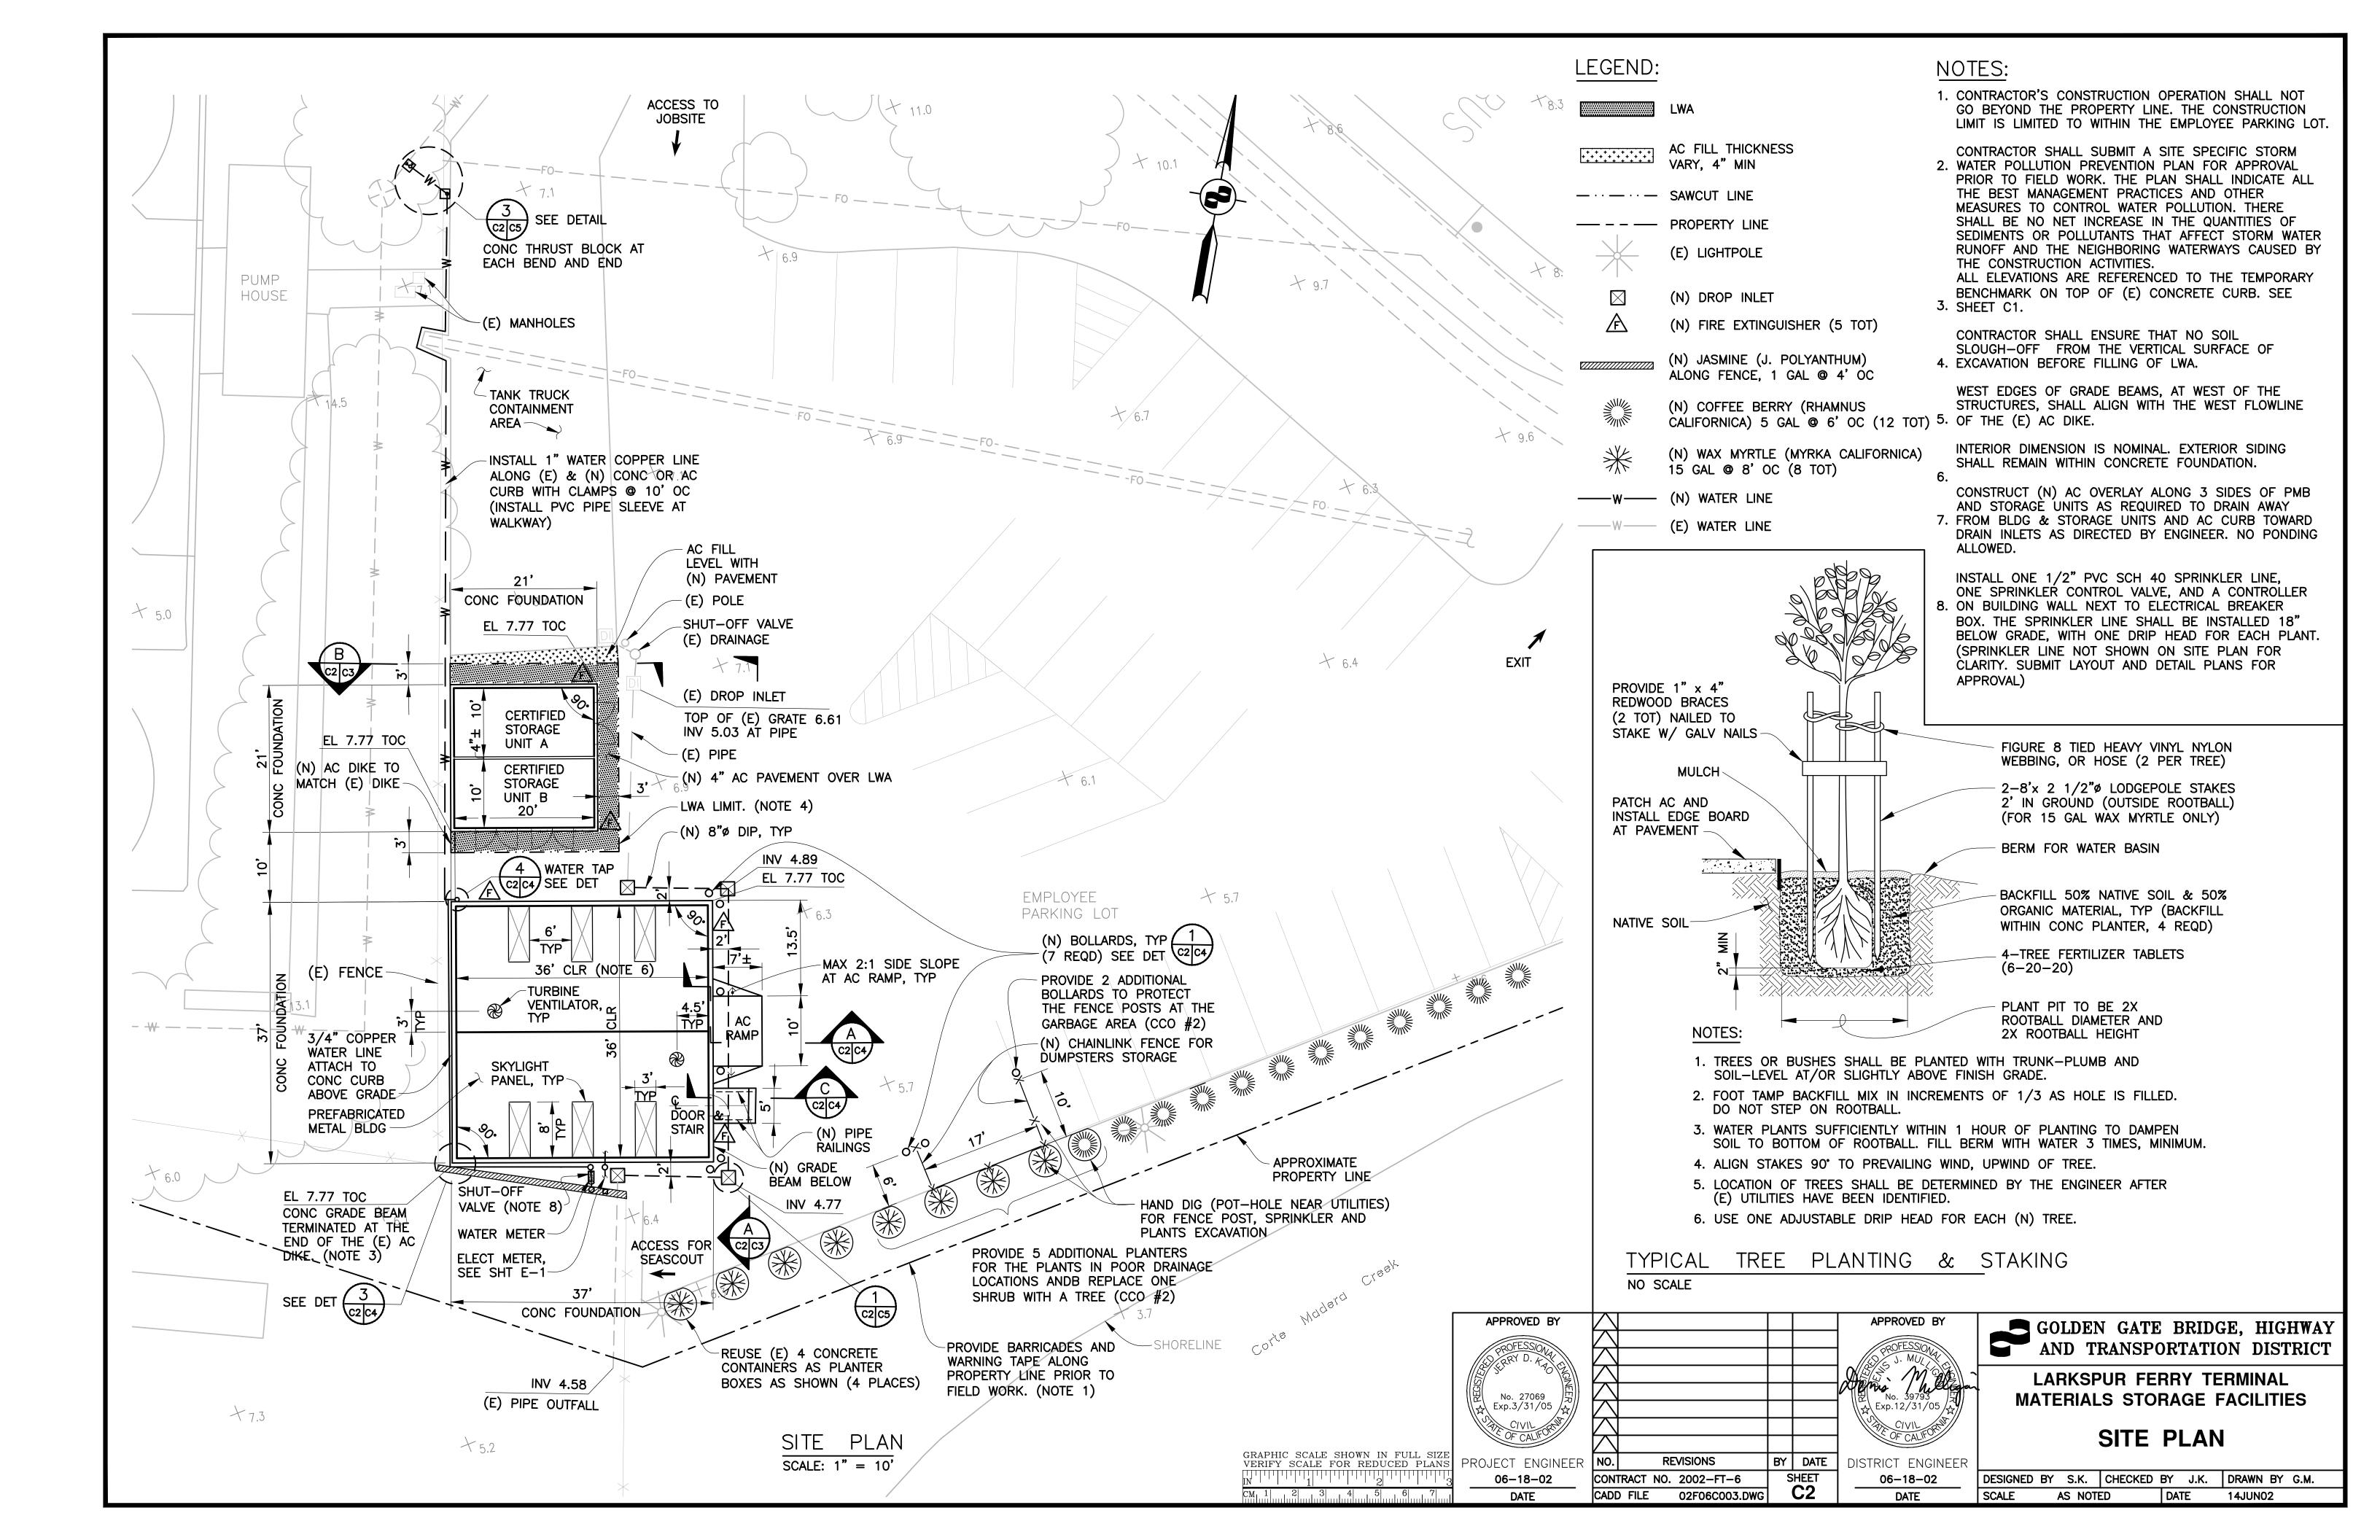

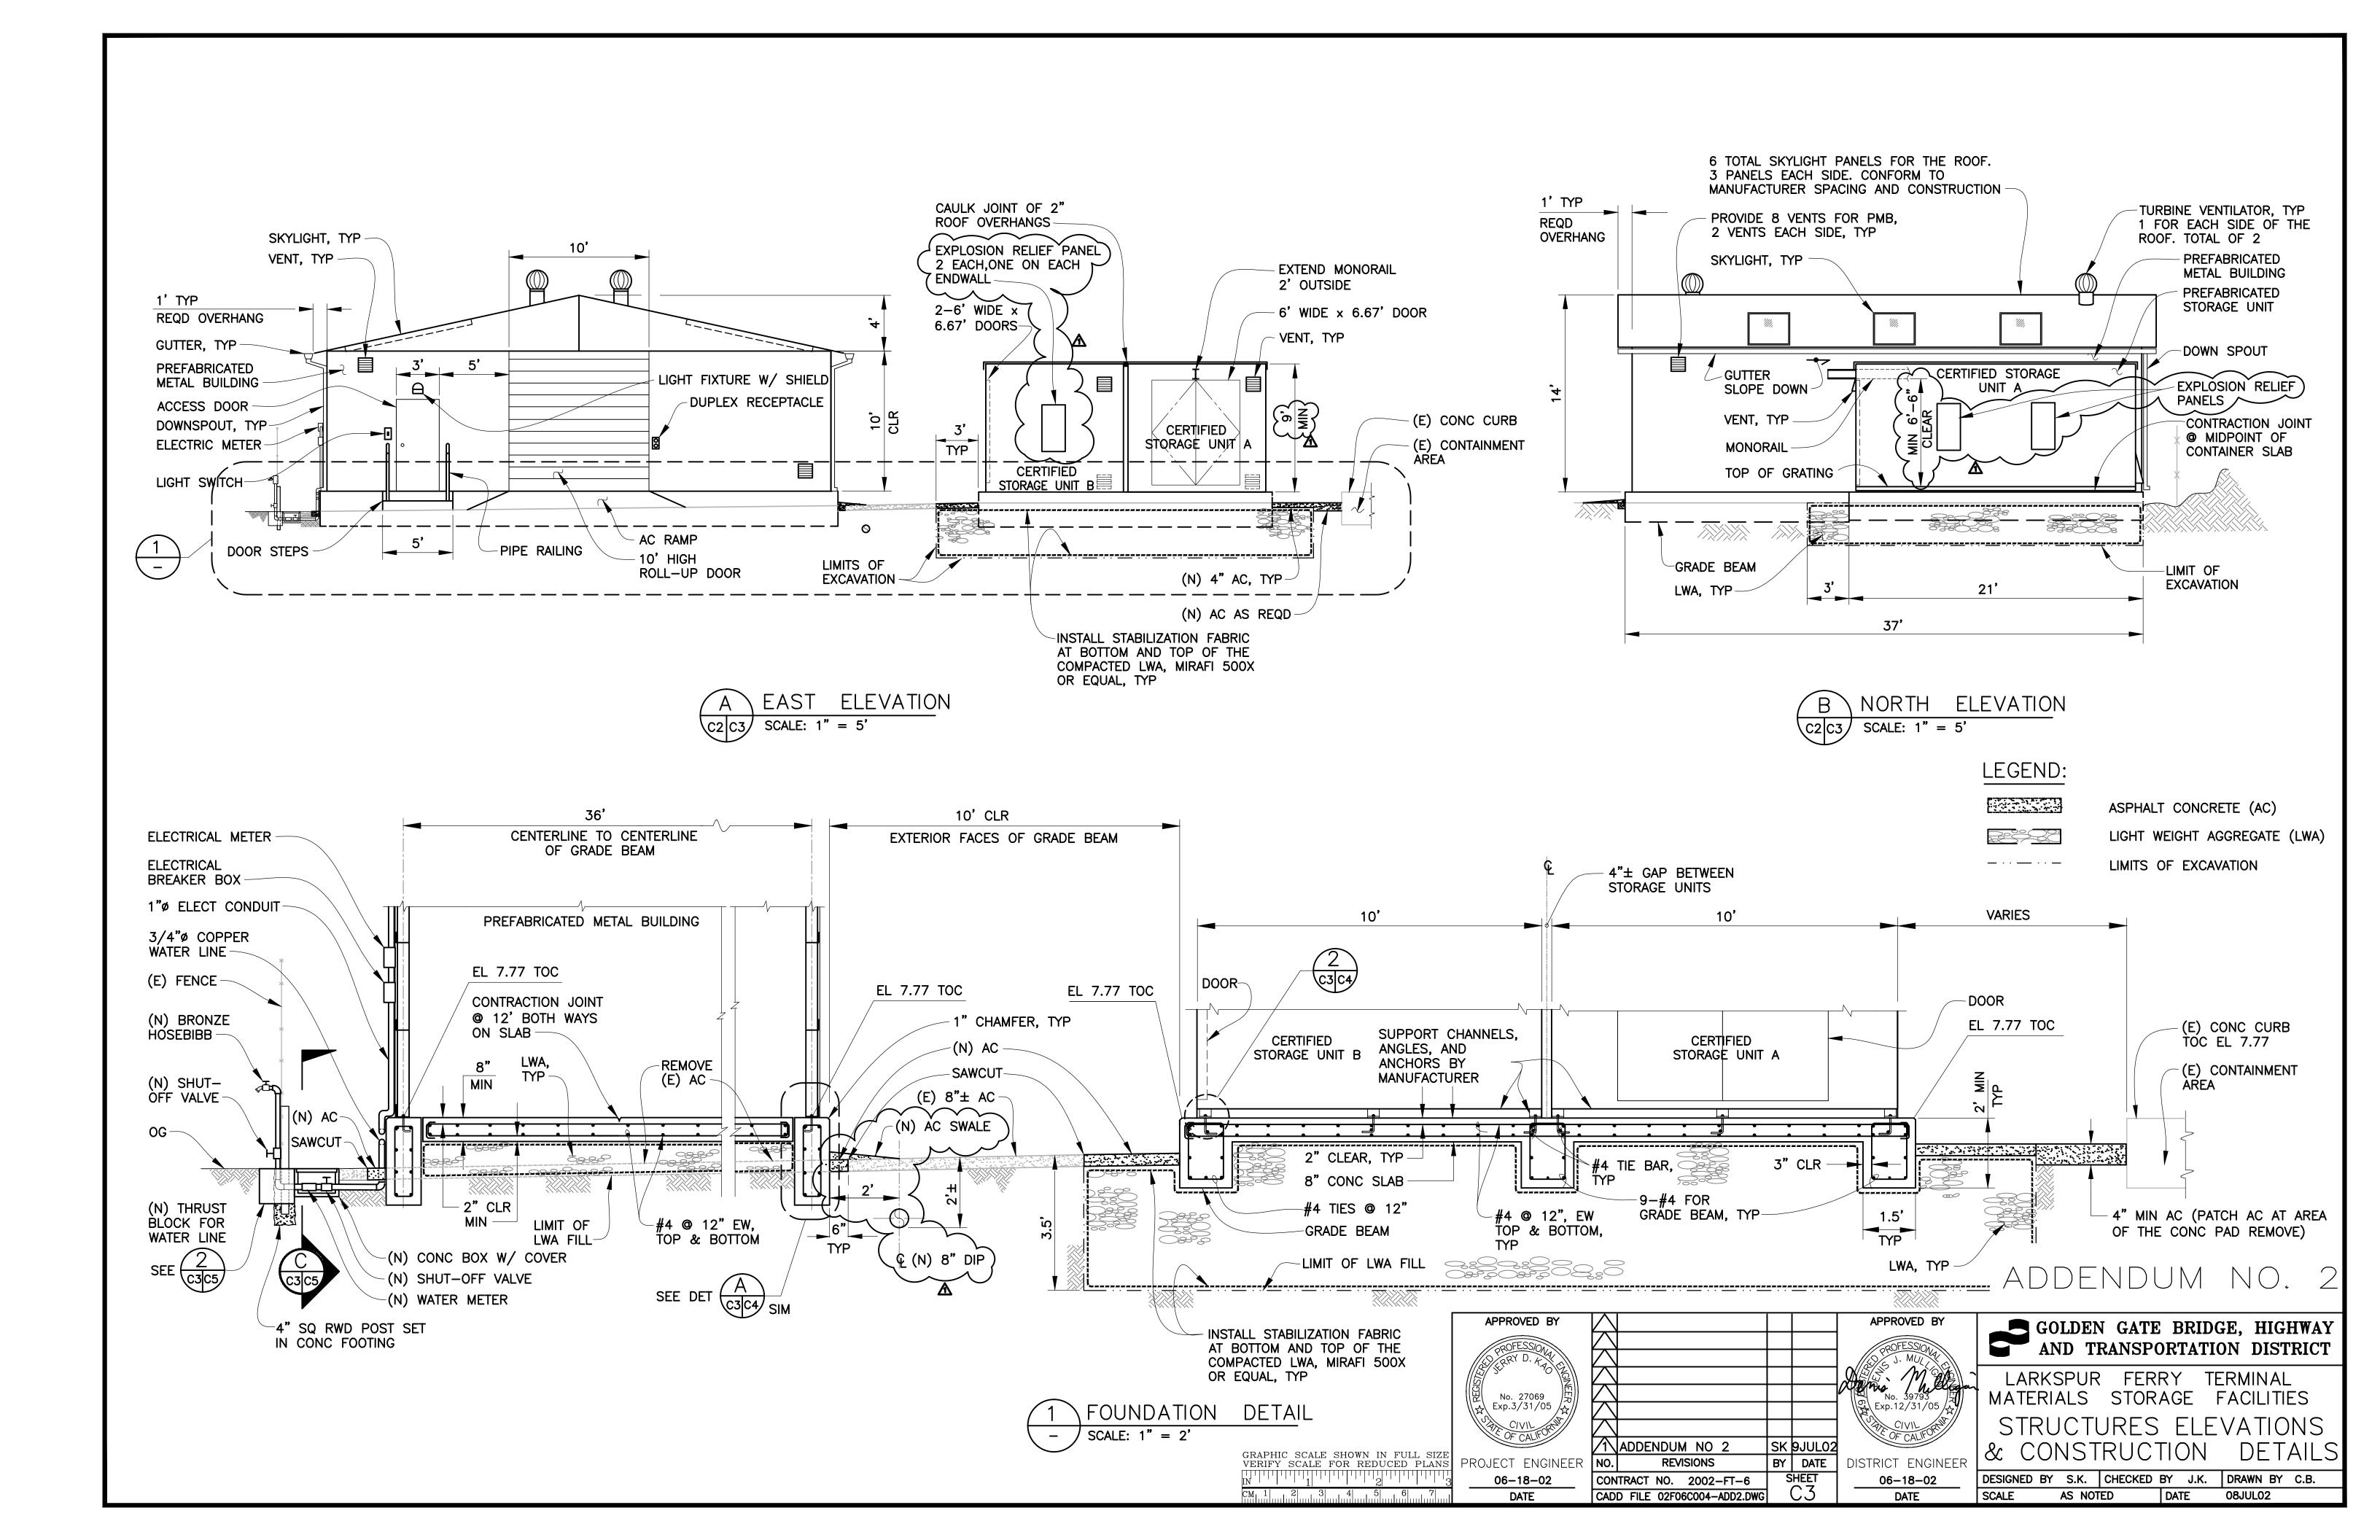




- 1. STRUCTURAL PANEL, GIRT, CHANNEL, ANGLE, BRACING, ANCHOR BOLTS, ETC FOR PMB AND STORAGE UNITS AS SHOWN ARE SCHEMATIC ONLY. CONTRACTOR SHALL SUBMIT DESIGN CALCULATIONS, PLANS AND DETAILS FOR APPROVAL. ADJUST DIMENSIONS AS NEEDED TO SUIT CONC FOUNDATION.
- 2. FINISH PAINT COLOR FOR HANDRAILS SHALL BE SAME AS BUILDING EXTERIOR.

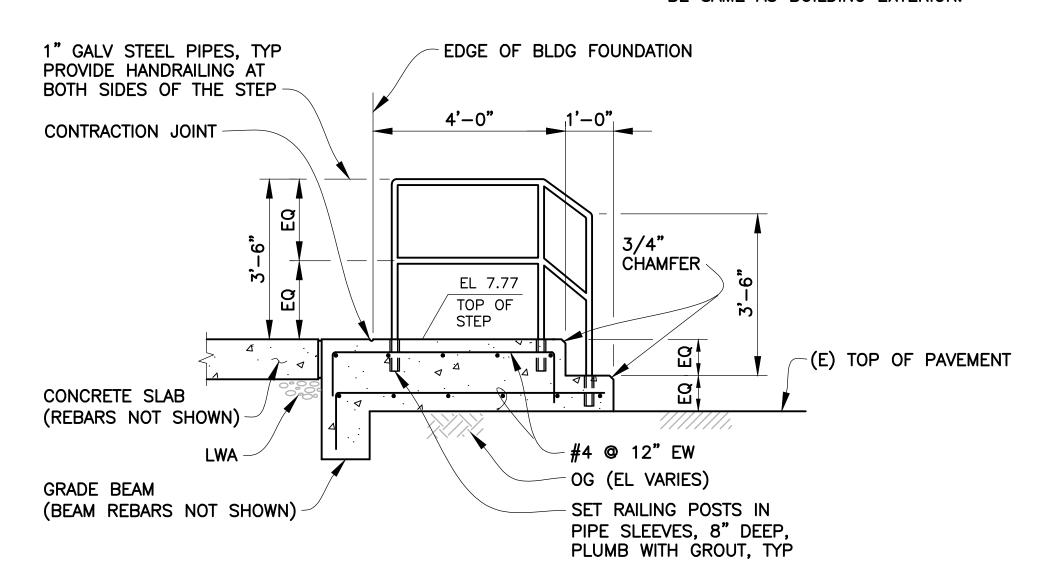



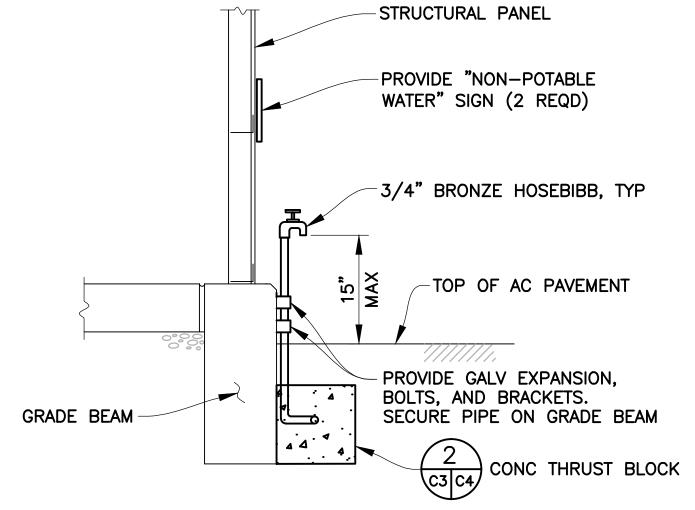



BY DATE

APPROVED BY 💻 GOLDEN GATE BRIDGE, HIGHWAY

DISTRICT ENGINEER

06-18-02


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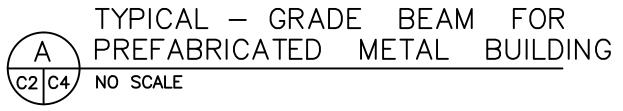
AND TRANSPORTATION DISTRICT LARKSPUR FERRY TERMINAL MATERIALS STORAGE FACILITIES


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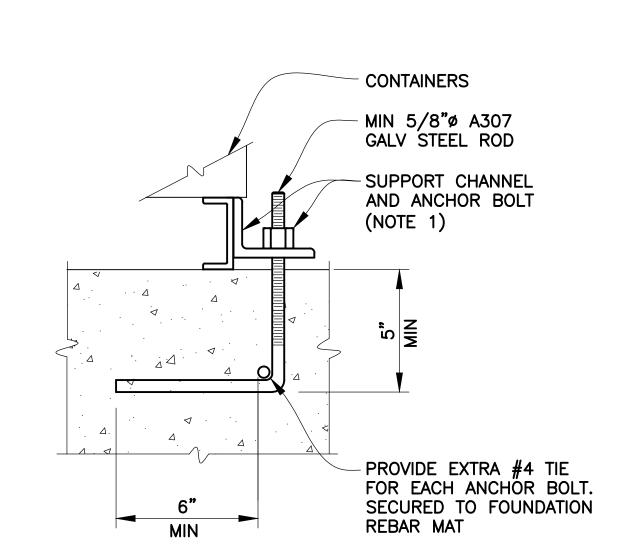
CONSTRUCTION DETAILS

DESIGNED BY S.K. CHECKED BY J.K. DRAWN BY G.M. AS NOTED DATE 14JUN02 SCALE





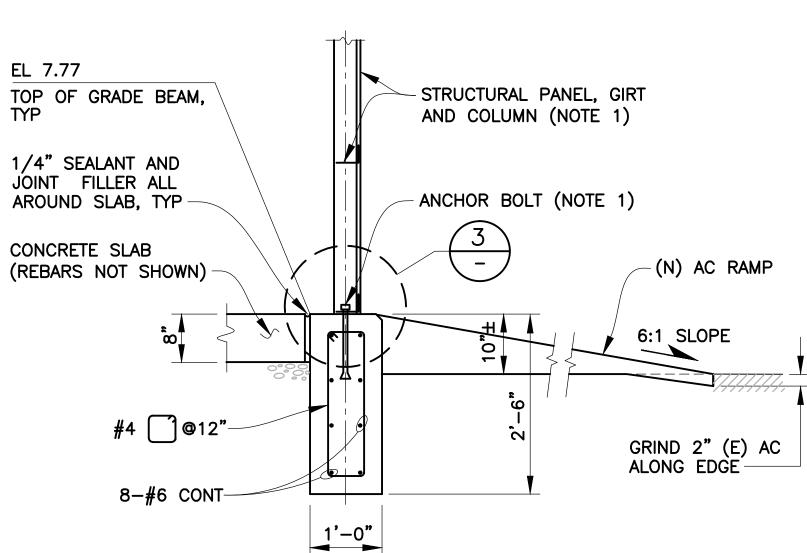

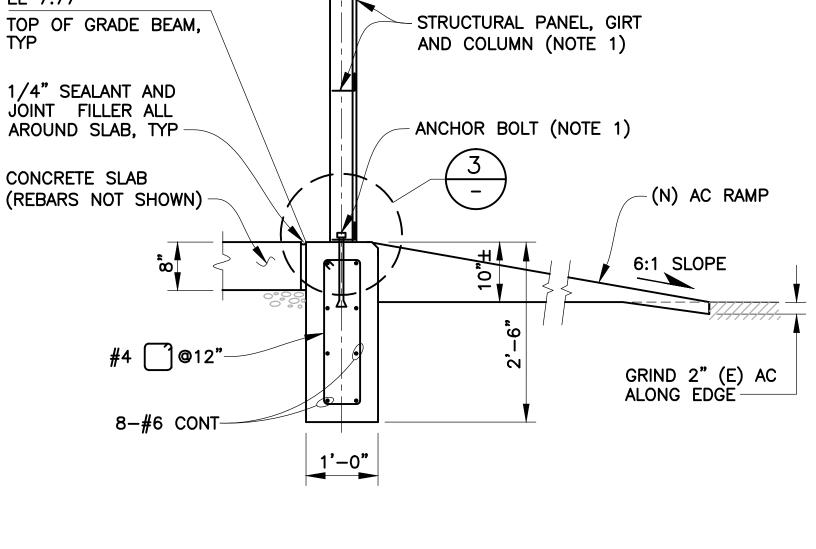

DETAIL

1'-3"ø

POURED IN PLACE CONC

BOLLARD

C2 C4 NO SCALE

4" WIDE RED

REFLECTORIZED TAPE -

BOLLARD, 1/2"ø GALV

MIN 2" RADIUS —

FILL 4"Ø PIPE WITH CONCRETE

BOLLARD HANDLE, 2 PER

STEEL ROD WITH 1/4" WELD

ALL AROUND CONNECTION,

4"ø GALV STD STEEL PIPE

WITH BOTTOM PL WITH TOP

FINISHED IN CONC DOME SHIM


& APPLY SEALANT BETWEEN PIPES -

BOLLARD SLEEVE WITH BOTTOM

PL (5"ø GALV STD STEEL PIPE)

AS REQD TO PLUMB BOLLARD



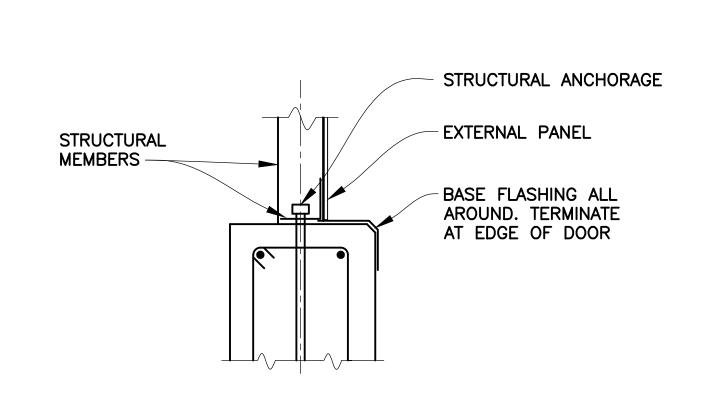



GRAPHIC SCALE SHOWN IN FULL SIZE

VERIFY SCALE FOR REDUCED PLANS

APPROVED BY

PROJECT ENGINEER **NO.** 


06-18-02


DATE


**REVISIONS** 


CONTRACT NO. 2002-FT-6

CADD FILE 02F06C005.DWG

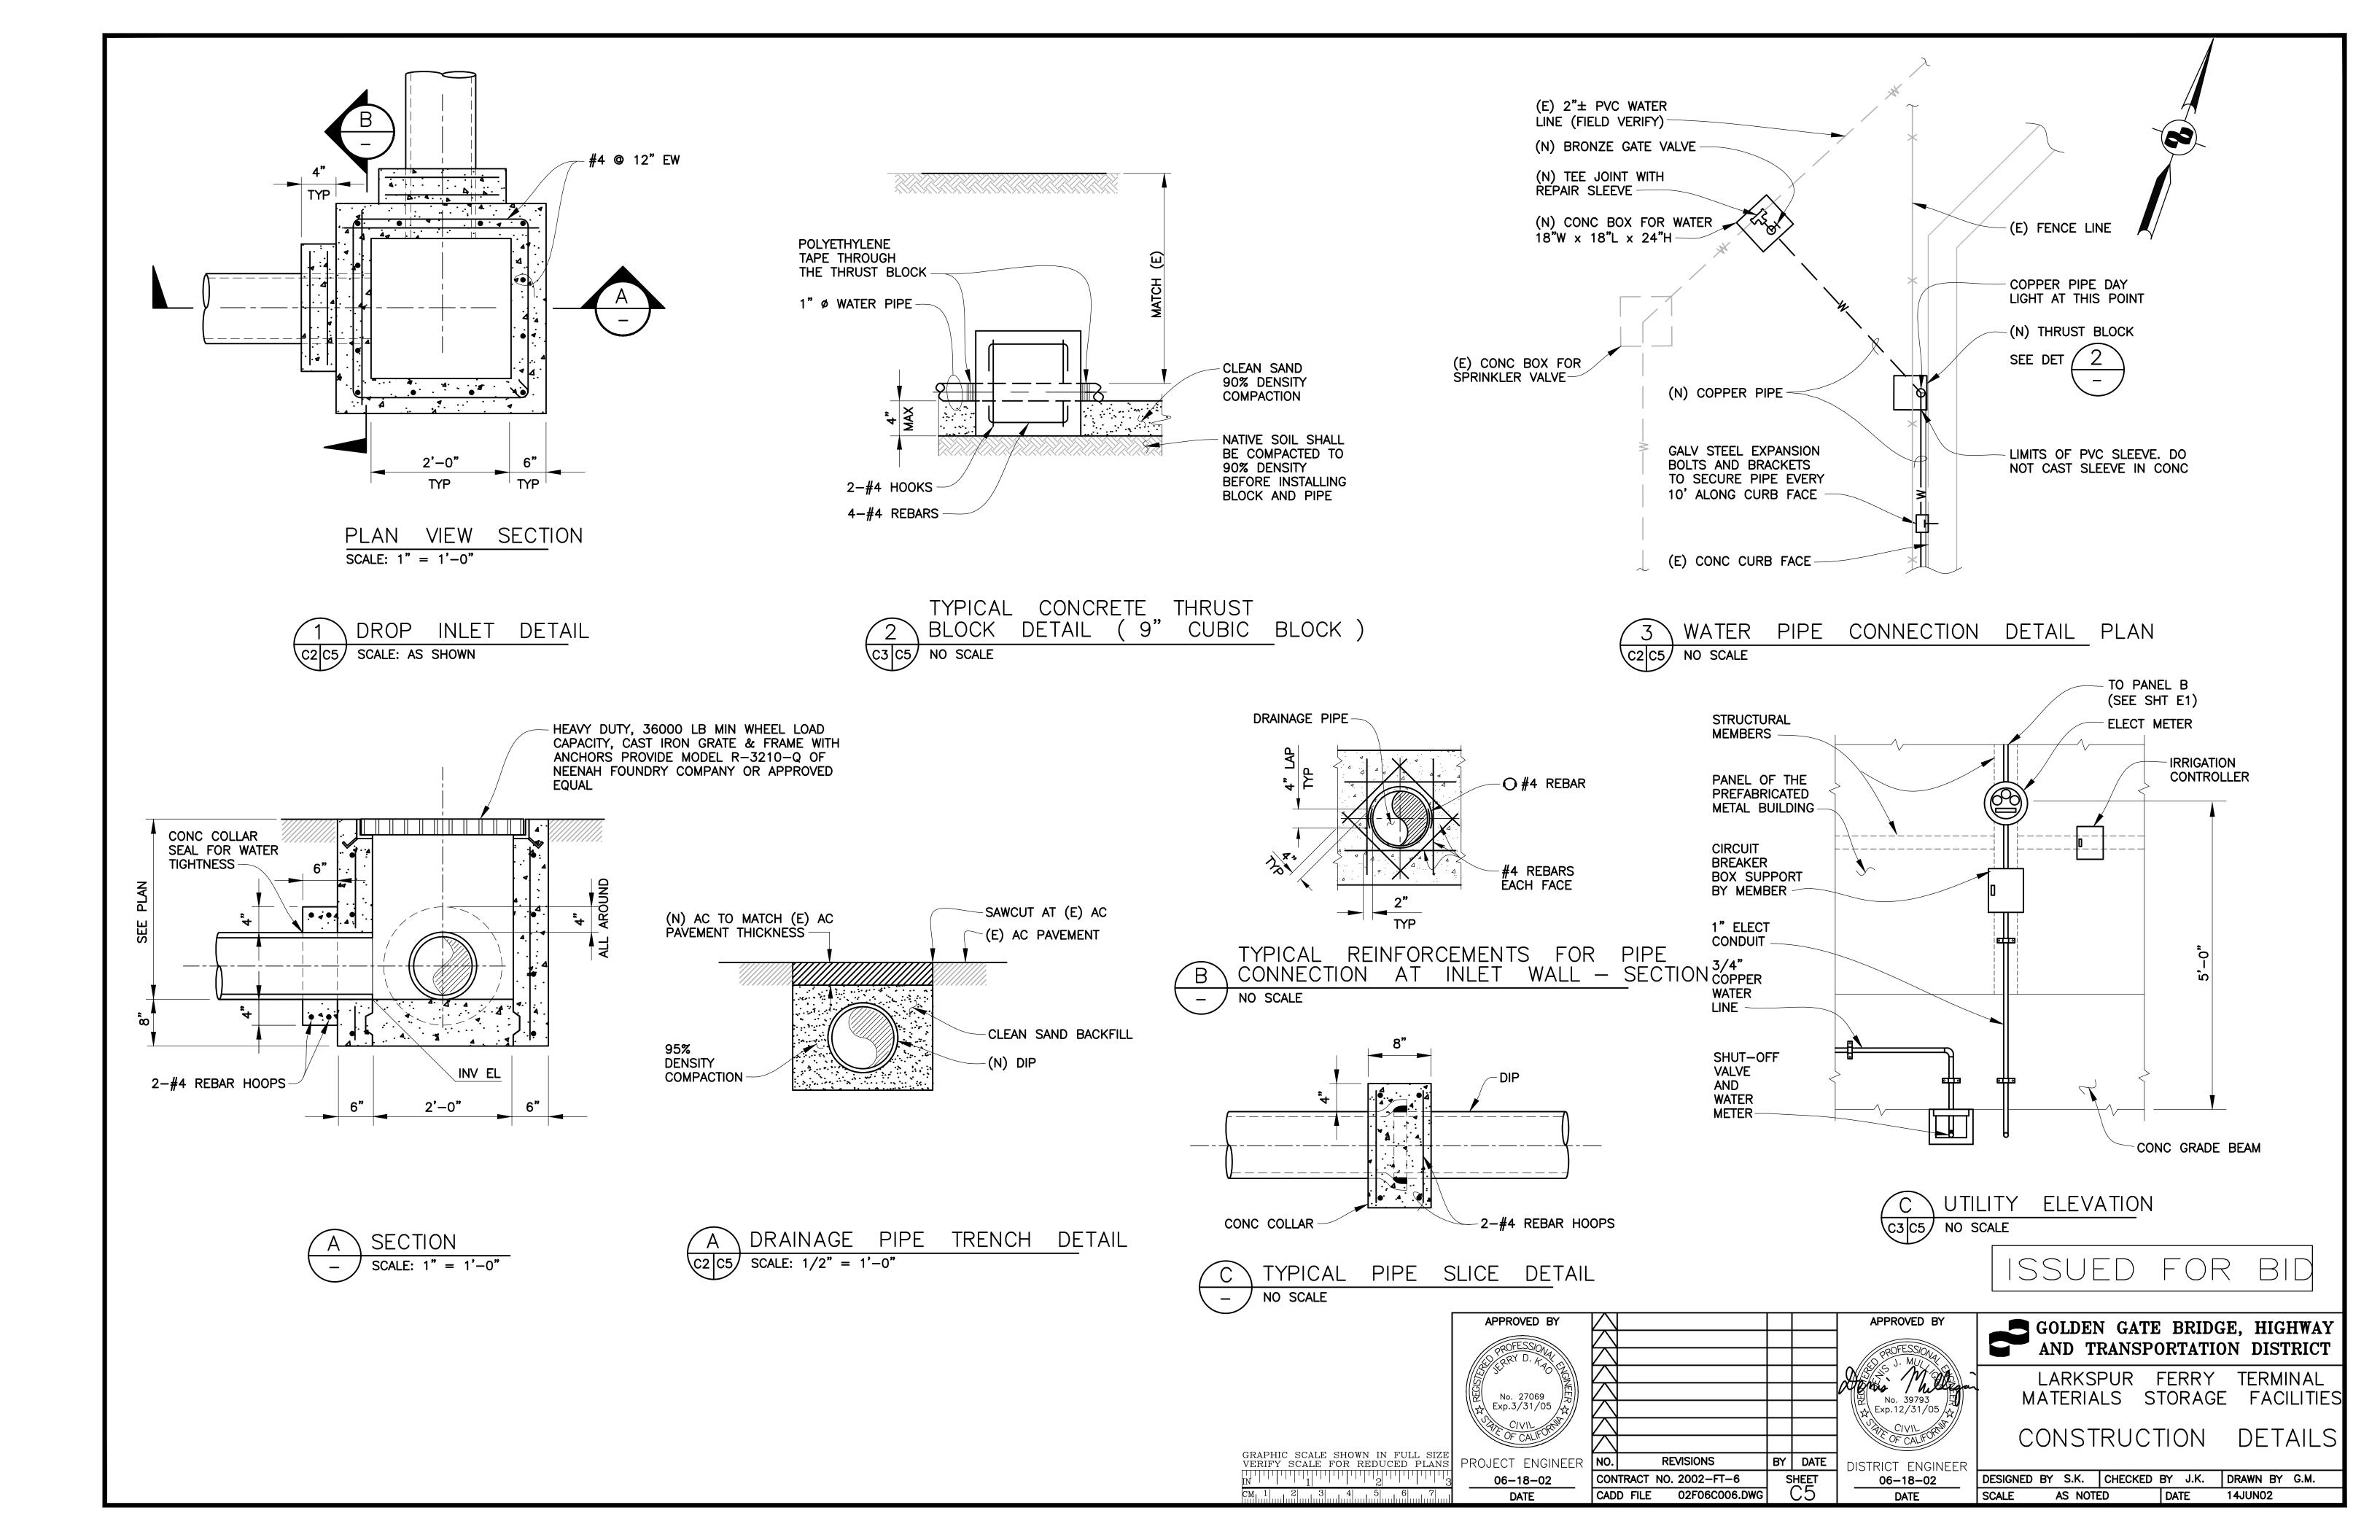

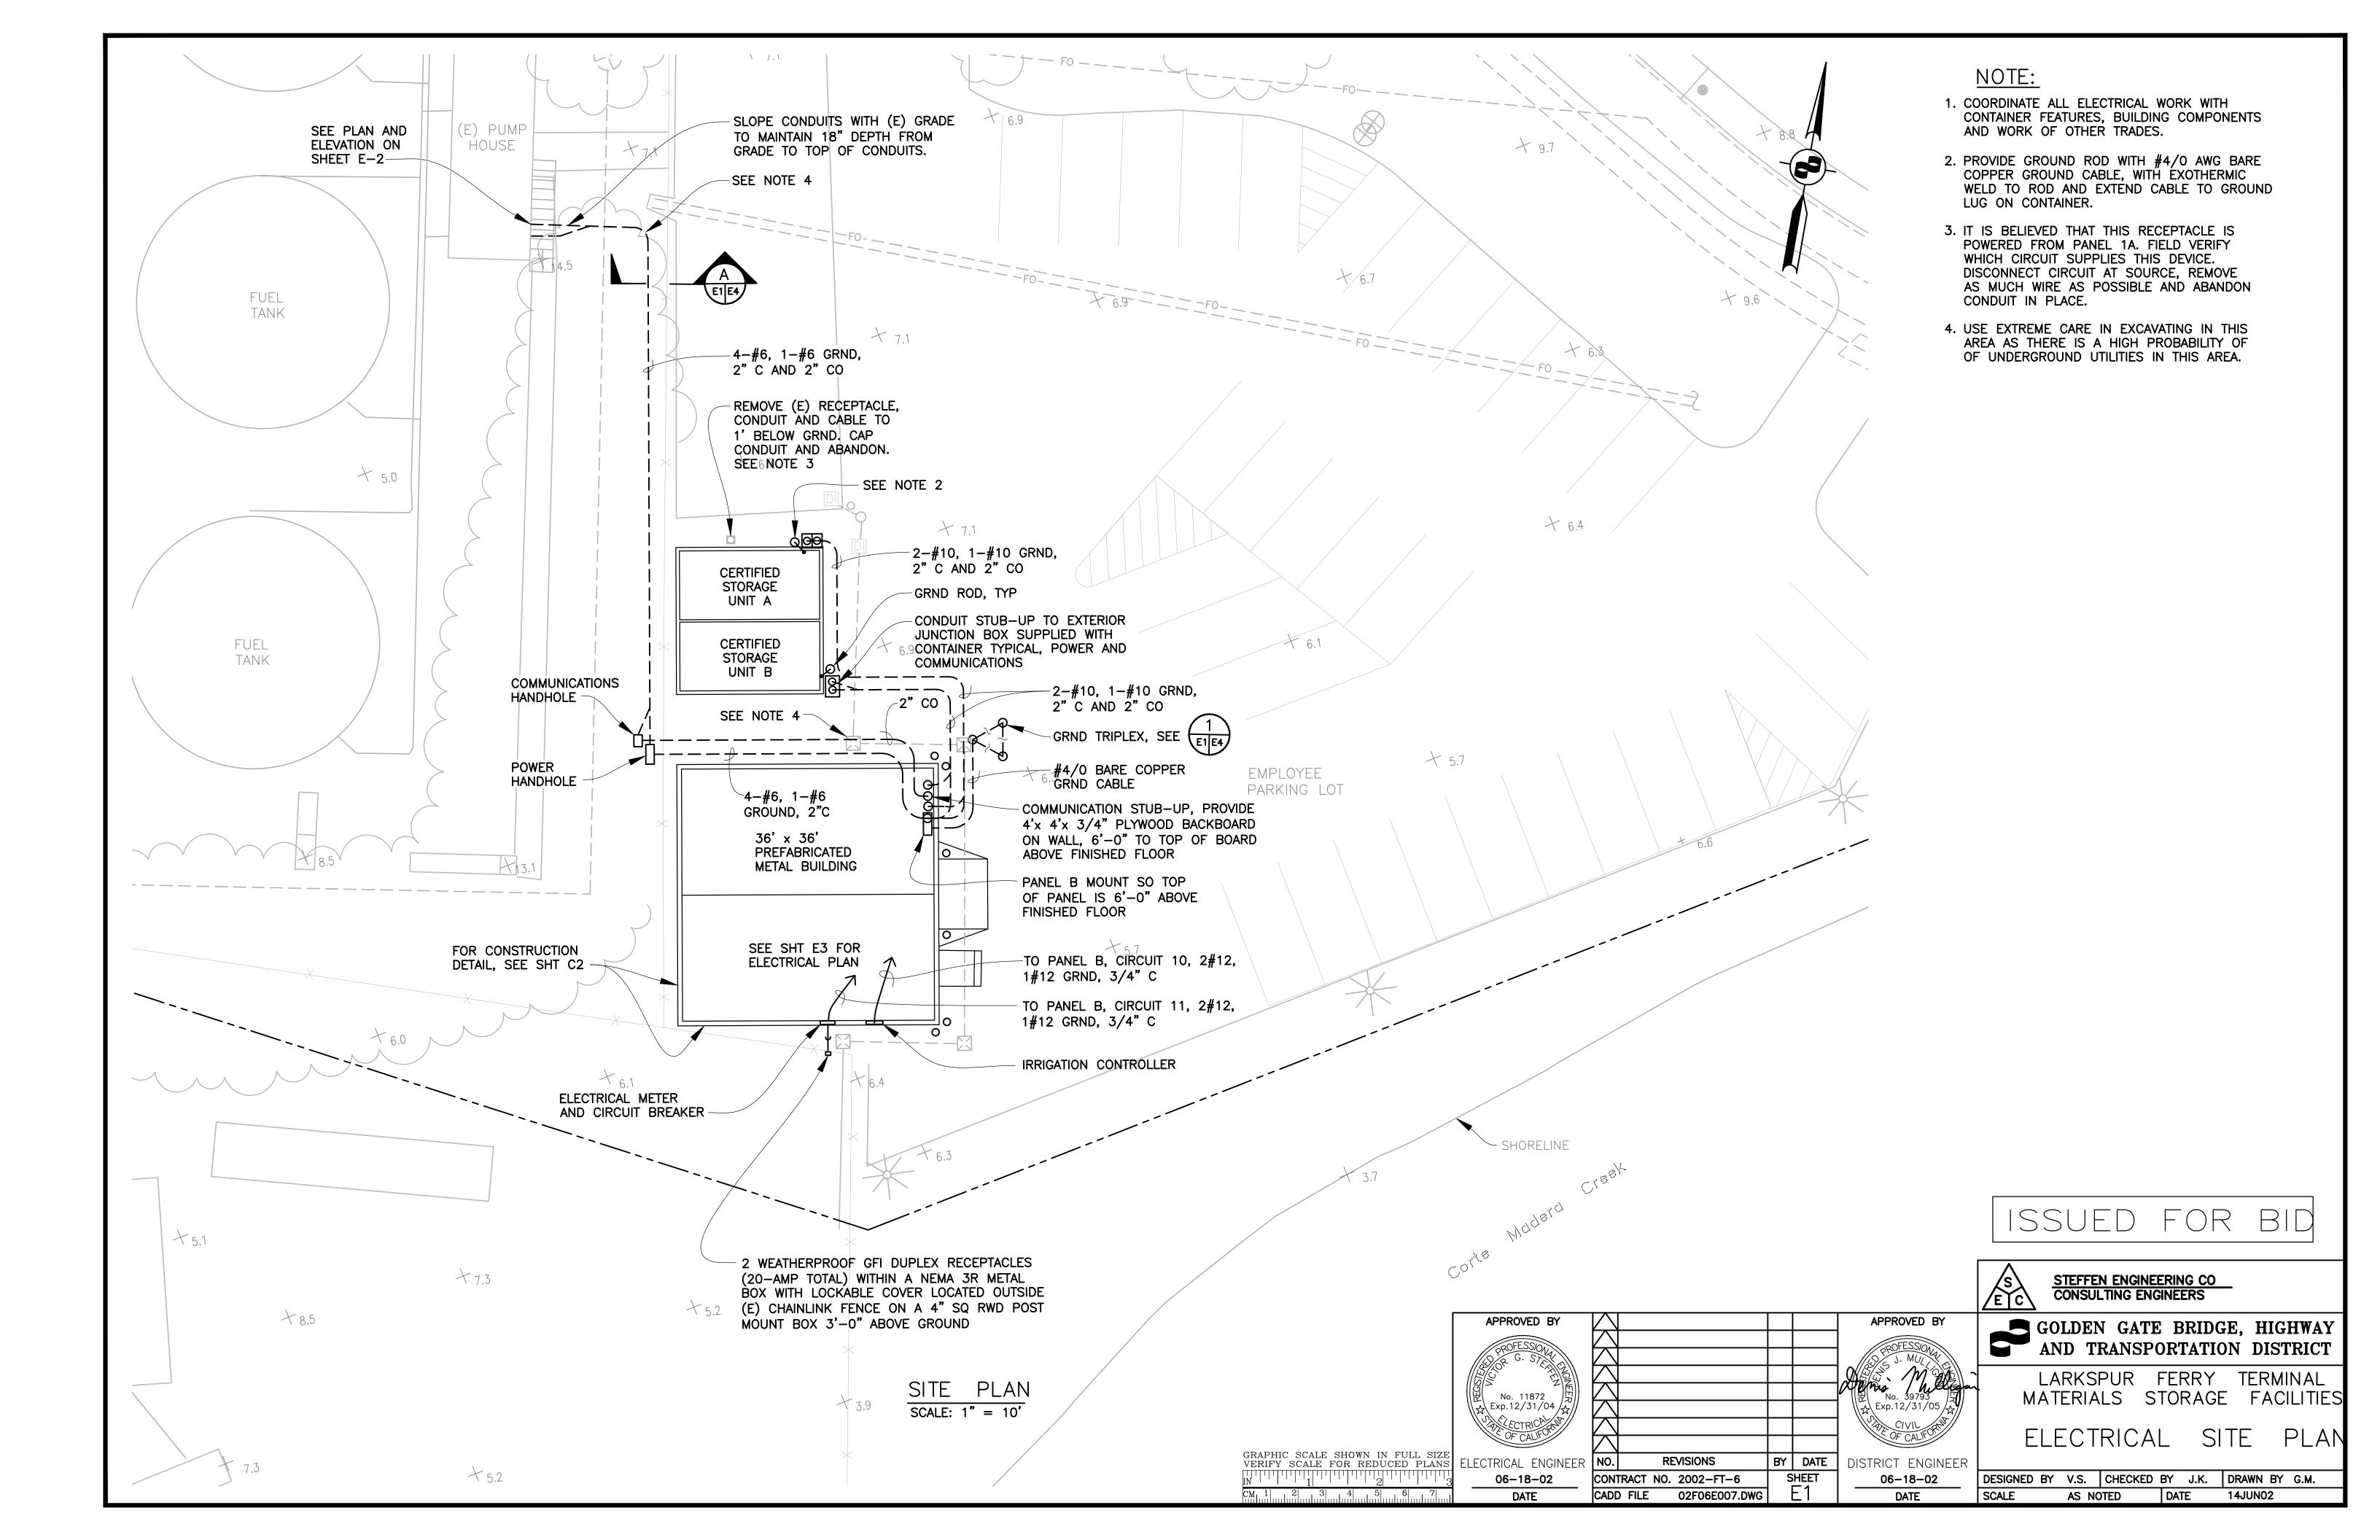

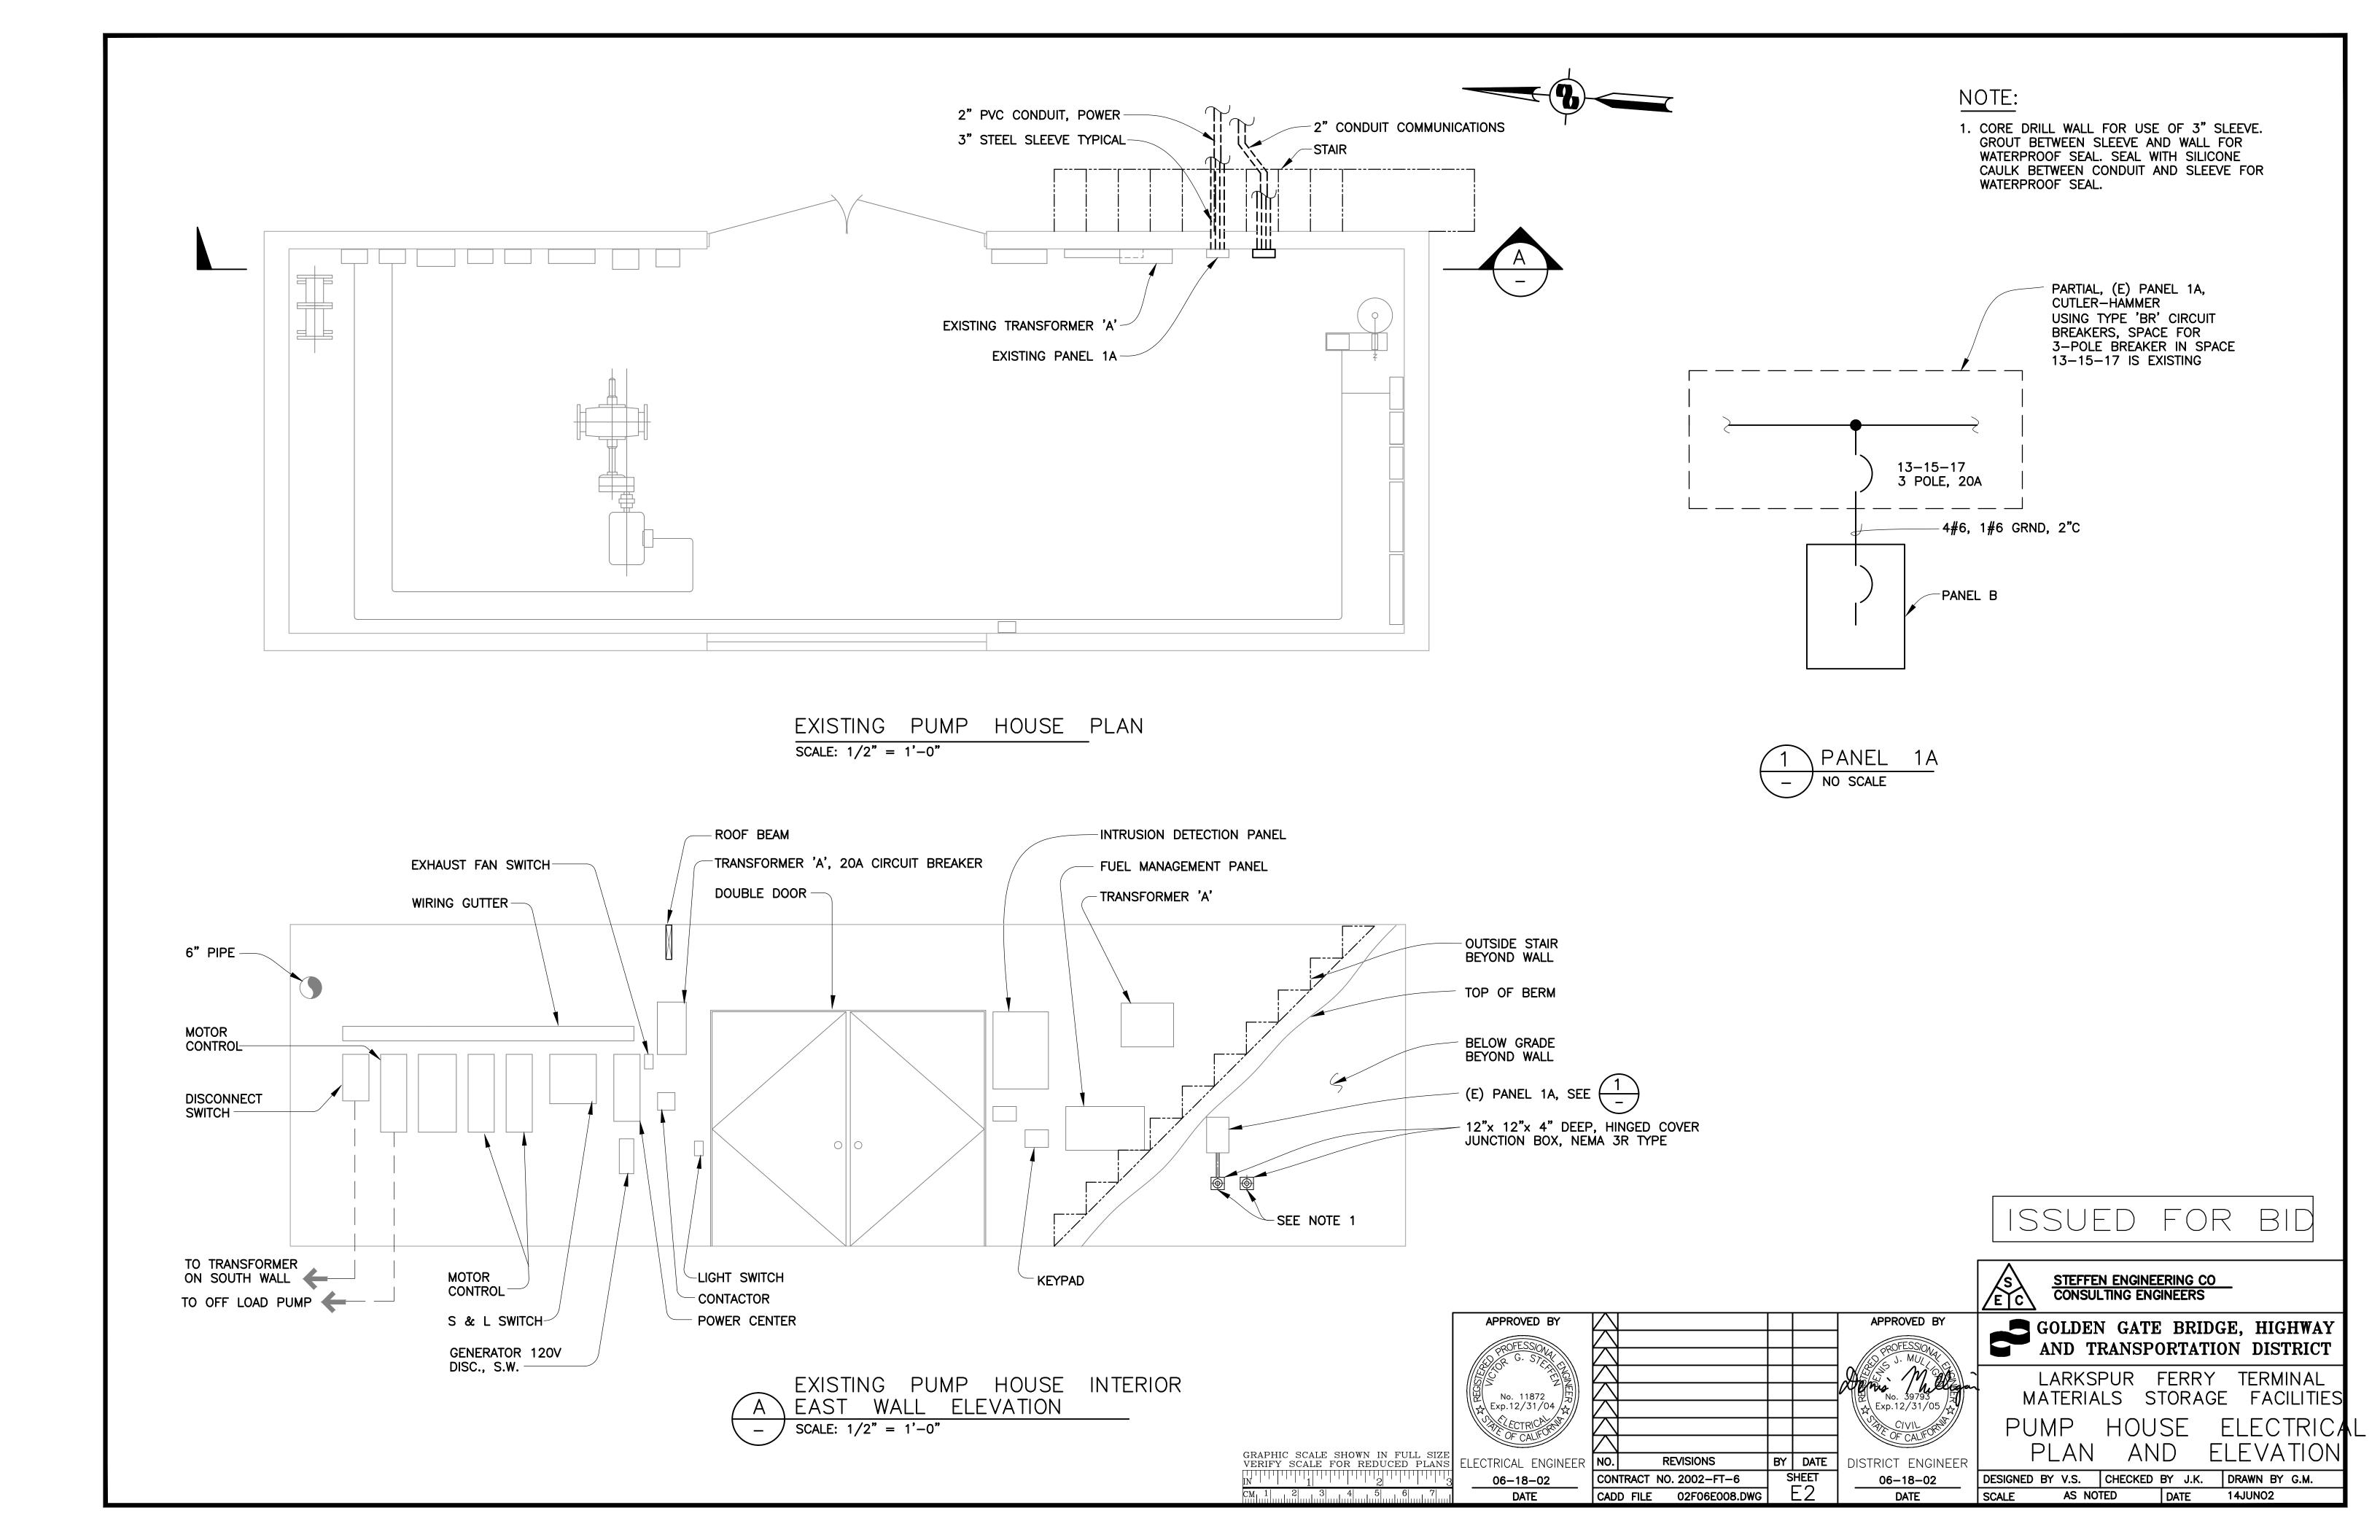

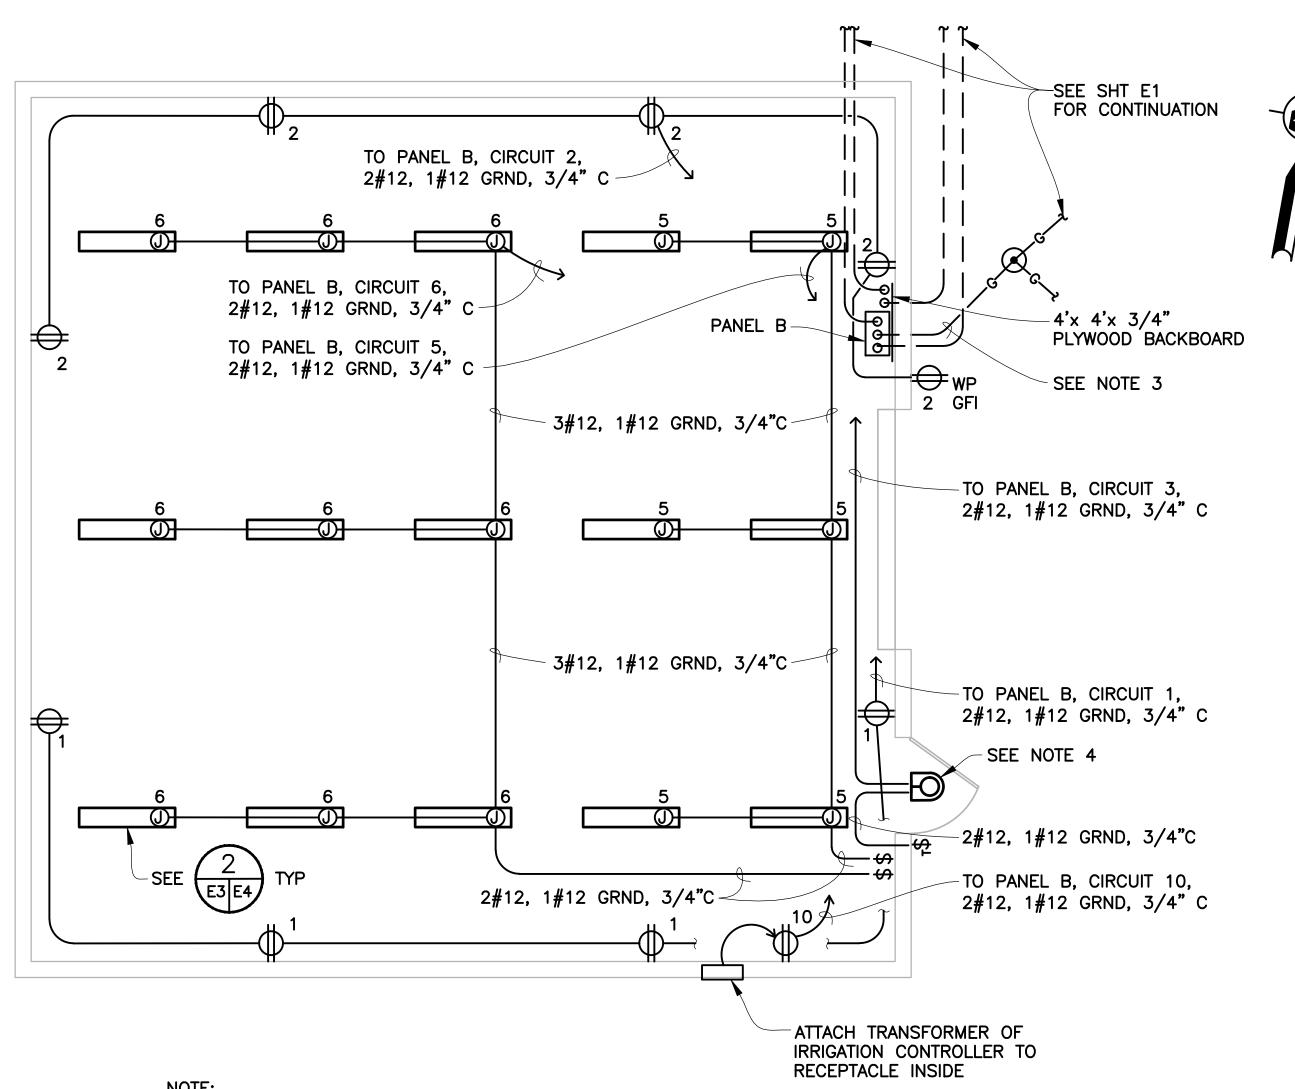

NOTE: LIGHT FIXTURE SHOWN AS REFLECTED CEILING PLAN

STORAGE BUILDING ELECTRICAL PLAN SCALE: 1/4"=1'-0"

	LIGHTING FIXTURE SCHEDULE									
TYPE	DESCRIPTION	# LAMPS WATTAGE	VOLTS	CATALOG NO.						
A	INDUSTRIAL FLOURESCENT FIXTURE W/ REFLECTOR AND 10% UPLIGHT PENDANT HUNG, 0°F BALLAST	2 32W/EA	120	LITHONIA #AF10-2-32-120-GEBIORS						
В	OUTDOOR INCANDESCENT WALLPACK W/ GALVANIZED SHEET METAL SHIELD	1 100W	120	HOLOPHANE #WL2K-30DIN-12-GR						

#### LEGEND & ABBREVIATIONS:

\$ LIGHT SWITCH
\$T TWIST TYPE TIMER SWITCH 0-60 MINUTE

DUPLEX RECEPTACLE

EXPOSED CONDUIT

UNDERGROUND DIRECT BURIED CONDUIT

GROUND ROD

G-#4/0 BARE COPPER GROUND CABLE

POWER PANEL WITH CONDUIT STUB-UPS SHOWN

CONDUIT STUB-UP

INCANDESCENT AREA LIGHT


CO CONDUIT ONLY


AFF ABOVE FINISHED FLOOR

## NOTES:

- 1. ALL SYSTEMS, EQUIPMENT AND MATERIALS SHOWN ARE NEW AND SHALL BE PROVIDED UNDER THIS CONTRACT, UNLESS OTHERWISE NOTED. LIGHT LINEWORK DENOTES EXISTING SYSTEMS, HEAVY LINEWORK DENOTES NEW WORK UNDER THIS CONTRACT.
- 2. CARRY GROUND CONDUCTOR TO ALL EQUIPMENT, DEVICES, AND OUTLETS AND BOND AT ALL LOCATIONS.
- 3. BOND INCOMING GROUND CABLE TO BUILDING STEEL AT ONE LOCATION, TO PANEL B GROUND BUS AND LEAVE 6' PIGTAIL AT PLYWOOD BACKBOARD. CABLE TO BUILDING STEEL BY EXOTHERMIC WELD.
- 4. THE OUTDOOR LIGHT SHALL BE SHIELDED TO DIRECT THE LIGHT DOWN TO AN AREA IN FRONT OF THE ACCESS DOOR ONLY.

SUPPLY: 🛛 _BOTT. 🔲 _TOP 🔲 _LUGS 🖾 _MAIN BRKR. 💮 _LTG. 🔯 _RECEPT. 🔲NEMA													
TYPE: ☐ _3P3W ☒ -3P4W ☒ -WITH GRD. BAR MOUNTING ☒ -SURFACE ☐ -FLUSH ☐ -COL									-COLUM	N			
	MAINS: 100 A 10,000 A.I.C PANEL VOLTAGE ☑ -120/208 ☐ -277/480									□- /			
B TANEE													
60 A. MAIN BRKR. WITH -SHUNT. TRIP -ADJ. TRIP -G.F.P.													
CKT.	TRIP	NO. OF	USED FOR	COL. #1 VOLT —		- AMPS	COL. #2 VOLT -		- AMPS	USED FOR	NO. OF	TRIP	CKT.
NO.		POLES	332B 13K	A	В	C	A B		C	332B 13K	POLES	''''	NO.
1	20	1	RECEPTACLES SOUTH	800			800			RECEPTACLES NORTH	1	20	2
3	20	1	OUTDOOR LIGHT		100			500		CONTAINER B	1	20	4
5	20	1	LIGHTING FRONT			420			640	LIGHTING REAR	1	20	6
7	20	1	SPARE							SPARE	1	20	8
9	20	1	CONTAINER A		500			20		IRRIGATION CONTROL	1	20	10
11	20	1	SEA SCOUTS RECEPTACLE			400				SPARE	1	20	12
13	20	1	SPARE							SPACE			14
15			SPACE										16
17													18
19													20
21										<u> </u>			22
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25													26
27 29				<del>                                     </del>									28 30
31											1		32
33													34
35													36
37													38
39													40
41													42
				1	•				•		1	·	
			PHA	ASE TO	TALS C	OL. #1	800	800	820				
						OL. #2	800						
PHASE TOTAL VA 1600 1300 1460													
TOTAL 3 PHASE CONNECTED 4380 KVA 14 AMPS													

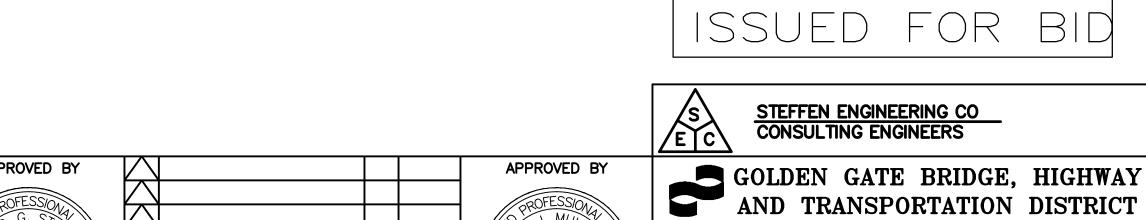


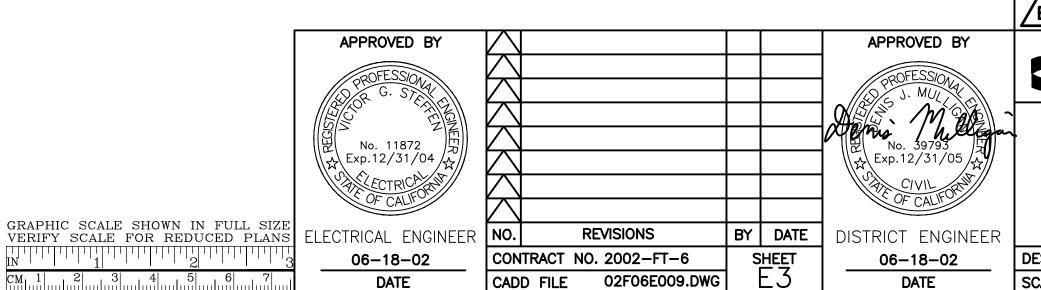


LARKSPUR FERRY TERMINAL MATERIALS STORAGE FACILITIES ELECTRICAL PLAN, LEGEND, AND SCHEDULES

DESIGNED BY V.S. CHECKED BY J.K. DRAWN BY G.M.

SCALE AS NOTED DATE 14JUN02

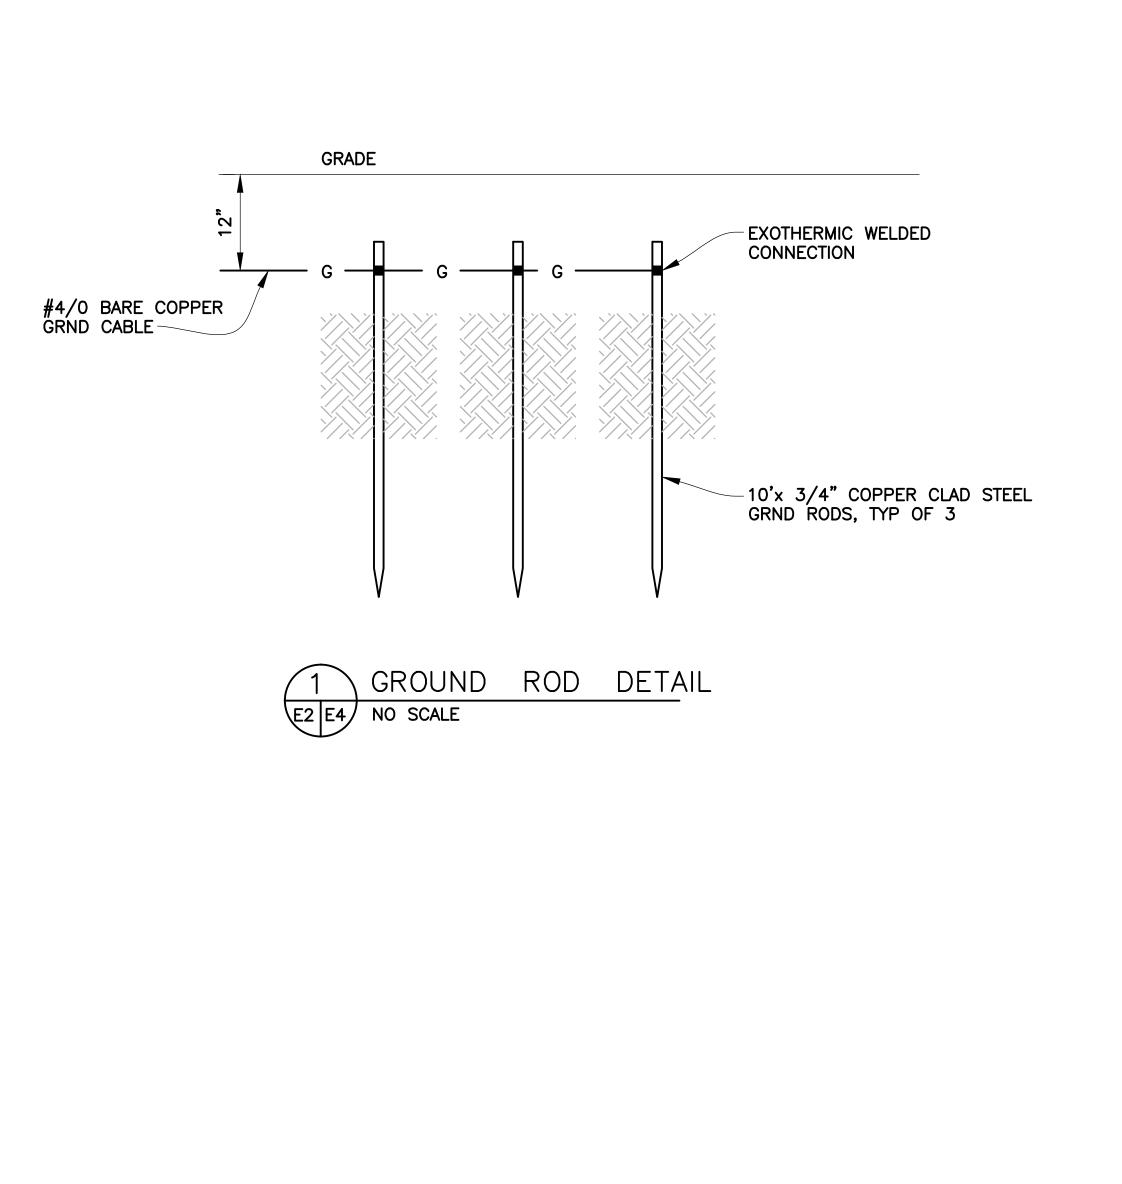

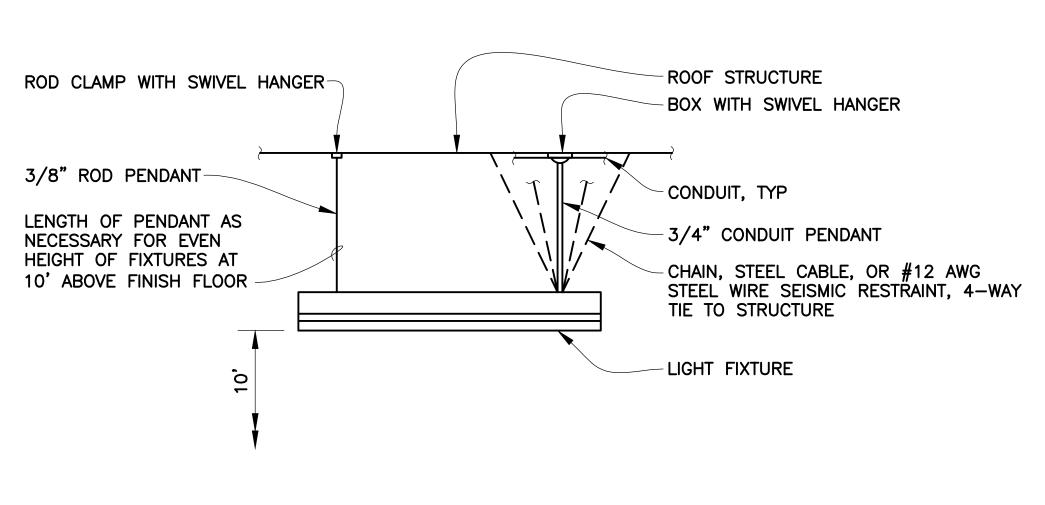

E3 E4 NO SCALE

FIXTURE MOUNTING DETAIL

