

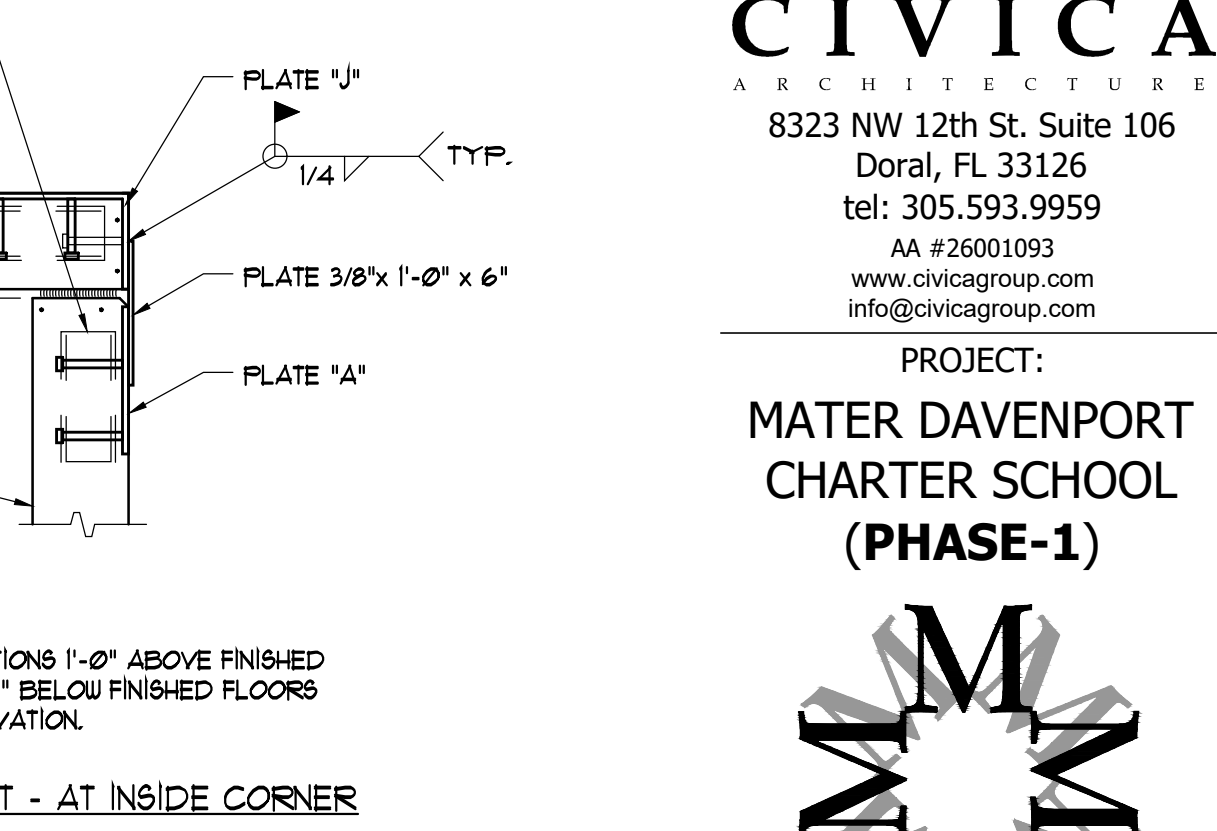
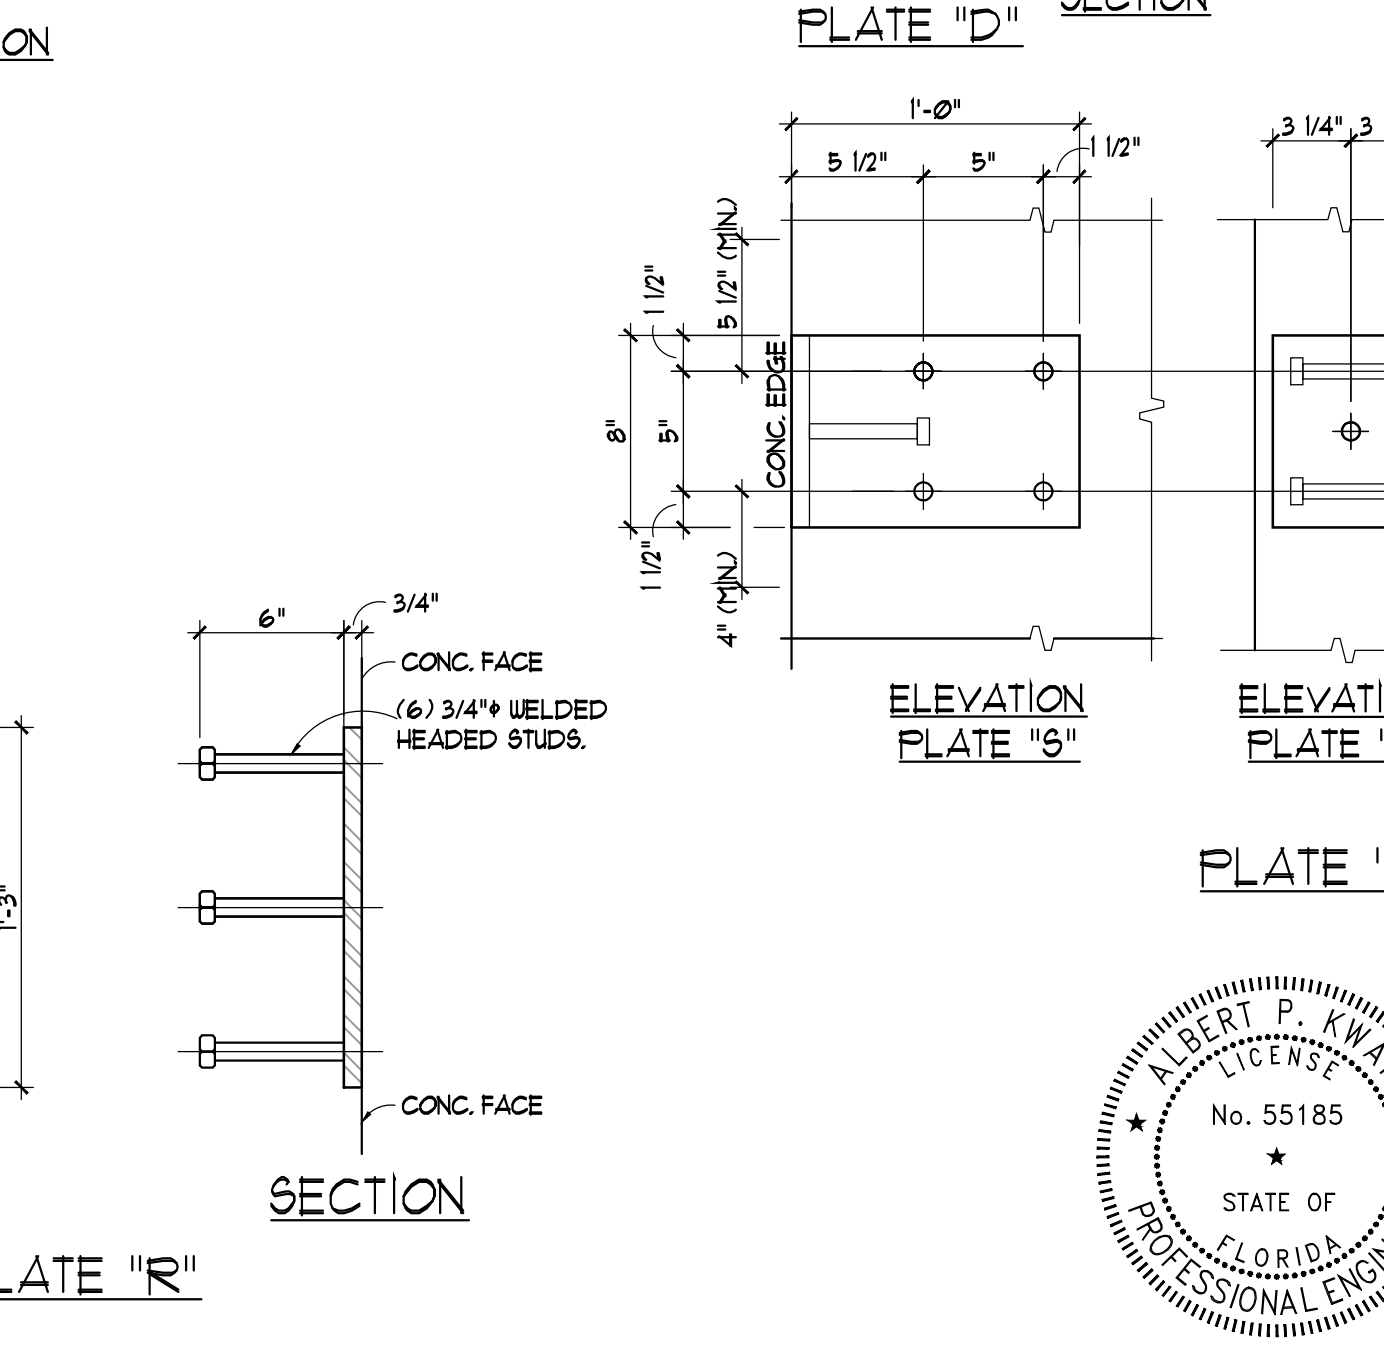
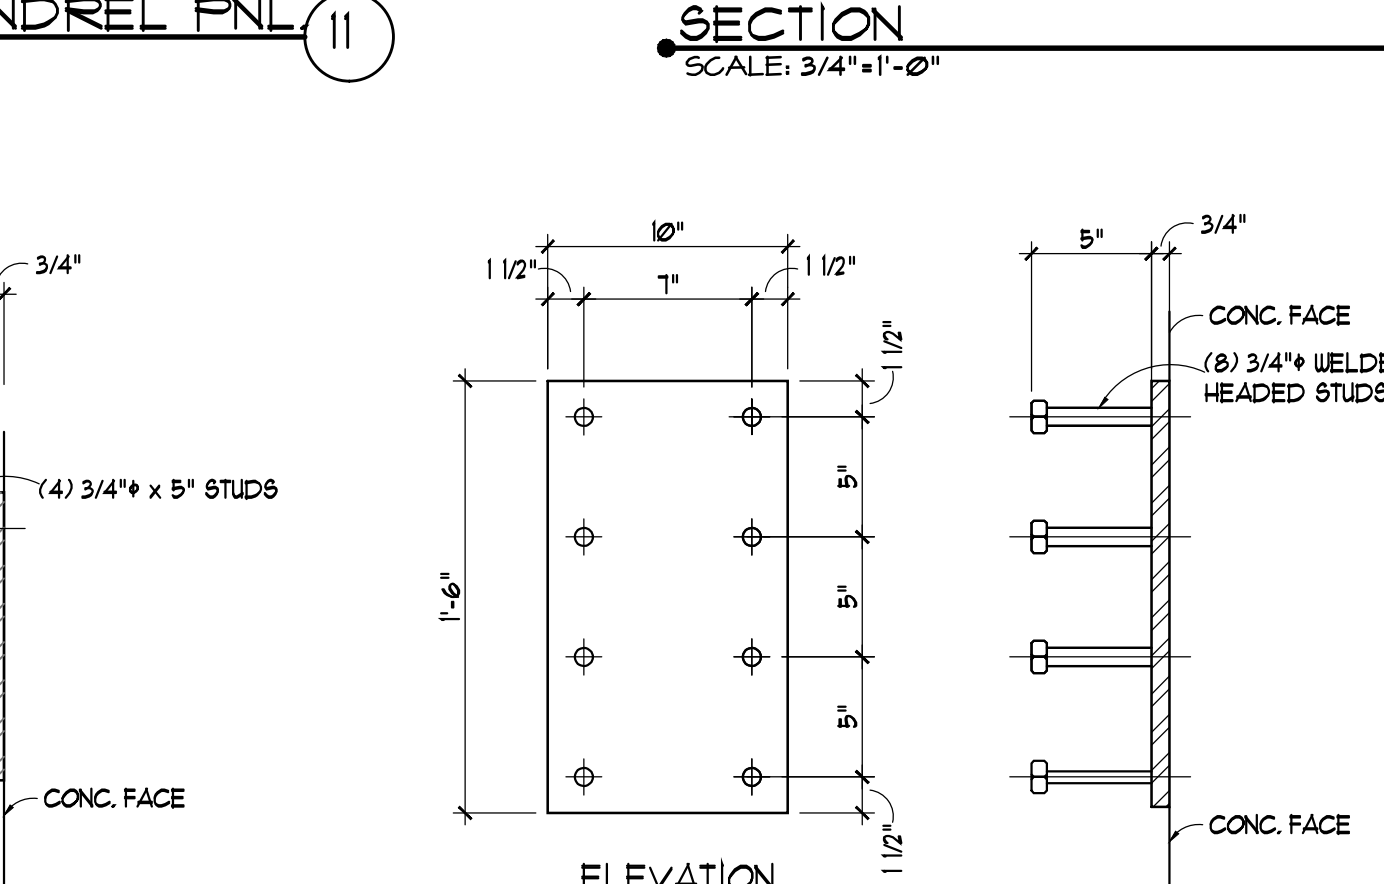
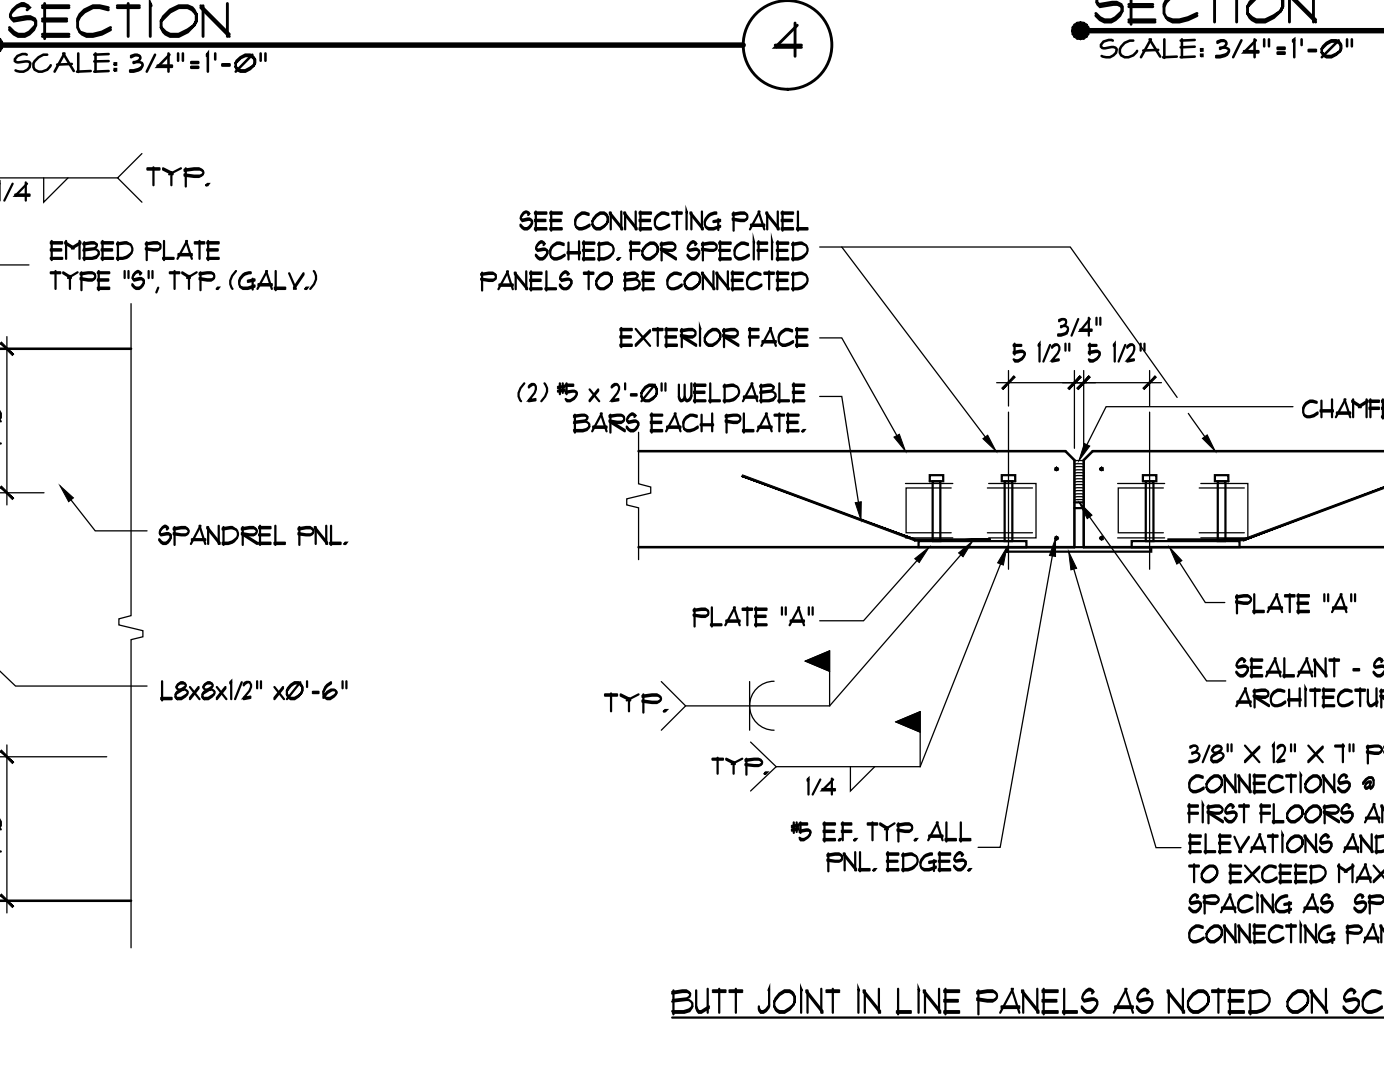
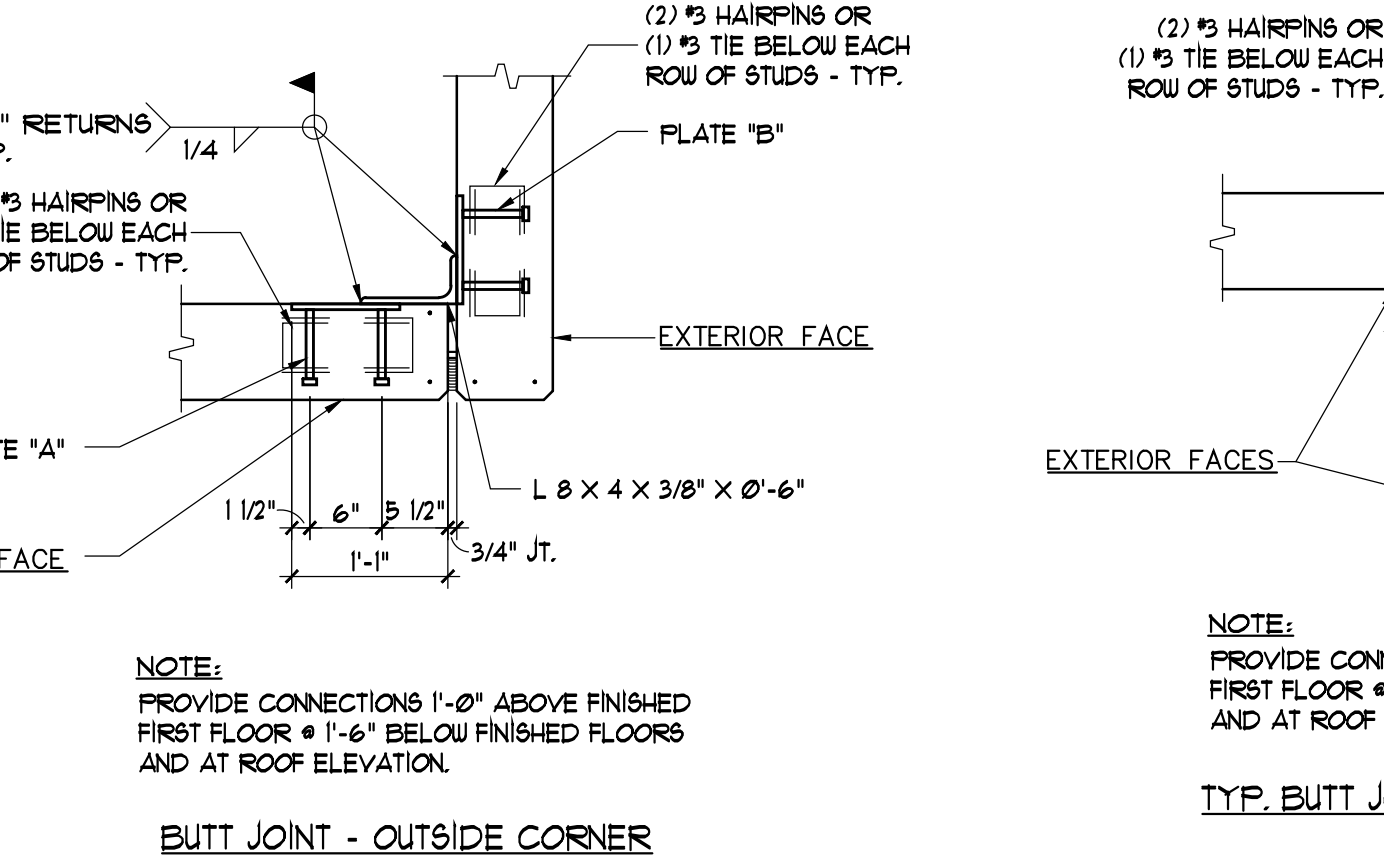
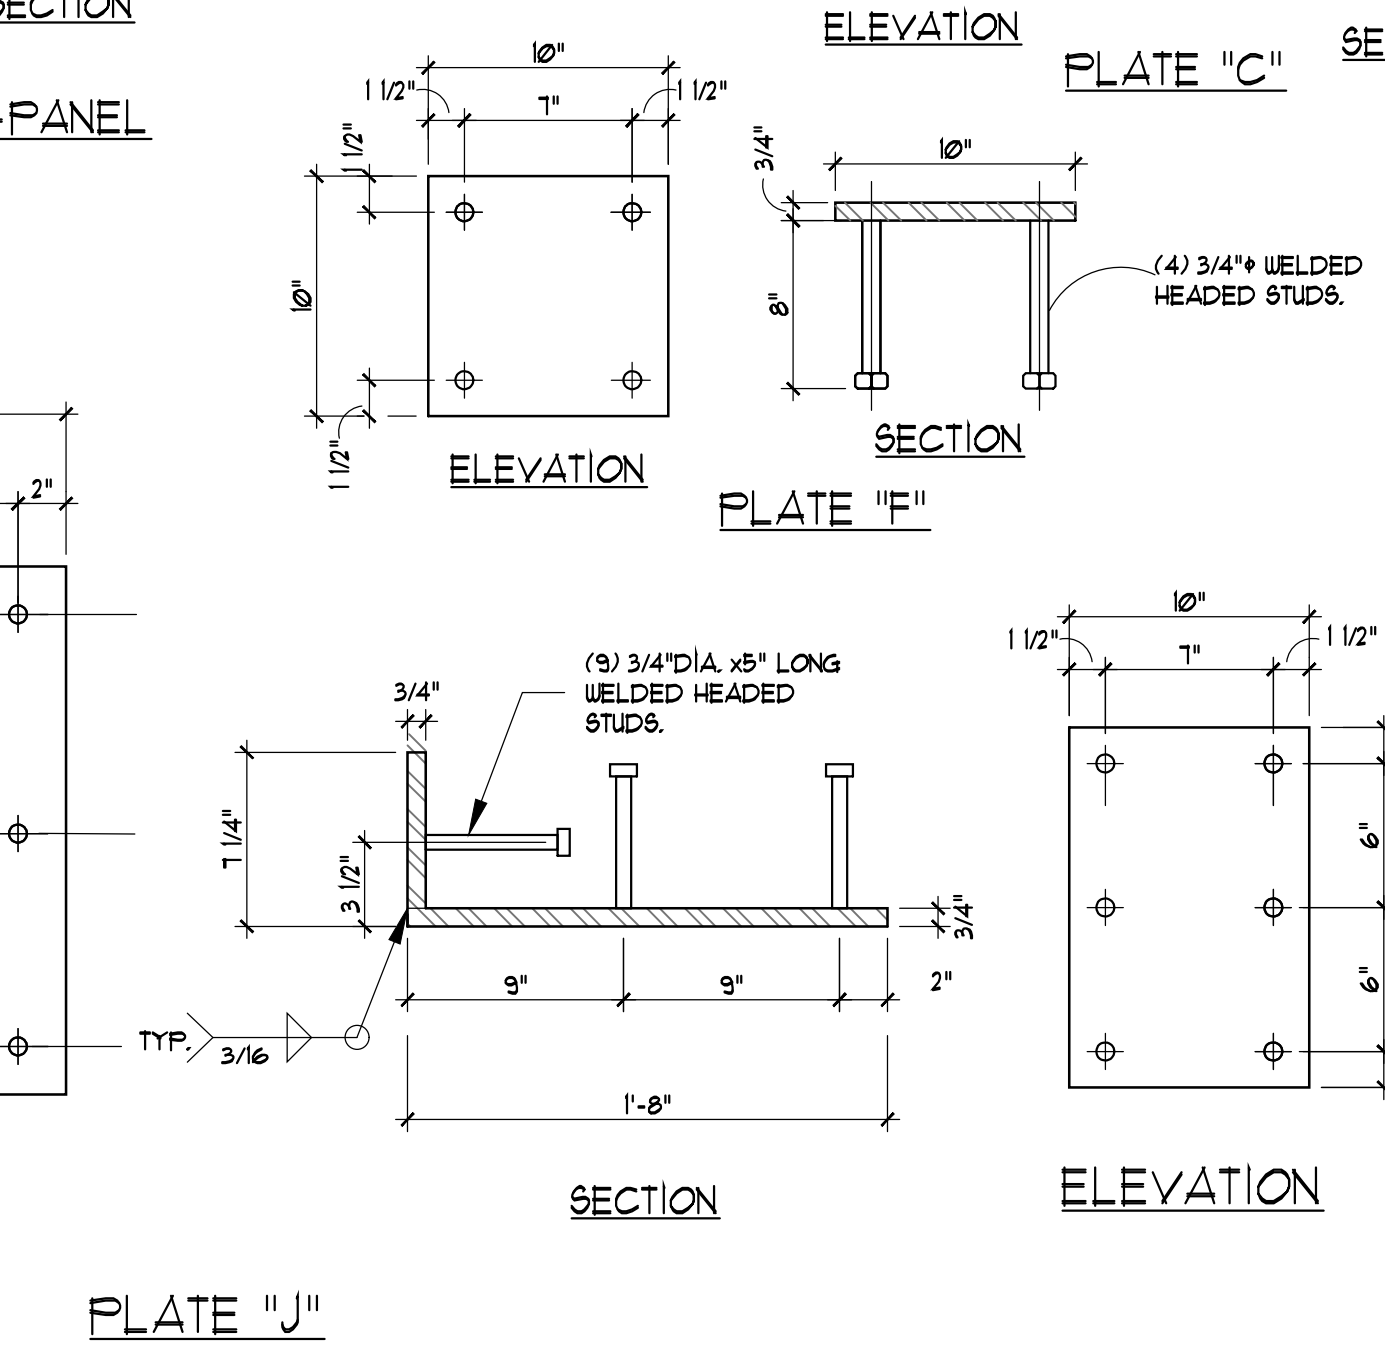
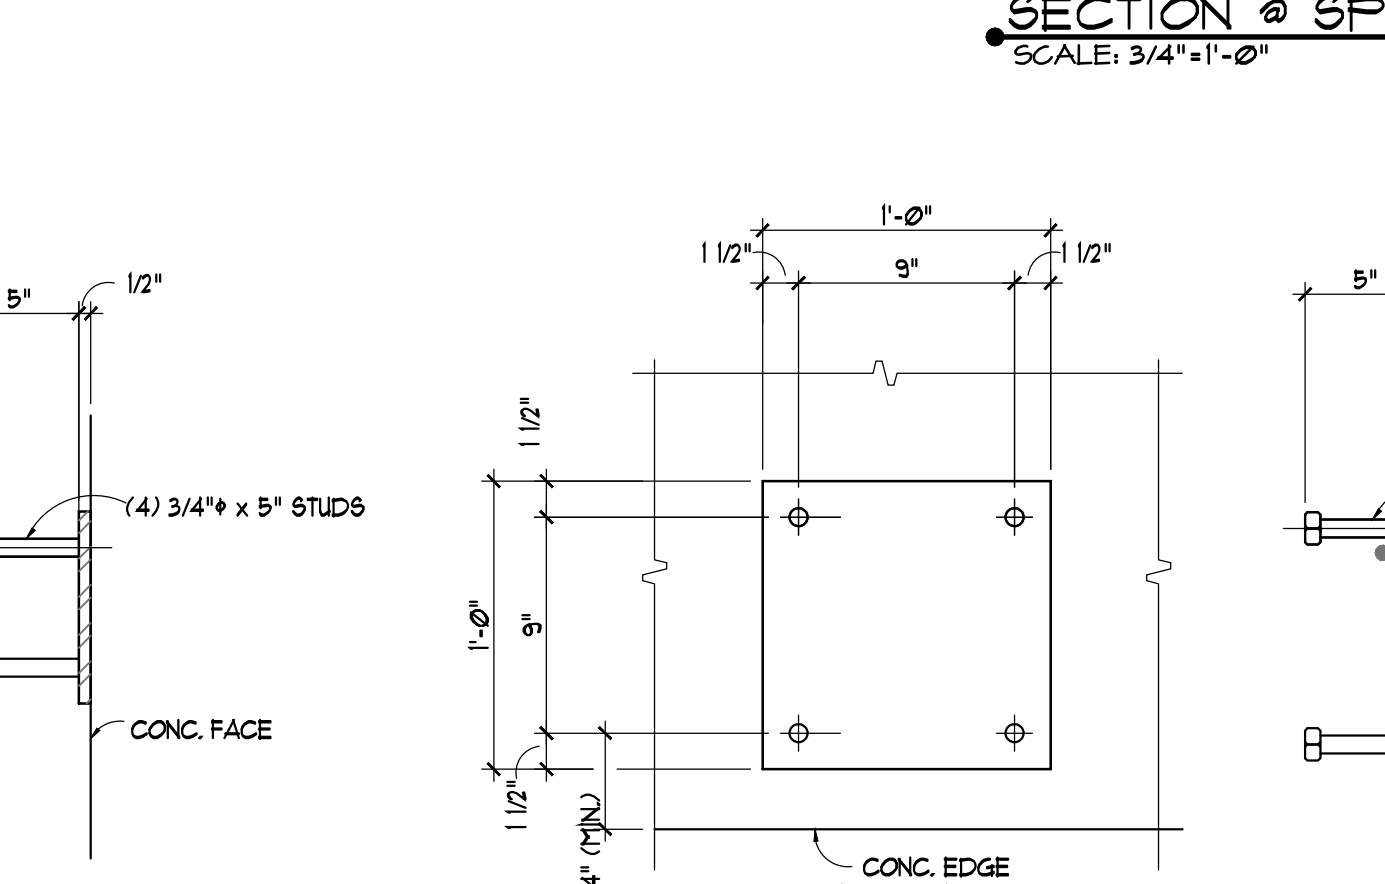
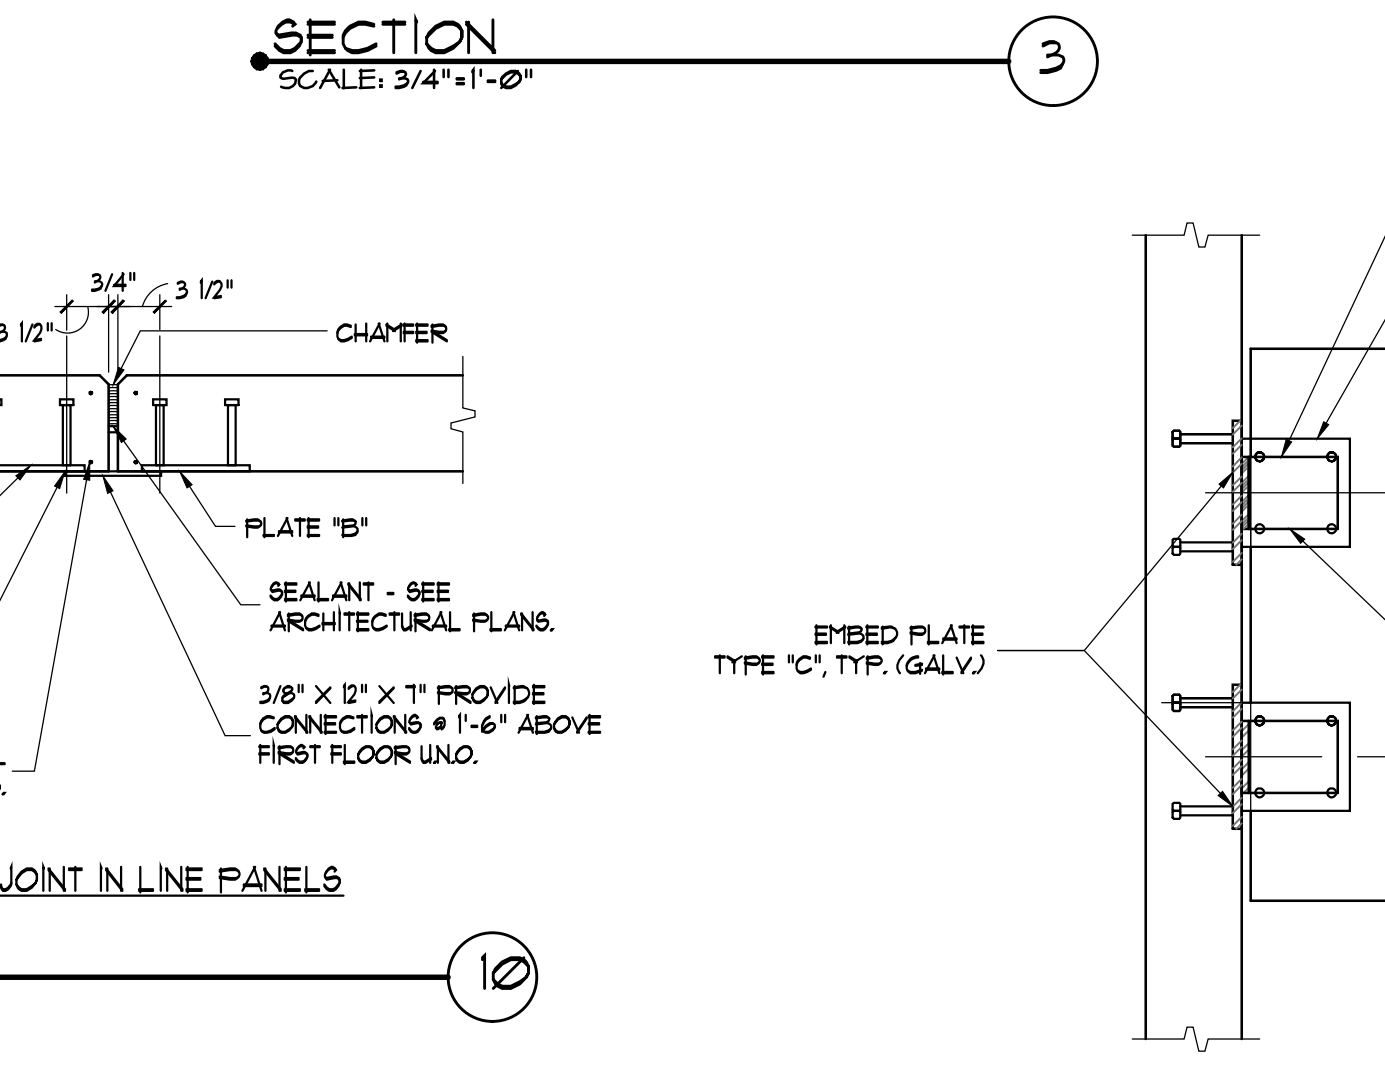
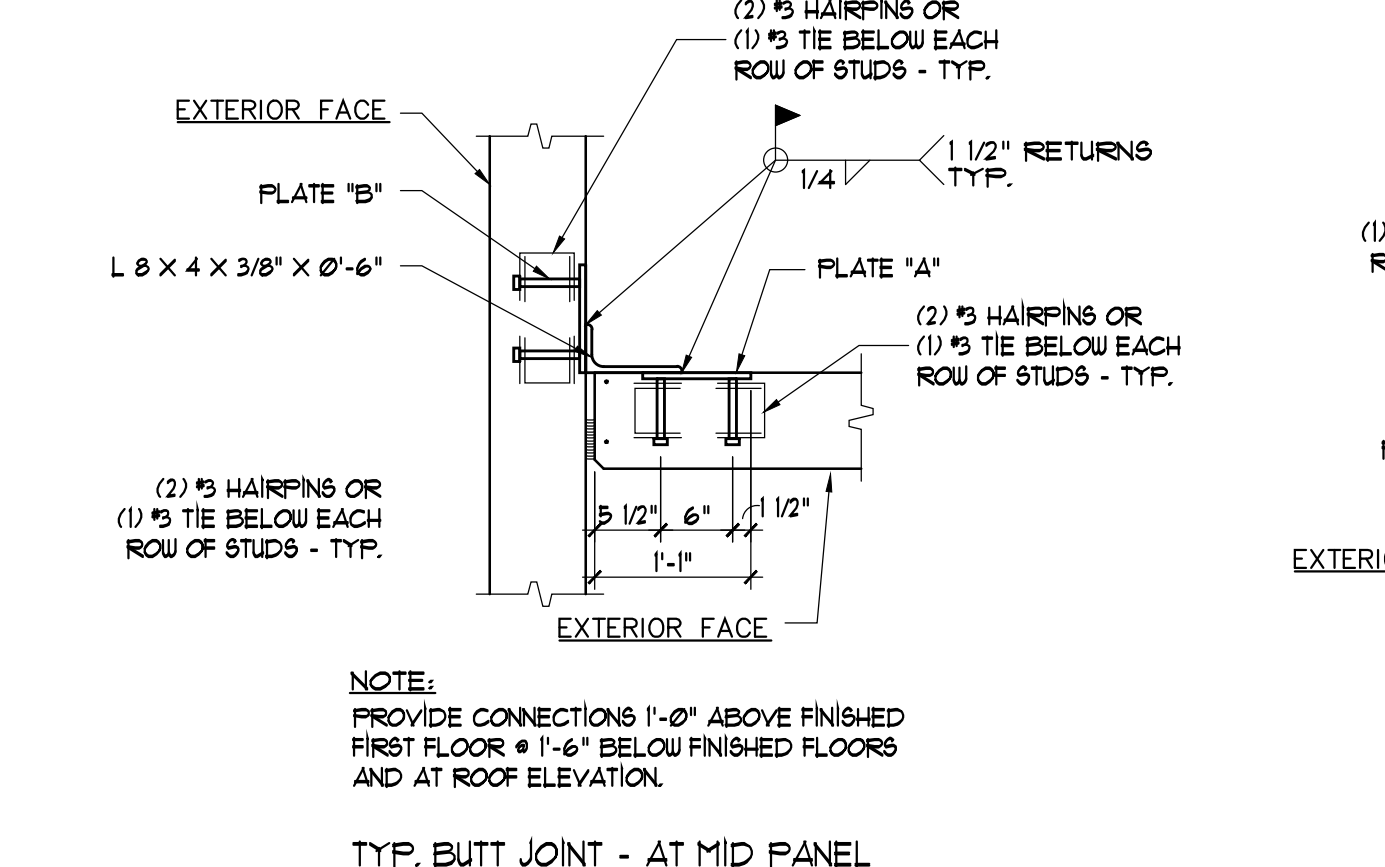
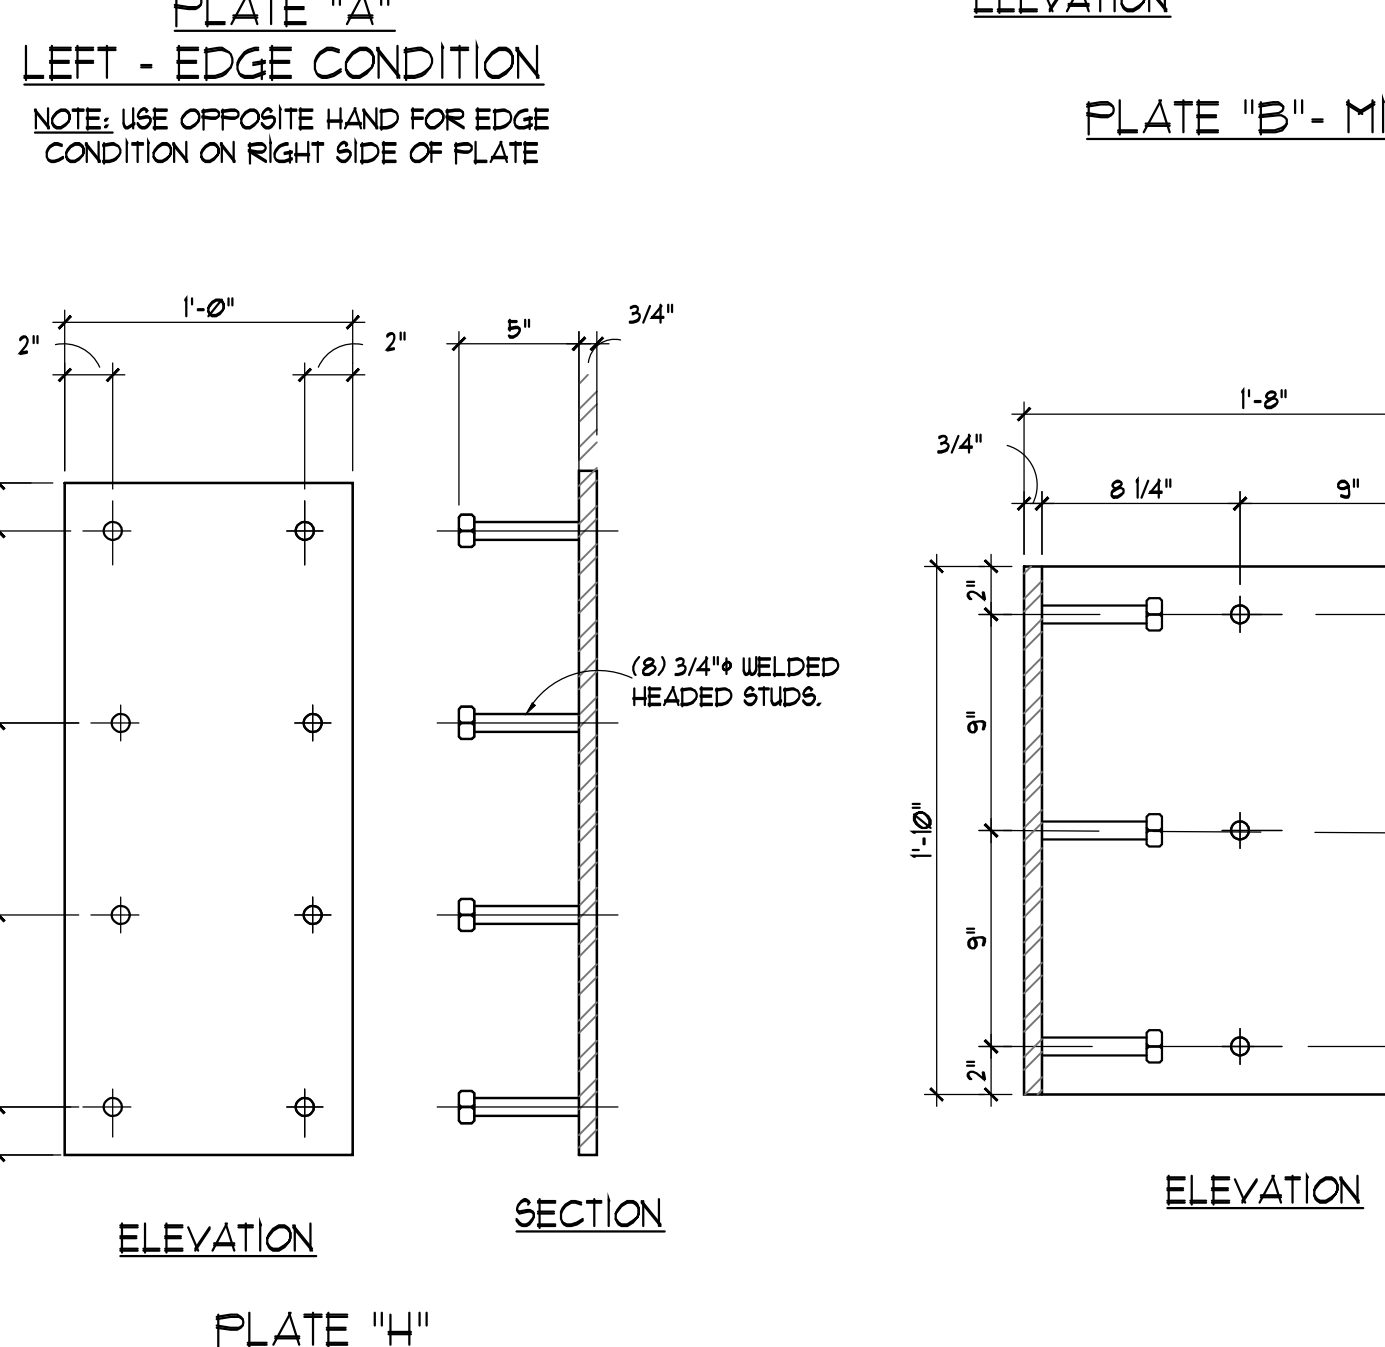
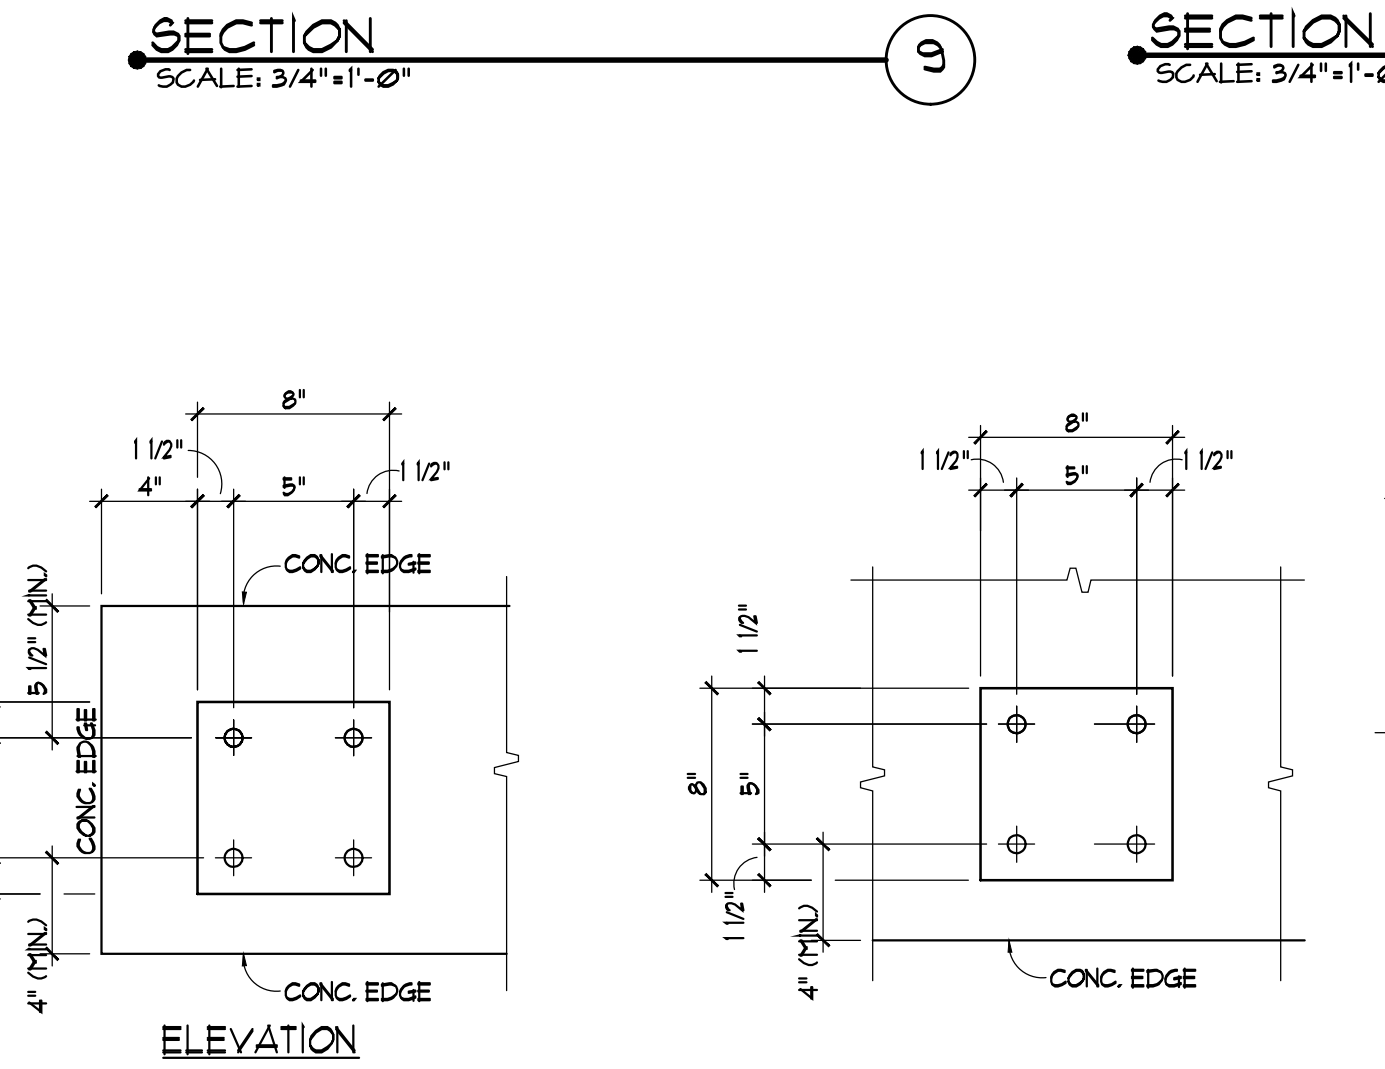
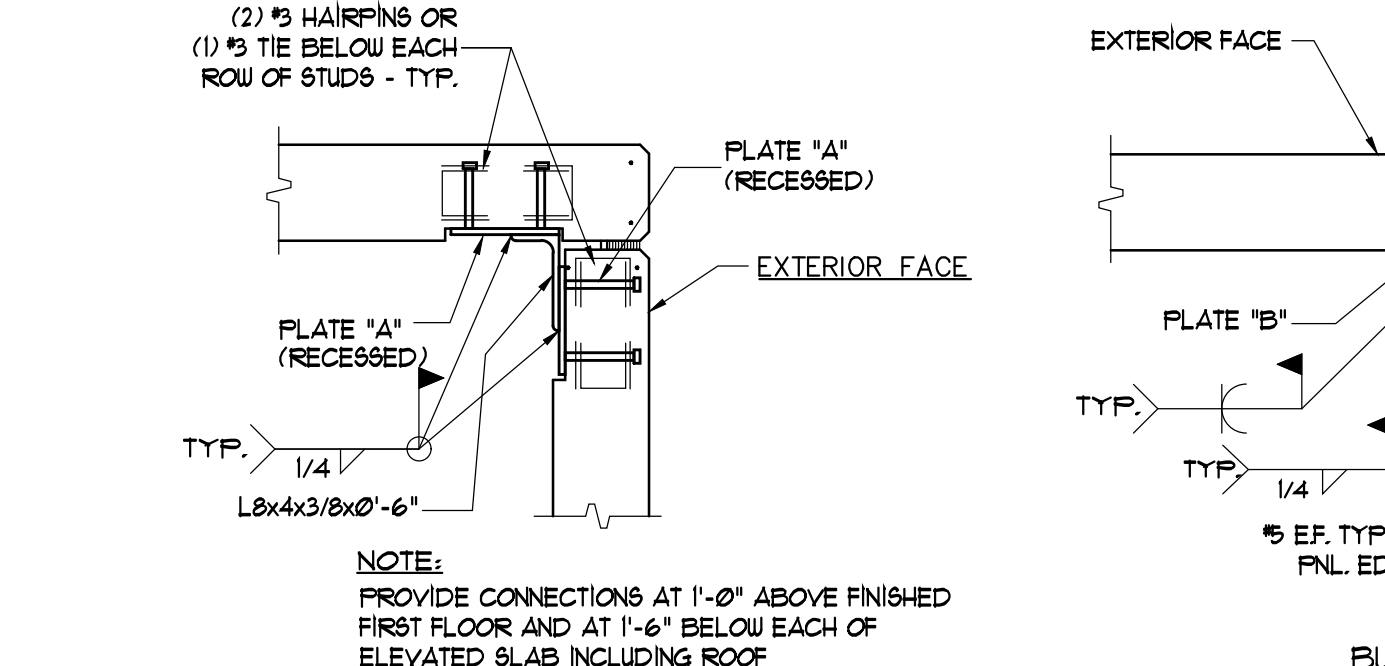
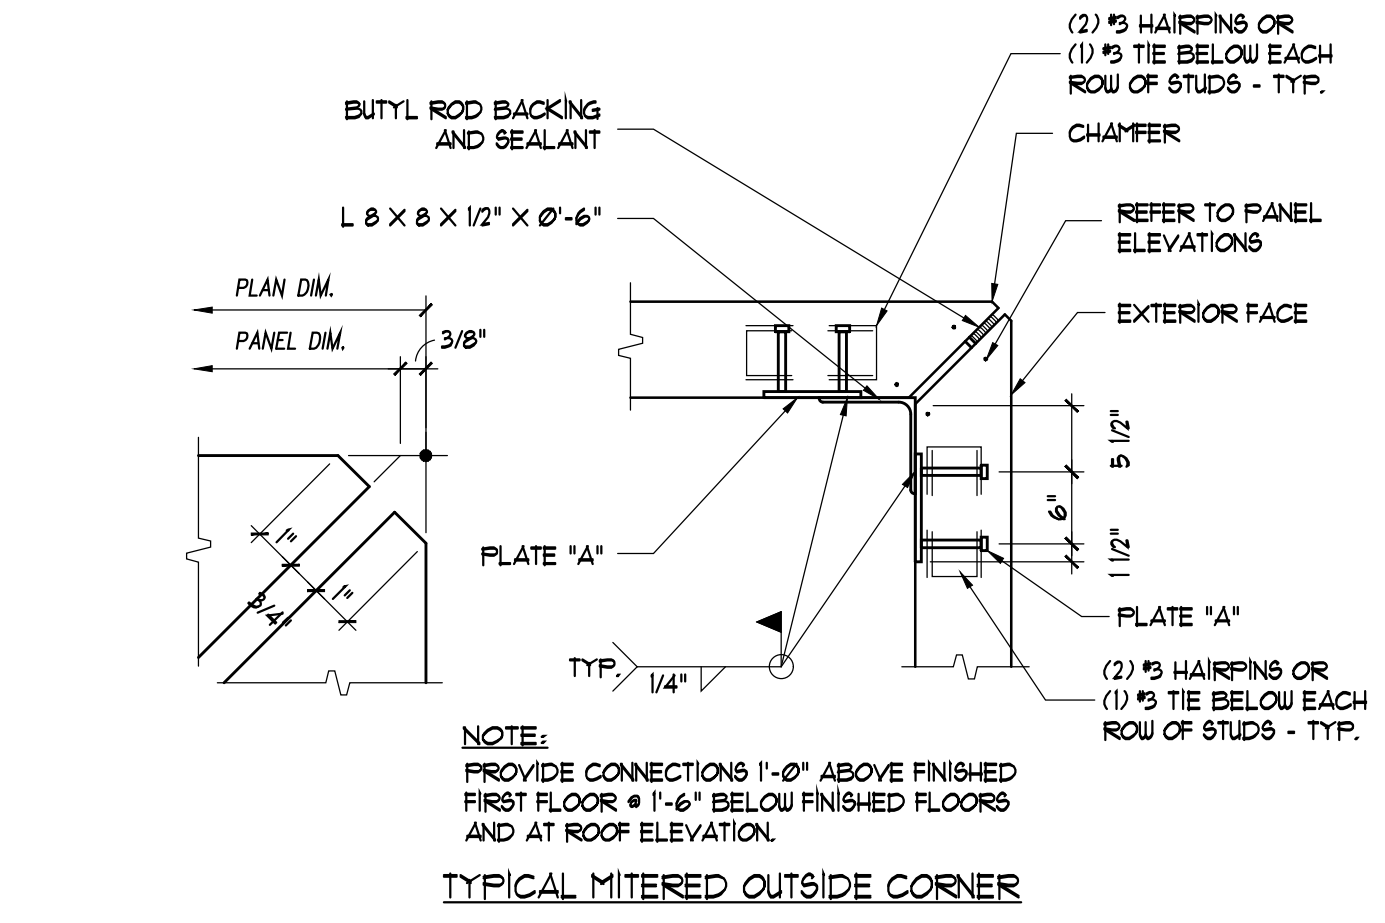


- TILT-UP PANELS:**
- ALL PANELS ARE VIEWED FROM THE INSIDE.
 - THE TOTAL THICKNESS OF ALL PANELS IS 7 1/2" TYP. U.O.N. REFER TO PANEL TYPES FOR THICKNESS. 3/4" REVEAL ALLOWANCE IS INCLUDED TYP. U.O.N.
 - REFER TO THE ARCHITECTURAL DRAWINGS FOR FINISHES & REVEAL REQUIREMENTS.
 - PANELS SHALL NOT BE LIFTED UNTIL CONCRETE HAS ATTAINED A MINIMUM COMPRESSIVE STRENGTH 3000 PSI.
 - THE CONTRACTOR SHALL PROVIDE DESIGN FOR THE LIFTS, INSERTS AND ANY ADDITIONAL REINFORCING STEEL REQUIRED FOR THE LIFTING OPERATION. HOWEVER NO ADDITIONAL REINFORCING SHALL BE ADDED WITHOUT THE EXPRESSED APPROVAL OF THE ENGINEER. THE DESIGNERS OF THE LIFTING INSERTS MUST CONSIDER THE REINFORCING NO REQUIRED IN THE PANELS.
 - THE CONTRACTOR SHALL CHECK ALL PANEL DIMENSIONS, PLATE LOCATIONS AND DETERMINE THE LOCATION OF ALL OPENINGS REQUIRED TO BE PROVIDED. NO PANEL WORK SHALL BE PERFORMED WITHOUT THE CONTRACTORS APPROVAL OF ALL OF THE ABOVE. THE CONTRACTOR IS INDICATING THAT HE HAS REVIEWED THE ABOVE AND IS SATISFIED WITH THE ACCURACY OF THE DRAWINGS BY COMMENCEMENT OF PANEL CONSTRUCTION.
 - MISCELLANEOUS OPENINGS MAY BE REQUIRED FOR FIRE LINES, PLUMBING, SANITARY LINES, ELECTRICAL CONDUITS, ETC. CORE DRILLING AFTER ERECTION OF THE WALL MUST NOT BE PERFORMED WITHOUT THE APPROVAL OF THE ARCHITECT AND ENGINEER.
 - SEE ARCH'L FOR DOOR & WINDOW SCHEDULE. COORDINATE WINDOWS & DOOR OPENING SIZE WITH WINDOW & DOOR MANUFACTURER. SUBMIT DOOR & WINDOW SHOP DUGS PRIOR OR WITH TILT-UP PANEL SHOP DUGS.
 - ALL REINF. SHALL BE MID UNLESS NOTED OTHERWISE AS EF. (EACH FACE).
 - SPECIALTY ENGINEER TO PROVIDE SIGNED AND SEALED CALCULATIONS FOR TILT-UP PANELS.

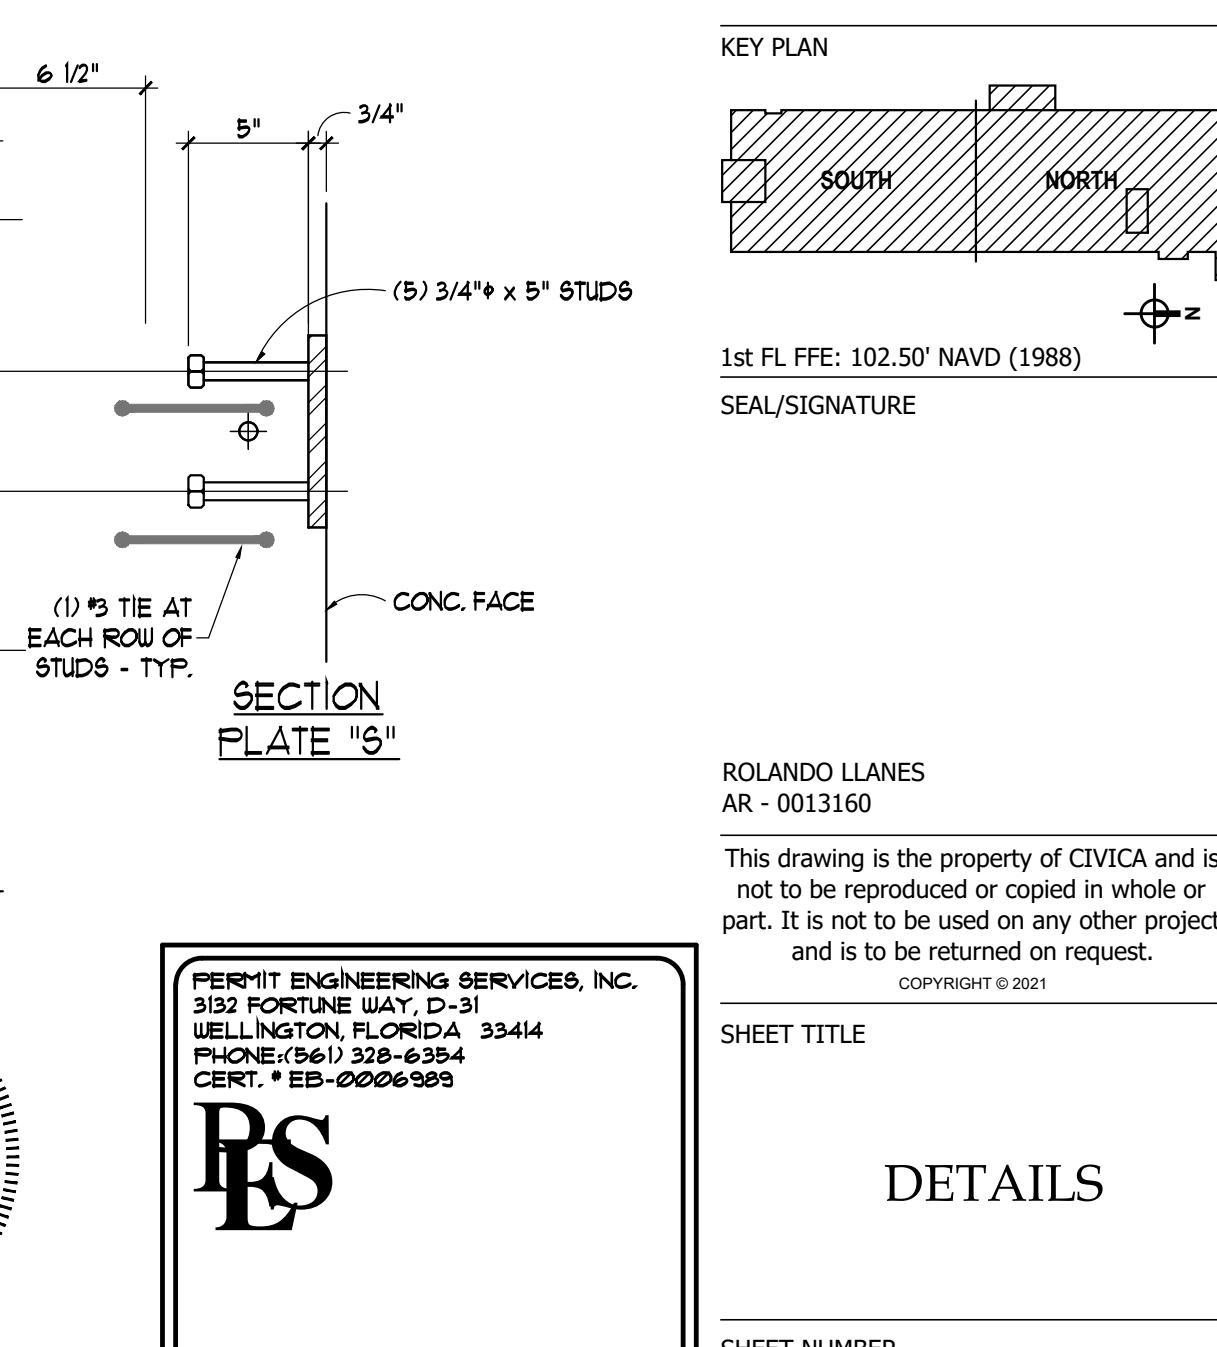

CONNECTING PANEL SCHEDULE		
PANEL JOINTS BETWEEN	MAX. PLATE SPACING	
P-3 P-4	6'-0" o.c.	
P-5 P-6	6'-0" o.c.	
P-7 P-8	6'-0" o.c.	
P-9 P-10	6'-0" o.c.	
P-11 P-12	6'-0" o.c.	
P-13 P-20	6'-0" o.c.	
P-25 P-26	6'-0" o.c.	
P-27 P-28	6'-0" o.c.	
P-29 P-30	6'-0" o.c.	
P-31 P-32	6'-0" o.c.	
P-33 P-34	6'-0" o.c.	

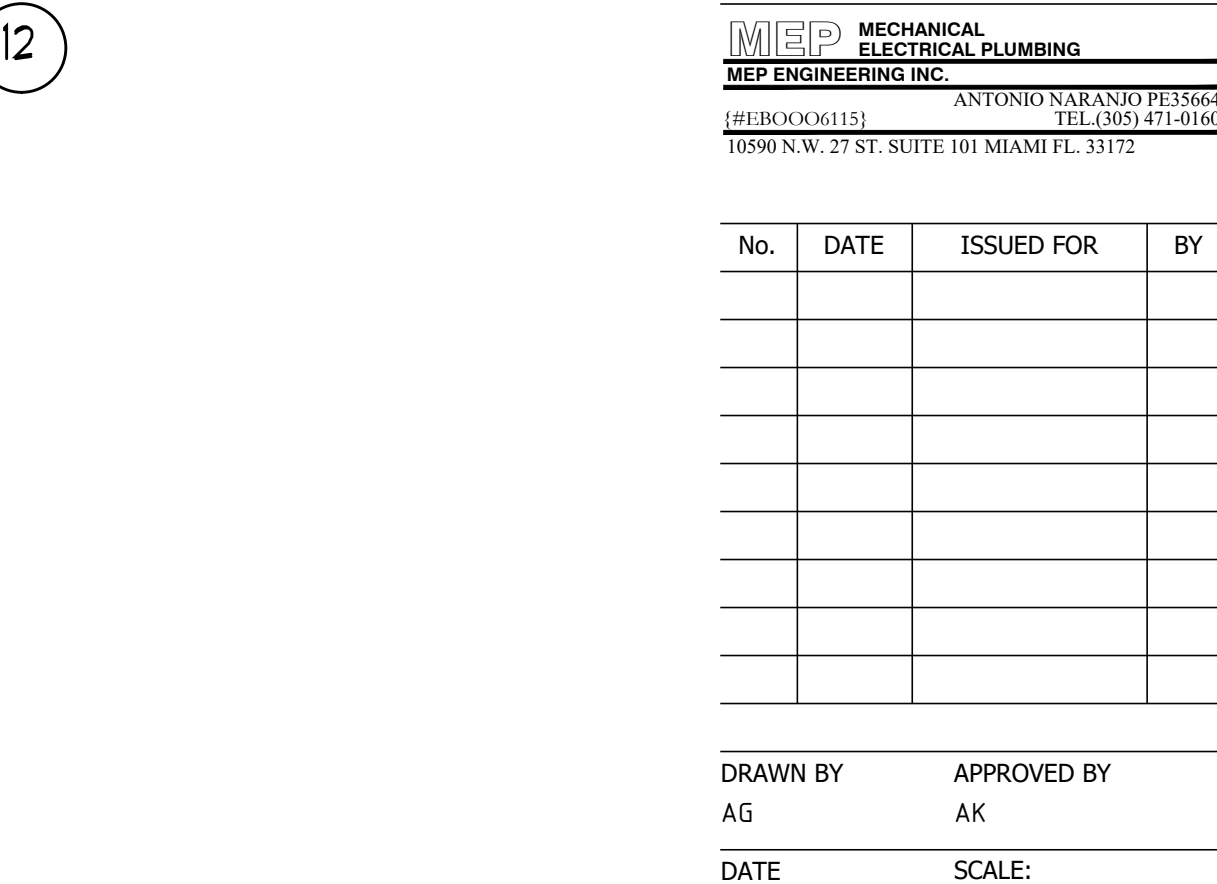

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PROJECT:
**MATER DAVENPORT
CHARTER SCHOOL
(PHASE-1)**

Ronald Reagan Pkwy.
Davenport, FL 33896

PARCEL ID:
27-26-12-0000000-14220
27-26-12-0000000-12010

APPLICANT:
SCHOOL
DEVELOPMENT HC, LLC
6457 Sunset Dr.
Miami, FL 33143

ISSUED FOR:
PERMIT SUBMITTAL

CIVICA PROJECT No :
210122

CONSULTANTS:

KPMFranklin
ENGINEERS & PLANNERS - SURVEYORS
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CERT. # EB-00000000
Albert Kwan, # 55185

MEP MECHANICAL
ELECTRICAL PLUMBING
ENGINEERING INC.
(#EBC0006115)
ANTONIO NARANJO PLESSER
TEL: (305) 471-0100
10590 N.W. 27 ST. SUITE 101 MIAMI FL 33172

No.	DATE	ISSUED FOR	BY

DRAWN BY: AG
APPROVED BY: AK

DATE: 07/21/2021
SCALE: AS SHOWN

KEY PLAN

1st FL FFE: 102.50' NAVD (1988)
SEAL/SIGNATURE

ROLANDO LLANES
AR - 0013160

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SHEET NUMBER

S-6.0