

**APRIL** . 2024

BENUE STATE UNIVERSAL BASIC
EDUCATION BOARD,
PHYSICAL PLANNING AND TECHNICAL
SERVICES DEPARTMENT




OUR
DREAM
BLOCK
OF
CLASSROOMS
AND
LIBRARIES

BENUE STATE UNIVERSAL BASIC EDUCATION BOARD, MAKURDI






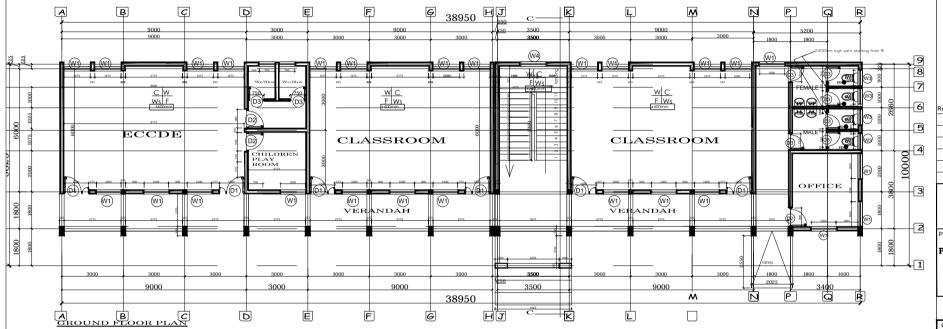

#### NOTES

- 1. Do not measure or scale drawings.
- 2. Dimensions shall be read out from call-outs on drawings.
- 3. Any discripancies between the drawing and other specifications should be brought to the attention of the Architect.
- 4. Copyright or reproduction of this drawings in any format without the consent of the designer is prohibited.

Revision

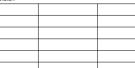



Project

PROPOSED PROTOTYPE BLOCK OF 4-CLASSROOMS, 2-LIBRARIES, 3-OFFICES, STORE AND 10NO TOILETS.

Client:

UNIVERSAL BASIC EDUCATION COMMISSION (UBEC)/BENUE STATE UNIVERSAL BASIC EDUCATION BOARD (SUBEB).

Sheet tiltle:

GROUND FLOOR PLAN

DESIGNED: Arc. ORKOH, D. D. (MNIA)

DRAWN: TSE, A.A. (Arc. )


CHECKED: Arc. ORKOH, D.D. (MNIA)


1,105


SCALE: 1:125

DATE: APRIL, 2024

١

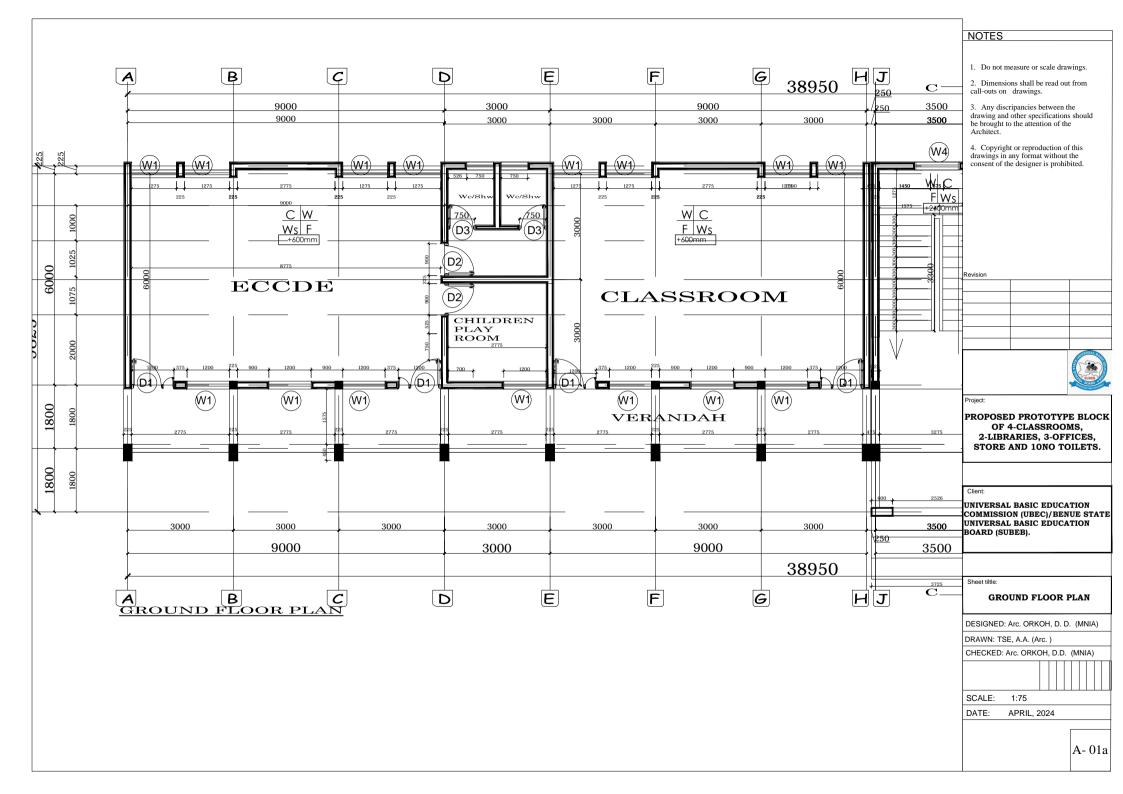

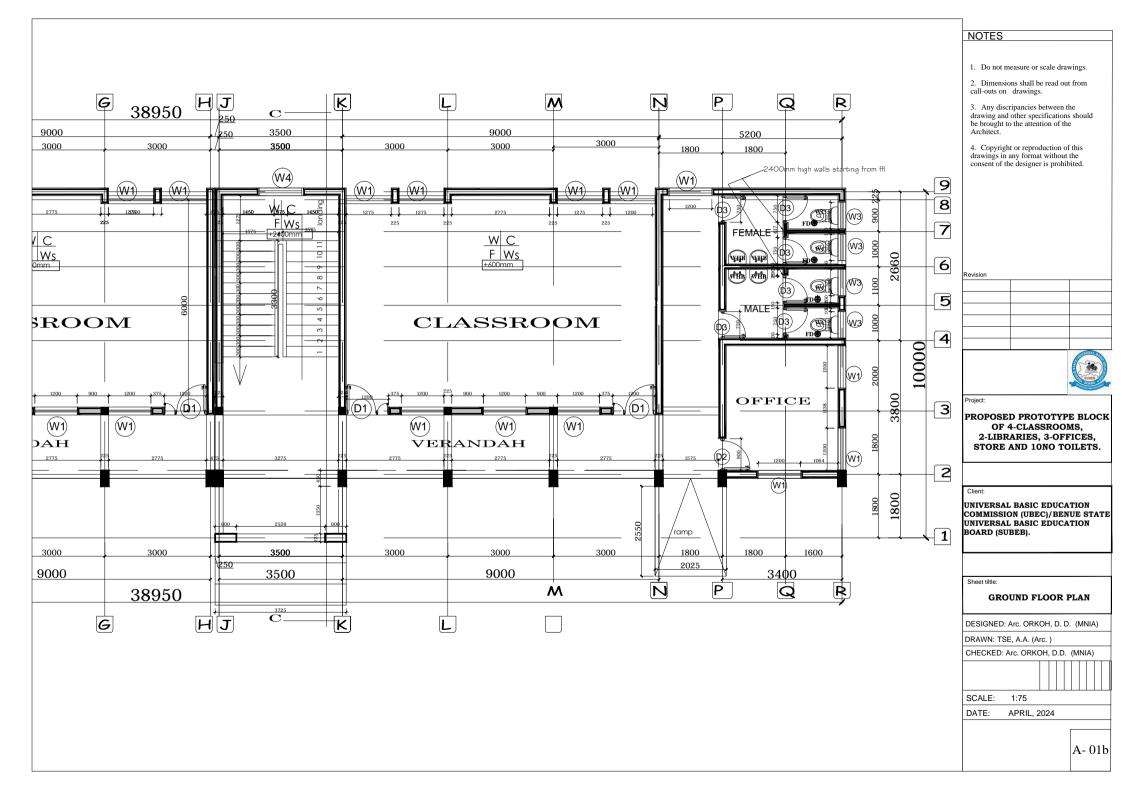

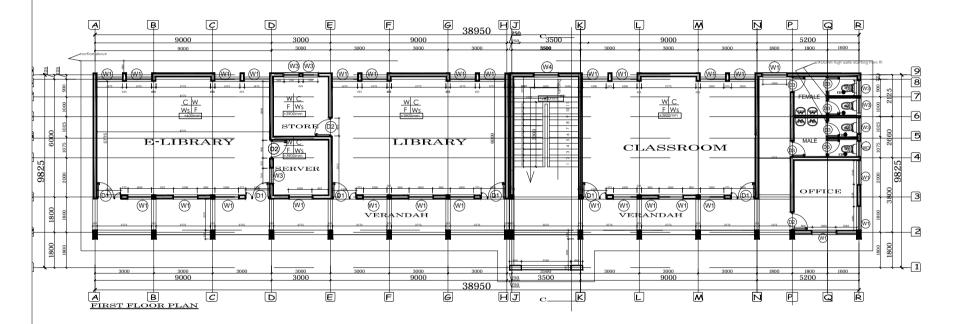

#### NOTES

- 1. Do not measure or scale drawings.
- 2. Dimensions shall be read out from call-outs on drawings.
- 3. Any discripancies between the drawing and other specifications should be brought to the attention of the Architect.
- 4. Copyright or reproduction of this drawings in any format without the consent of the designer is prohibited.

Revision			



Projec

PROPOSED PROTOTYPE BLOCK OF 4-CLASSROOMS, 2-LIBRARIES, 3-OFFICES, STORE AND 10NO TOILETS.

Client:

UNIVERSAL BASIC EDUCATION COMMISSION (UBEC)/BENUE STATE UNIVERSAL BASIC EDUCATION BOARD (SUBEB).

Sheet tiltle:

FIRST FLOOR PLAN


DESIGNED: Arc. ORKOH, D. D. (MNIA)


DRAWN: TSE, A.A. (Arc. )


CHECKED: Arc. ORKOH, D.D. (MNIA)

SCALE: 1:125

DATE: APRIL, 2024

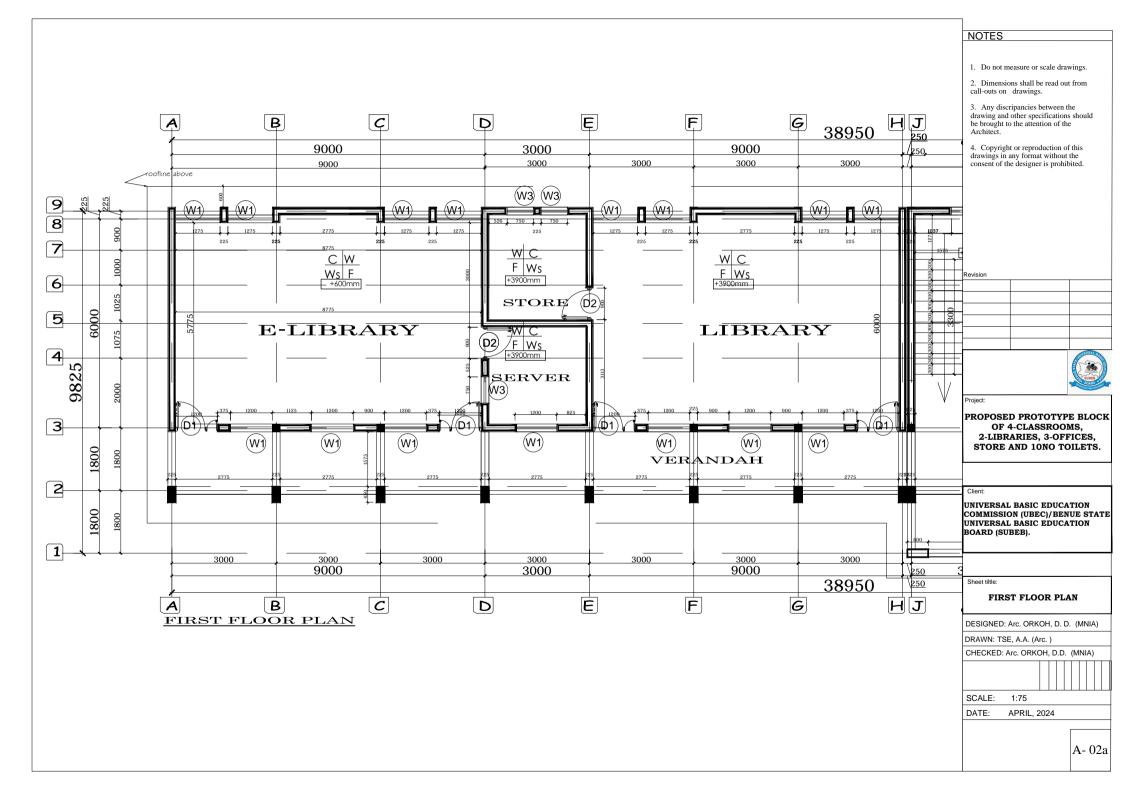

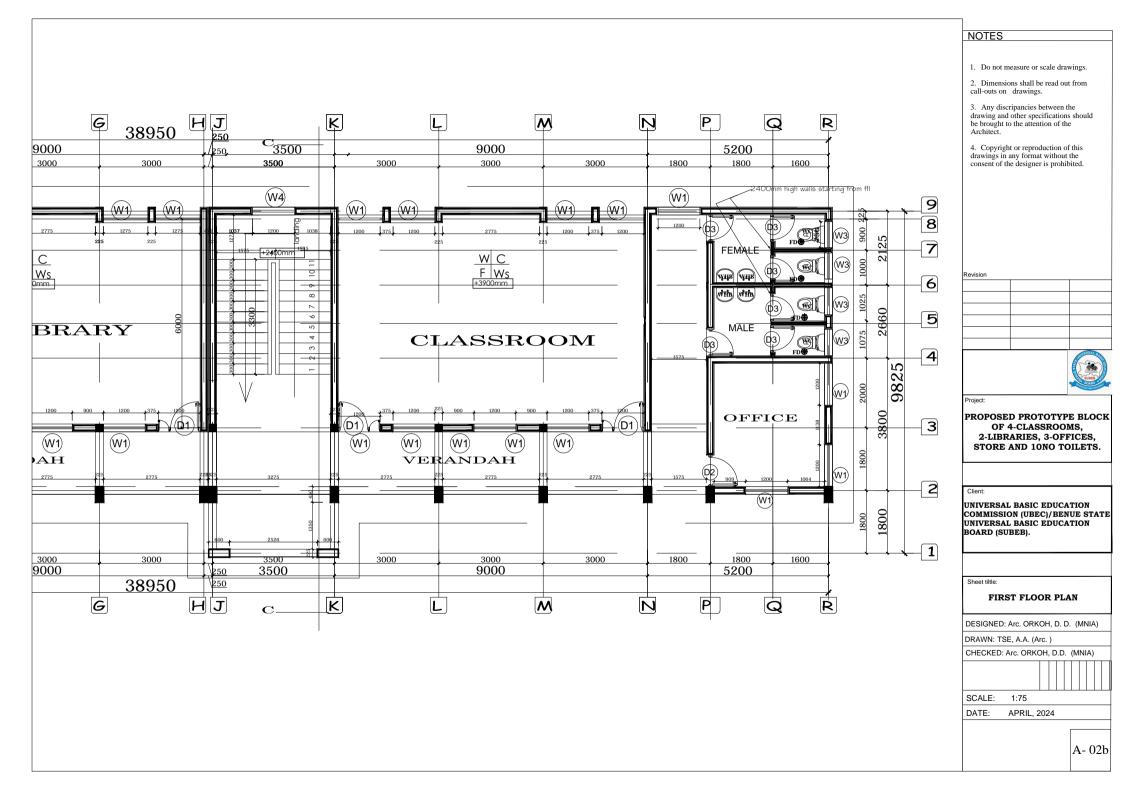

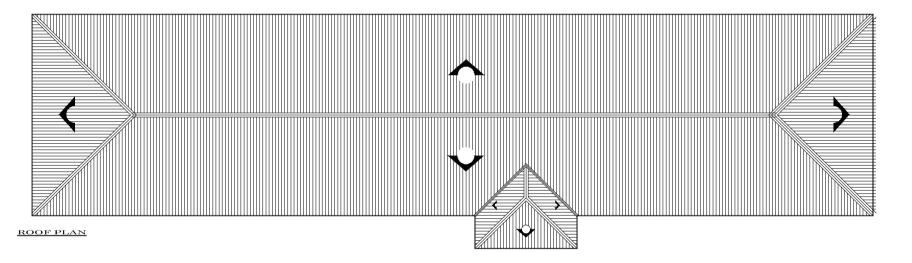

#### NOTES

- Do not measure or scale drawings.
- 2. Dimensions shall be read out from call-outs on drawings.
- 3. Any discripancies between the drawing and other specifications should be brought to the attention of the Architect.
- 4. Copyright or reproduction of this drawings in any format without the consent of the designer is prohibited.

Revision			



Proje

PROPOSED PROTOTYPE BLOCK OF 4-CLASSROOMS, 2-LIBRARIES, 3-OFFICES, STORE AND 10NO TOILETS.

Client:

UNIVERSAL BASIC EDUCATION COMMISSION (UBEC)/BENUE STATE UNIVERSAL BASIC EDUCATION BOARD (SUBEB).

Sheet tiltle:

ROOF PLAN


DESIGNED: Arc. ORKOH, D. D. (MNIA)

DRAWN: TSE, A.A. (Arc. )

CHECKED: Arc. ORKOH, D.D. (MNIA)


SCALE: 1:125

DATE: APRIL, 2024

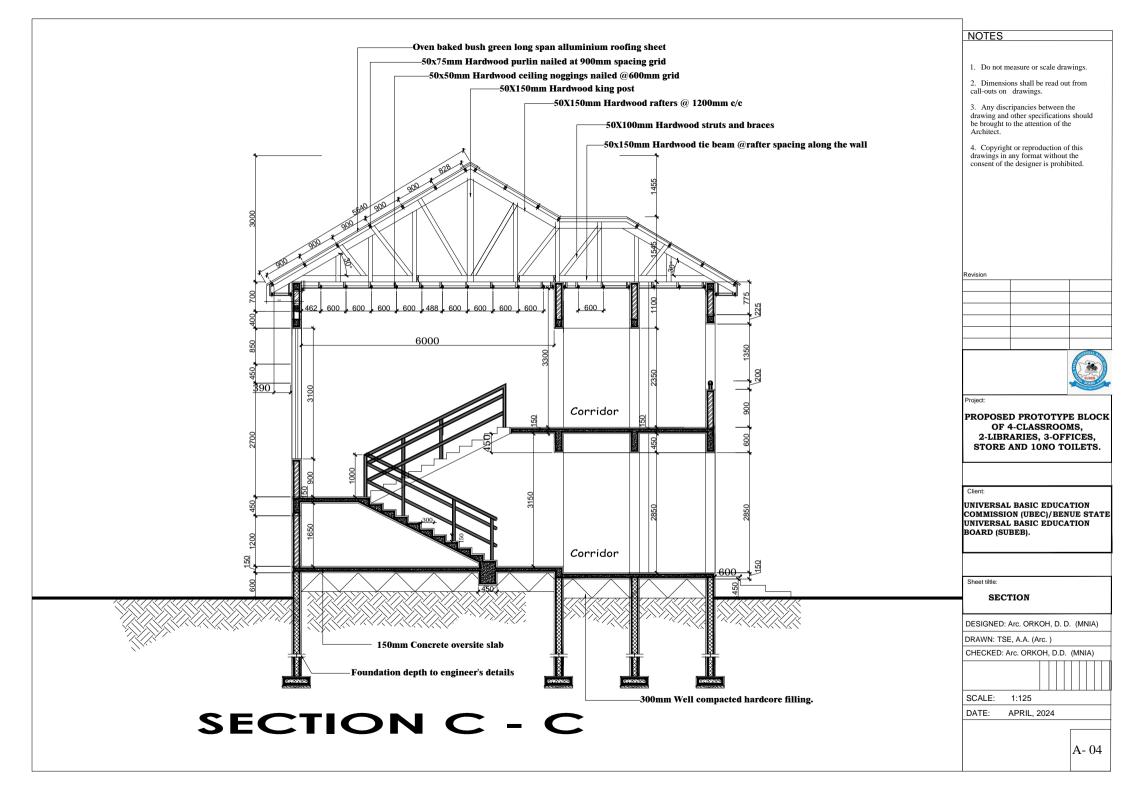

## 1. Do not measure or scale drawings. 2. Dimensions shall be read out from call-outs on drawings. 3. Any discripancies between the drawing and other specifications should be brought to the attention of the Architect. 4. Copyright or reproduction of this drawings in any format without the consent of the designer is prohibited. Revision PROPOSED PROTOTYPE BLOCK OF 4-CLASSROOMS. 2-LIBRARIES, 3-OFFICES, STORE AND 10NO TOILETS. Client: APPROACH ELEVATION UNIVERSAL BASIC EDUCATION COMMISSION (UBEC)/BENUE STATE UNIVERSAL BASIC EDUCATION BOARD (SUBEB). Sheet tiltle: FRONT ELEVATION DESIGNED: Arc. ORKOH, D. D. (MNIA) DRAWN: TSE, A.A. (Arc. ) CHECKED: Arc. ORKOH, D.D. (MNIA) SCALE: 1:125 DATE: APRIL, 2024 A- 05

NOTES

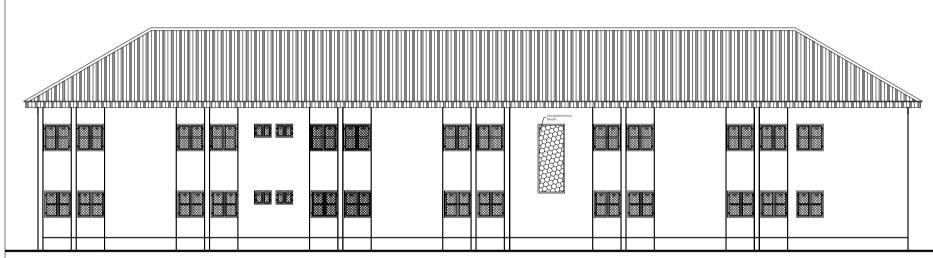

BACK ELEVATION

#### NOTES

- 1. Do not measure or scale drawings.
- 2. Dimensions shall be read out from call-outs on drawings.
- 3. Any discripancies between the drawing and other specifications should be brought to the attention of the Architect.
- 4. Copyright or reproduction of this drawings in any format without the consent of the designer is prohibited.

Revision			



Project:

PROPOSED PROTOTYPE BLOCK OF 4-CLASSROOMS, 2-LIBRARIES, 3-OFFICES, STORE AND 10NO TOILETS.

Client:

UNIVERSAL BASIC EDUCATION COMMISSION (UBEC)/BENUE STATE UNIVERSAL BASIC EDUCATION BOARD (SUBEB).

Sheet tiltle:

REAR ELEVATION


DESIGNED: Arc. ORKOH, D. D. (MNIA)


DRAWN: TSE, A.A. (Arc. )

CHECKED: Arc. ORKOH, D.D. (MNIA)

SCALE: 1:125

DATE: APRIL, 2024

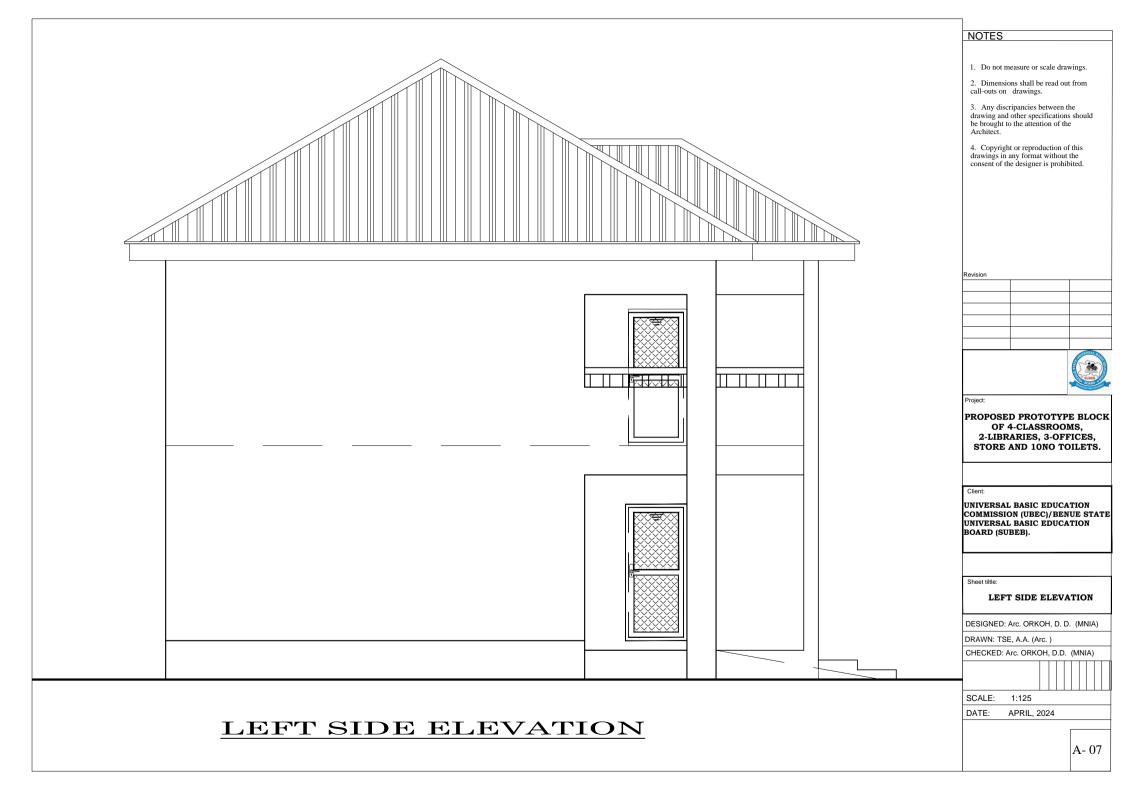

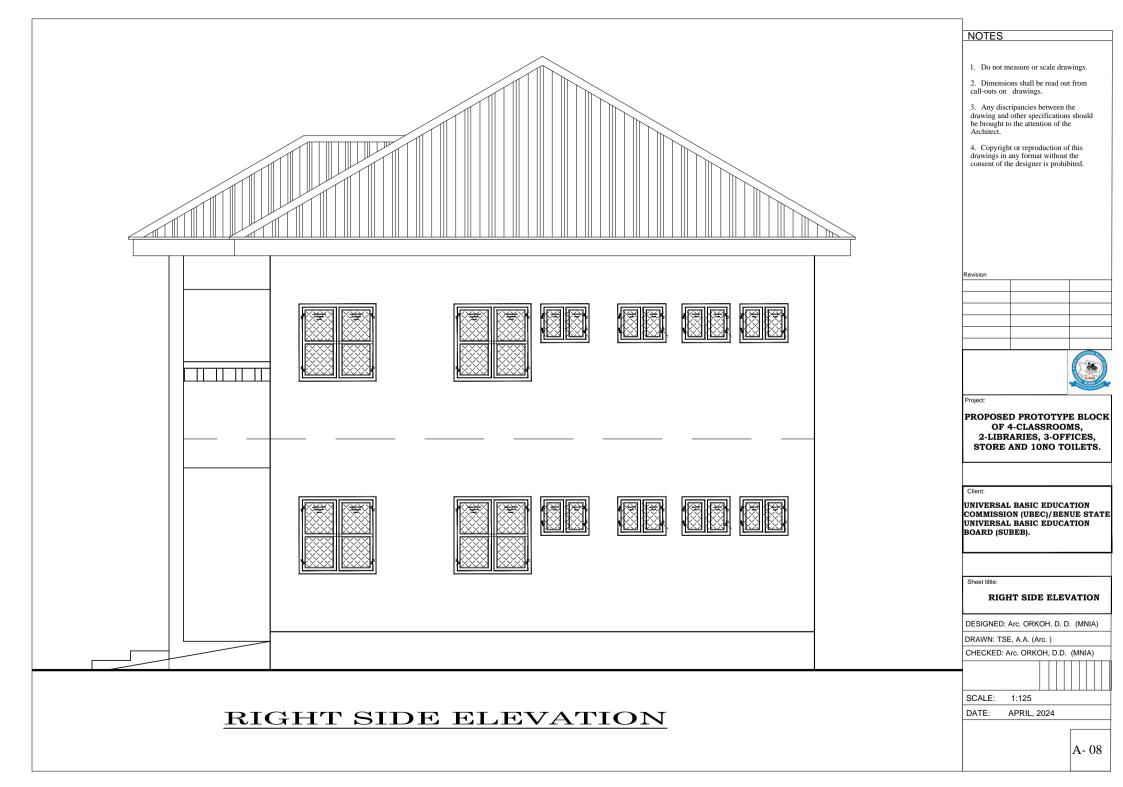

# DOORS & WINDOWS SCHEDULE.

PLAN CODE	D1	D2	W1	W3
DIAGRAM				750
DIMENSION	1200mmX2100mm	900mmX2100mm	1200mmX1200mm	750mmX600mm
DESCRIPTION	Purpose made steel double/single leave doors hinged on steel frame of 40x40x1.2mm square pipes and shutters of 80x40x1.2mm rectangular pipes covered with <b>checker plates</b> of 1.2mm gauge and painted to architect's specification		Purpose made steel casement windows hinged on steel frame of 40x40x1.2mm square pipes and shutters of 40x25x1.2mm rectangular pipes covered with <b>checker plates</b> of 1.2mm gauge with 25mmX25mm hollow square pipe burglary proof welded to window steel frame and painted to architect's specification	
No. REQUIRED	12	6	66	10

#### NOTES

- 1. Do not measure or scale drawings.
- 2. Dimensions shall be read out from call-outs on drawings.
- 3. Any discripancies between the drawing and other specifications should be brought to the attention of the Architect.
- Copyright or reproduction of this drawings in any format without the consent of the designer is prohibited.

Revision			



Proje

PROPOSED PROTOTYPE BLOCK OF 4-CLASSROOMS, 2-LIBRARIES, 3-OFFICES, STORE AND 10NO TOILETS.

Client:

UNIVERSAL BASIC EDUCATION COMMISSION (UBEC)/BENUE STATE UNIVERSAL BASIC EDUCATION BOARD (SUBEB).

Sheet tiltle:

DOORS AND WINDOWS SCHEDULE

DESIGNED: Arc. ORKOH, D. D. (MNIA)

DRAWN: TSE, A.A. (Arc. )


CHECKED: Arc. ORKOH, D.D. (MNIA)


ED. AIC. ORROTI, D.D. (WINIA)

SCALE: 1:125

DATE: APRIL, 2024

### DOORS AND WINDOWS DETAILS

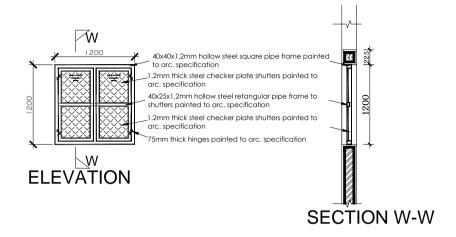


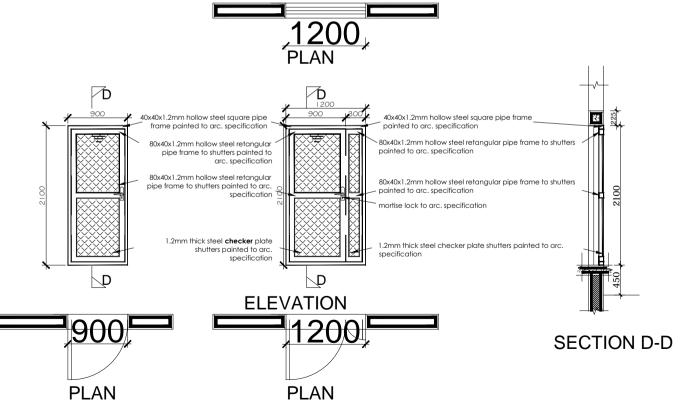

#### NOTES

- 1. Do not measure or scale drawings.
- 2. Dimensions shall be read out from call-outs on drawings.
- 3. Any discripancies between the drawing and other specifications should be brought to the attention of the Architect.
- 4. Copyright or reproduction of this drawings in any format without the consent of the designer is prohibited.

Revision

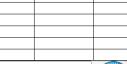



Proj

PROPOSED PROTOTYPE BLOCK OF 4-CLASSROOMS, 2-LIBRARIES, 3-OFFICES, STORE AND 10NO TOILETS.

Client:

UNIVERSAL BASIC EDUCATION COMMISSION (UBEC)/BENUE STATE UNIVERSAL BASIC EDUCATION BOARD (SUBEB).

Sheet tiltle:

#### DOORS AND WINDOWS DETAILS

DESIGNED: Arc. ORKOH, D. D. (MNIA)

DRAWN: TSE, A.A. (Arc. )

CHECKED: Arc. ORKOH, D.D. (MNIA)



SCALE: 1:125

DATE: APRIL, 2024

## Schedule of Finishes.

code	description	code	description	code	description
R	ROOF FINISHES	EW	EXTERNAL WALLS	F	floor finishes
ROOF COVERING	0.55mm thick oven baked light brown coloured long span aluminum roofing sheets.	WALLS	"BERGER" or any approved high quality EMULSION paint on 12mm thick rendering.	TOILETS  LABORATORIES, ICT, OFFICES & STORES	2X250X250mm vitrified floor tiles on 50mm thick cement /sand screed.  20mm thick terrazzo floor finish on 30mm cement/sand screed.
W	INTERNAL WALLS	C	CEILING FINISHES	WS	WALL SKIRTING
ALL SURFACES. TOILETS	2-coats of emulsion paint on 12mm thick rendering.  6X150X150mm white glazed ceramic tiles on 12mm thick rendering laid to a height of 2100mm.		600mmX600mm celotex ceiling sheets fixed to wooden noggin @ 600mm centers.	LABORATORIES, ICT, OFFICES & STORES	100mm wide terrazoo slates skirting plugged into the wall

#### NOTES

- 1. Do not measure or scale drawings.
- 2. Dimensions shall be read out from call-outs on drawings.
- 3. Any discripancies between the drawing and other specifications should be brought to the attention of the Architect.
- 4. Copyright or reproduction of this drawings in any format without the consent of the designer is prohibited.

Revision			



Proj

PROPOSED PROTOTYPE BLOCK OF 4-CLASSROOMS, 2-LIBRARIES, 3-OFFICES, STORE AND 10NO TOILETS.

Client:

UNIVERSAL BASIC EDUCATION COMMISSION (UBEC)/BENUE STATE UNIVERSAL BASIC EDUCATION BOARD (SUBEB).

Sheet tiltle:

SCHEDULE OF FINISHES

DESIGNED: Arc. ORKOH, D. D. (MNIA)

DRAWN: TSE, A.A. (Arc. )

CHECKED: Arc. ORKOH, D.D. (MNIA)

SCALE: 1:125

DATE: APRIL, 2024