



2-54 Adelaide Street Winnipeg Manitoba R3A 0V7
P 204 947 3775 F 204 947 3789 www.nejmark.mb.ca

PROPOSED CHANGE NOTICE

2445-26

No work is to be done before this matter is finalized and a "Change Order" is issued. This copy to remain with your office. Do not return. Contractor to submit signed letter with price including cost breakdown and change (if any) to construction schedule. Authority having Jurisdiction shall advise of any objections.

TO: QUOREX CONSTRUCTION SERVICES LTD.
1630A 8th Avenue,
Regina, SK S4R 1E5

RE: AURORA FOOD STORE
2000 ANAQUOD ROAD
REGINA, SK
Commission No. 2445

DATE: July 24, 2025

PAGES: 4 (including cover)

RE: HMR POS Station

1.0 ELECTRICAL

- .1 Refer to attached Electrical PCN #11, dated July 23, 2025.
(1 page text, 2 full size drawings E2.4, E5.0)

Distribution:

Sobeys Inc. – Jeff Craig
Sobeys Inc. – Shanwen Hsu
Quorex Construction Services Ltd. – Chris Walbaum
Lavergne Draward & Associates Inc. – Charles Koop
CGM Engineering – Justin Albo
CGM Engineering – Tony Mitousis
CGM Engineering – Brendan Simpson


jeff.craig@sobeys.com
shanwen.hsu@sobeys.com
c.walbaum@quorex.ca
ckoop@ldaeng.ca
justin_albo@cgmeng.ca
tony_mitousis@cgmeng.ca
brendan_simpson@cgmeng.ca

Principal
Kevin Fawley, SAA MRAIC

Project: Aurora Grocery Store
2000 Anaquod Road, Regina, Saskatchewan
Subject: HMR POS Station
Date: 2025.07.23

Subject: HMR POS Station
References: Electrical Drawing E2.4 – Partial Layout - Power
Electrical Drawing E5.0 – Floor Plan - Communications


1. Refer to attached drawing E2.4 for the location of one(1) additional receptacle to serve the HMR POS station. Wire and connect to existing circuit 'H-23' on panel 'H'. The HMR prep area equipment schedule is updated for reference.
2. Refer to attached drawing E5.0 for the location of one(1) additional data outlet to service the HMR POS station.

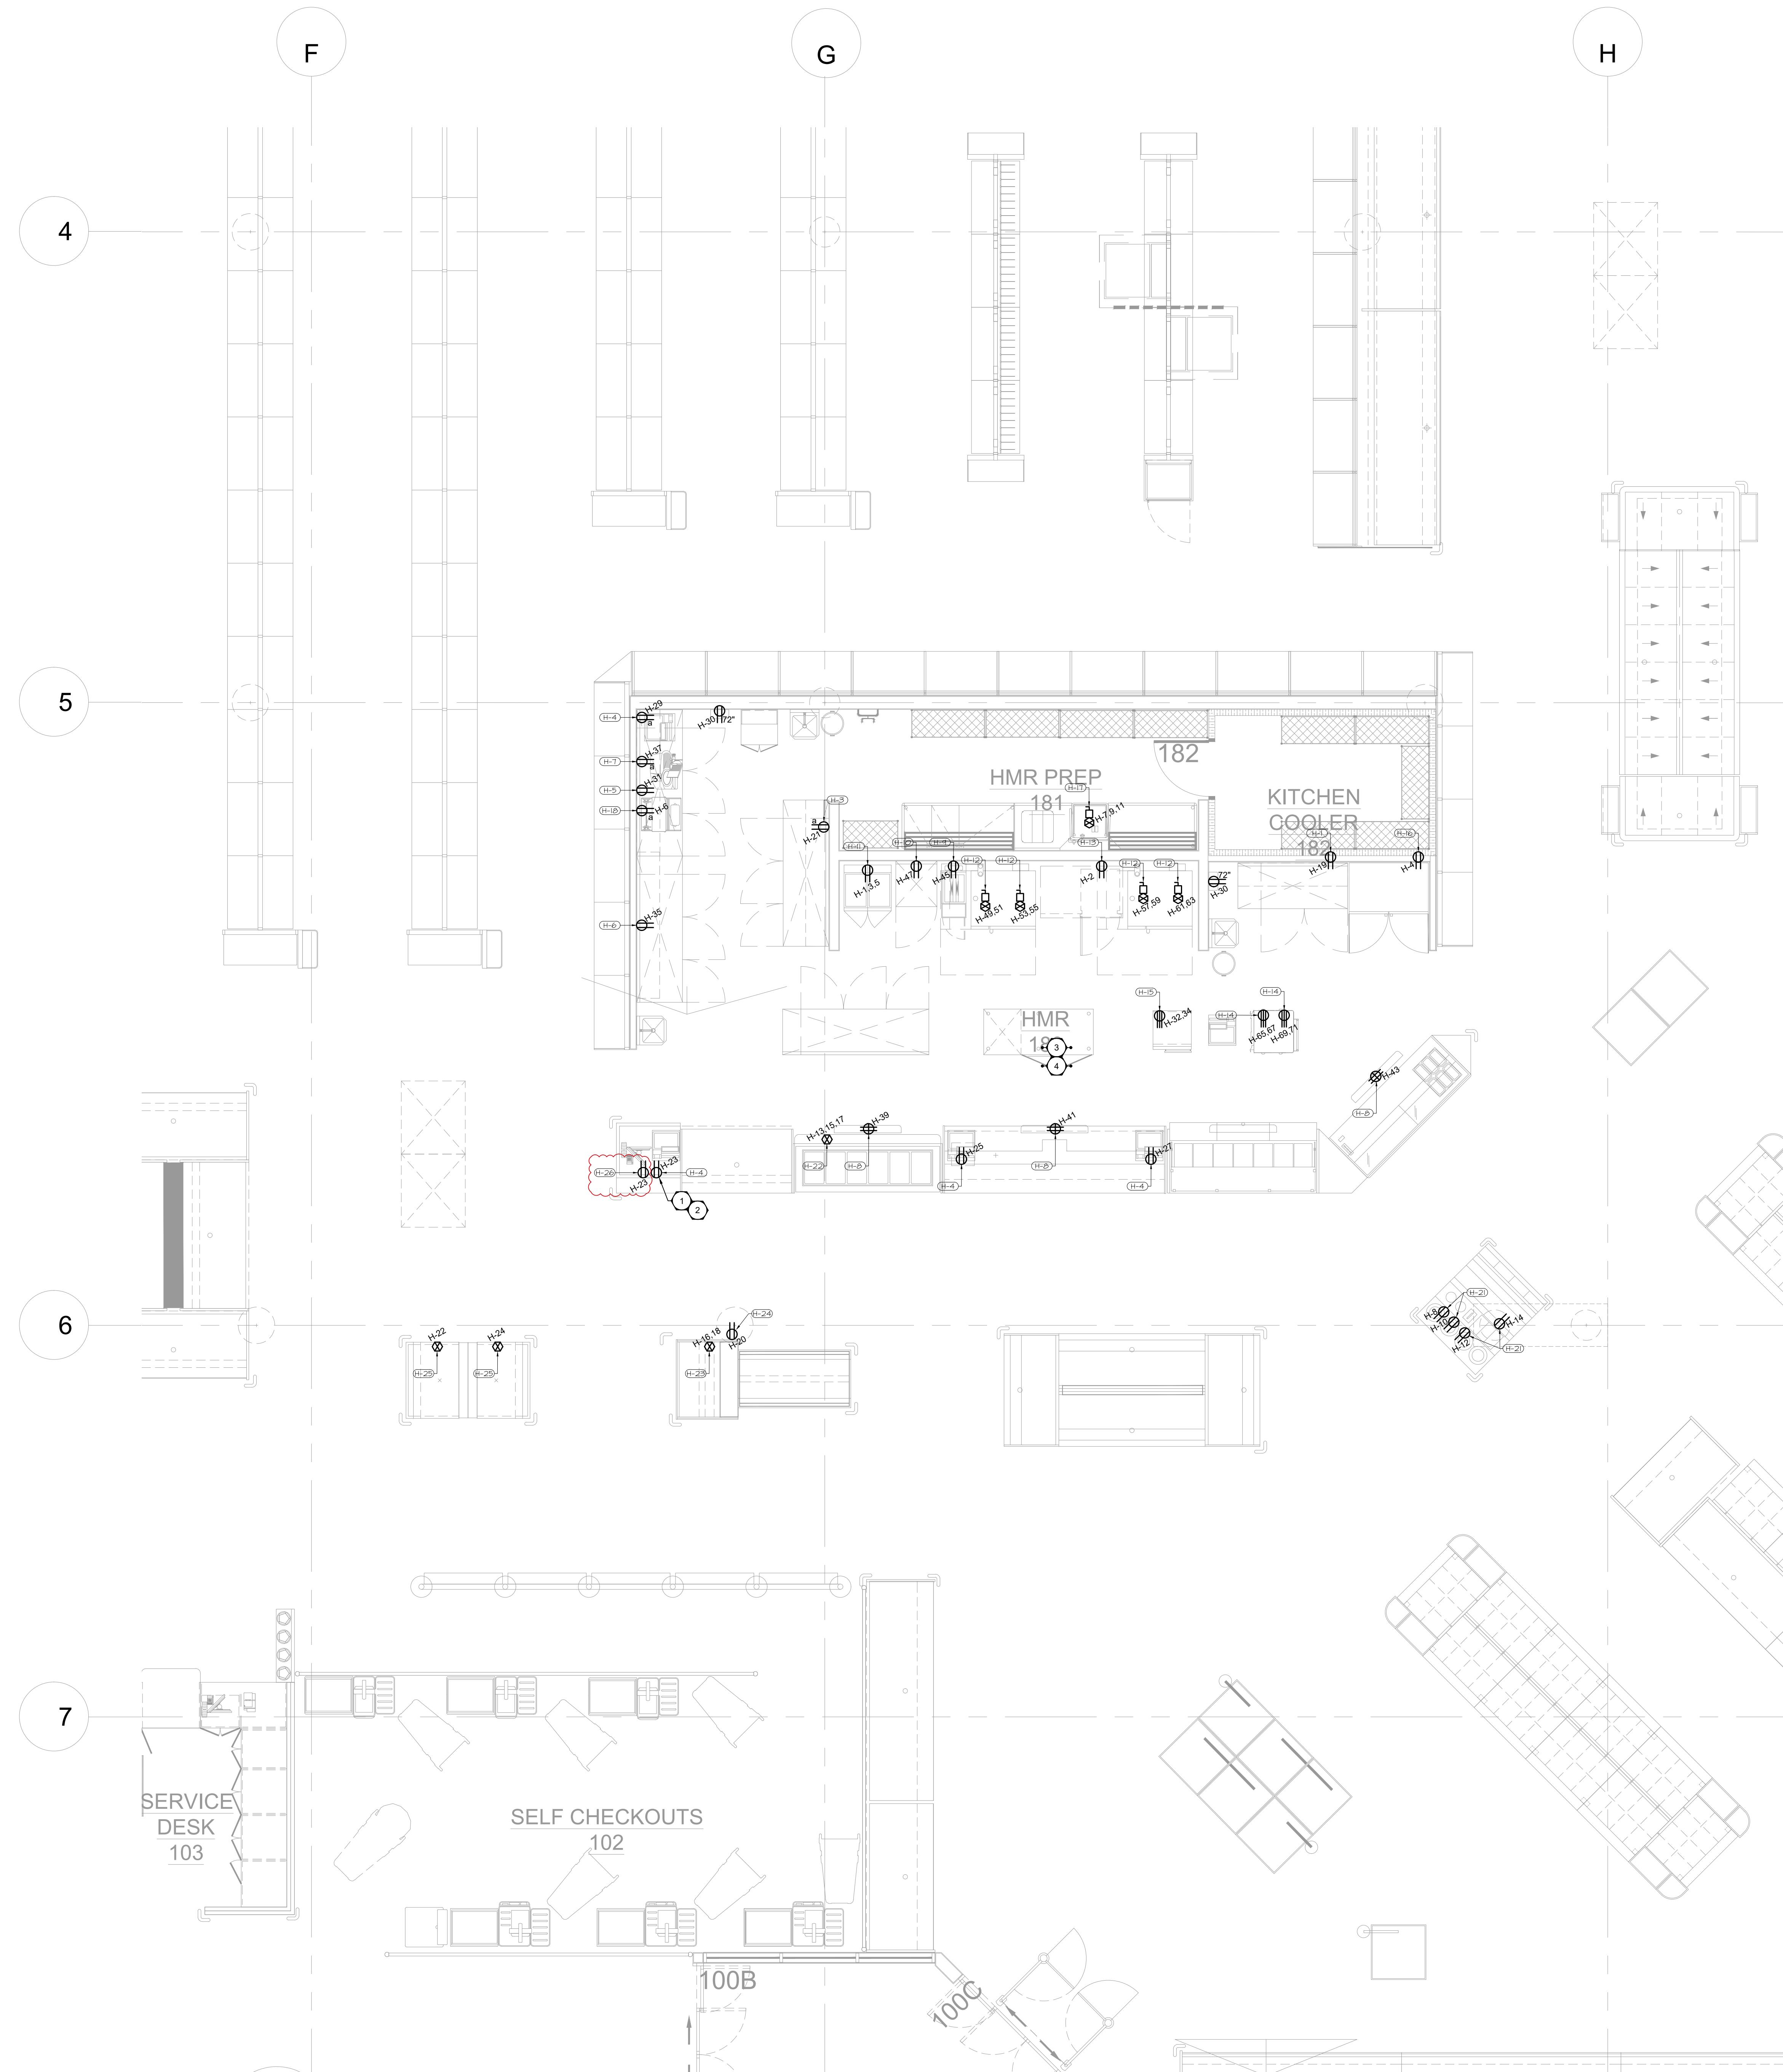

PARTIAL LAYOUT - POWER - HMR

DRAWING NOTES - HMR

- ① PROVIDE PERMANENT TYPE WRITTEN LABEL ON ALL RECEPTACLES NUMBER AND PANEL BOARD NAME WHERE IT IS CONNECTED.
- ② VERIFY MOUNTING HEIGHT AND EXACT LOCATION OF RECEPTACLES AND STUB-UPS. COORDINATE WITH MILL WORK, MECHANICAL AND PLUMBING TRADES AND SCAFFOLDING TRADES AND SAFETY MANAGEMENT PRIOR TO ROUGH-IN.
- ③ COORDINATE FINAL LOCATION AND POWER CONTROL REQUIREMENTS OF ALL EQUIPMENT IN VARIOUS DEPARTMENTS. COORDINATE WITH LIGHTING FIXTURE SUPPLIERS AND MILL WORKS PRIOR TO ROUGH-IN.
- ④ ALL RECEPTACLES WITHIN PREPARATION AREAS (MEAT, SEAFOOD, PRODUCE PREPARATION, ETC.) TO BE WATERPROOF.
- ⑤ PROVIDE 1" DIAMETER CONDUIT AS INDICATED. PRIOR TO CONCRETE POURING, EXAMINE SITE AND CONFIRM ROUTING OF CONDUIT WITH GC AND ALL ASSOCIATED TRADES.

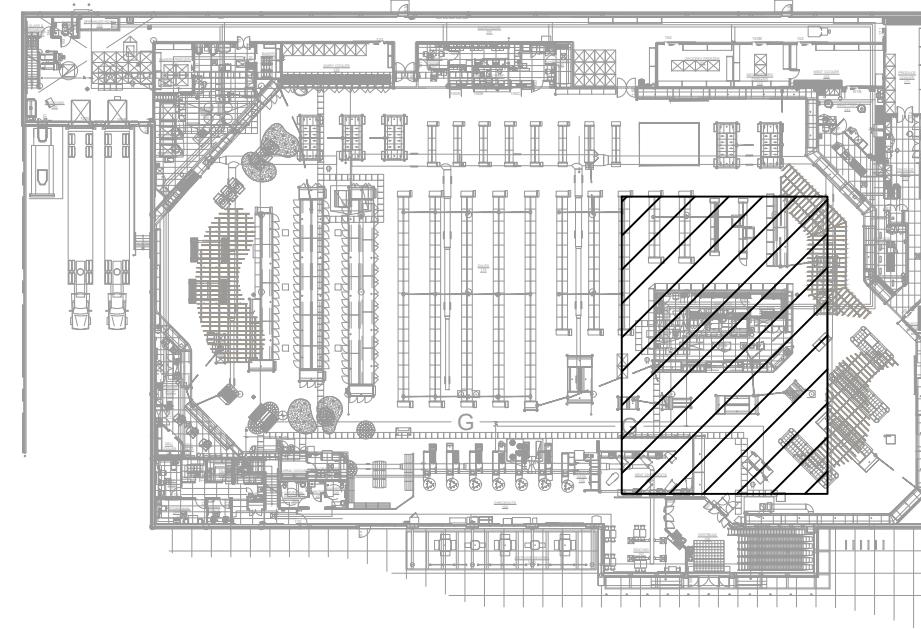

KEY PLAN
E2.4 SCALE: 1/64" = 1'-0"

H.M.R. PREP. AREA EQUIPMENT SCHEDULE

EQUIP #	QTY	EQUIPMENT	CONDUCTORS (CU)	VOLTS	LOAD	BREAKER
H-1	1	6' REFRIGERATOR U/C UNIT	#12	120V-1PH	1.44 KW	15A-1P
H-3	1	RICE COOKER	#12	120V-1PH	1.55 KW	20A-1P
H-4	4	SCALE PRINTER	#12	120V-1PH	240W	15A-1P
H-5	1	8' REFRIGERATOR U/C UNIT	#12	120V-1PH	1.44 KW	15A-1P
H-6	2	8' FREEZER U/C UNIT	#12	120V-1PH	1.6 KW	20A-1P
H-7	1	Slicer	#12	120V-1PH	840W	15A-1P
H-8	3	55" LG TV	#12	120V-1PH	100W	15A-1P
H-9	1	DEEP FRYER (GAS)	#12	120V-1PH	720W	15A-1P
H-10	1	27" FREEZER	#12	120V-1PH	1.44 KW	15A-1P
H-11	1	PITCO RETHERMALIZER (GAS)	#10	208V-3PH	22 A	30A-3P
H-12	4	RATIONAL COMBO OVEN (GAS)	#12	208V-1PH	900W	15A-2P
H-13	1	5' BLAST CHILLER	#12	120V-1PH	13.3 A	15A-1P
H-14	1	DOUBLE DECK TURBO CHEF	#8	208V-1PH	8.32 KW	50A-2P
H-15	1	AMANA OVEN	#10	208V-1PH	5.7 KW	30A-2P
H-16	1	2 DOOR FREEZER	#12	120V-1PH	1.34 KW	15A-1P
H-17	1	DISHWASHER	#6	208V-3PH	53.7 A	60A-3P
H-18	1	WRAPPER	#12	120V-1PH	725W	15A-1P
H-21	4	HOT AND COLD SOUP	#12	120V-1PH	500W	15A-1P
H-22	1	SELF SERVICE HOT FOODS	#4	208V-3PH	52 A	70A-3P
H-23	1	HOT CHICKEN ISLAND	#8	208V-1PH	6.2 KW	40A-2P
H-24	1	MOBILE HOLDING CABINET	#6	120V-1PH	1.8 KW	20A-1P
H-25	2	SNACK BAR	#10	120V-1PH	2.6 KW	30A-1P
H-26	1	POS STATION	#12	120V-1PH	240W	15A-1P

NOTES:
 1. ELECTRICAL CONTRACTOR TO WIRE AND CONNECT ALL KITCHEN EQUIPMENT AS INDICATED. PROVIDE WIRING AND CIRCUIT BREAKERS TO FINAL NAMEPLATE OF THE EQUIPMENT. PROVIDE WIRING AND CIRCUIT BREAKERS FOR ALL EQUIPMENT, CIRCUIT SIZES, AND MOUNTING HEIGHTS PRIOR TO ROUGH-IN.
 2. ELECTRICAL CONTRACTOR TO PROVIDE ALL RELAYS & WIRING AND MAKE ALL CONNECTIONS FOR INTERLOCKING OF ALL EQUIPMENT AS REQUIRED. CONFIRM AND COORDINATE EXACT REQUIREMENTS ON SITE FOR INTERLOCKING.
 3. ELECTRICAL CONTRACTOR TO PROVIDE ALL STARTERS AND DISCONNECT SWITCHES AS REQUIRED.
 4. ELECTRICAL CONTRACTOR TO PROVIDE ALL LINE VOLTAGE CONTROL WIRING AS REQUIRED.
 5. CONTRACTOR TO PROVIDE ALL EQUIPMENT AS LISTED.
 6. QUANTITIES ARE FOR UTILITIES INFORMATION ONLY TO DETERMINE LOADS. CONTRACTOR TO CONFIRM EXACT QUANTITIES AND LOCATIONS WITH THE APPROVED EQUIPMENT PACKAGE AND PLAN.

4	PCN-11	2025.07.23	KC
3	PCN-10	2025.07.23	KC
2	PCN-09	2025.06.25	KC
1	PCN-08	2025.06.13	KC
No.	ISSUED FOR	DATE	BY

DRAWN BY: BS


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CGM
200-698 CORYDON AVE
WINNIPEG, MB R3M 0X9
(204) 272-3255
PROJECT NO: 2428

NEJMARK
ARCHITECT
2-54 Adelaide Street Winnipeg Manitoba R3A 0V7
P 204 947 3775 F 204 947 3789 www.nejmark.mb.ca
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The contractor is to verify dimensions and date noted herein with conditions on the site and is responsible for reporting discrepancies to the Architect for adjustment.

AURORA GROCERY
STORE
2000 ANAQUD ROAD
REGINA, SASKATCHEWAN

SHEET TITLE:
PARTIAL LAYOUT -
POWER
COMMISSION NUMBER:
2445
E2.4

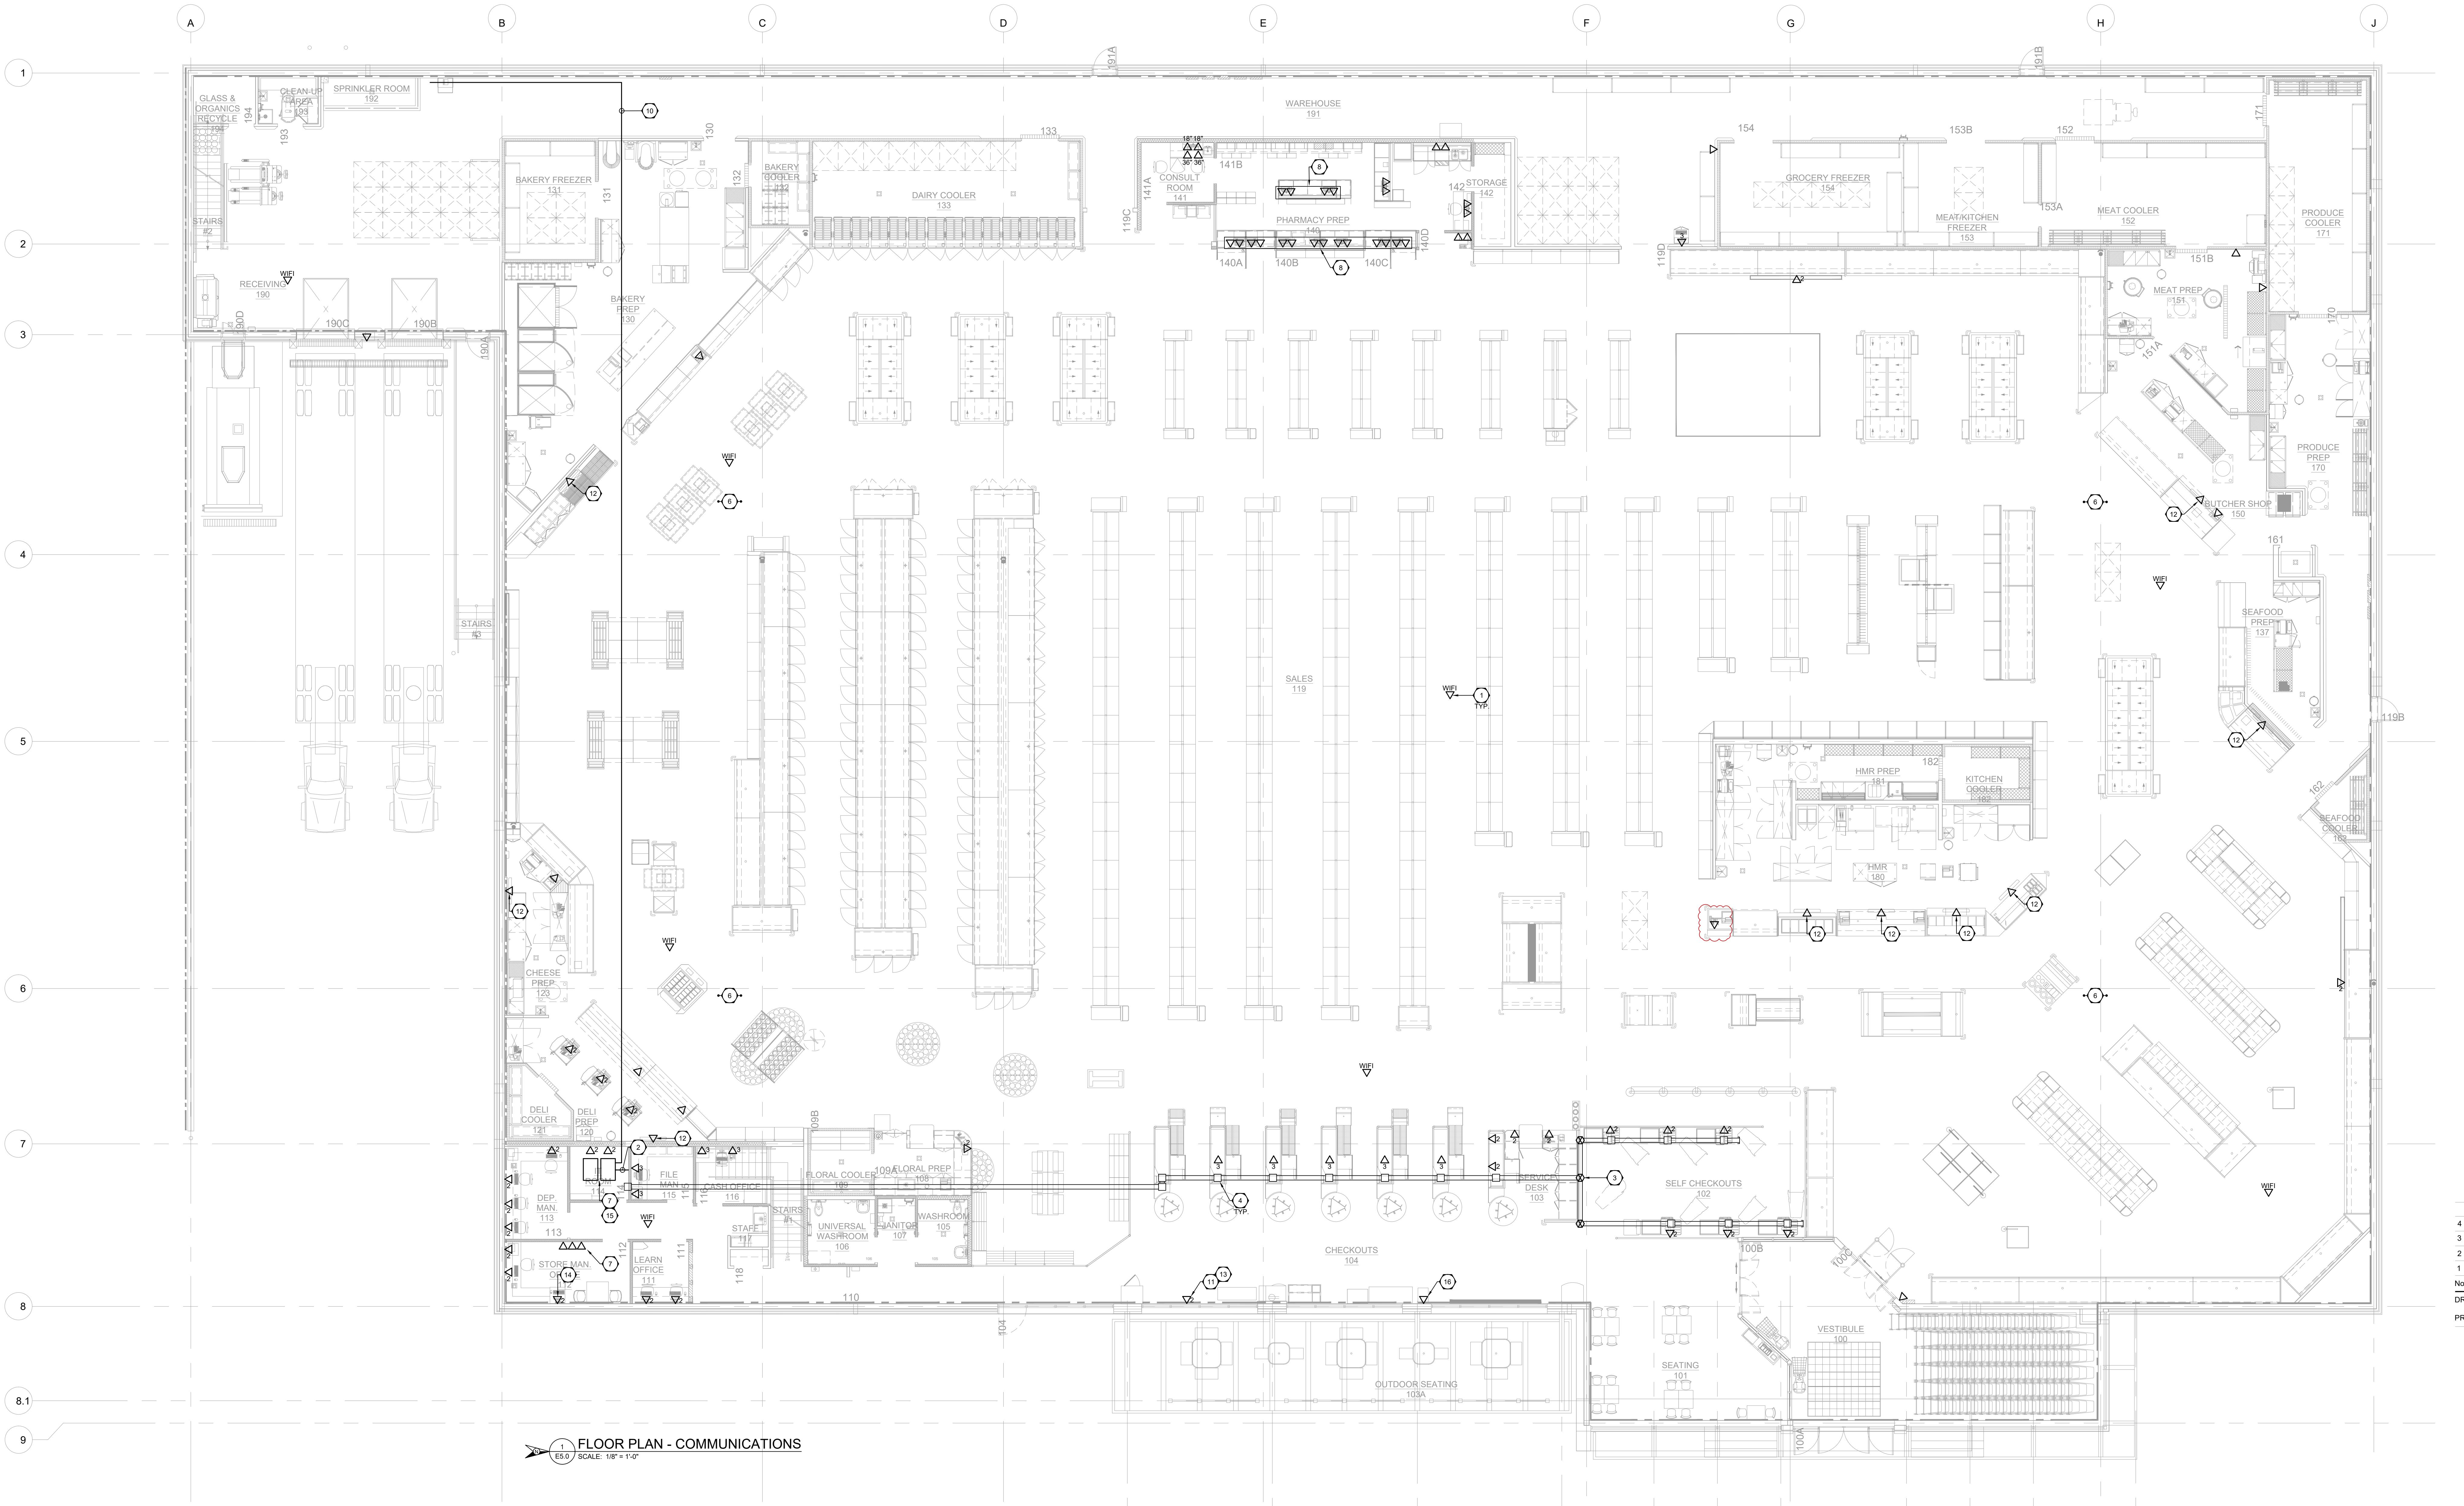

FLOOR PLAN - COMMUNICATIONS
SCALE: 1/8" = 1'-0"

DRAWING NOTES - COMMUNICATIONS

- ① CONFIRM LOCATION WITH SOBEYS I.T. DEPARTMENT WIRELESS SUPPLIER FOR LOCATIONS OF ADDITIONAL DATA POINTS.
- ② CONFIRM DATA RACK REQUIREMENTS WITH SAFEWAY I.T. DEPARTMENT.
- ③ MOUNT DATA OUTLETS ON MILLWORK SURFACE AT 24" A.F.F. COORDINATE WITH SOBEYS PROJECT MANAGER.
- ④ PROVIDE ONE 1/2" RIGID PVC CONDUIT C/W PULL STRING FOR DATA CABLE. THIS CONDUIT WILL FOLLOW CONDUIT FROM CONDUIT UP TO THE ASSOCIATED ELBOW, BOXES AND CONDUITS UP TO THE CONDUIT IN THE SERVICE MEZZANINE. THIS NOTE SHALL BE READ IN CONJUNCTION WITH THE RELEVANT NOTE OF DRAWING NO. E2-0 - MAIN FLOOR POWER DRAWING.
- ⑤ PROVIDE A DEDICATED 4" EMT CONDUIT C/W PULL STRING OR A 1/2" EMT CONDUIT C/W PULL STRING FROM TELEPHONE BACKBOARD HARDWIRE FROM TELEPHONE BACKBOARD IN SERVICE MEZZANINE TO SERVER RACK I.T. ROOM.
- ⑥ MOUNT DATA OUTLET AT SAME HEIGHT AS RECEIPTABLE AND PROVIDE A DEDICATED 4" EMT CONDUIT C/W PULL STRING FROM RECEIPTABLE COORDINATE WITH GG AND DIGITAL BILLBOARD SUPPLIER FOR LOCATION OF R440 PORT ON DIGITAL BILLBOARD.
- ⑦ COORDINATE WITH DATA CONTRACTOR FOR CONFIRMED LOCATION OF REMOTE DATA CABINET. PROVIDE 2" DIAMETER CONDUIT FROM DATA CABINET LOCATION I.T. ROOM.
- ⑧ COORDINATE WITH SAFEWAY REPRESENTATIVE AND FIXTURE SUPPLIER FOR LOCATIONS OF ADDITIONAL DATA POINTS.
- ⑨ CONFIRM DATA RACK REQUIREMENTS WITH SAFEWAY I.T. DEPARTMENT.
- ⑩ MOUNT DATA OUTLETS ON MILLWORK SURFACE AT 24" A.F.F. COORDINATE WITH SOBEYS PROJECT MANAGER.
- ⑪ PROVIDE ONE 1/2" RIGID PVC CONDUIT C/W PULL STRING FOR DATA CABLE. THIS CONDUIT WILL FOLLOW CONDUIT FROM CONDUIT UP TO THE ASSOCIATED ELBOW, BOXES AND CONDUITS UP TO THE CONDUIT IN THE SERVICE MEZZANINE. THIS NOTE SHALL BE READ IN CONJUNCTION WITH THE RELEVANT NOTE OF DRAWING NO. E2-0 - MAIN FLOOR POWER DRAWING.
- ⑫ PROVIDE A DEDICATED 4" EMT CONDUIT C/W PULL STRING OR A 1/2" EMT CONDUIT C/W PULL STRING FROM TELEPHONE BACKBOARD HARDWIRE FROM TELEPHONE BACKBOARD IN SERVICE MEZZANINE TO SERVER RACK I.T. ROOM.
- ⑬ MOUNT DATA OUTLET AT SAME HEIGHT AS RECEIPTABLE AND PROVIDE A DEDICATED 4" EMT CONDUIT C/W PULL STRING FROM RECEIPTABLE COORDINATE WITH GG AND DIGITAL BILLBOARD SUPPLIER FOR LOCATION OF R440 PORT ON DIGITAL BILLBOARD.
- ⑭ MOUNT DATA OUTLET AT SAME HEIGHT AS RECEIPTABLE AND PROVIDE A 2" DIAMETER CONDUIT FROM RECEIPTABLE.
- ⑮ SUPPLY AND INSTALL CAT6 SHIELDED CABLE TO BILLBOARD RACK. BILLBOARD RACK LOCATION COORDINATE WITH GG AND DIGITAL BILLBOARD INSTALLER FOR THE LENGTH OF CABLE REQUIRED FOR CONNECTION TO THE BILLBOARD FROM THE WALL.
- ⑯ PROVIDE TWO RJ45 PORTS IN DATA OUTLET. PROVIDE AND INSTALL CAT6 SHIELDED CABLE FROM DATA OUTLET TO BILLBOARD RACK. BILLBOARD RACK LOCATION COORDINATE WITH GG AND DIGITAL BILLBOARD INSTALLER FOR THE LENGTH OF CABLE REQUIRED FOR CONNECTION TO THE BILLBOARD FROM THE WALL.
- ⑰ PROVIDE ONE 1/2" RIGID PVC CONDUIT C/W PULL STRING FOR DATA CABLE. THIS CONDUIT WILL FOLLOW CONDUIT FROM CONDUIT UP TO THE ASSOCIATED ELBOW, BOXES AND CONDUITS UP TO THE CONDUIT IN THE SERVICE MEZZANINE. THIS NOTE SHALL BE READ IN CONJUNCTION WITH THE RELEVANT NOTE OF DRAWING NO. E2-0 - MAIN FLOOR POWER DRAWING.
- ⑱ PROVIDE AND INSTALL ONE DATA CABINET IN A 3x4' EMT CONDUIT C/W PULL STRING. THIS CONDUIT WILL FOLLOW CONDUIT FROM CONDUIT UP TO THE ASSOCIATED ELBOW, BOXES AND CONDUITS UP TO THE CONDUIT IN THE SERVICE MEZZANINE. THIS NOTE SHALL BE READ IN CONJUNCTION WITH THE RELEVANT NOTE OF DRAWING NO. E2-0 - MAIN FLOOR POWER DRAWING.
- ⑲ MOUNT DATA OUTLET AT SAME HEIGHT AS RECEIPTABLE AND PROVIDE A 2" DIAMETER CONDUIT FROM RECEIPTABLE.
- ⑳ MOUNT DATA OUTLET AT SAME HEIGHT AS RECEIPTABLE AND PROVIDE A 2" DIAMETER CONDUIT FROM RECEIPTABLE.

200-698 CORDON AVE WINNIPEG, MB R3M 0X9 (204) 272-3255 PROJECT NO: 24288

CGM ENGINEERING LTD.

NEJMARK ARCHITECT
2-54 Adelaide Street Winnipeg Manitoba R3A 0V7
P 204 947 3775 F 204 947 3789

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The contractor is to verify dimensions and date noted herein with conditions on the site and is responsible for reporting discrepancies to the Architect for adjustment.

PROJECT TITLE:

AURORA GROCERY STORE
2000 ANAQUD ROAD
REGINA, SASKATCHEWAN

