

No work is to be done before this matter is finalized and a "Change Order" is issued. This copy to remain with your office. Do not return. Contractor to submit signed letter with price including cost breakdown and change (if any) to construction schedule. Authority having Jurisdiction shall advise of any objections.

TO: QUOREX CONSTRUCTION SERVICES LTD.
1630A 8th Avenue,
Regina, SK S4R 1E5

RE: AURORA FOOD STORE
2000 ANAQUOD ROAD
REGINA, SK
Commission No. 2445

DATE: April 24, 2025

PAGES: 7 (including cover)

RE: Electrical Revisions

1.0 ELECTRICAL

- .1 Refer to attached Electrical PCN #2, dated April 23, 2025.
(1 page text, 5 full sized drawings, E0.1, E0.2, E0.3 E1.0, E3.0)

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Principal
Kevin Fawley, SAA MRAIC

Project: Aurora Grocery Store
2000 Anaquod Road, Regina, Saskatchewan
Subject: General Revisions
Date: 2025.04.23

Subject: Single Line Revisions
References: Electrical Drawing 2/E0.1 – Single Line Diagram


1. Refer to attached drawing 2/E0.1 for the removal of the service entrance splitter. Provide credit to the owner for any electrical items no longer required because of this change.

Subject: Lighting Revisions
References: Electrical Drawing E0.2 – Schedules
Electrical Drawing E0.3 - Schedules
Electrical Drawing E1.0 - Lighting


2. Refer to attached drawing E1.0 for the location of two(2) dock lights within 'Receiving 190'. The luminaire schedule on drawing E0.3 has been updated to include a Type F dock light fixture. Provide, wire and connect one(1) 15A-1P circuit breaker on panel '2L' for dock lights as required.
3. Refer to attached drawing 3/E1.0. One(1) Type LA fixture is replaced with one(1) Type N fixture in the 'Staff Lounge 201'.

Subject: Exterior Emergency Lighting
References: Electrical Drawing E3.0 – Life Safety

4. Refer to attached drawing E3.0 for the location of an additional weatherproof emergency remote head covering the exterior passageway from doors 190A and 119A.

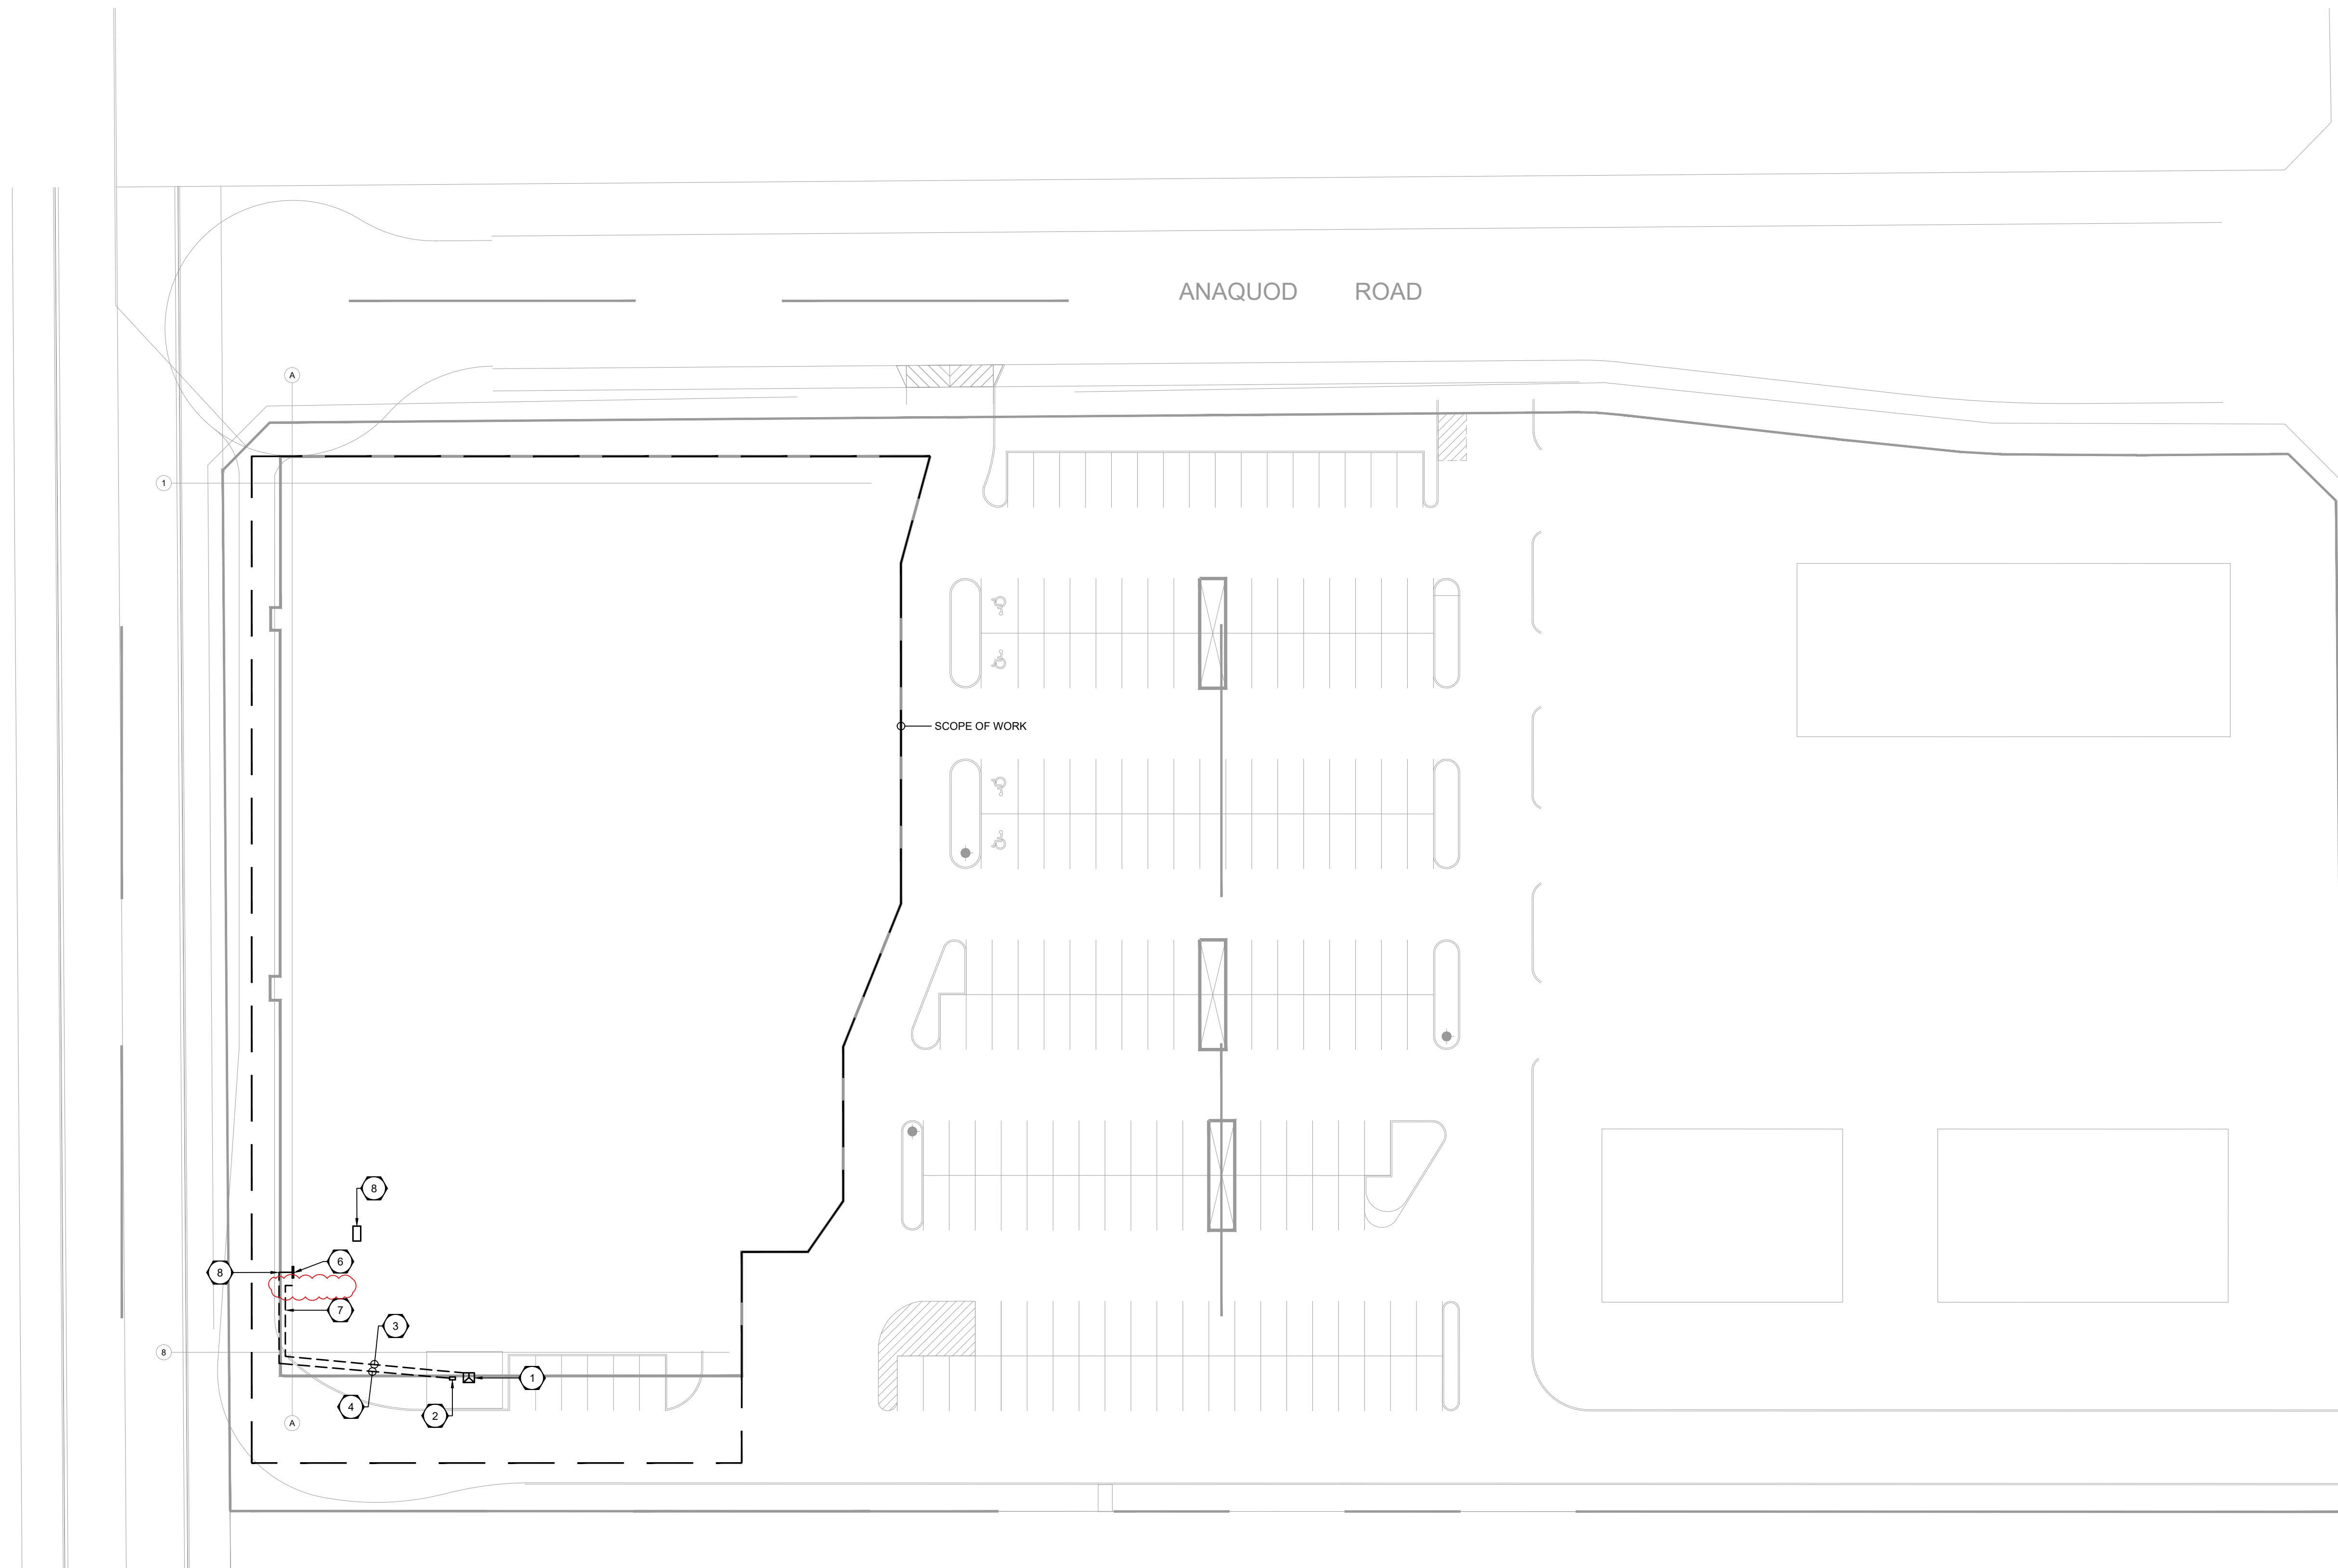

SITE PLAN
E0.1 SCALE: 1/32" = 1'-0"

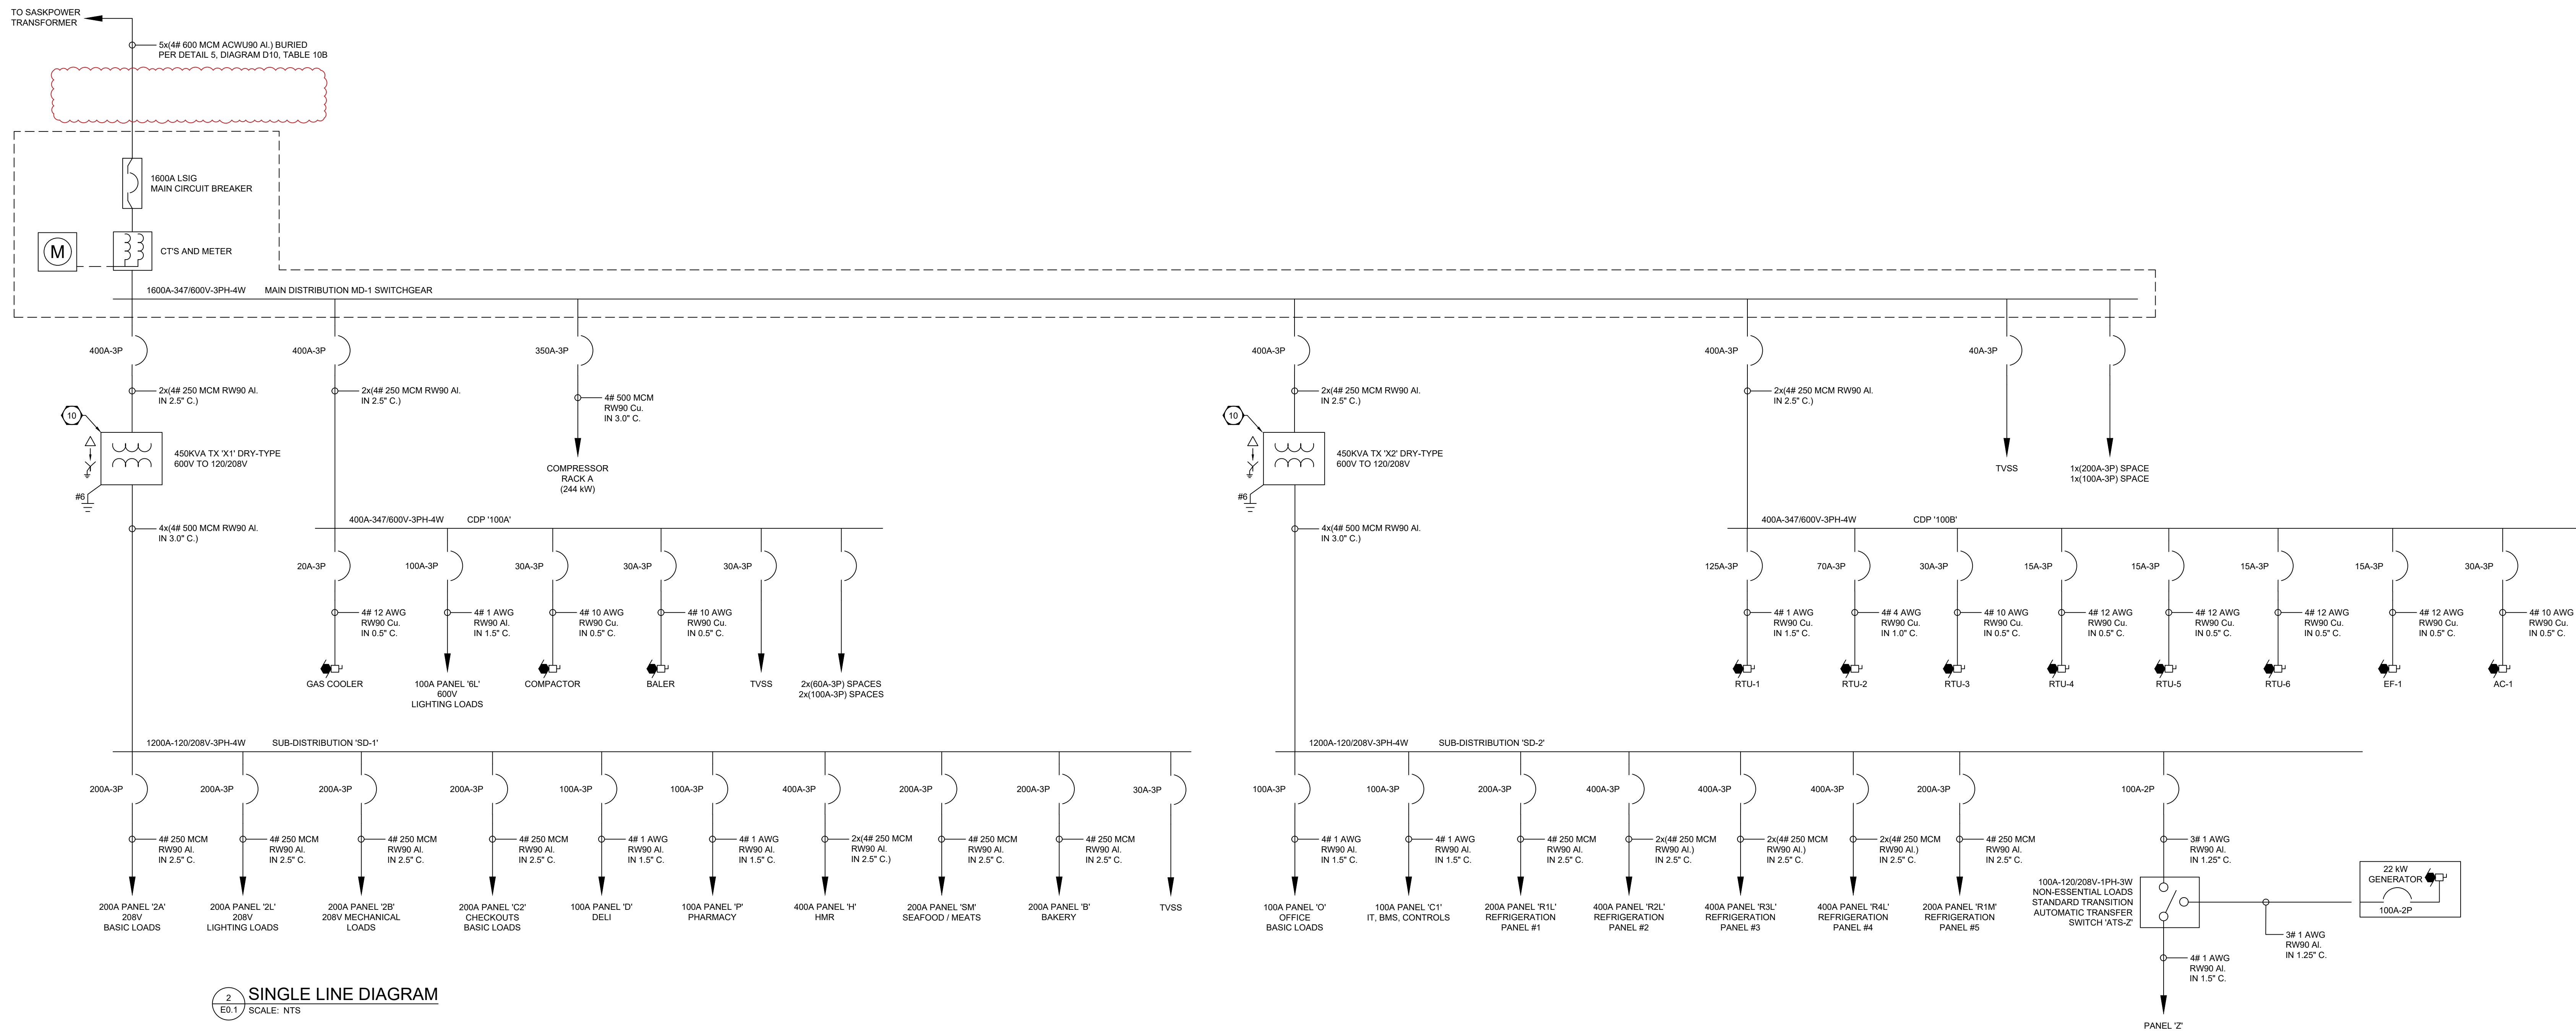

SINGLE LINE DIAGRAM
E0.1 SCALE: NTS

DRAWING NOTES

- APPROXIMATE LOCATION OF PAD-MOUNTED UTILITY TRANSFORMER. COORDINATE EXACT REQUIREMENTS WITH SASKPOWER ON SITE.
- APPROXIMATE LOCATION OF SASKTEL COMMUNICATION UTILITY PEDESTALS. COORDINATE EXACT REQUIREMENTS WITH SASKTEL ON SITE.
- REFER TO SINGLE LINE DIAGRAM FOR CONDUCTOR AND CONDUIT SIZING.
- PROVIDE ONE(1) 3" RIGID PVC CONDUIT FROM SASKTEL COMMUNICATION UTILITY PEDESTAL TO SERVICE TELECOM BACKBOARD LOCATED IN THE SERVICE MEZZANINE. COORDINATE ALL COMMUNICATIONS REQUIREMENTS WITH THE OWNER'S INTERNET SERVICE PROVIDER.
- NOT USED.
- MAIN TELECOM DEMARICATION BACKBOARD ON SECOND FLOOR MEZZANINE ELECTRICAL ROOM.
- ELECTRICAL SERVICE CONDUCTORS & CONDUITS TO RUN FROM WALL MOUNTED SPLITTER, PENETRATE INTO CONCRETE SHAFT WITHIN THE BUILDING ENVELOPE, AND RUN UP TO SECOND FLOOR MEZZANINE TO TERMINATE AT THE MAIN DISCONNECT SWITCH WITHIN THE MEZZANINE COMPRESSOR ROOM.
- TELECOM SERVICE CONDUCTORS AND CONDUITS TO RUN FROM EXTERIOR WALL MOUNTED JUNCTION BOX, PENETRATE INTO CONCRETE SHAFT WITHIN BUILDING ENVELOPE, AND RUN UP TO SECOND FLOOR MEZZANINE TO TERMINATE AT THE MAIN TELECOM DEMARICATION BACKBOARD WITHIN THE MEZZANINE COMPRESSOR ROOM.
- APPROXIMATE LOCATION OF ROOF TOP GENERATOR, PROVIDED BY REFRIGERATION CONTRACTOR. ELECTRICAL CONTRACTOR TO PROVIDE ALL CONDUITS, CONDUCTORS AND SUPPORTS.
- PROVIDE A 450 KVA TRANSFORMER AND CHOKO USING A 400A-3P FUSED DISCONNECT SWITCH (EQUIVALENT TO 332 KVA) PRIMARY PROTECTION SIZED AS PER CEC 26-256(3). PROVIDE A RIVET FASTENED LAMACQD LABEL ON THE OVERCURRENT PROTECTION DEVICE STATING THAT THE TRANSFORMER IS CHOKO TO 400A ON THE PRIMARY SIDE. REFER TO SINGLE LINE DIAGRAM.

3	PCN-02	2025.04.23	KC
2	PCN-01	2025.04.04	KC
1	CONSTRUCTION	2025.03.25	KC
No.	ISSUED FOR	DATE	BY
DRAWN BY:	BS		
PRINTING DATE:	APRIL 23, 2025		

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PROJECT TITLE:

AURORA GROCERY
STORE
2000 ANAQUOD ROAD
REGINA, SASKATCHEWAN

SHEET TITLE:
SITE PLAN AND
SINGLE LINE
COMMISSION NUMBER:
2445

SHEET NUMBER:
E0.1

PANEL '100A'				
400A-347/600V-3PH-4W PANEL SURFACE MOUNTED IN COMPRESSOR ROOM 300				
DESCRIPTION	CIRCUIT BREAKER	PHASE A B C	CIRCUIT BREAKER	DESCRIPTION
PANEL '8L'	100	1 0 2 3 0 1 5 0 15	20	GAS COOLER
TVSS #10 WIRE	30	7 0 8 9 0 10	30	COMPACTOR #10 WIRE
SPACE	-	13 0 14	-	BALER #10 WIRE
SPACE	-	15 0 16	30	SPACE
SPACE	-	17 0 18	-	SPACE
SPACE	-	19 0 20	-	SPACE
SPACE	-	21 0 22	-	SPACE
SPACE	-	23 0 24	-	SPACE
SPACE	-	25 0 26	-	SPACE
SPACE	-	27 0 28	-	SPACE
SPACE	-	29 0 30	-	SPACE
SPACE	-	31 0 32	-	SPACE
SPACE	-	33 0 34	-	SPACE
SPACE	-	35 0 36	-	SPACE
SPACE	-	37 0 38	-	SPACE
SPACE	-	39 0 40	-	SPACE
SPACE	-	41 0 42	-	SPACE

PANEL '100B'				
400A-347/600V-3PH-4W PANEL SURFACE MOUNTED IN COMPRESSOR ROOM 300				
DESCRIPTION	CIRCUIT BREAKER	PHASE A B C	CIRCUIT BREAKER	DESCRIPTION
RTU-1, ROOF TOP UNIT #1 WIRE	125	1 0 2 3 0 4 5 0 6 7 0 8	15	RTU-4, ROOF TOP UNIT
RTU-2, ROOF TOP UNIT #1 WIRE	70	9 0 10 11 0 12 13 0 14	15	RTU-5, ROOF TOP UNIT
RTU-3, ROOF TOP UNIT #10 WIRE	30	15 0 16 17 0 18 19 0 20 21 0 22 23 0 24	15	RTU-6, ROOF TOP UNIT
EF-1, EXHAUST FAN	15	25 0 26 27 0 28 29 0 30	30	AC-1, AIR CURTAIN #10 WIRE
TVSS #10 WIRE	30	31 0 32 33 0 34 35 0 36 37 0 38 39 0 40 41 0 42	-	SPACE
SPACE	-	31 0 32	-	SPACE
SPACE	-	33 0 34	-	SPACE
SPACE	-	35 0 36	-	SPACE
SPACE	-	37 0 38	-	SPACE
SPACE	-	39 0 40	-	SPACE
SPACE	-	41 0 42	-	SPACE

PANEL '8L'				
100A-347/600V-3PH-4W PANEL SURFACE MOUNTED IN WEST STAFF CORRIDOR				
DESCRIPTION	CIRCUIT BREAKER	PHASE A B C	CIRCUIT BREAKER	DESCRIPTION
LIGHTING - SALES - POT LIGHTS	15	1 0 2 3 0 4 5 0 6 7 0 8 9 0 10 11 0 12 13 0 14 15 0 16 17 0 18 19 0 20 21 0 22 23 0 24	15	LIGHTING - SALES
SPACE	-	15 0 16	-	LIGHTING - SALES
SPACE	-	15 0 16	-	LIGHTING - SALES
SPACE	-	15 0 16	-	LIGHTING - SALES
LIGHTING - CHECKOUTS	15	9 0 10 11 0 12 13 0 14 15 0 16 17 0 18 19 0 20 21 0 22 23 0 24	15	LIGHTING - SALES
LIGHTING - OFFICE	15	11 0 12 13 0 14 15 0 16 17 0 18 19 0 20 21 0 22 23 0 24	15	LIGHTING - SALES
LIGHTING - DELI	15	13 0 14 15 0 16 17 0 18 19 0 20 21 0 22 23 0 24	15	LIGHTING - SALES
LIGHTING - PHARMACY	15	15 0 16 17 0 18 19 0 20 21 0 22 23 0 24	15	LIGHTING - RECEIVING / WAREHOUSE
LIGHTING - BAKERY	15	17 0 18 19 0 20 21 0 22 23 0 24	15	LIGHTING - COMPRESSOR ROOM
LIGHTING - HMR	15	19 0 20 21 0 22 23 0 24	15	LIGHTING - COOLERS
LIGHTING - SEAFOOD / MEATS / PRODUCE	15	21 0 22 23 0 24 25 0 26 27 0 28 29 0 30 31 0 32 33 0 34 35 0 36 37 0 38 39 0 40 41 0 42	15	LIGHTING - VESTIBULE
SPACE	-	23 0 24	-	LIGHTING - EXTERIOR
SPACE	-	25 0 26	-	SPACE
SPACE	-	27 0 28	-	SPACE
SPACE	-	29 0 30	-	SPACE
SPACE	-	31 0 32	-	SPACE
SPACE	-	33 0 34	-	SPACE
SPACE	-	35 0 36	-	SPACE
SPACE	-	37 0 38	-	SPACE
SPACE	-	39 0 40	-	SPACE
SPACE	-	41 0 42	-	SPACE

PANEL 'SD-1'				
1200A-120/208V-3PH-4W PANEL SURFACE MOUNTED IN COMPRESSOR ROOM 300				
DESCRIPTION	CIRCUIT BREAKER	PHASE A B C	CIRCUIT BREAKER	DESCRIPTION
PANEL '2A'	200	1 0 2 3 0 4 5 0 6 7 0 8 9 0 10 11 0 12	100	PANEL '1'
PANEL '2L'	200	13 0 14 15 0 16 17 0 18 19 0 20	100	PANEL '1'
PANEL '2B'	200	21 0 22 23 0 24 25 0 26 27 0 28 29 0 30 31 0 32 33 0 34 35 0 36 37 0 38 39 0 40 41 0 42	400	PANEL '1'
PANEL 'C2	200	43 0 44 45 0 46 47 0 48 49 0 50 51 0 52 53 0 54 55 0 56 57 0 58 59 0 60	200	PANEL '5M'
TVSS	30	21 0 22 23 0 24 25 0 26 27 0 28 29 0 30 31 0 32 33 0 34 35 0 36 37 0 38 39 0 40 41 0 42 43 0 44 45 0 46 47 0 48 49 0 50 51 0 52 53 0 54 55 0 56 57 0 58 59 0 60	200	PANEL '1'
SPACE	-	31 0 32	-	SPACE
SPACE	-	33 0 34	-	SPACE
SPACE	-	35 0 36	-	SPACE
SPACE	-	37 0 38	-	SPACE
SPACE	-	39 0 40	-	SPACE
SPACE	-	41 0 42	-	SPACE
SPACE	-	43 0 44	-	SPACE
SPACE	-	45 0 46	-	SPACE
SPACE	-	47 0 48	-	SPACE
SPACE	-	49 0 50	-	SPACE
SPACE	-	51 0 52	-	SPACE
SPACE	-	53 0 54	-	SPACE
SPACE	-	55 0 56	-	SPACE
SPACE	-	57 0 58	-	SPACE
SPACE	-	59 0 60	-	SPACE

PANEL 'SD-2'				
1200A-120/208V-3PH-4W PANEL SURFACE MOUNTED IN COMPRESSOR ROOM 300				
DESCRIPTION	CIRCUIT BREAKER	PHASE A B C	CIRCUIT BREAKER	DESCRIPTION
PANEL '1'	100	1 0 2 3 0 4 5 0 6 7 0 8 9 0 10 11 0 12 13 0 14 15 0 16 17 0 18 19 0 20 21 0 22 23 0 24 25 0 26 27 0 28 29 0 30 31 0 32 33 0 34 35 0 36 37 0 38 39 0 40 41 0 42 43 0 44 45 0 46 47 0 48 49 0 50 51 0 52 53 0 54 55 0 56 57 0 58 59 0 60	200	PANEL '1L'
PANEL '1'	100	1 0 2 3 0 4 5 0 6 7 0 8 9 0 10 11 0 12 13 0 14 15 0 16 17 0 18 19 0 20 21 0 22 23 0 24 25 0 26 27 0 28 29 0 30 31 0 32 33 0 34 35 0 36 37 0 38 39 0 40 41 0 42 43 0 44 45 0 46 47 0 48 49 0 50 51 0 52 53 0 54 55 0 56 57 0 58 59 0 60	400	PANEL '1L'
PANEL '1M'	200	15 0 16 17 0 18 19 0 20 21 0 22 23 0 24 25 0 26 27 0 28 29 0 30 31 0 32 33 0 34 35 0 36 37 0 38 39 0 40 41 0 42 43 0 44 45 0 46 47 0 48 49 0 50 51 0 52 53 0 54 55 0 56 57 0 58 59 0 60	400	PANEL '1L'
PANEL '2'	100	21 0 22 23 0 24 25 0 26 27 0 28 29 0 30 31 0 32 33 0 34 35 0 36 37 0 38 39 0 40 41 0 42 43 0 44 45 0 46 47 0 48 49 0 50 51 0 52 53 0 54 55 0 56 57 0 58 59 0 60	200	PANEL '1L'
SPACE	-	23 0 24	-	SPACE
SPACE	-	25 0 26	-	SPACE
SPACE	-	27 0 28	-	SPACE
SPACE	-	29 0 30	-	SPACE
SPACE	-	31 0 32	-	SPACE
SPACE	-	33 0 34	-	SPACE
SPACE	-	35 0 36	-	SPACE
SPACE	-	37 0 38	-	SPACE
SPACE	-	39 0 40	-	SPACE
SPACE	-	41 0 42	-	SPACE
SPACE	-	43 0 44	-	SPACE
SPACE	-	45 0 46	-	SPACE
SPACE	-	47 0 48	-	SPACE
SPACE	-	49 0 50	-	SPACE
SPACE	-	51 0 52	-	SPACE
SPACE	-	53 0 54	-	SPACE
SPACE	-	55 0 56	-	SPACE
SPACE	-	57 0 58	-	SPACE
SPACE	-	59 0 60	-	SPACE

PANEL '2A'				
200A-120/208V-3PH-4W PANEL SURFACE MOUNTED IN COMPRESSOR ROOM 300				
DESCRIPTION	CIRCUIT BREAKER	PHASE A B C	CIRCUIT BREAKER	DESCRIPTION
DOOR OPENER (EXTERIOR)	15	1 0 2 3 0 4 5 0 6 7 0 8 9 0 10 11 0 12 13 0 14 15 0 16 17 0 18 19 0 20 21 0 22 23 0 24	15	EXTERIOR SIGNAGE
DOOR OPENER (EXTERIOR)	15	1 0 2 3 0 4 5 0 6 7 0 8 9 0 10 11 0 12 13 0 14 15 0 16 17 0 18 19 0 20 21 0 22 23 0 24	15	WAREHOUSE COMPUTER
DOOR OPENER (INSIDE)	15	1 0 2 3 0 4 5 0 6 7 0 8 9 0 10 11 0 12 13 0 14 15 0 16 17 0 18 19 0 20 21 0 22 23 0 24	15	SHELVING RECEPTACLE
DOOR OPENER (INSIDE)	15	1 0 2 3 0 4 5 0 6 7 0 8 9 0 10 11 0 12 13 0 14 15 0 16 17 0 18 19 0 20 21 0 22 23 0 24	15	SHELVING RECEPTACLE
DOOR OPENER (INSIDE)	15	1 0 2 3 0 4 5 0 6 7 0 8 9 0 10 11 0 12 13 0 14 15 0 16 17 0 18 19 0 20 21 0 22 23 0 24	15	SHELVING RECEPTACLE
BILLBOARD - NORTH	15	13 0 14 15 0 16 17 0 18 19 0 20 21 0 22 23 0 24	15	SHELVING RECEPTACLE
BILLBOARD - NORTH	15	15 0 16 17 0 18 19 0 20 21 0 22 23 0 24	15	SHELVING RECEPTACLE
BILLBOARD - NORTH	15	17 0 18 19 0 20 21 0 22 23 0 24	15	SHELVING RECEPTACLE
BILLBOARD - WEST	15	19 0 20 21 0 22 23 0 24	15	SHELVING RECEPTACLE
BILLBOARD - WEST	15	21 0 22 23 0 24 25 0 26 27 0 28 29 0 30 31 0 32 33 0 34 35 0 36 37 0 38 39 0 40 41 0 42	15	SHELVING RECEPTACLE
BILLBOARD - WEST	15	23 0 24 25 0 26 27 0 28 29 0 30 31 0 32 33 0 34 35 0 36 37 0 38 39 0 40 41 0 42	15	SHELVING RECEPTACLE
BILLBOARD - WEST	15	25 0 26 27 0 28 29 0 30 31 0 32 33 0 34 35 0 36 37 0 38 39 0 40 41 0 42	15	SHELVING RECEPTACLE
BILLBOARD - WEST	15	27 0 28 29 0 30 31 0 32 33 0 34 35 0 36 37 0 38 39 0 40 41 0 42	15	SHELVING RECEPTACLE
EXTERIOR SIGNAGE	15	29 0 30 31 0 32 33 0 34 35 0 36 37 0 38 39 0 40 41 0 42	15	SHELVING RECEPTACLE
SPACE	-	31 0 32 33 0 34 35 0 36 37 0 38 39 0 40 41 0 42	-	SPACE
SPACE	-	33 0 34 35 0 36 37 0 38 39 0 40 41 0 42	-	SPACE
SPACE	-	35 0 36 37 0 38 39 0 40 41 0 42	-	SPACE
SPACE	-	37 0 38 39 0 40 41 0 42	-	SPACE
SPACE	-	39 0 40 41 0 42	-	SPACE
SPACE	-	41 0 42	-	SPACE
SPACE	-	43 0 44 45 0 46 47 0 48 49 0 50 51 0 52 53 0 54 55 0 56 57 0 58 59 0 60	-	SPACE
SPACE	-	45 0 46 47 0 48 49 0 50 51 0 52 53 0 54 55 0 56 57 0 58 59 0 60	-	SPACE
SPACE	-	47 0 48 49 0 50 51 0 52 53 0 54 55 0 56 57 0 58 59 0 60	-	SPACE
SPACE	-	49 0 50 51 0 52 53 0 54 55 0 56 57 0 58 59 0 60	-	SPACE
SPACE	-	51 0 52 53 0 54 55 0 56 57 0 58 59 0 60	-	SPACE
SPACE	-	53 0 54 55 0 56 57 0 58 59 0 60	-	SPACE
SPACE	-	55 0 56 57 0 58 59 0 60	-	SPACE
SPACE	-	57 0 58 59 0 60	-	SPACE
SPACE	-	59 0 60	-	SPACE

PANEL '2L'				
200A-120/208V-3PH-4W PANEL SURFACE MOUNTED IN WEST STAFF CORRIDOR				
DESCRIPTION	CIRCUIT BREAKER	PHASE A B C	CIRCUIT BREAKER	DESCRIPTION
LIGHTING - SALES - TRACK	20	1 0 2	15	LIGHTING - SEATING
LIGHTING - SALES - TRACK	15	3 0 4	20	LIGHTING - TRELLIS
LIGHTING - SALES - TRACK	15	5 0 6	20	LIGHTING - TRELLIS
LIGHTING - SALES - TRACK	15	7 0 8	20	LIGHTING - TRELLIS
LIGHTING - SALES - TRACK	15	9 0 10	15	LIGHTING - BULKHEAD
LIGHTING - DOCK LIGHTS	15	11 0 12	15	LIGHTING - BULKHEAD
SPACE	13	0 14	-	SPACE
SPACE	15	0 16	-	SPACE
SPACE	17	0 18	-	SPACE
SPACE	19	0 20	-	SPACE
SPACE	21	0 22	-	SPACE
SPACE	23	0 24	-	SPACE
SPACE	25	0 26	-	SPACE
SPACE	27	0 28	-	SPACE
SPACE	29	0 30	-	SPACE
SPACE	31	0 32	-	SPACE
SPACE	33	0 34	-	SPACE
SPACE	35	0 36	-	SPACE
SPACE	37	0 38	-	SPACE
SPACE	39	0 40	-	SPACE
SPACE	41	0 42	-	SPACE



PANEL '2B'					
200A-120/208V-3PH-4W PANEL					
SURFACE MOUNTED IN WEST STAFF CORRIDOR					
DESCRIPTION	CIRCUIT BREAKER	PHASE A B C	CIRCUIT BREAKER	DESCRIPTION	
DWH-1, DOMESTIC WATER HEATER	15	1	2	-	SPACE
DWH-2, DOMESTIC WATER HEATER	15	3	4	15	EF-4, EXHAUST FAN
P-1, RE-CIRCULATION PUMP	15	5	6	15	EF-4, EXHAUST FAN
P-2, RE-CIRCULATION PUMP	15	7	8	15	EF-5, EXHAUST FAN
CU-1, CONDENSING UNIT	20	9	10	15	EF-6, EXHAUST FAN
CU-1, CONDENSING UNIT	20	11	12	15	EF-7, EXHAUST FAN
CU-1, CONDENSING UNIT	20	13	14	15	EF-8, EXHAUST FAN
MUA-1, MAKE-UP AIR	20	15	16	15	DF-2.4-6 - DESTRATIFICATION FAN
EF-6, EXHAUST FAN	17	17	18	15	DF-3.5-7 - DESTRATIFICATION FAN
EF-6, EXHAUST FAN	17	19	20	15	DF-4.8-9 - DESTRATIFICATION FAN
EF-6, EXHAUST FAN	30	21	22	15	TF-1, TRANSFER FAN
EF-6, EXHAUST FAN	23	23	24	15	UH-1, UNIT HEATER
EF-6, EXHAUST FAN	25	25	26	15	UH-2, UNIT HEATER
EF-6, EXHAUST FAN	25	27	28	15	UH-3, UNIT HEATER
EF-6, EXHAUST FAN	25	29	30	15	UH-4, UNIT HEATER
EF-6, EXHAUST FAN	30	31	32	15	UH-5, UNIT HEATER
EF-6, EXHAUST FAN	33	33	34	15	MOTORIZED DAMPERS
SPACE	-	35	36	-	SPACE
EFF-1, FORCE FLOW HEATER (1 x 2.0 MW)	15	37	38	-	SPACE
EFF-1, FORCE FLOW HEATER (1 x 2.0 MW)	39	39	40	-	SPACE
EFF-1, FORCE FLOW HEATER (1 x 2.0 MW)	41	41	42	-	SPACE
EFF-1, FORCE FLOW HEATER (1 x 2.0 MW)	15	43	44	-	SPACE
EBB-1, BASEBOARD HEATERS (4 x 1.0 KW)	25	45	46	-	SPACE
SPACE	-	47	48	-	SPACE
SPACE	-	49	50	-	SPACE
SPACE	-	51	52	-	SPACE
SPACE	-	53	54	-	SPACE
SPACE	-	55	56	-	SPACE
SPACE	-	57	58	-	SPACE
SPACE	-	59	60	-	SPACE
SPACE	-	61	62	-	SPACE
SPACE	-	63	64	-	SPACE
SPACE	-	65	66	-	SPACE
SPACE	-	67	68	-	SPACE
SPACE	-	69	70	-	SPACE
SPACE	-	71	72	-	SPACE
SPACE	-	73	74	-	SPACE
SPACE	-	75	76	-	SPACE
SPACE	-	77	78	-	SPACE
SPACE	-	79	80	-	SPACE
SPACE	-	81	82	-	SPACE
SPACE	-	83	84	-	SPACE

PANEL 'C1'					
180A-120/208V-3PH-4W PANEL					
SURFACE MOUNTED IN COMPRESSOR ROOM 300					
DESCRIPTION	CIRCUIT BREAKER	PHASE A B C	CIRCUIT BREAKER	DESCRIPTION	
FIRE ALARM CONTROL PANEL	15	1	2	-	SPACE
TELECOM BACKBOARD	20	3	4	20	DOCK LEVELER
SECURITY PANEL	20	5	6	-	SPACE
DATA RACK	20	7	8	-	SPACE
SPARE	20	9	10	20	DOCK LEVELER
SPARE	20	11	12	-	SPACE
SPARE	20	13	14	15	OVERHEAD DOOR
SPARE	15	15	16	15	OVERHEAD DOOR
SPARE	15	17	18	15	SC RECEPTACLE
ROOF MAINTENANCE RECEPTACLE	20	19	20	15	SC RECEPTACLE
ROOF MAINTENANCE RECEPTACLE	20	21	22	15	HOUSEKEEPING RECEPTACLES
ROOF MAINTENANCE RECEPTACLE	20	23	24	-	SPACE
ROOF MAINTENANCE RECEPTACLE	20	25	26	15	EXTERIOR SIGNAGE
ROOF MAINTENANCE RECEPTACLE	20	27	28	15	HOUSEKEEPING RECEPTACLE
ROOF MAINTENANCE RECEPTACLE	20	29	30	-	SPACE
ROOF MAINTENANCE RECEPTACLE	20	31	32	-	SPACE
ROOF MAINTENANCE RECEPTACLE	20	33	34	-	SPACE
ROOF MAINTENANCE RECEPTACLE	20	35	36	-	SPACE
ROOF MAINTENANCE RECEPTACLE	20	37	38	-	SPACE
ROOF MAINTENANCE RECEPTACLE	20	39	40	-	SPACE
SPACE	-	41	42	-	SPACE
SPACE	-	43	44	-	SPACE
SPACE	-	45	46	-	SPACE
SPACE	-	47	48	-	SPACE
SPACE	-	49	50	-	SPACE
SPACE	-	51	52	-	SPACE
SPACE	-	53	54	-	SPACE
SPACE	-	55	56	-	SPACE
SPACE	-	57	58	-	SPACE
SPACE	-	59	60	-	SPACE
SPACE	-	61	62	-	SPACE
SPACE	-	63	64	-	SPACE
SPACE	-	65	66	-	SPACE
SPACE	-	67	68	-	SPACE
SPACE	-	69	70	-	SPACE
SPACE	-	71	72	-	SPACE
SPACE	-	73	74	-	SPACE
SPACE	-	75	76	-	SPACE
SPACE	-	77	78	-	SPACE
SPACE	-	79	80	-	SPACE
SPACE	-	81	82	-	SPACE
SPACE	-	83	84	-	SPACE

PANEL 'R1M'					
200A-120/208V-3PH-4W PANEL					
SURFACE MOUNTED IN WEST STAFF CORRIDOR					
DESCRIPTION	CIRCUIT BREAKER	PHASE A B C	CIRCUIT BREAKER	DESCRIPTION	
AM-C1 (LIGHTS, FANS, ANTI-CONDENSATE)	15	1	2	15	AM-C27 (LIGHTS, FANS, ANTI-CONDENSATE)
AM-C2 (LIGHTS, FANS, ANTI-CONDENSATE)	15	3	4	15	AM-C28 (LIGHTS, FANS, ANTI-CONDENSATE)
AM-C3 (LIGHTS, FANS, ANTI-CONDENSATE)	15	5	6	15	AM-C29 (LIGHTS, FANS, ANTI-CONDENSATE)
AM-C4 (LIGHTS, FANS, ANTI-CONDENSATE)	15	7	8	15	AM-C30 (LIGHTS, FANS, ANTI-CONDENSATE)
AM-C5 (LIGHTS, FANS, ANTI-CONDENSATE)	15	9	10	15	AM-C31 (LIGHTS, FANS, ANTI-CONDENSATE)
AM-C6 (LIGHTS, FANS, ANTI-CONDENSATE)	15	11	12	15	AM-C32 (LIGHTS, FANS, ANTI-CONDENSATE)
AM-C7 (LIGHTS, FANS, ANTI-CONDENSATE)	15	13	14	15	AM-C33 (LIGHTS, FANS, ANTI-CONDENSATE)
AM-C8 (LIGHTS, FANS, ANTI-CONDENSATE)	15	15	16	15	AM-C34 (LIGHTS, FANS, ANTI-CONDENSATE)
AM-C9 (LIGHTS, FANS, ANTI-CONDENSATE)	15	17	18	15	AM-C35 (LIGHTS, FANS, ANTI-CONDENSATE)
AM-C10 (LIGHTS, FANS, ANTI-CONDENSATE)	15	19	20	15	AM-C36 (LIGHTS, FANS, ANTI-CONDENSATE)
AM-C11 (LIGHTS, FANS, ANTI-CONDENSATE)	15	21	22	15	AM-E8 (EVAPORATOR PANEL I)
AM-C12 (LIGHTS, FANS, ANTI-CONDENSATE)	15	23	24	-	SPACE
SPACE	-	25	26	15	AM-C37 (LIGHTS, FANS, ANTI-CONDENSATE)
SPACE	-	27	28	15	AM-C38 (LIGHTS, FANS, ANTI-CONDENSATE)
AM-C13 (LIGHTS, FANS, ANTI-CONDENSATE)	15	29	30	15	AM-C39 (LIGHTS, FANS, ANTI-CONDENSATE)
AM-C14 (LIGHTS, FANS, ANTI-CONDENSATE)	15	31	32	15	AM-C40 (LIGHTS, FANS, ANTI-CONDENSATE)
AM-E2 (EVAPORATOR PANEL E)	33	33	34	15	AM-C41 (LIGHTS, FANS, ANTI-CONDENSATE)
AM-C15 (LIGHTS, FANS, ANTI-CONDENSATE)	15	35	36	15	AM-C42 (LIGHTS, FANS, ANTI-CONDENSATE)
AM-C16 (LIGHTS, FANS, ANTI-CONDENSATE)	15	37	38	15	AM-C43 (LIGHTS, FANS, ANTI-CONDENSATE)
AM-C17 (LIGHTS, FANS, ANTI-CONDENSATE)	15	39	40	15	AM-C44 (LIGHTS, FANS, ANTI-CONDENSATE)
AM-C18 (LIGHTS, FANS, ANTI-CONDENSATE)	15	41	42	15	AM-C45 (LIGHTS, FANS, ANTI-CONDENSATE)
AM-C19 (LIGHTS, FANS, ANTI-CONDENSATE)	15	43	44	15	AM-C46 (LIGHTS, FANS, ANTI-CONDENSATE)
AM-C20 (LIGHTS, FANS, ANTI-CONDENSATE)	15	45	46	15	AM-C47 (LIGHTS, FANS, ANTI-CONDENSATE)
AM-C21 (LIGHTS, FANS, ANTI-CONDENSATE)	15	47	48	15	AM-C48 (LIGHTS, FANS, ANTI-CONDENSATE)
AM-C22 (LIGHTS, FANS, ANTI-CONDENSATE)	15	49	50	15	AM-C49 (LIGHTS, FANS, ANTI-CONDENSATE)
AM-C23 (LIGHTS, FANS, ANTI-CONDENSATE)	15	51	52	15	AM-C50 (LIGHTS, FANS, ANTI-CONDENSATE)
AM-E3 (EVAPORATOR PANEL F)	15	53	54	15	AM-C51 (LIGHTS, FANS, ANTI-CONDENSATE)
AM-E4 (EVAPORATOR PANEL G)	25	57	58	15	AM-C52 (LIGHTS, FANS, ANTI-CONDENSATE)
SPACE	-	59	60	15	AM-E10 (EVAPORATOR PANEL J)
SPACE	-	61	62	15	AM-E11 (EVAPORATOR PANEL K)
AM-E5 (EVAPORATOR PANEL H)	15	63	64	15	AM-E12 (EVAPORATOR PANEL L)
SPACE	-	65	66	15	AM-E13 (EVAPORATOR PANEL M)
AM-C24 (LIGHTS, FANS, ANTI-CONDENSATE)	15	67	68	15	AM-E1 (EVAPORATOR PANEL N)
AM-C25 (LIGHTS, FANS, ANTI-CONDENSATE)	15	69	70	15	AM-E2 (EVAPORATOR PANEL O)
AM-C26 (LIGHTS, FANS, ANTI-CONDENSATE)	15	71	72	15	AM-C13 (DEFROST HEATERS)
SPACE	-	73	74	15	AM-C16 (DEFROST HEATERS)
SPACE	-	75	76	15	AM-C17 (DEFROST HEATERS)
SPACE	-	77	78	15	AM-C18 (DEFROST HEATERS)
SPACE	-	79	80	15	AM-C19 (DEFROST HEATERS)
SPACE	-	81	82	15	AM-C20 (DEFROST HEATERS)
SPACE	-	83	84	15	AM-C21 (DEFROST HEATERS)
SPACE	-	85	86	15	AM-C22 (DEFROST HEATERS)
SPACE	-	87	88	15	AM-C23 (DEFROST HEATERS)
SPACE	-	89	90	15	AM-C24 (DEFROST HEATERS)
SPACE	-	91	92	15	AM-C25 (DEFROST HEATERS)
SPACE	-	93	94	15	AM-C26 (DEFROST HEATERS)
SPACE	-	95	96	15	AM-C27 (DEFROST HEATERS)
SPACE	-	97	98	15	AM-C28 (DEFROST HEATERS)
SPACE	-	99	100	15	AM-C29 (DEFROST HEATERS)
SPACE	-	101	102	15	AM-C30 (DEFROST HEATERS)
SPACE	-	103	104	15	AM-C31 (DEFROST HEATERS)
SPACE	-	105	106	15	AM-C32 (DEFROST HEATERS)
SPACE	-	107	108	15	AM-C33 (DEFROST HEATERS)
SPACE	-	109	110	15	AM-C34 (DEFROST HEATERS)
SPACE	-	111	112	15	AM-C35 (DEFROST HEATERS)
SPACE	-	113	114	15	AM-C36 (DEFROST HEATERS)
SPACE	-	115	116	15	AM-C37 (DEFROST HEATERS)
SPACE	-	117	118	15	AM-C38 (DEFROST HEATERS)
SPACE	-	119	120	15	AM-C39 (DEFROST HEATERS)

PANEL 'C2'					
200A-120/208V-3PH-4W PANEL					
RECESS MOUNTED IN OFFICE CORRIDOR					
DESCRIPTION	CIRCUIT BREAKER	PHASE A B C	CIRCUIT BREAKER	DESCRIPTION	
CHECKOUT #1	15	1	2	15	SELF CHECKOUT #1
CHECKOUT #1	15	3	4	15	SELF CHECKOUT #1
CHECKOUT #2	15	5	6	15	SELF CHECKOUT #2
CHECKOUT #2	15	7	8	15	SELF CHECKOUT #2
CHECKOUT #3	15	9	10	15	SELF CHECKOUT #3
CHECKOUT #3	15	11	12	15	SELF CHECKOUT #3
CHECKOUT #4	15	13	14	15	SELF CHECKOUT #4
CHECKOUT #4	15	15	16	15	SELF CHECKOUT #4
CHECKOUT #5	15	17	18	15	SELF CHECKOUT #5
CHECKOUT #5	15	19	20	15	SELF CHECKOUT #5
CHECKOUT #6	15	21	22	15	SELF CHECKOUT #6
CHECKOUT #6	15	23	24	15	SELF CHECKOUT #6
CHECKOUT COOLER	15	25	26	15	SERVICE DESK
CHECKOUT COOLER	15	27	28	15	SERVICE DESK
CHECKOUT COOLER	15	29	30	15	SERVICE DESK
EXTERIOR SIGNAGE	15	31	32	15	SERVICE DESK
RECEPTACLES	15	33	34	15	SERVICE DESK
EXTERIOR SEATING RECEPTACLES	15	35	36	15	BILLBOARD - CHECKOUT
COUNTER RECEPTACLES	20	37	38	15	BILLBOARD - CHECKOUT
COUNTER RECEPTACLES	20	39	40	15	BILLBOARD - CHECKOUT
COUNTER RECEPTACLES	20	41	42	15	BILLBOARD - CHECKOUT
ROLLER WINDOW SHUTTER	15	43	44	15	ENB-1, BASEBOARD HEATER (1 x 2.0 KW)
ROLLER WINDOW SHUTTER	15	45	46	15	ENB-1, BASEBOARD HEATER (1 x 2.0 KW)
ROLLER WINDOW SHUTTER	15	47	48	15	ENB-1, BASEBOARD HEATER (1 x 2.0 KW)
ROLLER WINDOW SHUTTER	15	49	50	15	ENB-1, BASEBOARD HEATER (1 x 2.0 KW)
SPACE	-	51	52	-	SPACE
SPACE	-	53	54	-	SPACE
SPACE	-	55	56	-	SPACE
SPACE	-	57	58	-	SPACE
SPACE	-	59	60	-	SPACE
SPACE	-	61	62	-	SPACE
SPACE	-	63	64	-	SPACE
SPACE	-	65	66	-	SPACE
SPACE	-	67	68	-	SPACE
SPACE	-	69	70	-	SPACE
SPACE	-	71	72	-	SPACE
SPACE	-	73	74	-	SPACE
SPACE	-	75	76	-	SPACE
SPACE	-	77	78	-	SPACE
SPACE	-	79	80	-	SPACE
SPACE	-	81	82	-	SPACE
SPACE	-	83	84	-	SPACE

PANEL 'R1L'					
200A-120/208V-3PH-4W PANEL					
SURFACE MOUNTED IN WEST STAFF CORRIDOR					
DESCRIPTION	CIRCUIT BREAKER	PHASE A B C	CIRCUIT BREAKER	DESCRIPTION	
AL-C1 (FANS, LIGHTS, ANTI-CONDENSATE)	15	1	2	-	SPACE
AL-C2 (FANS, LIGHTS, ANTI-CONDENSATE)	15	3	4	-	SPACE
AL-C4 (FANS, LIGHTS, ANTI-CONDENSATE)	15	5	6	15	AL-C28 (FANS, LIGHTS, ANTI-CONDENSATE)
AL-C5 (FANS, LIGHTS, ANTI-CONDENSATE)	15	7	8	15	AL-C29 (FANS, LIGHTS, ANTI-CONDENSATE)
AL-C6 (FANS, LIGHTS, ANTI-CONDENSATE)	15	9	10	15	AL-C30 (FANS, LIGHTS, ANTI-CONDENSATE)
AL-C7 (FANS, LIGHTS, ANTI-CONDENSATE)	15	11	12	15	AL-C31 (FANS, LIGHTS, ANTI-CONDENSATE)
AL-C8 (FANS, LIGHTS, ANTI-CONDENSATE)	15	13	14	15	AL-C32 (FANS, LIGHTS, ANTI-CONDENSATE)
AL-C10 (FANS, LIGHTS, ANTI-CONDENSATE)	15	15	16	15	AL-C33 (FANS, LIGHTS, ANTI-CONDENSATE)
AL-C11 (FANS, LIGHTS, ANTI-CONDENSATE)	15	17	18	15	AL-C34 (FANS, LIGHTS, ANTI-CONDENSATE)
AL-C12 (FANS, LIGHTS, ANTI-CONDENSATE)	15	19	20	15	AL-C35 (FANS, LIGHTS, ANTI-CONDENSATE)

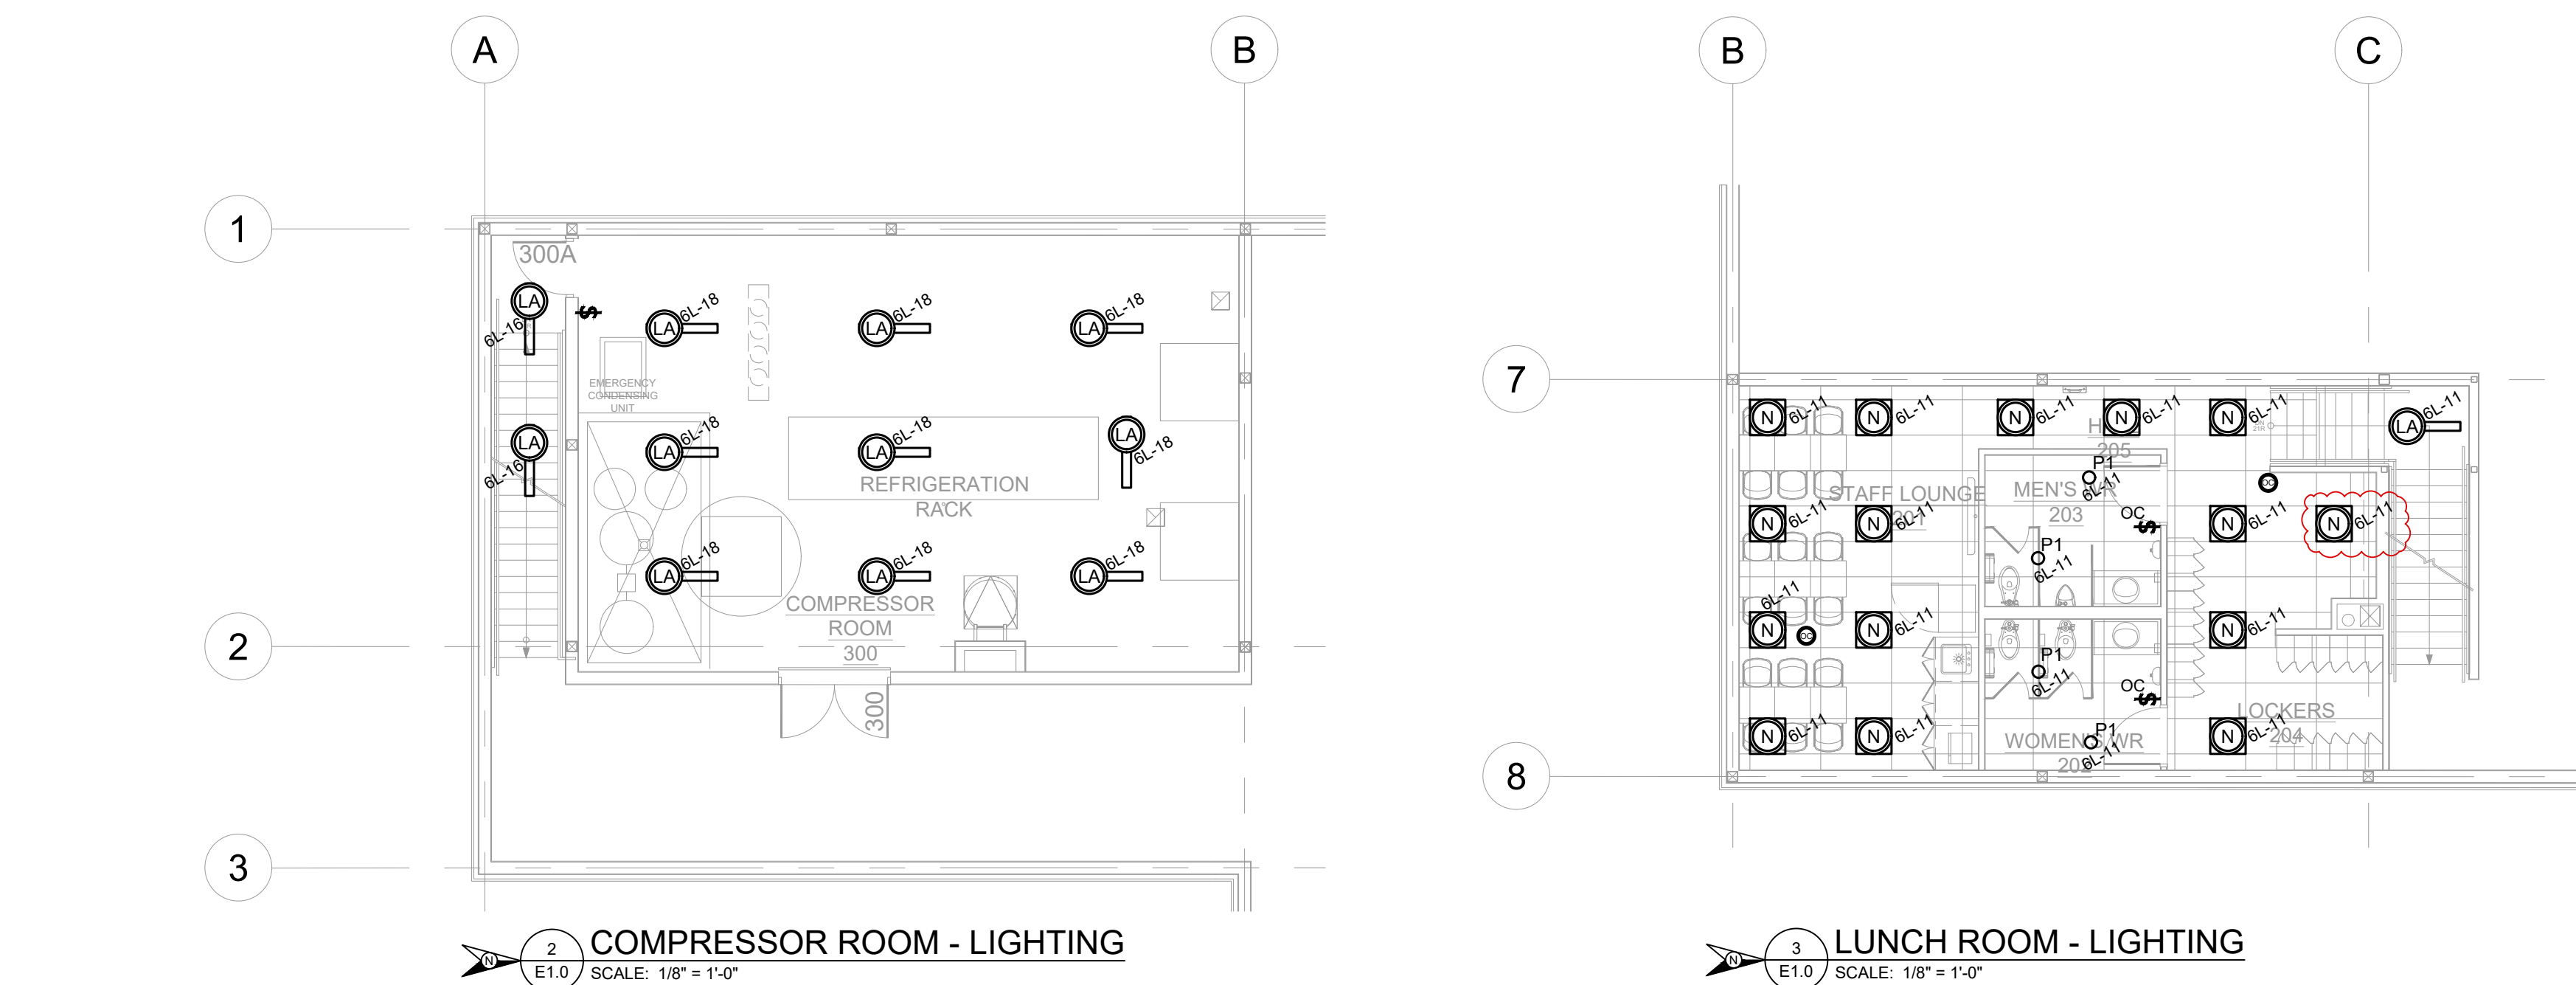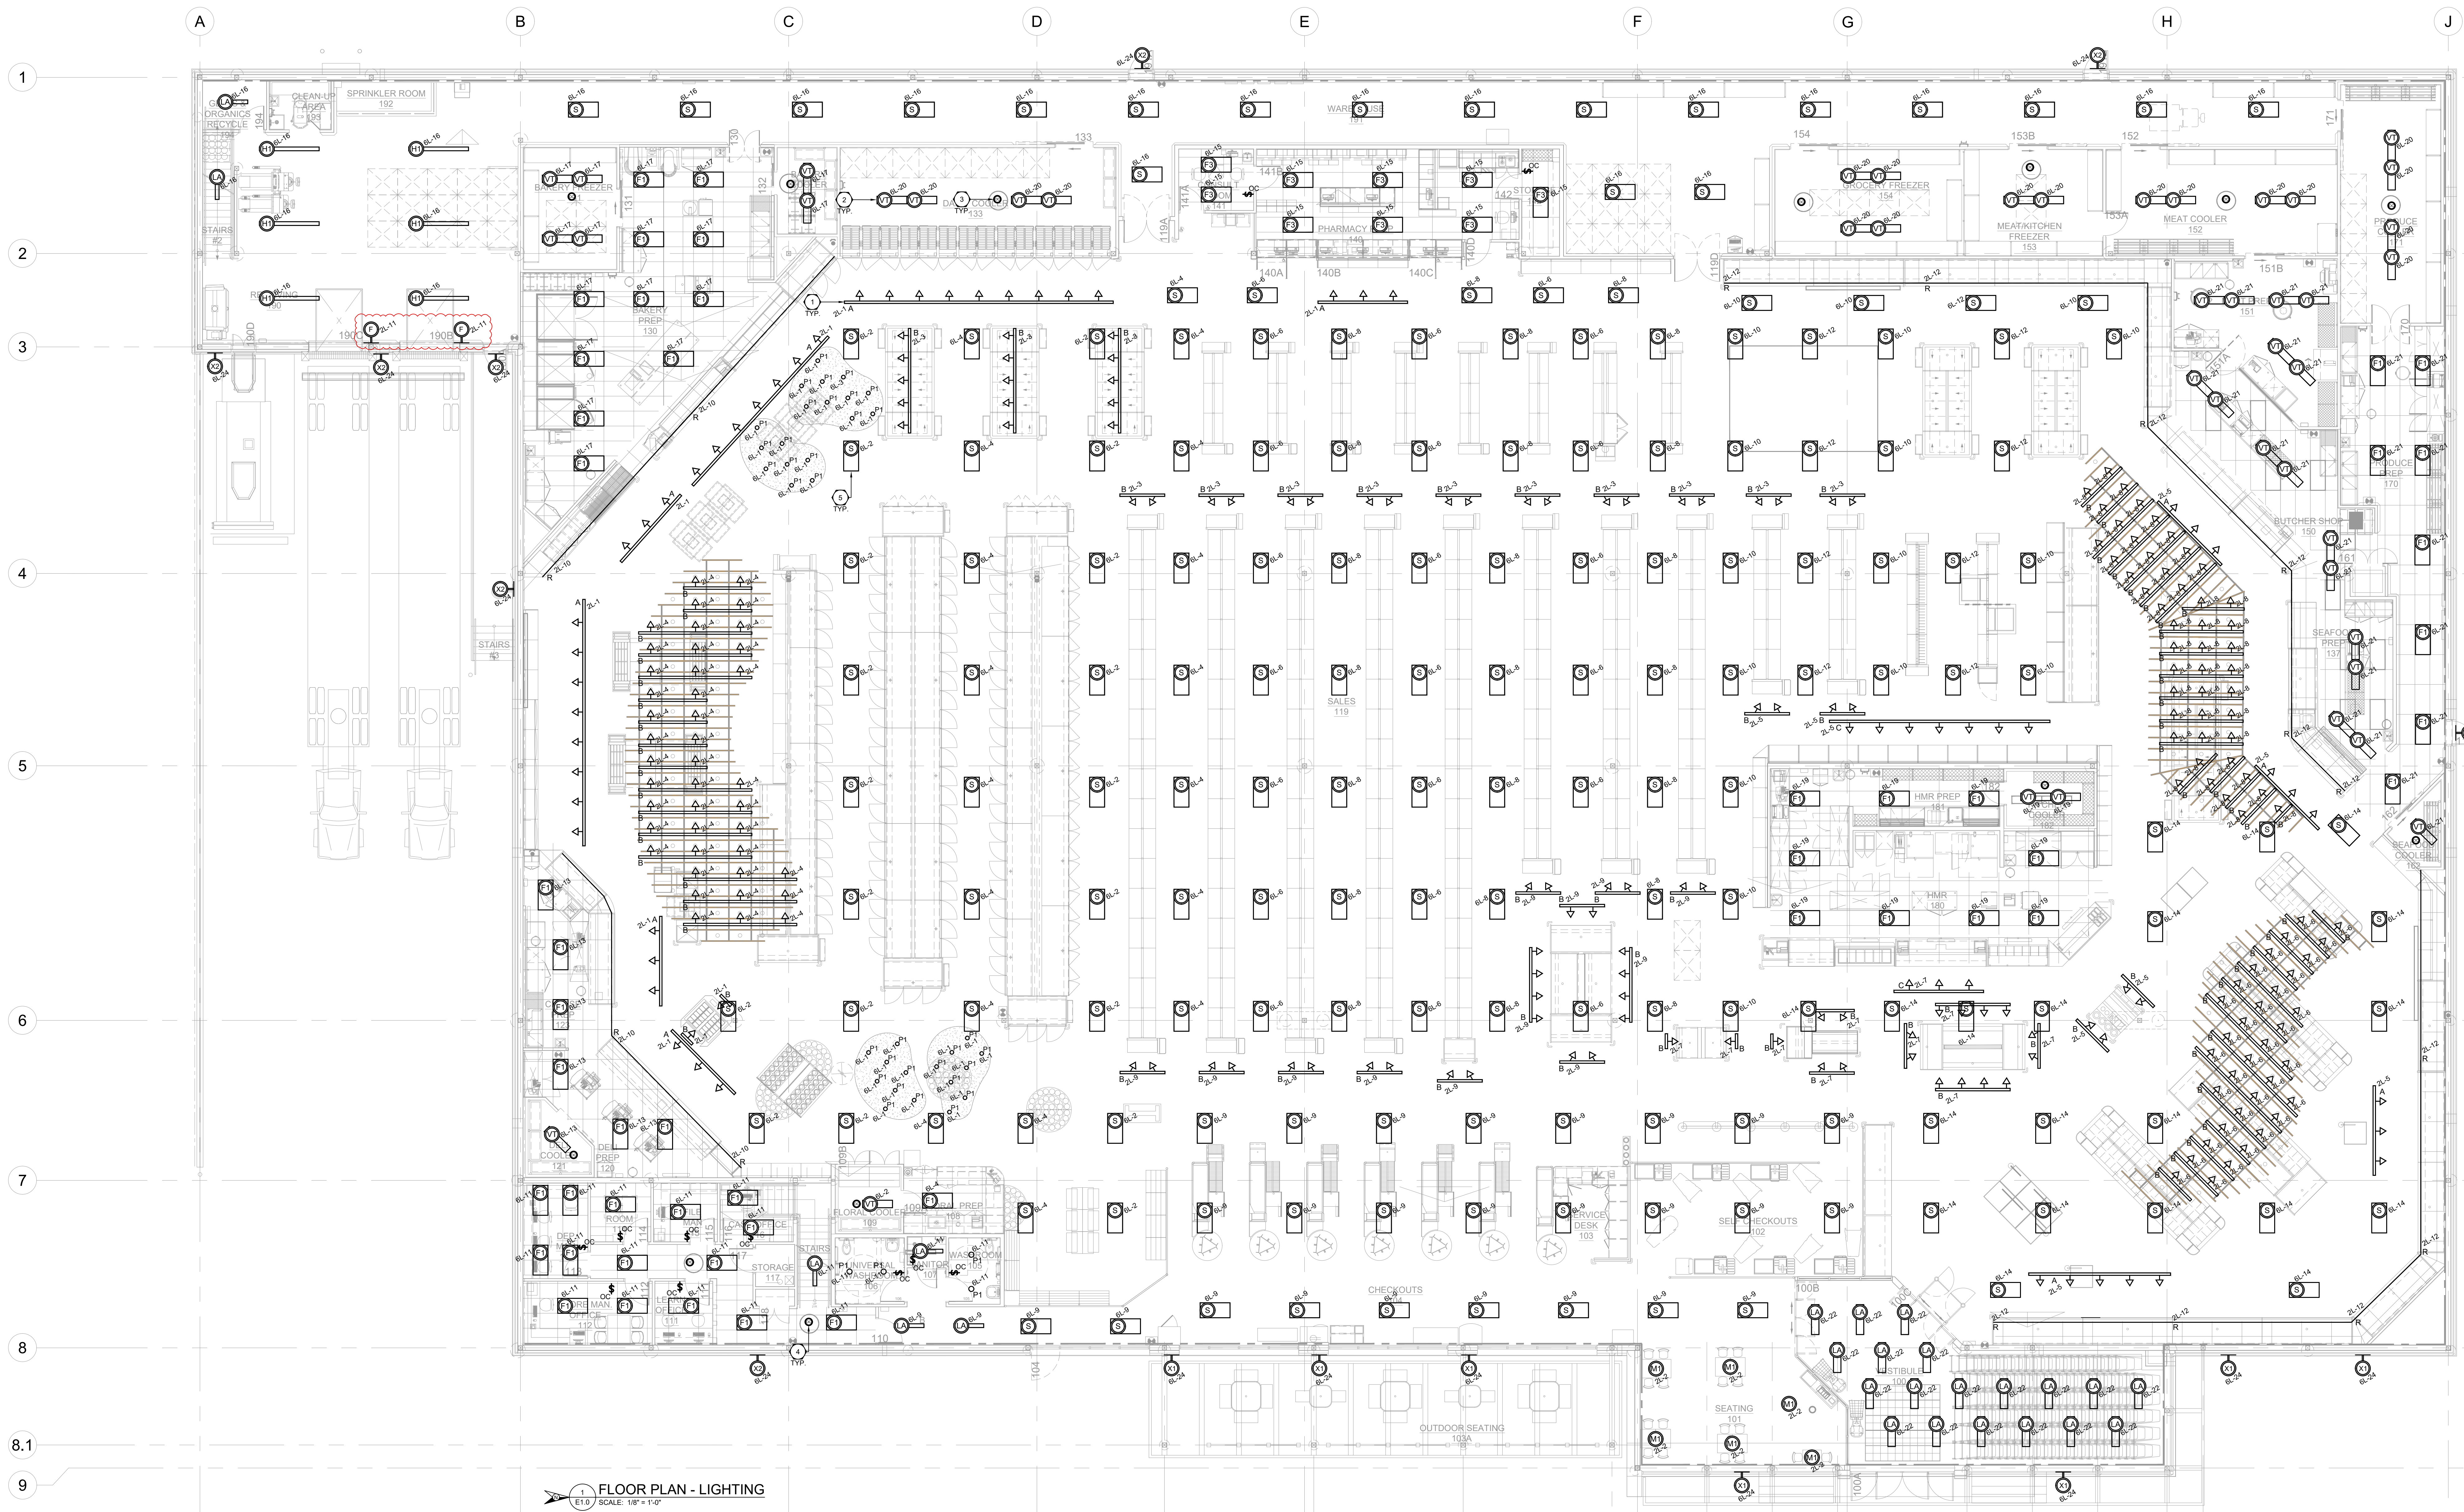

- GENERAL NOTES**
- ALL SUSPENDED FIXTURE ACCESSORIES AND VISIBLE JUNCTION BOXES TO MATCH CEILING FINISH.
 - ELECTRICAL CONTRACTOR TO COORDINATE, INSTALL AND WIRE ALL MILLWORK/FURNITURE LIGHTING FIXTURES SUPPLIED BY OTHERS, INCLUDING FINAL CONNECTIONS.
 - UNLESS OTHERWISE NOTED, ALL LIGHTING FIXTURES ARE SUPPLIED AND INSTALLED BY ELECTRICAL CONTRACTOR, INCLUDING, BUT NOT LIMITED TO, ALL NECESSARY MOUNTING HARDWARE SUCH AS STEEL CABLES, GAT CONDUIT, SUPPORTED UNISTRUTS, ETC.
 - REFER TO ARCHITECTURAL DECOR LIGHTING AND REFLECTED CEILING PLAN FOR EXACT MOUNTING HEIGHTS OF ALL LUMINAIRES. COORDINATE WITH ARCHITECT.
 - LIGHTING CONTROLS (INCLUDING LOW VOLTAGE CONTROLS) SHALL BE PROVIDED AND INSTALLED BY EC. COORDINATE THE PURCHASE AND INSTALLATION OF ALL LIGHTING CONTROL EQUIPMENT THROUGH MICRO THERMO WEST. ALL LIGHTING CONTROLS ARE TO BE TIED IN WITH BUILDING EMS SYSTEM AS REQUIRED. COORDINATE EXACT REQUIREMENTS FOR THE LIGHTING CONTROL SYSTEM WITH MICRO THERMO WEST ON SITE.

3	PCN-02	2025.04.23	KC
2	PCN-01	2025.04.04	KC
1	CONSTRUCTION	2025.03.25	KC
No. ISSUED FOR		DATE	BY
DRAWN BY:		BS	
PRINTING DATE: APRIL 23, 2025			

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The contractor is to verify dimensions and data noted herein with conditions on the site and is held responsible for reporting discrepancies to the architect for adjustment.

PROJECT TITLE:
**AURORA GROCERY
STORE**
2000 ANAQUOD ROAD
REGINA, SASKATCHEWAN

SHEET TITLE:
**FLOOR PLAN -
LIGHTING**
COMMISSION NUMBER:
2445
SHEET NUMBER:
E.10



DRAWING NOTES - LIGHTING

- ALL TRACK LIGHTING TO BE SUSPENDED ON THREADED ROD, FOLLOW MANUFACTURER'S DIRECTIONS FOR QUANTITIES OF SUSPENSION POINTS. TYPICAL.
- PRIOR TO ROUGH-IN OF ALL COOLER/FREEZER LUMINAIRES, COORDINATE WITH THE REFRIGERATION CONTRACTOR TO AVOID CONFLICT WITH EVAPORATION COILS. SEAL CONDUIT TO LUMINAIRES. TYPICAL.
- PROVIDE CEILING MOUNT LOW TEMPERATURE OCCUPANCY SENSOR. COORDINATE WITH REFRIGERATION CONTRACTOR SO SENSOR IS NOT IN DIRECT LINE OF COILS AND FLOW. TYPICAL OF ALL COOLERS.
- PROVIDE DUAL-TECH OCCUPANCY SENSOR. PROVIDE VOLTAGE TO SUT. SENSOR TO PROVIDE LOCAL CONTROL OF THE LIGHTS IN THE AREA. TYPICAL.
- LIGHT FIXTURE TYPE 'S' TO BE SUSPENDED WITH AIRCRAFT CABLE FROM UNISTRUT SUPPORT BETWEEN JOISTS. TYPICAL.

LIGHTING ZONE SCHEDULE

ZONE	LIGHTING CIRCUIT	AREA DESCRIPTION	CONTROL SCHEME
1	6L-22	VESTIBULE	EMS TIMELOCK
2	6L-2, 6L-4, 6L-6, 6L-8	SALES AREA HIGH BAYS - WEST	EMS TIMELOCK
3	6L-10, 6L-12, 6L-14	SALES AREA HIGH BAYS - EAST	EMS TIMELOCK
4	6L-1, 6L-3, 6L-5, 6L-7	347V SALES AREA POT LIGHTS	EMS TIMELOCK
5	2L-2, 2L-4, 2L-6, 2L-8	120V SALES AREA TRACK AND BULKHEAD LIGHTING	EMS TIMELOCK
6	6L-16	WAREHOUSE / RECEIVING	EMS TIMELOCK
7	6L-18	COMPRESSOR ROOM	EMS TIMELOCK
8	6L-17	BAKERY	EMS TIMELOCK / OCCUPANCY SENSORS
9	6L-15	PHARMACY	EMS TIMELOCK / OCCUPANCY SENSORS
10	6L-21	SEAFOOD / MEATS / PRODUCE	EMS TIMELOCK / OCCUPANCY SENSORS
11	6L-19	H.M.R.	EMS TIMELOCK / OCCUPANCY SENSORS
12	6L-20	LARGE COOLERS	OCCUPANCY SENSOR
13	2L-2	SEATING	EMS TIMELOCK
14	6L-11	OFFICE	OCCUPANCY SENSOR
15	6L-24	EXTERIOR LIGHTS	EMS TIMELOCK

NOTES:
1. ZONE SCHEDULE SHOWN FOR INFORMATION ONLY. WIRING, COMPONENT AND PROGRAMMING REQUIREMENTS TO BE COORDINATED WITH THE SUPPLIER FOR THE SYSTEM USED.

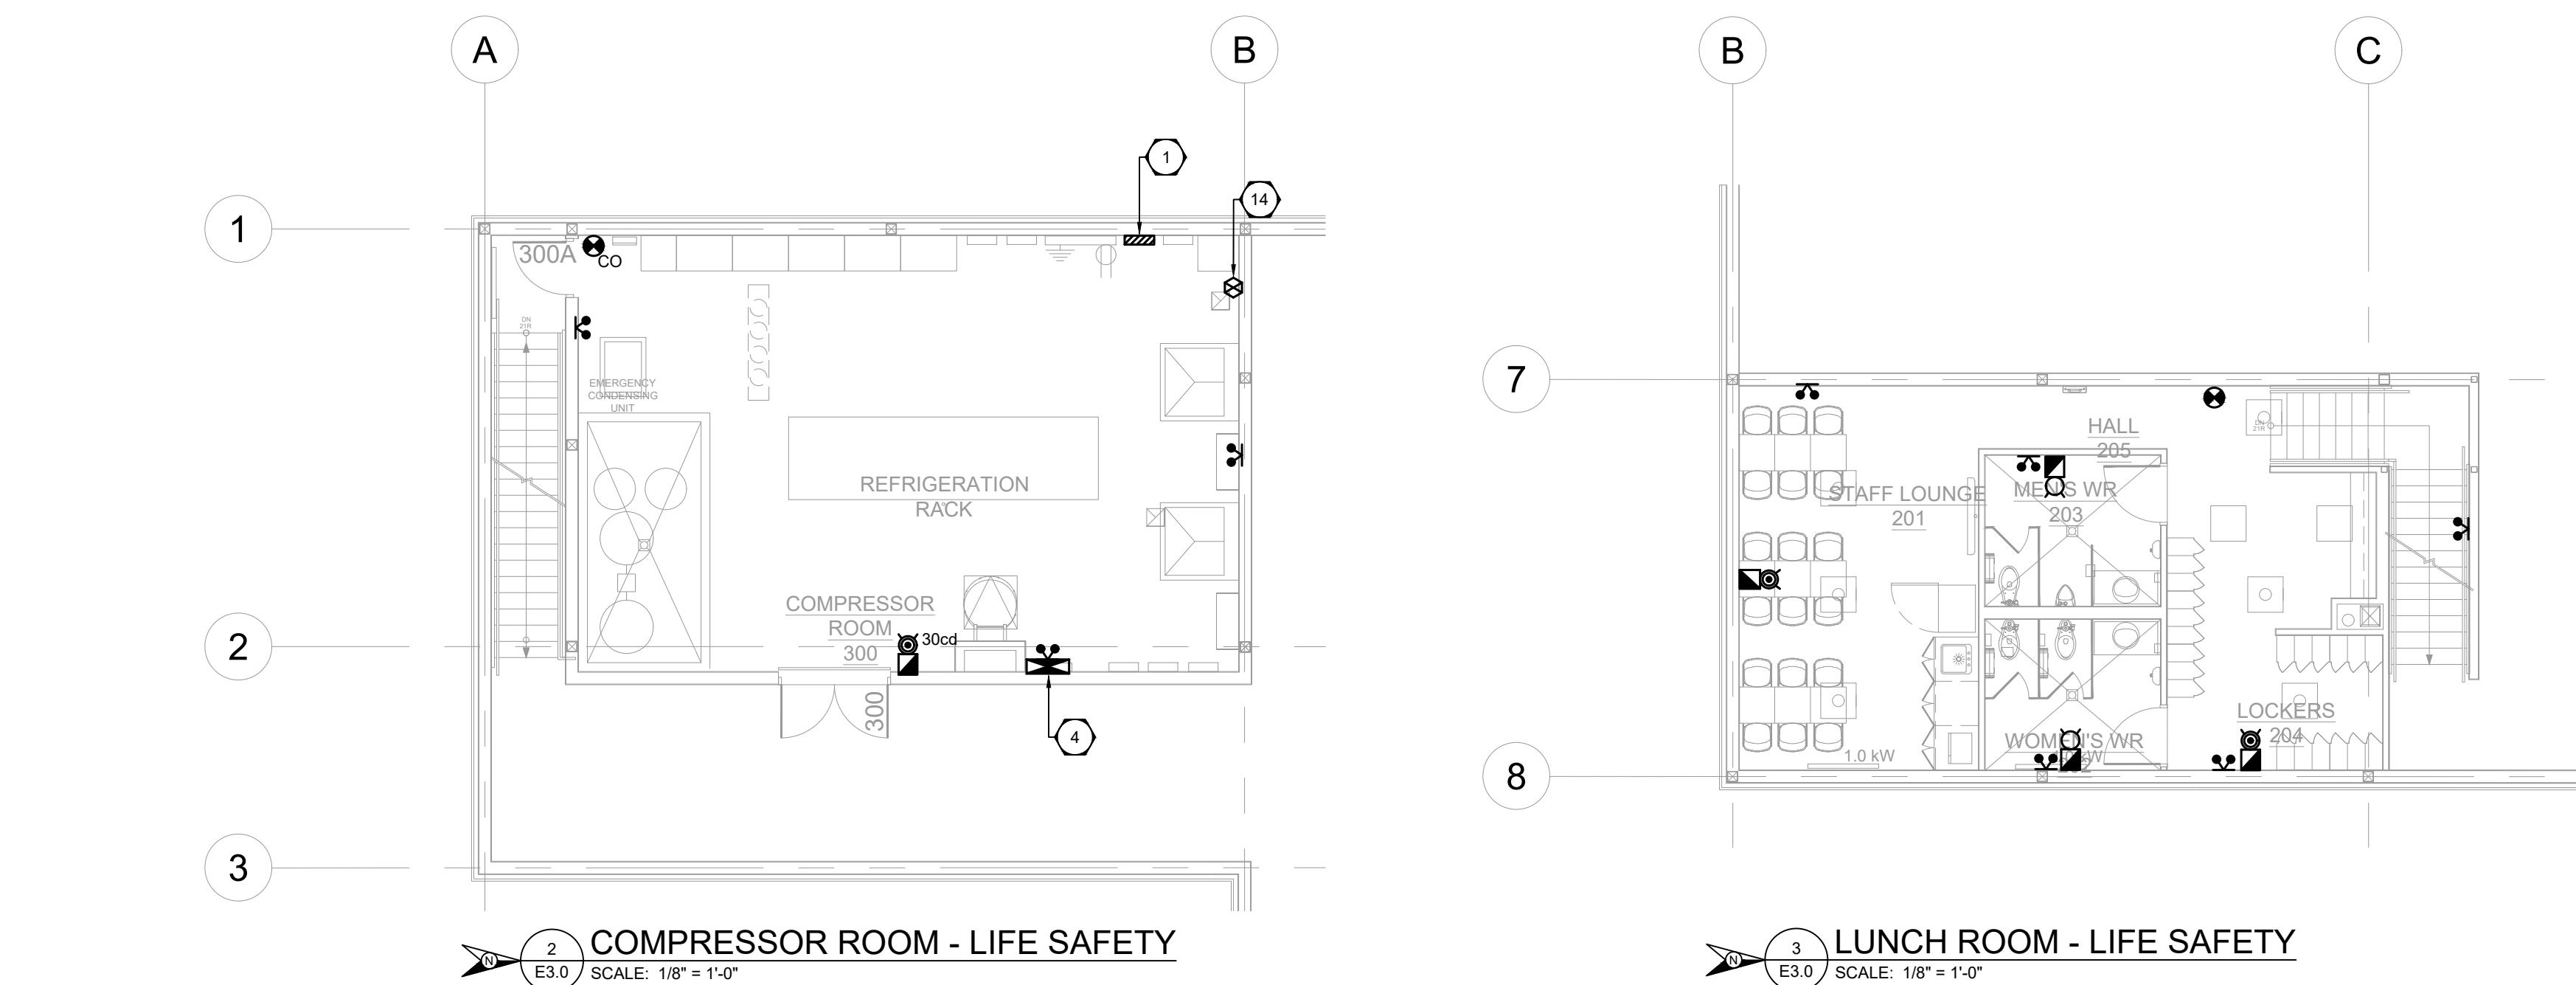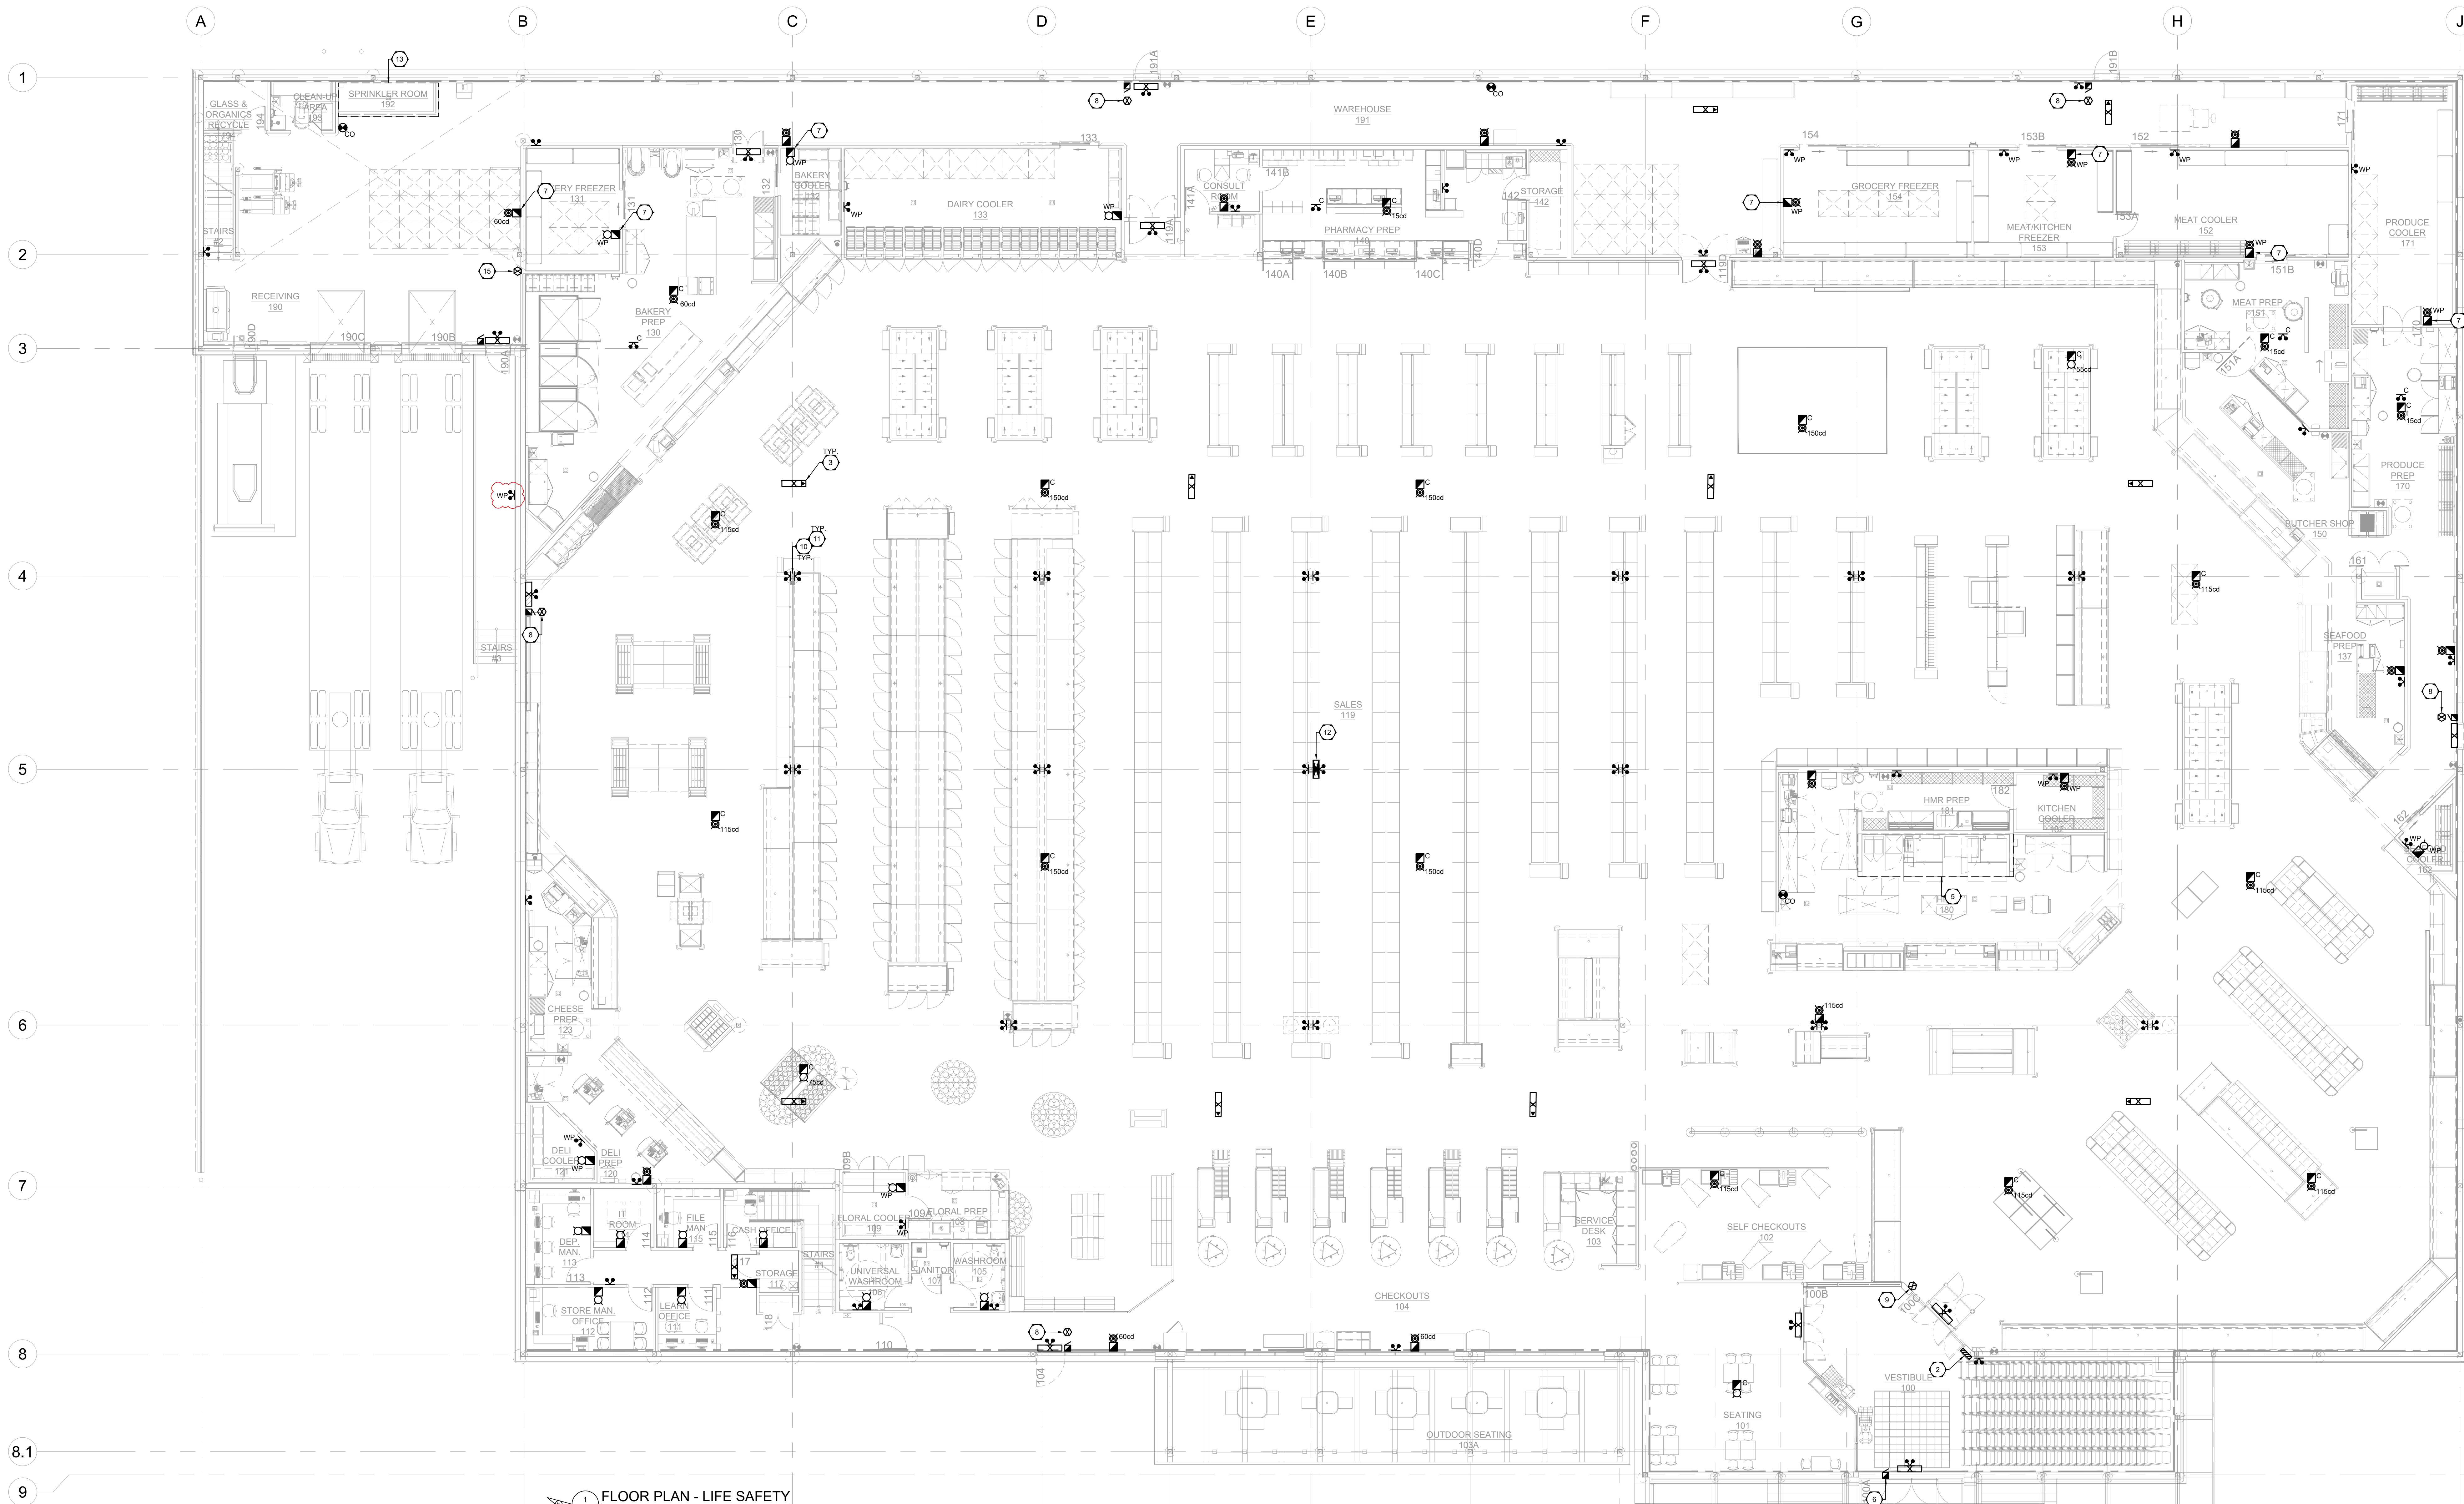

GENERAL NOTES

- ELECTRICAL CONTRACTOR TO PROVIDE AND INSTALL ALL CIRCUITS FOR SIGNALING/INITIATING DEVICES. VERTICAL RISER, CABLE TERMINATION AND OTHER DEVICES TO MAKE A FULLY FUNCTIONAL FIRE ALARM SYSTEM. SYSTEM CABLES TO BE INSTALLED IN ACCORDANCE WITH MANUFACTURER'S RECOMMENDATIONS.
- INSTALLATION OF NEW FIRE ALARM SYSTEM SHALL COMPLY WITH CANULC-5524-A.
- ALL CONDUITS SHALL BE 21mm (MINIMUM DIAMETER). UPRISE CONDUIT SIZE AS NECESSARY AND COMPLY WITH CEC ALLOWABLE CONDUIT FILL TO ACCOMMODATE ALL REQUIRED WIRING.
- REFER TO SPRINKLER DIAGRAM AND MECHANICAL DRAWING FOR ACTUAL QUANTITY AND EXACT LOCATION OF ASSOCIATED DEVICES.
- THE TESTING AND VERIFICATION OF ALL FIRE ALARM CIRCUITS AND DEVICES (COMBINATION OF EXISTING AND NEW ONES) SHALL BE UNDER THIS CONTRACT.

3	PCN-02	2025.04.23	KC
2	PCN-01	2025.04.04	KC
1	CONSTRUCTION	2025.03.25	KC

No. ISSUED FOR: DATE: BY:

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PRINTING DATE: APRIL 23, 2025

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PROJECT TITLE:

**AURORA GROCERY
STORE**
2000 ANAQUOD ROAD
REGINA, SASKATCHEWAN

SHEET TITLE:
**FLOOR PLAN - LIFE
SAFETY**
COMMISSION NUMBER:
2445

SHEET NUMBER:
E3.0