

PROPOSED CHANGE NOTICE

2445-13

No work is to be done before this matter is finalized and a "Change Order" is issued. This copy to remain with your office. Do not return. Contractor to submit signed letter with price including cost breakdown and change (if any) to construction schedule. Authority having Jurisdiction shall advise of any objections.

TO: QUOREX CONSTRUCTION SERVICES LTD.
 1630A 8th Avenue,
 Regina, SK S4R 1E5

RE: AURORA FOOD STORE
 2000 ANAQUOD ROAD
 REGINA, SK
 Commission No. 2445


DATE: June 5, 2025

PAGES: 18 (including cover)

RE: Building Permit / Misc Modifications

1.0 ARCHITECTURAL

- a) Adjust width of main floor office hallway below staff mezzanine.
- b) Convert 'Storage Room #117' into a small staff room. Add furring wall at RWL. Add microwave and sink in this space, delete door and provide credit.
- c) Modify Floral and Customer Service Desk millwork to have barrier-free counter.
- d) Delete furring wall behind 3-compartment sink in Meat Prep cooler box. Pipes to be surface mounted and insulated. Provide credit.

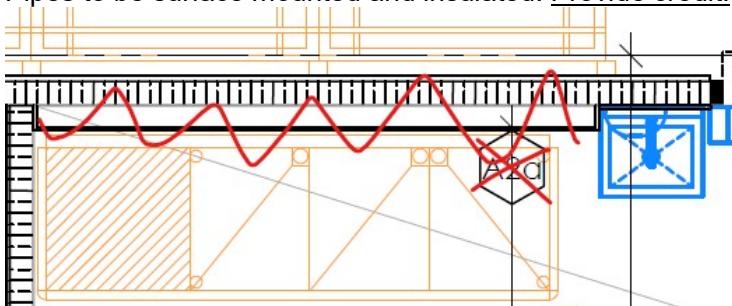


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 CGM Engineering – Tony Mitousis
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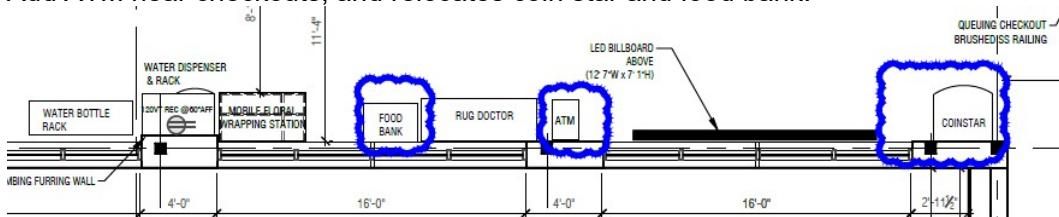
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Principal
 Kevin Fawley, SAA MRAIC

- e) Add full height 3 5/8" wall <A2> behind refrigerated case south side of Butcher Shop. Modify location of handsink. Provide white FRP at Butcher Shop side. Provide stainless steel cap at end of wall.



- f) Owner supplied locker added to Learn Office #111.
 g) Butcher Shop and Seafood Prep ceilings to be T-bar/ACT instead of insulated cooler panel ceiling.
 h) Add ATM near checkouts, and relocates coin star and food bank:

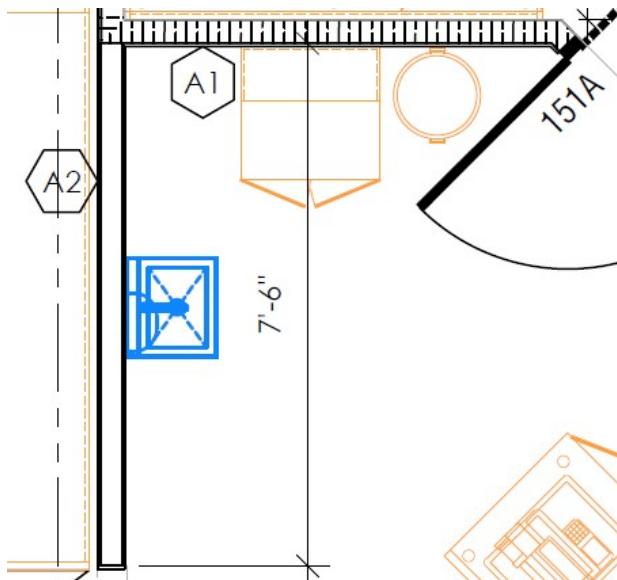


- i) Replace the following full size drawings with the attached dated May 29, 2025:
- A2.1 LARGE SCALE PLAN
 - A3.0 REFLECTED CEILING PLAN
 - A8.2 CUSTOMER SERVICE MILLWORK
 - A8.3 FLORAL MILLWORK
 - A8.4 STAFF MILLWORK

2.0 MECHANICAL

- .1 Refer to attached Mechanical PCN #01, dated June 4, 2025.
 (1 page text, 4 detail pages MP-01A, MP-01B, MP-01C, MP-01D).

3.0 ELECTRICAL

- .1 Refer to attached Electrical PCN #6, dated June 5, 2025.
 (1 page text, 5 full size drawings E0.2, E0.3, E1.0, E2.0, E5.0)

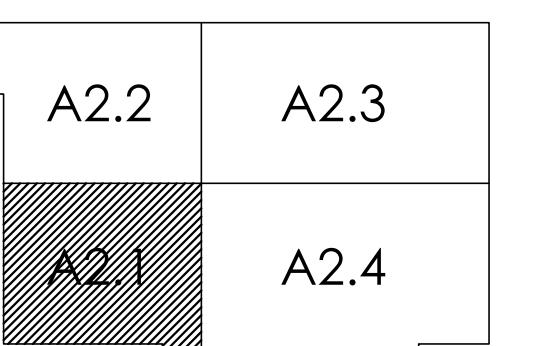

KEY PLAN

LARGE SCALE PLAN LEGEND:

- DRAIN, REFER TO MECH.
- TRENCH DRAIN
- GREASE INTERCEPTOR
- FIRE EXTINGUISHER
- REFRIGERATION BENCH, REFER TO DETAILS COORDINATE WITH REFRIGERATION CONTRACTOR.
- REFRIGERATION LINE (CRAIGG MANUFACTURING CORP 24" x 24") COORDINATE WITH REFRIGERATION CONTRACTOR.
- REFRIGERATION LINE DROPS TO BE RUN WITHIN WALLS OR ENCLOSURES, SURFACE MOUNTED LINES ARE NOT ACCEPTABLE, COORDINATE WITH REFRIGERATION CONTRACTOR.
- COOLER / FREEZER WALLS
- ELECTRICAL PANEL
- WALKER DUCT, REFER TO ELECTRICAL AND STRUCTURAL.
- UNDERGROUND CONDUIT, REFER TO ELECTRICAL.
- REMOVABLE STAINLESS STEEL CASE GUARD TO BE SUPPLIED BY SOBEYS, REFER TO DETAILS BY GENERAL CONTRACTOR, REFER TO DETAIL ON A.7.
- STAINLESS STEEL COLUMN PROTECTION TO BE SUPPLIED AND INSTALLED BY THE GENERAL CONTRACTOR, REFER TO SOBEYS STANDARD DETAIL 9-14.
- FIXTURES / SHELVING / EQUIPMENT
- MEZZANINE ABOVE
- BULKHEAD ABOVE
- CONCRETE CURB
 - (1) REFER TO DETAIL ON A.7.0.
 - (2) REFER TO DETAIL ON A.7.0.
 - (3) REFER TO TYPICAL DETAIL B-03
 - (4) REFER TO TYPICAL DETAIL B-05
 - (5) REFER TO TYPICAL DETAIL B-07
 - (6) REFER TO TYPICAL DETAIL B-13 (SMALL CURB TO BE PLACED ON TOP OF EPOXY, PROVIDE BEAD OF SILICONE BEHIND COMPOSITE BOARD)
 - (7) REFER TO TYPICAL DETAIL B-14
 - (8) REFER TO TYPICAL DETAIL B-15
 - (9) REFER TO TYPICAL DETAIL B-16 (LARGE CURB TO BE PLACED ON TOP OF EPOXY, PROVIDE BEAD OF SILICONE BEHIND COMPOSITE BOARD).
- CURB GENERAL NOTES
 - 1) THERE SHOULD BE NO CURBS AT THE LOCATIONS OF COMPARTMENT SINKS, CURBS INTERFERE WITH LEGS OF SINKS.

CURB GENERAL NOTES:

1) THERE SHOULD BE NO CURBS AT THE LOCATIONS OF COMPARTMENT SINKS, CURBS INTERFERE WITH LEGS OF SINKS.

3 PON 2445-13
2 CONSTRUCTION APRIL 21, 2025 KF
1 CONSTRUCTION JANUARY 9, 2025 KF
No. ISSUED FOR DATE BY
DRAWN BY: RD
PRINTING DATE: MAY 29, 2025
STAMP

NEJMARK
ARCHITECT

2-54 Adelaide Street Winnipeg Manitoba R3A 0V7
P.204 947 3775 F.204 947 3780 www.nejmark.mb.ca

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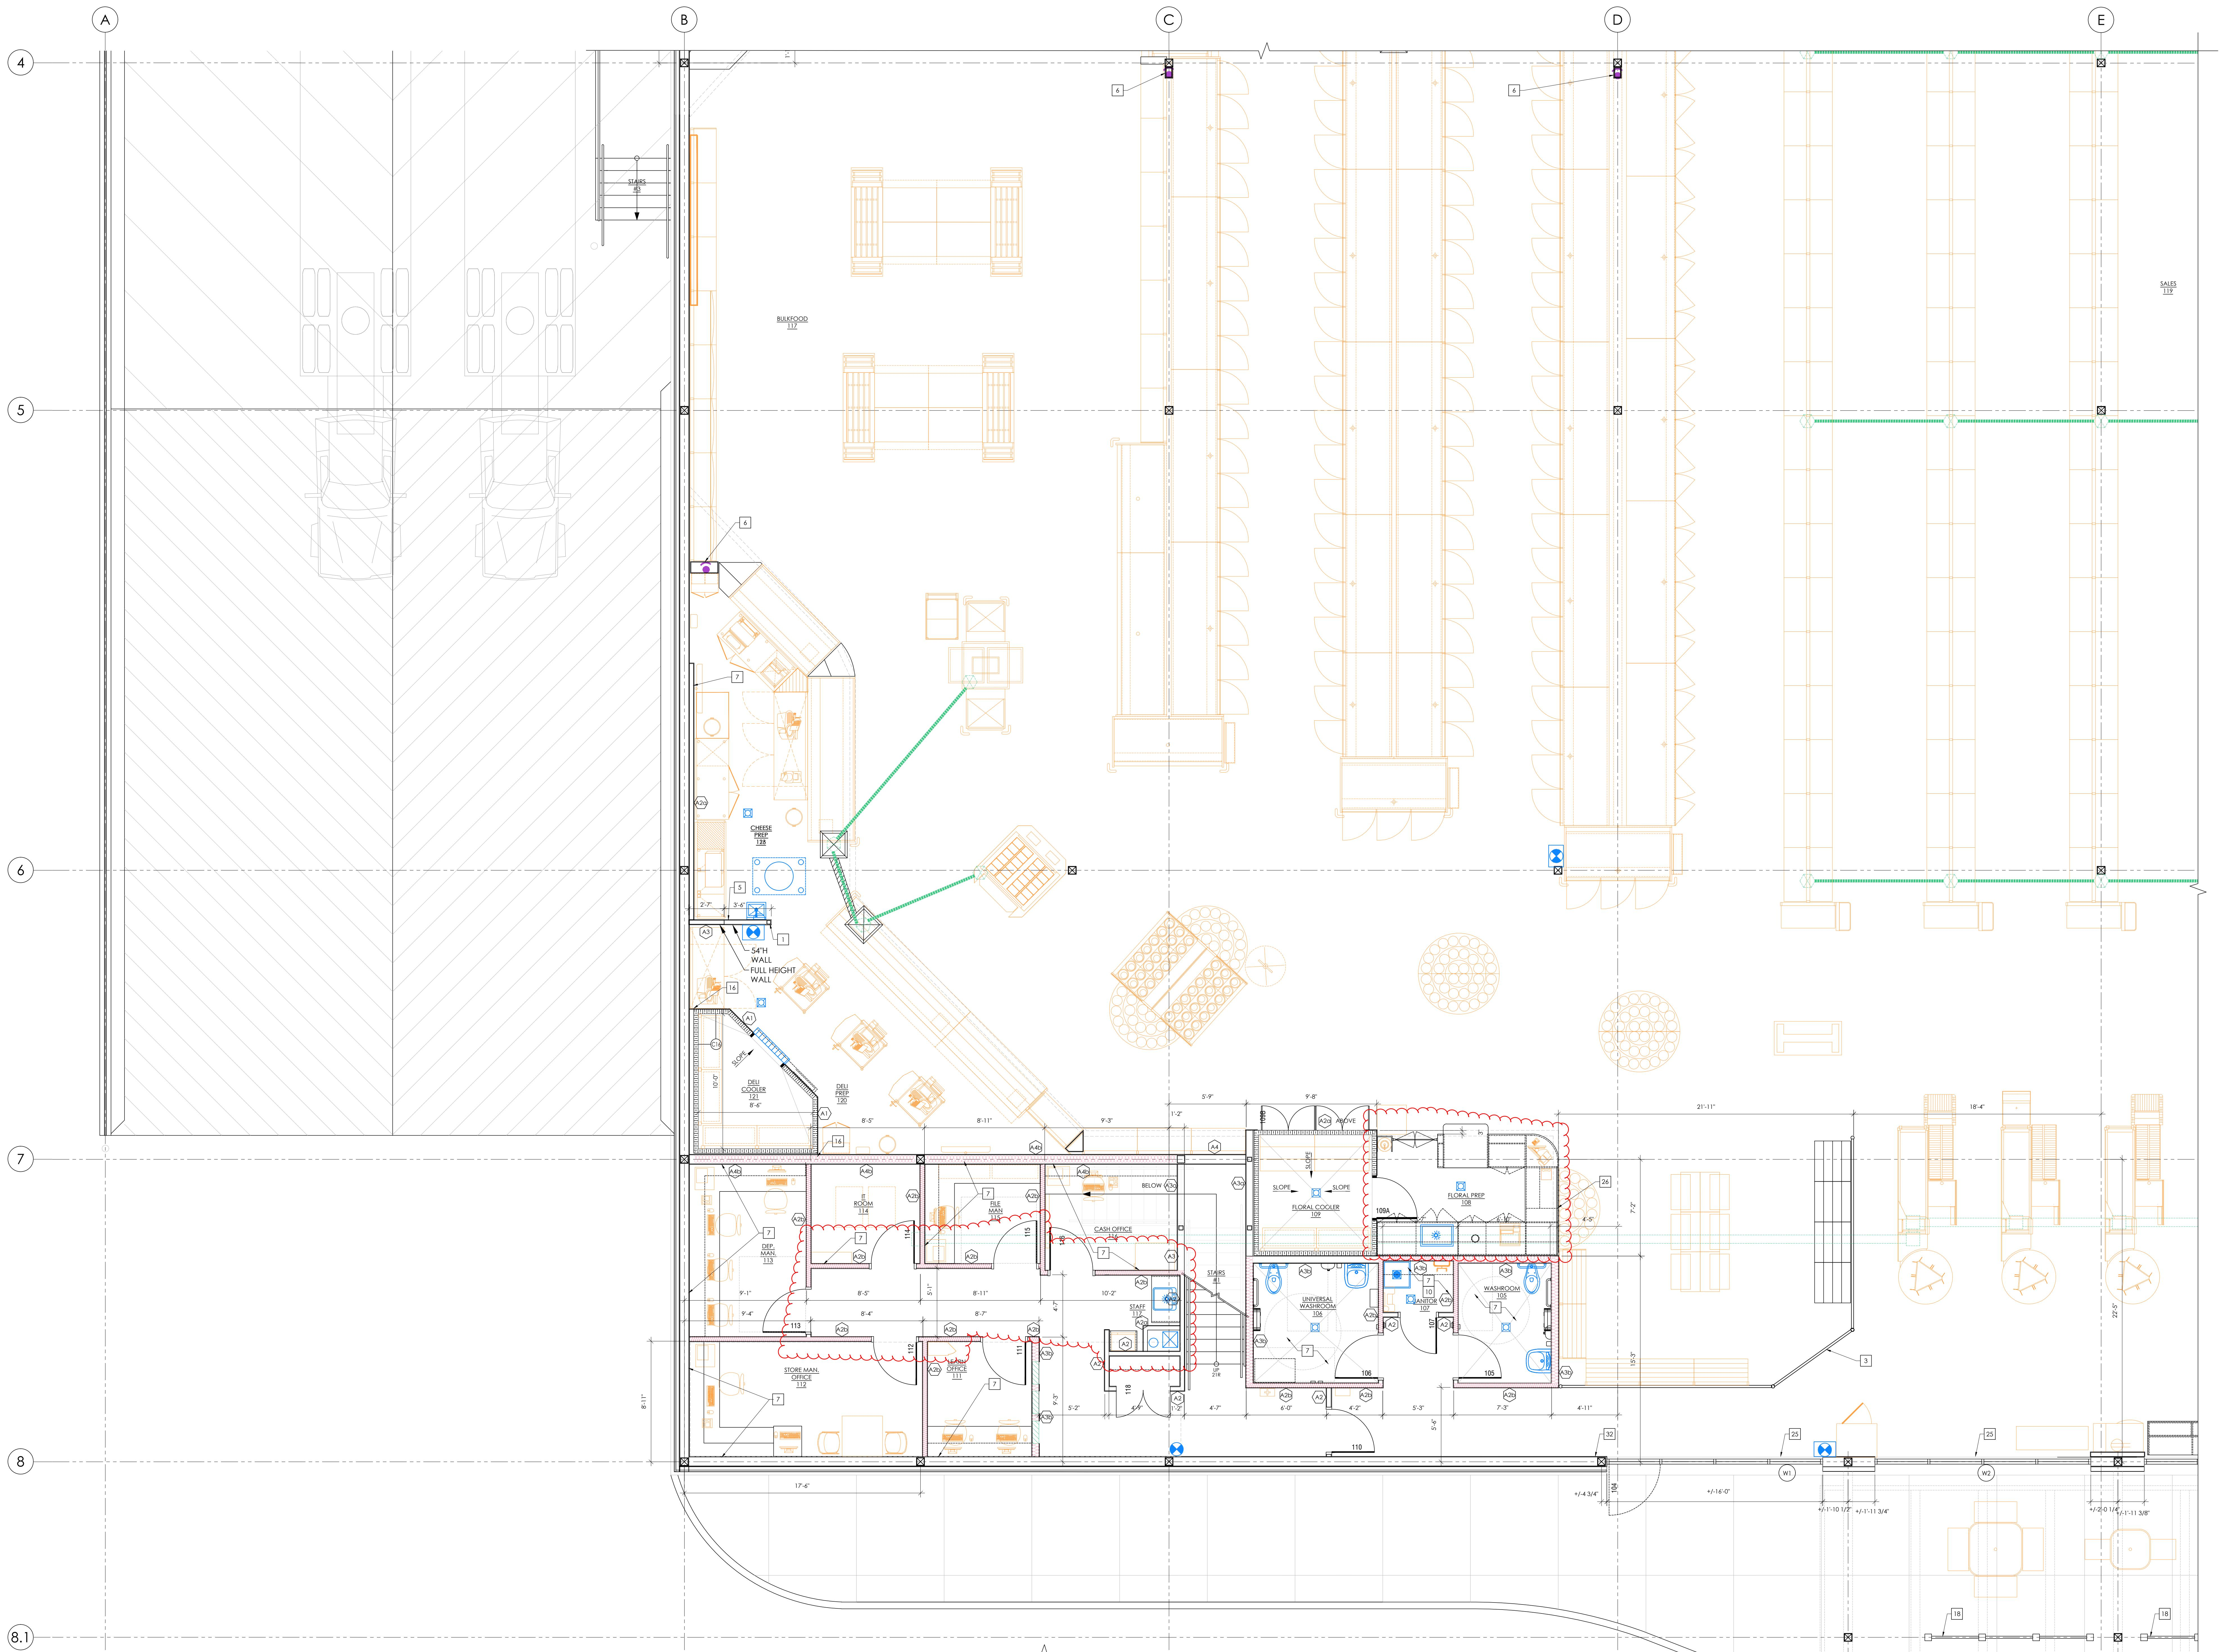
PROJECT TITLE:

AURORA GROCERY STORE
2000 ANAQUD ROAD
REGINA, SASKATCHEWAN

SHEET TITLE:
LARGE SCALE PLAN

COMMISSION NUMBER:
2445 SHEET NUMBER:
A2.1

FILE: 2445 A2.1-5 - LARGE SCALE PLANS.DWG




SOUTH EAST
SCALE: 1/4" = 1'-0"

LARGE SCALE PLAN KEYNOTES:

- 1 VERTICAL HSS INSIDE PONY WALL REFER TO STRUCTURAL.
- 2 SECURITY GATE TIED TO FIRE ALARM, SOBEYS SUPPLIED, GC INSTALLED.
- 3 BRASSON CHROME POST & RAILING SYSTEM, "B" STANDARD.
- 4 ROLLING SECURITY GRILLE, REFER TO DETAIL ON A.7.2.
- 5 PONY WALL C/W STAINLESS STEEL CAP, PROVIDE VERTICAL STEEL SUPPORT, REFER TO STRUCTURAL.
- 6 ENCLOSURE FOR REFRIGERATION LINE(S), REFER TO DETAILS ON A.7.1.
- 7 PROVIDE BLOCKING/BACKING IN WALL FOR FIXTURE/MILLWORK/SHELVING.
- 8 CONCRETE CURB C/W REMOVABLE STEEL HANDRAIL, REFER TO DRAWING A.7.1.
- 9 12" X 12" CONCRETE FOR HIGH VOLTAGE ELECTRICAL SUPPLY.
- 10 FIRESTOP ALL PENETRATIONS THROUGH WALLS, WALLS TO BE FULL HEIGHT.
- 11 IMPACT DOOR AND FRAME, REFER TO DETAILS ON A.7.1.
- 12 STEEL ANGLE IN DAIRY COOLER, REFER TO DETAIL ON A.7.2.
- 13 HYDRAULIC DOCK LEVELER.
- 14 DOCK SEAL (C/W CURTAIN) AND BUMPERS.
- 15 TRACK GUARD STEEL ANGLE BOTH SIDES OF OYVOD, PAINTED YELLOW, REFER TO PLAN DETAIL.
- 16 COOLER/FREEZER PANEL CLOSURE, REFER TO DETAIL ON A.7.1.
- 17 CONCRETE HOUSE KEEPING PAD BELOW TRANSFORMER.
- 18 C.J.LAURENCE ALUMINUM RAILING SYSTEM, 48" HIGH, CLEAR ANODIZED ALUMINUM C/W 1/2" TEMPERED GLASS PANELS.
- 19 SAFETY BAR, REFER TO DETAIL ON A.9.0.
- 20 ROOF LADDER.
- 21 STAINLESS STEEL SHROUD, REFER TO A.7.0.
- 22 PROVIDE 2" PVC SLEEVE THROUGH MEZZANINE FLOOR TO RUN REFRIGERATION LINE, COORDINATE LOCATION WITH REFRIGERATION CONTRACTOR, PROVIDE FIRE STOPPING AFTER LINE INSTALLATION.
- 23 QUILING MERCHANDISERS (INTRAC STORE FIXTURES).
- 24 ROOF HATCH ABOVE.
- 25 MOTORISED ROLLER WINDOW SHADES, FABRIC COLOUR: SILVER BIRCH, REFER TO ELECTRICAL FOR POWER.
- 26 PPSA/S SUNLINE SERIES STRAIGHT FRONT PARTITION POSTS FROM CRL PRODUCTS, POSTS TO BE 3" X 3" BRUSHED STAINLESS STEEL FINISH C/W FLAT CAPS, INSTALLED ON FLORAL MILLWORK COUNTERTOP.
- 27 PPSA/S SUNLINE SERIES STRAIGHT FRONT PARTITION POSTS FROM CRL PRODUCTS, POSTS 1" DIA, POSTS 14" HIGH W/ BRUSHED STAINLESS STEEL FINISH C/W FLAT CAPS, INSTALLED ON FLORAL MILLWORK COUNTERTOP, COORDINATE WITH VC STORE FIXTURES INC.
- 28 ROOM PAINTED P/T AS PER ADDENDUM #6, REFER TO DECOR.
- 29 PROVIDE STRUCTURE TO SUPPORT ERV SUSPENDED FROM OWS, GC TO COORDINATE WITH OWS SUPPLIER AND STEEL SUPPLIER.
- 30 MOTORISED ROLLER WINDOW SHADES, FABRIC COLOUR: SILVER BIRCH, REFER TO ELECTRICAL FOR POWER.
- 31 CHAINLINK SEPARATION FENCE BETWEEN FREEZERS.
- 32 TACTILE EXIT DOOR SIGN.
- 33 ONE KEY SWITCH LOCATED AT CUSTOMER SERVICE DESK SHALL RELEASE/RESET ALL MAGNETIC LOCKS, MAGNETIC LOCKS SHALL BE SET TO REQUIRE MANUAL RESET, MAGNETIC LOCKS SHALL NOT BE SET TO AUTOMATIC RELEASE, MAGNETIC LOCK IS NOT ACCEPTABLE, DAY/NIGHT CONTROL SIGNALS AS REQUIRED, REFER TO ELECTRICAL.

REFLECTED CEILING PLAN LEGEND:

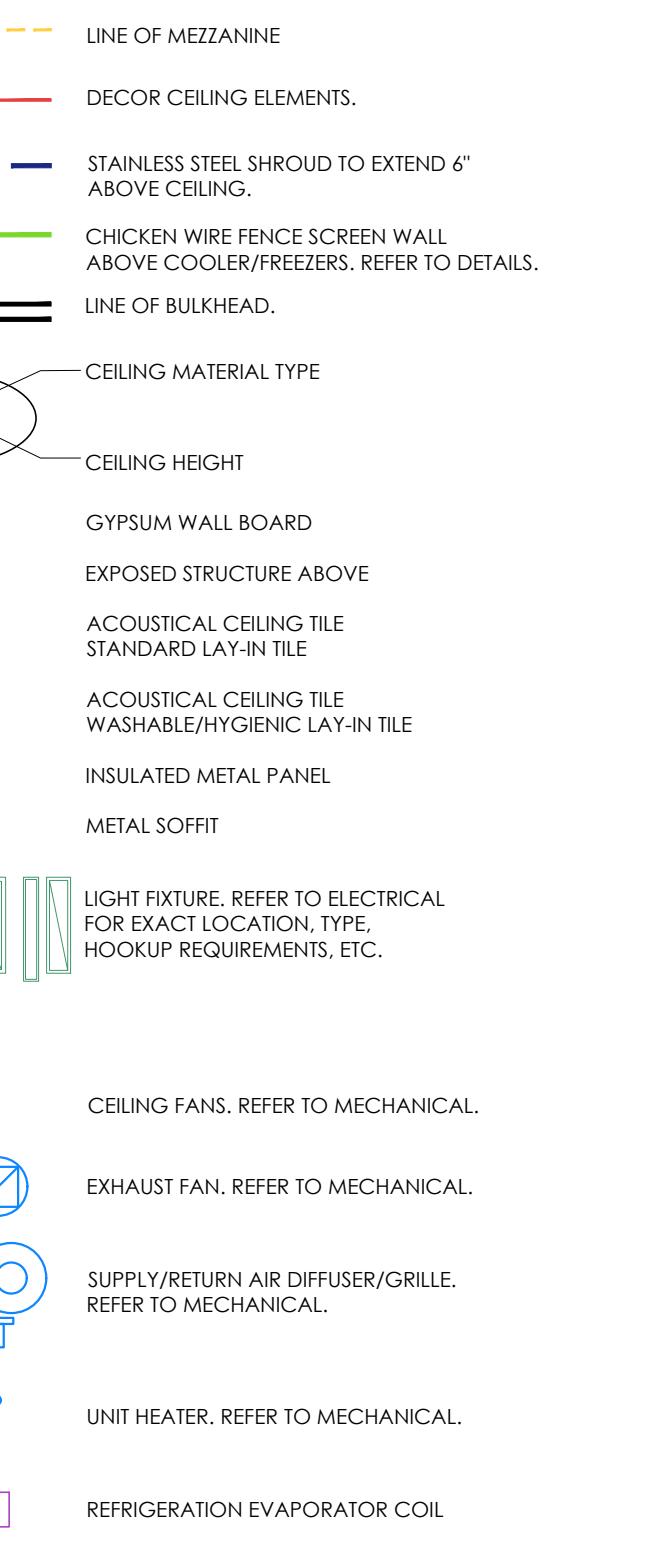

REFLECTED CEILING PLAN GENERAL NOTES:

- Mechanical & electrical fixtures are shown for information only. Refer to mechanical and electrical drawings for details.
- All ductwork is to be located between joists and is not to conflict with the lighting layout. Refer to mechanical and electrical drawings for details.
- Light fixtures in coolers are to be installed in conjunction with the refrigeration equipment.
- All bulkheads built above the coolers/freezers to the top of the roof deck are to be built after the installation of walk in coolers.
- Sprinkler heads above ovens and proofers shall be temperature appropriate.
- All exposed structures in sales floor to be painted | refer to finish schedule.
- All partitions/bulkheads between the sales area, back room areas, and cooler areas to be framed to US building structure, unless noted otherwise.
- Refer to interior elevations and signage drawing for all interior signage (including individual lettering, aisle directional, posters, wall mural, shelter, etc.).
- GC to coordinate refrigeration coil locations with lighting.

REFLECTED CEILING PLAN FEATURES:

- 1) VR track mounted at 15' 0" A.F.F.
- 2) Decor cloud suspended ceiling feature - Armstrong ceiling framework system.
- 3) Suspended decorative panels mounted at 15' 0" A.F.F. suspended from VR track. Refer to electrical for lighting.

3 PON 2445-13
2 CONSTRUCTION APRIL 21, 2025
1 CONSTRUCTION JANUARY 9, 2025
No. ISSUED FOR DATE BY
DRAWN BY: RD
PRINTING DATE: MAY 26, 2025
STAMP

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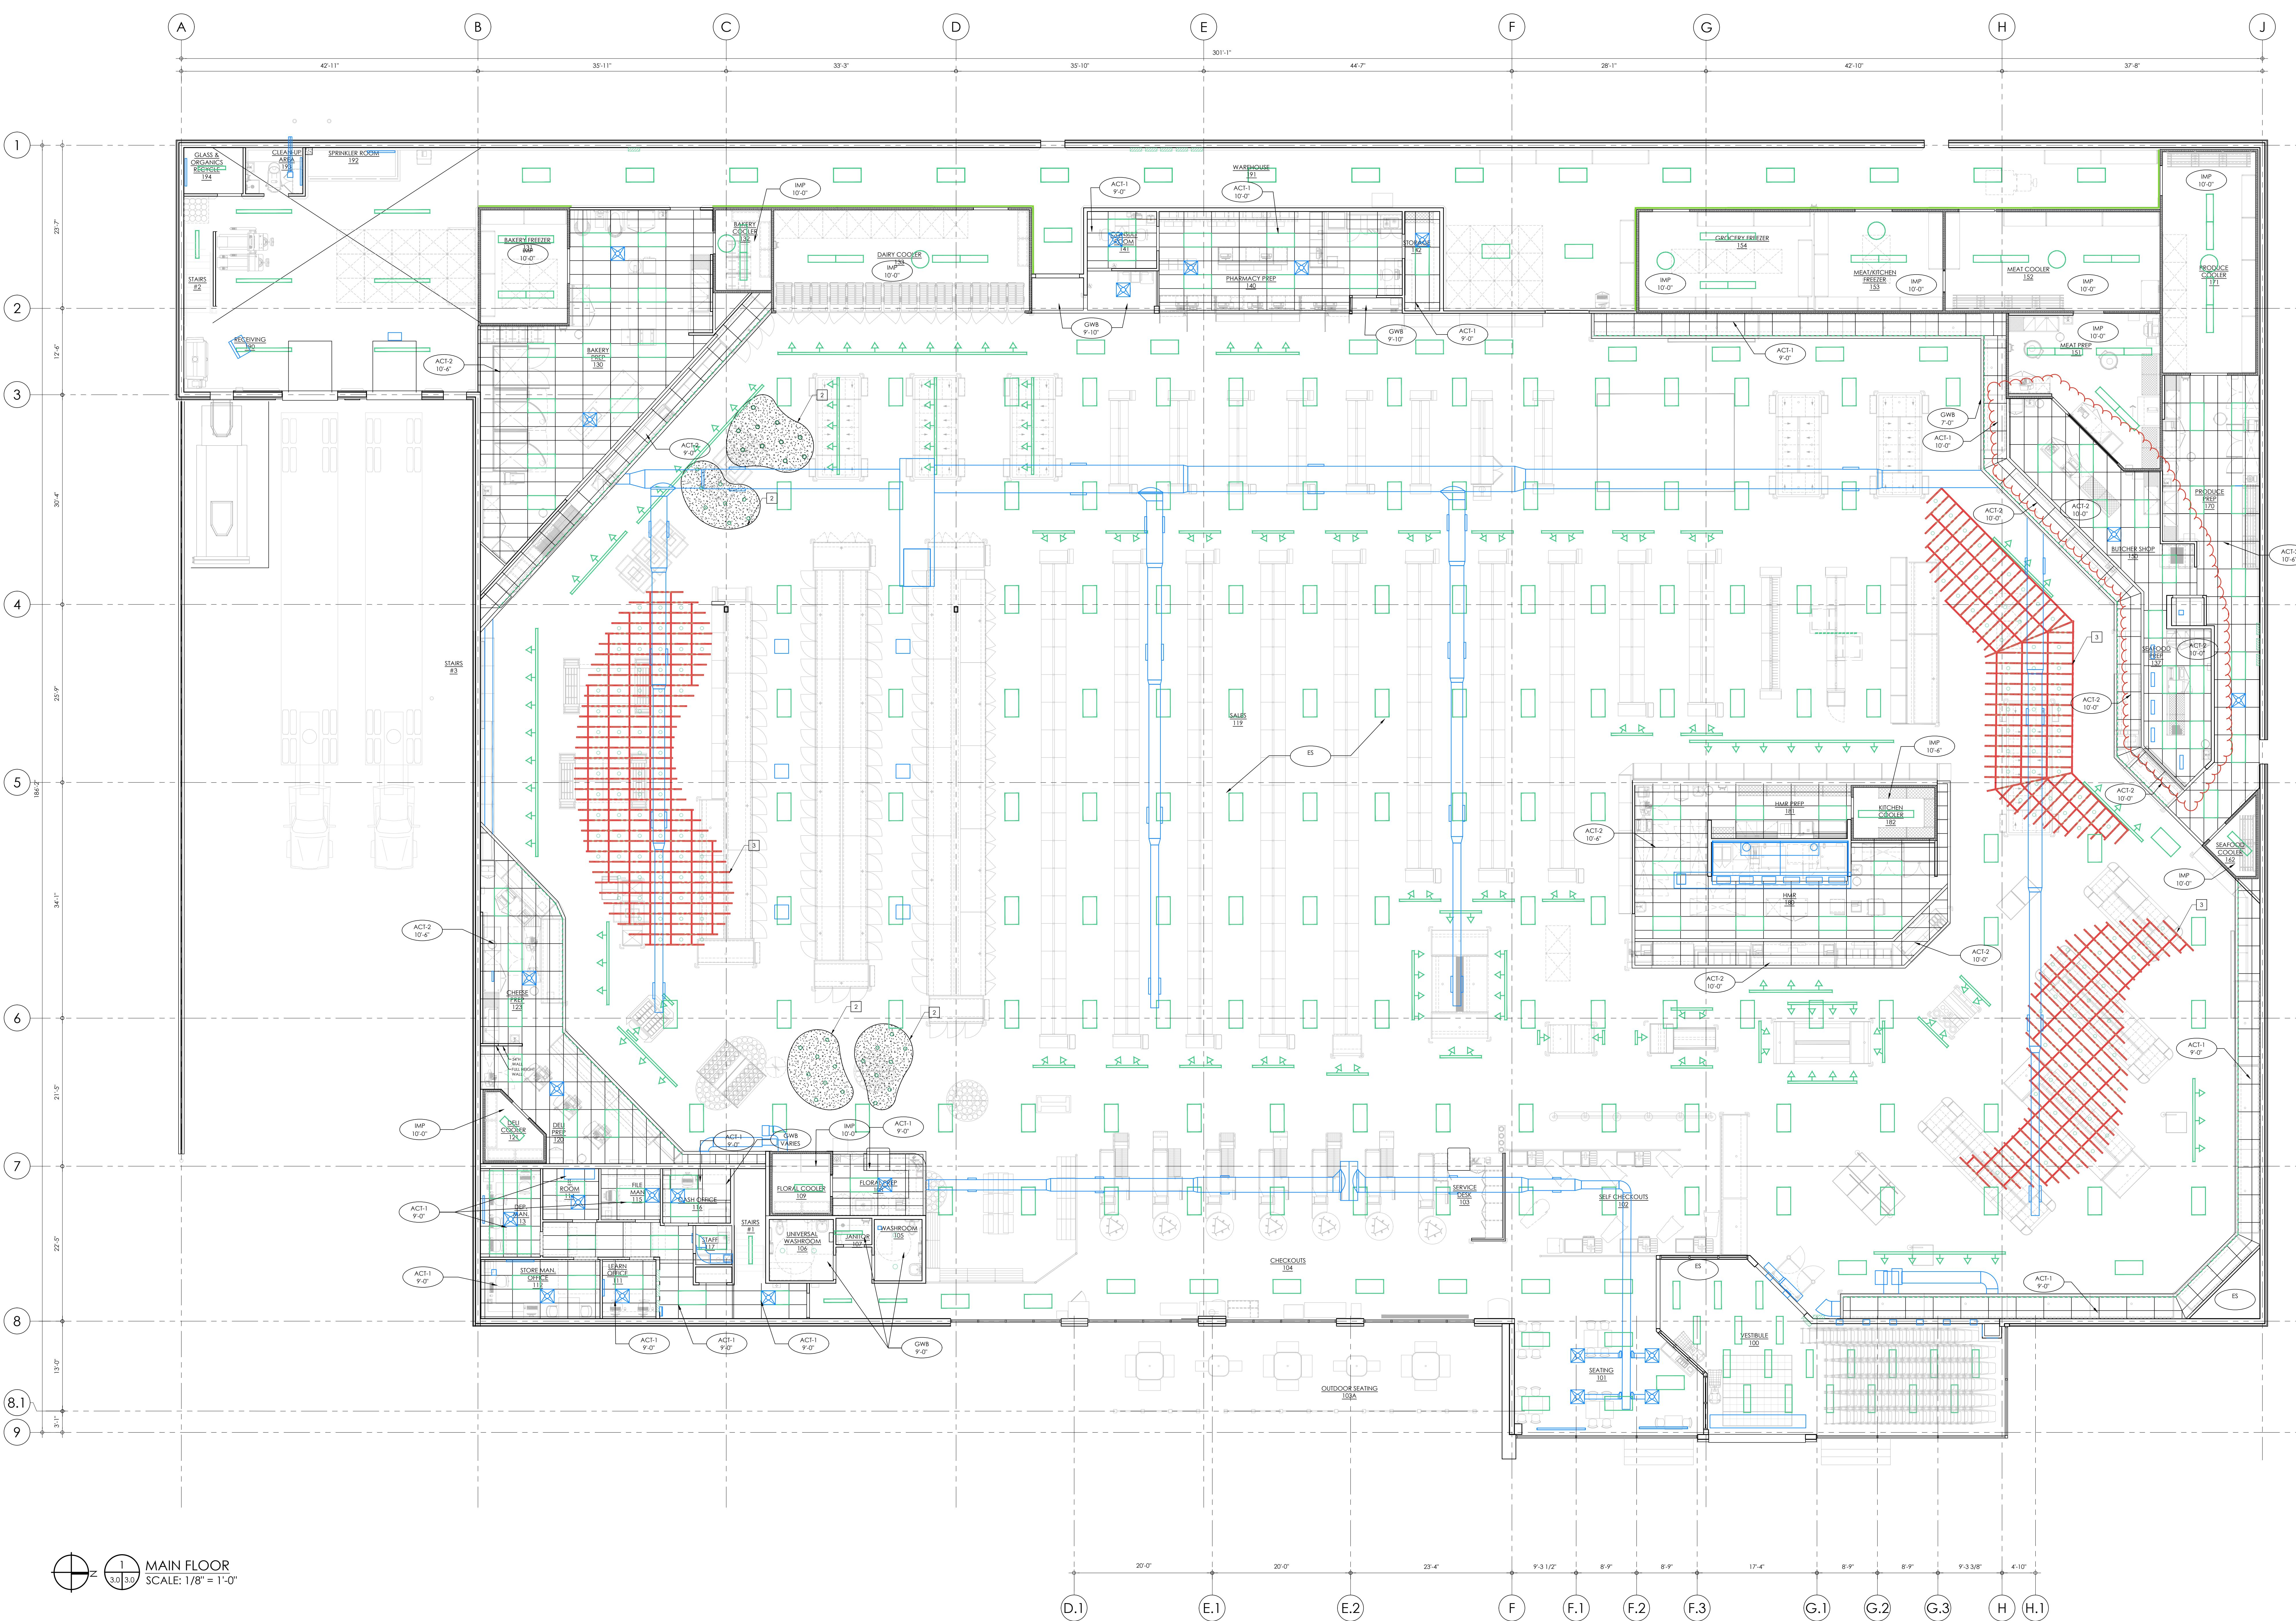
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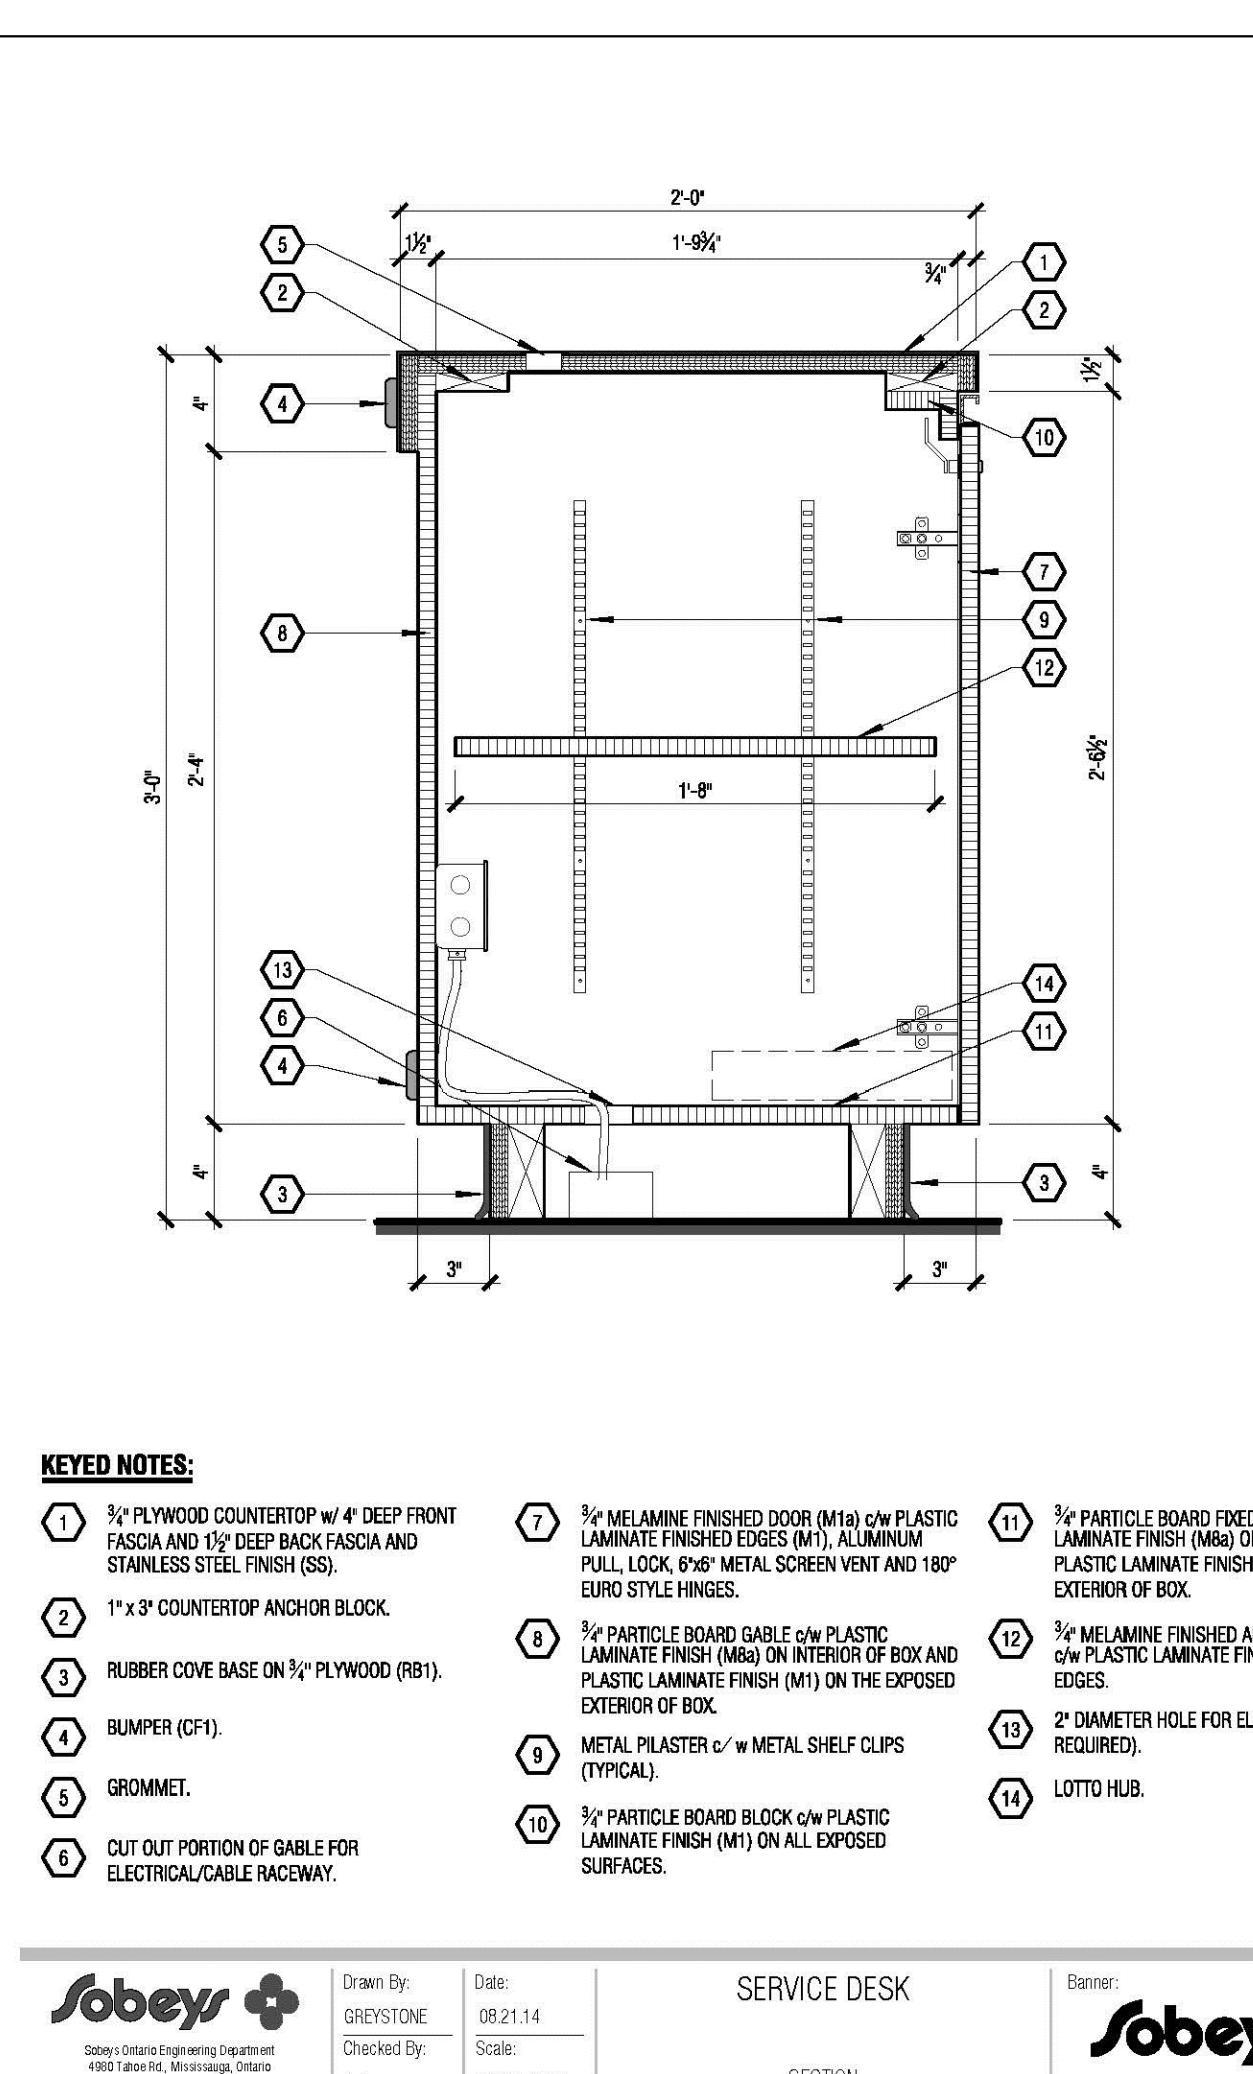
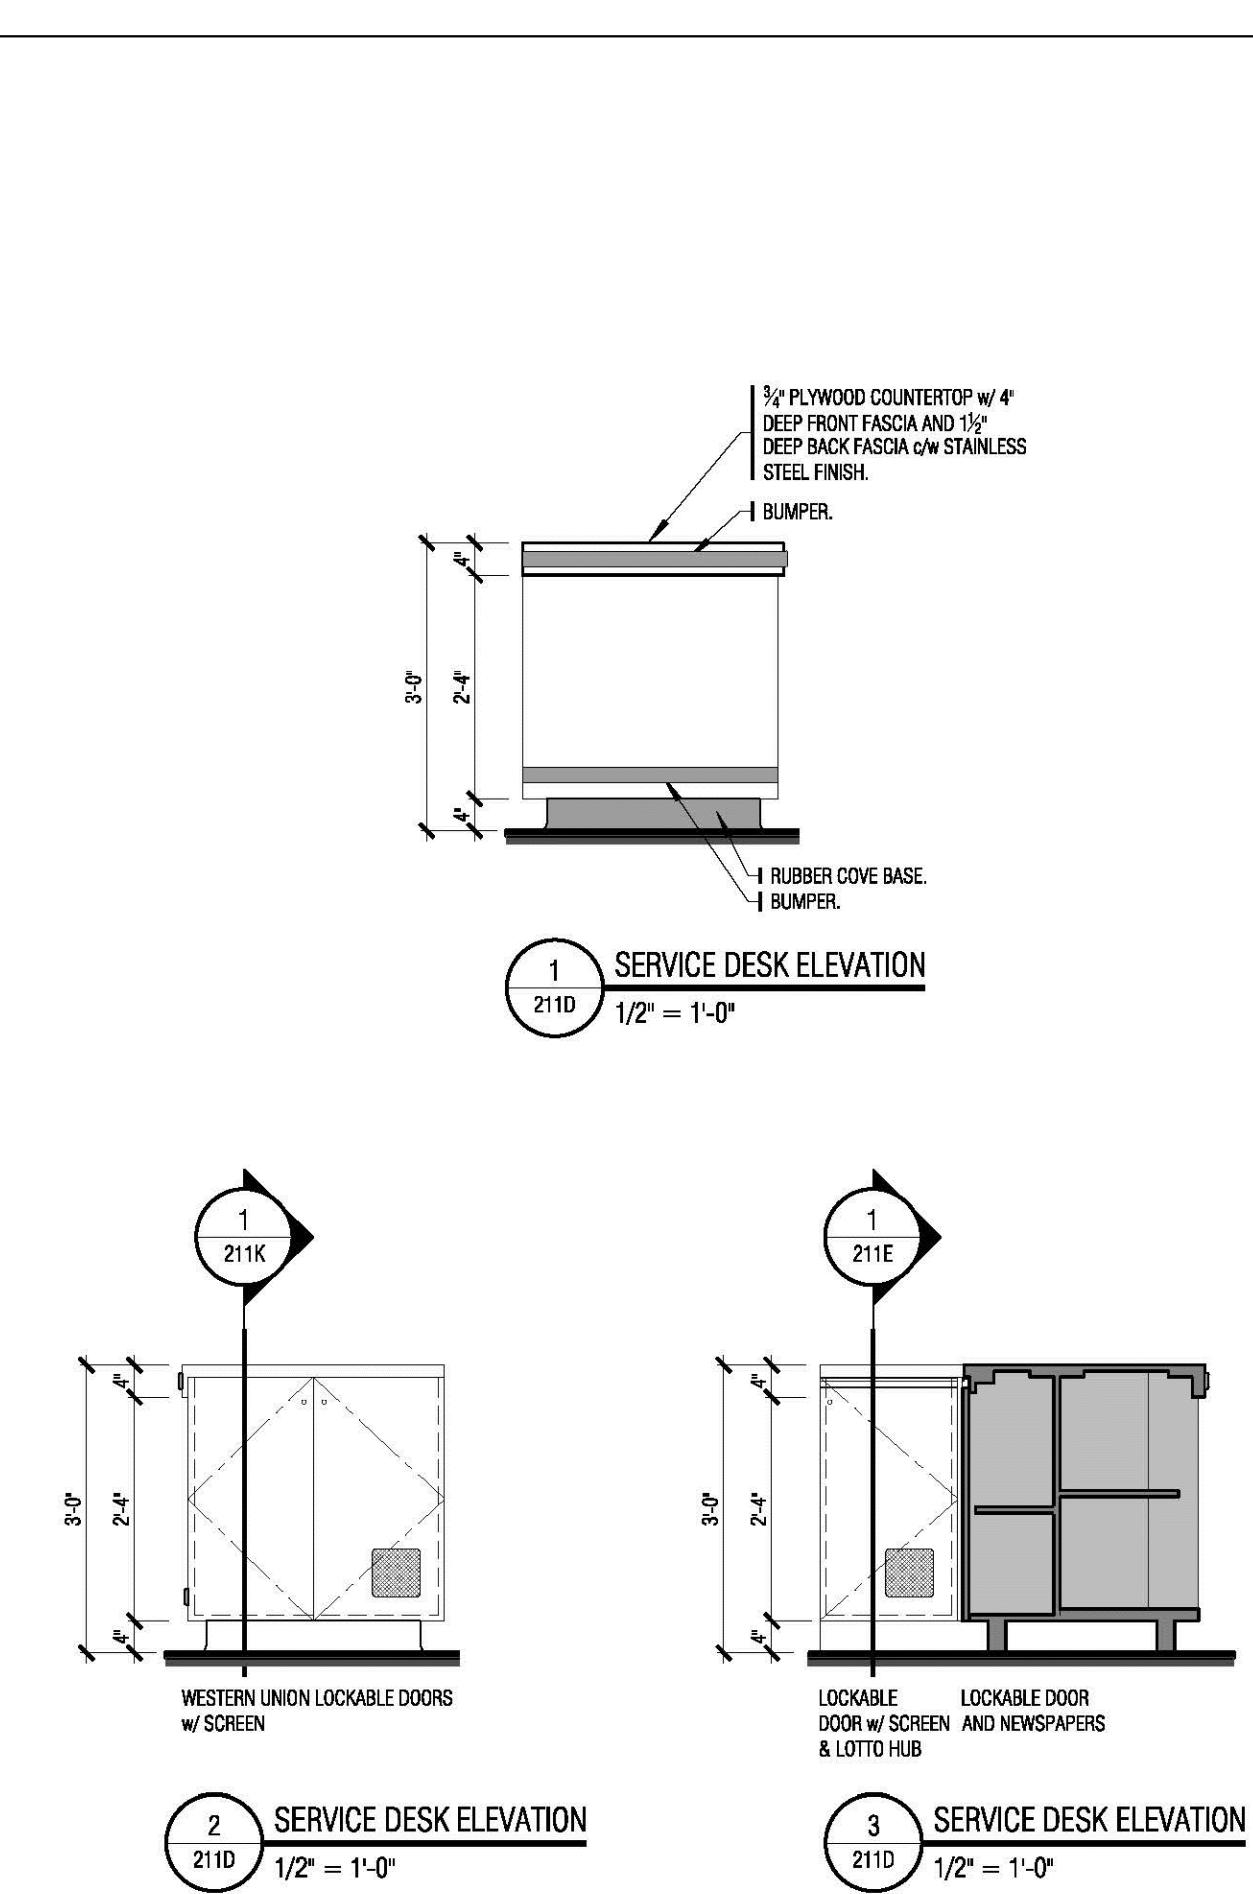
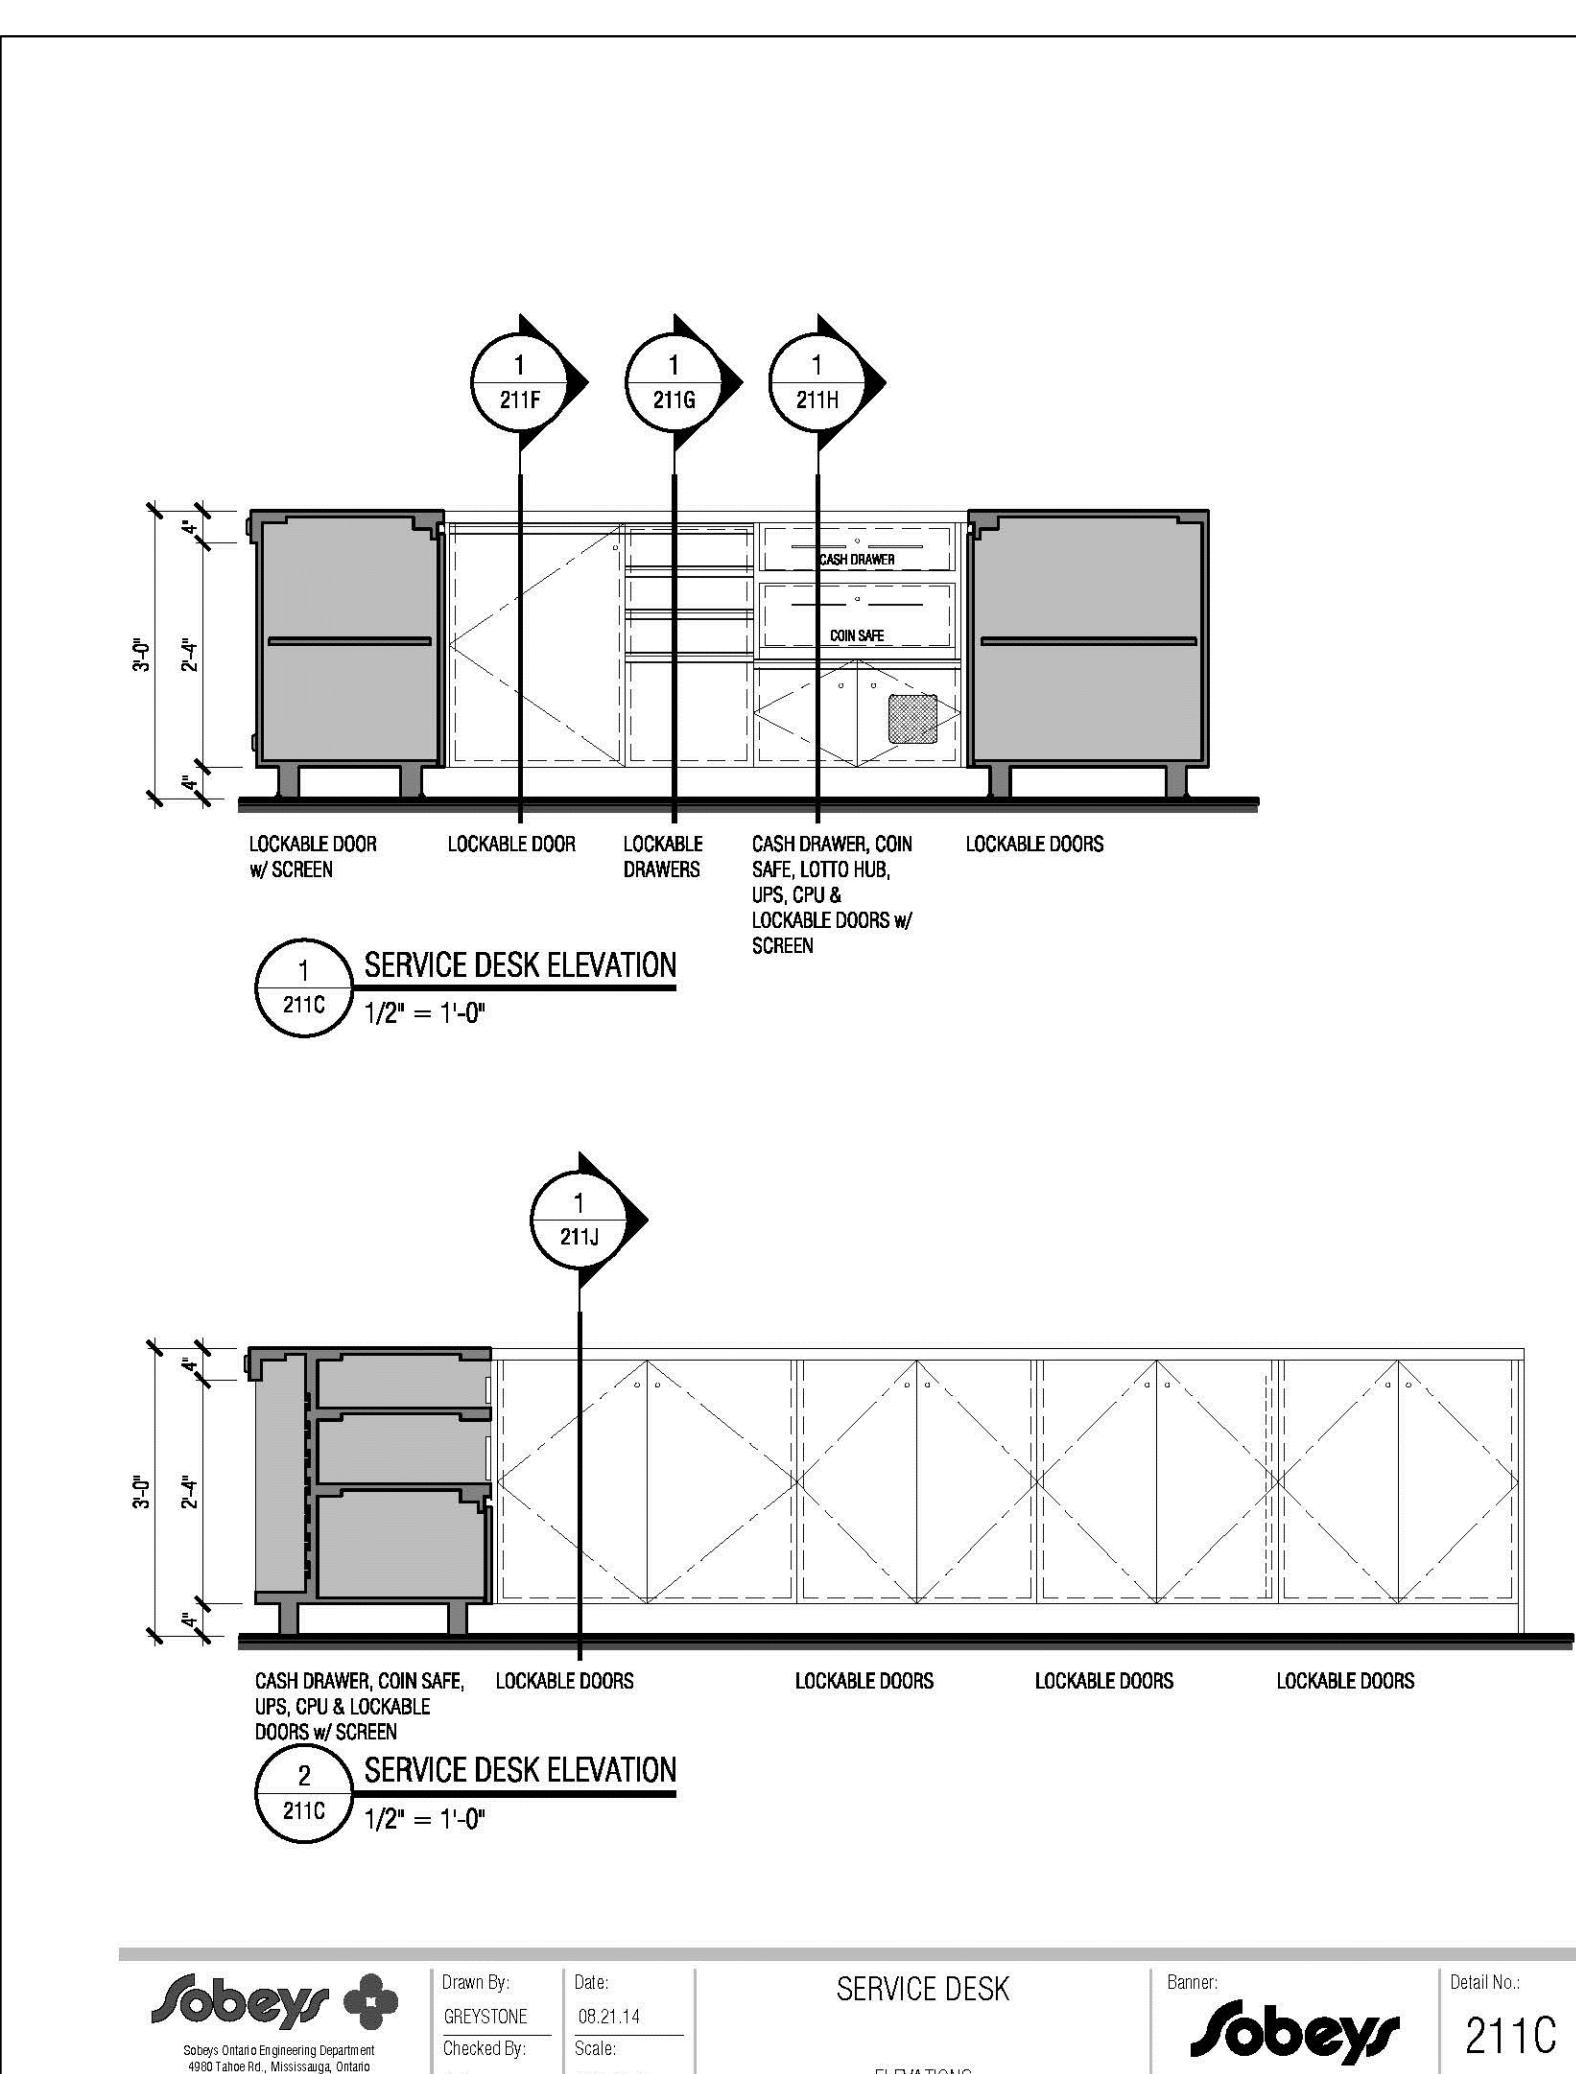
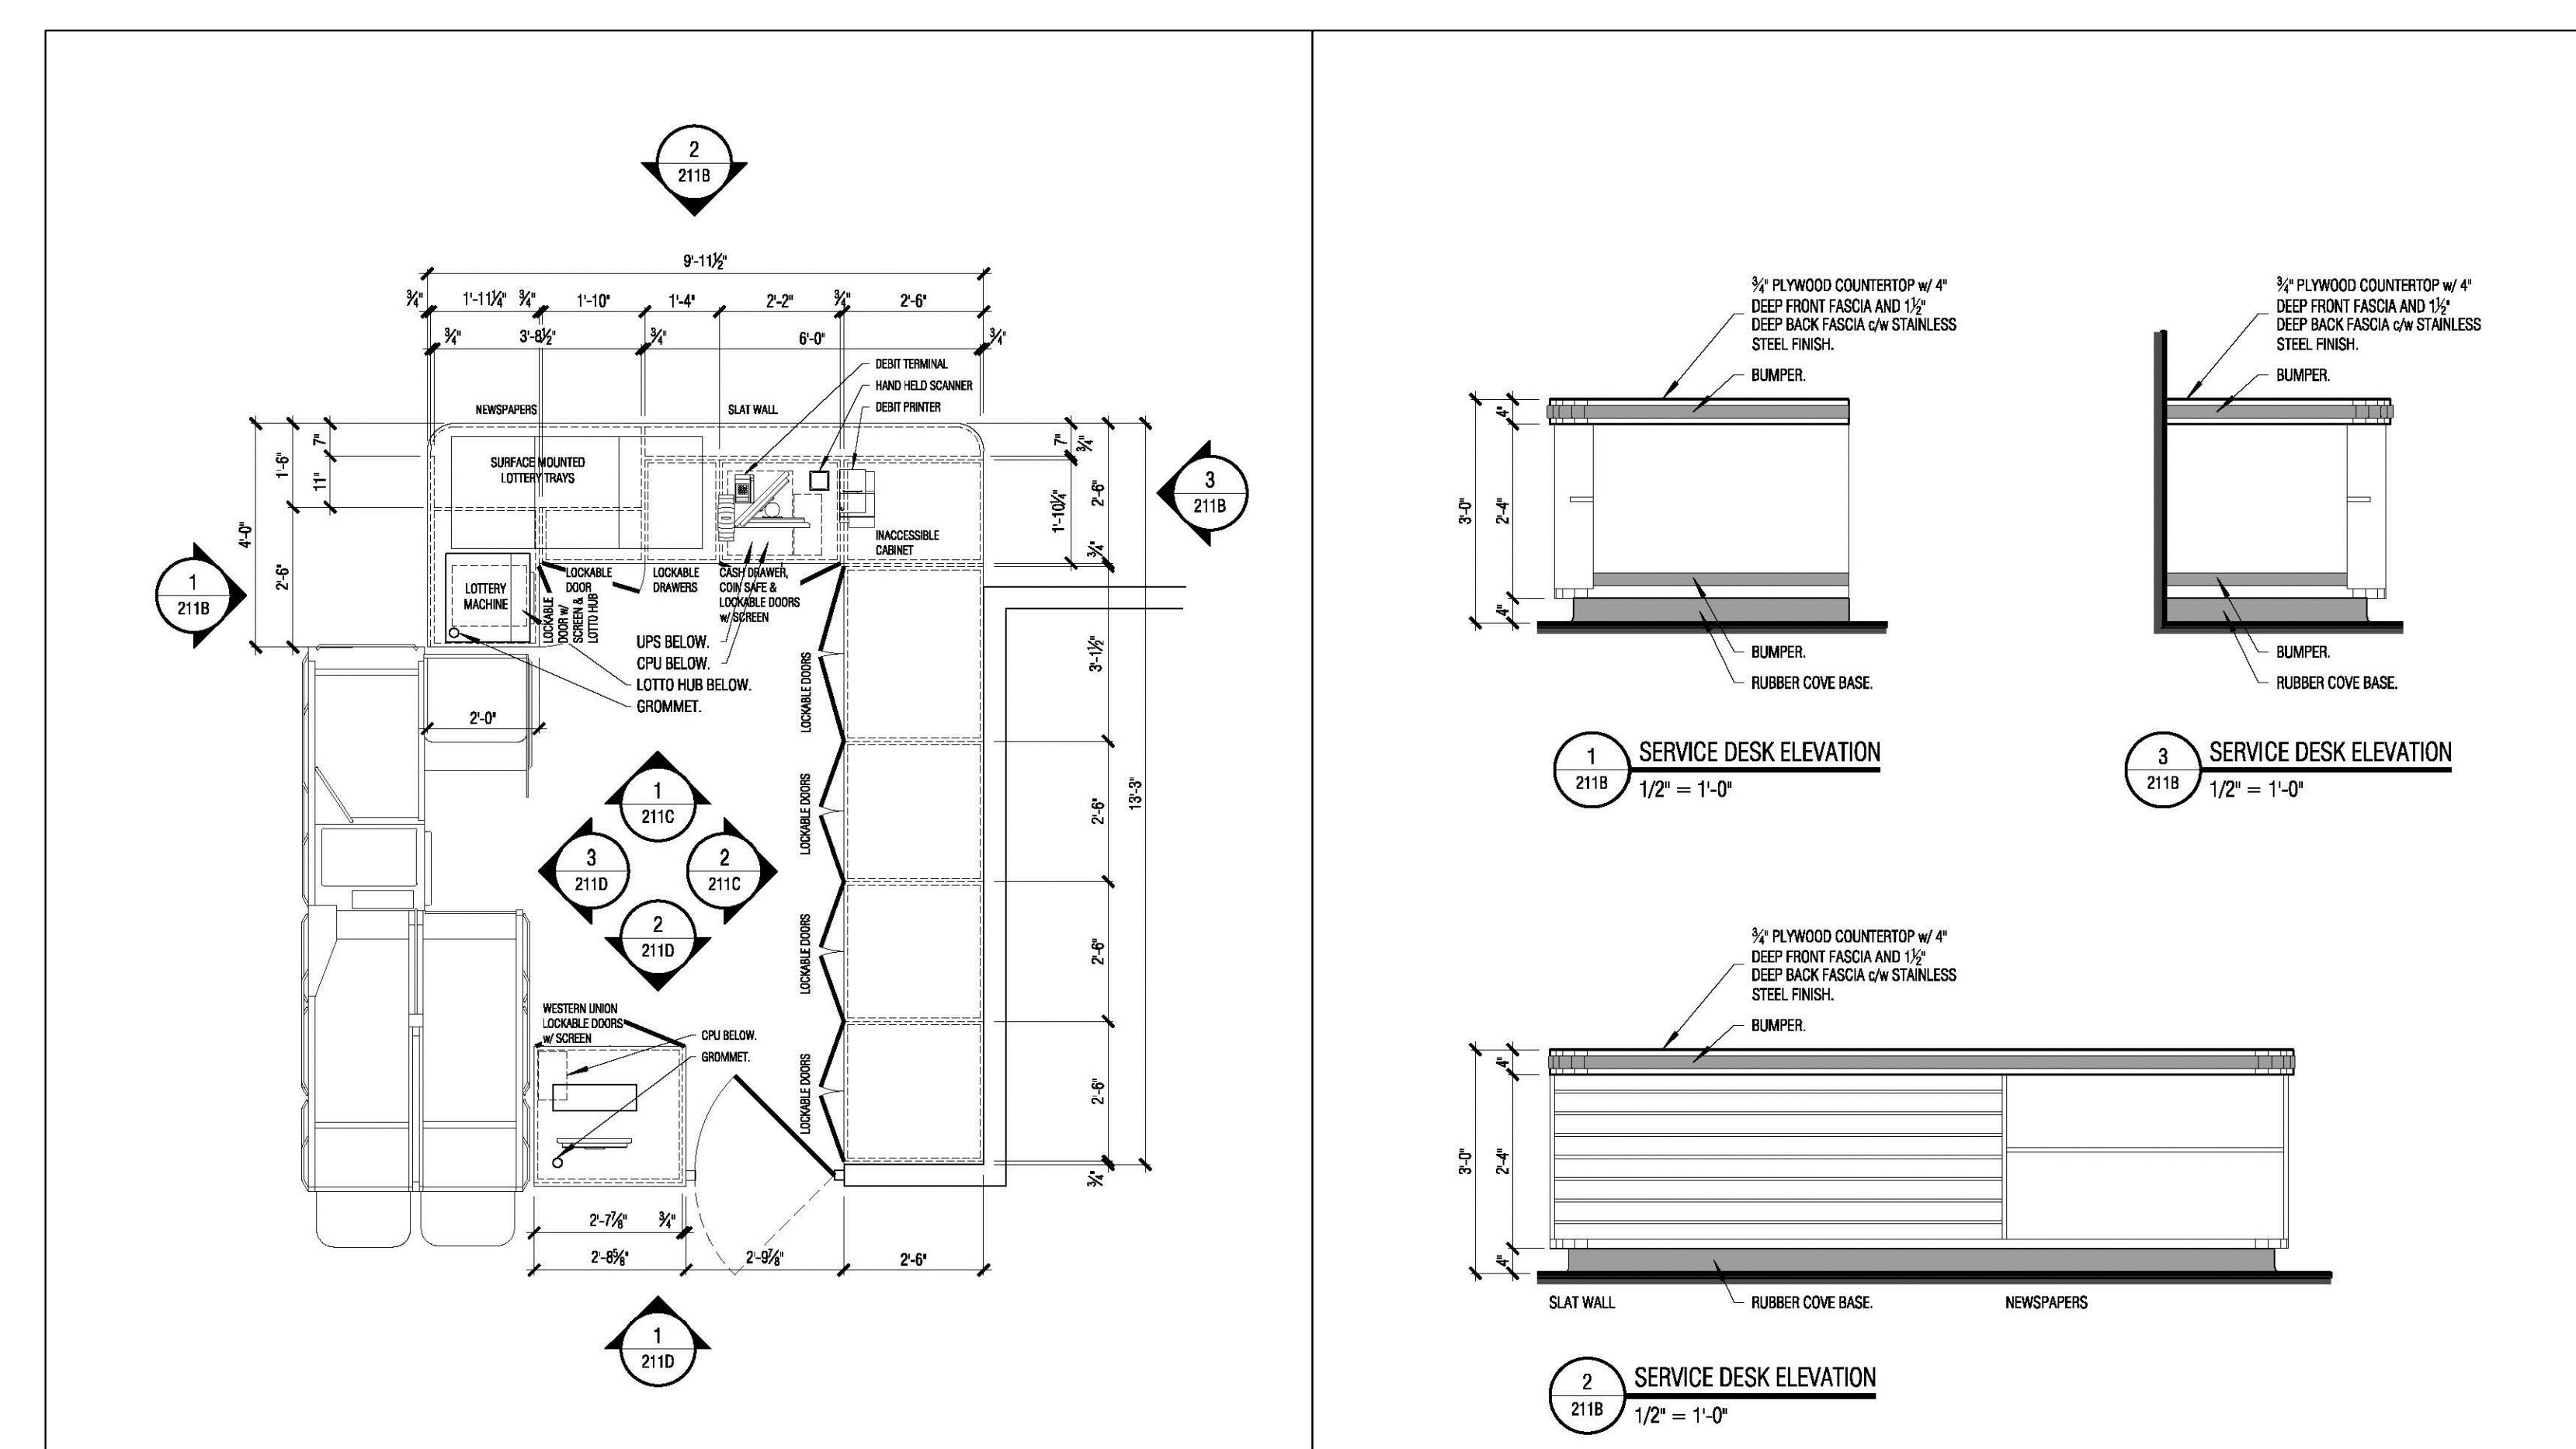
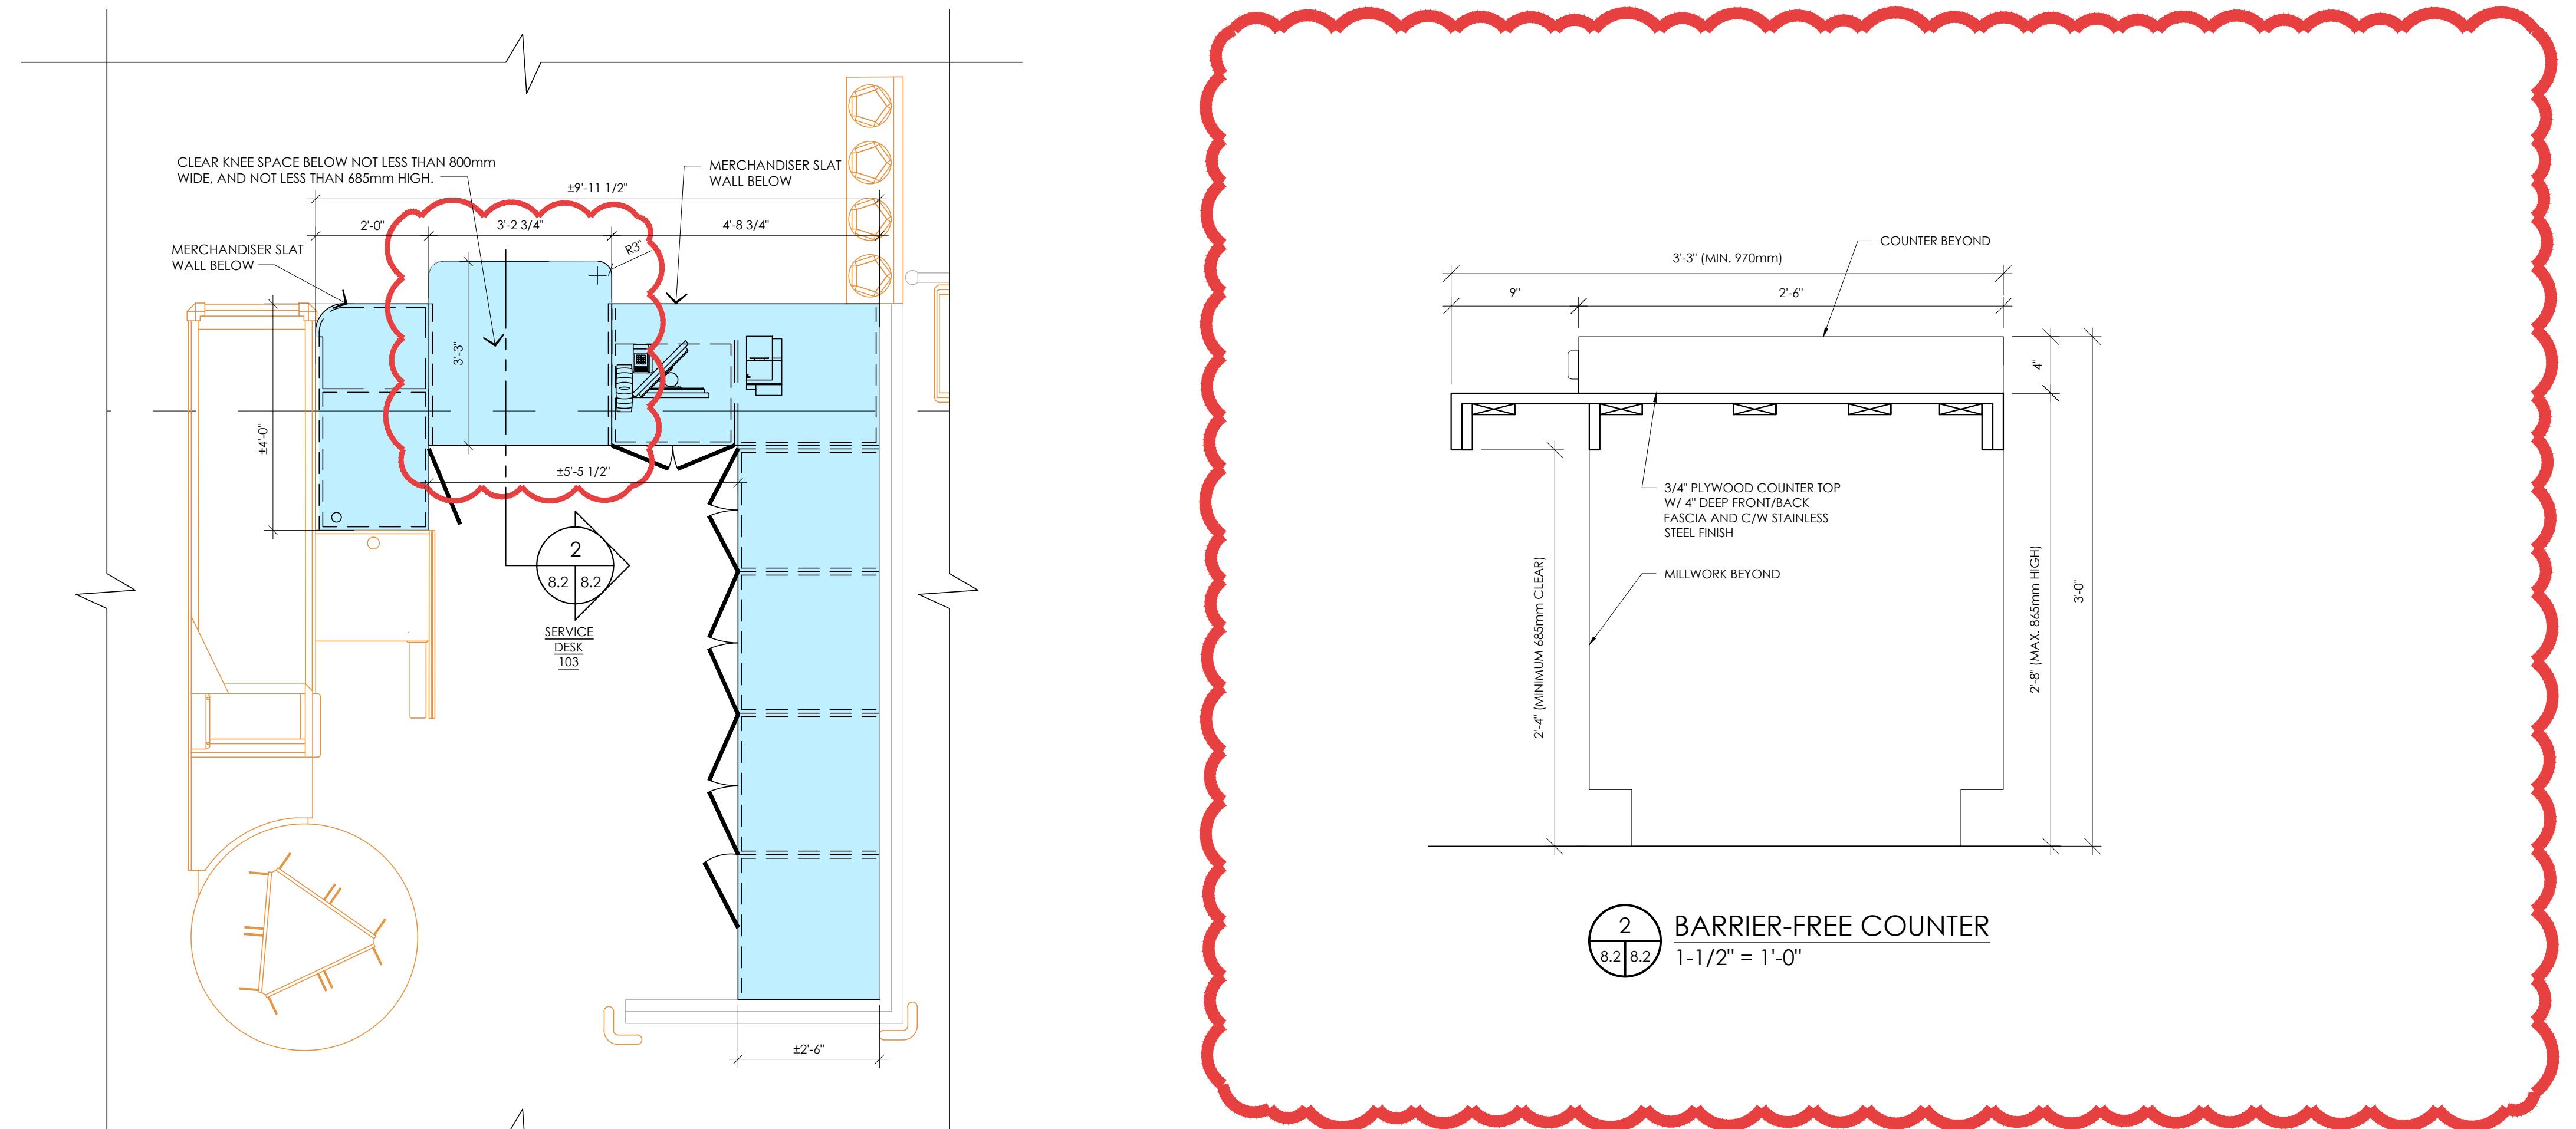
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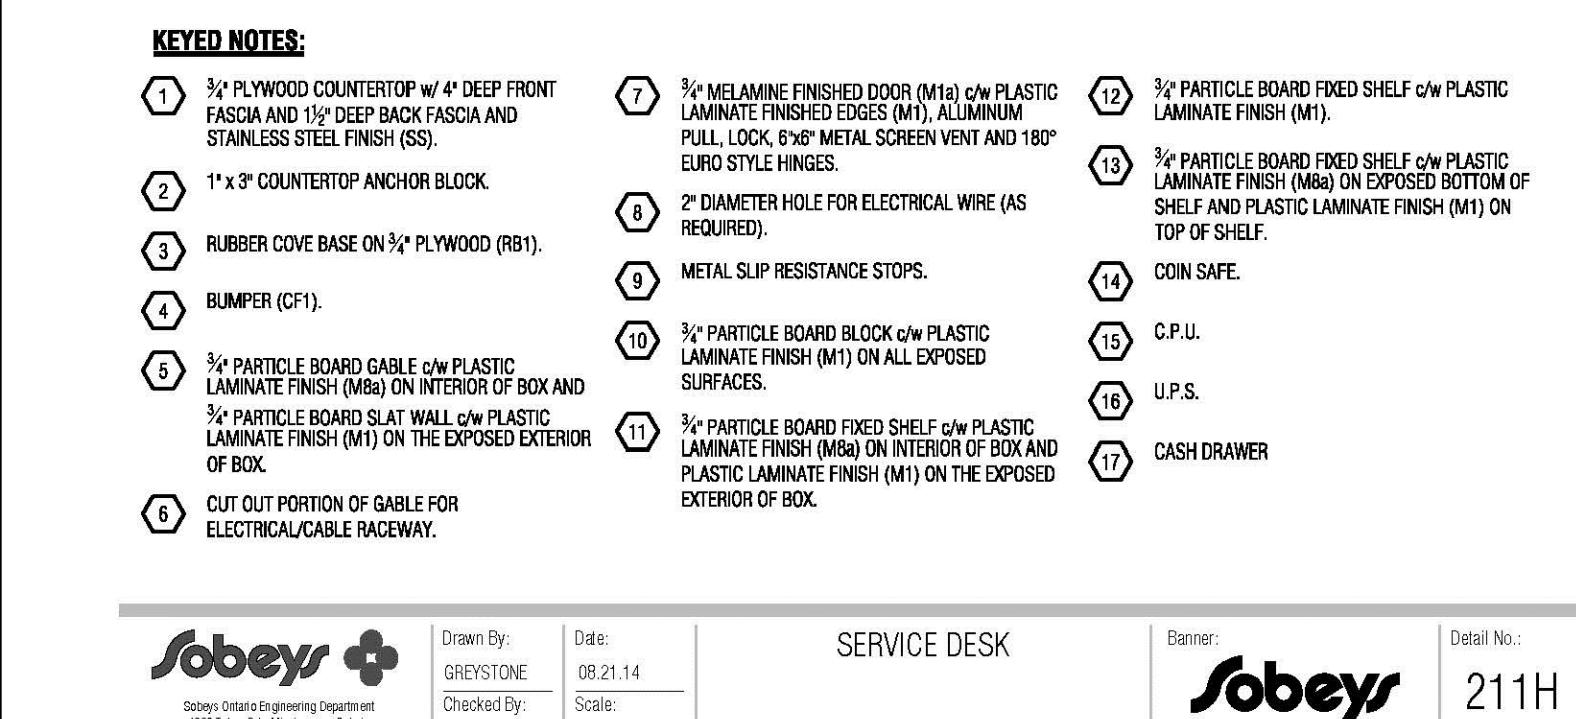
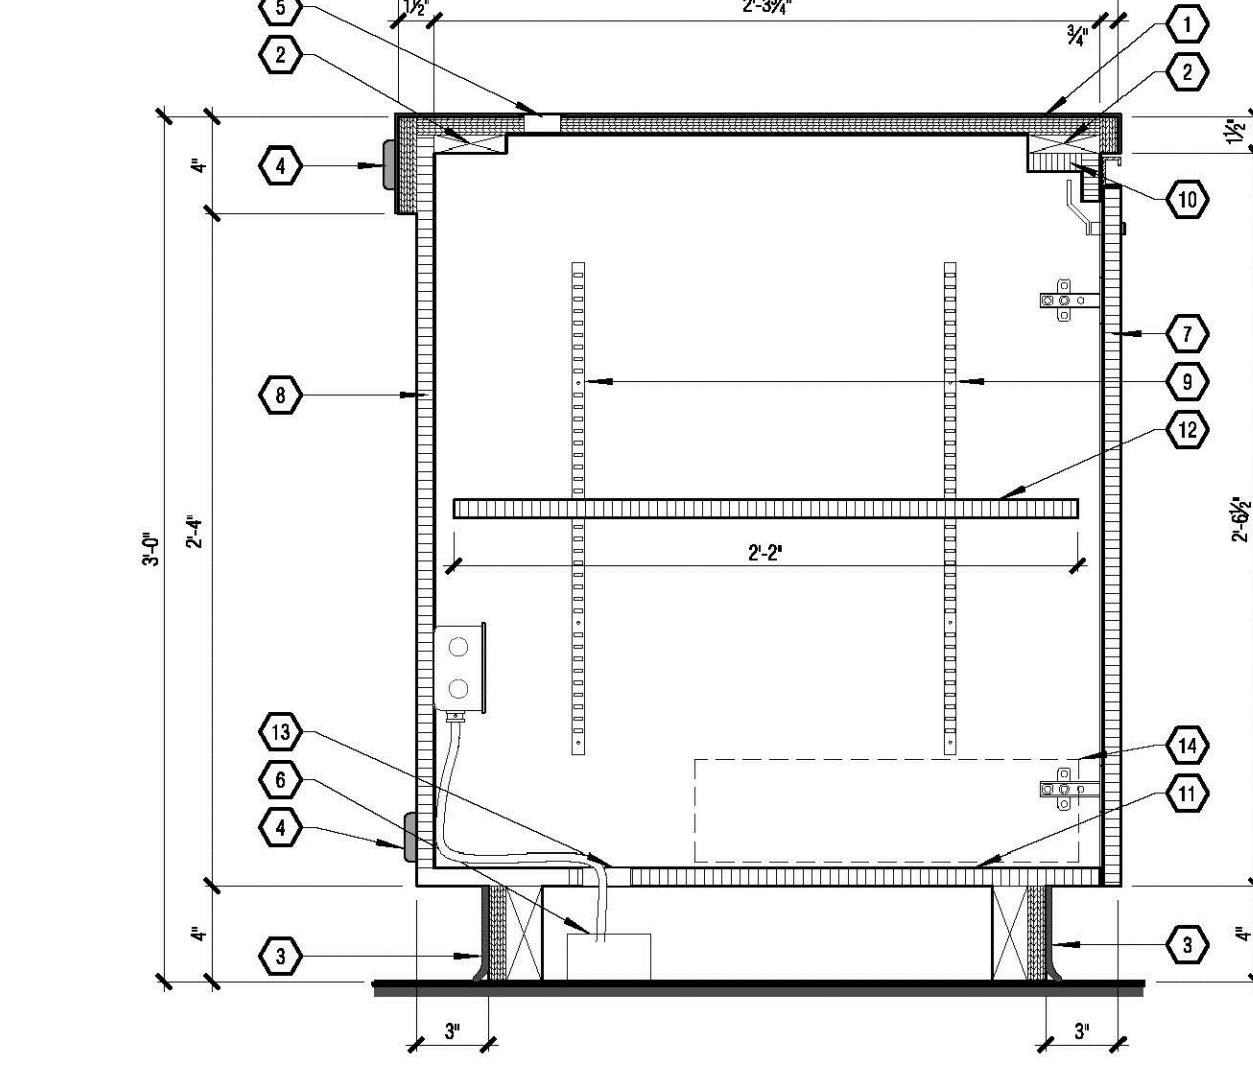
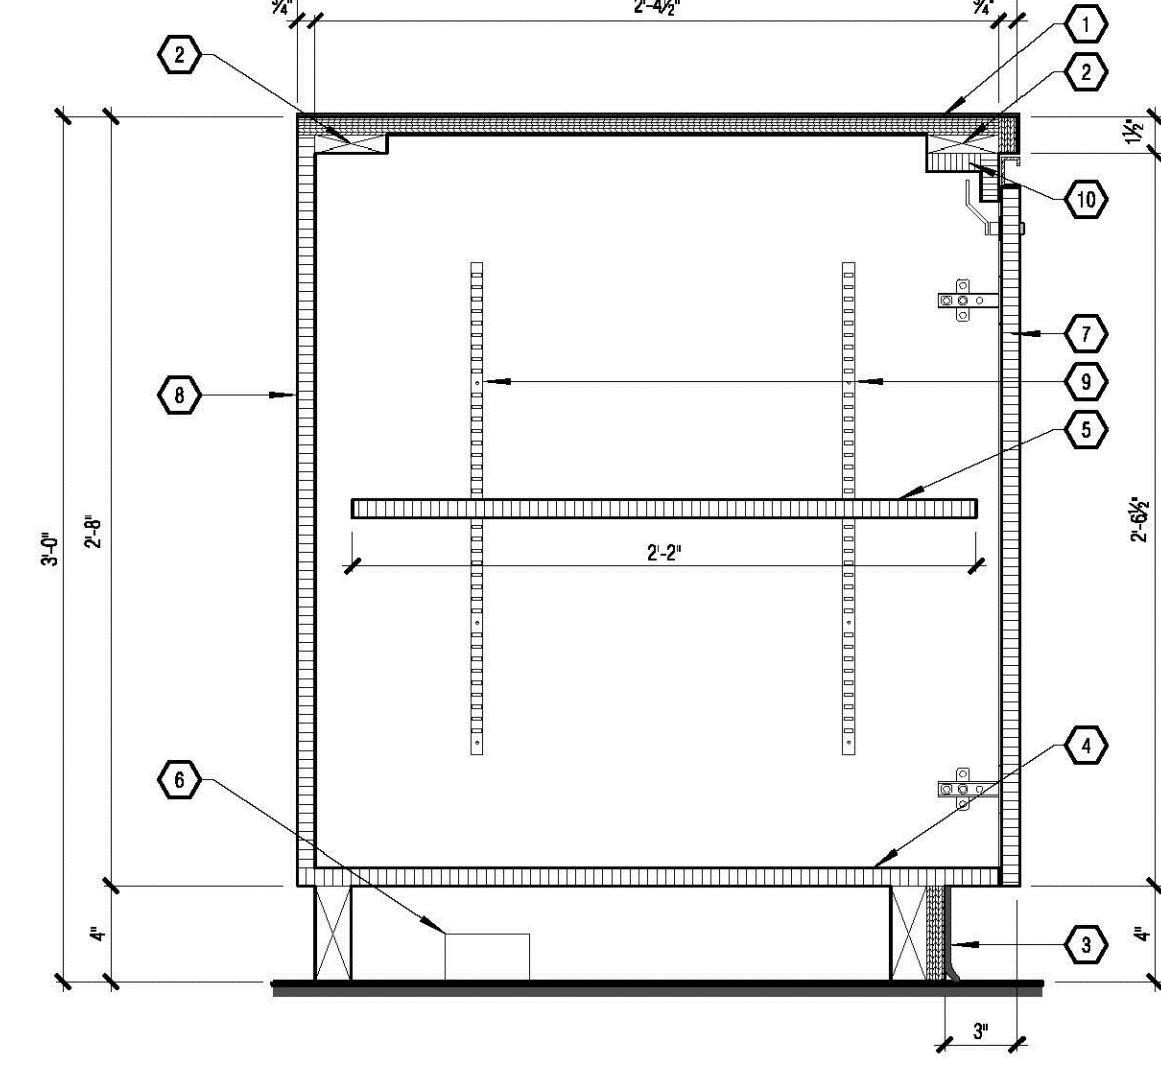
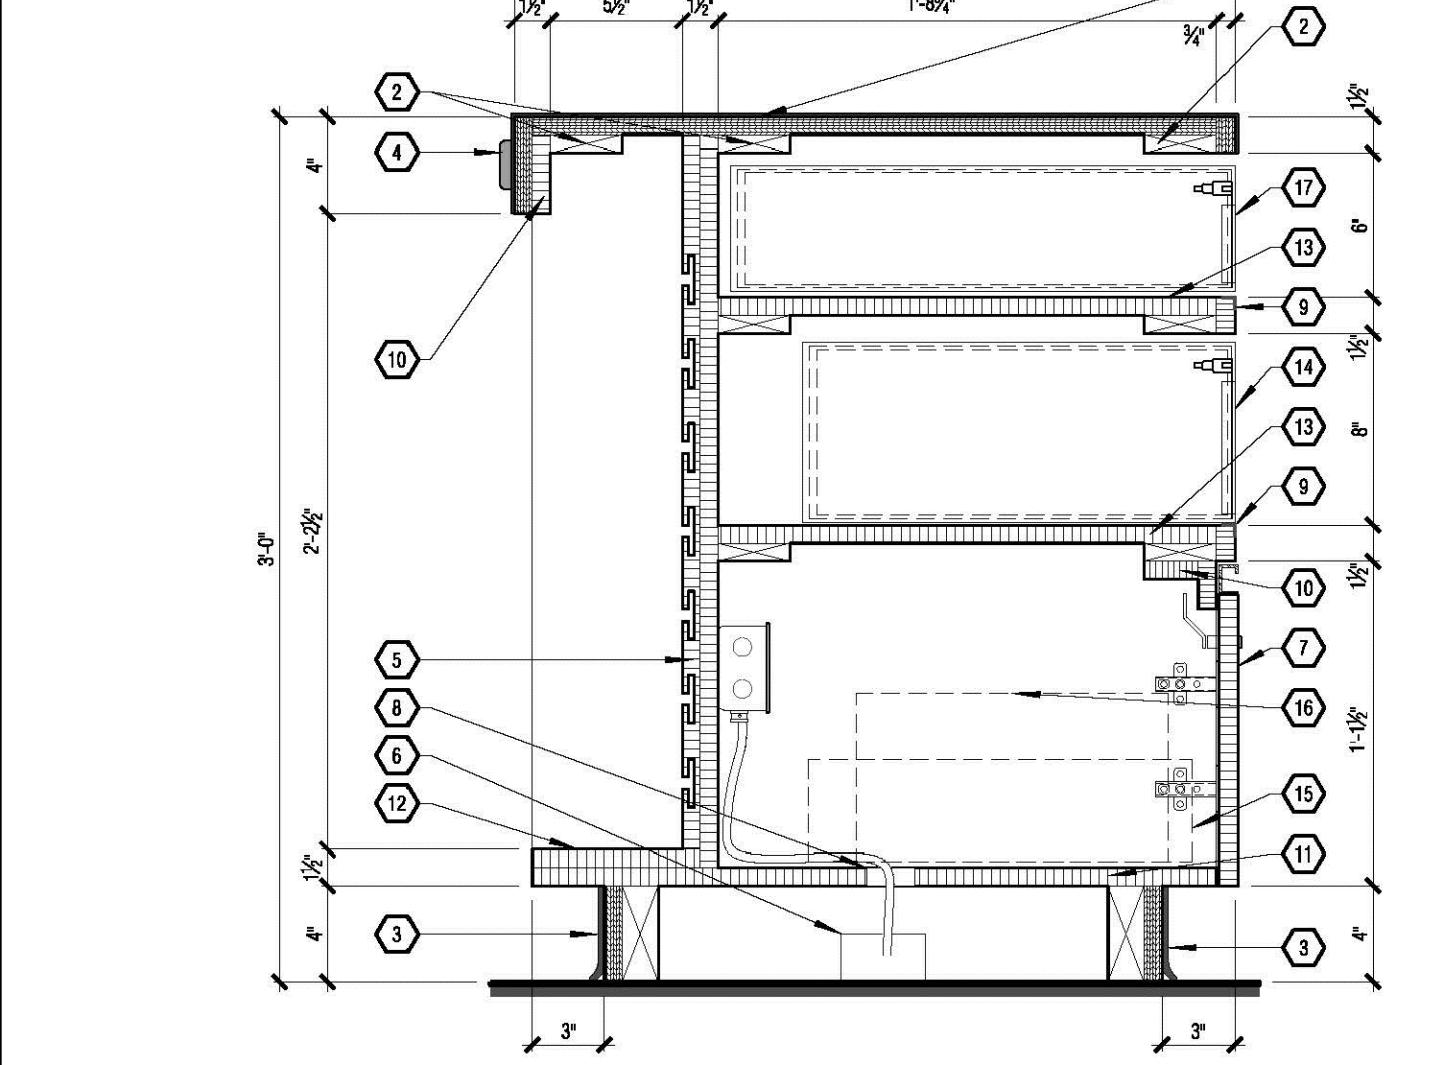
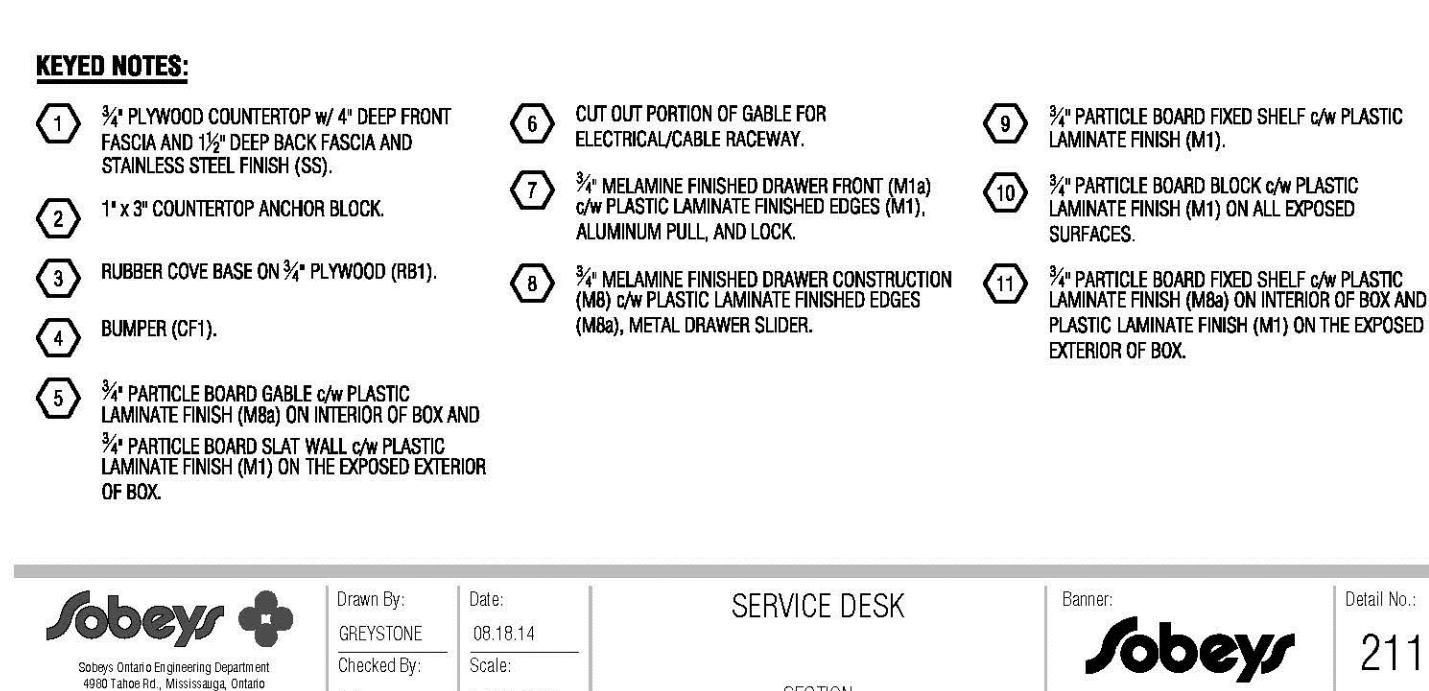
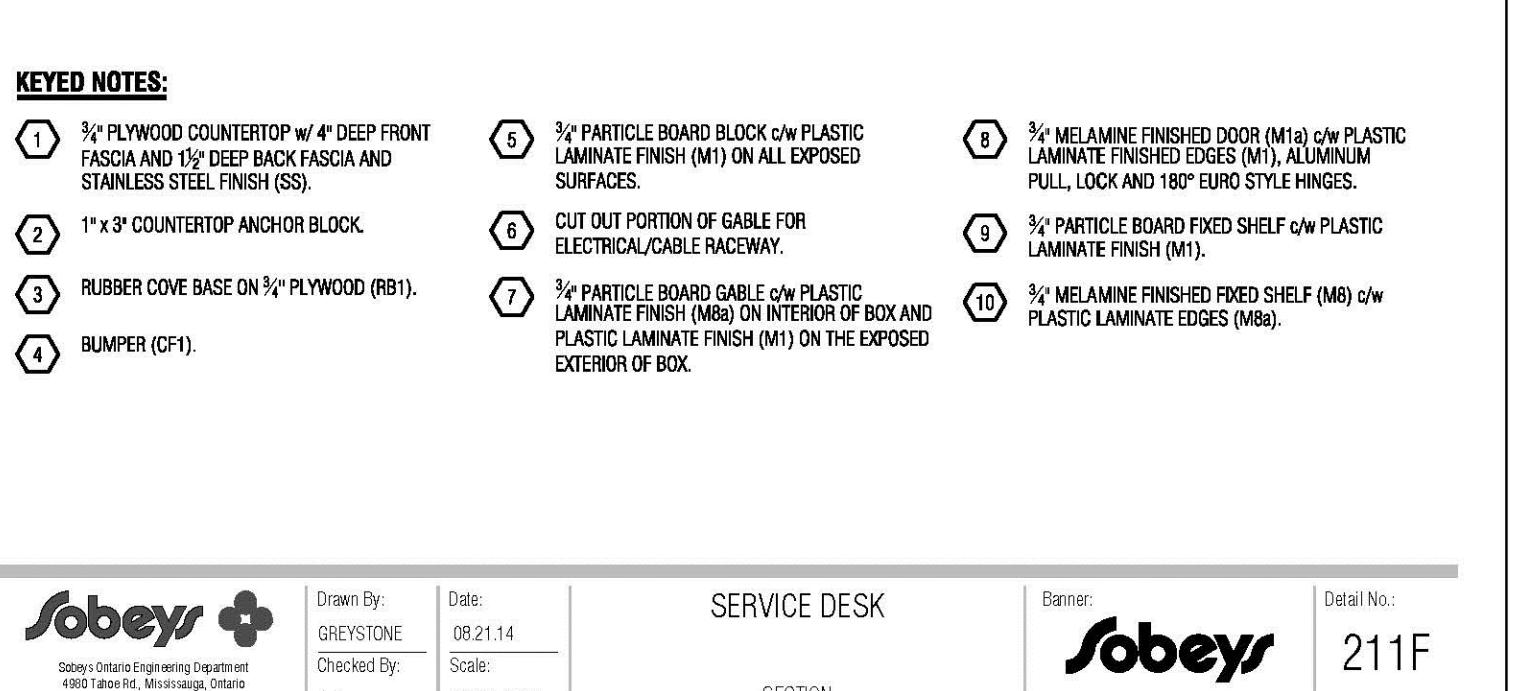
SHEET TITLE:
REFLECTED CEILING PLAN
COMMISSION NUMBER:
2445
SHEET NUMBER:
A3.0
FILE: 2445A3.0-RCP.DWG





Sobeys Drawn By: GRETSTONE Date: 08/14 Checked By: J.J. Scale: 1/2" = 1'-0" SERVICE DESK PLAN Detail No: 211A

Sobeys Drawn By: GRETSTONE Date: 08/14 Checked By: J.J. Scale: 1/2" = 1'-0" SERVICE DESK ELEVATIONS Detail No: 211B



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AURORA GROCERY STORE
2000 ANAQUOD ROAD
REGINA, SASKATCHEWAN

CUSTOMER SERVICE MILLWORK
COMMISSION NUMBER: 2445
FILE: 2445 AB-D-MILLWORK.DWG

PROJECT TITLE:

DRAWN BY: AK

PRINTING DATE: MAY 29, 2025

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GENERAL NOTE:
DRAWING IS TO BE VIEWED IN COLOUR.

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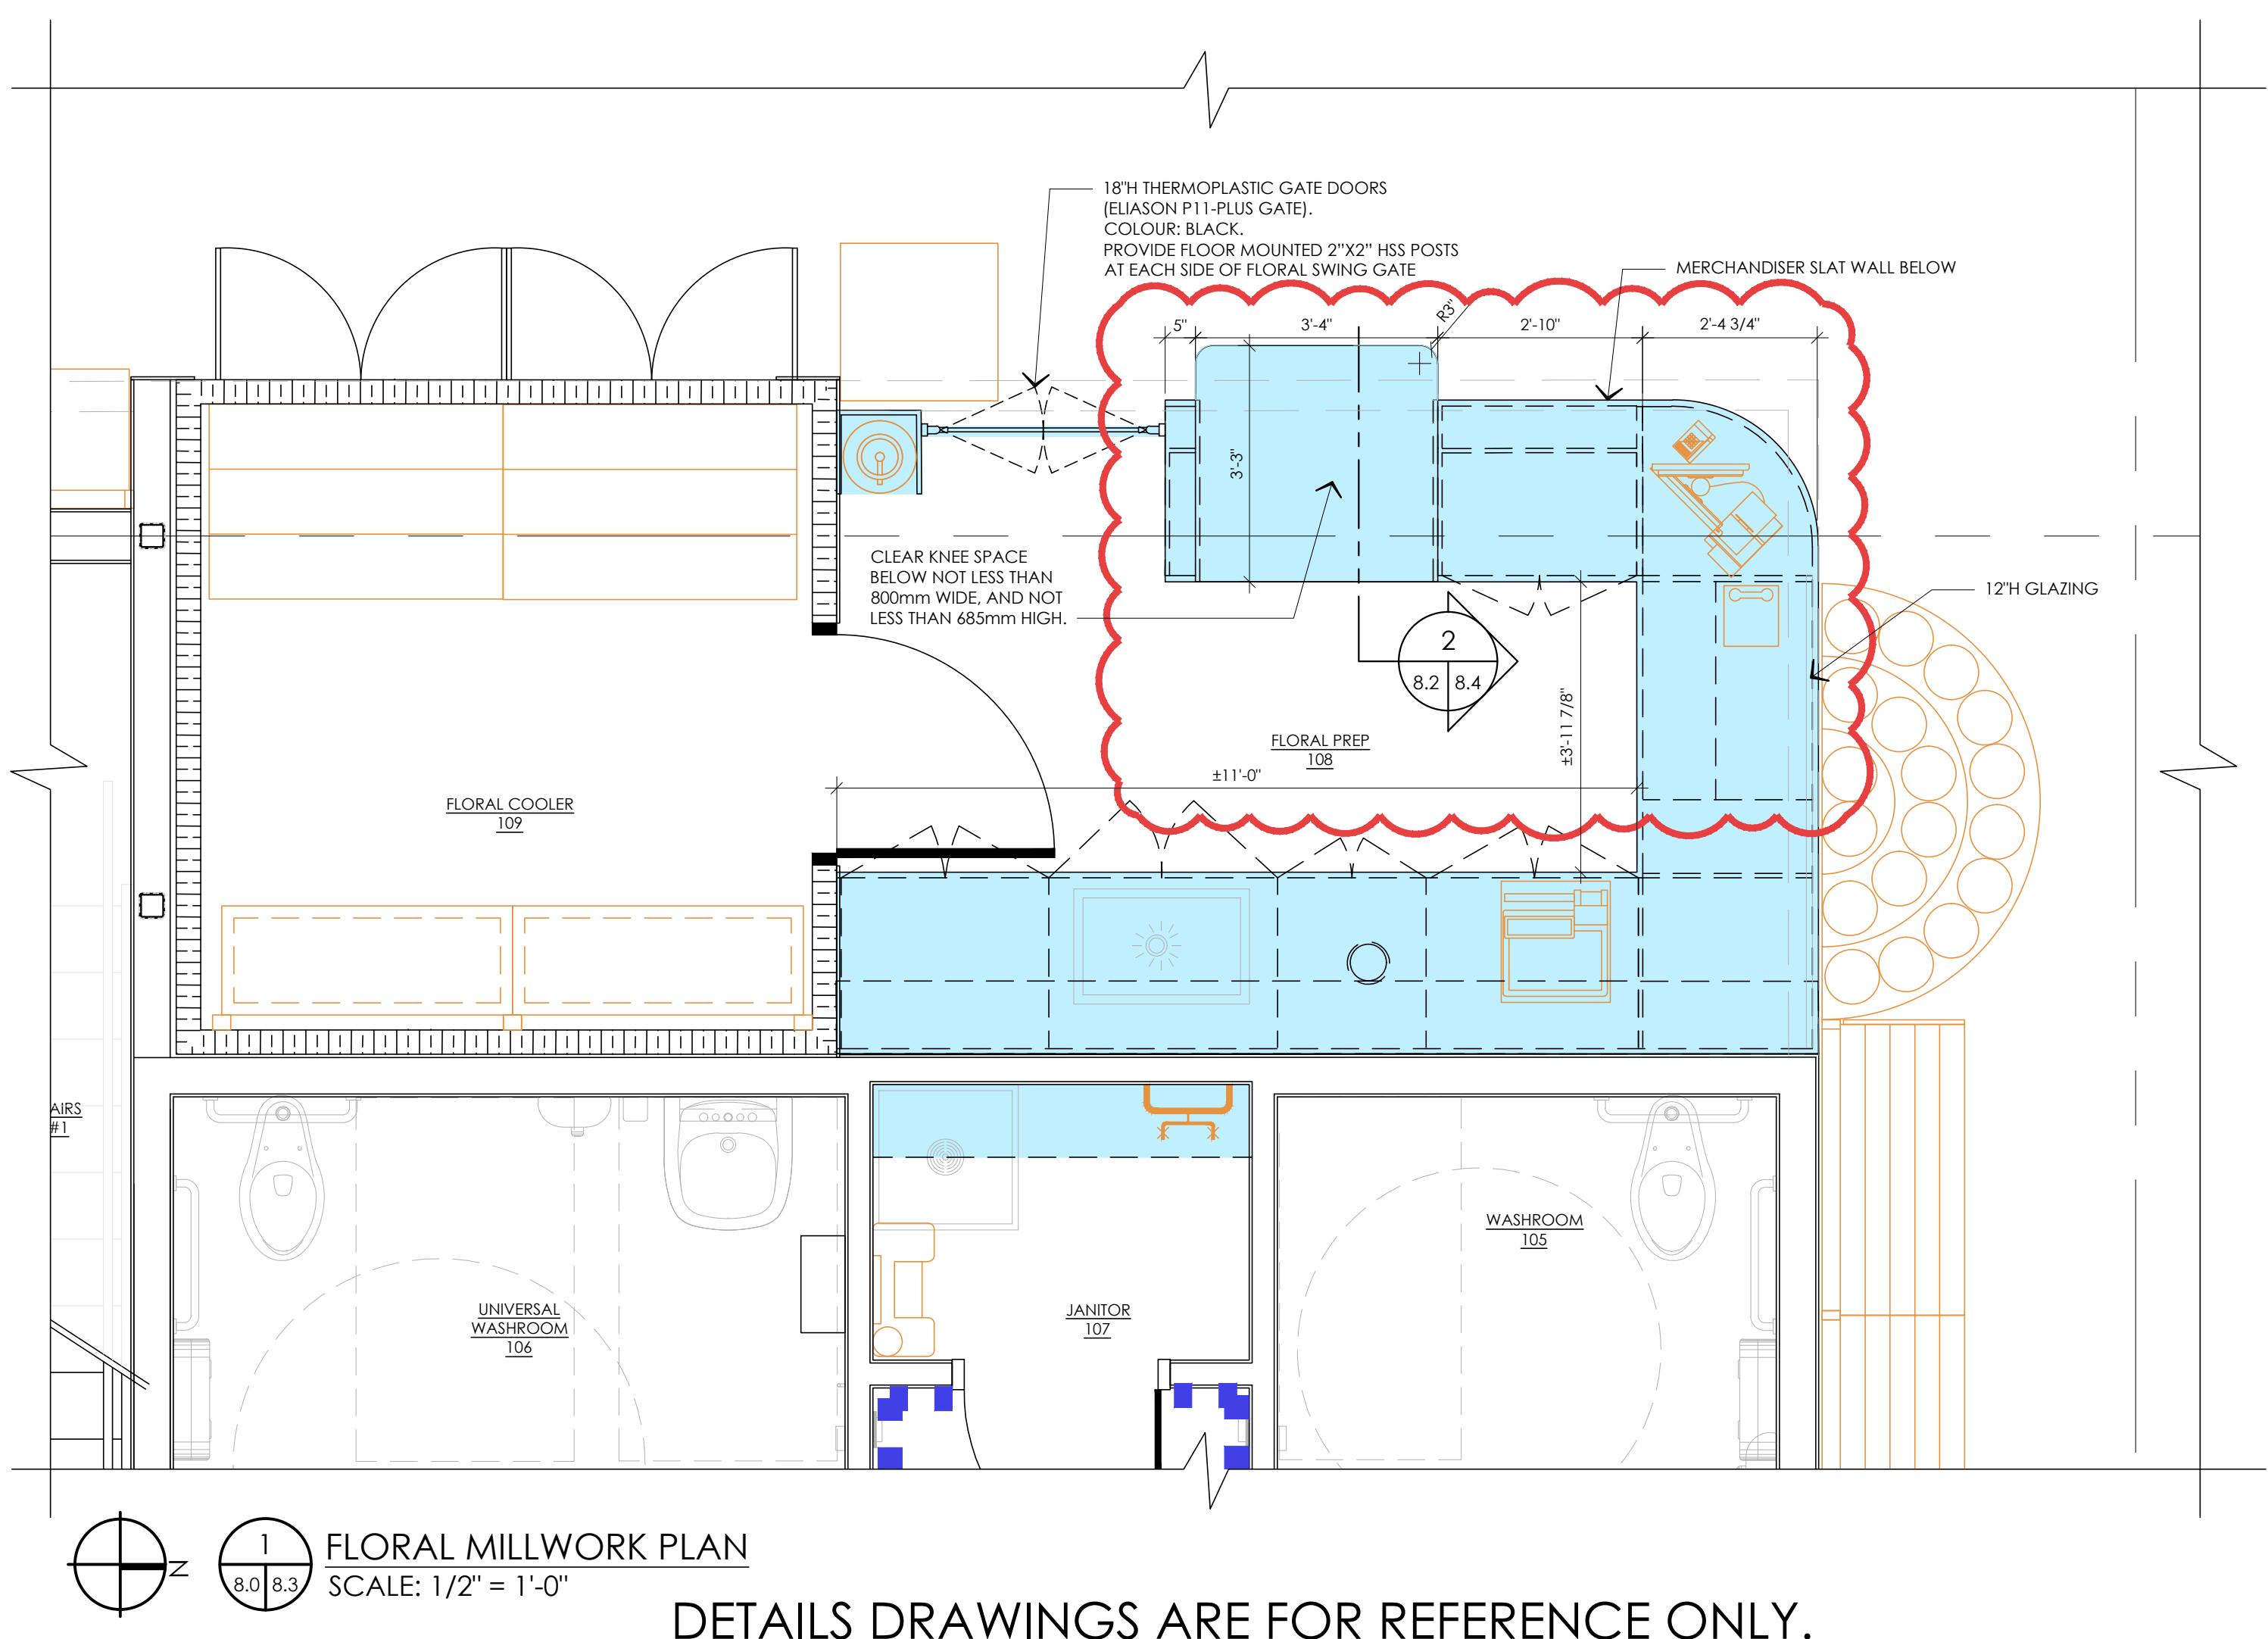
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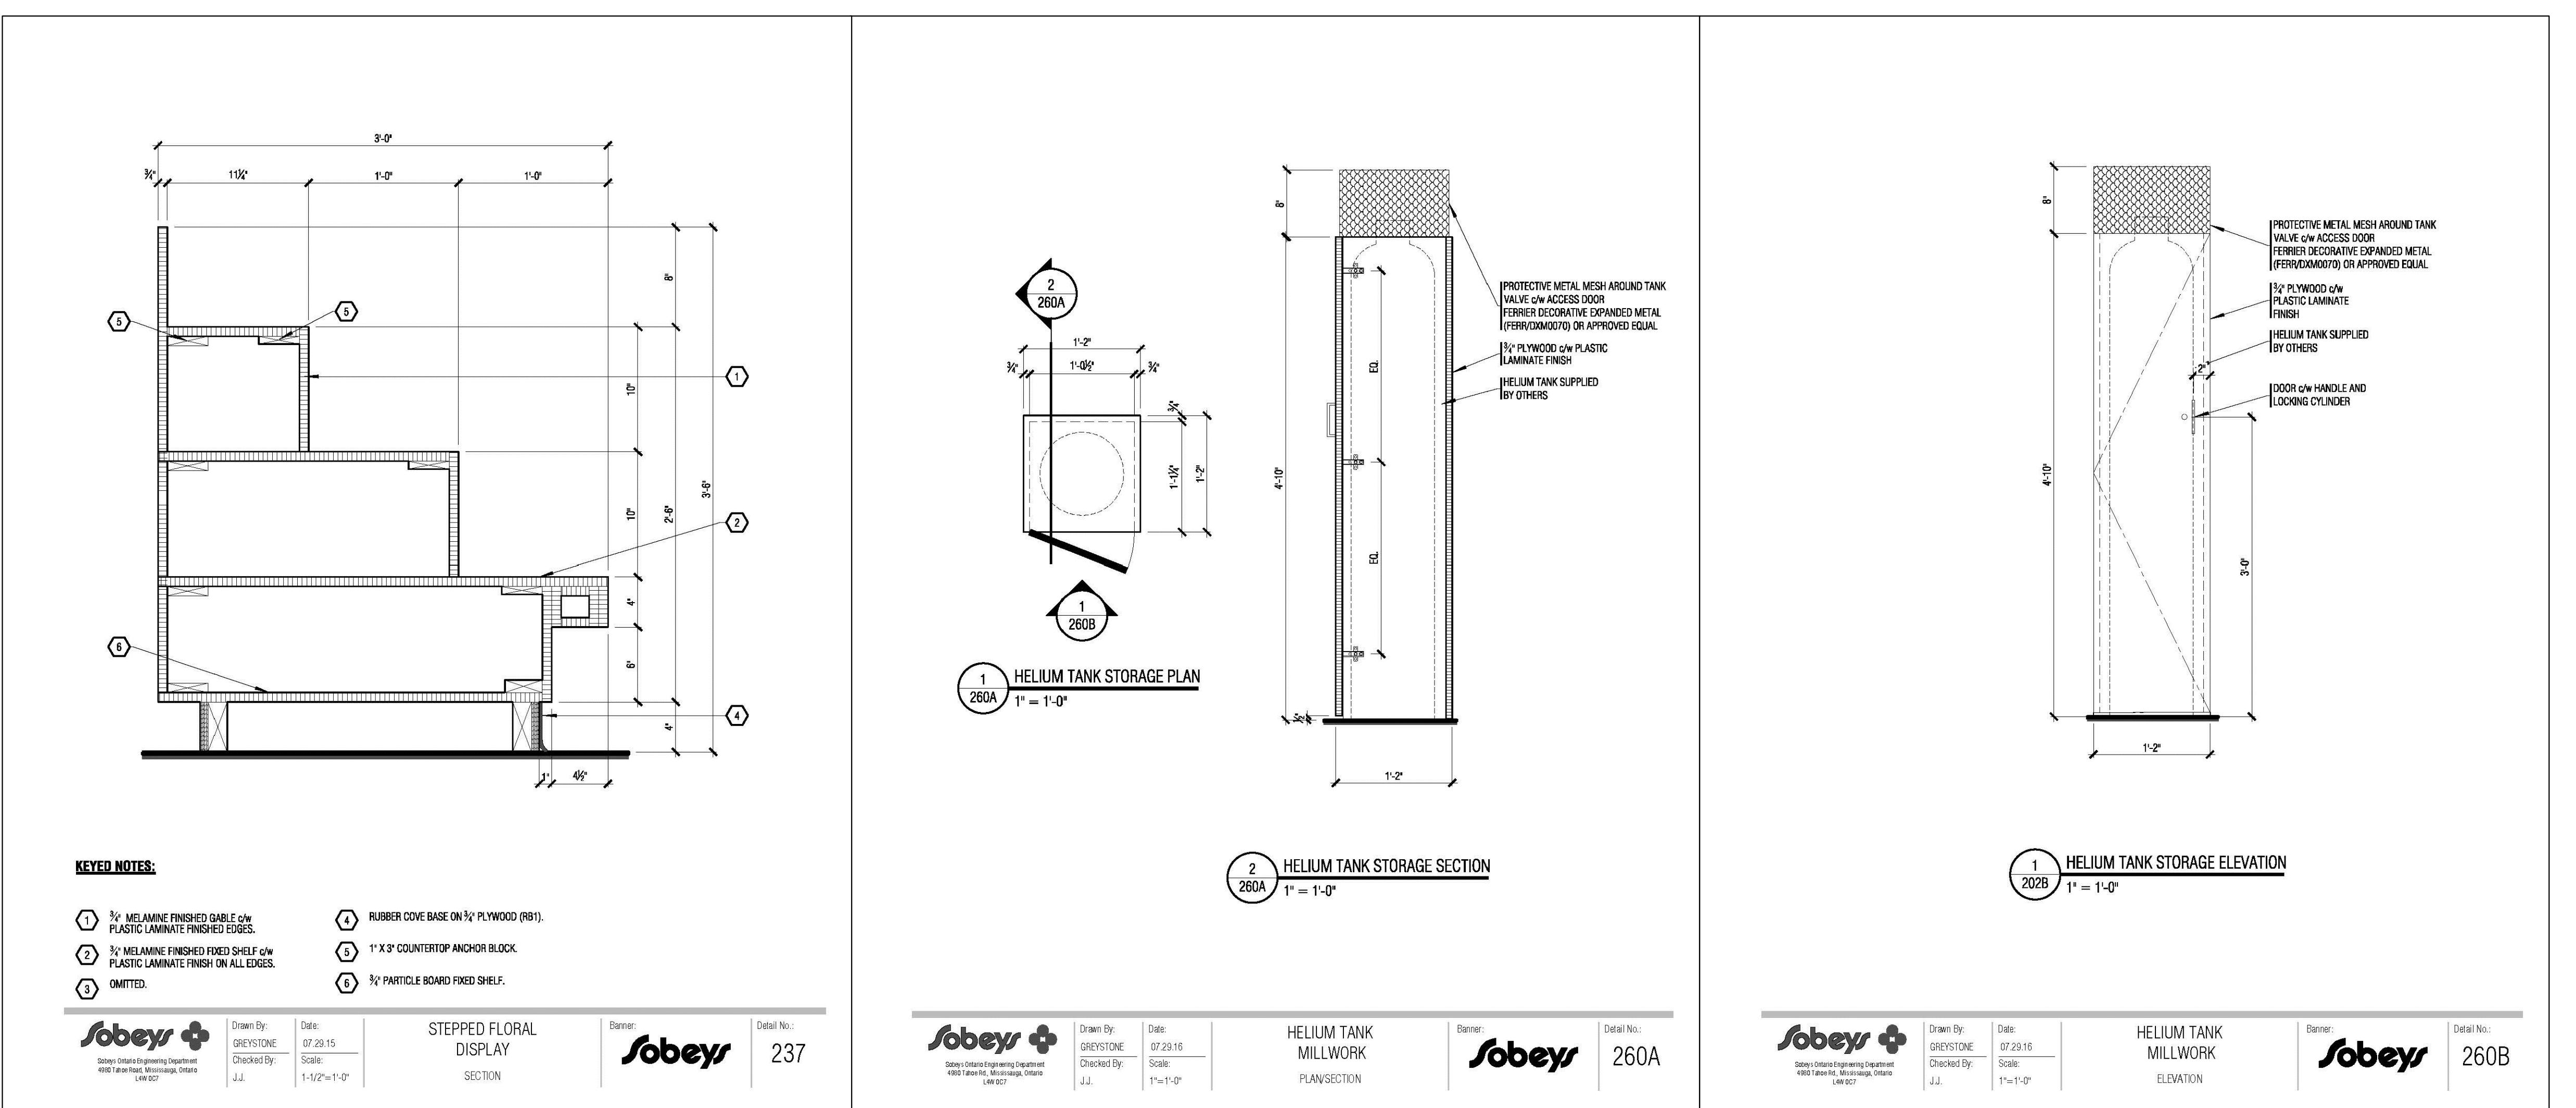
CUSTOMER SERVICE MILLWORK
COMMISSION NUMBER: 2445
FILE: 2445 AB-D-MILLWORK.DWG

PROJECT TITLE:



1 FLORAL MILLWORK PLAN
SCALE: 1/2" = 1'-0"

DETAILS DRAWINGS ARE FOR REFERENCE ONLY.
REFER TO PROJECT SPECIFIC PLAN ABOVE FOR LAYOUT REQUIREMENTS.





KEYED NOTES:

- ① PLASTIC LAMINATE FINISHED SHEET w/ PLASTIC LAMINATE FINISH ON ALL EDGES.
- ② RUBBER COVE BASE ON 1/2" PLYWOOD (RBT).
- ③ X" X" COUNTERTOP ANCHOR BLOCK.
- ④ OMITTED.
- ⑤ PLYWOOD C/W PLASTIC LAMINATE FINISH.

sobeys Drawn By: GRETSTONE Checked By: J.J. STEPPED FLORAL DISPLAY SECTION Date: 07/29/15 Scale: 1"-0" 237

sobeys Drawn By: GRETSTONE Checked By: J.J. HELIUM TANK MILLWORK PLANSSECTION Date: 07/29/15 Scale: 1"-0" 260A

sobeys Drawn By: GRETSTONE Checked By: J.J. HELIUM TANK MILLWORK ELEVATION Date: 07/29/15 Scale: 1"-0" 260B

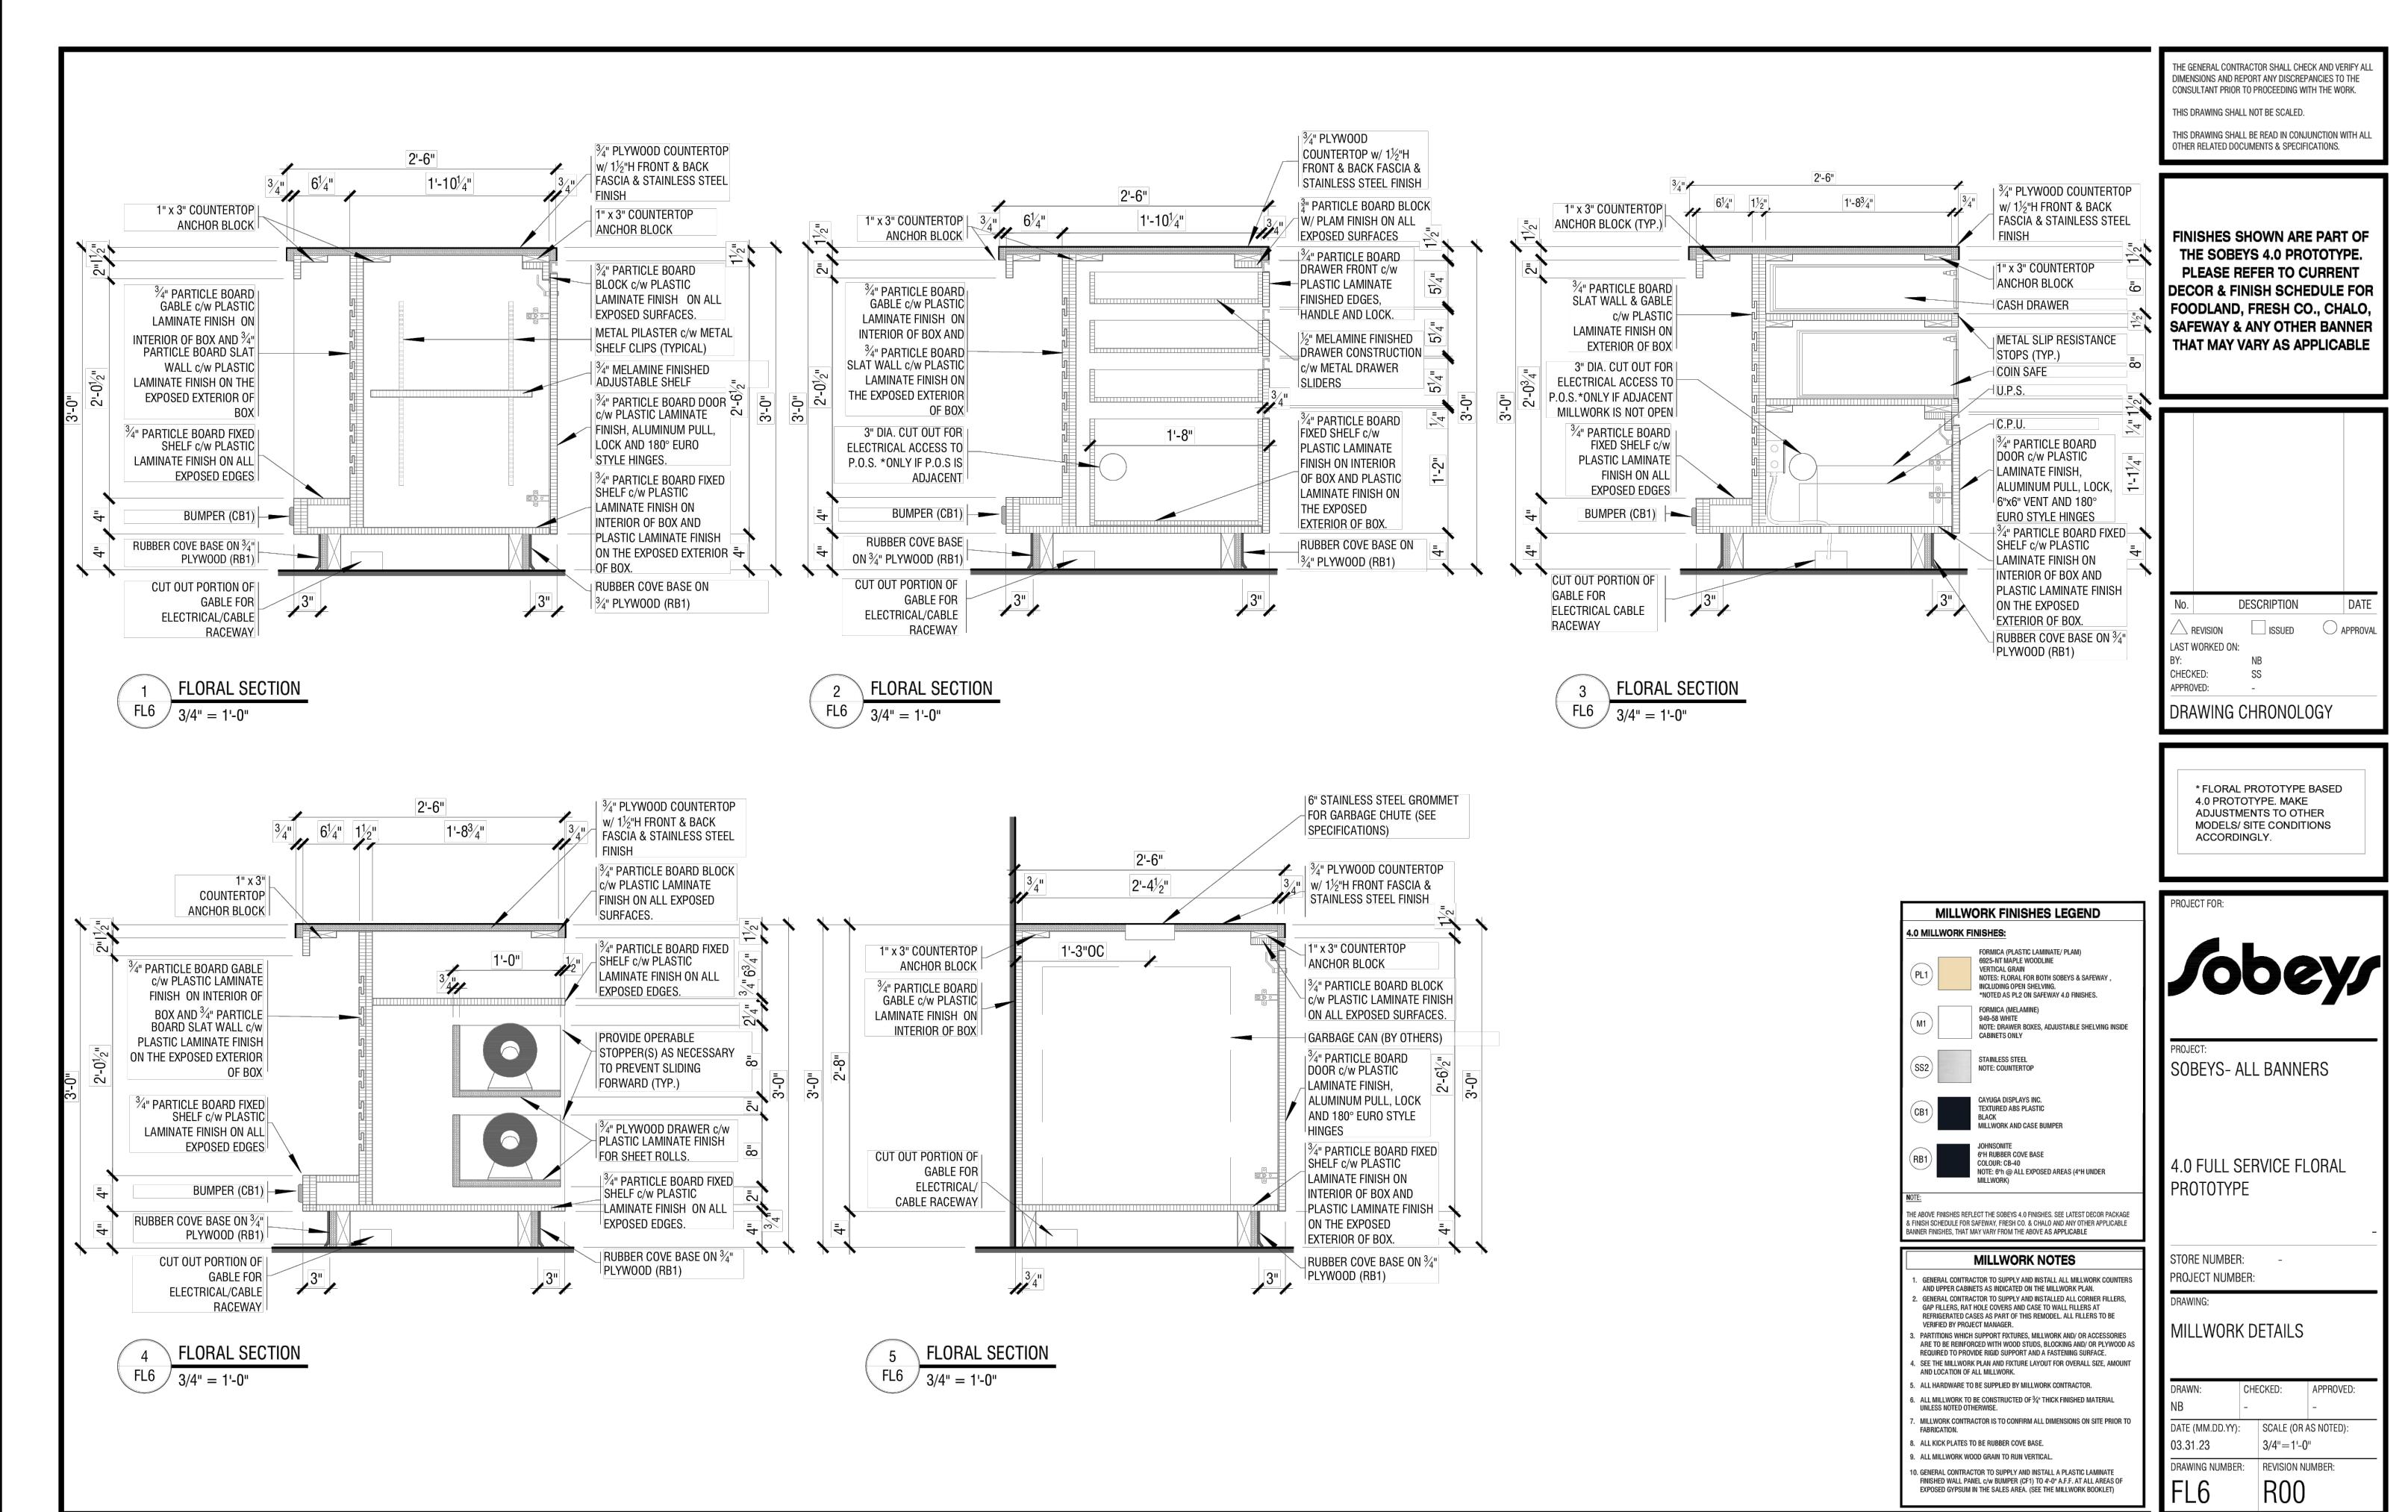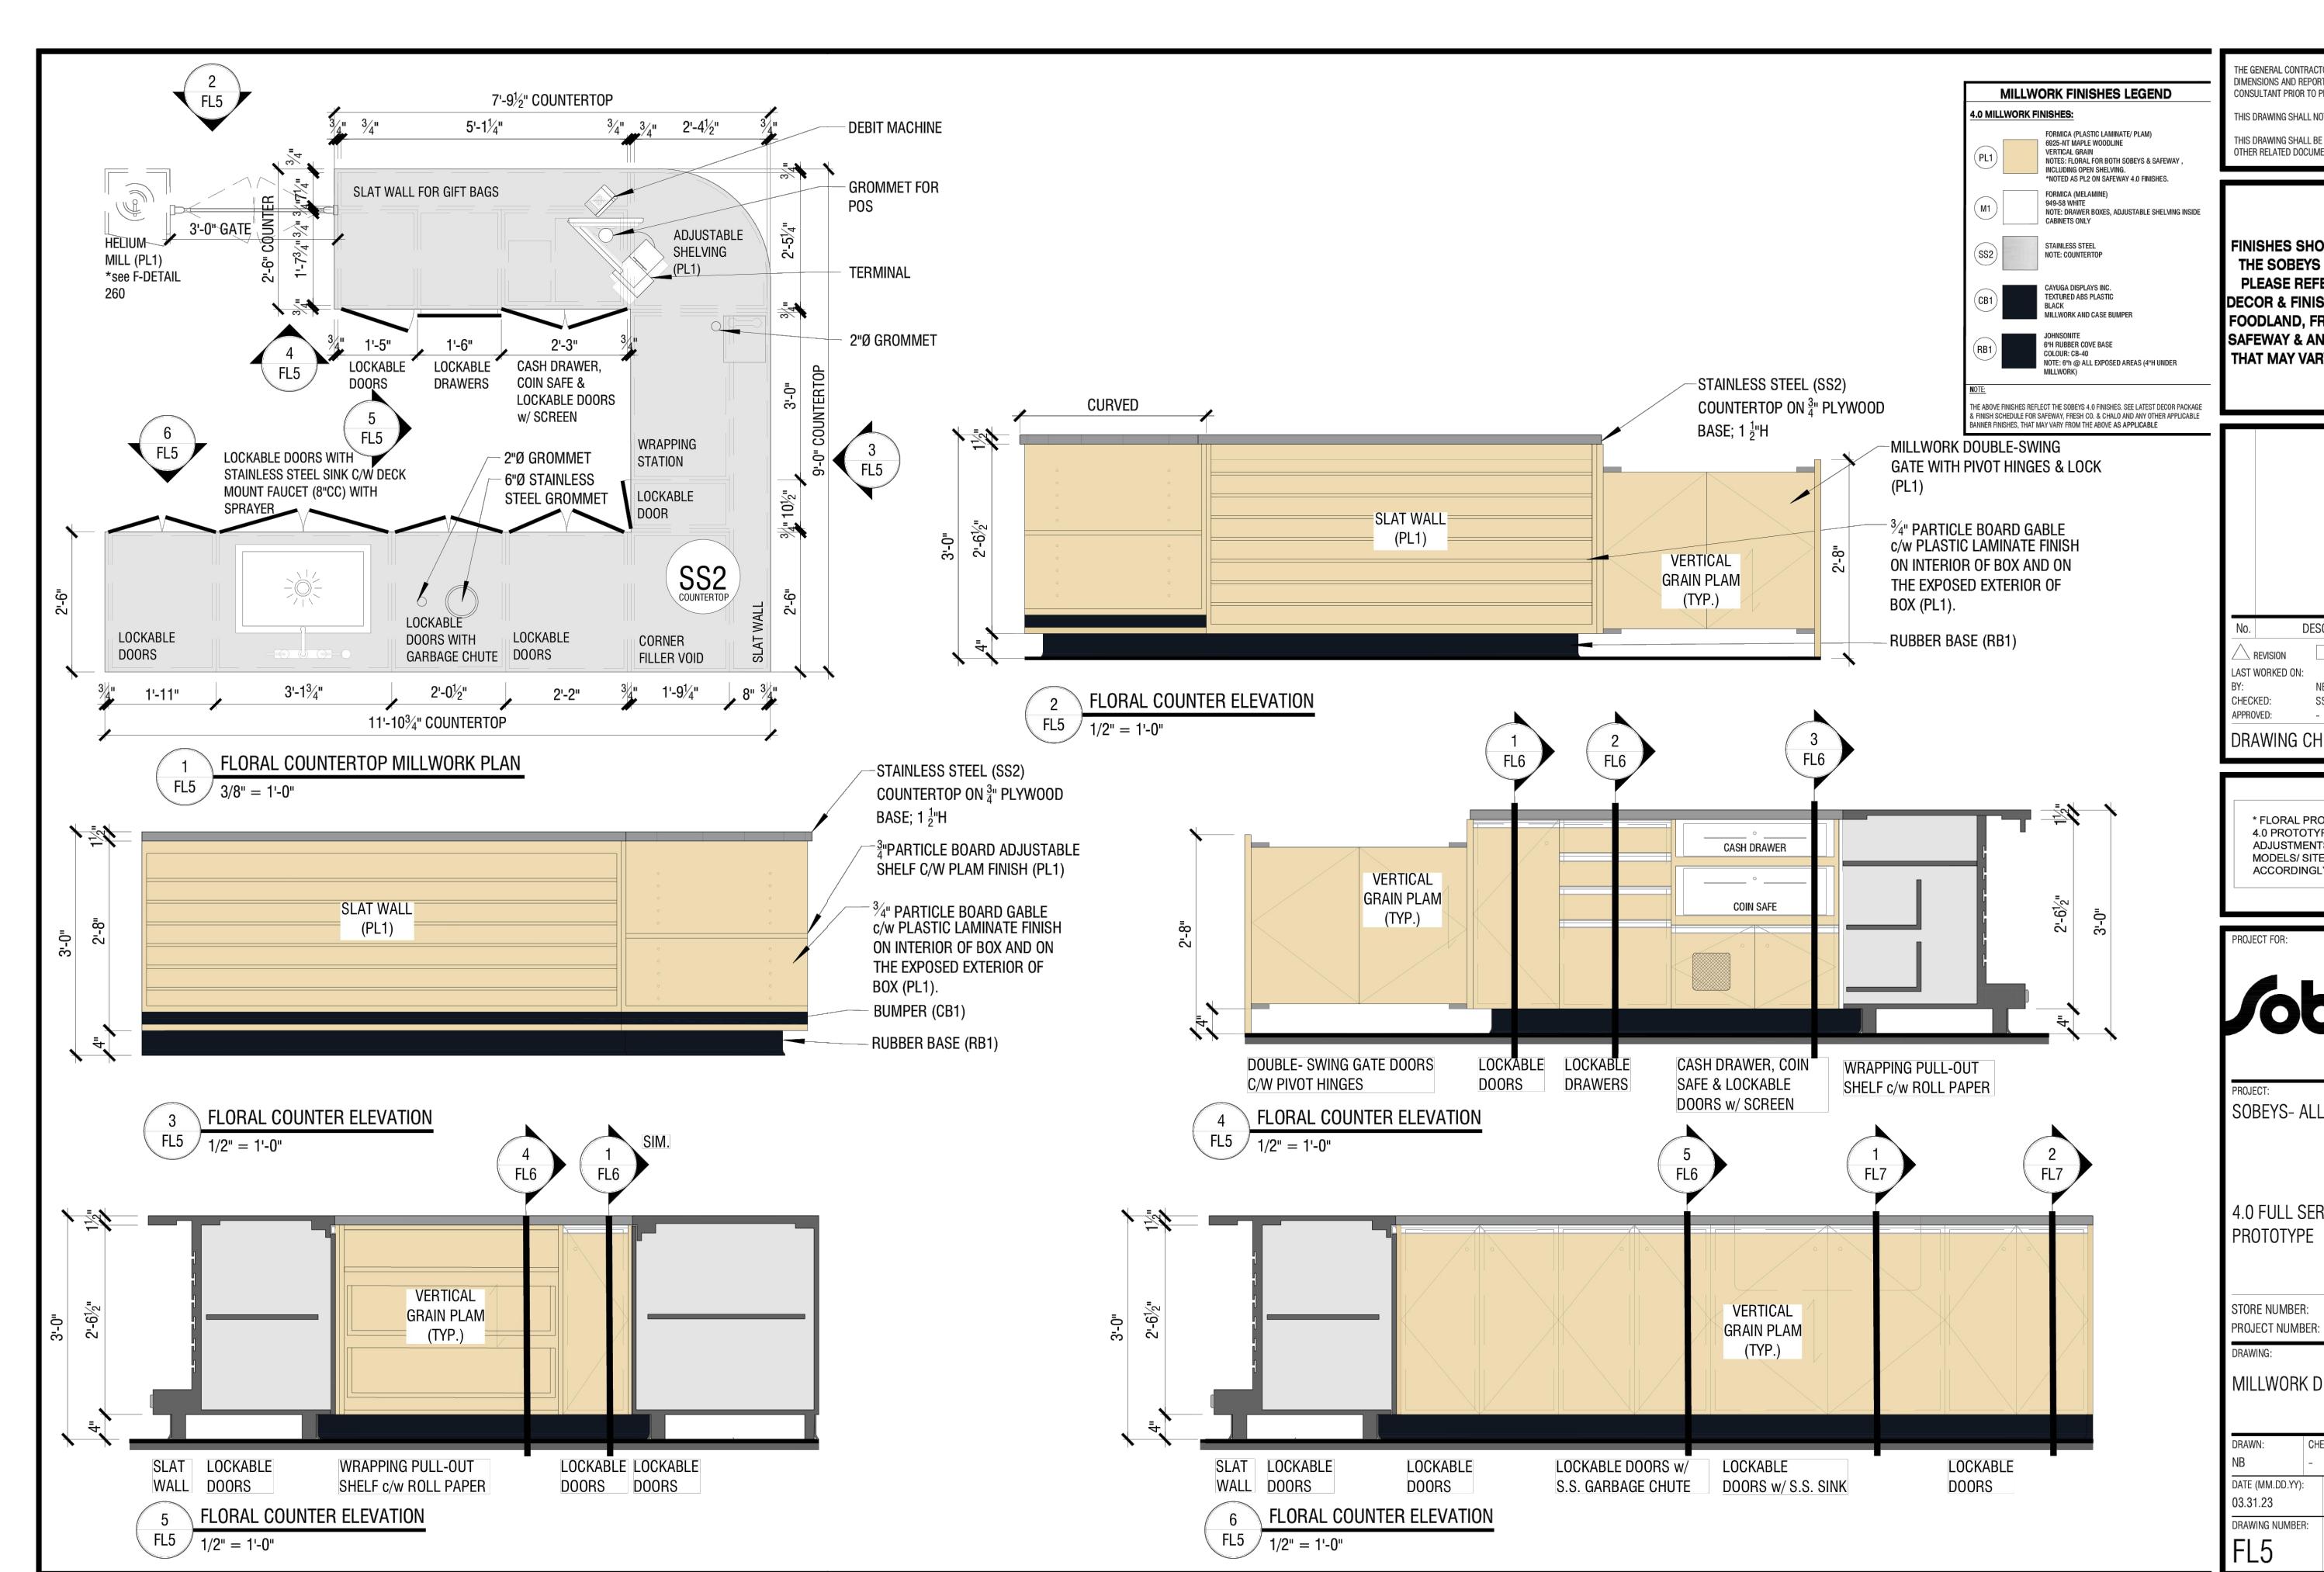

1 FLORAL SECTION

FL5 3/4" = 1'-0"

2 FL7 3/4" = 1'-0"

3 FL8 3/4" = 1'-0"

4 FL6 3/4" = 1'-0"

5 FL7 3/4" = 1'-0"

6 FL5 3/4" = 1'-0"

7 FL6 3/4" = 1'-0"

8 FL5 3/4" = 1'-0"

9 FL7 3/4" = 1'-0"

10 FL6 3/4" = 1'-0"

11 FL5 3/4" = 1'-0"

12 FL7 3/4" = 1'-0"

13 FL6 3/4" = 1'-0"

14 FL5 3/4" = 1'-0"

15 FL7 3/4" = 1'-0"

16 FL6 3/4" = 1'-0"

17 FL5 3/4" = 1'-0"

18 FL7 3/4" = 1'-0"

19 FL6 3/4" = 1'-0"

20 FL5 3/4" = 1'-0"

21 FL7 3/4" = 1'-0"

22 FL6 3/4" = 1'-0"

23 FL5 3/4" = 1'-0"

24 FL7 3/4" = 1'-0"

25 FL6 3/4" = 1'-0"

26 FL5 3/4" = 1'-0"

27 FL7 3/4" = 1'-0"

28 FL6 3/4" = 1'-0"

29 FL5 3/4" = 1'-0"

30 FL7 3/4" = 1'-0"

31 FL6 3/4" = 1'-0"

32 FL5 3/4" = 1'-0"

33 FL7 3/4" = 1'-0"

34 FL6 3/4" = 1'-0"

35 FL5 3/4" = 1'-0"

36 FL7 3/4" = 1'-0"

37 FL6 3/4" = 1'-0"

38 FL5 3/4" = 1'-0"

39 FL7 3/4" = 1'-0"

40 FL6 3/4" = 1'-0"

41 FL5 3/4" = 1'-0"

42 FL7 3/4" = 1'-0"

43 FL6 3/4" = 1'-0"

44 FL5 3/4" = 1'-0"

45 FL7 3/4" = 1'-0"

46 FL6 3/4" = 1'-0"

47 FL5 3/4" = 1'-0"

48 FL7 3/4" = 1'-0"

49 FL6 3/4" = 1'-0"

50 FL5 3/4" = 1'-0"

51 FL7 3/4" = 1'-0"

52 FL6 3/4" = 1'-0"

53 FL5 3/4" = 1'-0"

54 FL7 3/4" = 1'-0"

55 FL6 3/4" = 1'-0"

56 FL5 3/4" = 1'-0"

57 FL7 3/4" = 1'-0"

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67 FL6 3/4" = 1'-0"

68 FL5 3/4" = 1'-0"

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72 FL7 3/4" = 1'-0"

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76 FL6 3/4" = 1'-0"

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78 FL7 3/4" = 1'-0"

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80 FL5 3/4" = 1'-0"

81 FL7 3/4" = 1'-0"

82 FL6 3/4" = 1'-0"

83 FL5 3/4" = 1'-0"

84 FL7 3/4" = 1'-0"

85 FL6 3/4" = 1'-0"

86 FL5 3/4" = 1'-0"

87 FL7 3/4" = 1'-0"

88 FL6 3/4" = 1'-0"

89 FL5 3/4" = 1'-0"

90 FL7 3/4" = 1'-0"

91 FL6 3/4" = 1'-0"

92 FL5 3/4" = 1'-0"

93 FL7 3/4" = 1'-0"

94 FL6 3/4" = 1'-0"

95 FL5 3/4" = 1'-0"

96 FL7 3/4" = 1'-0"

97 FL6 3/4" = 1'-0"

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99 FL7 3/4" = 1'-0"

100 FL6 3/4" = 1'-0"

101 FL5 3/4" = 1'-0"

102 FL7 3/4" = 1'-0"

103 FL6 3/4" = 1'-0"

104 FL5 3/4" = 1'-0"

105 FL7 3/4" = 1'-0"

106 FL6 3/4" = 1'-0"

107 FL5 3/4" = 1'-0"

108 FL7 3/4" = 1'-0"

109 FL6 3/4" = 1'-0"

110 FL5 3/4" = 1'-0"

111 FL7 3/4" = 1'-0"

112 FL6 3/4" = 1'-0"

113 FL5 3/4" = 1'-0"

114 FL7 3/4" = 1'-0"

115 FL6 3/4" = 1'-0"

116 FL5 3/4" = 1'-0"

117 FL7 3/4" = 1'-0"

118 FL6 3/4" = 1'-0"

119 FL5 3/4" = 1'-0"

120 FL7 3/4" = 1'-0"

121 FL6 3/4" = 1'-0"

122 FL5 3/4" = 1'-0"

123 FL7 3/4" = 1'-0"

124 FL6 3/4" = 1'-0"

125 FL5 3/4" = 1'-0"

126 FL7 3/4" = 1'-0"

127 FL6 3/4" = 1'-0"

128 FL5 3/4" = 1'-0"

129 FL7 3/4" = 1'-0"

130 FL6 3/4" = 1'-0"

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133 FL6 3/4" = 1'-0"

134 FL5 3/4" = 1'-0"


135 FL7 3/4" = 1'-0"

136 FL6 3/4" = 1'-0"

137 FL5 3/4" = 1'-0"


138 FL7 3/4" = 1'-0"

139 FL6 3/4" = 1'-0"

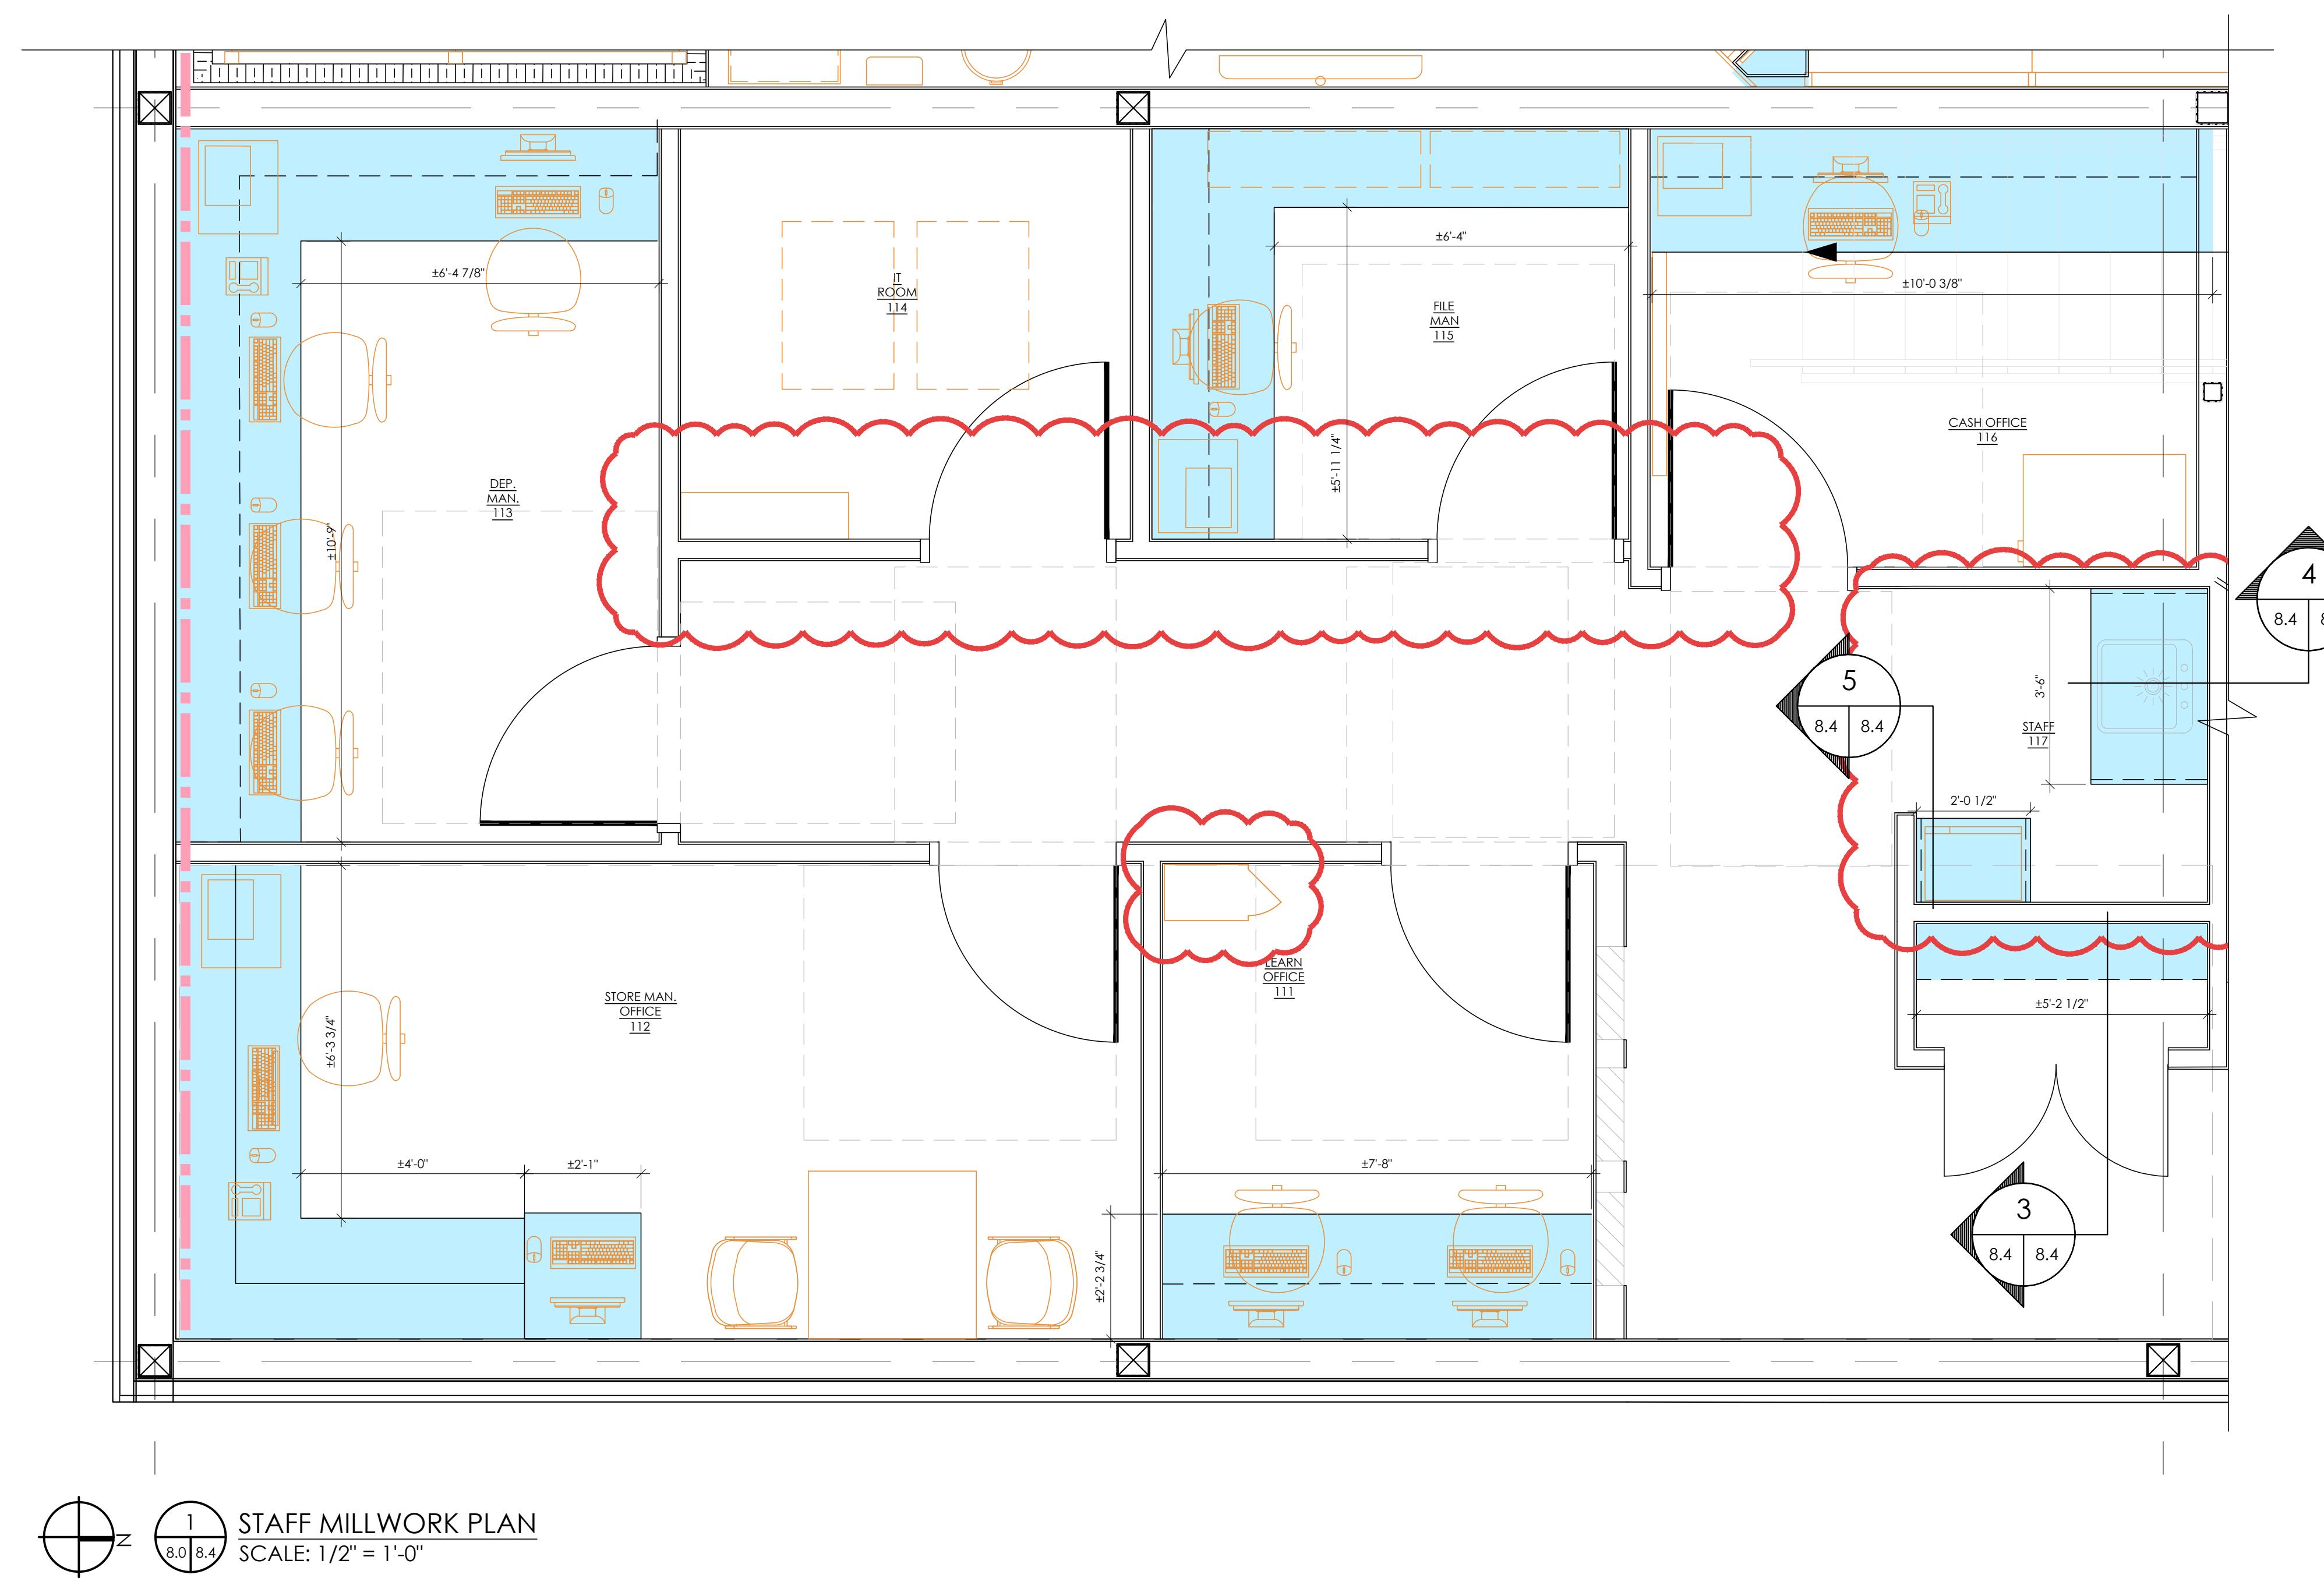




1 STAFF MILLWORK PLAN
SCALE: 1/2" = 1'-0"

DETAIL DRAWINGS ARE FOR REFERENCE ONLY.
REFER TO PROJECT SPECIFIC PLAN ABOVE FOR LAYOUT REQUIREMENTS.

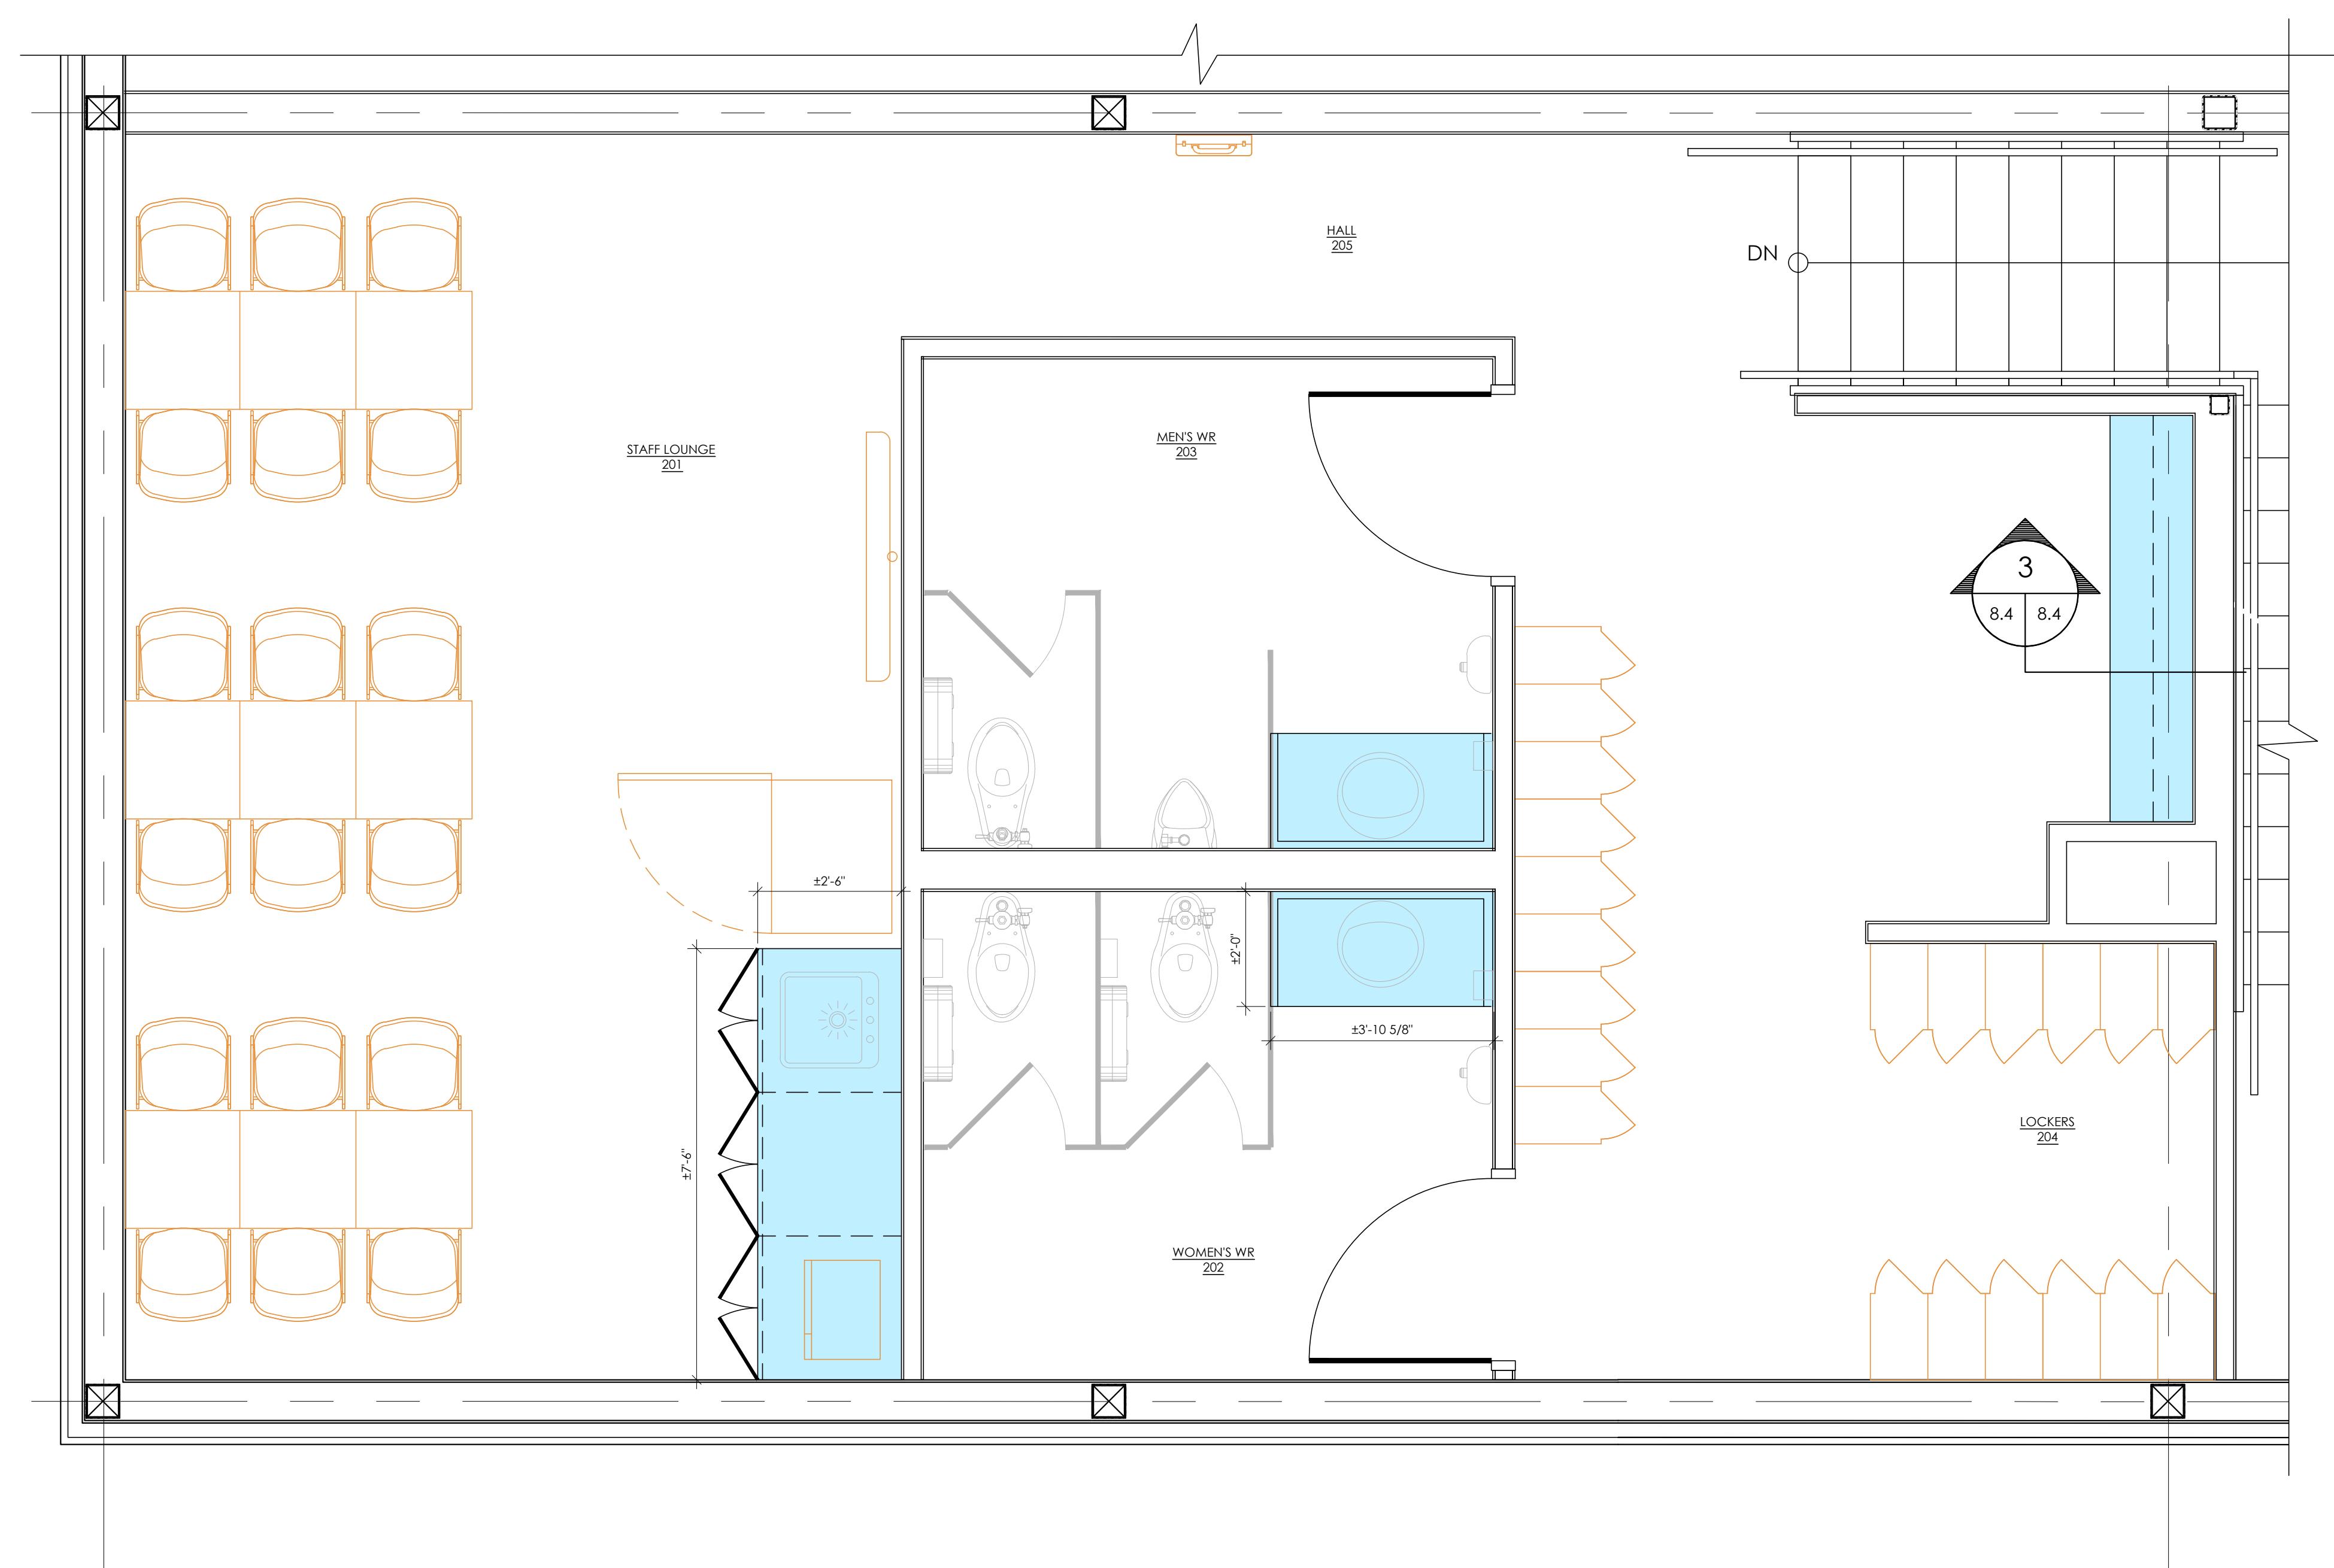

2 MEZZANINE MILLWORK PLAN
SCALE: 1/2" = 1'-0"

MILLWORK SHOP DRAWINGS TO BE
CHECKED AND APPROVED
BY SOBEYS DESIGN (STORE PLANNER)
PRIOR TO PRODUCTION.
REFER TO SOBEYS MASTER FINISH
SCHEDULE.

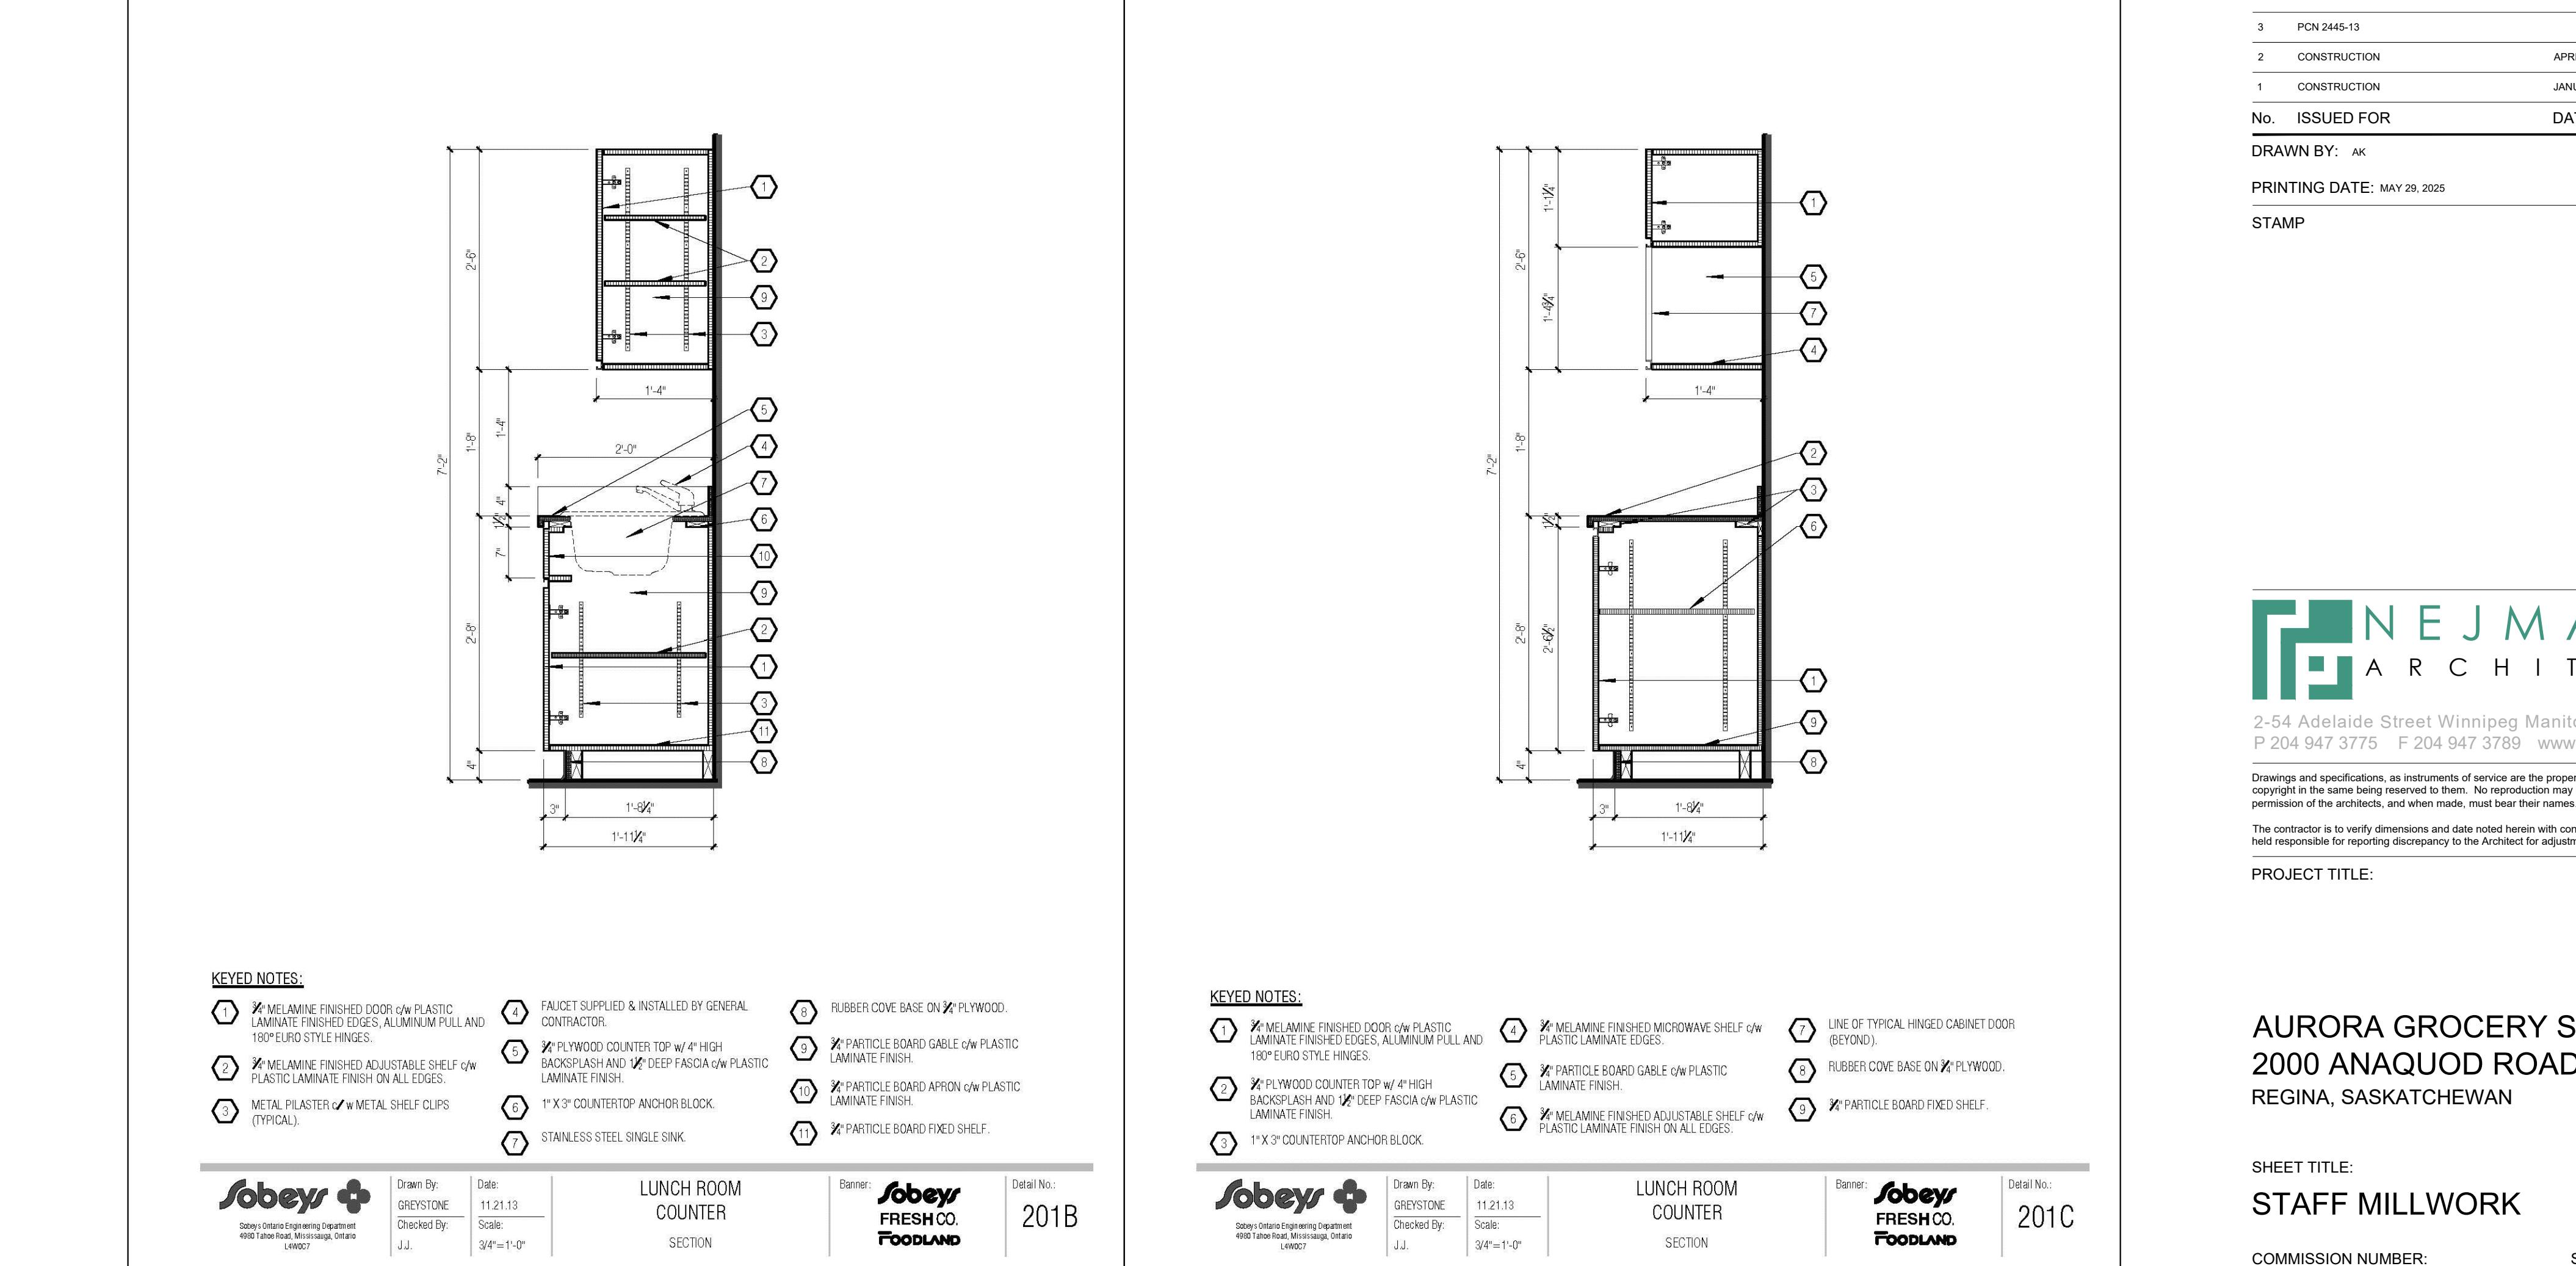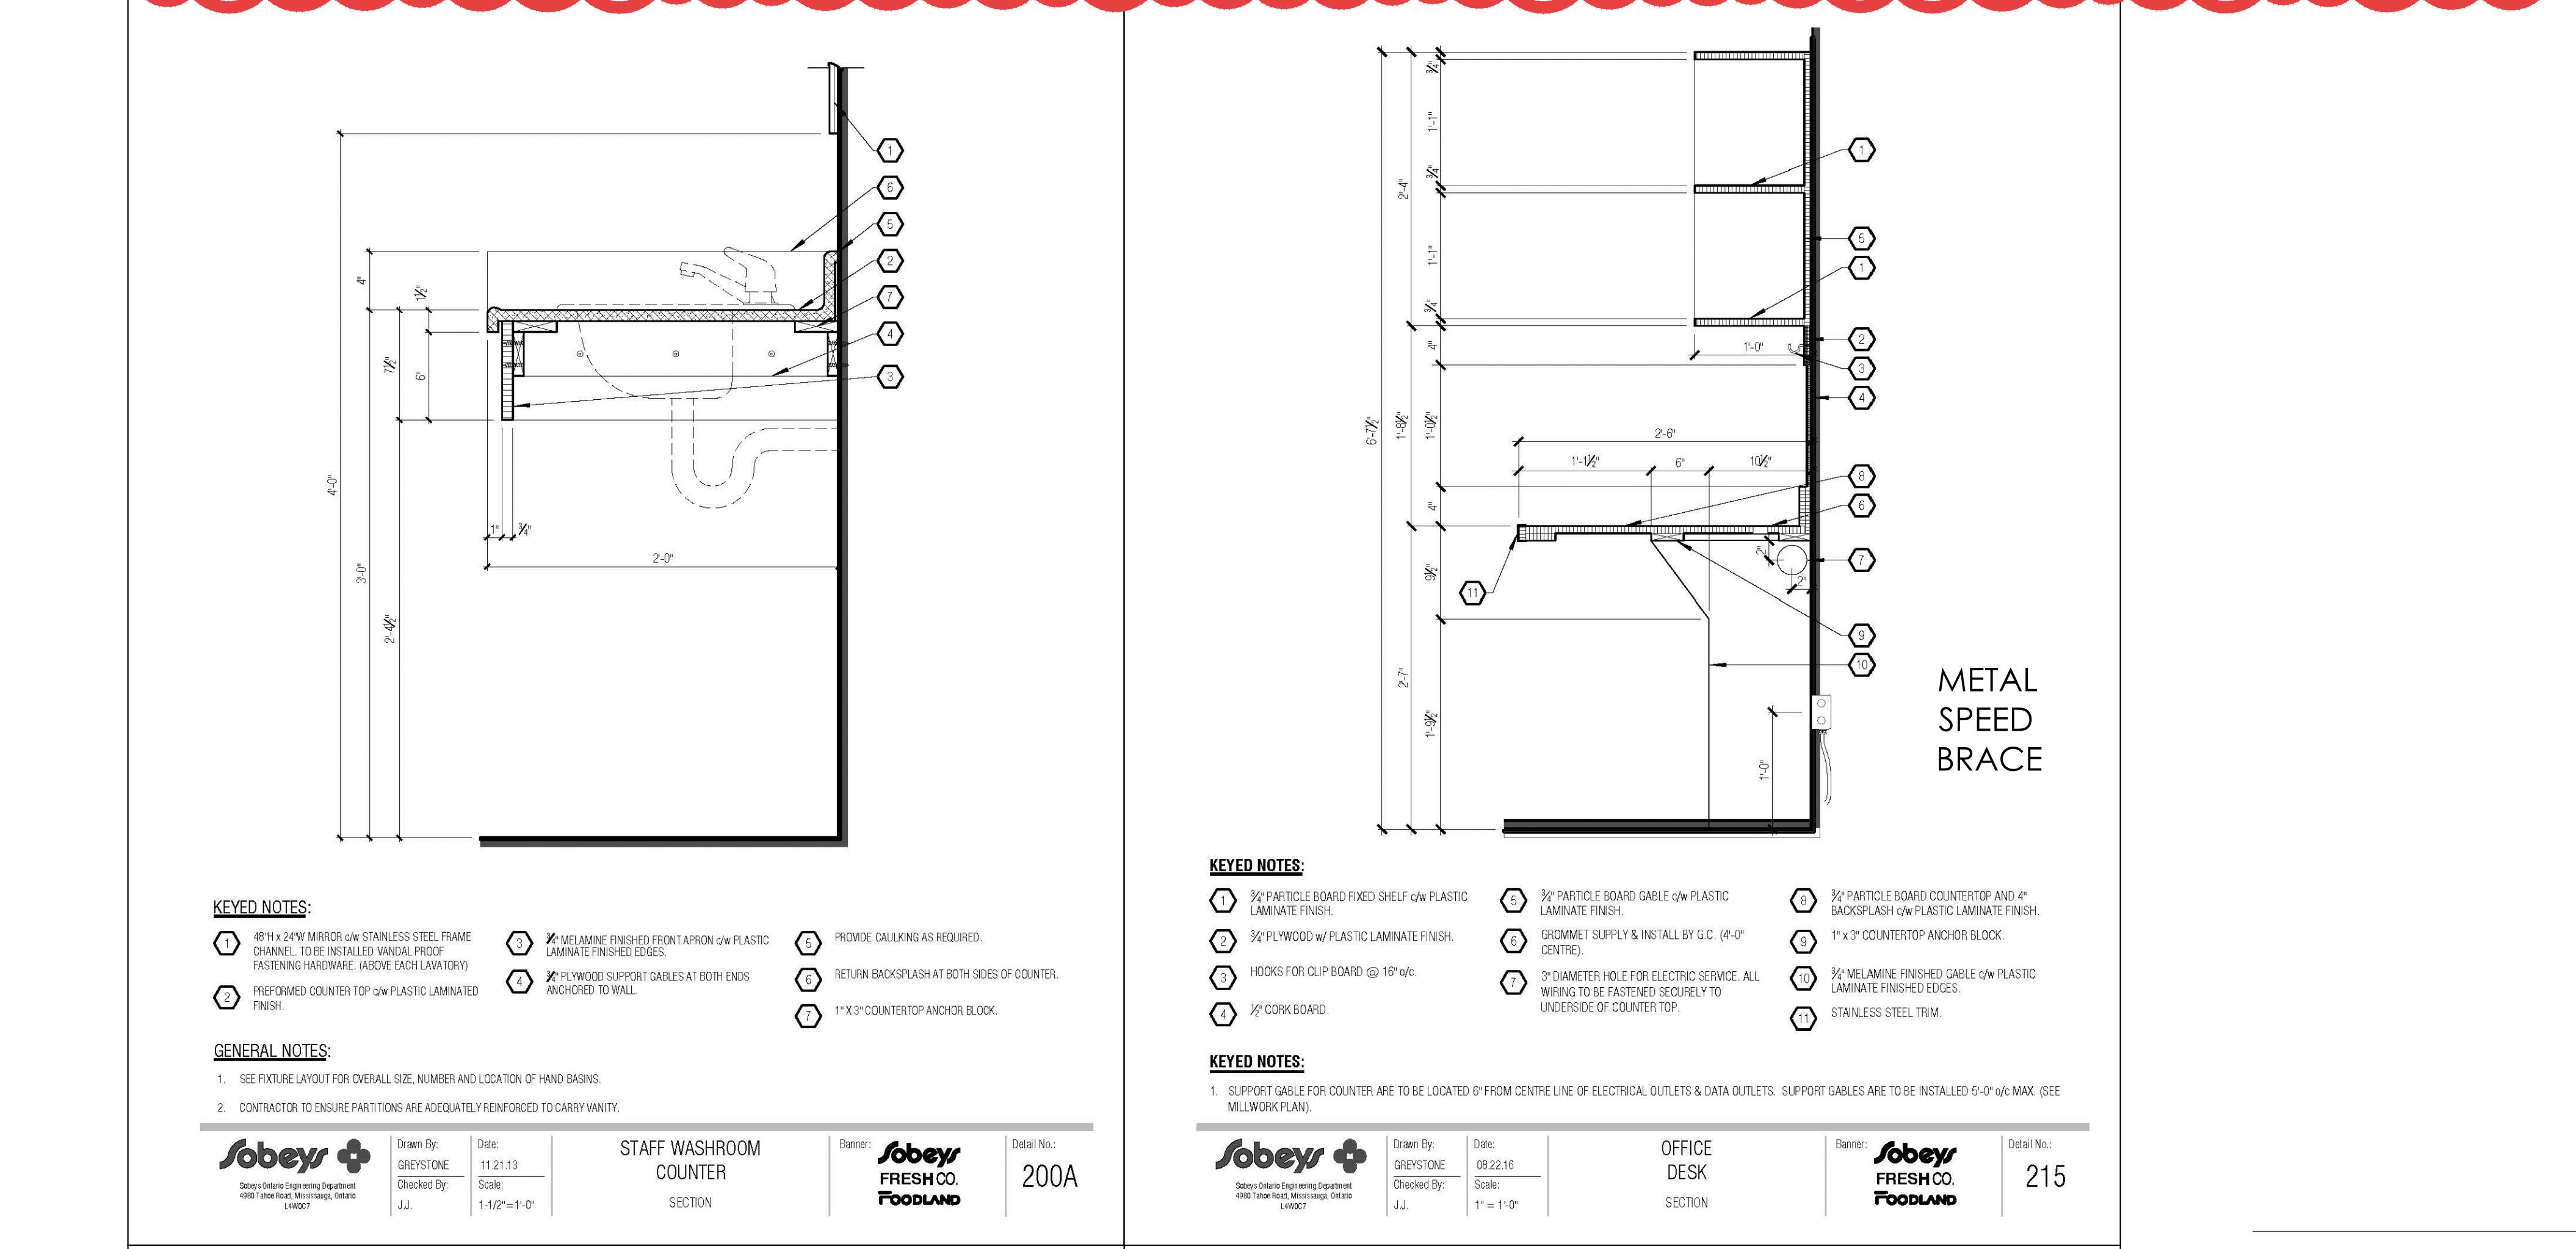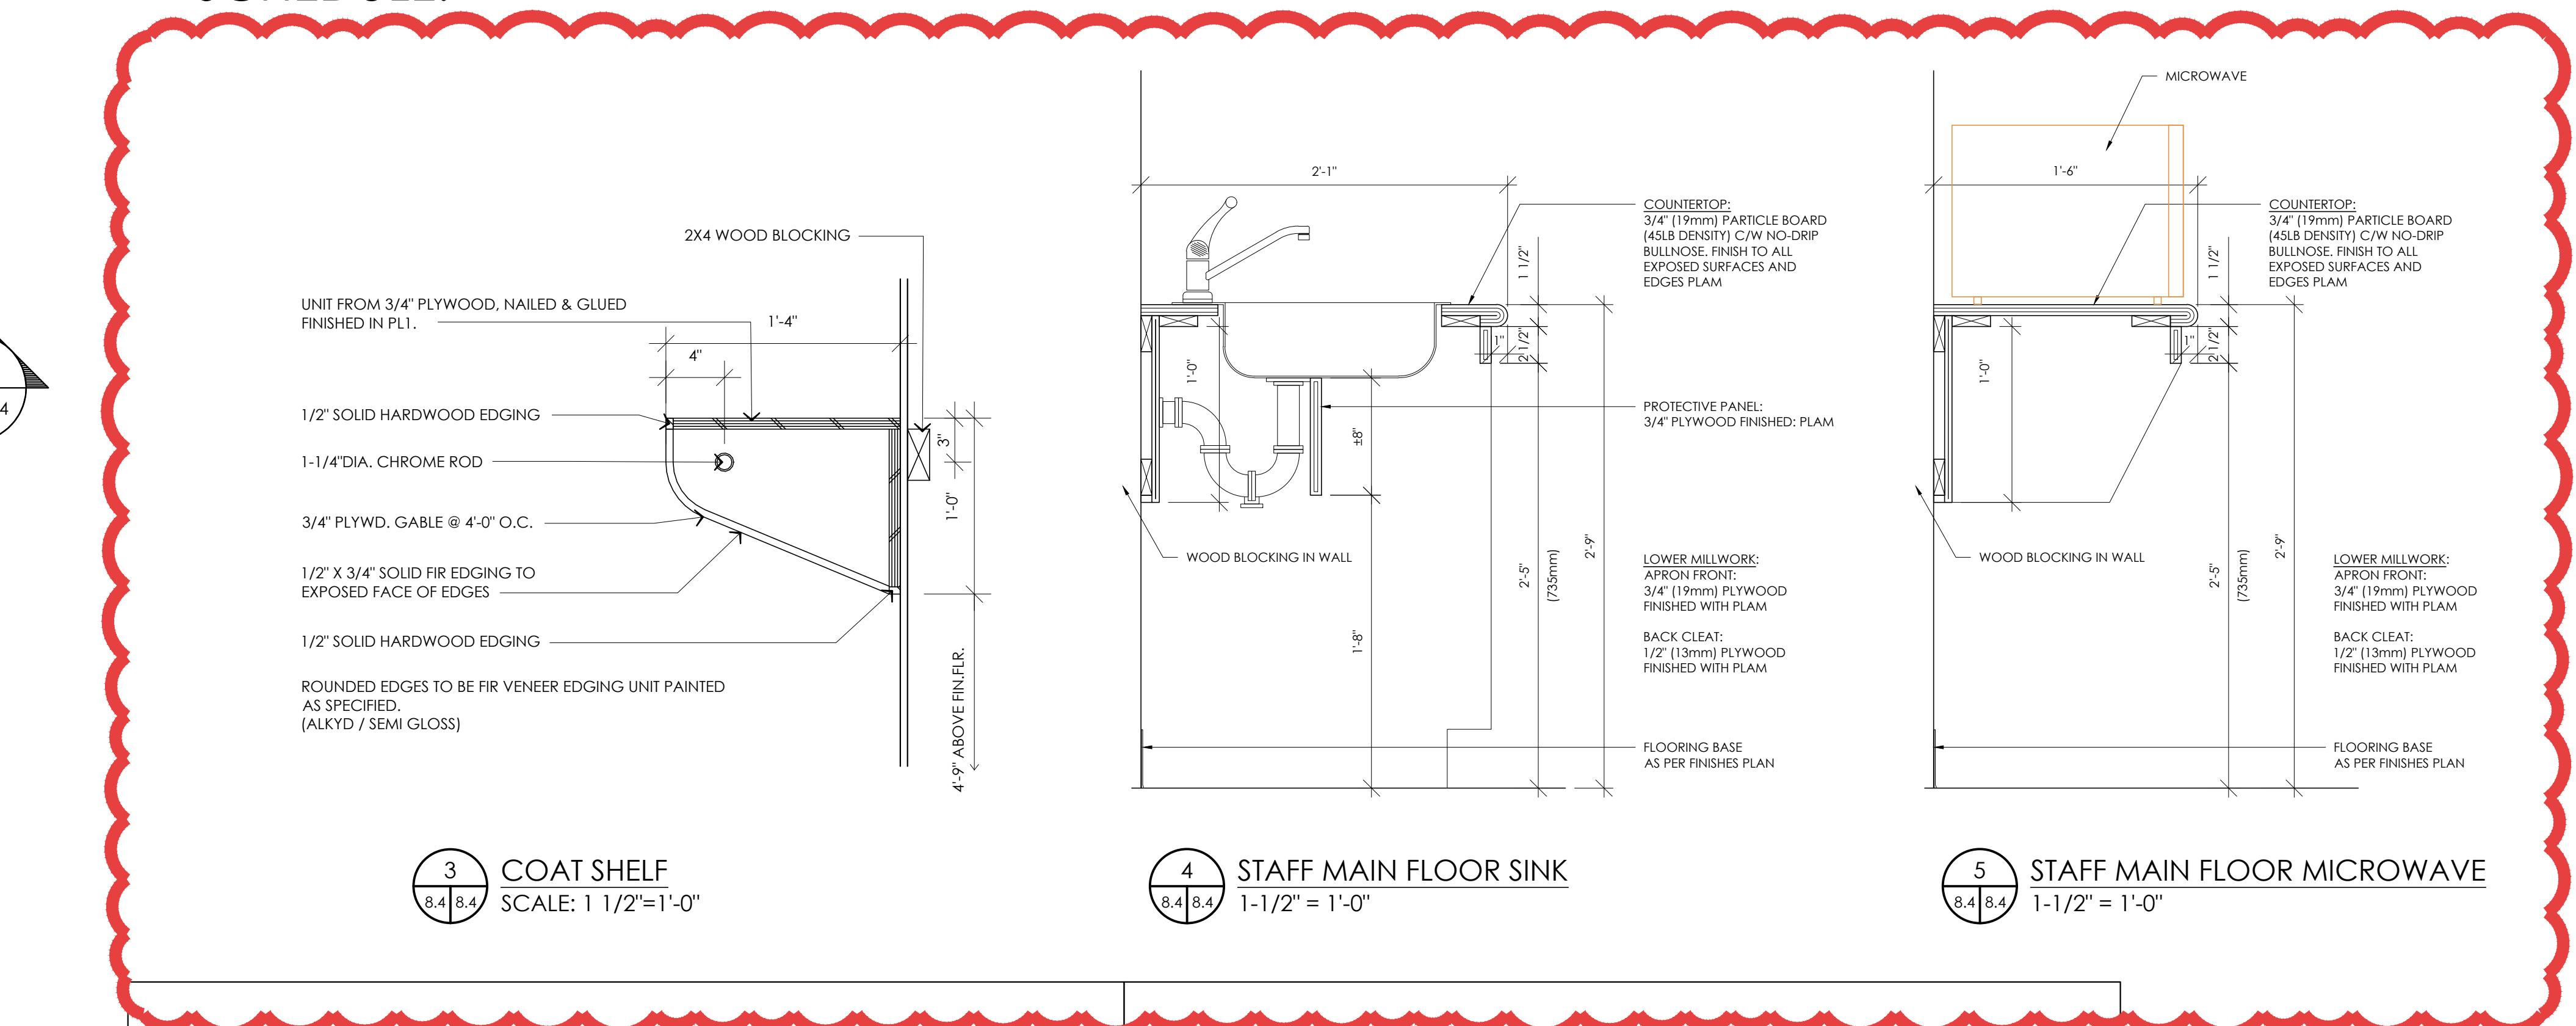

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ARCHITECT
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AURORA GROCERY STORE
2000 ANAQUD ROAD
REGINA, SASKATCHEWAN

SHEET TITLE:
STAFF MILLWORK

COMMISSION NUMBER:
2445

SHEET NUMBER:
A8.4


Project: Aurora Food Store
4801 Optimist Drive, Regina, Saskatchewan
Subject: Adjustments Based on Permit Comments
Date: 2025.06.04

Subject: Add Staff Sink on Main Floor Staff Area
References: Mechanical Drawing – M1.1 – Foundation Plan Plumbing and Pits
Mechanical Drawing – M1.3 – Main Floor Plan - Plumbing

1. Supply and install a new staff sink [SK-1], drain, vent, hot and cold domestic water lines in the main floor employee area as shown on mechanical revision drawings MP-01A and MP-01B.


Subject: Revise the location of the Hand Sink the Butcher Shop
References: Mechanical Drawing – M1.1 – Foundation Plan Plumbing and Pits
Mechanical Drawing – M1.3 – Main Floor Plan - Plumbing

2. Revise the location of the hand sink, drain, vent, hot and cold domestic water lines within the Butcher Shop as shown on mechanical revision drawings MP-01C and MP-01D.

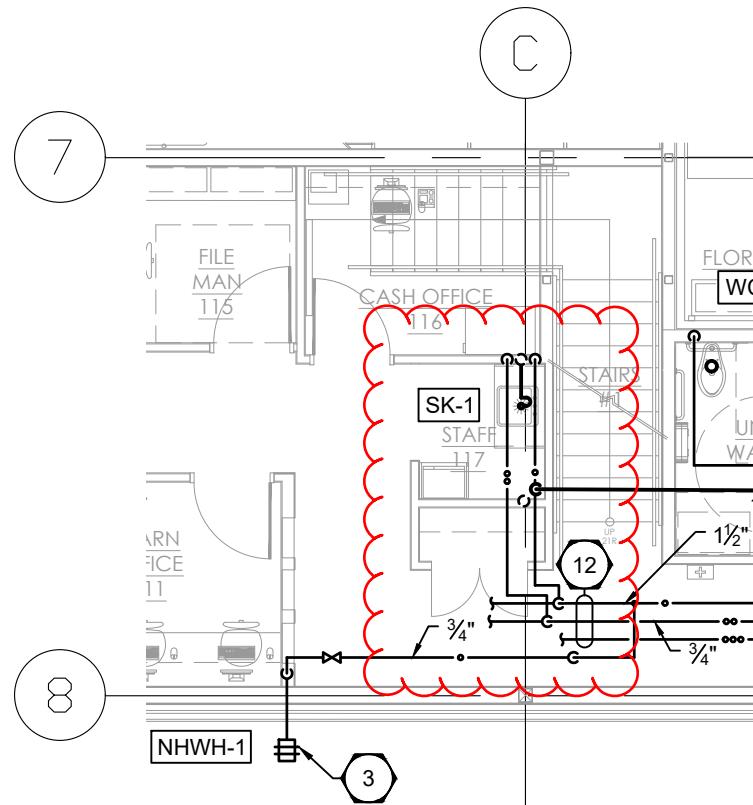

 1
MP-01A WATER AND VENT FOR NEW SINK
SCALE: 1/8" = 1'-0"

CGM ENGINEERING LTD. 200-698 CORYDON AVE WINNIPEG, MB R3M 0X9 (2 0 4) 2 7 2 - 3 2 5 5 PROJECT NO: 24258	PROJECT AURORA FOOD STORE REGINA, SK	SCALE AS NOTED
		DATE 2025.06.04
	DRAWING PROVIDE WATER AND VENT FOR NEW SINK	DWG NO. MP-01A

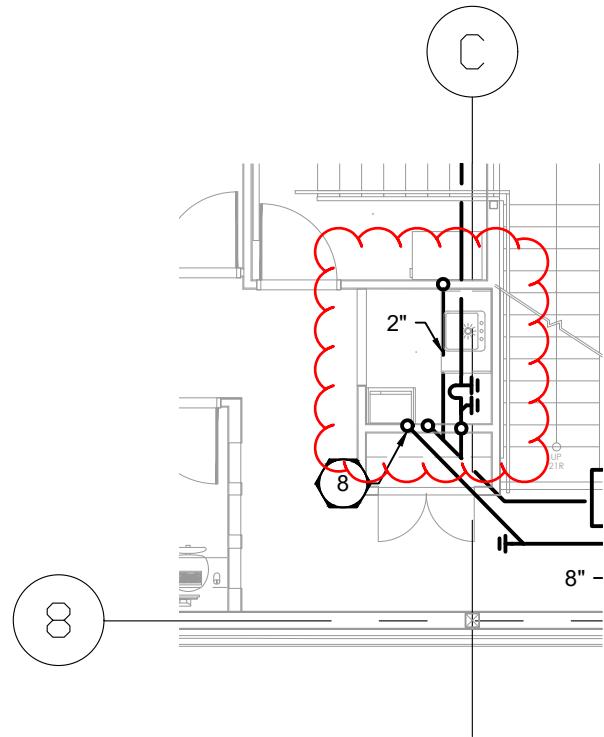

1 DRAIN FOR NEW SINK
MP-01B SCALE: 1/8" = 1'-0"

CGM
ENGINEERING LTD.
200-698 CORYDON AVE
WINNIPEG, MB R3M 0X9
(2 0 4) 2 7 2 - 3 2 5 5
PROJECT NO: 24258



PROJECT
AURORA FOOD STORE
REGINA, SK

SCALE
AS NOTED

DATE
2025.06.04

DRAWING
PROVIDE DRAIN FOR NEW SINK


DWG NO.
MP-01B

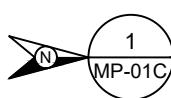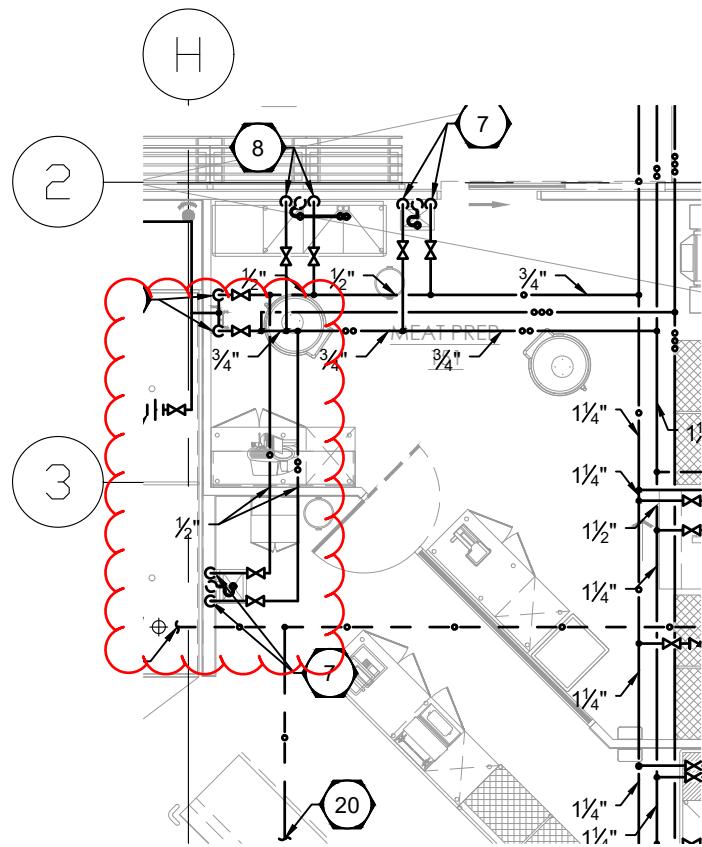

WATER AND VENT FOR RELOCATED SINK

SCALE: 1/8" = 1'-0"

CGM <small>ENGINEERING LTD.</small> 200-698 CORYDON AVE WINNIPEG, MB R3M 0X9 (204) 272-3255 PROJECT NO: 24258	PROJECT AURORA FOOD STORE <small>REGINA, SK</small>	SCALE <small>AS NOTED</small>
		DATE <small>2025.06.04</small>
	DRAWING REVISE WATER AND VENT HAND SINK	DWG NO. MP-01C

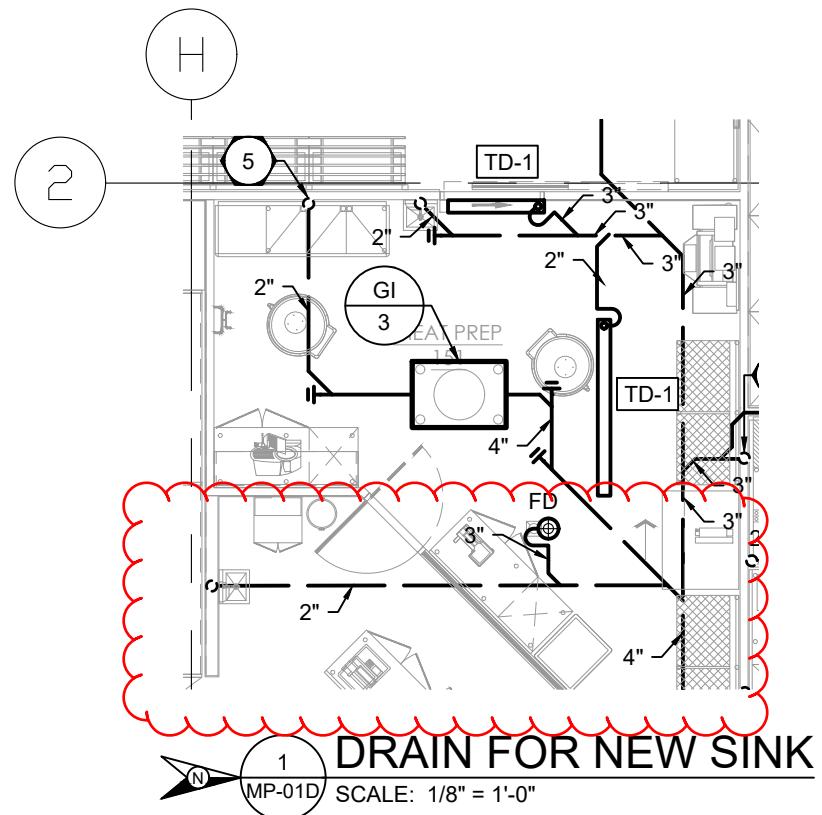

CGM ENGINEERING LTD. 200-698 CORYDON AVE WINNIPEG, MB R3M 0X9 (2 0 4) 2 7 2 - 3 2 5 5 PROJECT NO: 24258	PROJECT AURORA FOOD STORE REGINA, SK	SCALE AS NOTED
	DRAWING REVISE DRAIN FOR NEW SINK	DATE 2025.06.04
		DWG NO. MP-01D

Project: Aurora Grocery Store
2000 Anaquod Road, Regina, Saskatchewan
Subject: Adjustments Based on Permit Comments
Date: 2025.06.05

Subject: Add Staff Room on Main Floor Staff Area
References: Electrical Drawing E0.2 – Schedules
Electrical Drawing E1.0 – Lighting
Electrical Drawing E2.0 – Power

1. Refer to attached drawing E1.0 for one(1) additional type 'F1' light fixture added to new 'Staff 117'.
2. Refer to attached drawings E0.2 and E2.0 for one(1) additional receptacle c/w dedicated 15A-1P circuit for microwave.

Subject: Butcher Shop and Seafood Prep Ceilings Revised to T-Bar/ACT.
References: Electrical Drawing E1.0 - Lighting

3. Refer to attached drawing E1.0 for revised lighting layout in the 'Butcher Shop 150' and 'Seafood Prep 137' areas.
 - 3.1. Ten(10) type VT light fixtures are removed. Provide credit to owners for the removal these light fixtures from the project.
 - 3.2. Ten(10) type F1 light fixtures are added to 'Butcher Shop 150' and 'Seafood Prep 137' areas to replace the previous Type VT fixtures.

Subject: Add Receptacles, Circuits and Data for Owner Equipment.
References: Electrical Drawing E0.3 – Schedules
Electrical Drawing E2.0 – Power
Electrical Drawing E5.0 - Communications

4. Refer to attached drawings E0.3, E2.0 and E5.0 for additional receptacles, circuits and data for owner equipment.
 - 4.1. One(1) receptacle and one(1) 15A-1P circuit is added for the ATM machine.
 - 4.2. One(1) 15A-1P circuit is added for a dedicated circuit to the Coinstar machine.
 - 4.3. One(1) 15A-1P circuit is added for a dedicated circuit to the Water Dispenser.
 - 4.4. Specific note 16 is added to drawing E5.0 and states the following:
 - 4.4.1. "PROVIDE AND INSTALL ONE 1/2" EMT CONDUIT C/W PULLSTRING FROM SERVER RACK IN IT ROOM FOR ATM MACHINE DATA."

PANEL '100A'					
400A-34760V-IPH-4W PANEL SURFACE MOUNTED IN COMPRESSOR ROOM 300					
DESCRIPTION	CIRCUIT BREAKER	PHASE A B C	CIRCUIT BREAKER	PHASE A B C	DESCRIPTION
PANEL '1L'	100	1 9 2	20	3 4	GAS COOLER
		3 4 6		5 6	
TIVS #10 WIRE	30	9 10	30	COMPACTOR #10 WIRE	
		11 12		13 14	
SPACE	-	15 16	30	BALER #10 WIRE	
SPACE	-	17 18			
SPACE	-	19 20	-	SPACE	
SPACE	-	21 22	-	SPACE	
SPACE	-	23 24	-	SPACE	
SPACE	-	25 26	-	SPACE	
SPACE	-	27 28	-	SPACE	
SPACE	-	29 30	-	SPACE	
SPACE	-	31 32	-	SPACE	
SPACE	-	33 34	-	SPACE	
SPACE	-	35 36	-	SPACE	
SPACE	-	37 38	-	SPACE	
SPACE	-	39 40	-	SPACE	
SPACE	-	41 42	-	SPACE	

PANEL 'SD-2'					
1200A-120/208V-3PH-4W PANEL SURFACE MOUNTED IN COMPRESSOR ROOM 300					
DESCRIPTION	CIRCUIT BREAKER	PHASE A B C	CIRCUIT BREAKER	PHASE A B C	DESCRIPTION
PANEL 'O'	100	1 9 2	20	3 4	200 PANEL 'R1L'
		5 6		7 8	
PANEL 'C1'	100	9 10	400 PANEL 'R2L'		
		11 12		13 14	
PANEL 'R1M'	200	15 16	400 PANEL 'R3L'		
		17 18		19 20	
PANEL 'Z'	100	21 22	400 PANEL 'R4L'		
		23 24		25 26	
SPACE	-	27 28	-	SPACE	
SPACE	-	29 30	-	SPACE	
SPACE	-	31 32	-	SPACE	
SPACE	-	33 34	-	SPACE	
SPACE	-	35 36	-	SPACE	
SPACE	-	37 38	-	SPACE	
SPACE	-	39 40	-	SPACE	
SPACE	-	41 42	-	SPACE	

PANEL 'O'					
100A-120/208V-3PH-4W PANEL RECESS MOUNTED IN OFFICE CORRIDOR					
DESCRIPTION	CIRCUIT BREAKER	PHASE A B C	CIRCUIT BREAKER	PHASE A B C	DESCRIPTION
MAIN - HOUSEKEEPING	15	1 9 2	20	3 4	COUNTER RECEPTACLES
MAIN - IT RACK	20	3 4	15	5 6	COMPUTER DESKS
MAIN - IT RACK	20	5 6	15	7 8	HOUSEKEEPING
MAIN - IT RACK	20	7 8	15	9 10	FRONT COUNTER RECEPTACLES
MAIN - CASH OFFICE - DRAFT	15	1 9 10	15	11 12	FRONT COUNTER RECEPTACLES
MAIN - CASH OFFICE - PRINTER	15	13 14	15	15 16	SECOND - HANDRYER
MAIN - FILE MANAGER - RECEPTACLES	15	15 16	15	17 18	SECOND - WASHROOM RECEPTACLES
MAIN - FILE MANAGER - RECEPTACLES	15	19 20	15	20 21	SECOND - HOUSEKEEPING
MAIN - TELECOM BACKBOARD	20	21 22	15	23 24	SECOND - HOUSEKEEPING
MAIN - DEPARTMENT MANAGER - PRINTER	15	25 26	20	26 27	SECOND - COUNTER RECEPTACLES
MAIN - DEPARTMENT MANAGER - RECEPTACLES	15	29 30	15	31 32	SECOND - MICROWAVE
MAIN - MANAGEMENT MANAGER - RECEPTACLES	15	32 33	15	33 34	SECOND - TV
MAIN - STORE MANAGER - PRINTER	15	35 36	20	33 34	EV-1, EVAPORATOR
MAIN - LEADERSHIP MANAGER - RECEPTACLES	15	37 38	15	39 40	EBB-1, BASEBOARD HEATER (2 x 1.0 kW)
MAIN - JANITOR ROOM	20	41	15	39 40	EBB-1, BASEBOARD HEATER (2 x 1.0 kW)
MAIN - MICROWAVE	15	41	15	42 43	EBB-1, BASEBOARD HEATER (1 x 0.5 kW)
SPACE	-	43 44	-	SPACE	
SPACE	-	45 46	-	SPACE	
SPACE	-	47 48	-	EXHAUST FAN	
SPACE	-	49 50	-	SPACE	
SPACE	-	51 52	-	SPACE	
SPACE	-	53 54	-	SPACE	
SPACE	-	55 56	-	SPACE	
SPACE	-	57 58	-	SPACE	
SPACE	-	59 60	-	SPACE	

PANEL '100B'					
400A-34760V-IPH-4W PANEL SURFACE MOUNTED IN COMPRESSOR ROOM 300					
DESCRIPTION	CIRCUIT BREAKER	PHASE A B C	CIRCUIT BREAKER	PHASE A B C	DESCRIPTION
RTU-1, ROOF TOP UNIT #1 WIRE	125	1 9 2	15	RTU-4, ROOF TOP UNIT	
		3 4		5 6	
		7 8			
RTU-2, ROOF TOP UNIT #4 WIRE	70	9 10	15	RTU-5, ROOF TOP UNIT	
		11 12			
RTU-3, ROOF TOP UNIT #10 WIRE	30	15 16	15	RTU-6, ROOF TOP UNIT	
		17 18			
EF-1, EXHAUST FAN	15	21 22	30	AC-1, AIR CURTAIN #10 WIRE	
		23 24			
TIVS #10 WIRE	30	27 28	-	SPACE	
		29 30	-	SPACE	
		31 32	-	SPACE	
		33 34	-	SPACE	
		35 36	-	SPACE	
		37 38	-	SPACE	
		39 40	-	SPACE	
		41 42	-	SPACE	

PANEL 'GL'					
100A-34760V-IPH-4W PANEL SURFACE MOUNTED IN WEST STAFF CORRIDOR					
DESCRIPTION	CIRCUIT BREAKER	PHASE A B C	CIRCUIT BREAKER	PHASE A B C	DESCRIPTION
LIGHTING - SALES - LIGHTS	15	1 9 2	2	15	LIGHTING - SALES
SPACE	15	3 4	15	4 5	LIGHTING - SALES
SPACE	15	5 6	15	6 7	LIGHTING - SALES
LIGHTING - SEATING	15	7 9	8	15	LIGHTING - SALES
LIGHTING - CHECKOUTS	15	9 10	15	10 11	LIGHTING - SALES
LIGHTING - OFFICE	15	11 12	15	12 13	LIGHTING - SALES
LIGHTING - DELI	15	13 14	15	14 15	LIGHTING - RECEIVING / WAREHOUSE
LIGHTING - BAKERY	15	15 17	15	16 18	LIGHTING - COMPRESSOR ROOM
LIGHTING - IRR	15	19 20	15	21 22	LIGHTING - COOLERS
LIGHTING - SEAFOOD / MEATS / PRODUCE	15	21 22	15	23 24	LIGHTING - VESTIBULE
SPACE	-	25 26	15	26 27	LIGHTING - EXTERIOR
SPACE	-	27 28	-	SPACE	
SPACE	-	29 30	-	SPACE	
SPACE	-	31 32	-	SPACE	
SPACE	-	33 34	-	SPACE	
SPACE	-	35 36	-	SPACE	
SPACE	-	37 38	-	SPACE	
SPACE	-	39 40	-	SPACE	
SPACE	-	41 42	-	SPACE	

PANEL 'SD-1'					
1200A-120/208V-3PH-4W PANEL SURFACE MOUNTED IN COMPRESSOR ROOM 300					
DESCRIPTION					



PANEL 'B2'						
200A/120/208V/3PH-4W PANEL SURFACE MOUNTED IN WEST STAFF CORRIDOR						
DESCRIPTION	CIRCUIT BREAKER	PHASE A	B	C	CIRCUIT BREAKER	DESCRIPTION
DWH-1, DOMESTIC WATER HEATER	15	1	9	2	-	SPACE
DWH-2, DOMESTIC WATER HEATER	15	3	9	4	15	EF3- EXHAUST FAN
P-1, RE-CIRCULATION PUMP	15	5	9	6	15	EF4- EXHAUST FAN
P-2, RE-CIRCULATION PUMP	15	7	9	8	15	EF5- EXHAUST FAN
CU-1, CONDENSING UNIT	20	9	10	15	15	EF6- EXHAUST FAN
MUA-1, MAKE-UP AIR	20	11	9	14	15	EF7- EXHAUST FAN
EFF-9, EXHAUST FAN #10 WIRE	30	21	9	15	15	EF8- EXHAUST FAN
ERV-1, ENERGY RECOVERY VENTILATOR	20	23	9	16	15	UH1- UNHEATED
EHC-2, ELECTRIC HEATING COIL #8 WIRE	15	25	9	26	15	UH2- UNIT HEATER
EHC-2, ELECTRIC HEATING COIL #8 WIRE	50	27	9	28	15	UH3- UNIT HEATER
EFF-1, FORCE FLOW HEATER (1 x 2 kW)	15	39	9	40	-	SPACE
EFF-1, FORCE FLOW HEATER (1 x 2 kW)	15	41	9	42	-	SPACE
EBB-1, BASEBOARD HEATERS (4 x 1 kW)	45	43	9	44	-	SPACE
EBB-1, BASEBOARD HEATERS (4 x 1 kW)	55	45	9	46	-	SPACE
ICE COOLER	33	9	34	15	15	MOTORIZED DAMPERS
EXTERIOR SIGNAGE	35	9	36	15	15	SPARE
EXTENDED RECEIVING RECEPTACLES	35	9	37	15	15	BILLBOARD - CHECKOUT
COUNTER RECEPCETACLES	35	9	38	15	15	BILLBOARD - CHECKOUT
COUNTER RECEPCETACLES	35	9	39	15	15	BILLBOARD - CHECKOUT
COUNTER RECEPCETACLES	35	9	40	15	15	BILLBOARD - CHECKOUT
ROLLER WINDOW SHUTTER	15	43	9	44	15	ROLLER WINDOW SHUTTER
ROLLER WINDOW SHUTTER	15	45	9	46	15	ROLLER WINDOW SHUTTER
ROLLER WINDOW SHUTTER	15	47	9	48	15	ROLLER WINDOW SHUTTER
EXTERIOR SIGNAGE	15	51	9	52	-	SPACE
WATER DISPENSER	15	53	9	54	-	SPACE
COINSTAR	15	55	9	56	-	SPACE
ATM	15	57	9	58	-	SPACE
ICE COOLER	15	59	9	60	-	SPACE
SPACE	15	61	9	62	-	SPACE
SPACE	15	63	9	64	-	SPACE
SPACE	15	65	9	66	-	SPACE
SPACE	15	67	9	68	-	SPACE
SPACE	15	69	9	70	-	SPACE
SPACE	15	71	9	72	-	SPACE
SPACE	15	73	9	74	-	SPACE
SPACE	15	75	9	76	-	SPACE
SPACE	15	77	9	78	-	SPACE
SPACE	15	79	9	80	-	SPACE
SPACE	15	81	9	82	-	SPACE
SPACE	15	83	9	84	-	SPACE

PANEL 'C2'						
200A/120/208V/3PH-4W PANEL RECESS MOUNTED IN OFFICE CORRIDOR						
DESCRIPTION	CIRCUIT BREAKER	PHASE A	B	C	CIRCUIT BREAKER	DESCRIPTION
CHECKOUT #1	15	1	9	2	15	SELF CHECKOUT #1
CHECKOUT #1	15	3	9	4	15	SELF CHECKOUT #1
CHECKOUT #2	15	5	9	6	15	SELF CHECKOUT #2
CHECKOUT #2	15	7	9	8	15	SELF CHECKOUT #2
CHECKOUT #3	15	9	9	10	15	SELF CHECKOUT #3
CHECKOUT #3	15	11	9	12	15	SELF CHECKOUT #3
CHECKOUT #4	15	13	9	14	15	SELF CHECKOUT #4
CHECKOUT #4	15	15	9	16	15	SELF CHECKOUT #4
CHECKOUT #5	15	17	9	18	15	SELF CHECKOUT #5
CHECKOUT #5	15	19	9	20	15	SELF CHECKOUT #5
CHECKOUT #6	15	21	9	22	15	SELF CHECKOUT #6
CHECKOUT #6	15	23	9	24	15	SELF CHECKOUT #6
CHECKOUT #7	15	25	9	26	15	SERVICE DESK
CHECKOUT COOLER	15	25	9	27	15	SERVICE DESK
CHECKOUT COOLER	15	25	9	29	15	SERVICE DESK
EXTERIOR SIGNAGE	15	31	9	32	15	SERVICE DESK
ICE COOLER	15	33	9	34	15	SERVICE DESK
EXTENDED RECEIVING RECEPTACLES	15	35	9	36	15	BILLBOARD - CHECKOUT
COUNTER RECEPCETACLES	15	37	9	38	15	BILLBOARD - CHECKOUT
COUNTER RECEPCETACLES	15	39	9	40	15	BILLBOARD - CHECKOUT
COUNTER RECEPCETACLES	15	41	9	42	15	BILLBOARD - CHECKOUT
ROLLER WINDOW SHUTTER	15	43	9	44	-	SPACE
ROLLER WINDOW SHUTTER	15	45	9	46	-	SPACE
ROLLER WINDOW SHUTTER	15	47	9	48	-	SPACE
EXTERIOR SIGNAGE	15	51	9	52	-	SPACE
WATER DISPENSER	15	53	9	54	-	SPACE
COINSTAR	15	55	9	56	-	SPACE
ATM	15	57	9	58	-	SPACE
ICE COOLER	15	59	9	60	-	SPACE
SPACE	15	61	9	62	-	SPACE
SPACE	15	63	9	64	-	SPACE
SPACE	15	65	9	66	-	SPACE
SPACE	15	67	9	68	-	SPACE
SPACE	15	69	9	70	-	SPACE
SPACE	15	71	9	72	-	SPACE
SPACE	15	73	9	74	-	SPACE
SPACE	15	75	9	76	-	SPACE
SPACE	15	77	9	78	-	SPACE
SPACE	15	79	9	80	-	SPACE
SPACE	15	81	9	82	-	SPACE
SPACE	15	83	9	84	-	SPACE

PANEL 'R2'						
400A/120/208V/3PH-4W PANEL SURFACE MOUNTED IN WEST STAFF CORRIDOR						
DESCRIPTION	CIRCUIT BREAKER	PHASE A	B	C	CIRCUIT BREAKER	DESCRIPTION
AL-C1 (DEFROST HEATERS)	15	1	9	2	25	AL-E1 (EVAPORATOR PANEL A)
AL-C2 (DEFROST HEATERS)	15	3	9	4	25	AL-E2 (EVAPORATOR PANEL B)
AL-C3 (DEFROST HEATERS)	15	5	9	6	-	SPACE
AL-C4 (DEFROST HEATERS)	15	7	9	8	25	AL-C16 (DEFROST HEATERS)
AL-C5 (DEFROST HEATERS)	15	9	9	10	-	SPACE
AL-C6 (DEFROST HEATERS)	15	11	9	12	-	SPACE
AL-C7 (DEFROST HEATERS)	15	13	9	14	-	SPACE
AL-C8 (DEFROST HEATERS)	15	15	9	16	-	SPACE
AL-C9 (DEFROST HEATERS)	15	17	9	18	-	SPACE
AL-C10 (DEFROST HEATERS)	15	19	9	20	-	SPACE
AL-C11 (DEFROST HEATERS)	15	21	9	22	-	SPACE
AL-C12 (DEFROST HEATERS)	15	23	9	24	-	SPACE
AL-C13 (DEFROST HEATERS)	15	25	9	26	-	SPACE
AL-C14 (DEFROST HEATERS)	15	27	9	28	-	SPACE
AL-C15 (DEFROST HEATERS)	15	29	9	30	-	SPACE
AL-C16 (DEFROST HEATERS)	15	31	9	32	-	SPACE
AL-C17 (DEFROST HEATERS)	15	33	9	34	-	SPACE
AL-C18 (DEFROST HEATERS)	15	35	9	36	-	SPACE
AL-C19 (DEFROST HEATERS)	15	37	9	38	-	SPACE
AL-C20 (DEFROST HEATERS)	15	39	9	40	-	SPACE
AL-C21 (DEFROST HEATERS)	15	41	9	42	-	SPACE
AL-C22 (DEFROST HEATERS)	15	43	9	44	-	SPACE
AL-C23 (DEFROST HEATERS)	15	45	9	46	-	SPACE
AL-C24 (DEFROST HEATERS)	15	47	9	48	-	SPACE
AL-C25 (DEFROST HEATERS)	15	49	9	50	-	SPACE
AL-C26 (DEFROST HEATERS)	15	51	9	52	-	SPACE
AL-C27 (DEFROST HEATERS)	15	53	9	54	-	SPACE
AL-C28 (DEFROST HEATERS)	15	55	9	56	-	SPACE
AL-C29 (DEFROST HEATERS)	15	57	9	58	-	SPACE
AL-C30 (DEFROST HEATERS)	15					

GENERAL NOTES

- ALL SUSPENDED FIXTURE ACCESSORIES AND VISIBLE JUNCTION BOXES TO MATCH CEILING FINISH.
- ELECTRICAL CONTRACTOR TO COORDINATE AND INSTALL ALL LIGHTING FIXTURES PROVIDED BY OTHERS, INCLUDING FINAL CONDUIT AND WIRING.
- UNLESS OTHERWISE NOTED, ALL LIGHTING FIXTURES ARE SUPPLIED AND INSTALLED BY ELECTRICAL CONTRACTOR. CONTRACTOR IS RESPONSIBLE FOR ALL NECESSARY MOUNTING HARDWARE SUCH AS STEEL CHANNELS, ALL LIGHTING FIXTURES MUST BE TIED IN WITH BUILDING EMS SYSTEM AS REQUIRED. COORDINATE WITH MICRO THERMO WEST LIGHTING CONTROL SYSTEM WITH MICRO THERMO WEST ON SITE.
- REFER TO ARCHITECTURAL DECOR LIGHTING AND REFLECTED CEILING PLAN FOR EXACT MOUNTING HEIGHTS AND ALL LIGHTING FIXTURES.
- LIGHTING CONTROLS INCLUDE LOW VOLTAGE CONTROL PANELS TO BE PROVIDED AND INSTALLED BY EC. COORDINATE THE PURCHASE AND INSTALLATION OF ALL LIGHTING CONTROLS. CONTRACTOR IS RESPONSIBLE FOR TIE-IN WITH MICRO THERMO WEST LIGHTING CONTROL SYSTEM.
- ALL LIGHTING CONTROLS ARE TO BE TIED IN WITH MICRO THERMO WEST LIGHTING CONTROL SYSTEM.
- NECESSARY MOUNTING HARDWARE SUCH AS STEEL CHANNELS, ALL LIGHTING FIXTURES MUST BE TIED IN WITH BUILDING EMS SYSTEM AS REQUIRED. COORDINATE WITH MICRO THERMO WEST LIGHTING CONTROL SYSTEM WITH MICRO THERMO WEST ON SITE.

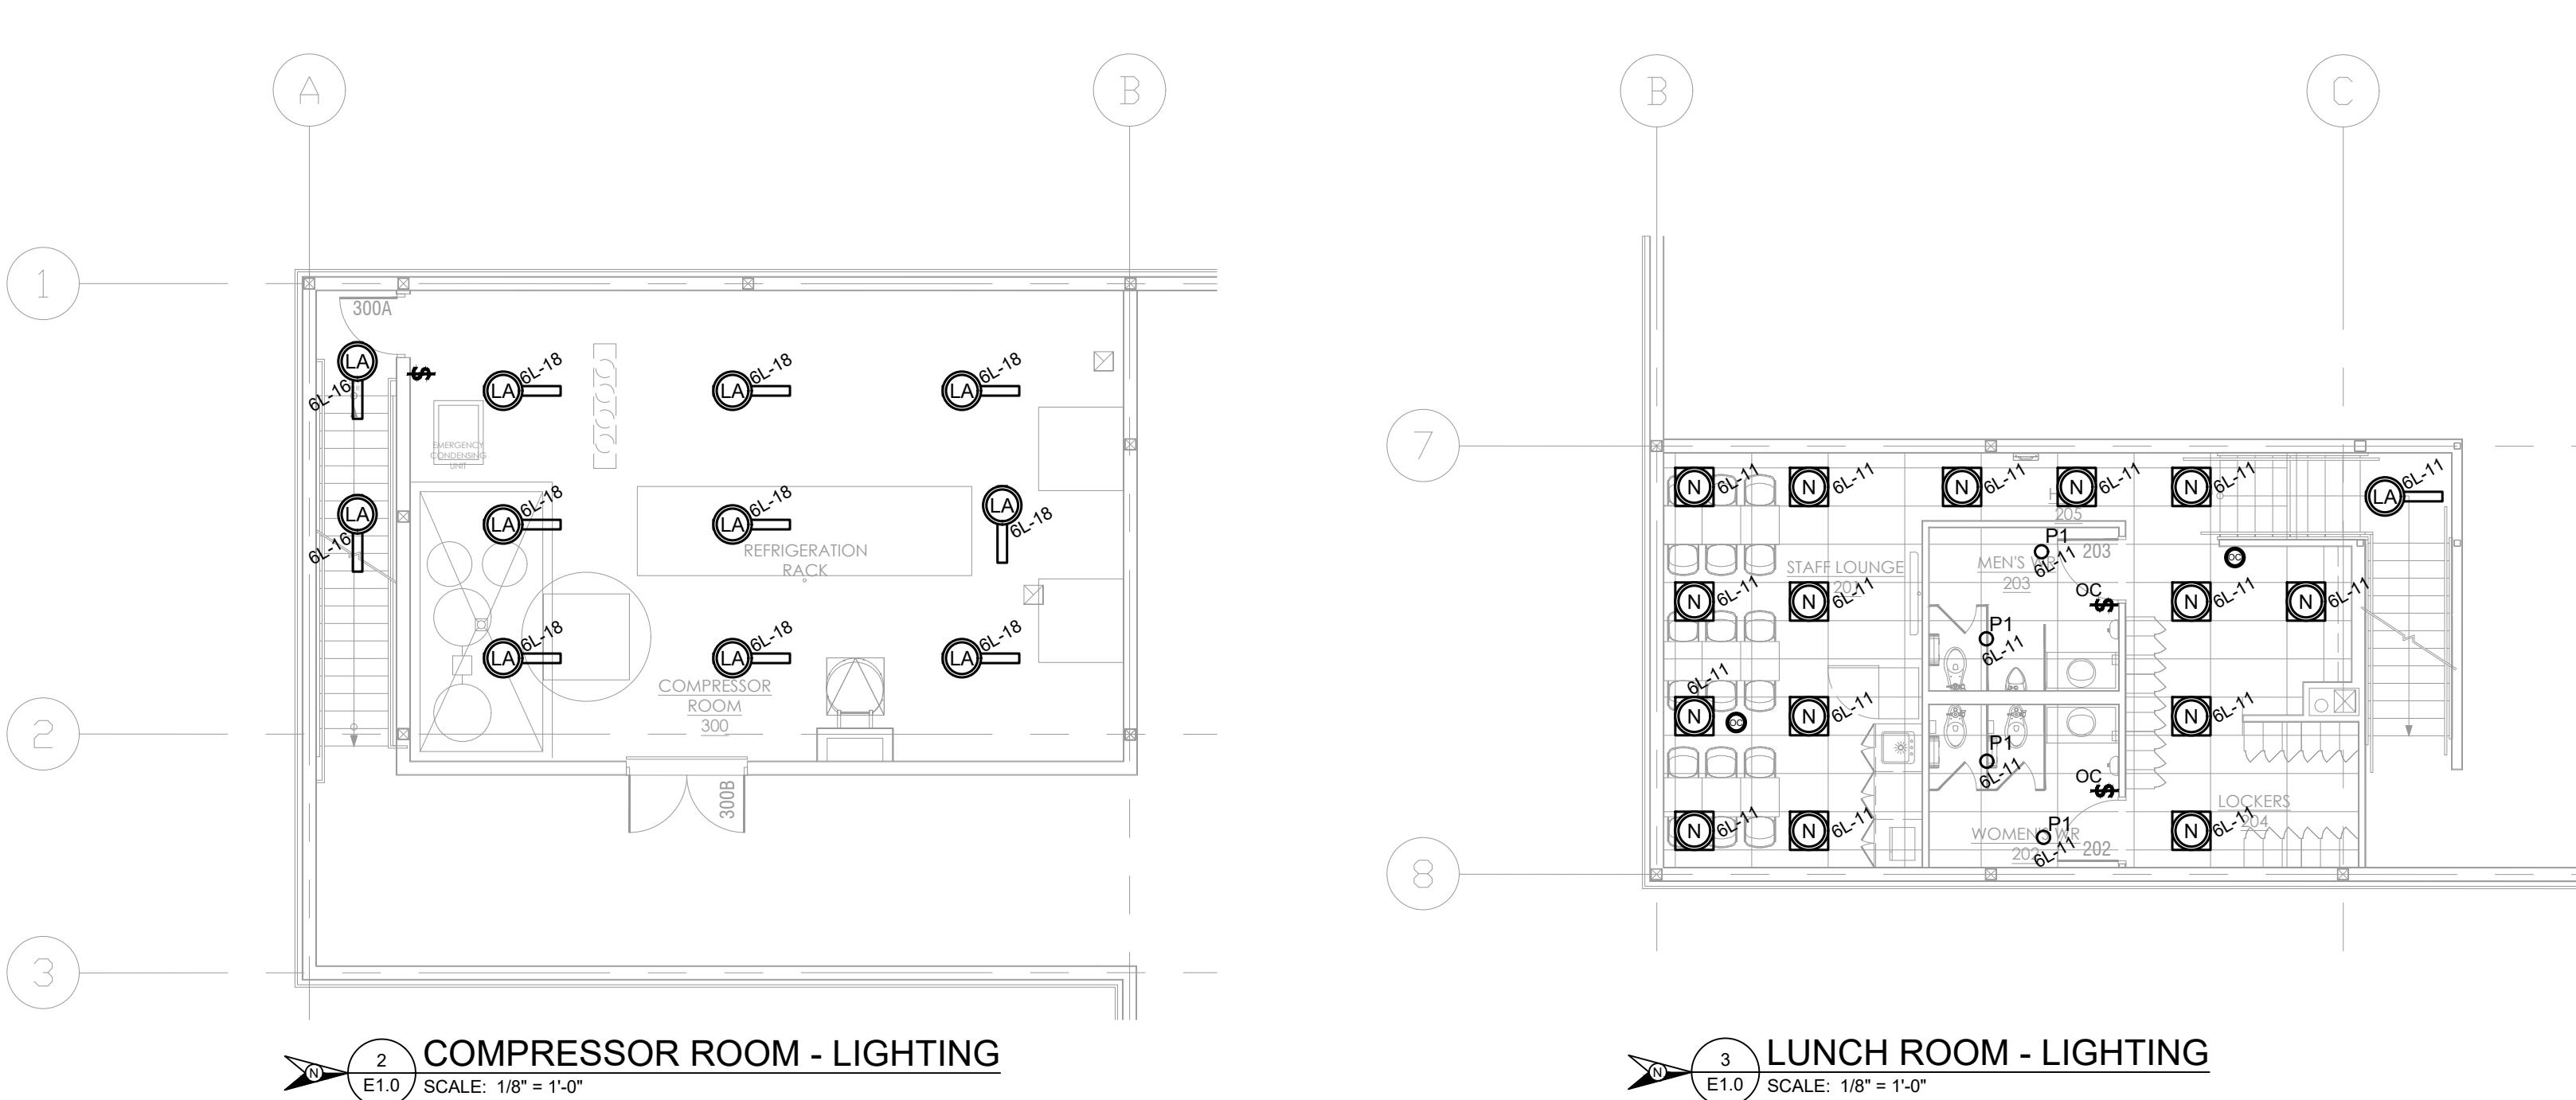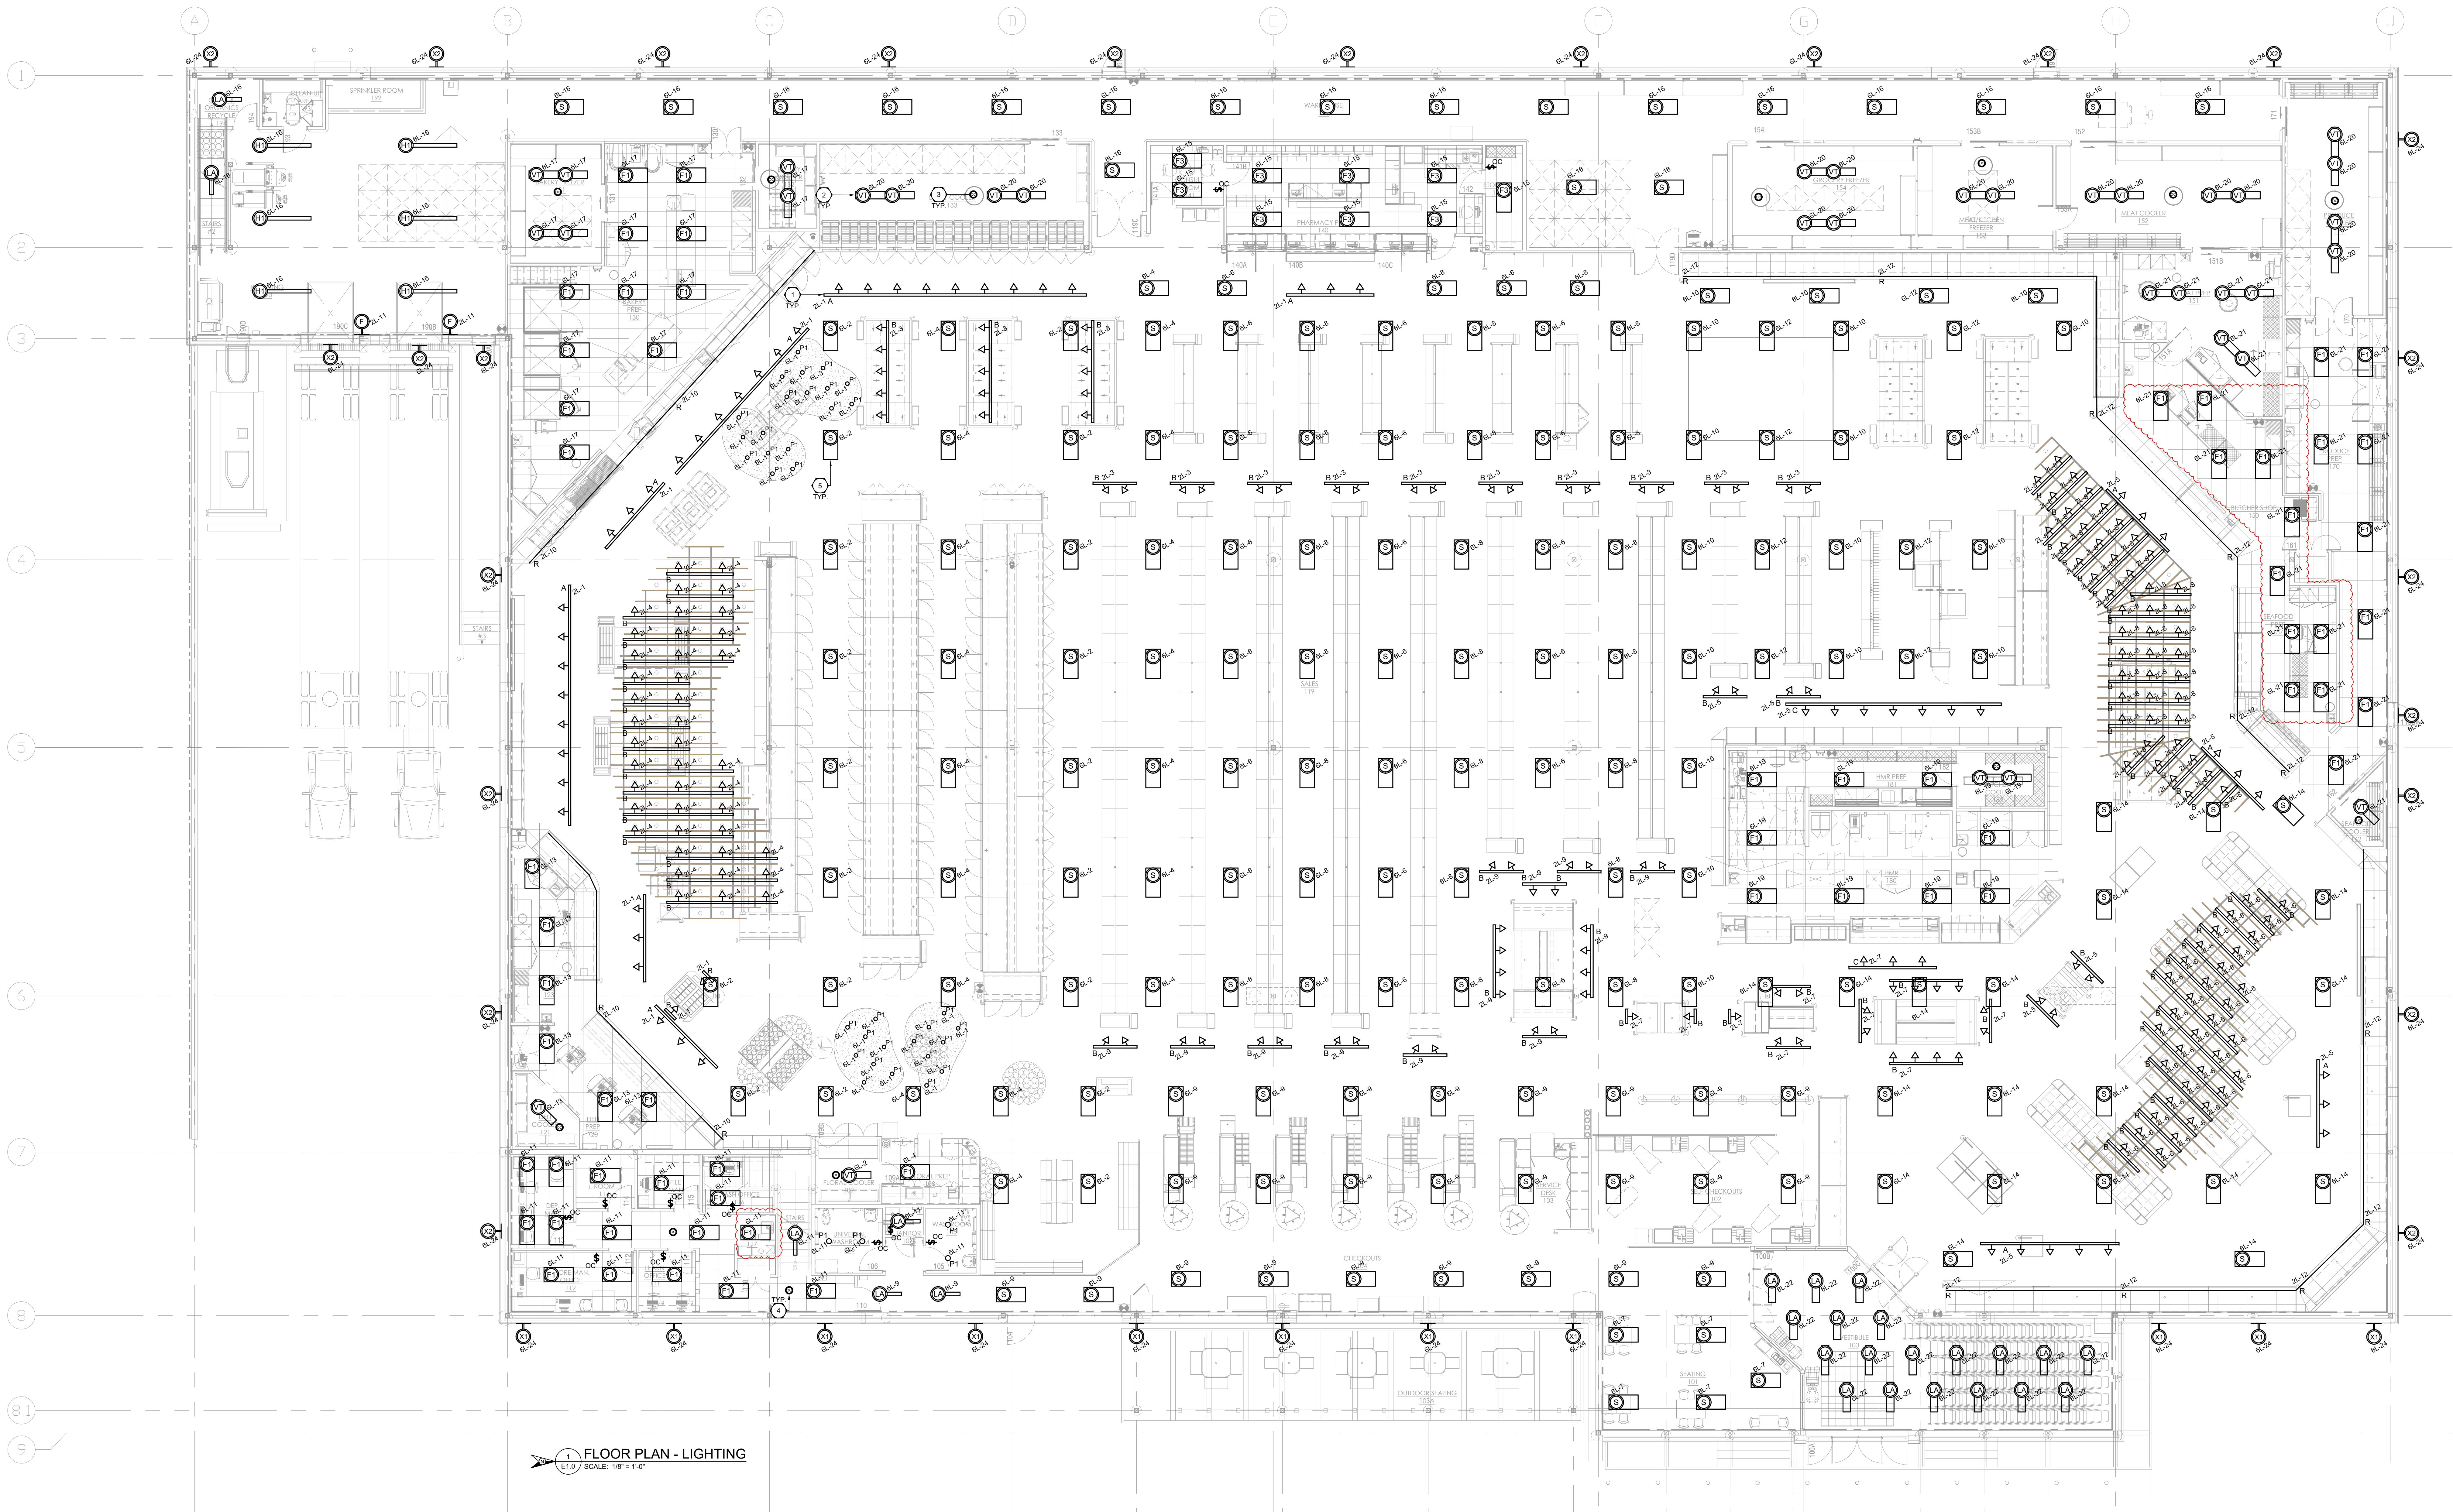

DRAWING NOTES - LIGHTING

- ① ALL TRACK LIGHTING TO BE SUSPENDED ON THREADED ROD. FOLLOW MANUFACTURER'S DIRECTIONS FOR QUANTITIES OF SUSPENSION POINTS. TYPICAL.
- ② PRIOR TO ROUGH-IN OF ALL COOLER/FREEZER LUMINAIRES, COORDINATE WITH THE REFRIGERATION CONTRACTOR TO AVOID COOLANT LEAKS. REFRIGERATION COILS SEAL CONDUIT TO LUMINAIRES. TYPICAL.
- ③ PROVIDE CEILING MOUNT LOW TEMPERATURE OCCUPANCY SENSOR. COORDINATE WITH REFRIGERATION CONTRACTOR SO SENSOR IS NOT IN DIRECT LINE OF COOL AIR FLOW. TYPICAL OF ALL COOLERS.
- ④ PROVIDE DUAL-TECH OCCUPANCY SENSOR. PROVIDE VOLTAGE TO SUIT SENSOR TO PROVIDED LOCAL CONTROL OF THE LIGHTS IN THE AREA. TYPICAL.
- ⑤ LIGHT FIXTURE TYPE 'S' TO BE SUSPENDED WITH AIRCRAFT CABLE FROM UNSTRUT SUPPORT BETWEEN JOISTS. TYPICAL.

LIGHTING ZONE SCHEDULE

ZONE	LIGHTING CIRCUIT	AREA DESCRIPTION	CONTROL SCHEME
1	6L-22	VESTIBULE	EMS TIMECLOCK
2	6L-14	SALES AREA HIGH BAYS - WEST	EMS TIMECLOCK
3	6L-10, 6L-14	SALES AREA HIGH BAYS - EAST	EMS TIMECLOCK
4	6L-5, 6L-7	347V SALES AREA POT LIGHTS	EMS TIMECLOCK
5	2L-2, 2L-4, 2L-10, 2L-12	120V SALES AREA TRACK AND BULKHEAD LIGHTING	EMS TIMECLOCK
6	6L-16	WAREHOUSE / RECEIVING	EMS TIMECLOCK
7	6L-18	COMPRESSOR ROOM	EMS TIMECLOCK
8	6L-17	BAKERY	EMS TIMECLOCK / OCCUPANCY SENSORS
9	6L-15	PHARMACY	EMS TIMECLOCK / OCCUPANCY SENSORS
10	6L-21	SEAFOOD / MEATS / PRODUCE	EMS TIMECLOCK / OCCUPANCY SENSORS
11	6L-19	H.M.R.	EMS TIMECLOCK / OCCUPANCY SENSORS
12	6L-20	LARGE COOLERS	OCCUPANCY SENSOR
13	2L-2	SEATING	EMS TIMECLOCK
14	6L-11	OFFICE	OCCUPANCY SENSOR
15	6L-24	EXTERIOR LIGHTS	EMS TIMECLOCK


NOTES:
1. ZONE SCHEDULE SHOWN FOR INFORMATION ONLY. WIRING, COMPONENT AND PROGRAMMING REQUIREMENTS TO BE COORDINATED WITH THE SUPPLIER FOR THE SYSTEM USED.

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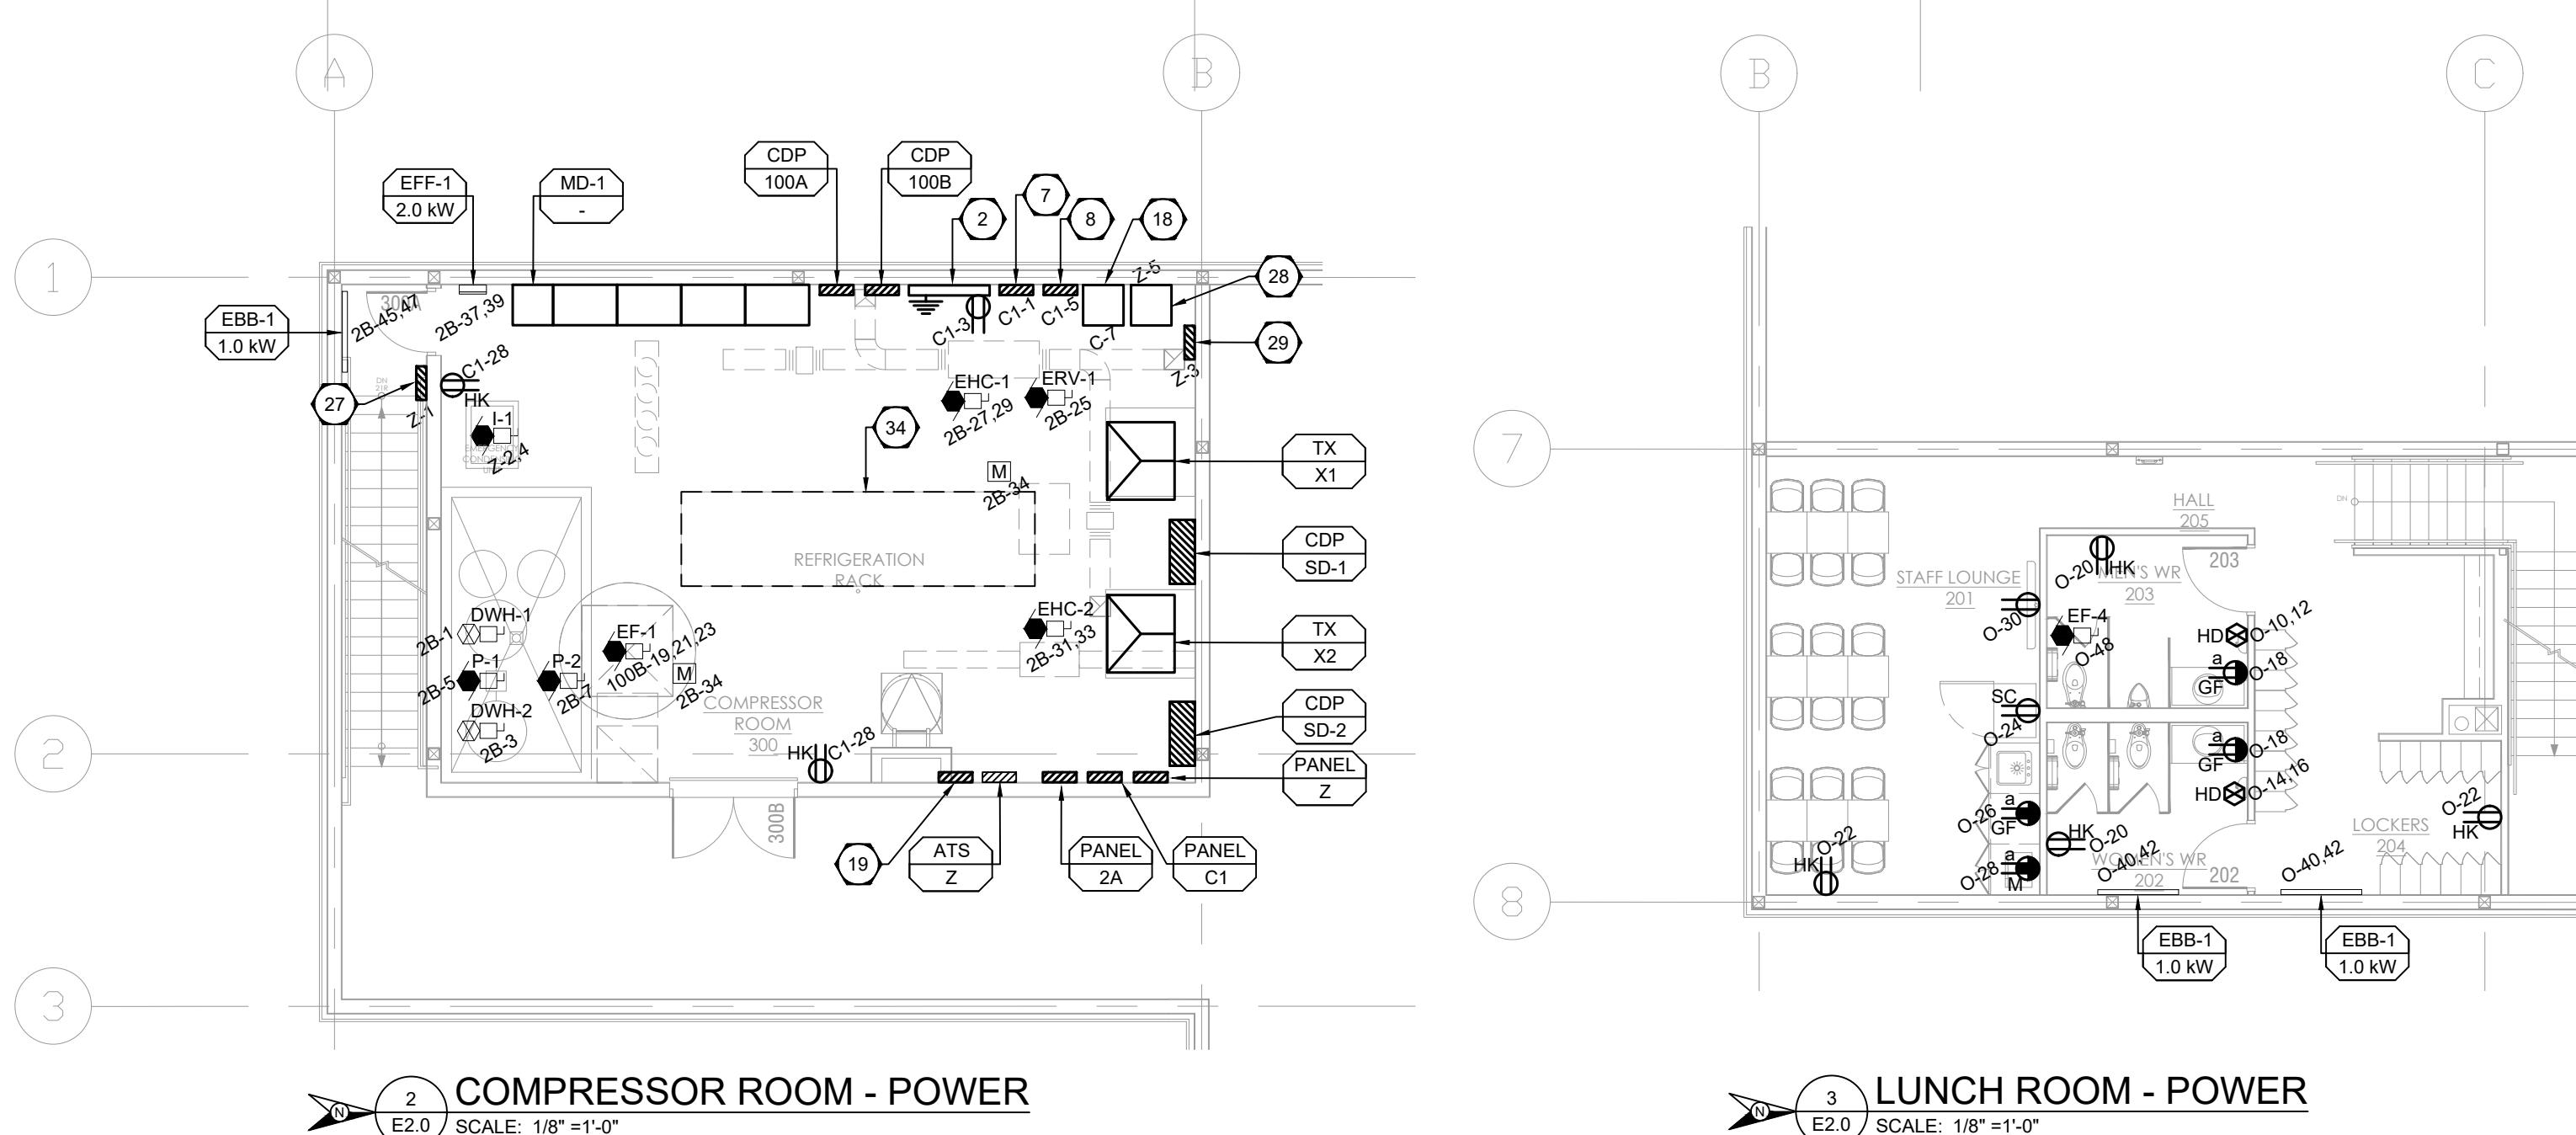
AURORA GROCERY STORE
2000 ANAQUD ROAD
REGINA, SASKATCHEWAN

FLOOR PLAN - LIGHTING
COMMISSION NUMBER: 2445
SHEET NUMBER: E1.0



FLOOR PLAN - POWER

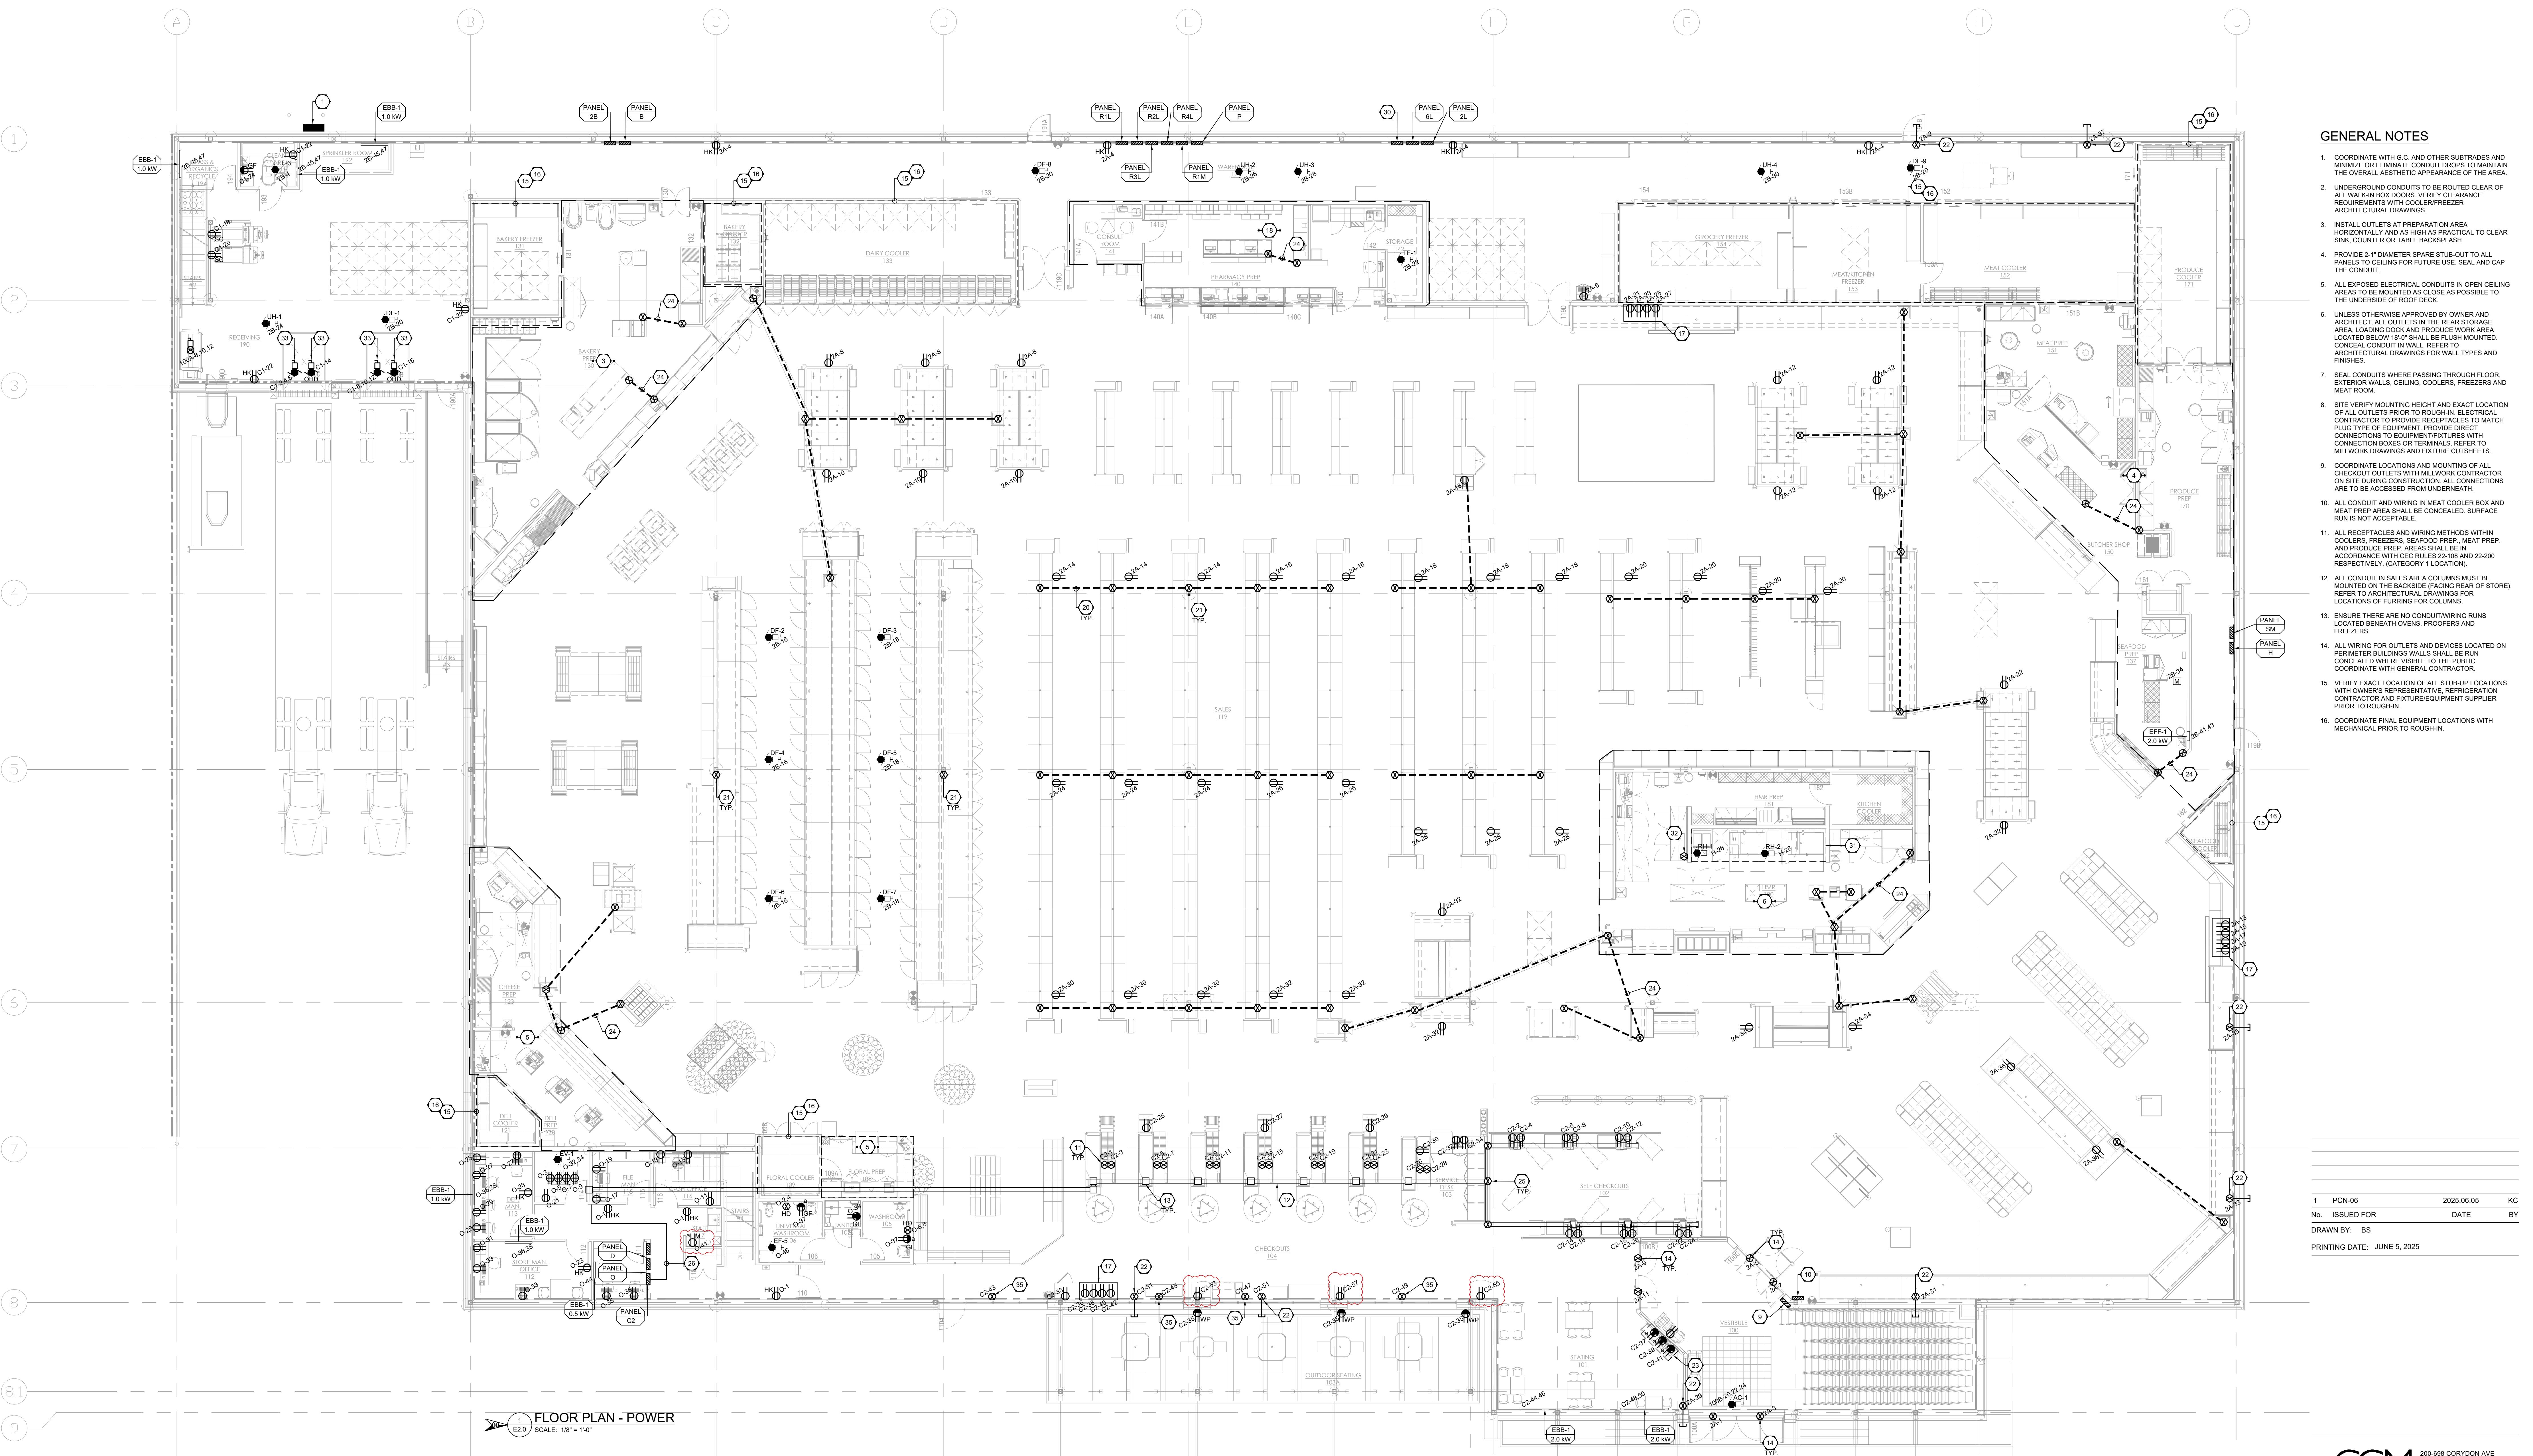 E2.0 SCALE: 1/8" = 1'-0"



The image shows an architectural floor plan for a 'LUNCH ROOM - POW'. The plan includes a circular table with four chairs labeled 'E2.0'. A north arrow points upwards. A scale bar indicates 'SCALE: 1/8" = 1'-0".

DRAWING NOTES - PC

- ER
INATE LOCATION AND SASKPOWER ON SITE.
ARD.
ED DELI POWER DRAWINGS.
ED BAKERY AND PHARMACY
GED SEAFOOD, MEATS AND
GED HMR POWER DRAWINGS.
A DEDICATED CIRCUIT, LABELED 'FIRE ALARM'
MULTI-LINE DIGITAL DISPLAY MOUNTED.

10 SECURITY GATE CONTROLLER PANEL. PROVIDE POWER INCLUDING NECESSARY CONTROL WIRES BETWEEN ASSOCIATED COMPONENTS. COORDINATE WITH SECURITY GATE SUPPLIER.

11 FOR EACH CHECKOUT STATION, PROVIDE ONE DEDICATED CIRCUIT TO THE UPS AND ONE DEDICATED CIRCUIT FOR THE CONVEYOR BELT, COURTESY RECEPTACLE AND MISCELLANEOUS RECEPTACLE.

12 PROVIDE AN UNDERFLOOR WALKERDUCT SYSTEM COMPLETE WITH ALL NECESSARY DUCTS, FITTINGS, SUPPORTS, BOXES AND OTHER REQUIRED ACCESSORIES IN COMPLIANCE WITH PROJECT SPECIFICATIONS AND MANUFACTURER'S RECOMMENDATIONS. ALIGN FLOOR DUCTS AND LOCATE AFTERSETS INCLUDING ALL ASSOCIATED FITTING/ACCESSORIES IN ACCESSIBLE AREA WITHIN THE DESIGNATED PRIMARY STUBBING AREA OF THE CHECKSTAND. COORDINATE WITH MILLWORK CONTRACTOR, CHECKOUT COUNTER SUPPLIER, ARCHITECTURAL AND STRUCTURAL PRIOR TO ROUGH-IN.

13 PROVIDE UNDER FLOOR WALKERDUCT AFTERSETS OF SPECIFIED SIZE (2-#2 AND 1-#4) TO FACILITATE POWER AND COMMUNICATION FEED TO CUSTOMER CHECK STANDS, SELF CHECK-OUT AND SERVICE DESK COMPLETE WITH REQUIRED JUNCTION BOXES, CONDUITS AND FITTINGS.

14 PROVIDE CONDUIT, WIRING AND CONNECTIONS FROM JUNCTION BOX FOR AUTOMATIC DOORS UP TO RESPECTIVE PANEL. COORDINATE WITH DOOR HARDWARE SUPPLIER AND ARCHITECTURAL.

15 PROVIDE PATHWAYS, CIRCUIT WIRING AND CONNECTIONS TO ACCESS CONTROL SYSTEM. E.C. IS RESPONSIBLE FOR ALL LOW VOLTAGE WIRING BETWEEN SYSTEM DEVICES AND REQUIRED CONNECTIONS TO THE DOOR HARDWARE FOR A COMPLETE AND OPERATION SYSTEM. COORDINATE WITH DOOR HARDWARE SUPPLIER AND SECURITY CONTRACTOR PRIOR TO ROUGH-IN.

16 AREA TO BE CONSIDERED A CATEGORY 1 LOCATION AS PER C.E.C. SECTION 22-002. PROVIDE WIRING METHODS, FIXTURES AND DEVICES TO SUIT.

17 BILLBOARD RECEPTACLES TO BE RECESSED INTO WALL STRUCTURE BY MINIMUM 50mm. COORDINATE WITH DECOR AND ARCHITECTURE DRAWINGS FOR FINAL MOUNTING HEIGHT AND LOCATIONS.

18 DATA RACK. CONFIRM EXACT REQUIREMENTS WITH SOBEYS I.T. DEPARTMENT.

19 SITE LIGHTING PANEL PROVIDED AND INSTALLED BY OTHERS. COORDINATE EXACT REQUIREMENTS WITH GC ON SITE.

20 PROVIDE 1" DIAMETER CONDUIT FROM STRUCTURAL COLUMN TO INDICATED GONDOLA. PRIOR TO CONCRETE POURING, EXAMINE SITE AND CONFIRM ROUTING OF CONDUIT WITH GC AND ALL ASSOCIATED TRADES.

21 INSTALL JUNCTION BOX EITHER UNDER THE SHELVES (SPACE PERMITTING) OR AT THE INTERNAL LOWER MOST PART OF SHELVING. POWER TO RUN DOWN STRUCTURAL COLUMN AS NEEDED. TYPICAL.

22 PROVIDE DEDICATED 15A CIRCUIT FOR EXTERIOR SIGNS. COORDINATE WITH ARCHITECT AND SIGN PROVIDER TO DETERMINE EXACT LOCATION AND ELECTRICAL REQUIREMENTS FOR SIGNS.

23 CONFIRM MOUNTING HEIGHT OF RECEPTACLES IN DASHED AREA. COORDINATE WITH GENERAL CONTRACTOR AND ISLAND SUPPLIER.

24 PROVIDE 1" DIAMETER CONDUIT AS INDICATED. PRIOR TO CONCRETE POURING, EXAMINE SITE AND CONFIRM ROUTING OF CONDUIT WITH GC AND ALL ASSOCIATED TRADES.

25 PROVIDE UNDER FLOOR JUNCTION BOX COMPLETE WITH CONDUIT HUB FOR POWER, VOICE/DATA AND SECURITY SYSTEM CABLE DISTRIBUTION TO SELF CHECKOUTS, SELF CHECKOUTS AND SERVICE DESK. UNDER FLOOR JUNCTION BOXES TO BE C/W NECESSARY DUCTS, CONDUITS, FITTINGS AND PANEL CONNECTORS TO CONNECT THE FLOOR DUCT SYSTEM TO CORRESPONDING ELECTRICAL PANELS.

26 RUN POWER AS NOTED FOR CHECKOUTS IN CONDUIT AND IN CEILING. POWER TO DROP DOWN 'IT ROOM 112' WALL AND INTO WALK DUCT AS REQUIRED.

27 LEAK DETECTOR PANEL. COORDINATE EXACT REQUIREMENTS WITH MICRO THERMO ON SITE.

28 EMS SYSTEM PC CABINET. COORDINATE EXACT REQUIREMENTS WITH MICRO THERMO ON SITE.

29 EMS SYSTEM PANEL. COORDINATE EXACT REQUIREMENTS WITH MICRO THERMO ON SITE.

30 EMS SYSTEM LIGHTING CONTROL PANEL. REFER TO DRAWING E7.0 FOR DETAILS.

31 WIRE AND CONNECT FIRE SUPPRESSION SYSTEM FOR COOKING LINE HOOD. INTERCONNECT WITH FIRE ALARM SYSTEM TO ACTIVATE A FIRE CONDITION UPON ACTIVATION OF FIRE SUPPRESSION SYSTEM. ALL ELECTRICAL BELOW HOOD TO DE-ENERGIZE UPON FIRE SUPPRESSION DISCHARGE.

32 PROVIDE RED SHUT OFF BUTTON AND LAMACOID LABEL AS PER C.E.C. 26-750 TO DE-ENERGIZE EXHAUST FANS ASSOCIATED WITH HOOD. CONFIRM EXACT LOCATION ON SITE. REFER TO MANUFACTURER'S LITERATURE.

33 PROVIDE JUNCTION BOX, CONDUIT, WIRING AND CONNECTION (FOR COMPACTOR, DOCK LEVELLER, AND OVERHEAD DOOR) TO RESPECTIVE PANEL TO SUIT TENANT FIT-UP REQUIREMENTS.

34 COMPRESSOR RACK. WIRE AND CONNECT AS REQUIRED.

35 WIRE AND CONNECT ROLLER WINDOW SHADES C/W MANUAL CONTROL SWITCH AS REQUIRED. REFER TO SOBEYS' MASTER SPECIFICATION FOR DETAILS.

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PCBA GROCERY

RORA GROCERY

ORE

10 ANAQUOD ROAD

U ANAQUOD ROAD
NA, SASKATCHEWAN

NA, SASKATCHEWAN

TITLE:

DOOR PLAN - INTERIOR

WER



SECTION NUMBER _____ SHEET NUMBER _____

SESSION NUMBER: SHEET NUMBER:
5 E20

E2.0

GENERAL NOTES

- GENERAL CONTRACTOR SHALL ENSURE THAT ALL WORK REQUIRED FOR THE COMMUNICATION AND SECURITY SYSTEMS IS IN PLACE AND OPERATIONAL PRIOR TO STORE OPENING. ELECTRICAL CONTRACTOR IS RESPONSIBLE FOR THE IMPLEMETATION OF THE COMMUNICATIONS SYSTEM FOR THE COMMUNICATION AND SECURITY SYSTEMS SUPPLY AND INSTALLATION. CONTRACTOR SHALL PROVIDE THEIR PREFERRED DATA CABLEING PROVIDER.
- CONVERGENT - 625-1 ST. SE SUITE 240, CALGARY, ALBERTA T2C 2Z2. CONTACT: SHAWN SMITH (403) 866-5030.
- ALL EXPOSED ELECTRICAL CONDUIT IN OPEN CEILING AREAS SHALL BE FLUSH MOUNTED AND SECURED TO THE UNDERSIDE OF ROOF DECK.
- ALL OUTLETS IN WORK AREA BELOW 18'-0" SHALL BE FLUSH MOUNTED CONCEAL CONDUIT IN WALL.
- SECURE CONDUIT AND CONDUIT HANGERS THROUGH CEILINGS, COOLERS, FREEZERS AND MEAT ROOM.
- SUPPLY AND INSTALL CONDUIT AND OUTLET/JUNCTION BOXES FOR ALL DATA, VOICE, SECURITY AND FIRE ALARM COVER PLATES FOR ALL PULL BOXES AND JUNCTION BOXES. COLOUR CODE TO SUIT. INSTALL AFTER SYSTEM INSTALLED.
- CONDUIT FOR VOICE/DATA AND SOUND SYSTEMS SHALL BE NYLON PULL STRING.
- ALL JUNCTION BOXES SHALL BE 6" SQUARE X 2" DEEP UNLESS OTHERWISE SPECIFIED.
- CLEARLY MARK ALL CONDUIT WITH CORRESPONDING TERMINATION POINT.
- COORDINATE LOCATION AND MOUNTING HEIGHTS OF OUTLETS WITH G.C. PRIOR TO DRAWING.
- ALL CONDUIT INSTALLED ON ROOF DECK MUST BE SECURED ON THE BACK SIDE FACING THE REAR OF STORE. REFER TO ARCHITECTURAL DRAWINGS FOR LOCATION.
- FIRE STOPPING OF ELECTRICAL CONDUITS PASSING THROUGH RATED ASSEMBLIES SHALL BE BY THE ELECTRICAL CONTRACTOR. REFER TO ARCHITECTURAL SPECIFICATIONS FOR DETAILED FIRESTOPPING REQUIREMENTS.

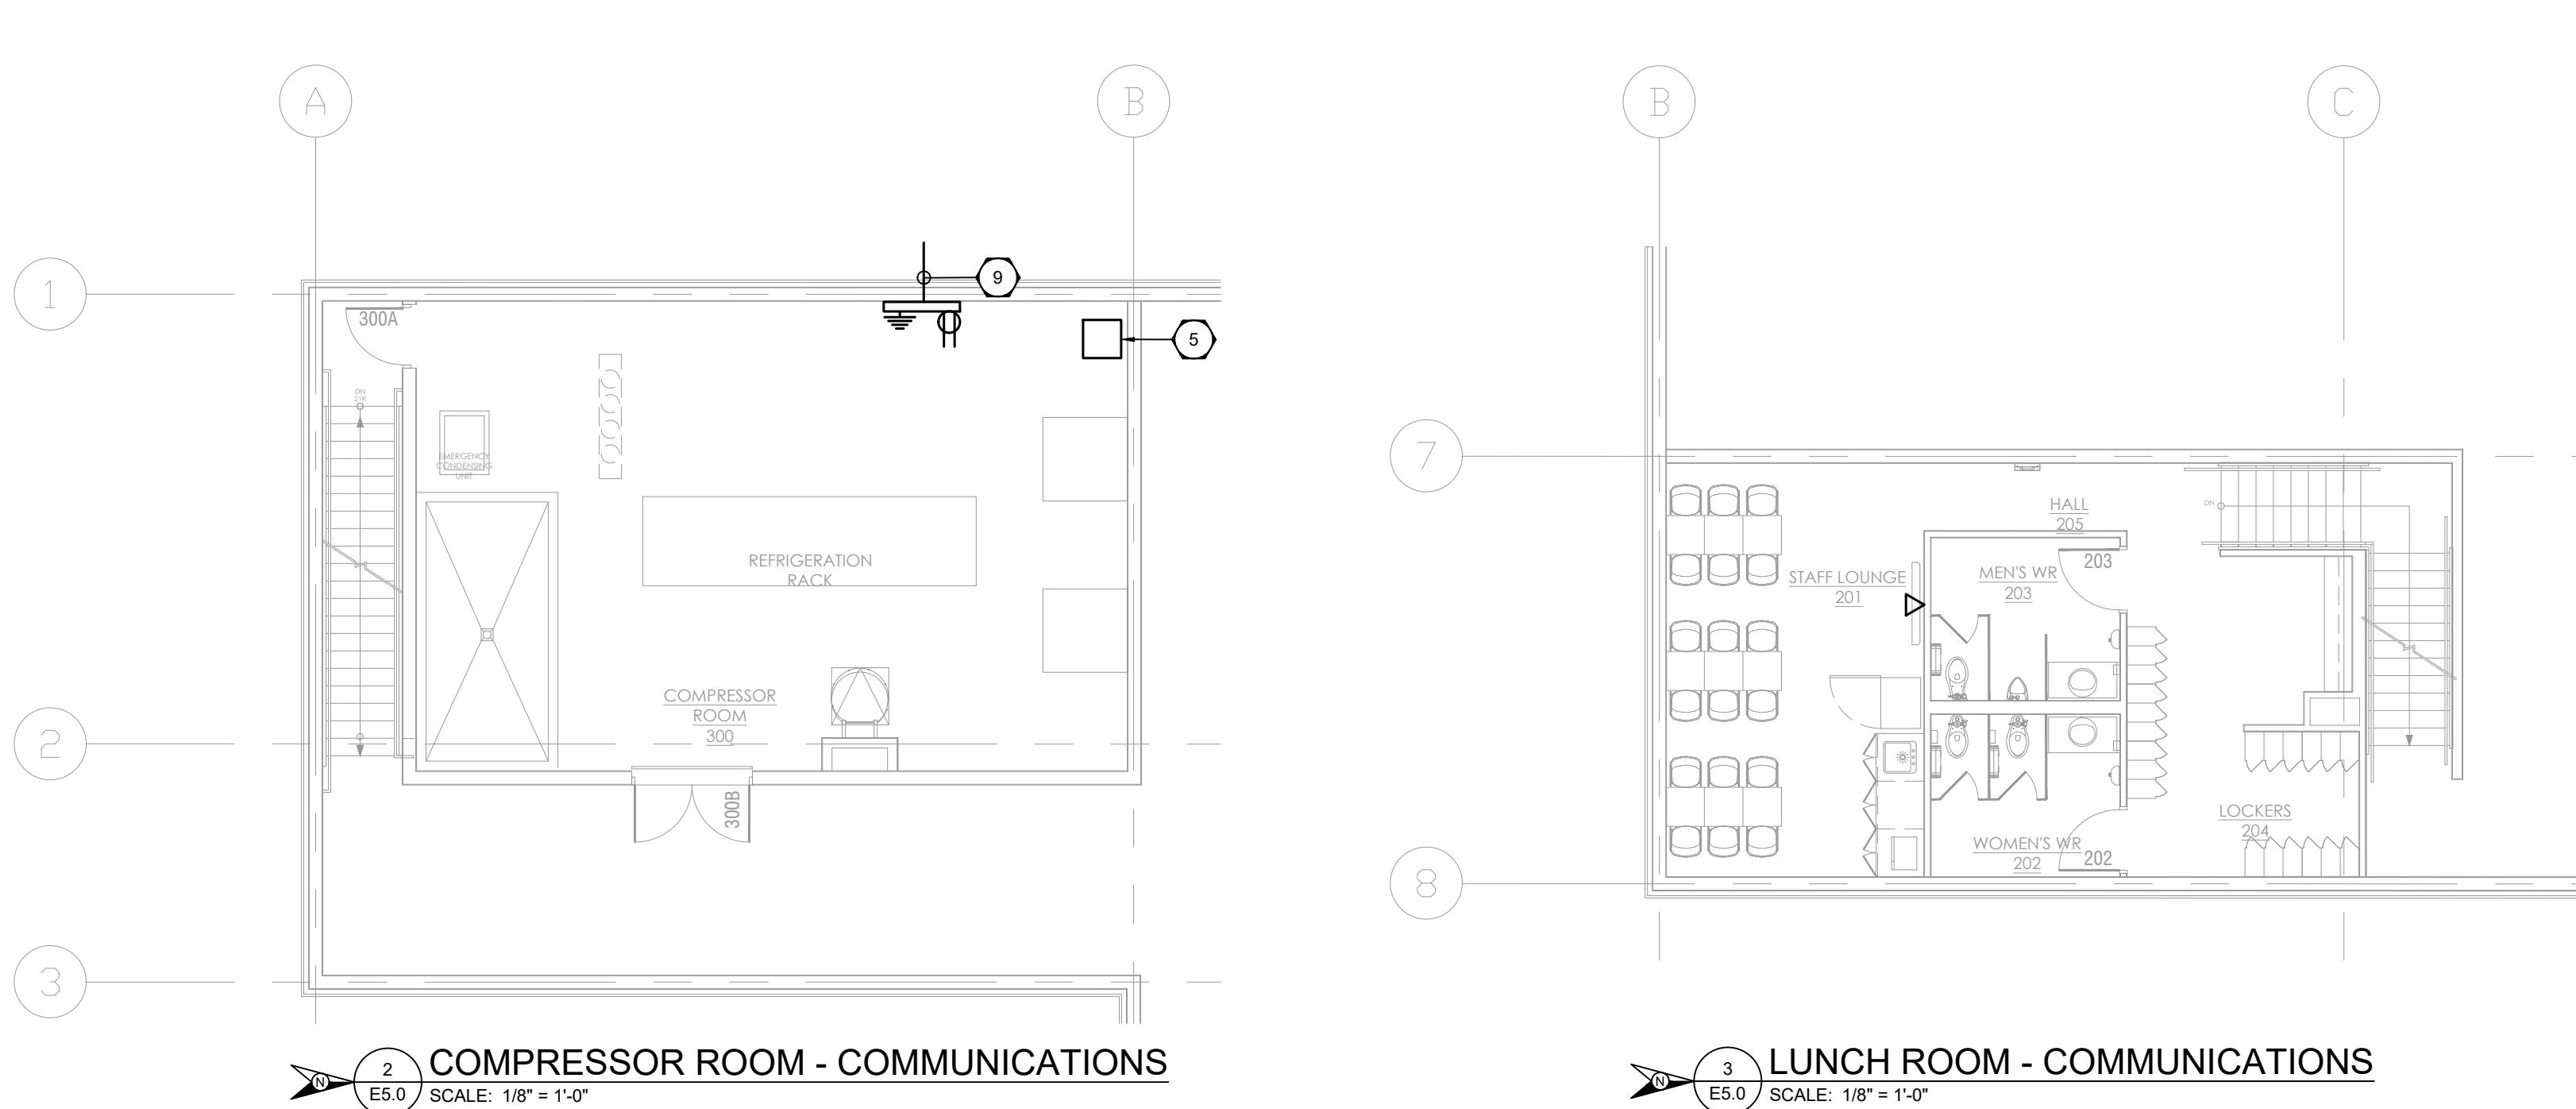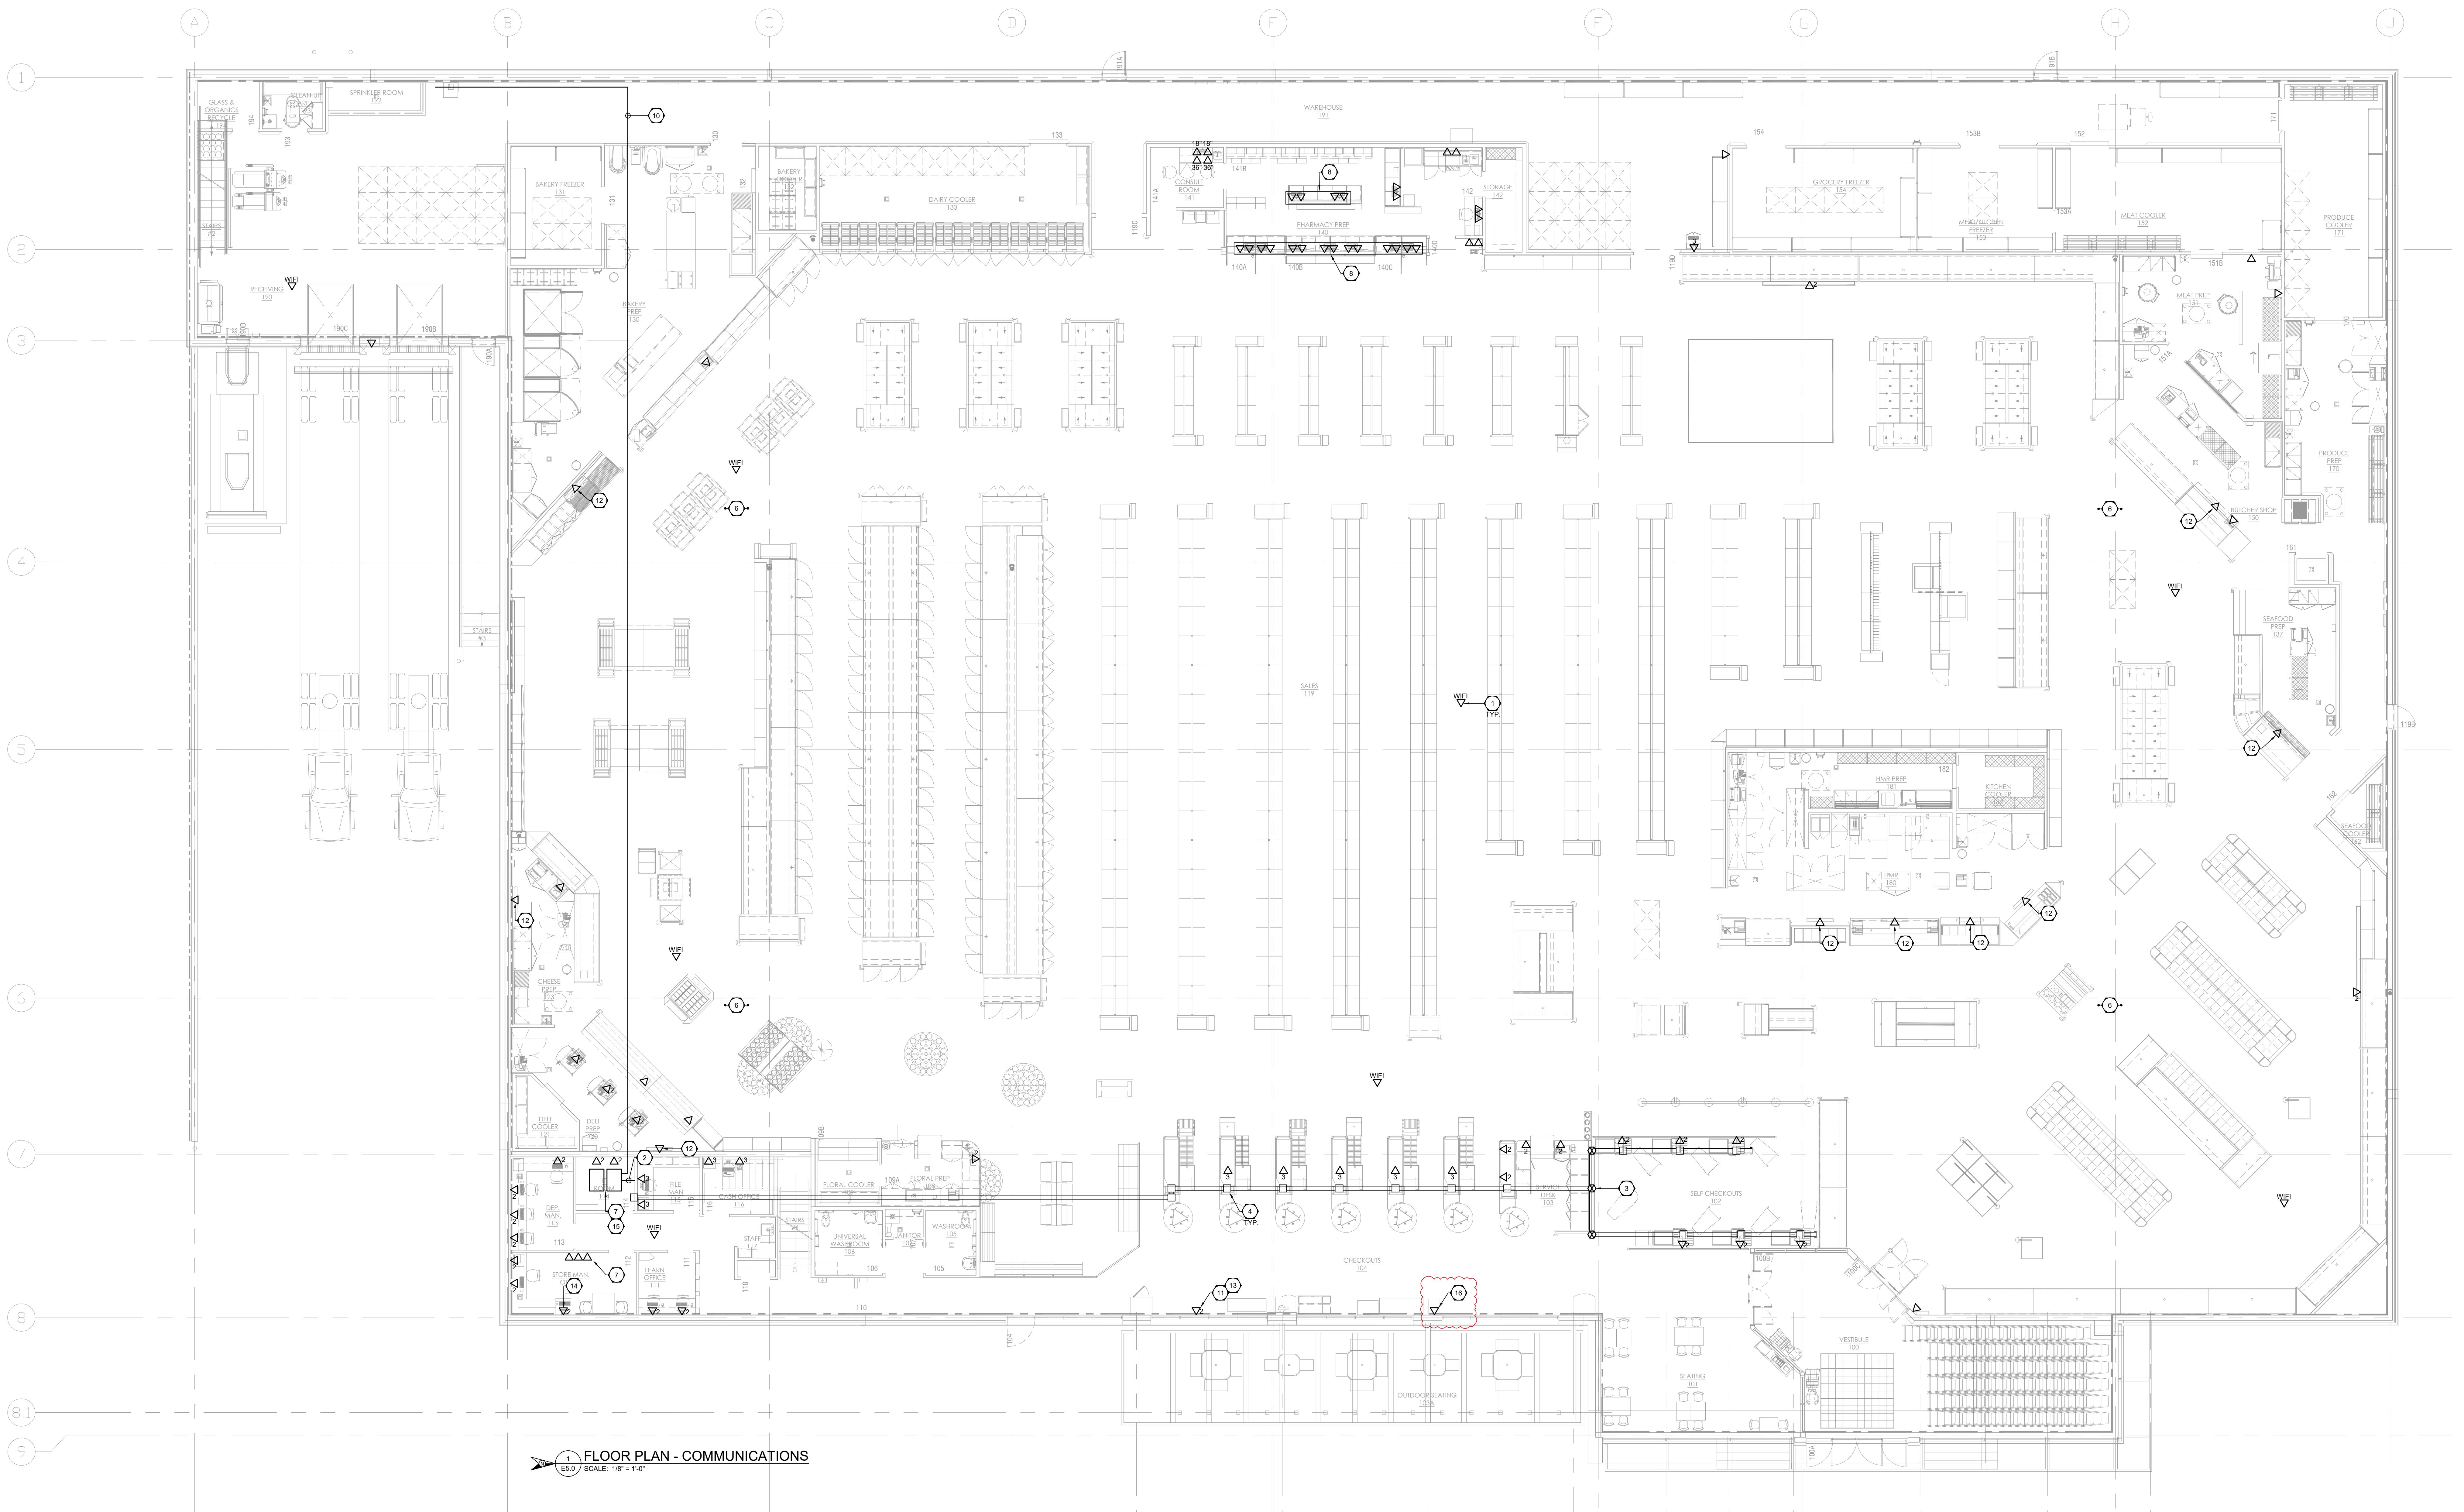

DRAWING NOTES - COMMUNICATIONS

- CONFIRM LOCATION WITH SOBEYS I.T. DEPARTMENT WIRELESS SUPPLIER FOR LOCATIONS OF ADDITIONAL DATA POINTS.
- CONFIRM DATA POINT SPACING.
- DATA WIRING FOR CHECKOUTS TO RUN IN CEILING AND INTO IT PODS. CONFIRM LENGTH OF CABLE TO RUN DOWN WALL AND INTO WALK DUCT AS REQUIRED.
- MOUNT DATA OUTLETS ON MILLWORK SURFACE AT 24" A.F.F. COORDINATE WITH SOBEYS PROJECT MANAGER.
- PROVIDE ONE 1/2" RIGID PVC CONDUIT C/W PULL STRING FOR DATA CONDUIT. PROVIDE ONE CONDUIT FOR SERVICE CABLE PEDESTAL TO TELEPHONE BACKBOARD IN SERVICE MEZZANINE. PROVIDE ONE CONDUIT FOR BILLBOARD BACKBOARD IN BILLBOARD LOCATION AND ROUTING PATH OF COMMUNICATIONS CONDUIT. COORDINATE WITH SOBEYS REPRESENTATIVE AND ISP/VIENDO.
- PROVIDE A DEDICATED 4" EMT CONDUIT C/W PULL STRING OR A HOSE DRAPE FOR BILLBOARD BACKBOARD. PROVIDE ONE 1/2" EMT HARDWIRE FROM TELEPHONE BACKBOARD IN SERVICE MEZZANINE TO SERVER RACK I.N.T. ROOM.
- PROVIDE ONE CAT6 SHIELDED CABLE TO BILLBOARD BACKBOARD. PROVIDE ONE CAT6 SHIELDED CABLE TO BILLBOARD BACKBOARD. COORDINATE WITH BILLBOARD SUPPLIER FOR LOCATION OF RJ45 PORT ON DIGITAL BILLBOARD.
- SUPPLY AND INSTALL CAT6 SHIELDED CABLE TO BILLBOARD BACKBOARD. PROVIDE ONE CAT6 SHIELDED CABLE TO BILLBOARD BACKBOARD. COORDINATE WITH BILLBOARD SUPPLIER FOR LENGTH OF CABLE REQUIRED FOR CONNECTION TO BILLBOARD FROM THE WALL.
- PROVIDE TWO RJ45 PORTS IN DATA OUTLET. PROVIDE AND INSTALL ONE RJ45 PORT IN BILLBOARD BACKBOARD. COORDINATE WITH BILLBOARD SUPPLIER FOR LENGTH OF CABLE REQUIRED FOR CONNECTION TO BILLBOARD.
- PROVIDE ONE RJ45 PORT IN BILLBOARD BACKBOARD. COORDINATE WITH BILLBOARD SUPPLIER FOR LENGTH OF CABLE REQUIRED FOR CONNECTION TO BILLBOARD BACKBOARD. COORDINATE WITH MICRO THERMO REPRESENTATIVE.
- PROVIDE AND INSTALL ONE CAT6 SHIELDED CABLE TO BILLBOARD BACKBOARD. COORDINATE WITH BILLBOARD SUPPLIER FOR LENGTH OF CABLE REQUIRED FOR CONNECTION TO BILLBOARD BACKBOARD. TERMINATE CABLE IN PATCH PANEL AND LABEL ACCORDINGLY. COORDINATE WITH MICRO THERMO REPRESENTATIVE.
- PROVIDE AND INSTALL ONE 1/2" EMT CONDUIT C/W PULL STRING FROM SERVER RACK IN IT ROOM FOR ATM MACHINE DATA.
- PROVIDE ONE CAT6 SHIELDED CABLE TO BILLBOARD BACKBOARD. COORDINATE WITH BILLBOARD SUPPLIER FOR LOCATION OF RJ45 PORT ON DIGITAL BILLBOARD.
- PROVIDE ONE CAT6 SHIELDED CABLE TO BILLBOARD BACKBOARD. COORDINATE WITH BILLBOARD SUPPLIER FOR LOCATION OF RJ45 PORT ON DIGITAL BILLBOARD.
- PROVIDE ONE CAT6 SHIELDED CABLE TO BILLBOARD BACKBOARD. COORDINATE WITH BILLBOARD SUPPLIER FOR LOCATION OF RJ45 PORT ON DIGITAL BILLBOARD.
- COORDINATE WITH DATA CONTRACTOR FOR CONFIRMED LOCATION OF REMOTE DATA CABINET. PROVIDE 2" DIAMETER CONDUIT FROM DATA CABINET LOCATION I.T. ROOM.

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SHEET TITLE:
**FLOOR PLAN -
COMMUNICATIONS**
COMMISSION NUMBER:
2445
SHEET NUMBER:
E5.0