

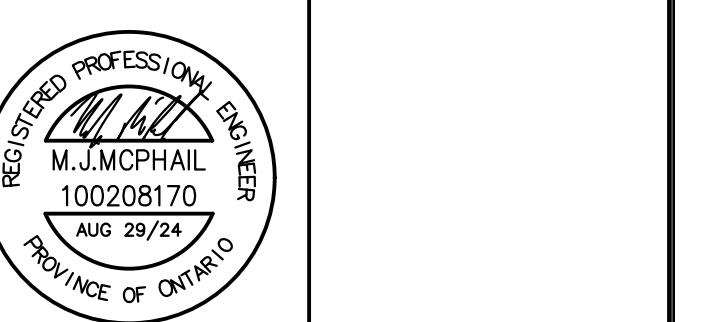
NOTES:

- ① 4 PARALLEL RUNS OF 4 X 1C #500 MCM CU + #3 AWG CU BOND IN RACEWAY
- ② 4 X 1C #250 MCM CU + #4 AWG CU BOND IN RACEWAY
- ③ 4 X 1C # 500 AWG CU + #4 AWG CU BOND IN RACEWAY
- ④ 3C #3 AWG CU + #8 AWG CU BOND IN RACEWAY.
- ⑤ 3C #10 AWG CU + #12 AWG CU BOND IN RACEWAY
- ⑥ 4C #10 AWG CU + #12 AWG CU BOND IN RACEWAY
- ⑦ 4 PARALLEL RUNS OF 4 X 1C #350MCM AWG CU + #4 AWG CU BOND IN RACEWAY
- ⑧ CONTRACTOR TO COORDINATE SUITE PANEL METERING EXACT REQUIREMENTS WITH OWNER 3RD PARTY VENDOR.
- ⑨ CONTRACTOR TO PROVIDE ALL POWER AND COMMUNICATIONS WIRING AND CONDUIT FROM BUILDING TO GENERATOR INCLUDING MAIN POWER, SHORE POWER, COMMUNICATIONS AND FIRE ALARM CONNECTIONS.

0	ISSUED FOR TENDER	2024.08.29	MJM
NO.	DESCRIPTION	DATE	BY

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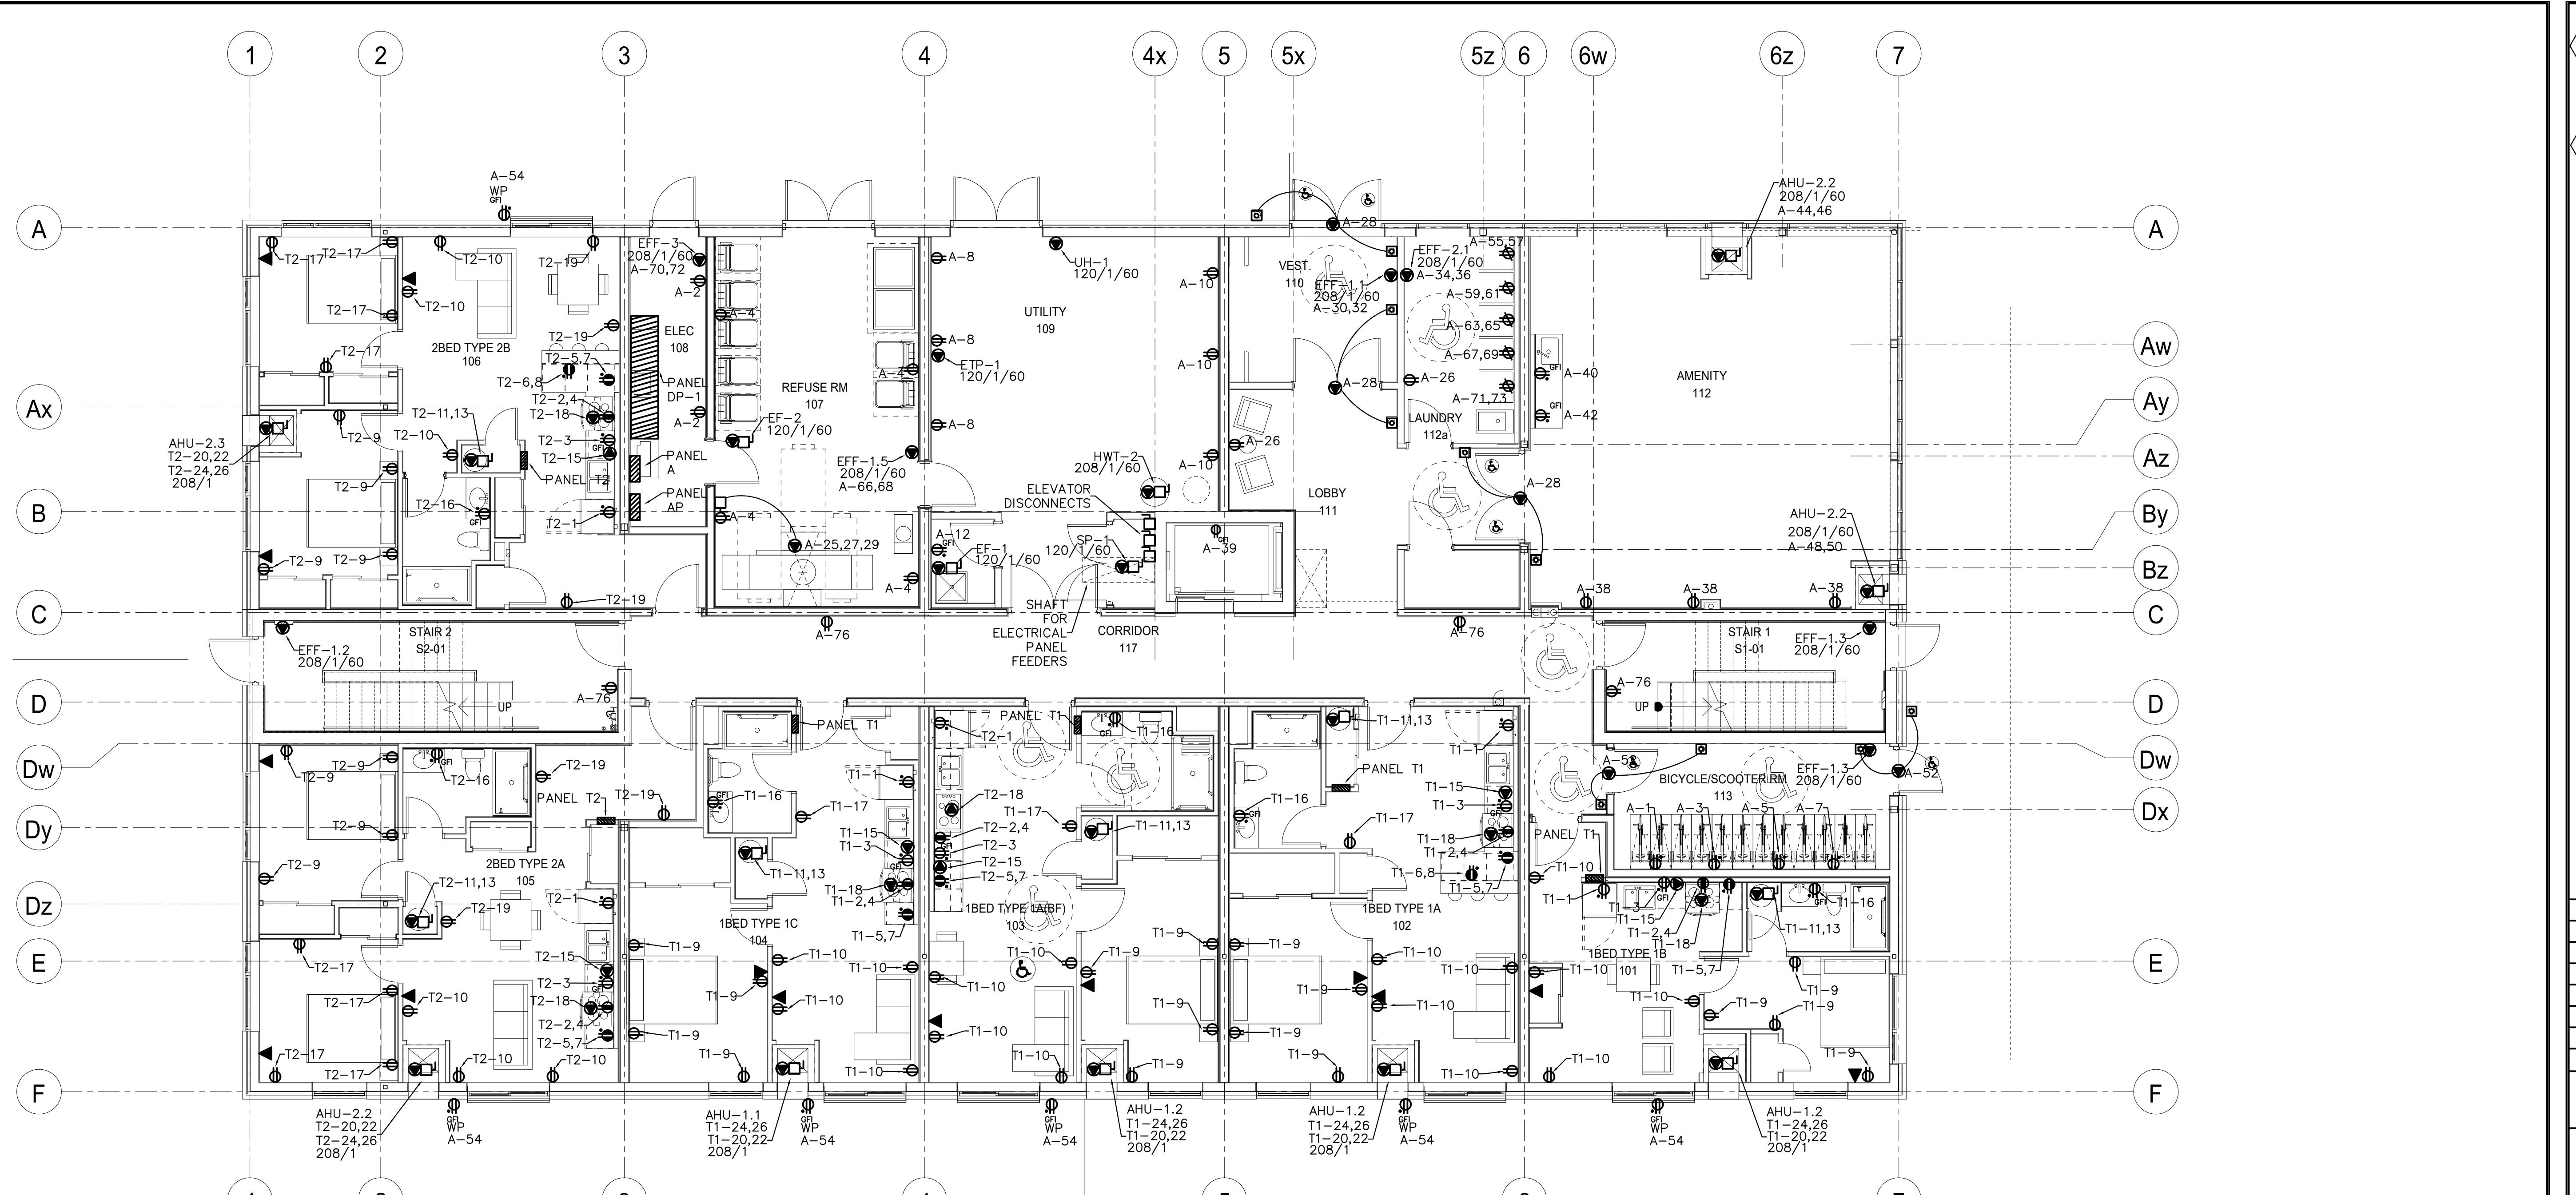
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PROJECT  
COURTICE SENIOR DEVELOPMENT

1697 HIGHWAY No 2  
CLARINGTON, ON

TITLE  
SLD

DESIGN	MJM	SCALE AS NOTED
DRAWN	AJM	DWG NO.
CHECKED	MJM	
APPROVED	MJM	
PROJECT	E1	7393



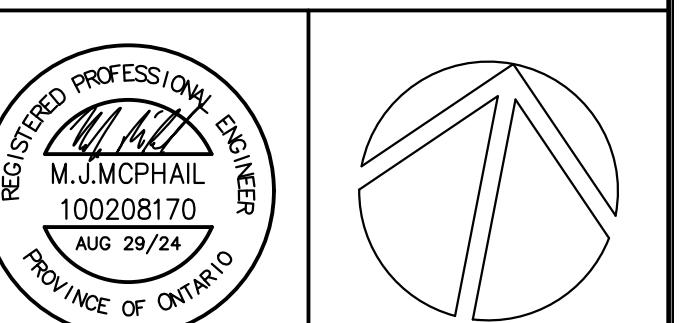
ELECTRICAL SYMBOLS LEGEND	
	DUPLEX RECEPTACLE
.	COUNTER MOUNT
	GFI DUPLEX RECEPTACLE
	STOVE RECEPTACLE
	SPLIT DUPLEX RECEPTACLE
●	DIRECT CONNECTION
□	DISCONNECT SWITCH
	DRYER RECEPTACLE
▼	DATA
	PANEL BOARD
WP	WEATHER PROOF

NOTES:

① ALL SUITE AHU UNITS REQUIRE TWO INDEPENDENT 208/1/60 CIRCUITS, ONE FOR THE HEAT PUMP AND ONE FOR THE SUPPLEMENTAL E4 ELECTRIC HEAT. REFER TO PANEL SCHEDULES FOR CIRCUIT AMPACITIES.

② PROVIDE A 12" X 12" BOX RECESSED IN ENTRANCE CLOSET WALL IN ALL SUITES FOR USE BY I.T./COMMS CONTRACTOR. RUN ALL CONDUITS FOR DATA/TV/PHONE TO CLOSET BOX AND PROVIDE 1" X 2" CONDUIT FROM BOX TO COMM CLOSET OR ACCESSIBLE CEILING SPACE. COORDINATE WITH COMMS CONTRACTOR ON SITE.

0	ISSUED FOR TENDER	2024.08.29	MJM
NO.	DESCRIPTION	DATE	BY
REVISIONS			
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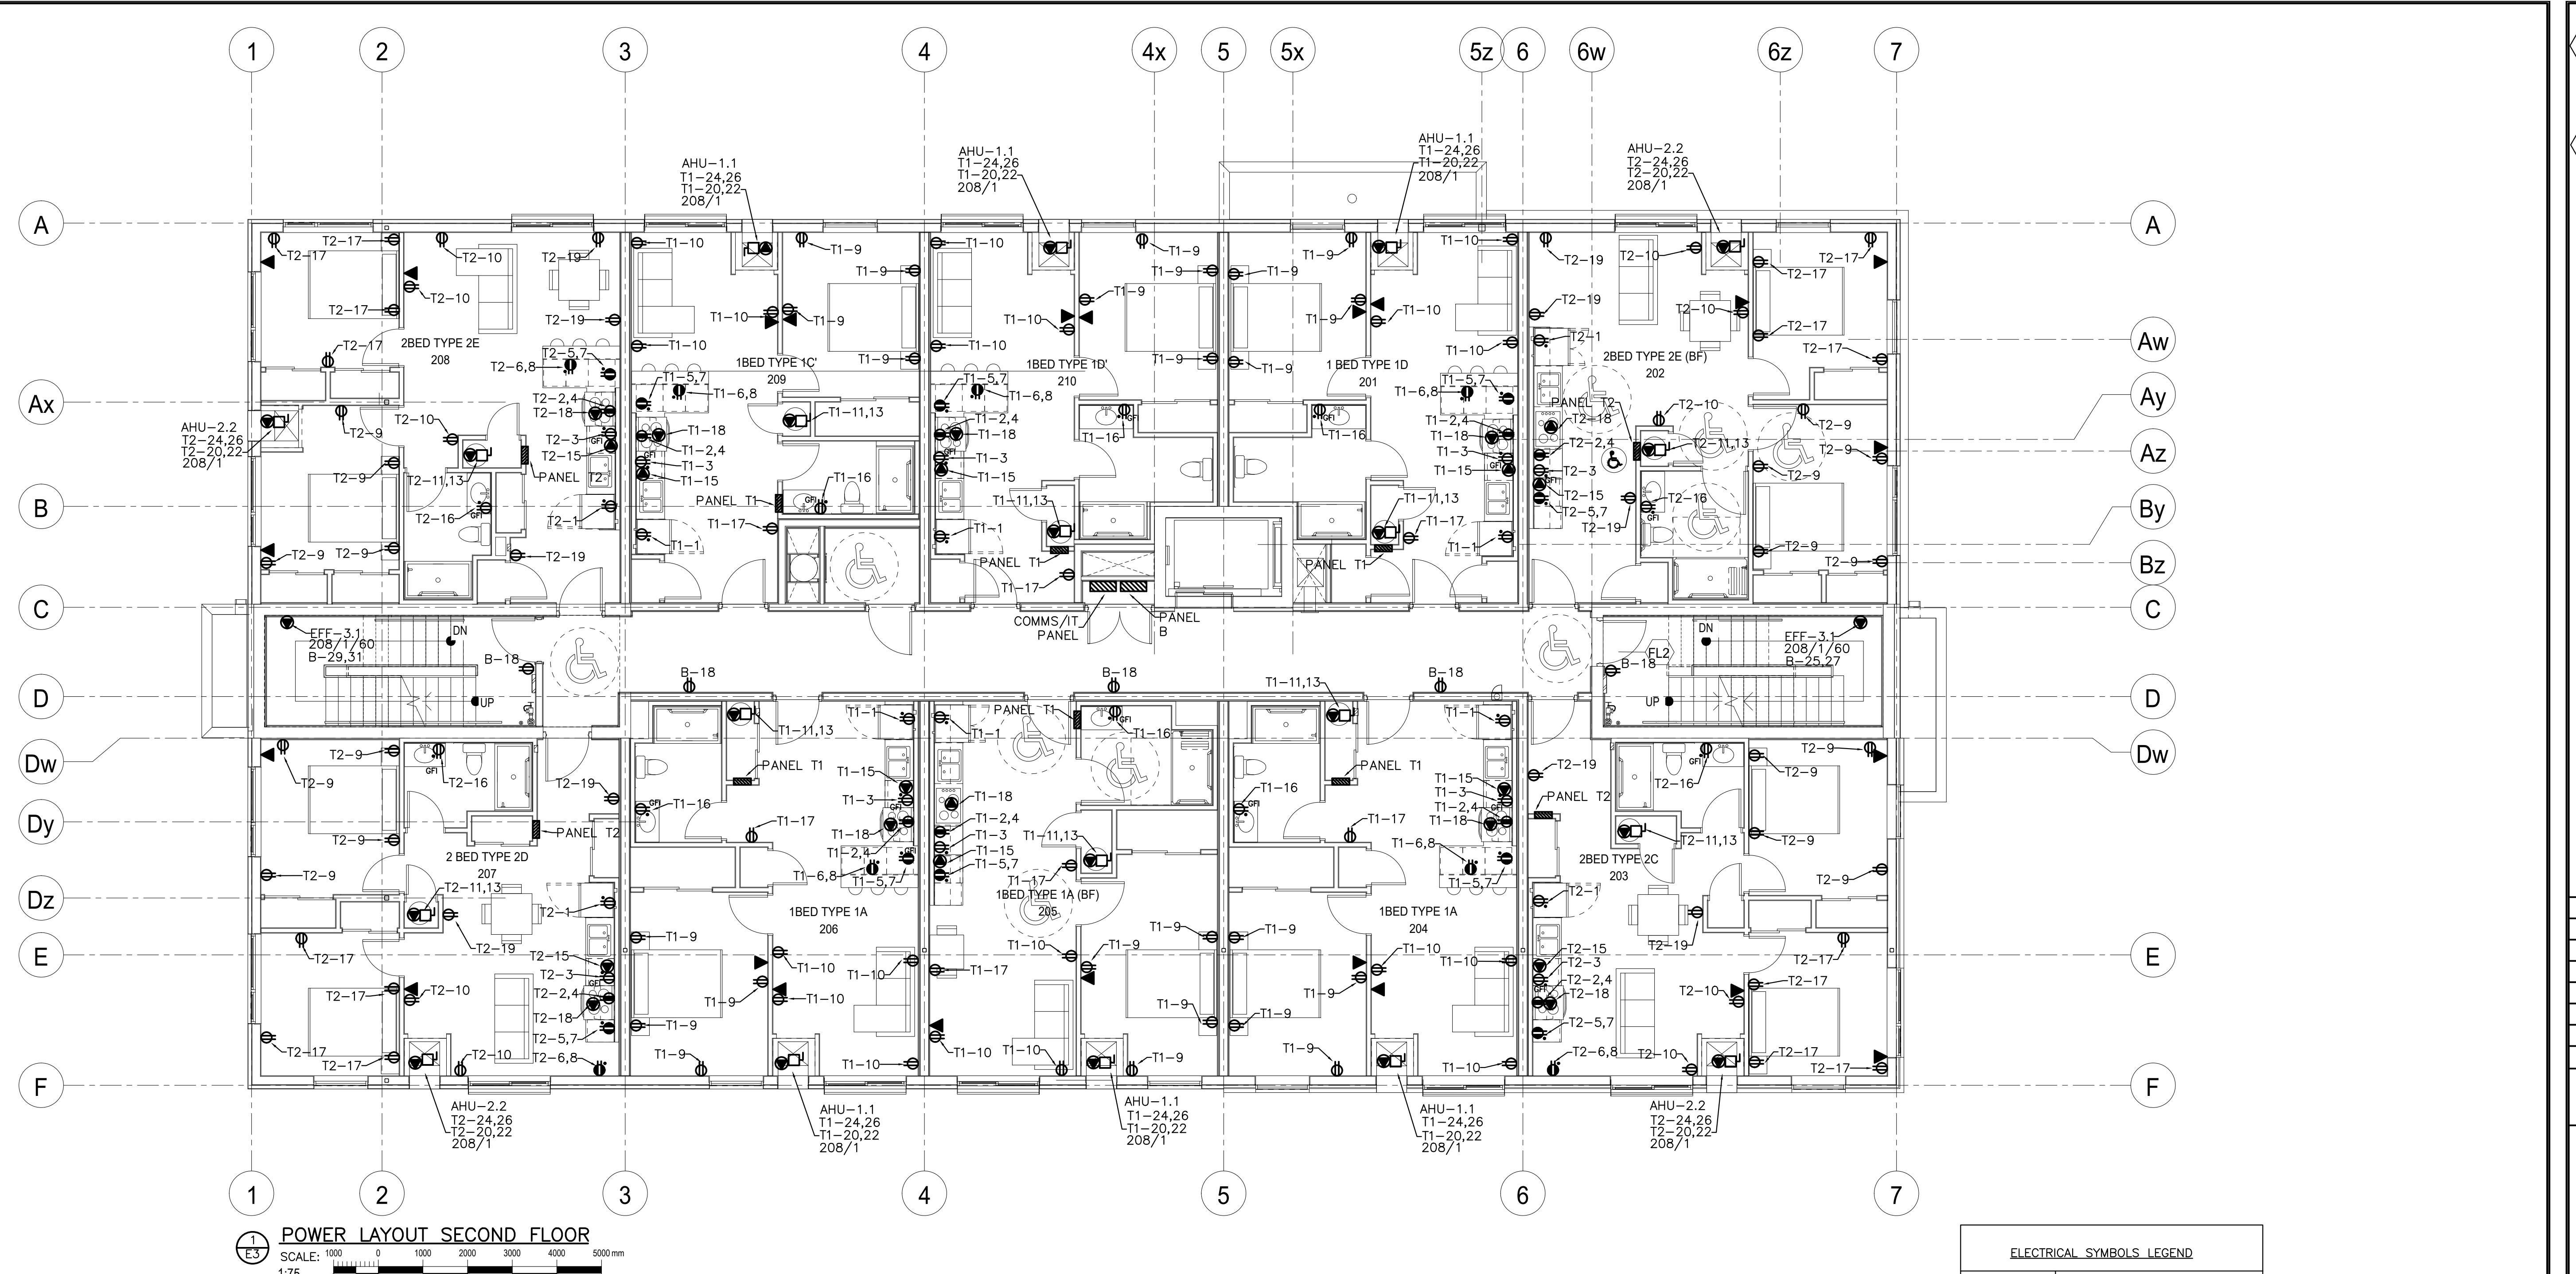
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PROJECT  
**COURTICE SENIOR DEVELOPMENT**

1697 HIGHWAY NO 2  
CLARINGTON, ON

DESIGN	MJM	SCALE AS NOTED
DRAWN	AJM	DWG NO.
CHECKED	MJM	
APPROVED	MJM	
PROJECT	E2	7393

E2

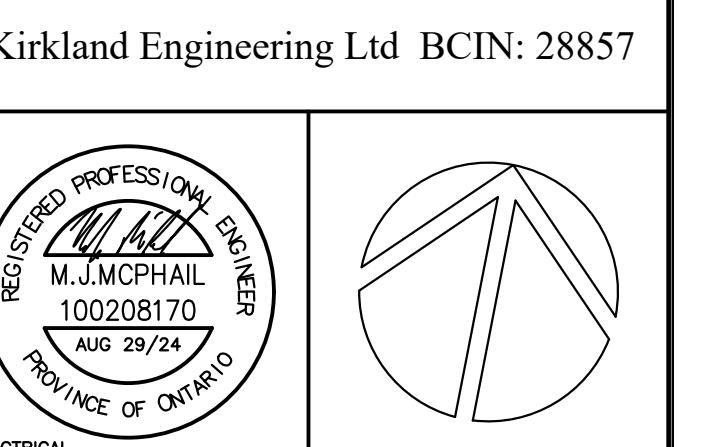
CADD FILE NO. 7393E2



ELECTRICAL SYMBOLS LEGEND	
	DUPLEX RECEPTACLE
.	COUNTER MOUNT
	GFI DUPLEX RECEPTACLE
	STOVE RECEPTACLE
	SPLIT DUPLEX RECEPTACLE
●	DIRECT CONNECTION
□	DISCONNECT SWITCH
	DRYER RECEPTACLE
▼	DATA
	PANEL BOARD
WP	WEATHER PROOF

- NOTES:**
- ① ALL SUITE AHU UNITS REQUIRE TWO INDEPENDENT 208/1/60 CIRCUITS, ONE FOR THE HEAT PUMP AND ONE FOR THE SUPPLEMENTAL E4 ELECTRIC HEAT. REFER TO PANEL SCHEDULES FOR CIRCUIT AMPACITIES.
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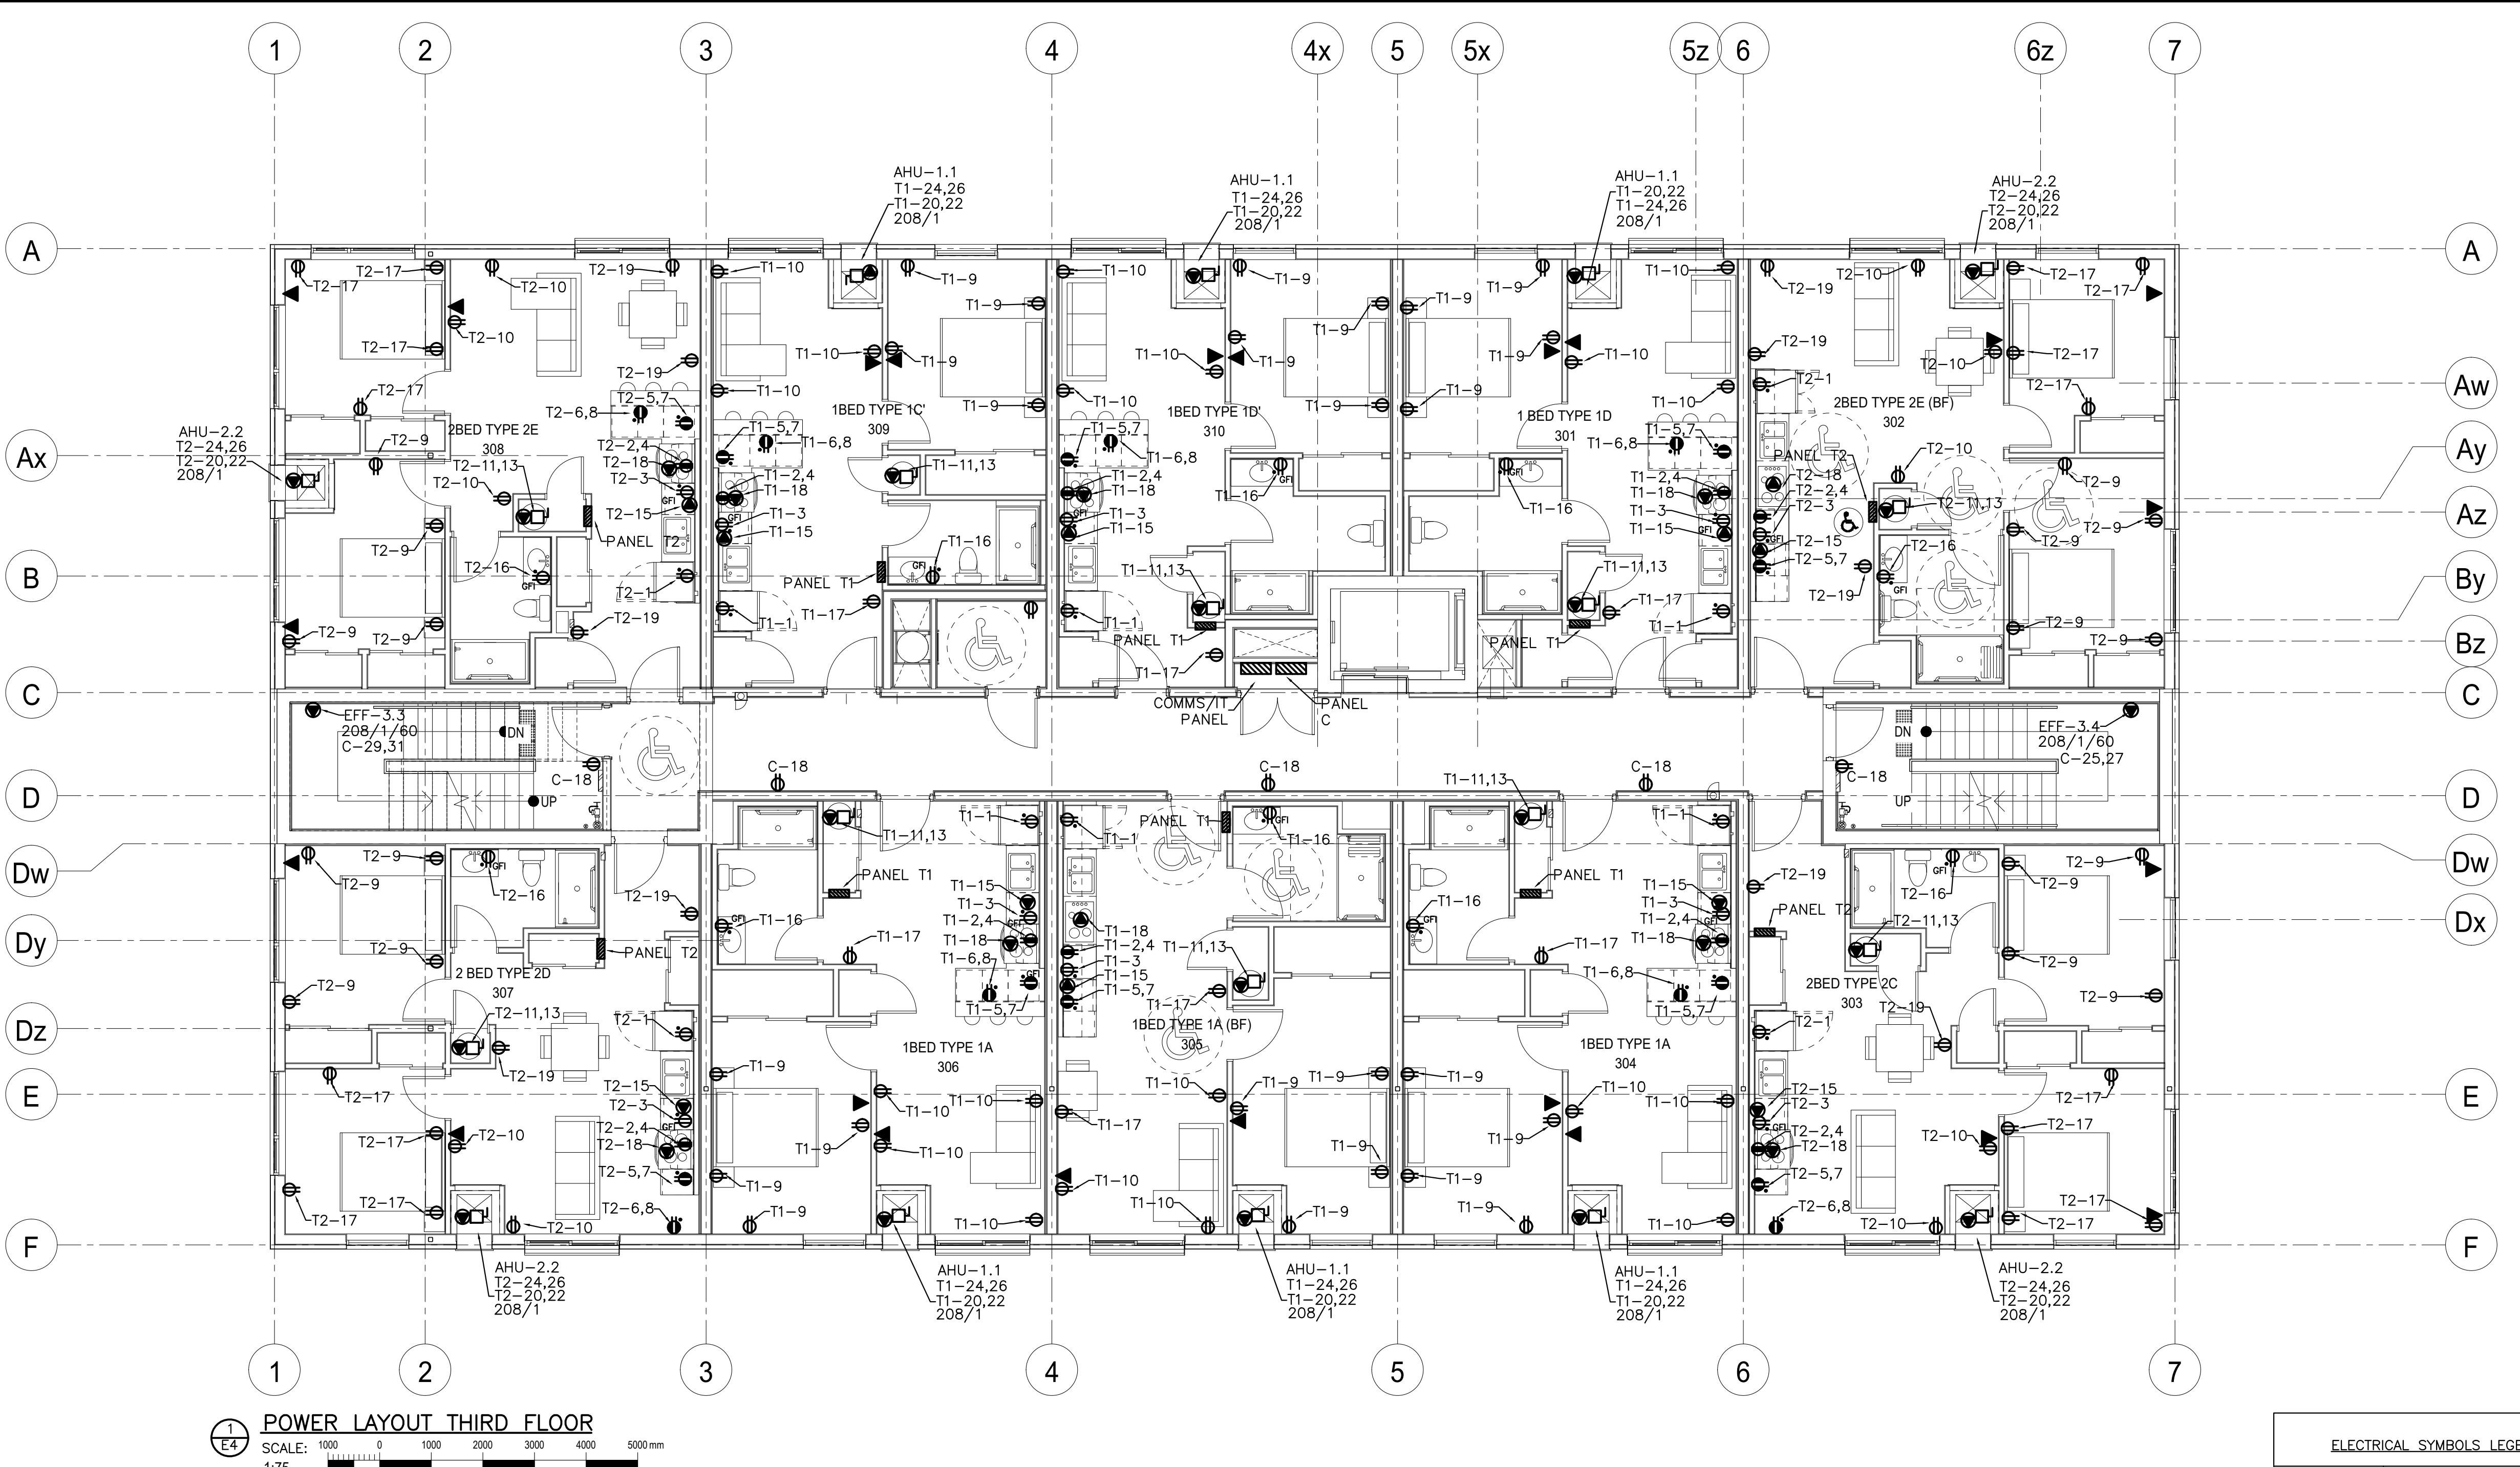
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PROJECT  
COURTICE SENIOR DEVELOPMENT

1697 HIGHWAY No 2  
CLARINGTON, ON

TITLE  
SECOND FLOOR POWER

DESIGN	MJM	SCALE AS NOTED
DRAWN	AJM	DWG NO.
CHECKED	MJM	
APPROVED	MJM	
PROJECT	E3	7393



POWER LAYOUT THIRD FLOOR  
SCALE: 1000 0 1000 2000 3000 4000 5000 mm  
1:75

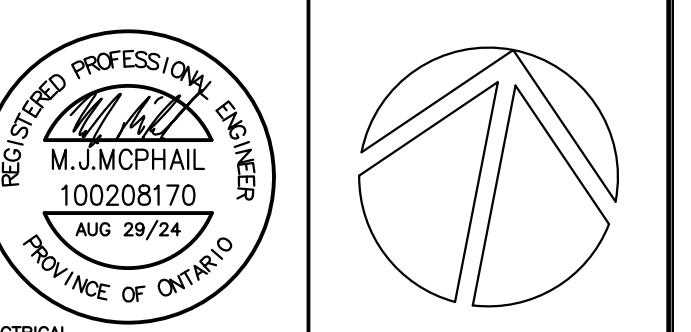
NOTES:

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ELECTRICAL SYMBOLS LEGEND	
	DUPLEX RECEPTACLE
	COUNTER MOUNT
	GFI DUPLEX RECEPTACLE
	STOVE RECEPTACLE
	SPLIT DUPLEX RECEPTACLE
	DIRECT CONNECTION
	DISCONNECT SWITCH
	DRYER RECEPTACLE
	DATA
	PANEL BOARD
WP	WEATHER PROOF

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DEVELOPMENT

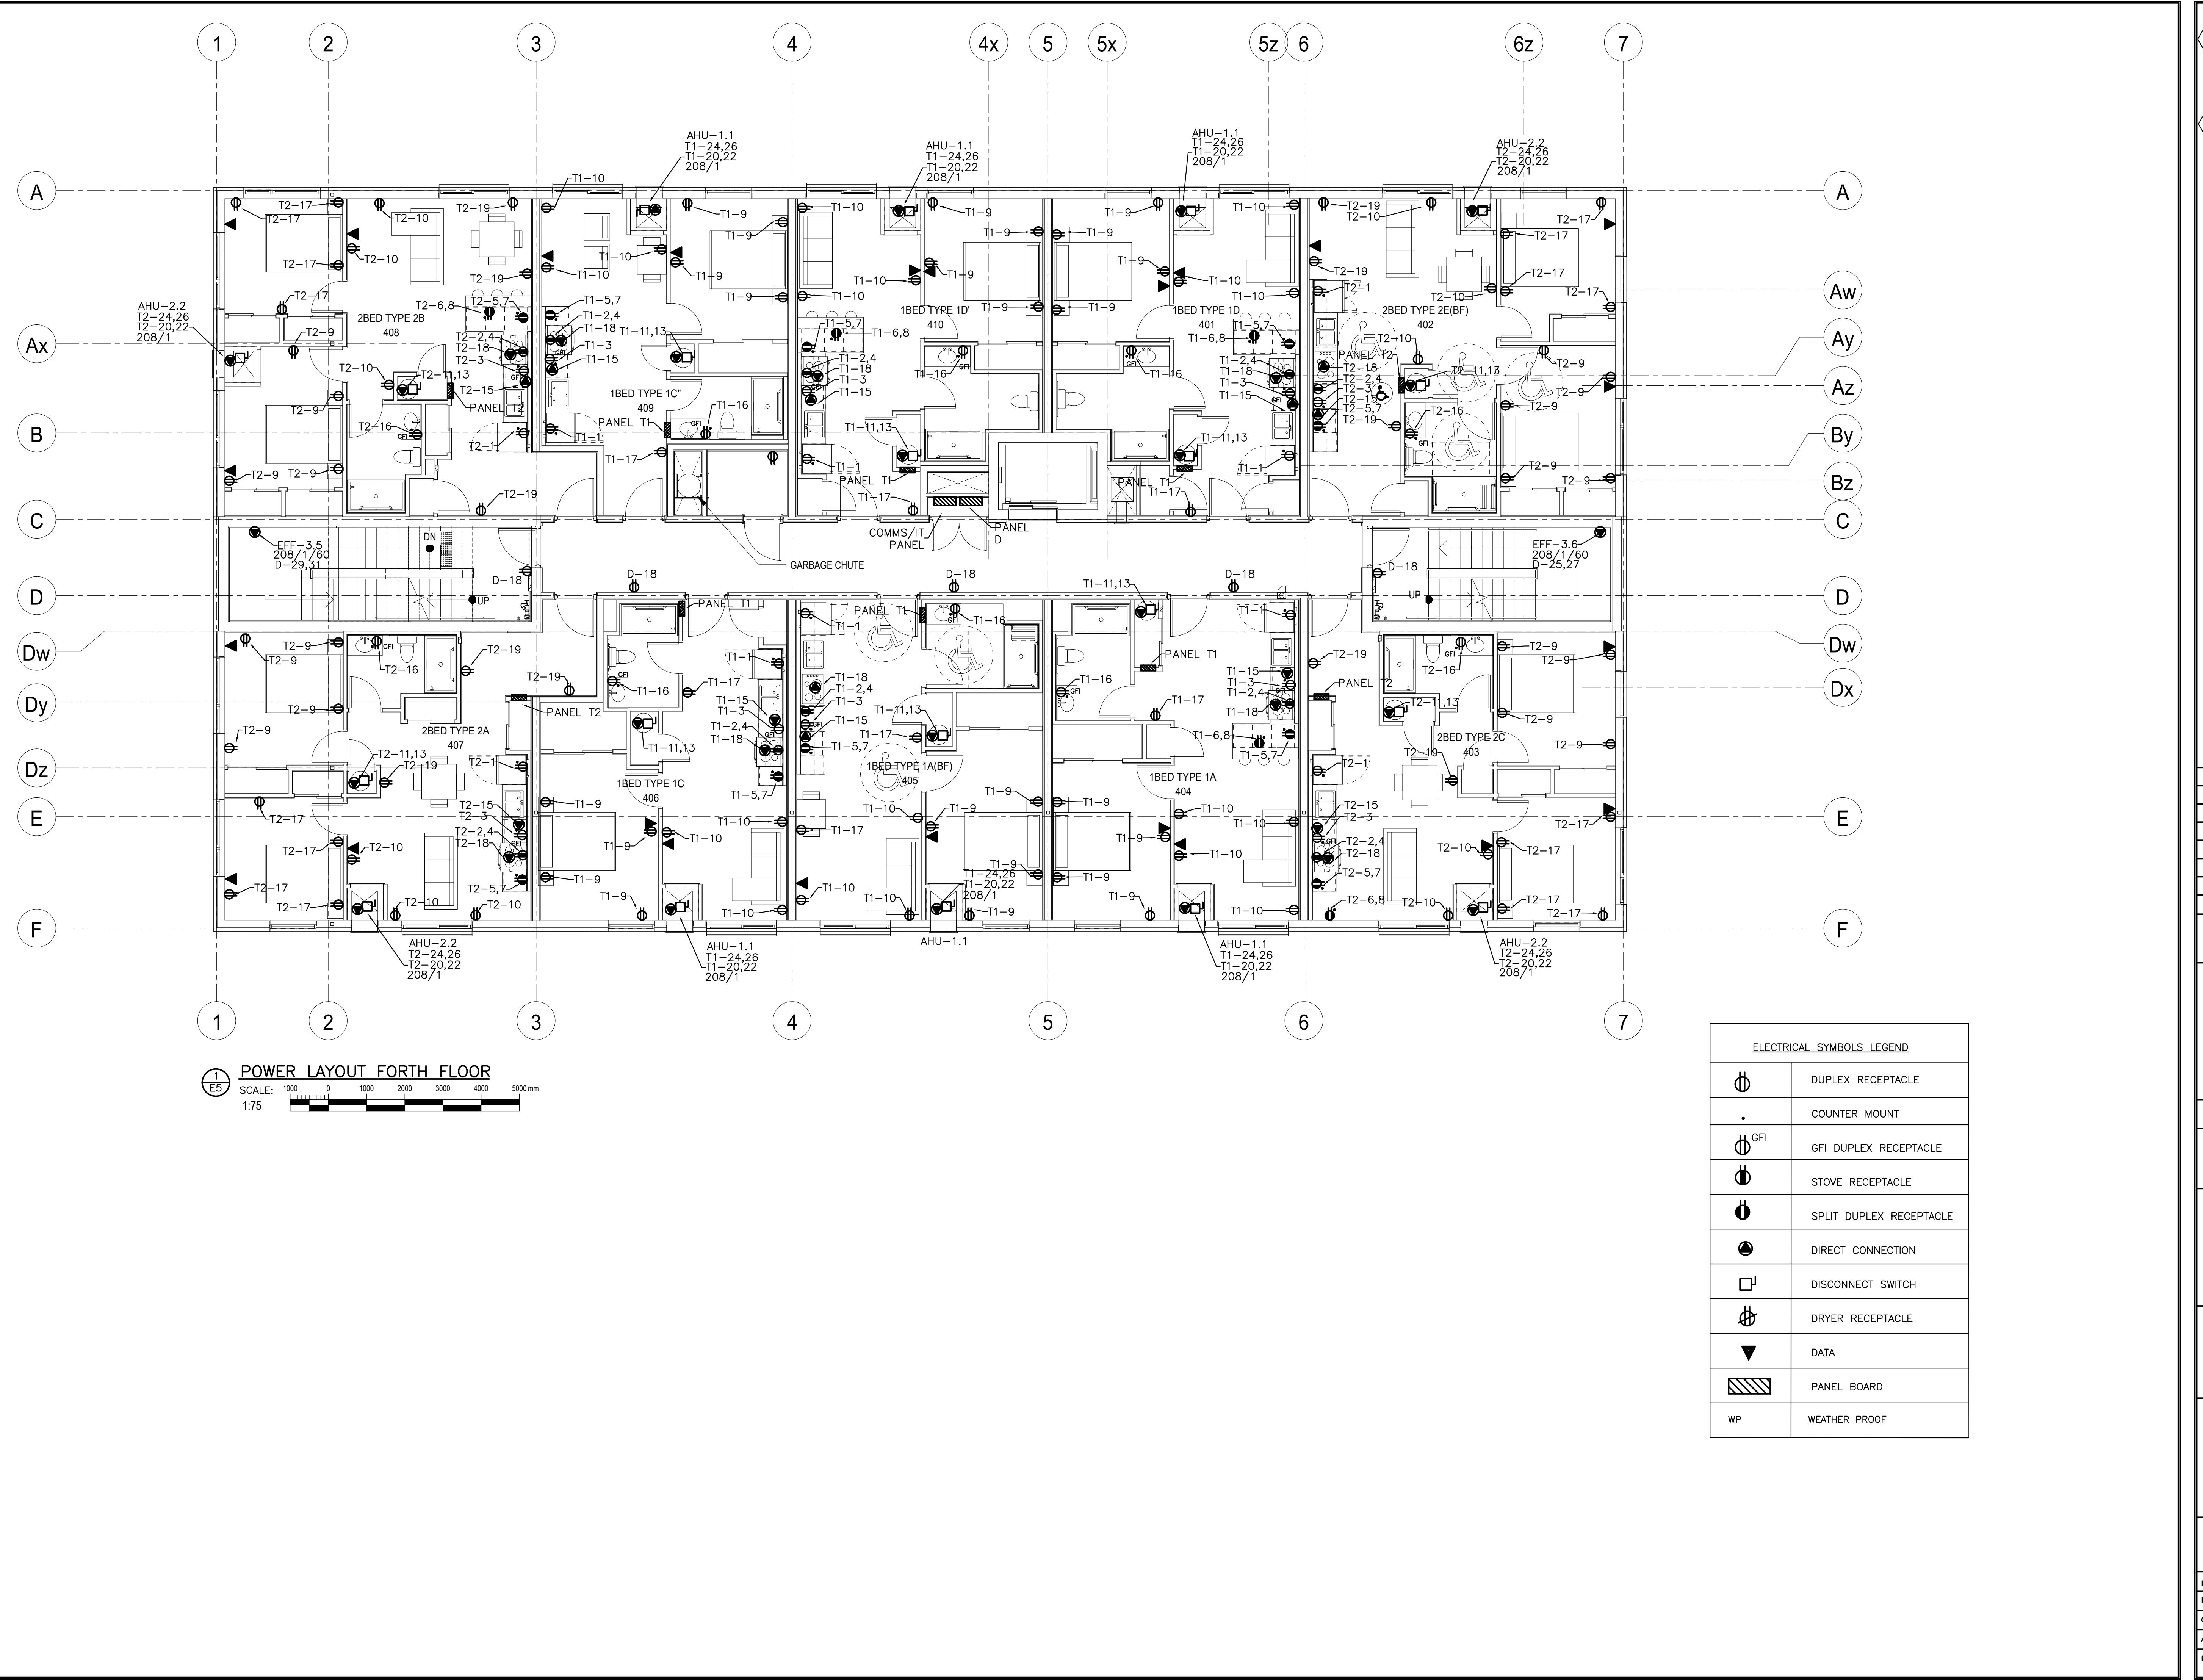
1697 HIGHWAY No 2  
CLARINGTON, ON

TITLE  
THIRD FLOOR POWER  
LAYOUT

DESIGN	MJM	SCALE AS NOTED
DRAWN	AJM	DWG NO.
CHECKED	MJM	
APPROVED	MJM	
PROJECT	E4	7393

**E4**

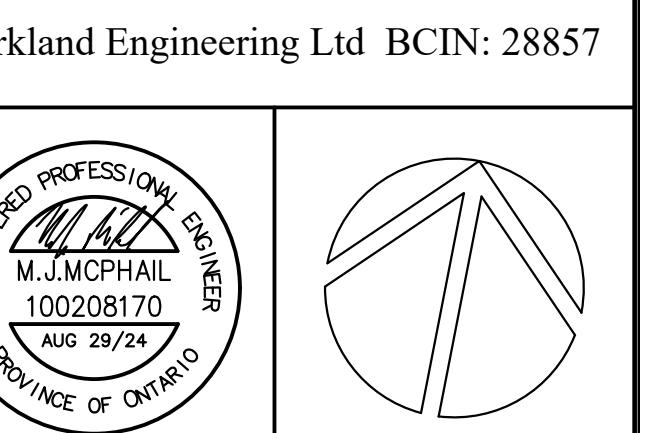
CADD FILE NO. 7393E4



**NOTES:**

- ALL SUITE AHU UNITS REQUIRE TWO INDEPENDENT 208/1/60 CIRCUITS, ONE FOR THE HEAT PUMP AND ONE FOR THE SUPPLEMENTAL E4 ELECTRIC HEAT. REFER TO PANEL SCHEDULES FOR CIRCUIT AMPACITIES.
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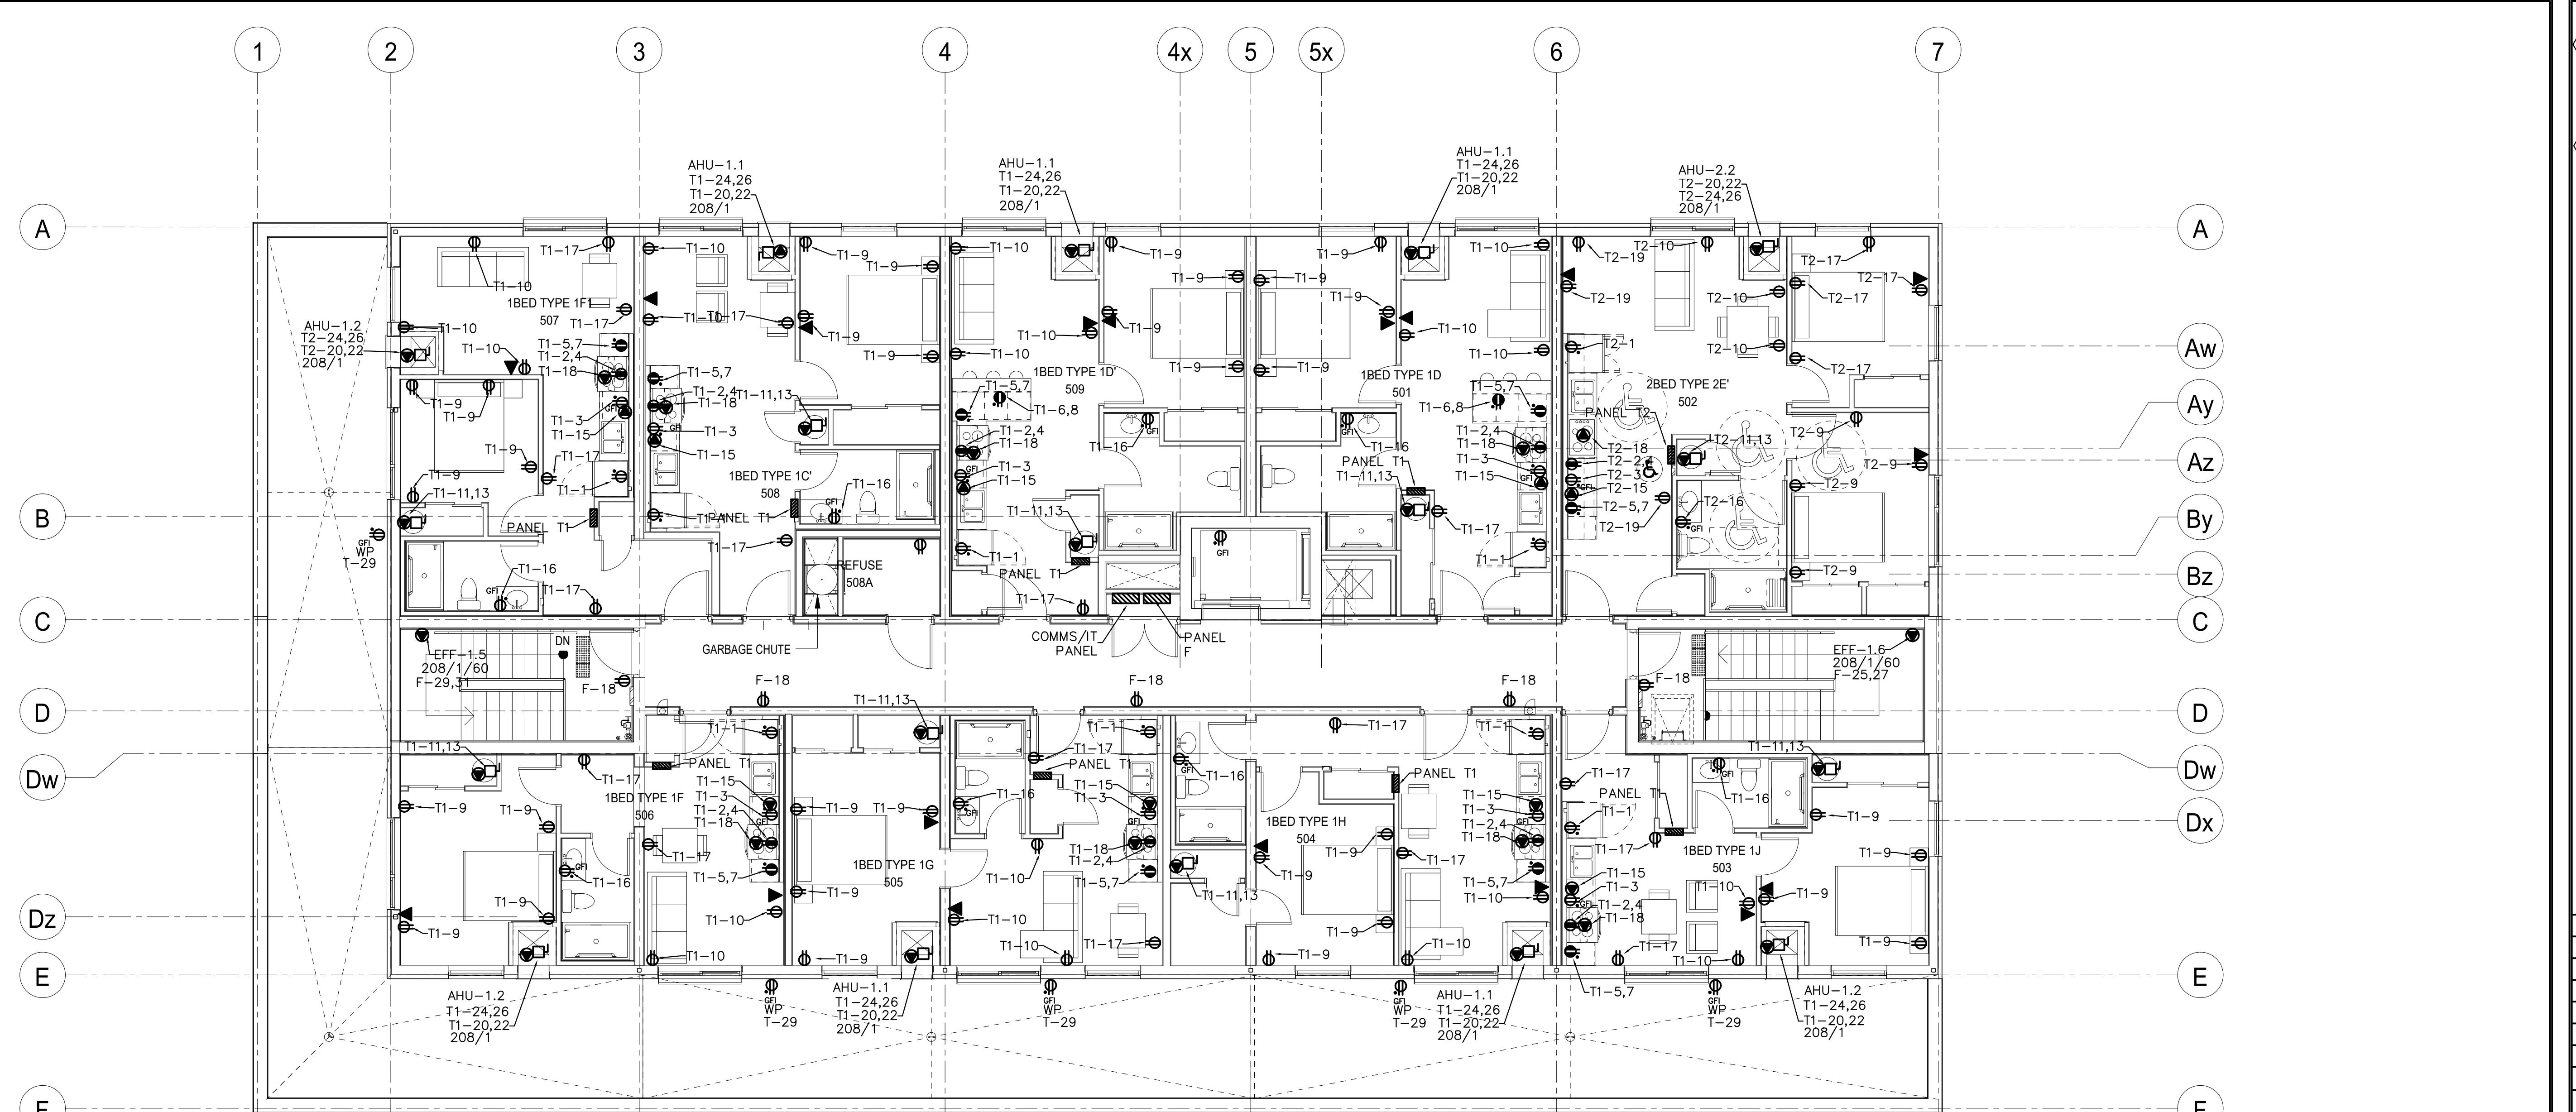
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**COURTICE SENIOR DEVELOPMENT**

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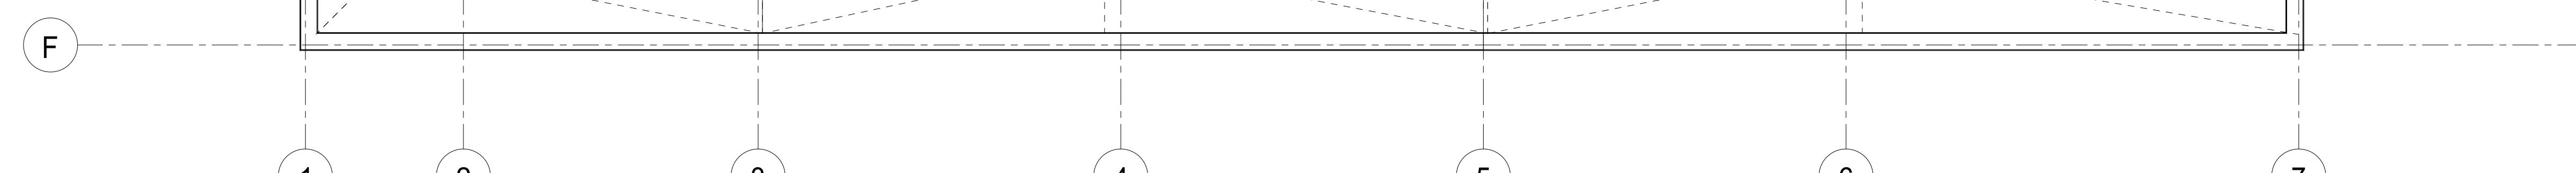
TITLE		
FORTH FLOOR POWER		
DESIGN	MJM	SCALE AS NOTED
DRAWN	AJM	DWG NO.
CHECKED	MJM	
APPROVED	MJM	
PROJECT	E5	7393



E6 POWER LAYOUT FIFTH FLOOR

SCALE: 1000  
1:75

0 1000 2000 3000 4000 5000 mm



ELECTRICAL SYMBOLS LEGEND	
	DUPLEX RECEPTACLE
.	COUNTER MOUNT
	GFI DUPLEX RECEPTACLE
	STOVE RECEPTACLE
	SPLIT DUPLEX RECEPTACLE
(●)	DIRECT CONNECTION
□	DISCONNECT SWITCH
	DRYER RECEPTACLE
▼	DATA
	PANEL BOARD
WP	WEATHER PROOF

NOTES:

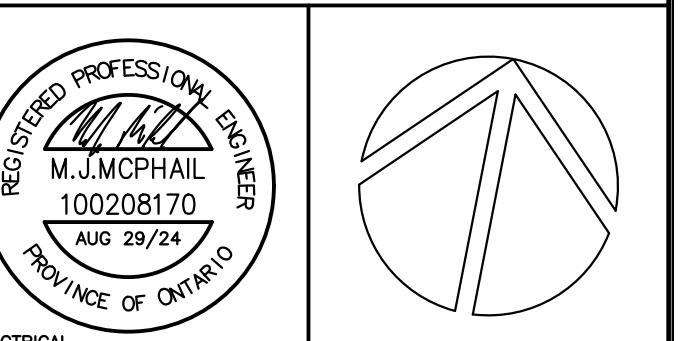
① ALL SUITE AHU UNITS REQUIRE TWO INDEPENDENT 208/1/60 CIRCUITS, ONE FOR THE HEAT PUMP AND ONE FOR THE SUPPLEMENTAL E4 ELECTRIC HEAT. REFER TO PANEL SCHEDULES FOR CIRCUIT AMPACITIES.

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0	ISSUED FOR TENDER	2024.08.29 MJM
NO.	DESCRIPTION	DATE BY

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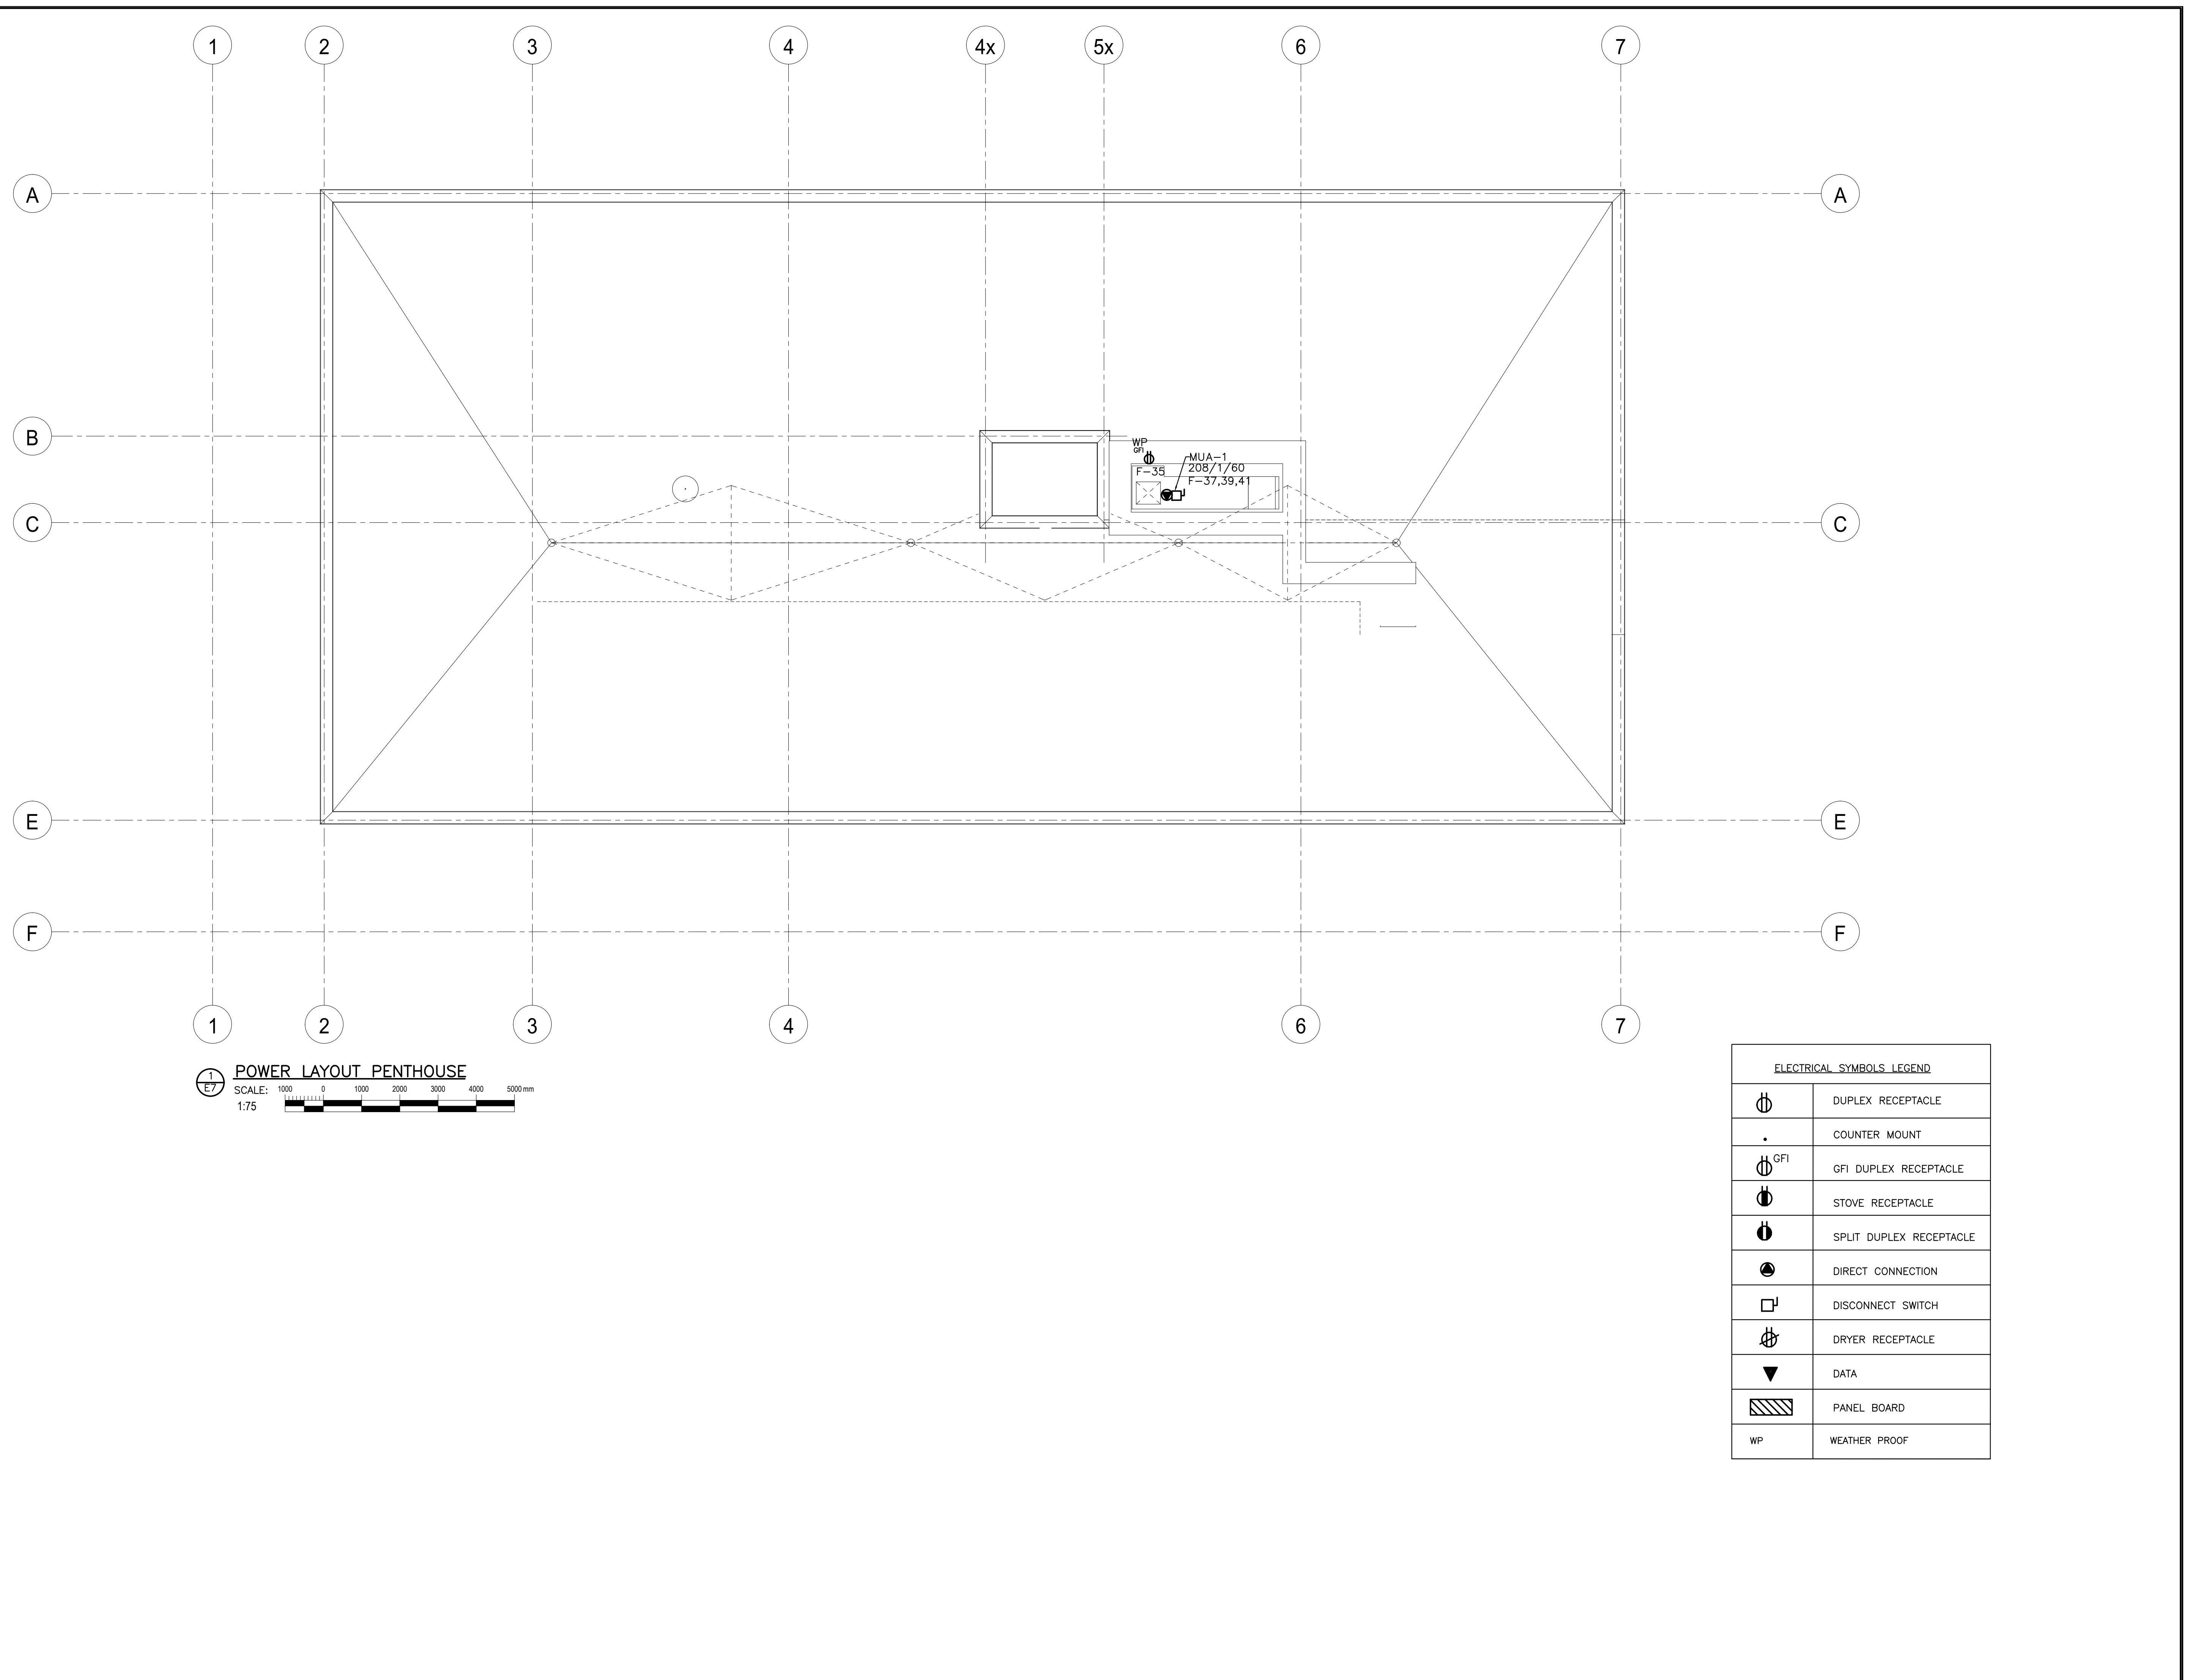
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PROJECT  
COURTICE SENIOR DEVELOPMENT

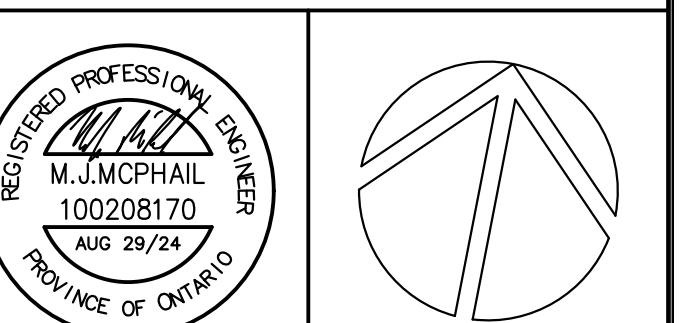
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CLARINGTON, ON

TITLE  
**FIFTH FLOOR POWER**

DESIGN	MJM	SCALE AS NOTED
DRAWN	AJM	DWG NO.
CHECKED	MJM	
APPROVED	MJM	
PROJECT	E6	7393
		CADD FILE NO. 7393E6



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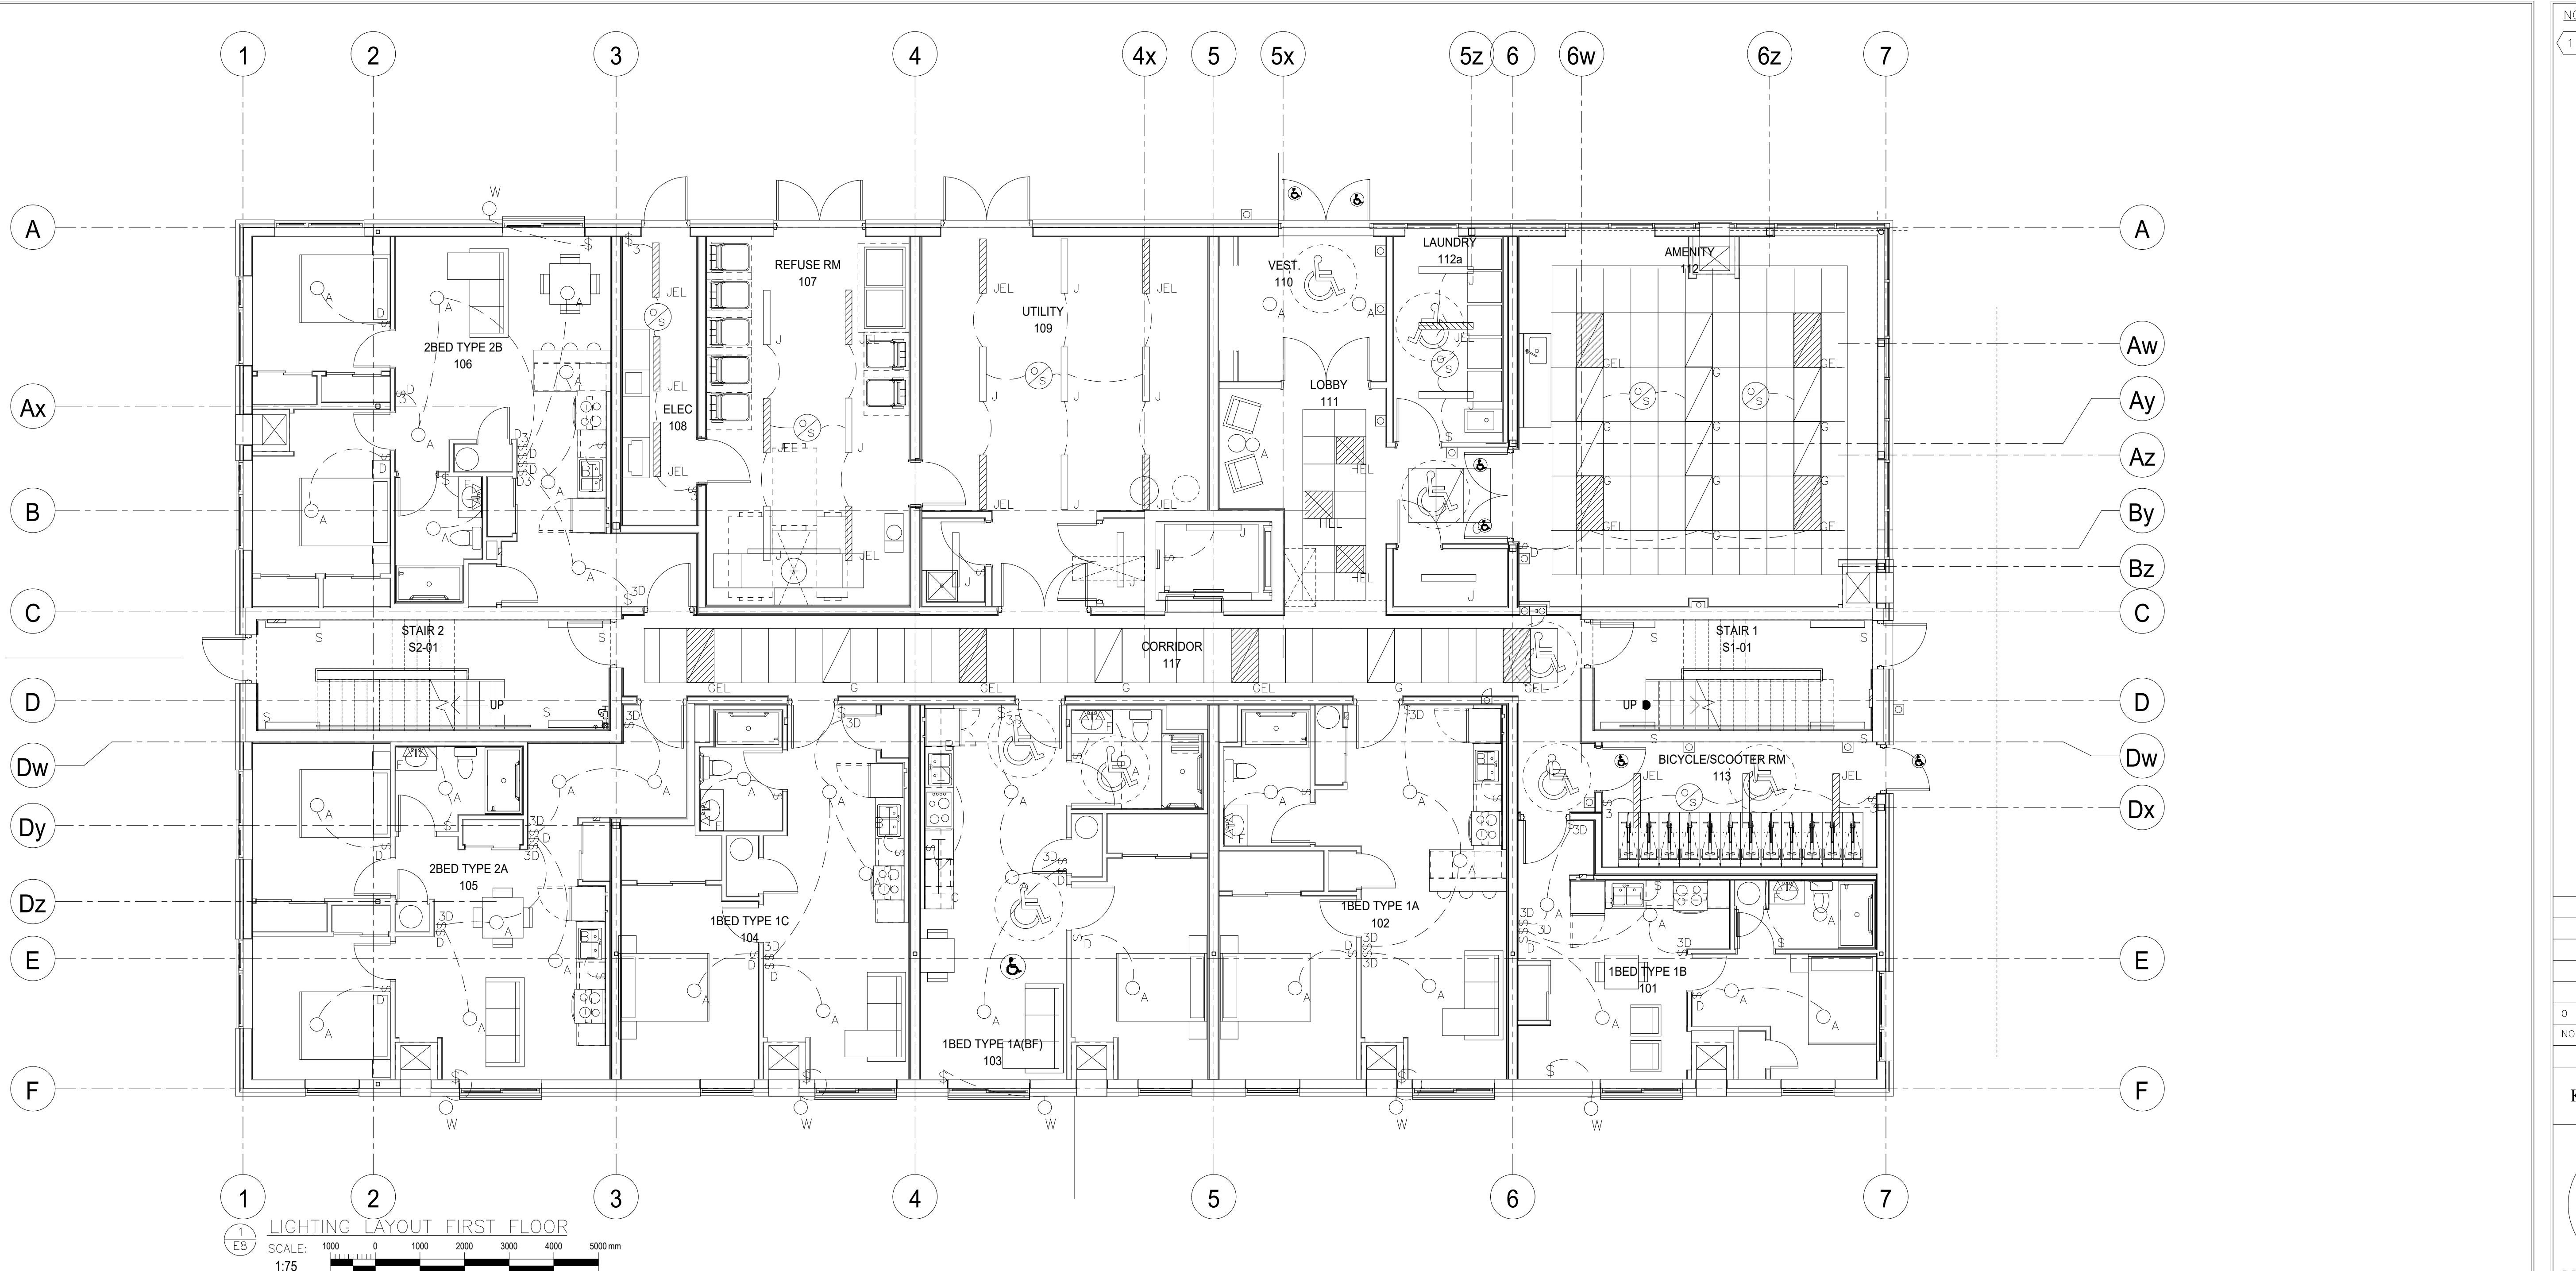
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ELECTRICAL SYMBOLS LEGEND	
	DUPLEX RECEPTACLE
•	COUNTER MOUNT
	GFI DUPLEX RECEPTACLE
	STOVE RECEPTACLE
	SPLIT DUPLEX RECEPTACLE
	DIRECT CONNECTION
	DISCONNECT SWITCH
	DRYER RECEPTACLE
	DATA
	PANEL BOARD
WP	WEATHER PROOF

**JECT**  
**COURTICE SENIOR**  
**DEVELOPMENT**

**1697 HIGHWAY No 2  
CLARINGTON, ON**

E PENTHOUSE POWER		
GN	MJM	SCALE AS NOTED
WN	AJM	DWG NO.
CKED	MJM	
ROVED	MJM	
JECT	7393	<b>E7</b>

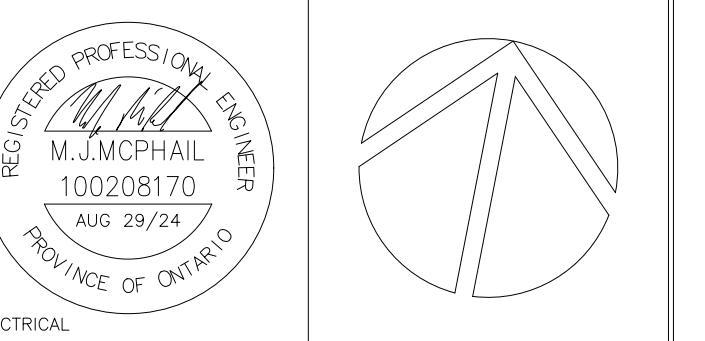


**NOTES:**

1 ALL FIXTURES WITH INTEGRAL BATTERY BACKUP ARE TO HAVE THE BATTERY SUPPLIED BY AN UN-SWITCHED PORTION OF THE LIGHTING CIRCUIT SUCH THAT THEY WILL AUTOMATICALLY COME ON IN CASES OF POWER OUTAGE AND CAN BE CONTROLLED ON AND OFF BY LIGHTING CONTROLS UNDER NORMAL POWER OPERATING CONDITIONS.

0	ISSUED FOR TENDER	2024.08.29	MJM
NO.	DESCRIPTION	DATE	BY
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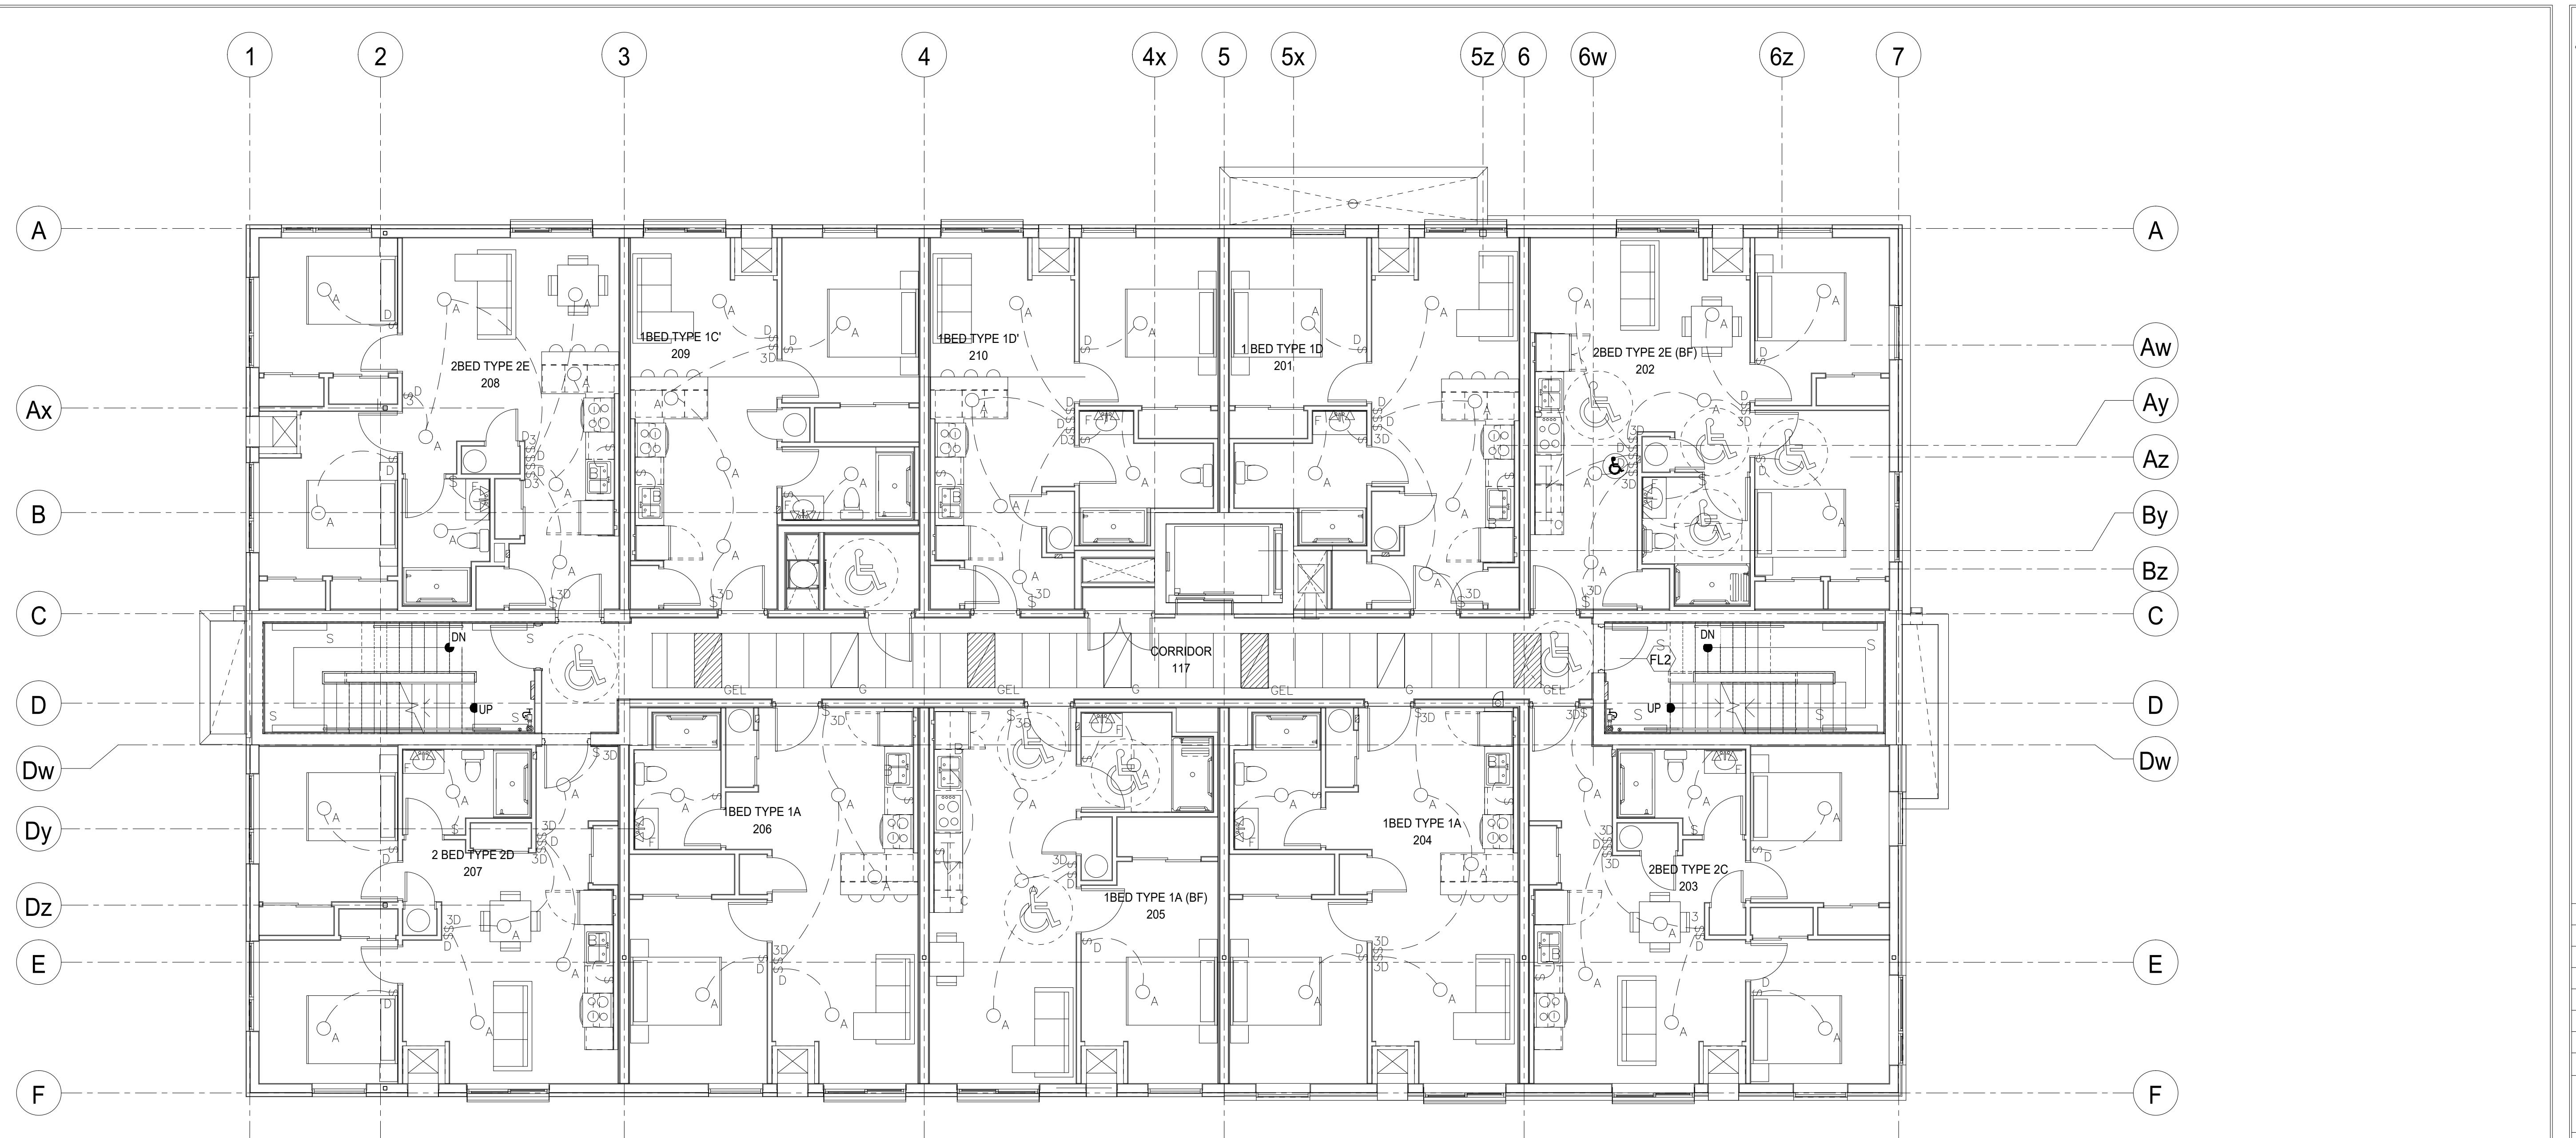
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COURTICE SENIOR DEVELOPMENT

1697 HIGHWAY No 2  
CLARINGTON, ON

TITLE  
FIRST FLOOR  
LIGHTING

DESIGN	MJM	SCALE AS NOTED
DRAWN	AJM	DWG NO.
CHECKED	MJM	
APPROVED	MJM	
PROJECT	E8	7393
CADD FILE NO.		7393E8



1 LIGHTING LAYOUT SECOND FLOOR  
E9

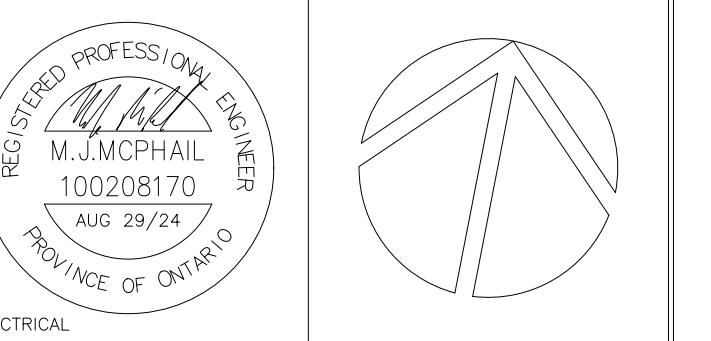
SCALE: 1000 0 1000 2000 3000 4000 5000 mm  
1:75

NOTES:

1 ALL FIXTURES WITH INTEGRAL BATTERY BACKUP ARE TO HAVE THE BATTERY SUPPLIED BY AN UN-SWITCHED PORTION OF THE LIGHTING CIRCUIT SUCH THAT THEY WILL AUTOMATICALLY COME ON IN CASES OF POWER OUTAGE AND CAN BE CONTROLLED ON AND OFF BY LIGHTING CONTROLS UNDER NORMAL POWER OPERATING CONDITIONS.

0	ISSUED FOR TENDER	2024.08.29	MJM
NO.	DESCRIPTION	DATE	BY
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PROJECT  
COURTICE SENIOR DEVELOPMENT

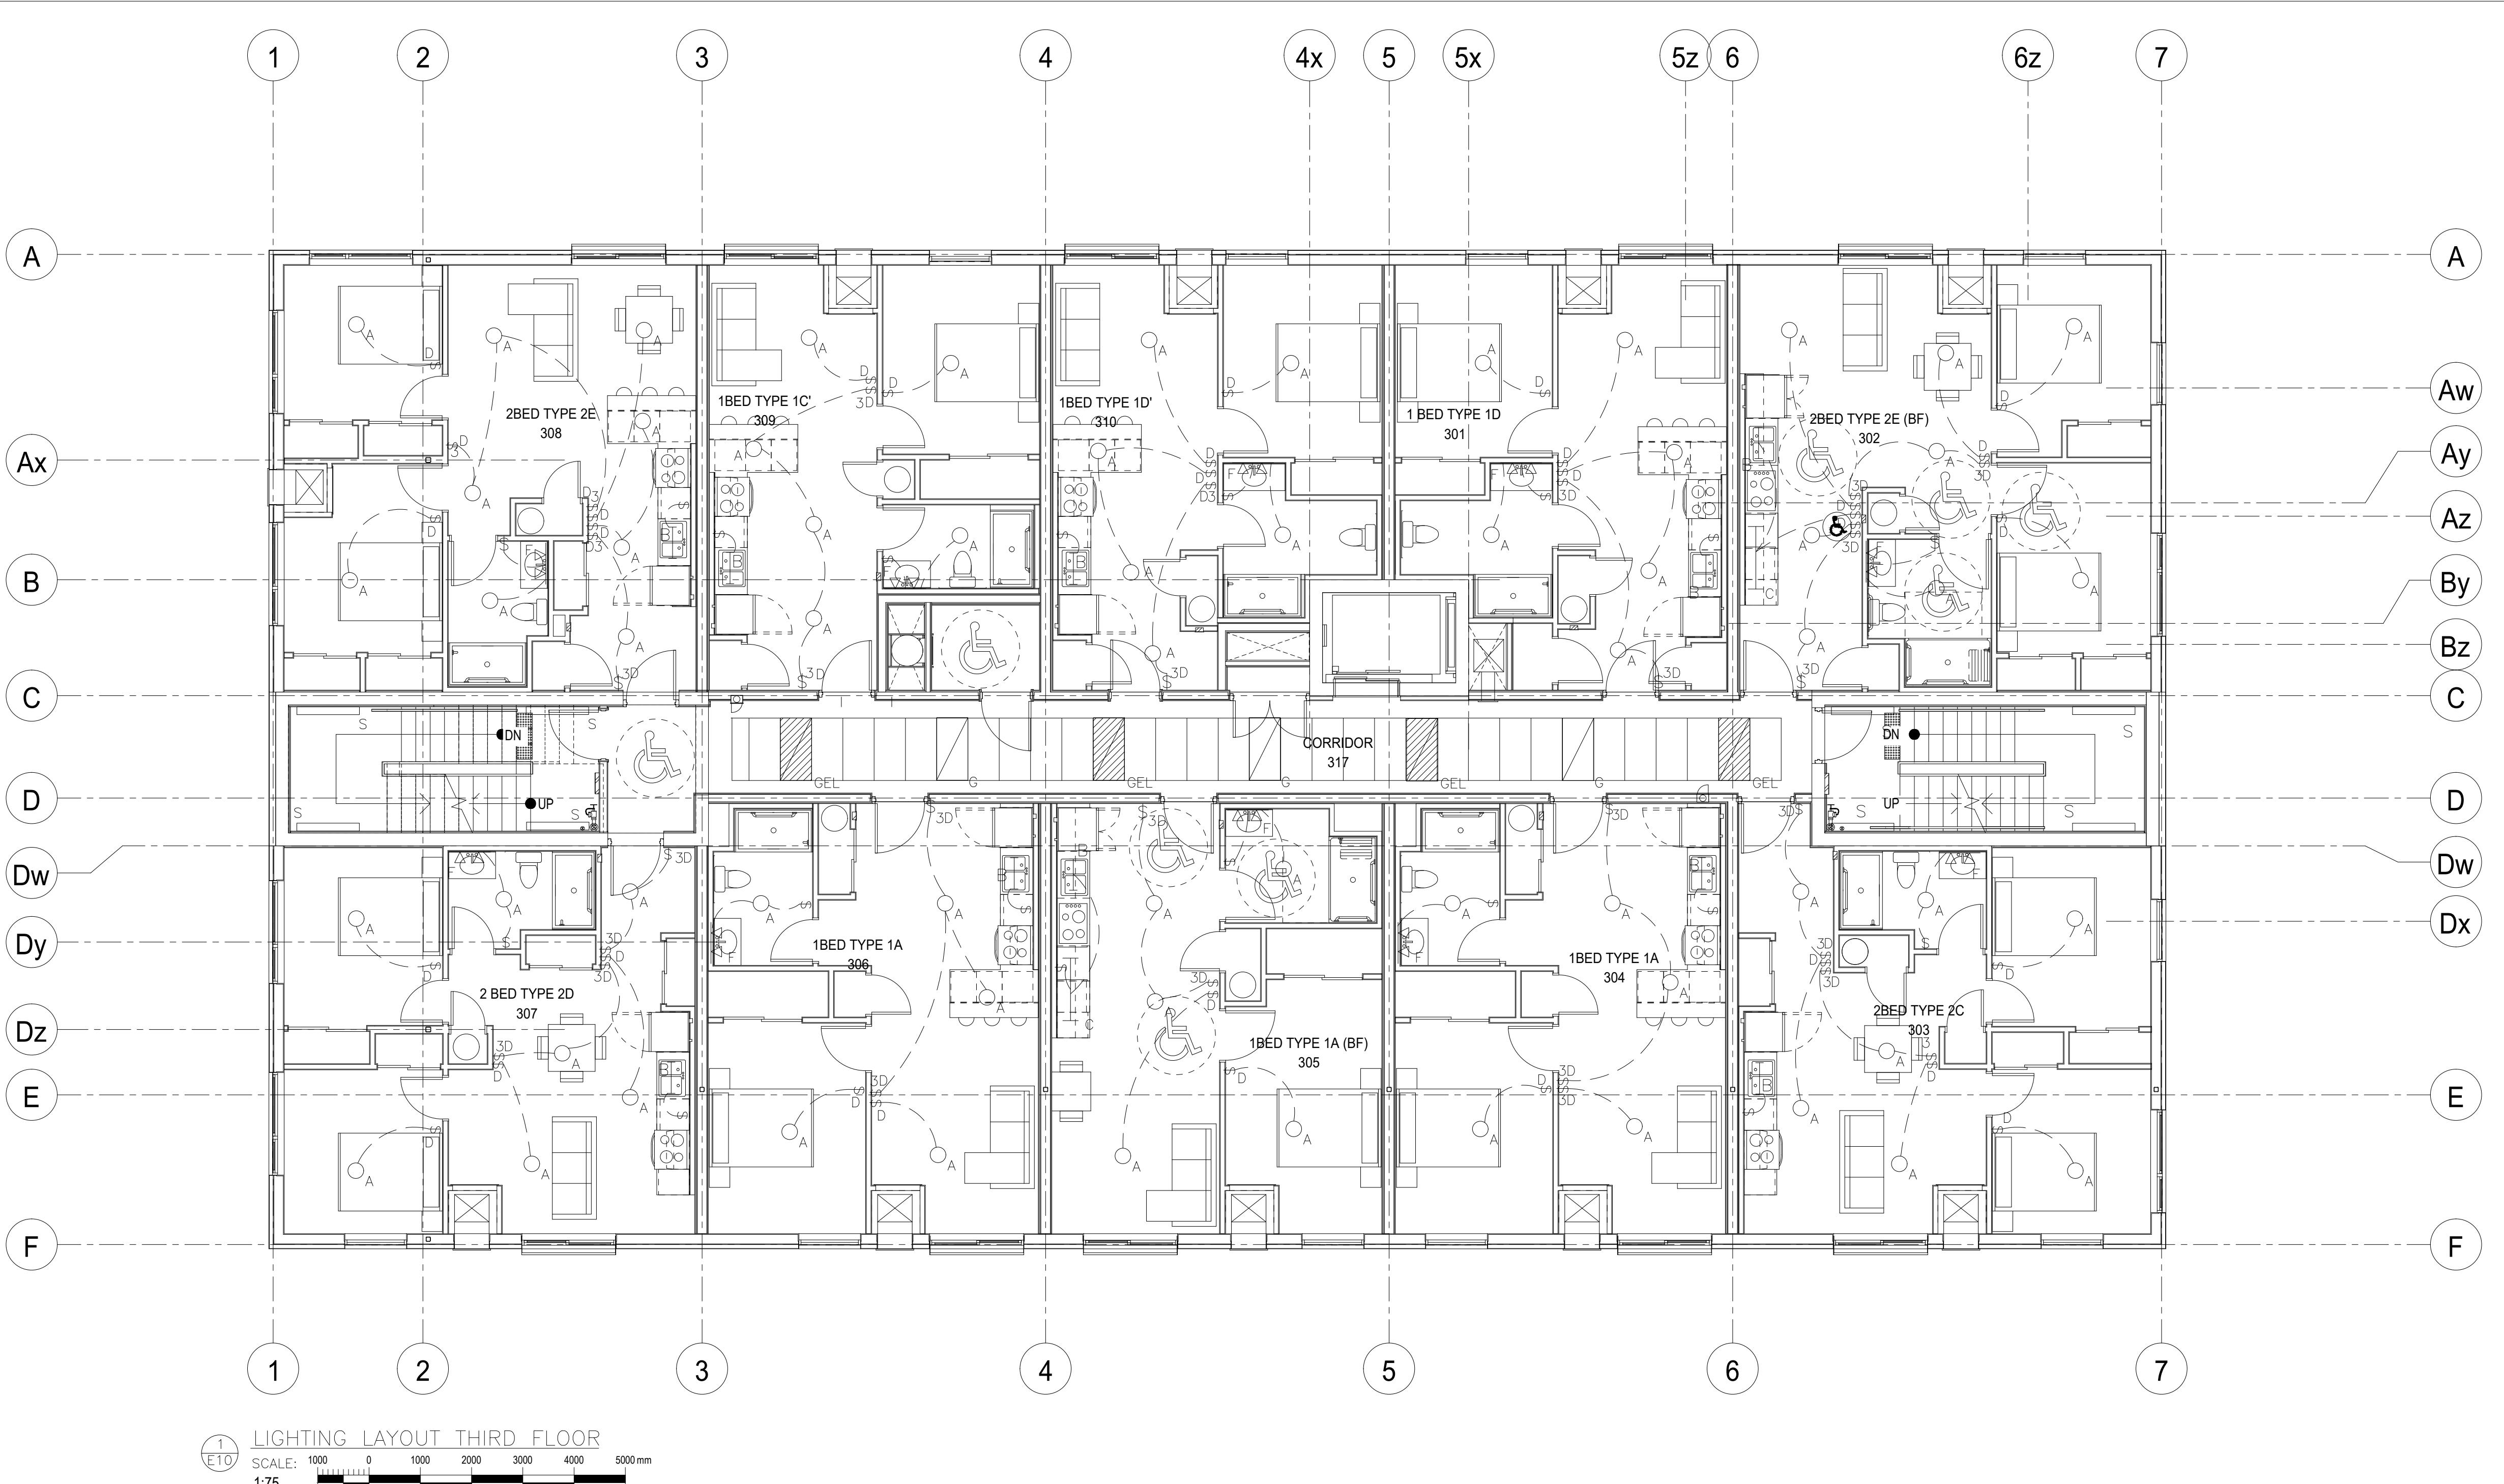
1697 HIGHWAY No 2  
CLARINGTON, ON

TITLE  
SECOND FLOOR  
LIGHTING

DESIGN	MJM	SCALE AS NOTED
DRAWN	AJM	DWG NO.
CHECKED	MJM	
APPROVED	MJM	
PROJECT	E9	7393

E9

CADD FILE NO. 7393E9



1 LIGHTING LAYOUT THIRD FLOOR  
E10

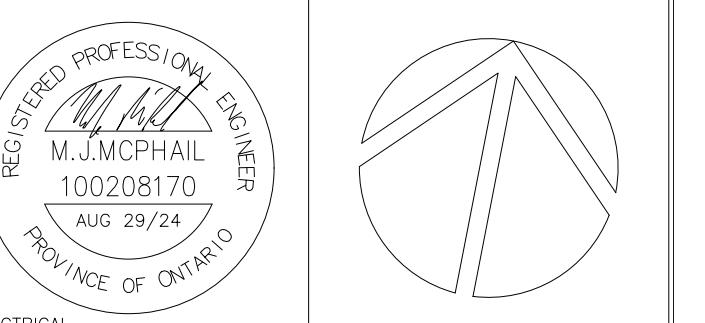
SCALE: 1000 0 1000 2000 3000 4000 5000 mm  
1:75

NOTES:  
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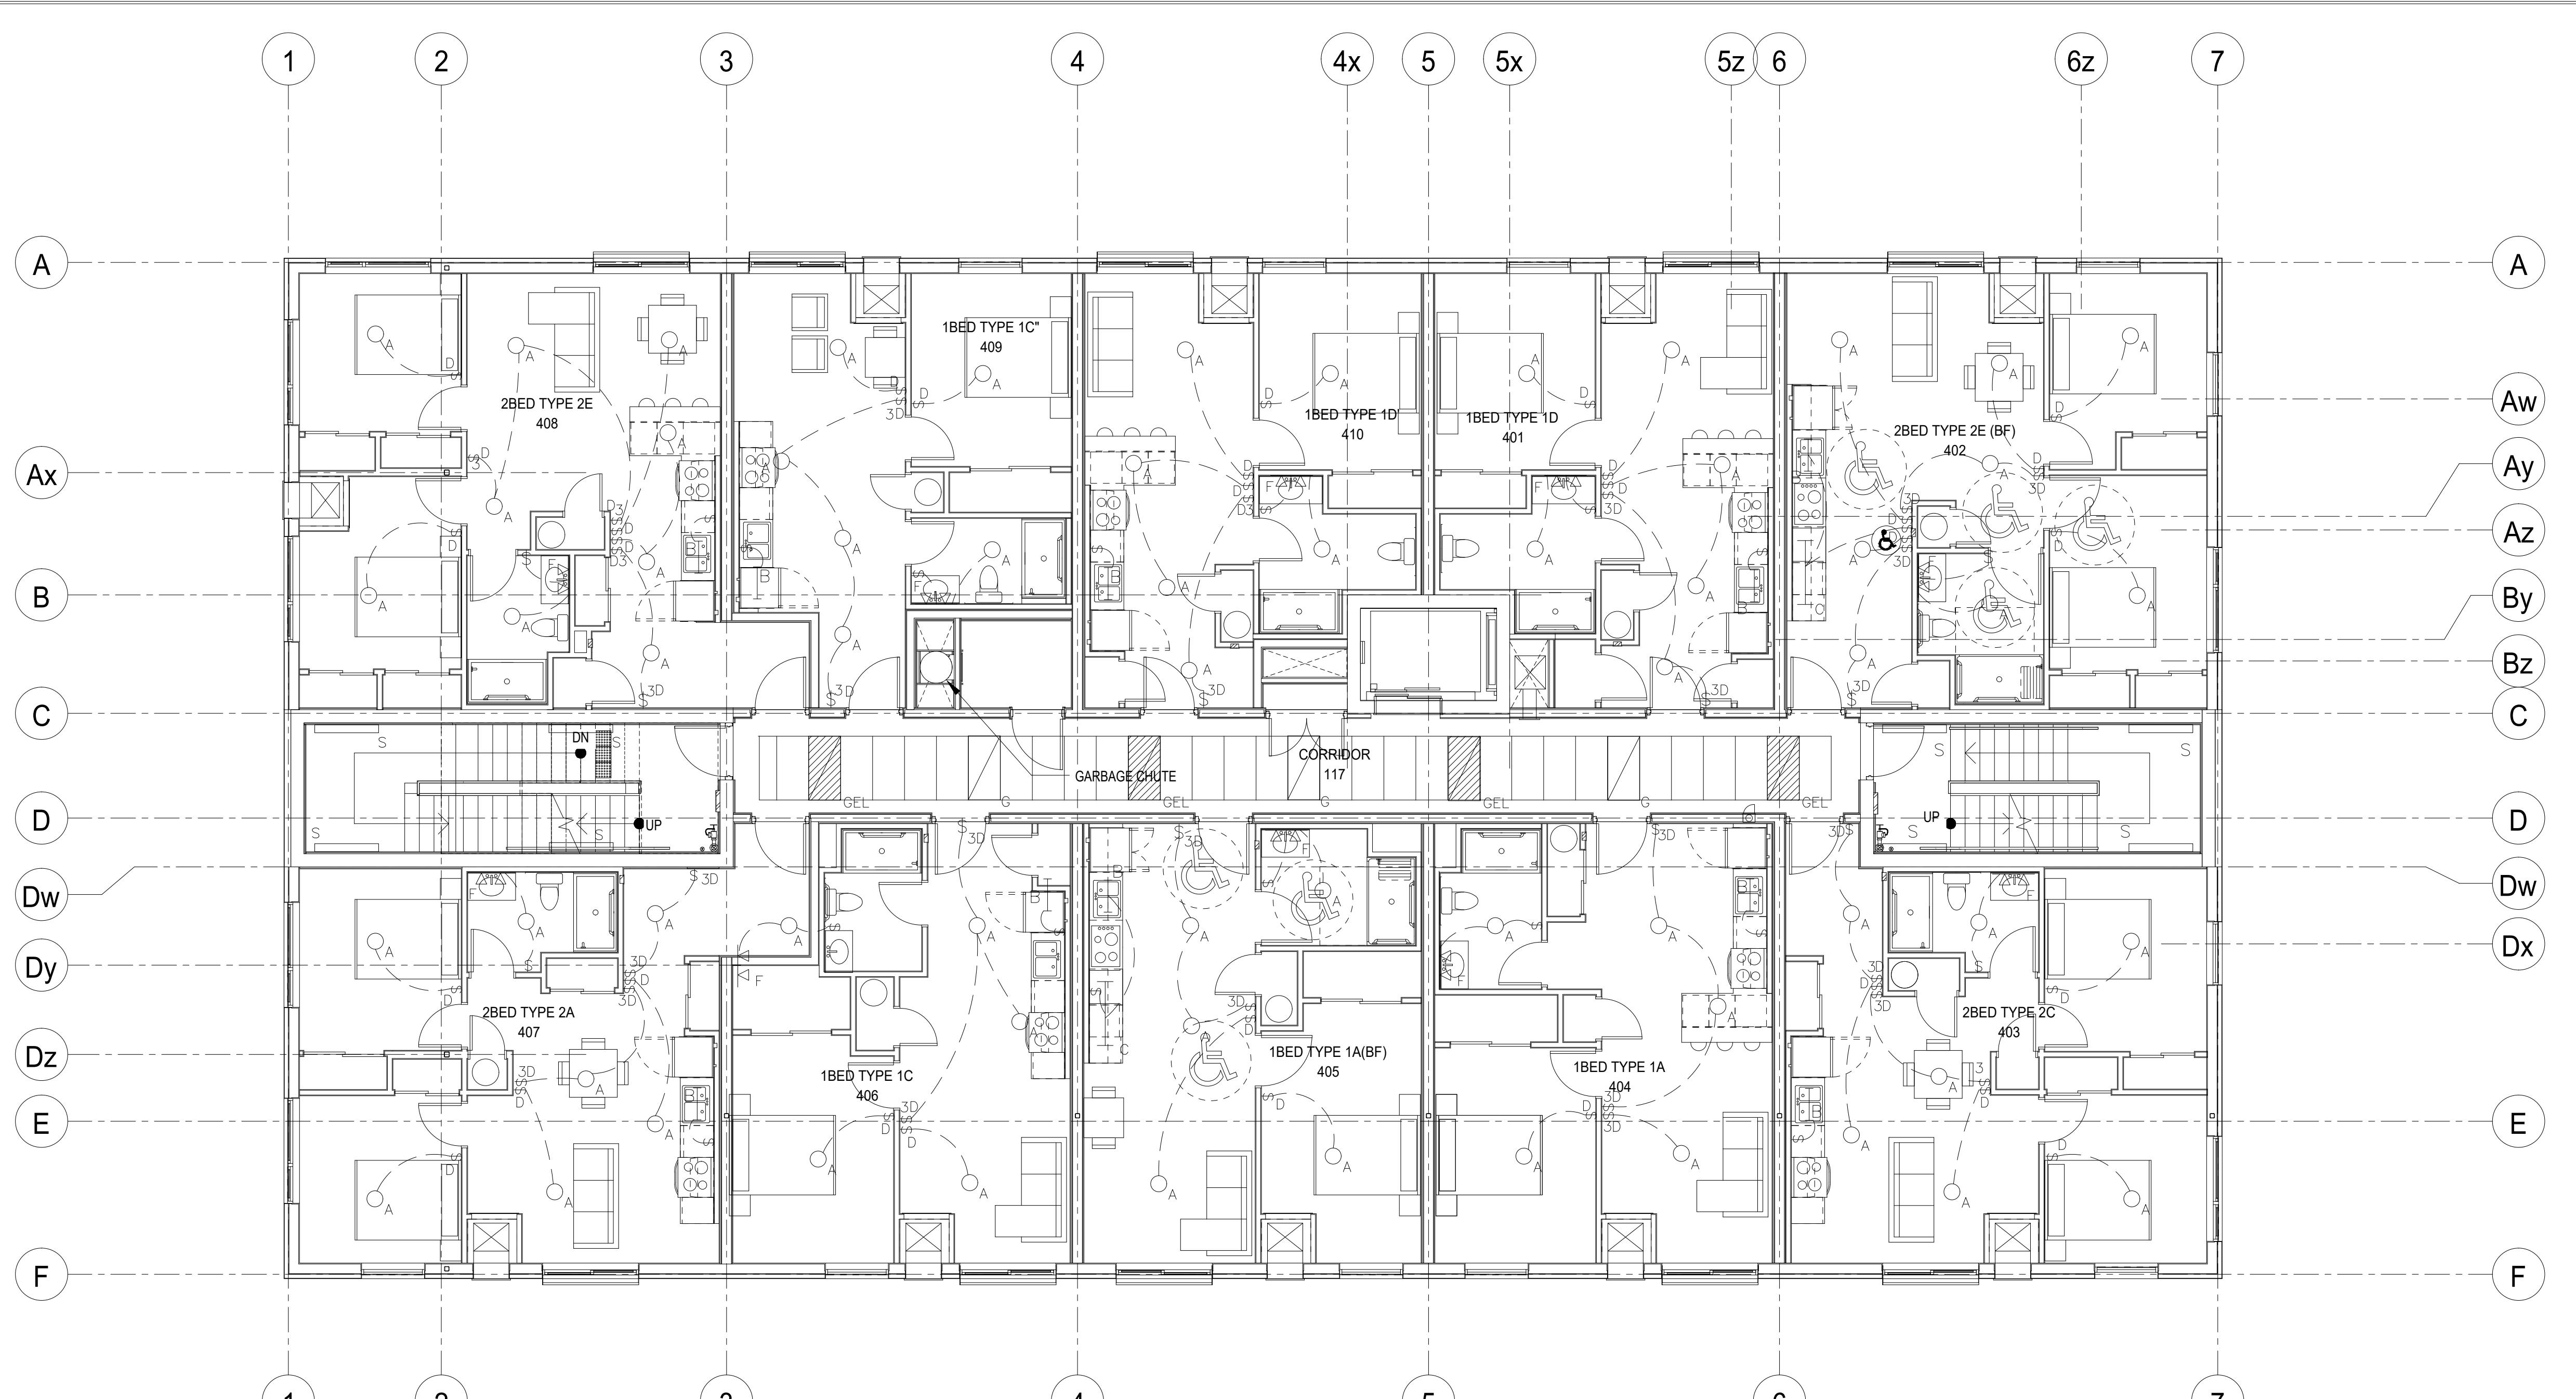
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PROJECT  
COURTICE SENIOR DEVELOPMENT

1697 HIGHWAY No 2  
CLARINGTON, ON

TITLE  
THIRD FLOOR  
LIGHTING

DESIGN	MJM	SCALE AS NOTED
DRAWN	AJM	DWG NO.
CHECKED	MJM	
APPROVED	MJM	
PROJECT	E10	7393
		CADD FILE NO. 7393E10



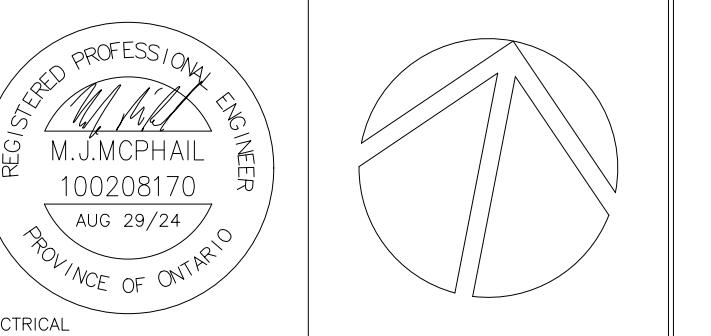
1 E11 LIGHTING LAYOUT FORTH FLOOR  
SCALE: 1000 0 1000 2000 3000 4000 5000 mm  
1:75

NOTES:

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PROJECT  
COURTICE SENIOR DEVELOPMENT

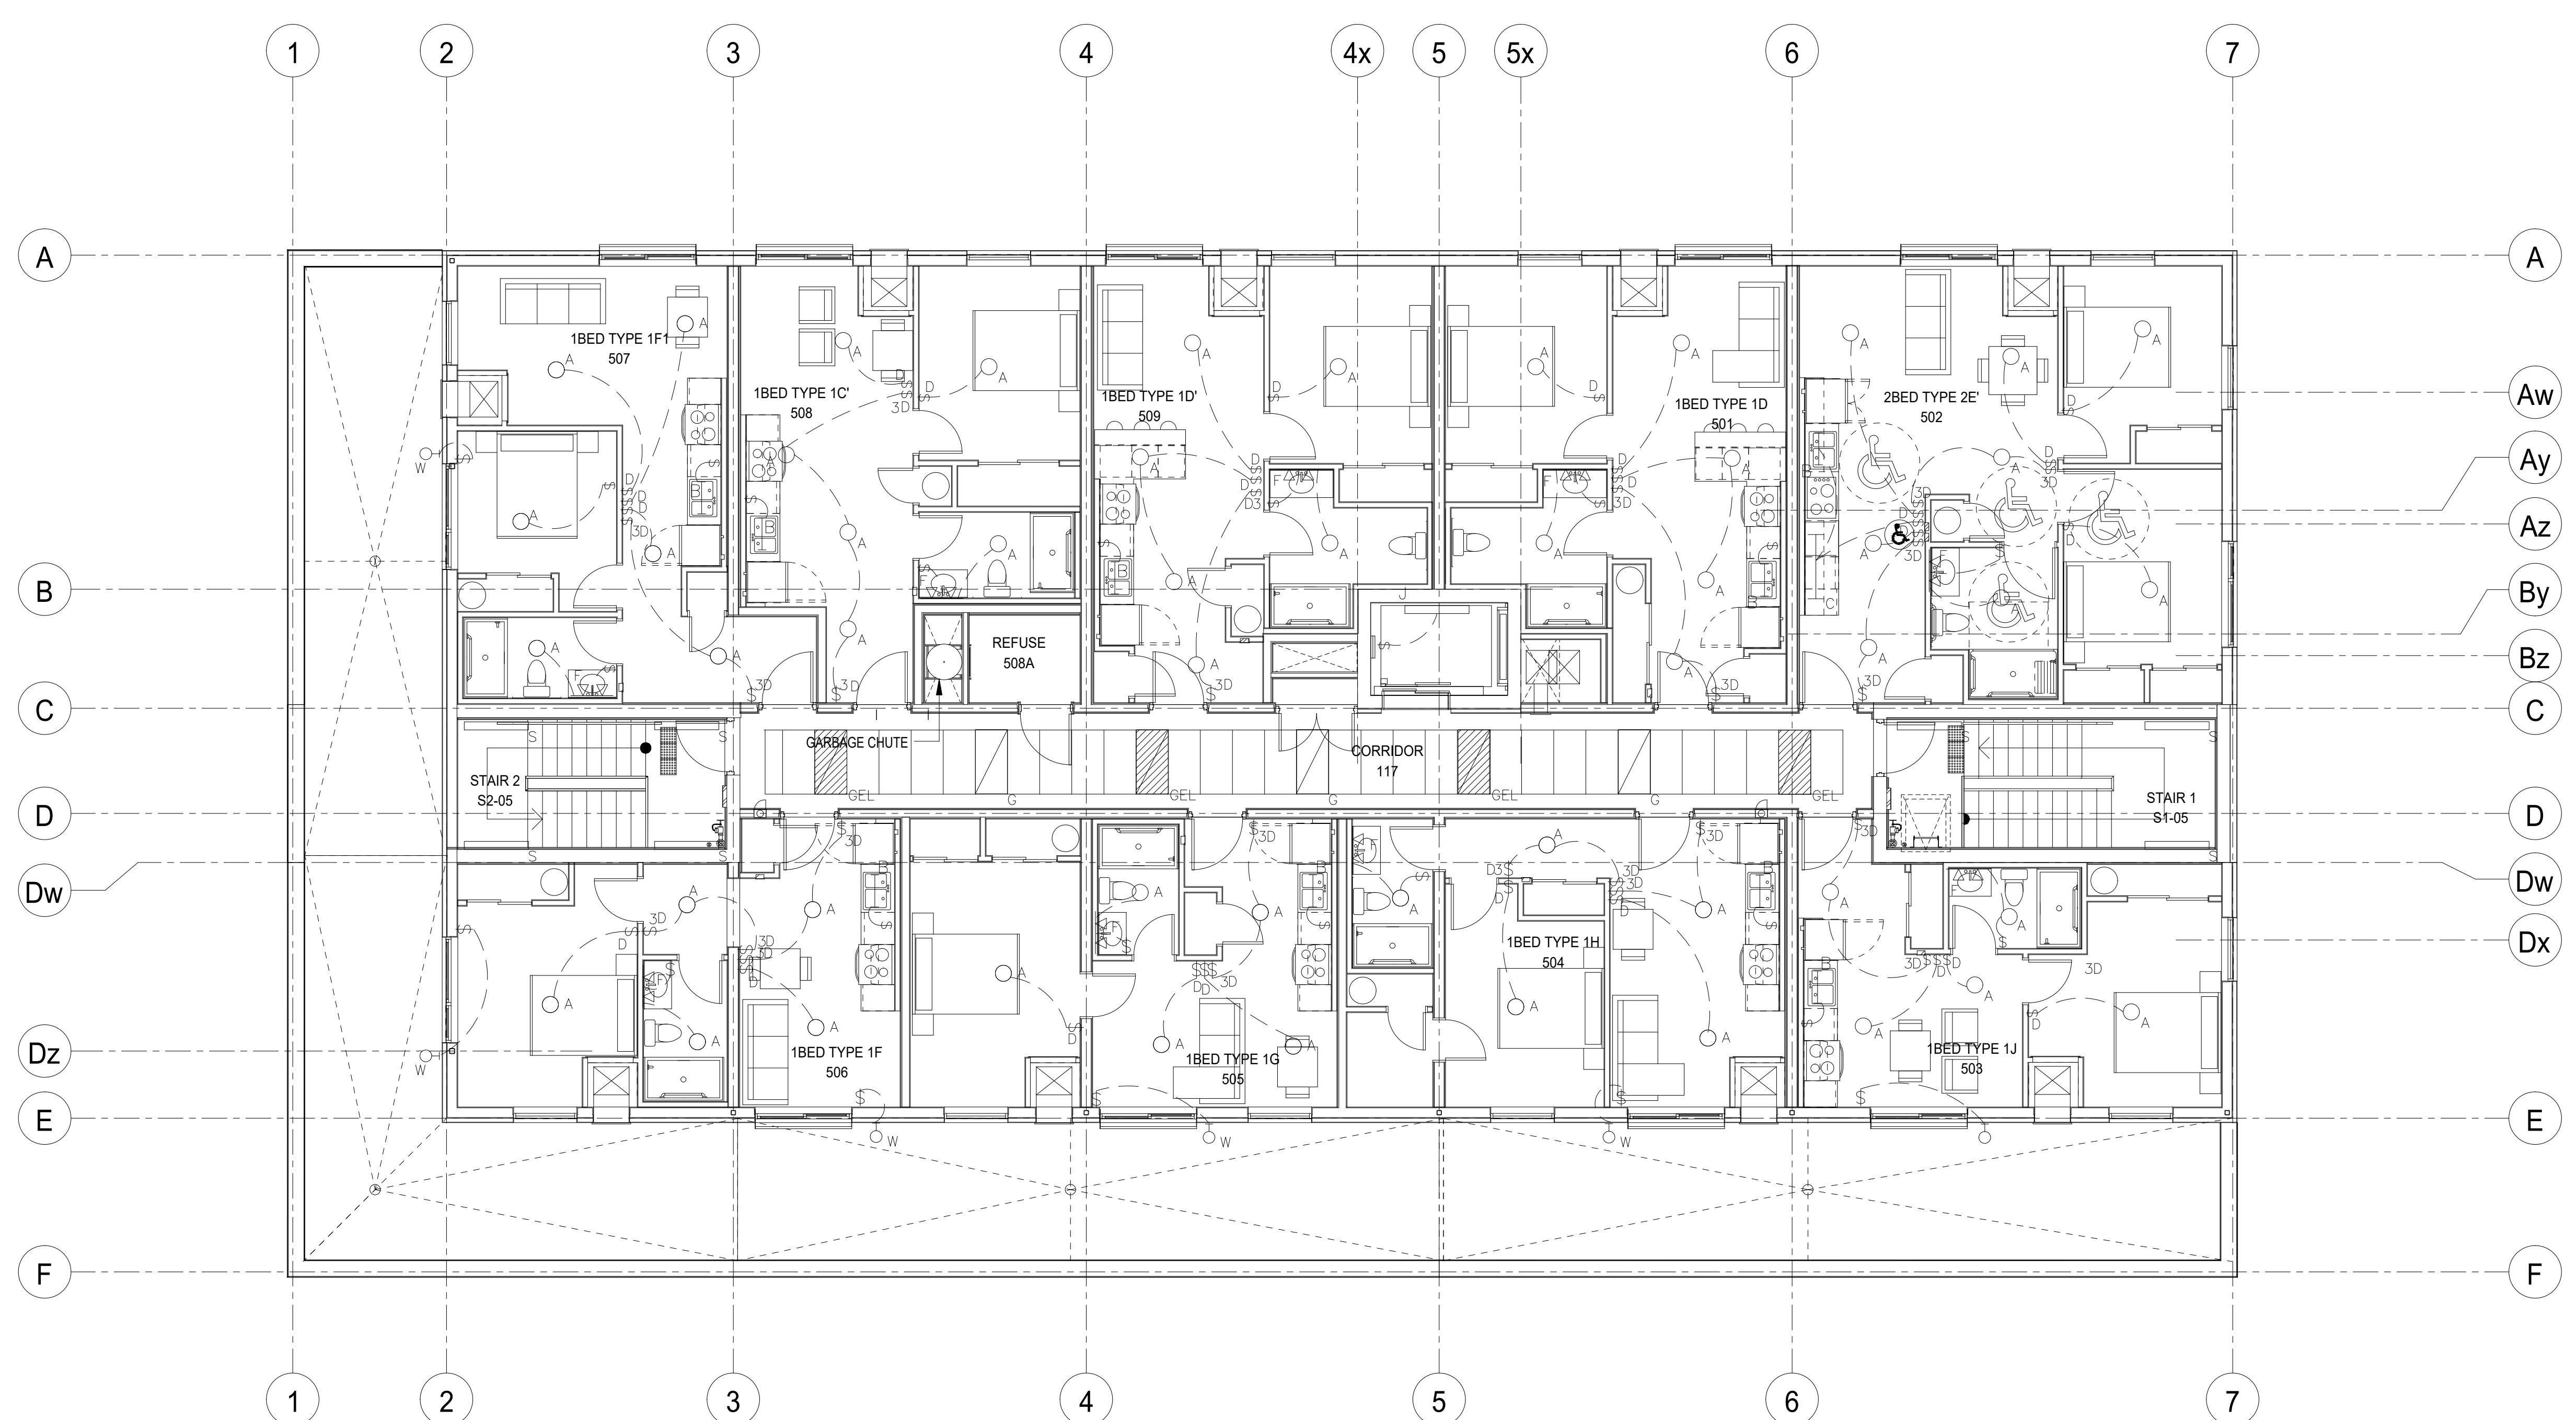
1697 HIGHWAY No 2  
CLARINGTON, ON

TITLE  
FORTH FLOOR  
LIGHTING

DESIGN	MJM	SCALE AS NOTED
DRAWN	AJM	DWG NO.
CHECKED	MJM	
APPROVED	MJM	
PROJECT	E11	7393

E11

CADD FILE NO. 7393E11



1 LIGHTING LAYOUT FIFTH FLOOR  
E12

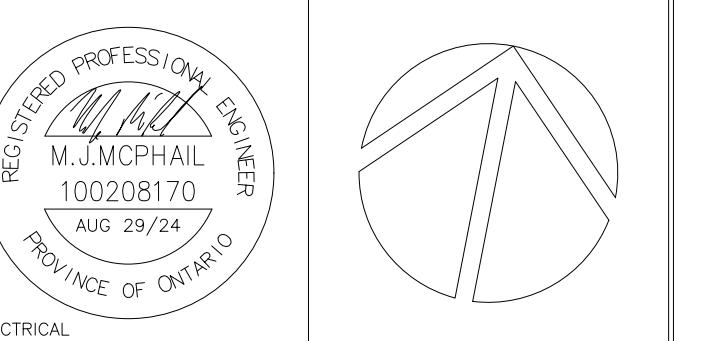
SCALE: 1000 0 1000 2000 3000 4000 5000 mm

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NOTES:  
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NO.	DESCRIPTION	DATE	BY
REVISIONS			

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PROJECT  
COURTICE SENIOR DEVELOPMENT

1697 HIGHWAY No 2  
CLARINGTON, ON

TITLE  
FIFTH FLOOR  
LIGHTING

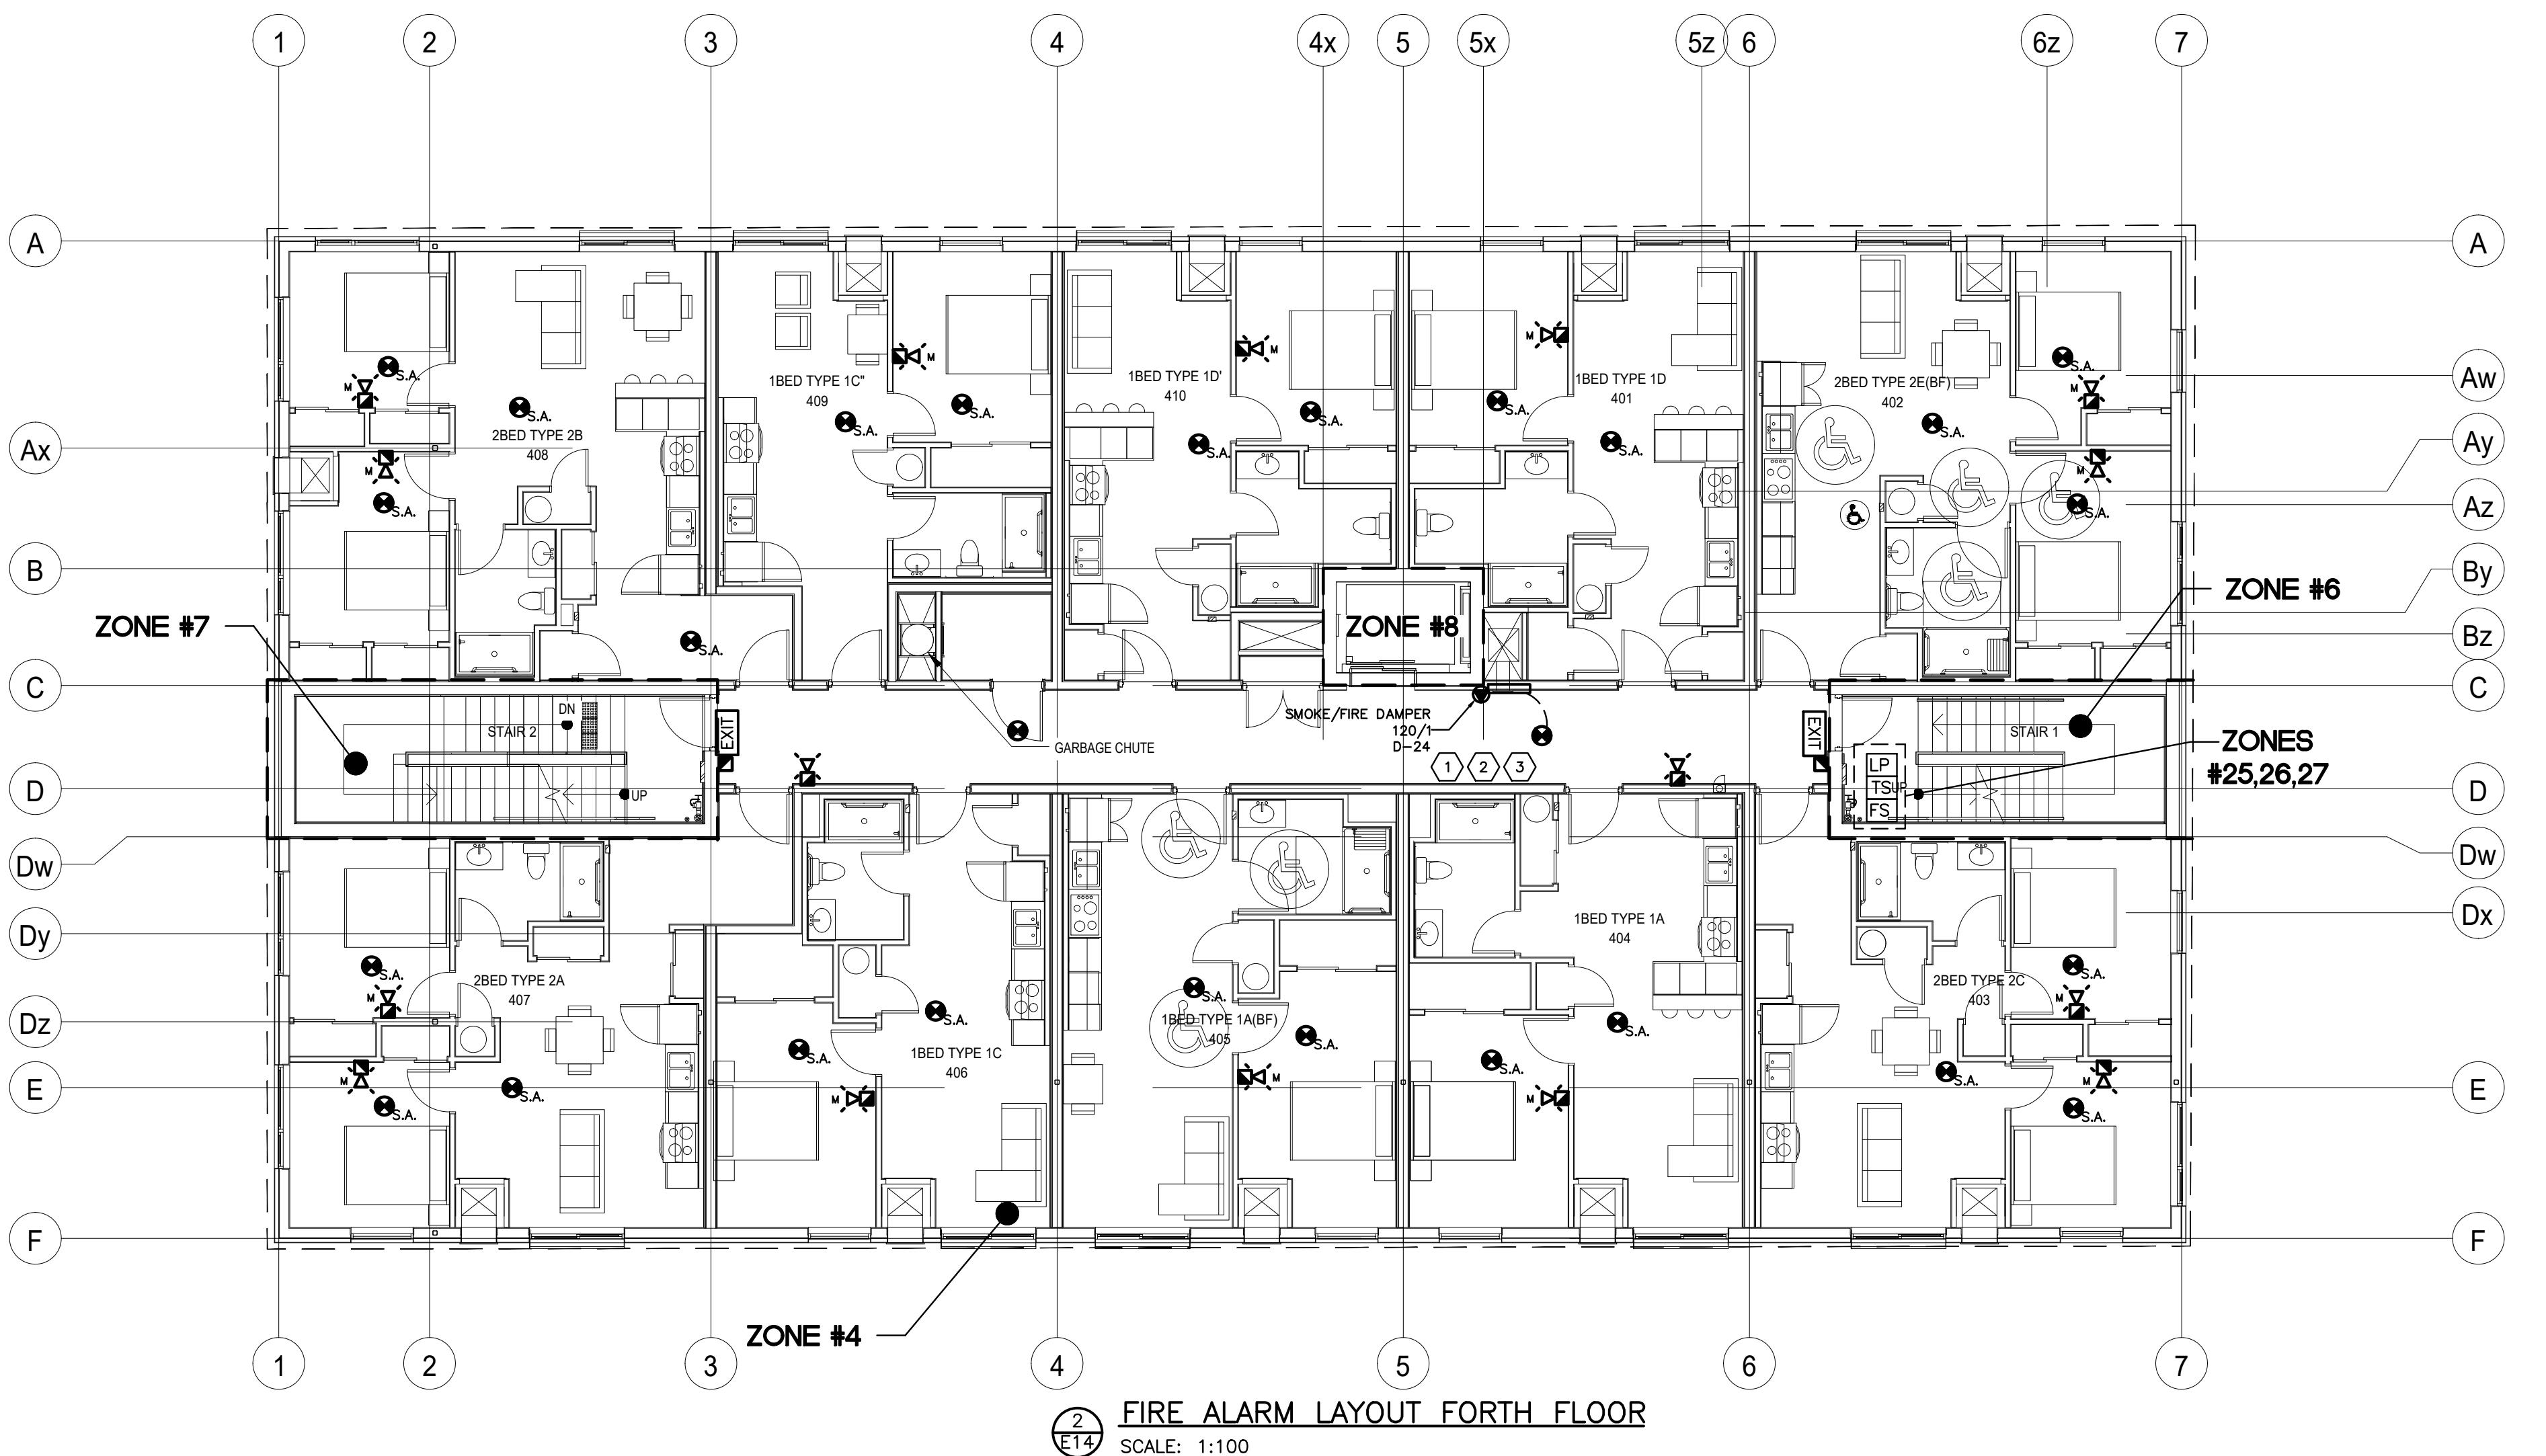
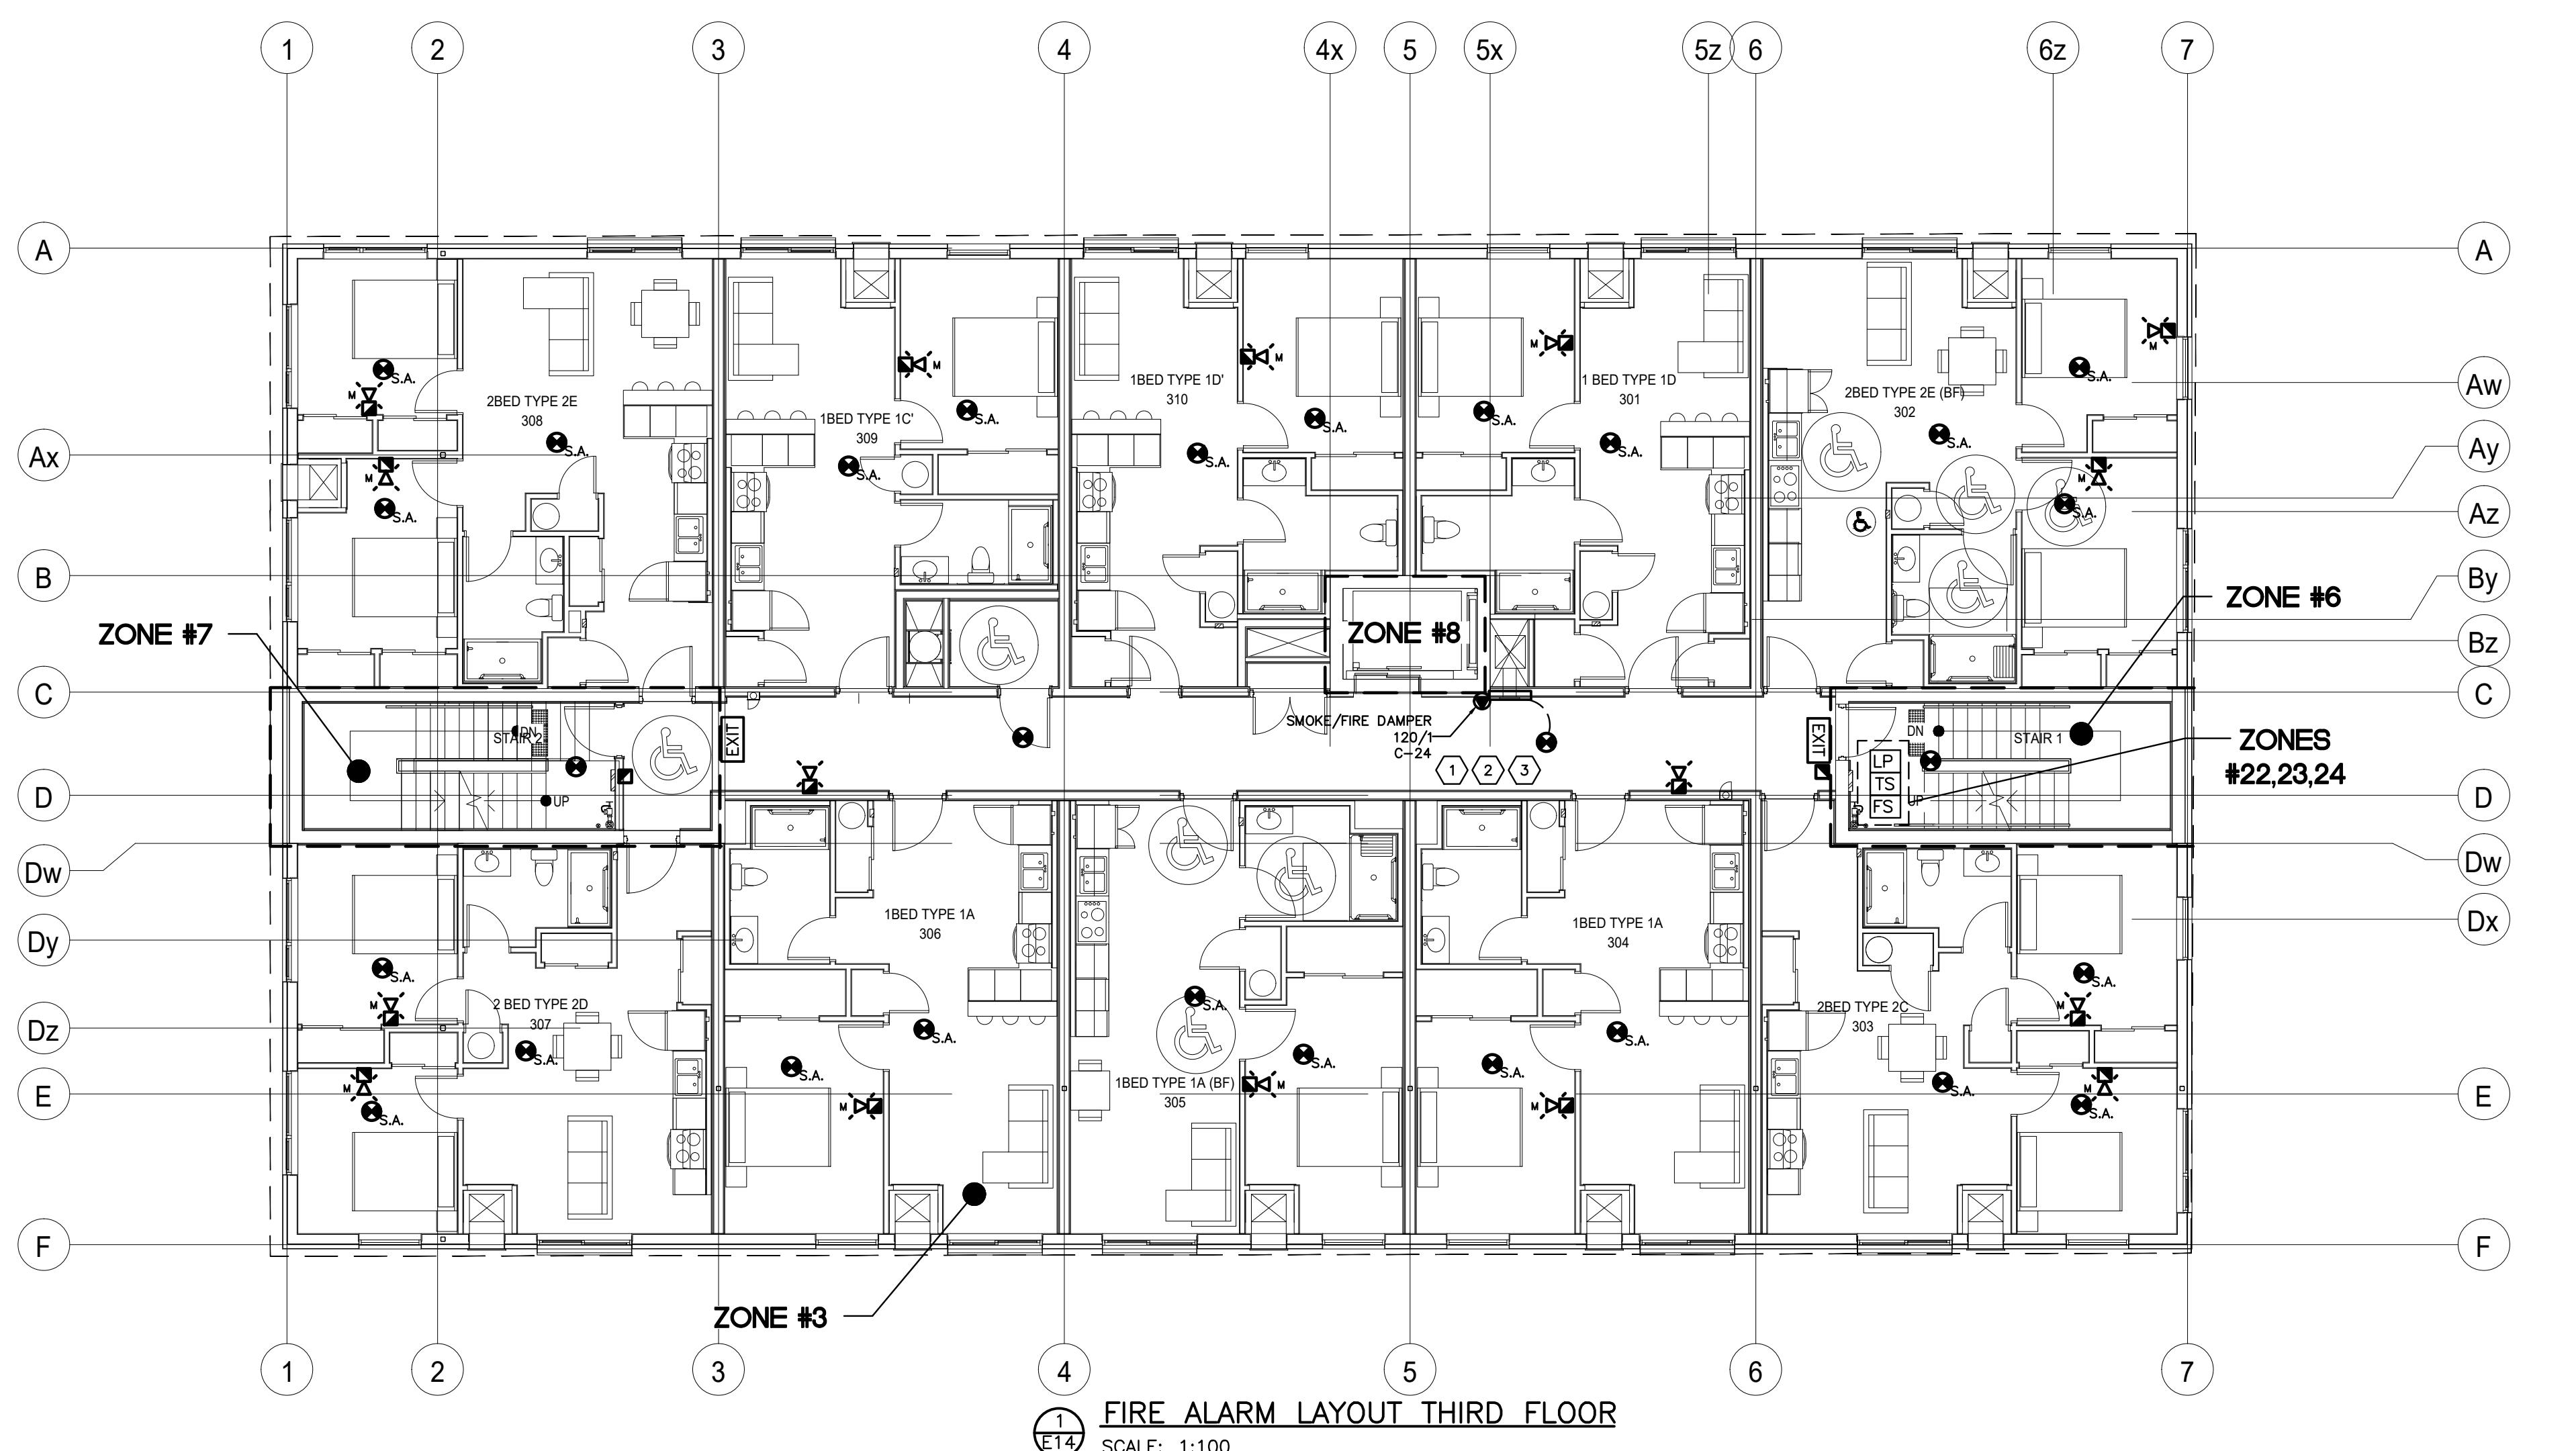
DESIGN	MJM	SCALE AS NOTED
DRAWN	AJM	DWG NO.
CHECKED	MJM	
APPROVED	MJM	
PROJECT	E12	7393

**E12**

CADD FILE NO. 7393E12



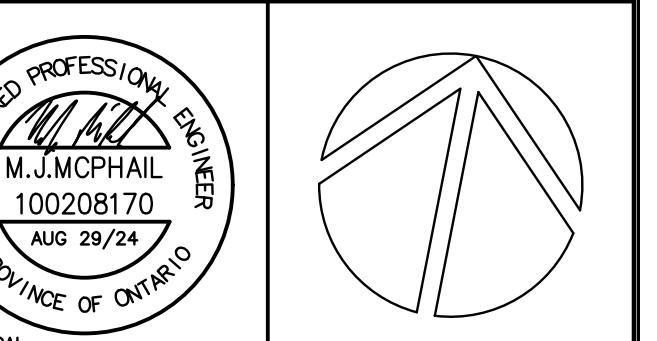
FIRE ALARM LEGEND	
<input checked="" type="checkbox"/>	FIRE ALARM HORN
<input checked="" type="checkbox"/>	FIRE ALARM HORN/STROBE
<input checked="" type="checkbox"/>	FIRE ALARM MINI HORN WITH SILENCE SWITCH
<input checked="" type="checkbox"/>	FIRE ALARM STROBE
<input checked="" type="checkbox"/>	MANUAL PULL STATION
<input checked="" type="checkbox"/>	SMOKE DETECTOR
<input checked="" type="checkbox"/>	120V SMOKE ALARM
<input checked="" type="checkbox"/>	120V CARBON MONOXIDE ALARM
<input checked="" type="checkbox"/>	DUCT TYPE SMOKE DETECTOR
<input checked="" type="checkbox"/>	SPRINKLER FLOW SWITCH
<input checked="" type="checkbox"/>	SPRINKLER TAMPER SWITCH
<input checked="" type="checkbox"/>	SPRINKLER LOW PRESSURE
<input checked="" type="checkbox"/>	FIRE ALARM CONTROL PANEL
<input checked="" type="checkbox"/>	FIRE ALARM ANNUNCIATOR PANEL
<input checked="" type="checkbox"/>	ADRESSABLE MODULE



- NOTES:**
- ① PROVIDE 120V POWER TO COMBINATION FIRE/SMOKE DAMPER. PROVIDE EACH DAMPER WITH A CONTACTOR FOR CONTROL BY THE FIRE ALARM SYSTEM.
  - ② EACH COMBINATION FIRE/SMOKE DAMPER IS TO HAVE A SMOKE DETECTOR WITHIN 1.5m OF THE. UPON ACTIVATION OF THE SMOKE DETECTOR A FIRE ALARM RELAY MODULE SHALL OPEN THE ASSOCIATED DAMPER CONTACTOR TO CAUSE THE DAMPER TO CLOSE.
  - ③ IF ANY COMBINATION FIRE/SMOKE DAMPER CLOSES THE FIRE ALARM SYSTEM SHALL ALSO SHUT DOWN THE ROOFTOP MUA UNIT.
  - ④ EXIT SIGNS ARE TO BE SUPPLIED FROM DEDICATED CIRCUIT FROM HOUSE PANEL ON THAT FLOOR. REFER TO PANEL SCHEDULE FOR CIRCUITING.
  - ⑤ EMERGENCY LIGHTING SUPPLIED BY LED GENERAL LIGHTING FIXTURES WITH INTEGRAL BATTERY BACKUP. REFER TO LIGHTING DRAWINGS FOR MORE DETAILS.

0	ISSUED FOR TENDER	2024.08.29	MJM
NO.	DESCRIPTION	DATE	BY
REVISIONS			

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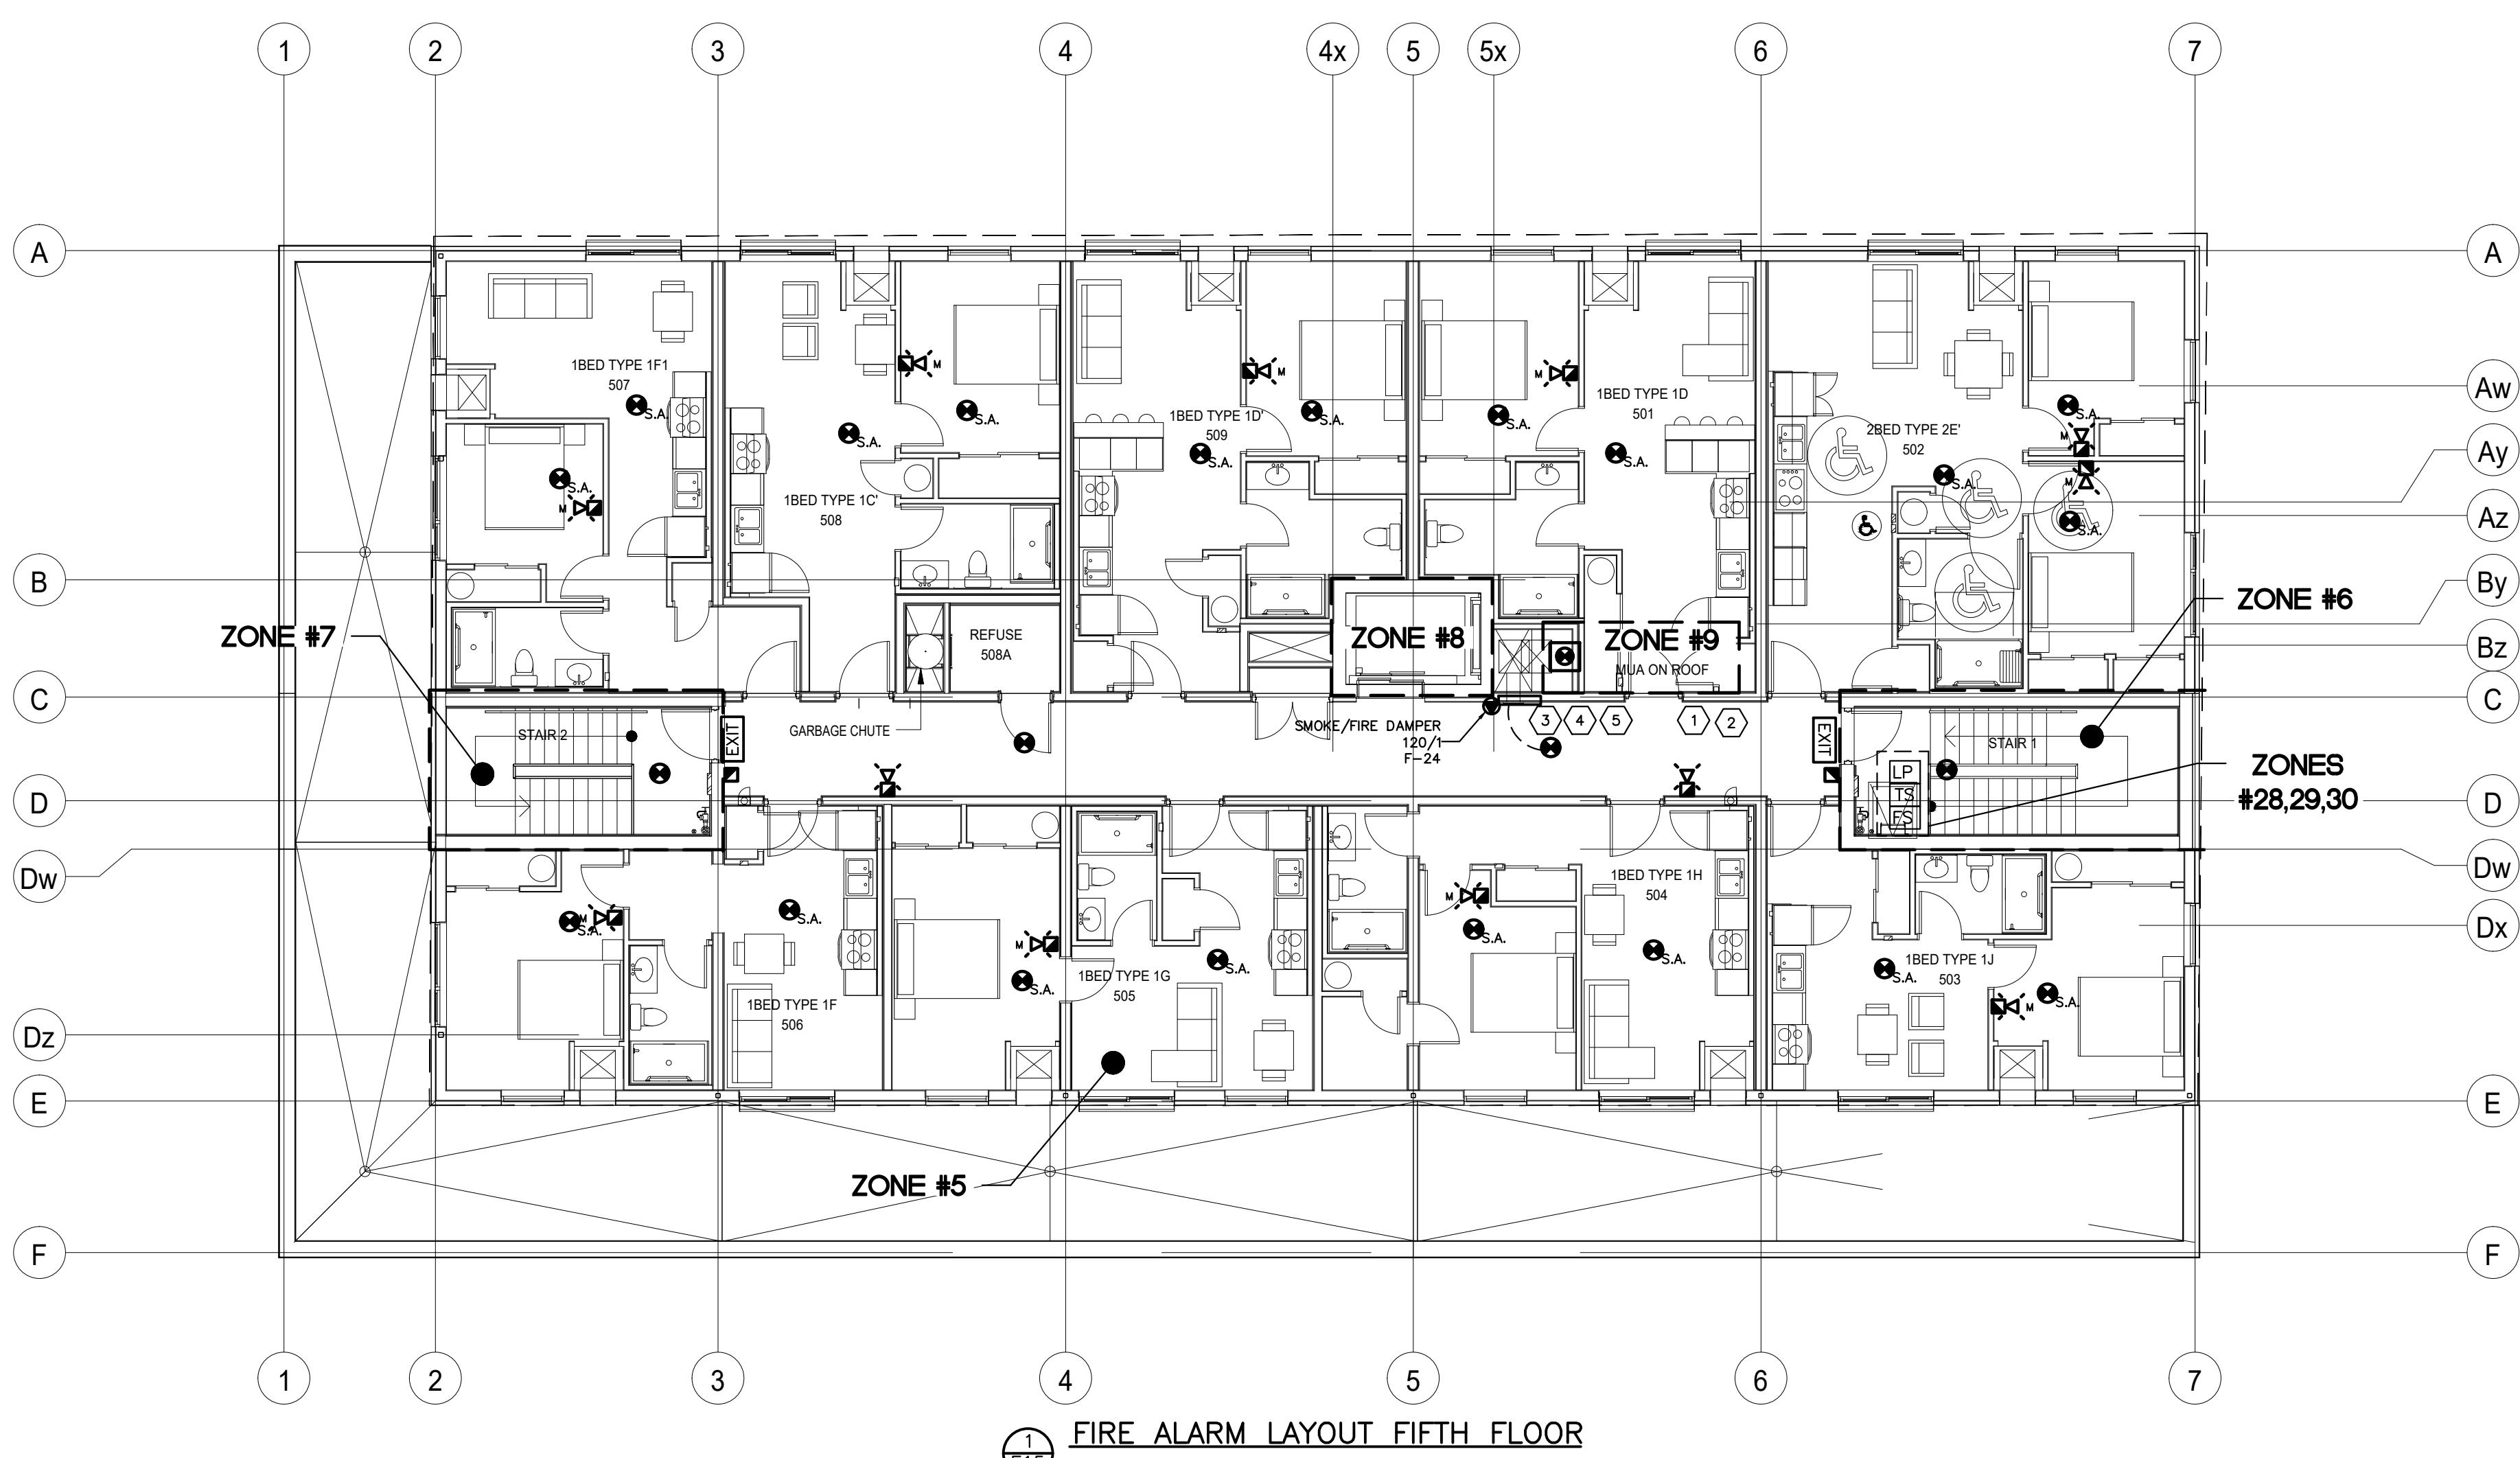
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**KIRKLAND ENGINEERING LTD.**

PROJECT  
**COURTICE SENIOR DEVELOPMENT**  
1697 HIGHWAY No 2  
CLARINGTON, ON

TITLE  
**THIRD AND FORTH FLOOR FIRE ALARM**  
DESIGN MJM SCALE AS NOTED  
DRAWN AJM DWG NO.  
CHECKED MJM  
APPROVED MJM  
PROJECT 7393  
E14  
CADD FILE NO. 7393E14

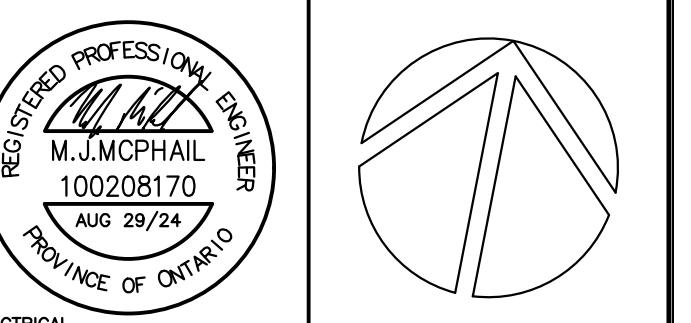


FIRE ALARM LAYOUT FIFTH FLOOR  
E15

SCALE: 1:100

- NOTES:**
- ① PROVIDE AND INSTALL A DUCT TYPE SMOKE DETECTOR IN THE SUPPLY OF MUA-1 AND PROVIDE AN ADDRESSABLE MODULE FOR CONNECTION TO THE FIRE ALARM PANEL.
  - ② ROOFTOP MUA-1 TO BE SHUT DOWN ON SIGNAL FROM FIRE ALARM CONTROL PANEL IF DUCT TYPE SMOKE DETECTOR ACTIVATES OR IF ANY OF THE COMBINATION FIRE/SMOKE DAMPERS ARE TRIGGERED TO CLOSE.
  - ③ PROVIDE 120V POWER TO COMBINATION FIRE/SMOKE DAMPER. PROVIDE EACH DAMPER WITH A CONTACTOR FOR CONTROL BY THE FIRE ALARM SYSTEM.
  - ④ EACH COMBINATION FIRE/SMOKE DAMPER IS TO HAVE A SMOKE DETECTOR WITHIN 1.5m OF THE. UPON ACTIVATION OF THE SMOKE DETECTOR A FIRE ALARM RELAY MODULE SHALL OPEN THE ASSOCIATED DAMPER CONTACTOR TO CAUSE THE DAMPER TO CLOSE.
  - ⑤ IF ANY COMBINATION FIRE/SMOKE DAMPER CLOSES THE FIRE ALARM SYSTEM SHALL ALSO SHUT DOWN THE ROOFTOP MUA UNIT.
  - ⑥ EXIT SIGNS ARE TO BE SUPPLIED FROM DEDICATED CIRCUIT FROM HOUSE PANEL ON THAT FLOOR. REFER TO PANEL SCHEDULE FOR CIRCUITING.
  - ⑦ EMERGENCY LIGHTING SUPPLIED BY LED GENERAL LIGHTING FIXTURES WITH INTEGRAL BATTERY BACKUP. REFER TO LIGHTING DRAWINGS FOR MORE DETAILS.

0	ISSUED FOR TENDER	2024.08.29	MJM
NO.	DESCRIPTION	DATE	BY
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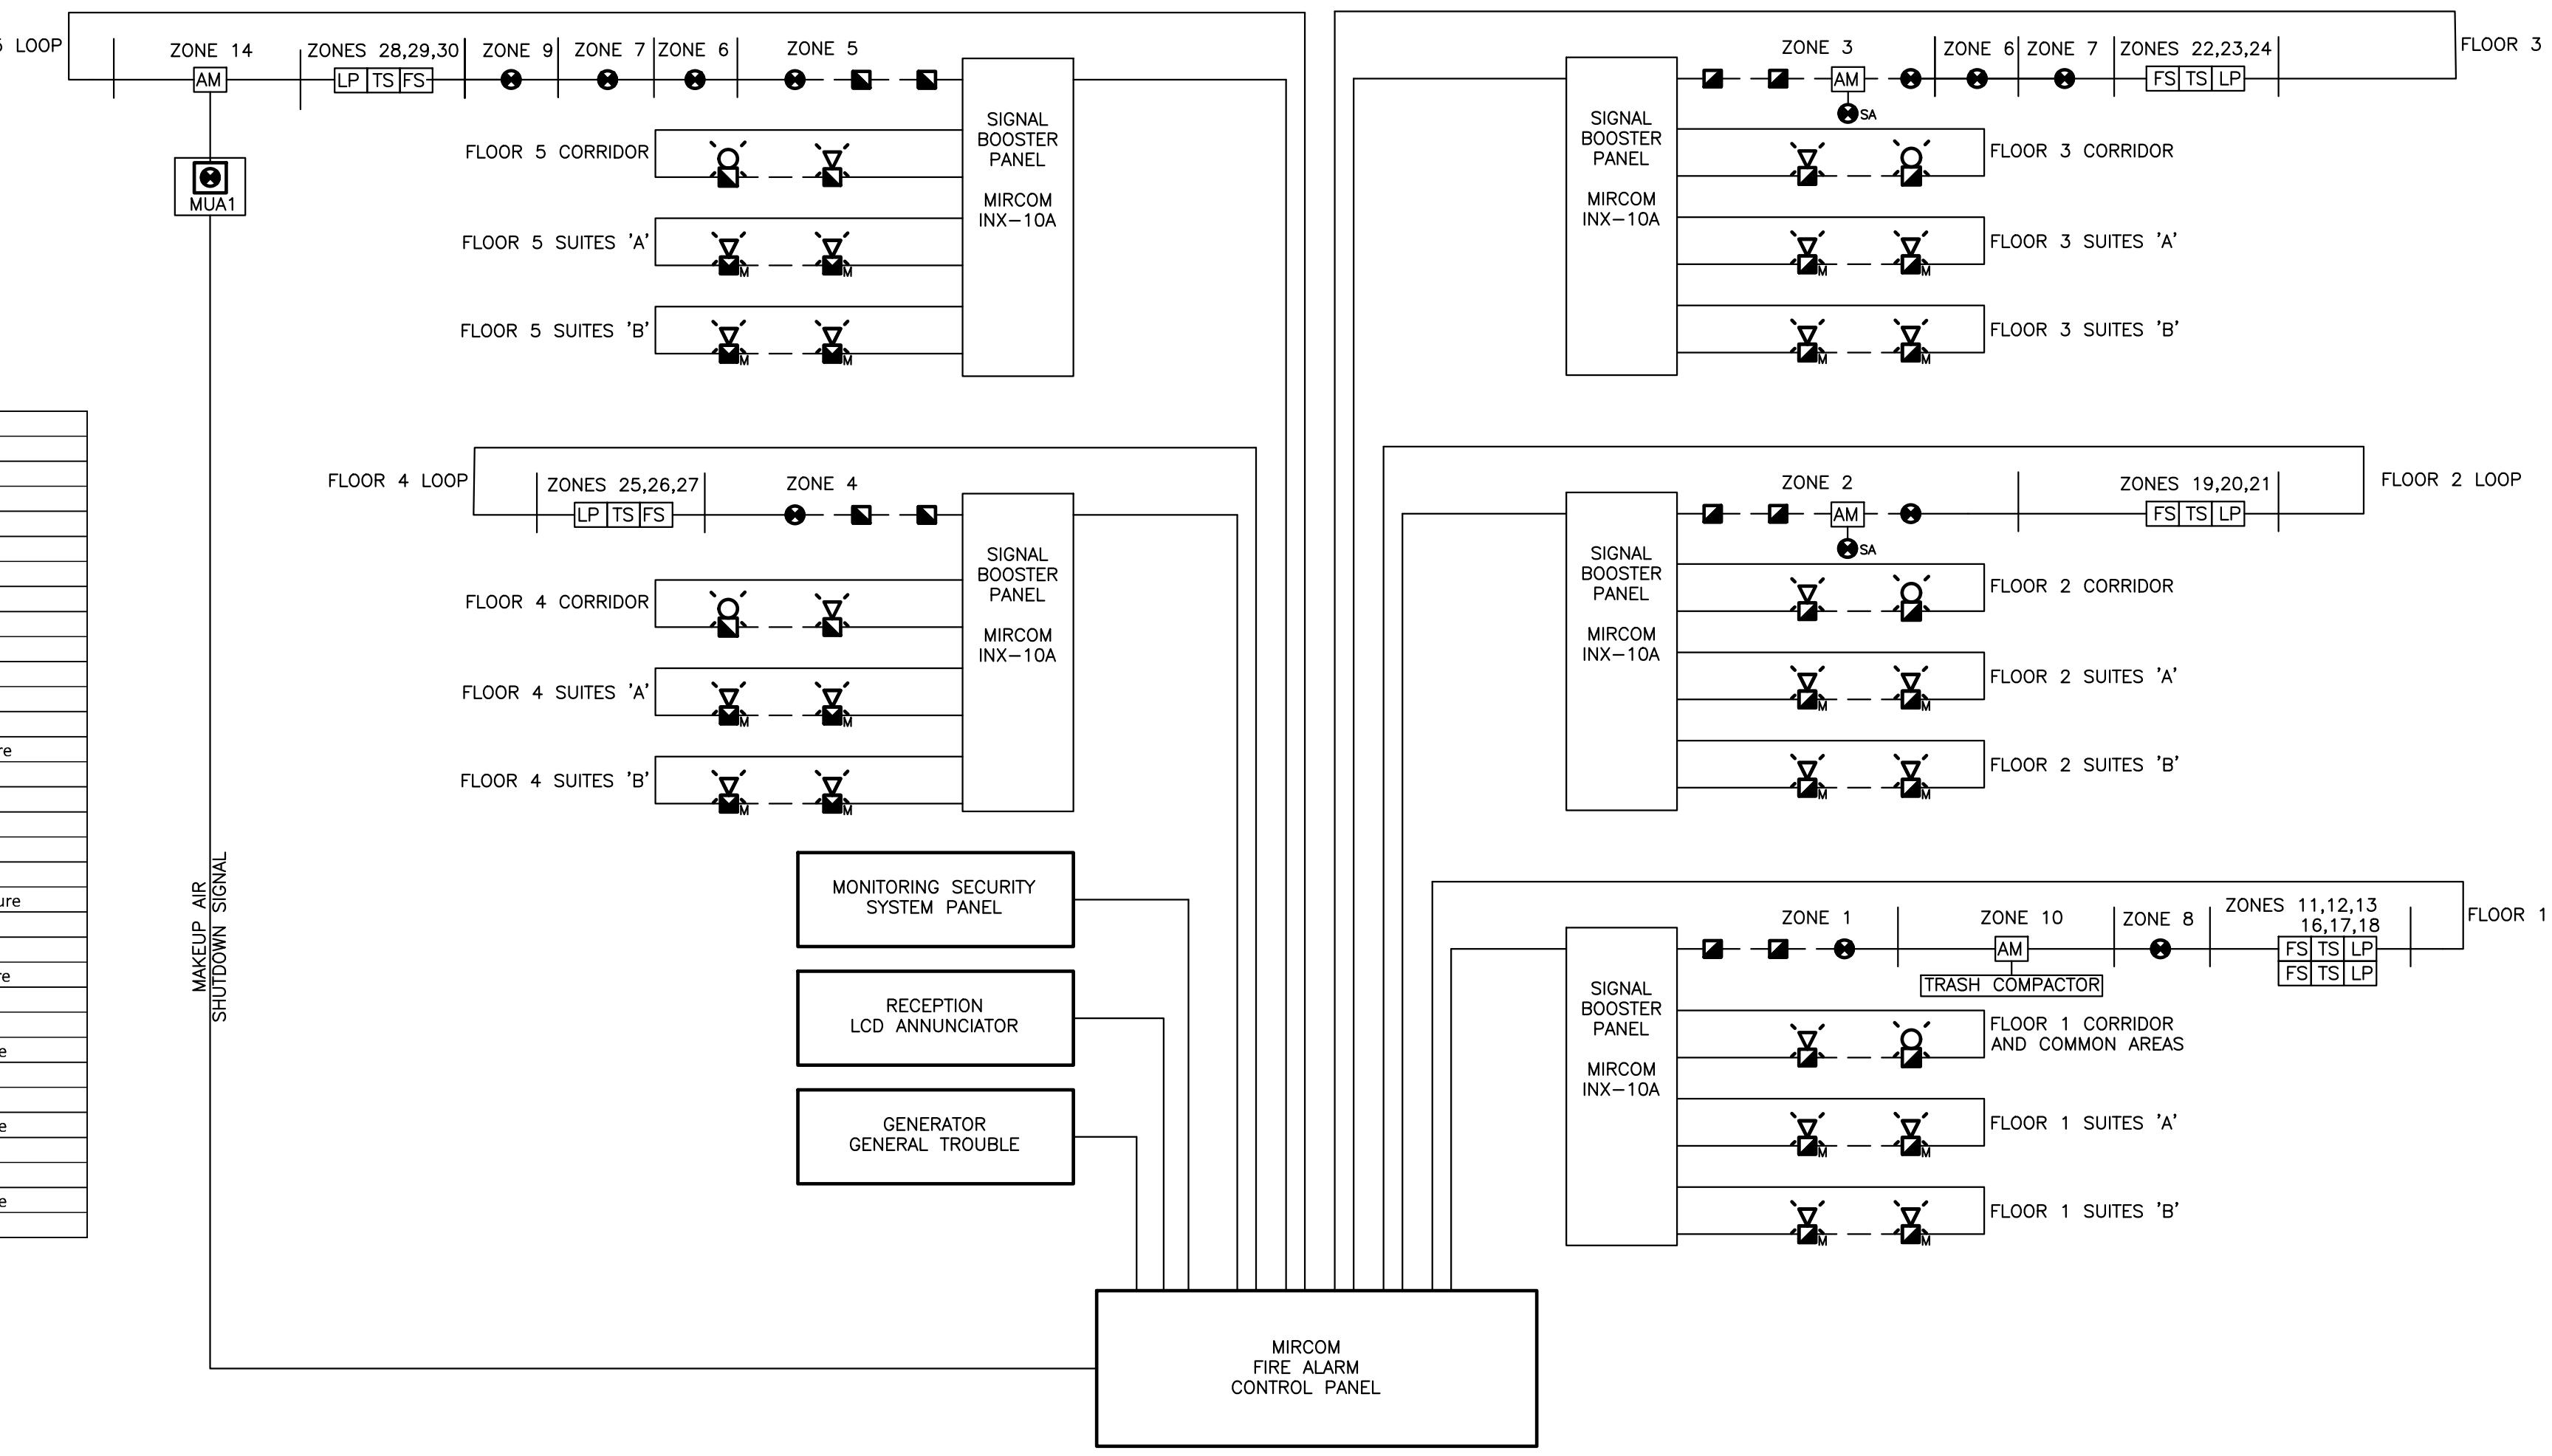
PROJECT  
**COURTICE SENIOR DEVELOPMENT**

1697 HIGHWAY No 2  
CLARINGTON, ON

TITLE  
**FIFTH FLOOR FIRE ALARM**

DESIGN	MJM	SCALE AS NOTED
DRAWN	AJM	DWG NO.
CHECKED	MJM	
APPROVED	MJM	
PROJECT	E15	7393

FIRE ALARM LEGEND		
<b>ARM ZONE SCHEDULE</b>		
Zone	Type	Description
1	ALARM	Main Floor
2	ALARM	2nd Floor
3	ALARM	3rd Floor
4	ALARM	4th Floor
5	ALARM	5th Floor
6	ALARM	Stair 1
7	ALARM	Stair 2
8	ALARM	Elevator
9	ALARM	Rooftop MUA
10	ALARM	Sprinkler Master Flow
11	TROUBLE	Sprinkler Master Tamper
12	TROUBLE	Sprinkler Master Low Pressure
13	ALARM	Garbage Chute Flow
14	TROUBLE	Garbage Chute Tamper
15	TROUBLE	Garbage Chute Low Pressure
16	ALARM	Sprinkler Main Flr Flow
17	TROUBLE	Sprinkler Main Flr Tamper
18	TROUBLE	Sprinkler Main Flr Low Pressure
19	ALARM	Sprinkler 2nd Flr Flow
20	TROUBLE	Sprinkler 2nd Flr Tamper
21	TROUBLE	Sprinkler 2nd Flr Low Pressure
22	ALARM	Sprinkler 3rd Flr Flow
23	TROUBLE	Sprinkler 3rd Flr Tamper
24	TROUBLE	Sprinkler 3rd Flr Low Pressure
25	ALARM	Sprinkler 4th Flr Flow
26	TROUBLE	Sprinkler 4th Flr Tamper
27	TROUBLE	Sprinkler 4th Flr Low Pressure
28	ALARM	Sprinkler 5th Flr Flow
29	TROUBLE	Sprinkler 5th Flr Tamper
30	TROUBLE	Sprinkler 5th Flr Low Pressure
31	TROUBLE	Generator General Trouble
<b>AM</b> ADDRESSABLE MODULE		



FIRE ALARM RISER  
E15

SCALE: N.T.S.

**E15**

CADD FILE NO. 7393E15

ELECTRICAL SYMBOLS LEGEND	
	DUPLEX RECEPTACLE
.	COUNTER MOUNT
	GFI DUPLEX RECEPTACLE
	STOVE RECEPTACLE
	SPLIT DUPLEX RECEPTACLE
	DIRECT CONNECTION
	DISCONNECT SWITCH
	DRYER RECEPTACLE
	DATA
	PANEL BOARD
WP	WEATHER PROOF
	20A T-SLOT RECEPTACLE

FIRE ALARM LEGEND	
	FIRE ALARM HORN
	FIRE ALARM HORN/STROBE
	IN SUITE MINI HORN/STROBE
	FIRE ALARM STROBE
	MANUAL PULL STATION
	SMOKE DETECTOR
	120V SMOKE ALARM
	120V CARBON MONOXIDE ALARM
	SPRINKLER FLOW SWITCH
	SPRINKLER TAMPER SWITCH
	SPRINKLER LOW PRESSURE
	FIRE ALARM CONTROL PANEL
	FIRE ALARM ANNUNCIATOR PANEL
	ADDRESSABLE MODULE

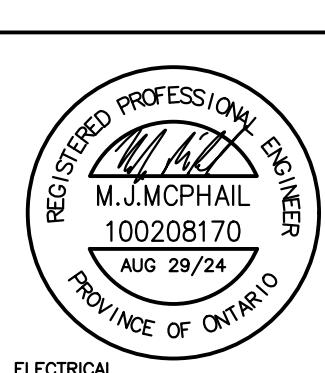
INTERIOR LIGHTING SCHEDULE			
SYMBOL	DESCRIPTION	MANUFACTURER	MODEL No.
O_A	12" LED SURFACE MOUNT FIXTURE, 0-10V DIMMING, 120V, 24W, 3000K COLOUR TEMP, 80+ CRI, 1787 LUMENS	EGLO	205989A TRAGO 5
H_B	2' LED SURFACE MOUNT UNDER CABINET FIXTURE, 120V, 26W, 3500K COLOUR TEMP, 80 CRI, 1600 LUMENS, WHITE FINISH	VISCOR	LTL24-LED835K016LUNV-F06
H_C	4' LED SURFACE MOUNT UNDER CABINET FIXTURE, 120V, 26W, 3500K COLOUR TEMP, 80 CRI, 3000 LUMENS, WHITE FINISH	VISCOR	LTL48-LED835K030LUNV-F06
V_V_F	LED BATHROOM VANITY, 0-10V DIMMING, 120V, 17.5W MAX WATTAGE, 3000K COLOUR TEMP, 1760 LUMENS	EGLO	205068A TORRETTA
G	2'X4' LED FLAT PANEL TROFFER, 4640 LUMENS, 35 WATTS, 80+ CRI, 4000K COLOUR TEMPERATURE, 120V, WHITE, 0-10V DIMMING	C-LITE	C-TR-D-FP24-S58L-SCCT-UL-WH-2
GEL	2'X4' LED FLAT PANEL TROFFER, 4640 LUMENS, 35 WATTS, 80+ CRI, 4000K COLOUR TEMPERATURE, 120V, WHITE, 0-10V DIMMING C/W INTEGRATED EMERGENCY BATTERY BACKUP	C-LITE	C-TR-D-FP24-S58L-SCCT-UL-WH-EB
H	2'X2' LED FLAT PANEL TROFFER, APPROX 4150 LUMENS, 30 WATTS, 3500K COLOUR TEMPERATURE, 120V, WHITE, COMPLETE WITH INTEGRATED EMERGENCY BATTERY BACKUP	C-LITE	IC-TR-D-FP22-S37L-SCCT-UL-WH-2
HEL	2'X2' LED FLAT PANEL TROFFER, APPROX 4150 LUMENS, 30 WATTS, 3500K COLOUR TEMPERATURE, 120V, WHITE, COMPLETE WITH INTEGRATED EMERGENCY BATTERY BACKUP	C-LITE	IC-TR-D-FP22-S37L-SCCT-UL-WH-EB
J	48" LED STRIP LUMINAIRE, 80+ CRI, 0-10V DIMMING, 4000K COLOUR TEMP, 4400 LUMENS, 120V, 29 INPUT WATTS, ROUND FROSTED EXTRUDED ACRYLIC LENS	VISCOR	LCOM48-LEED840K044LUNV-P77
JEL	48" LED STRIP LUMINAIRE, 80+ CRI, 0-10V DIMMING, 4000K COLOUR TEMP, 4400 LUMENS, 120V, 29 INPUT WATTS, ROUND FROSTED EXTRUDED ACRYLIC LENS C/W INTEGRATED EMERGENCY BATTERY BACKUP.	VISCOR	LCOM48-LEED840K044LUNV-B39-P77
S	48" LED STAIRWELL SURFACE FIXTURE, 80+ CRI, WITH INTEGRAL OCCUPANCY SENSOR AND STEP DIMMING (50%,100%), 4000K COLOUR TEMP, 4600 LUMENS, 120V, 35 INPUT WATTS FROSTED EXTRUDED ACRYLIC LENS	C-LITE	C-SW-A-S66L-SCCT-US-UC-WH
HO_W	OUTDOOR WALL MOUNTED FIXTURE, 80 CRI, 3000K COLOUR TEMP, 1650 LUMENS, 120V, 12 INPUT WATTS	CREE OR APPROVED EQUAL	C-WP-C-RDC-S3L-SCCT-DB
\$	LIGHT SWITCH		
\$_3	3-WAY LIGHT SWITCH		
\$_D	DIMMER SWITCH 0-10V		
\$_3D	3-WAY SWITCH WITH DIMMING		
	OCCUPANCY SENSOR		

EMERGENCY LIGHTING & EXIT SCHEDULE			
SYMBOL	DESCRIPTION	MANUFACTURER	MODEL No.
	SELF POWERED RUNNING MAN EXIT SIGN, SINGLE OR DOUBLE FACE AS INDICATED, ARROWS AS INDICATED, LED LAMPS FOR 120VAC, CSA-C860-96 LISTED & CERTIFIED	LUMACELL OR APPROVED EQUAL	LA SERIES



0	ISSUED FOR TENDER	2024.08.29	MJM
NO.	DESCRIPTION	DATE	BY

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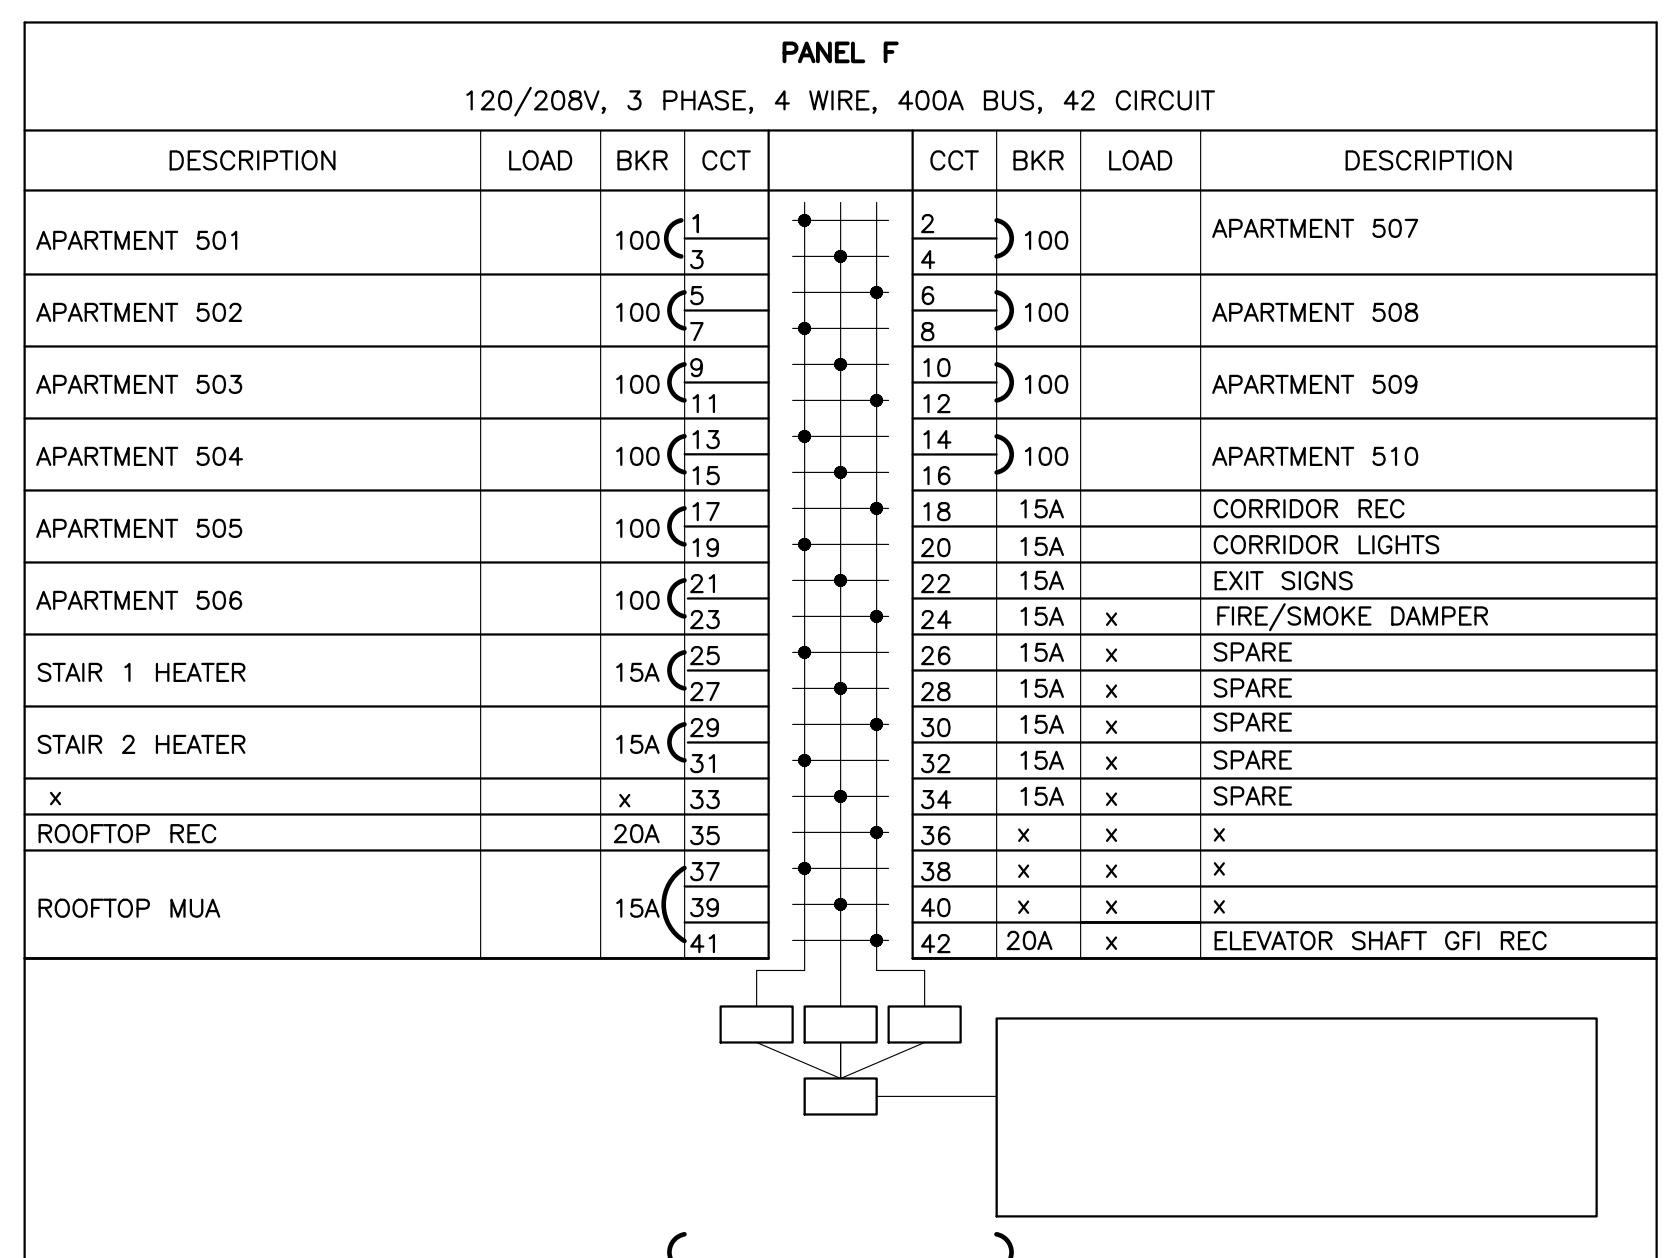
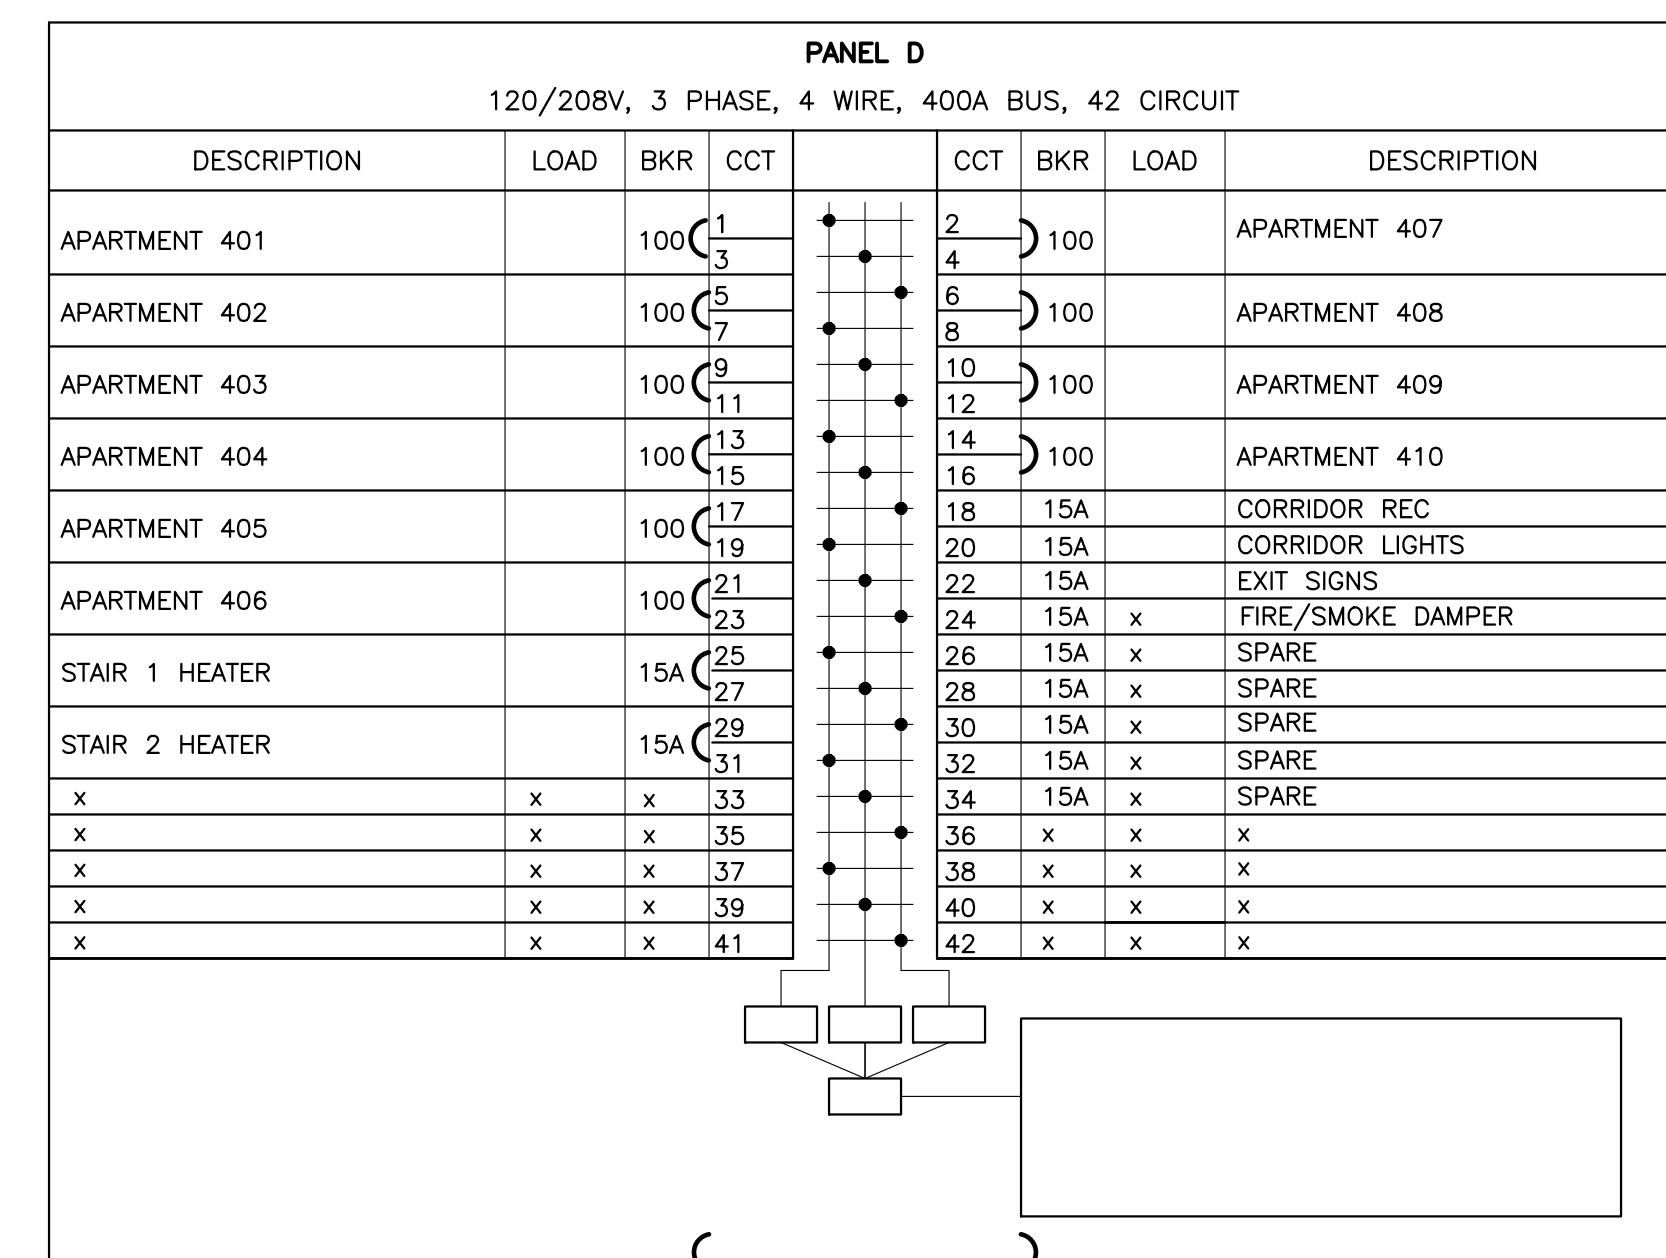
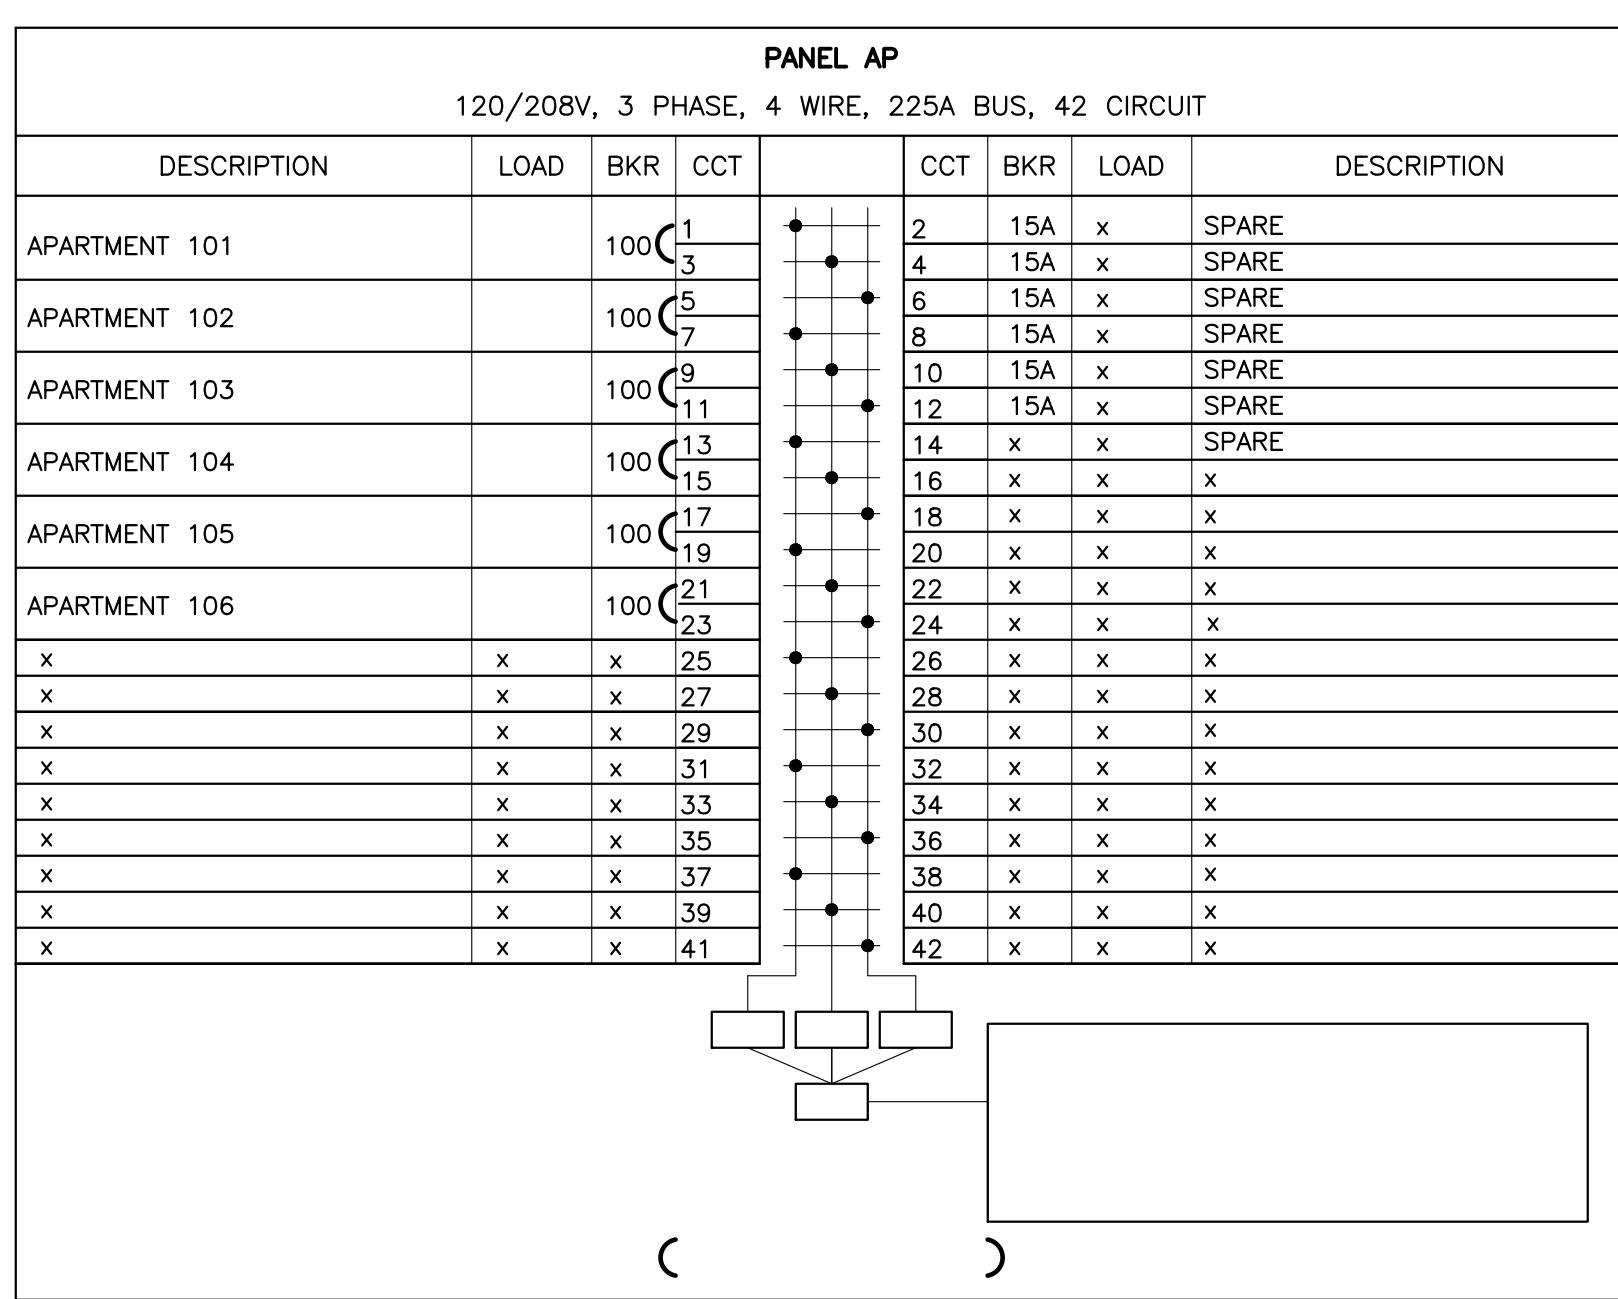
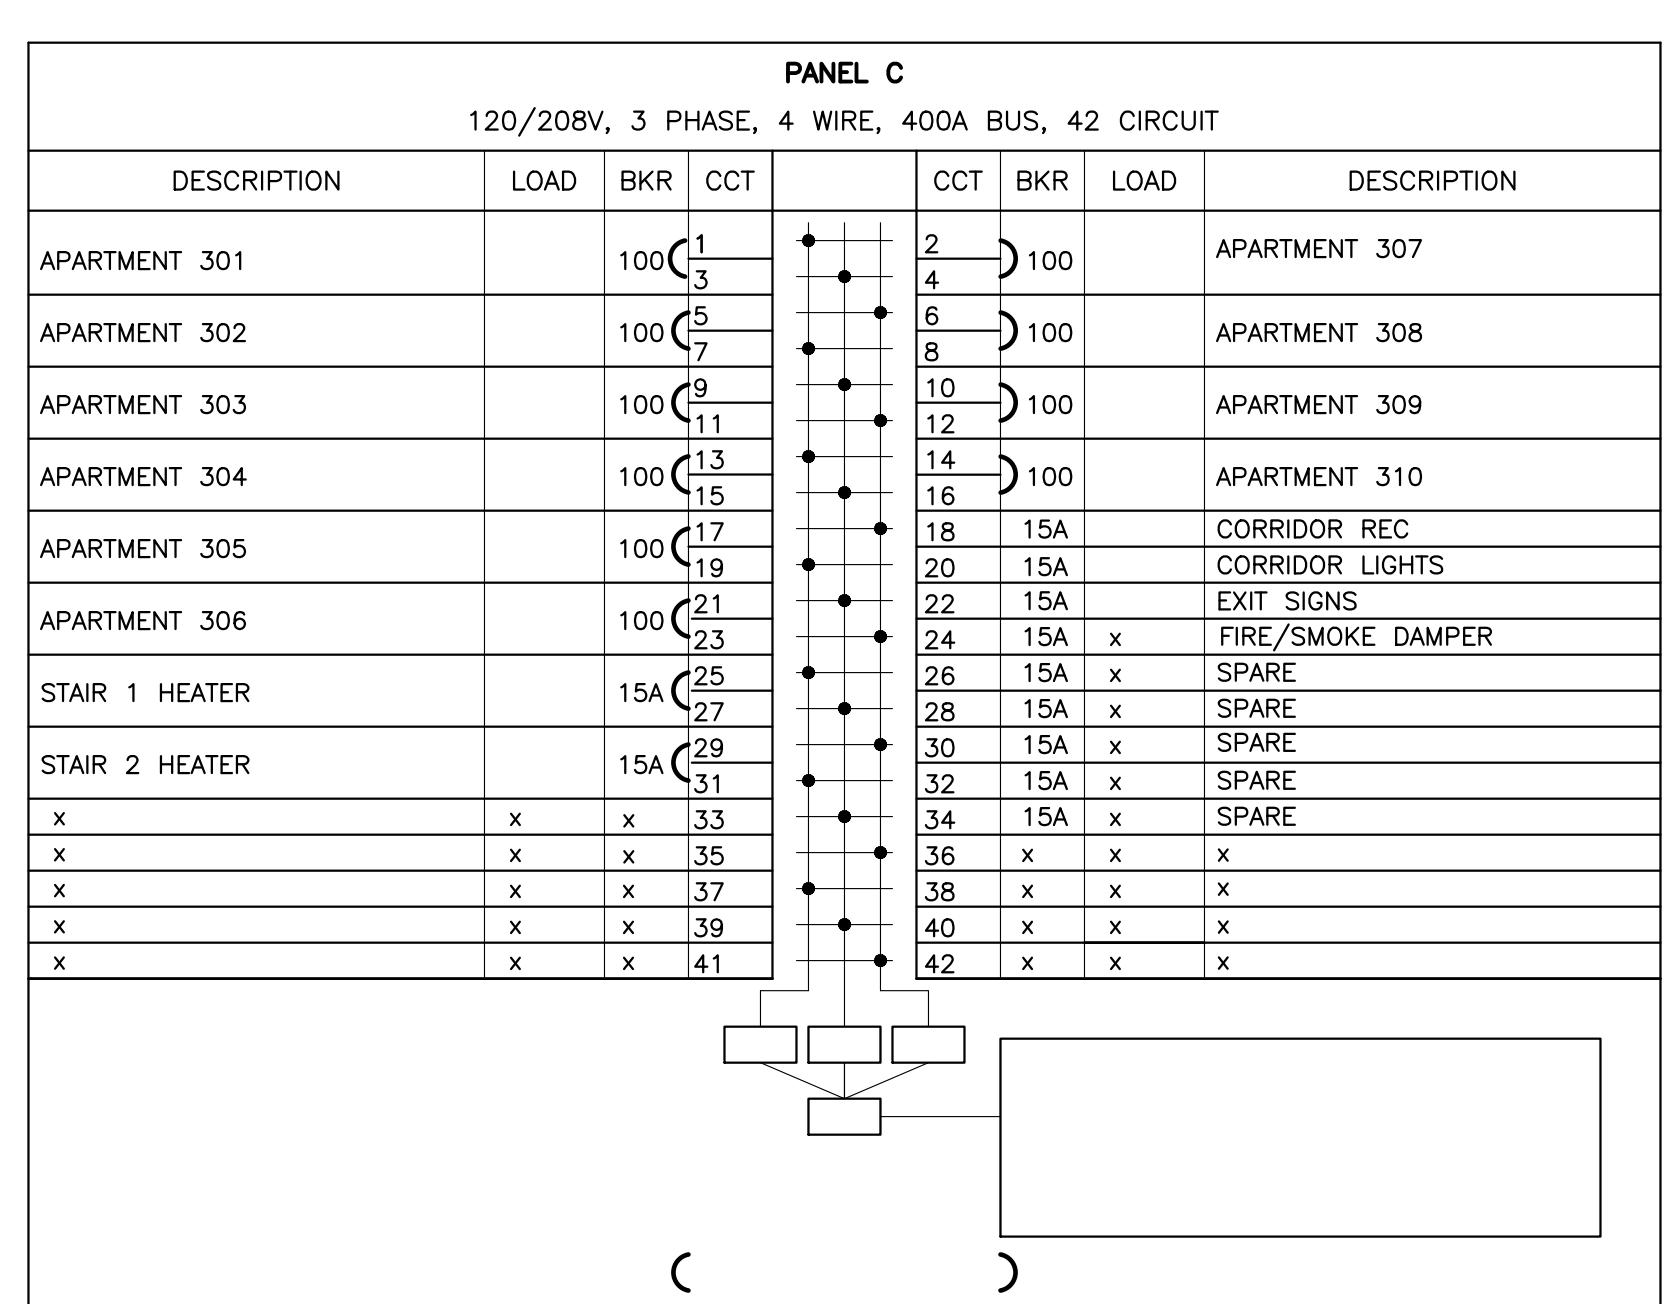
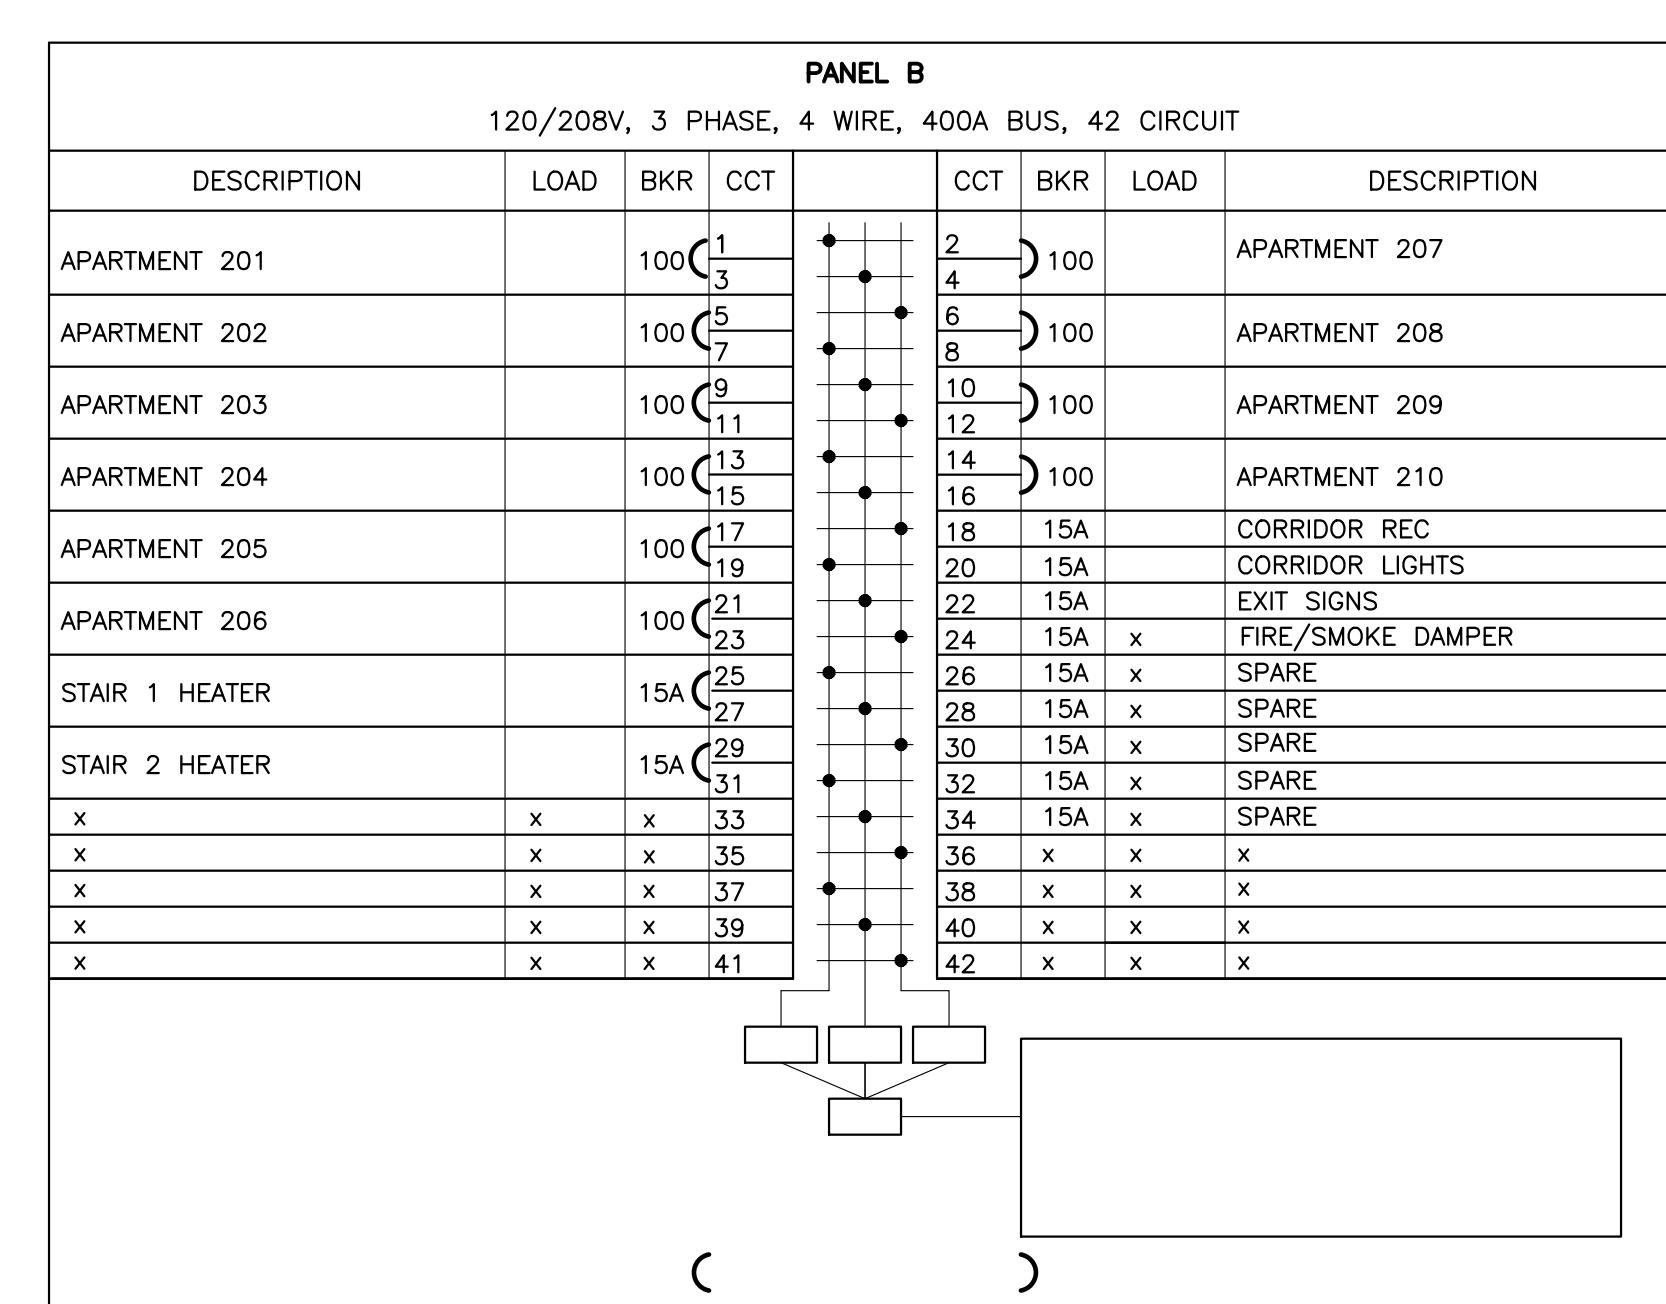
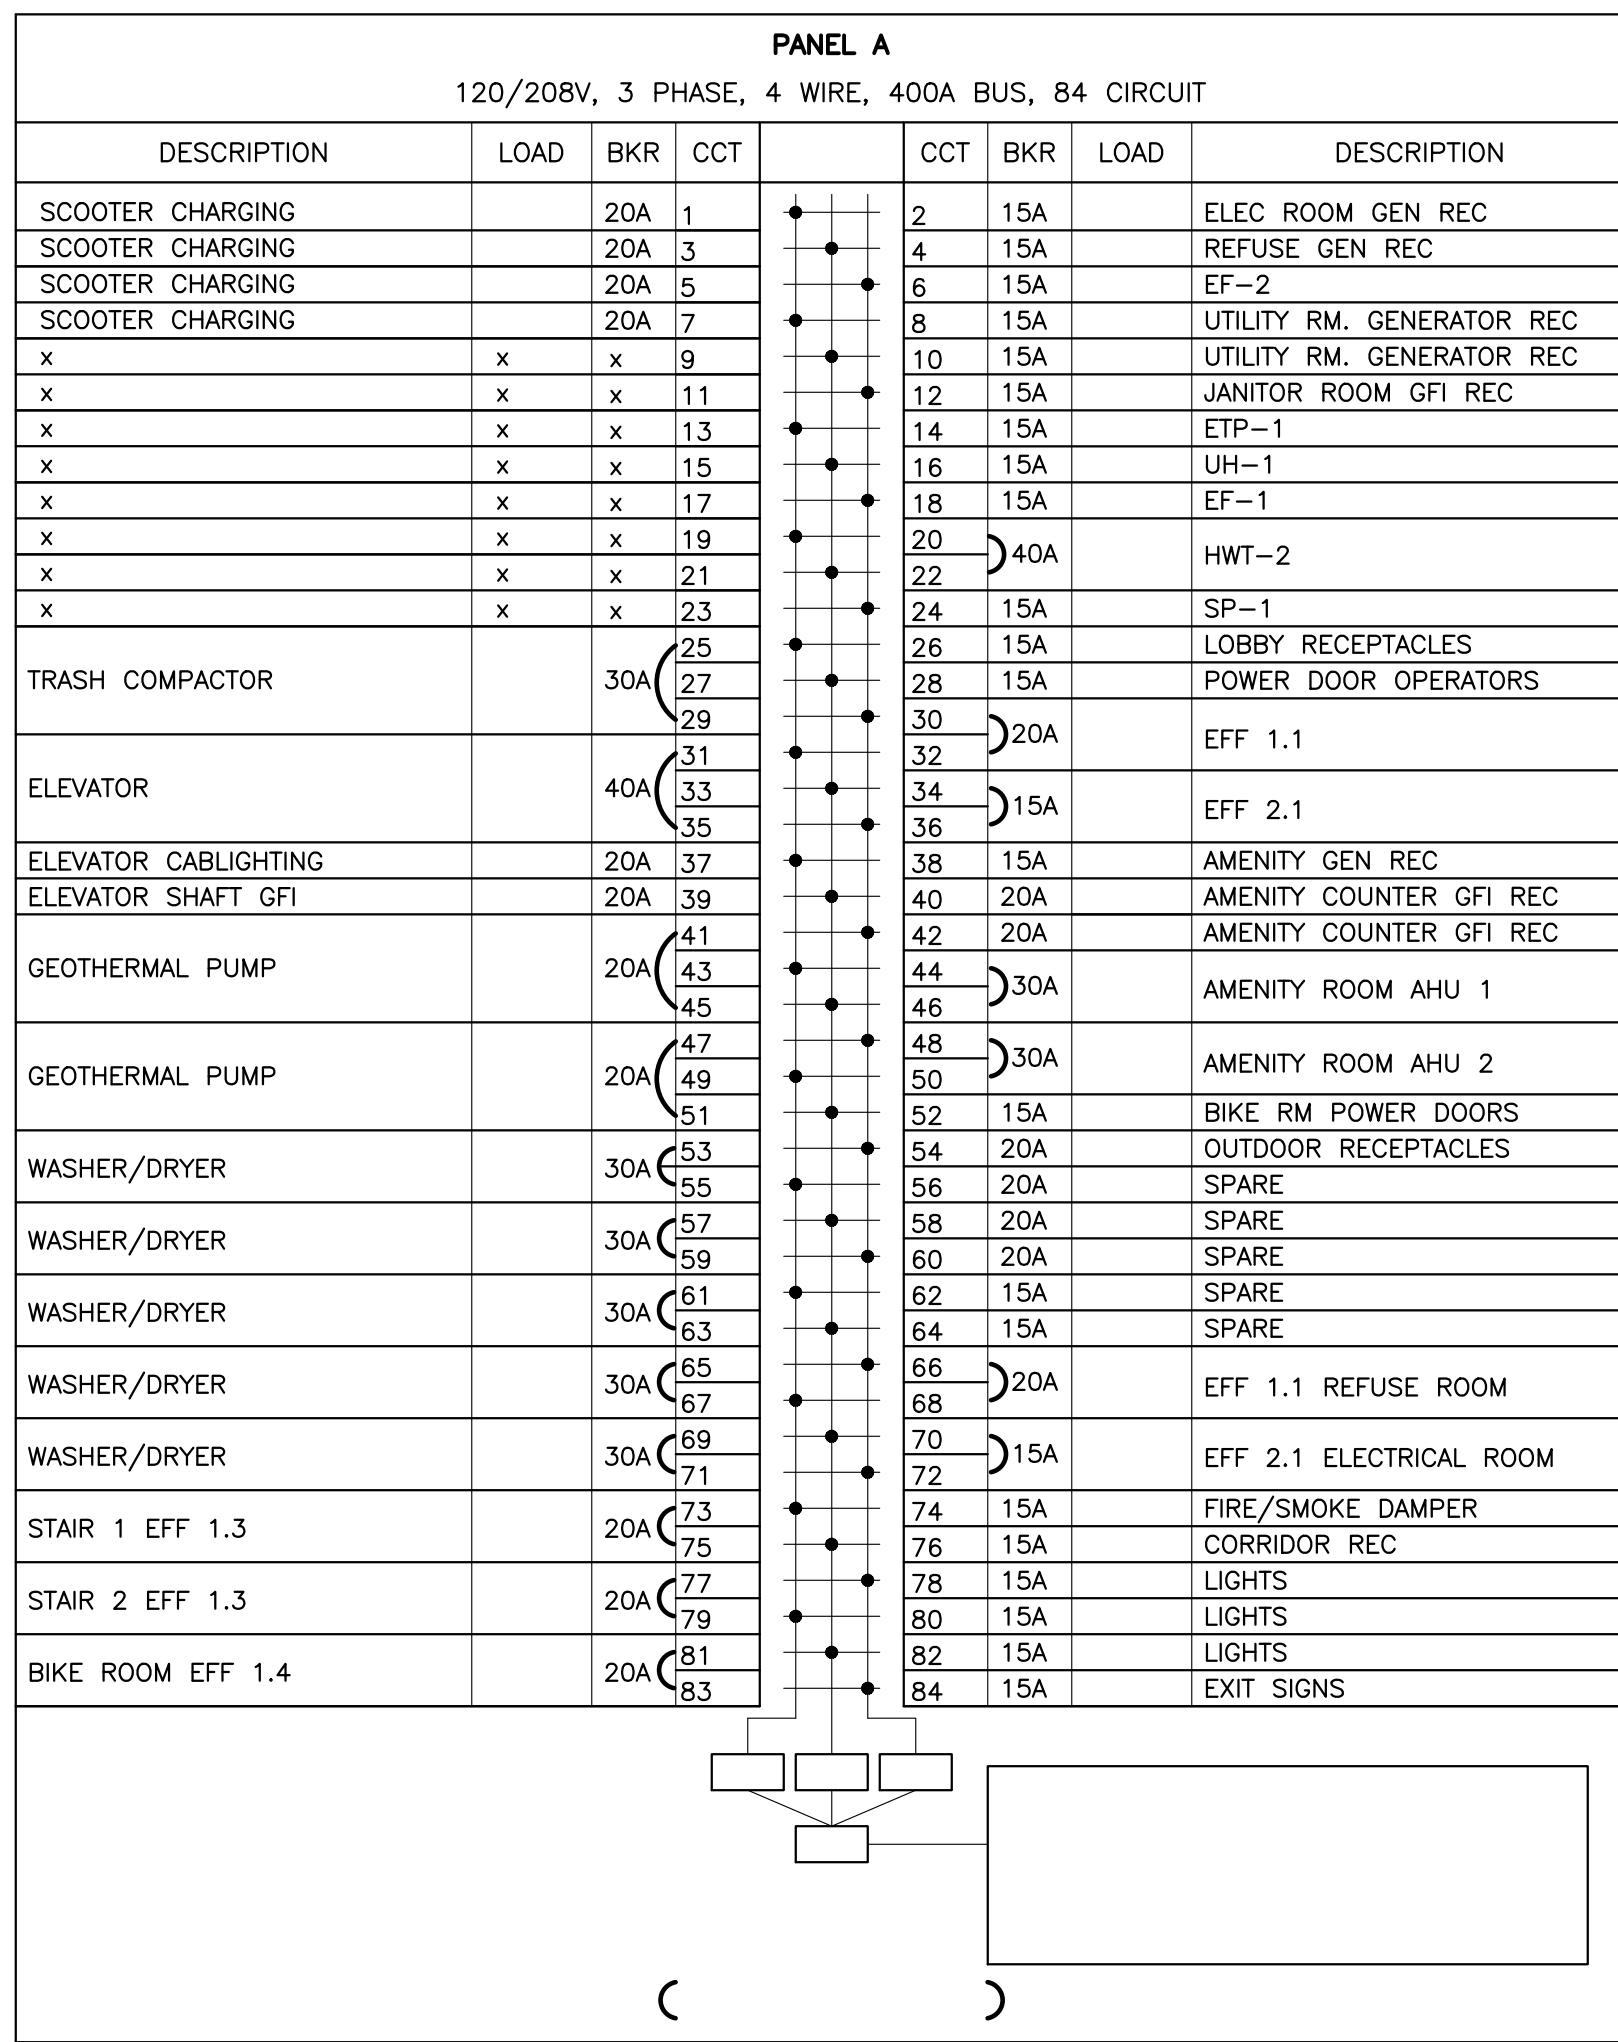
PROJECT  
COURTICE SENIOR DEVELOPMENT

1697 HIGHWAY NO 2  
CLARINGTON, ON

TITLE  
**LEGENDS**

DESIGN	MJM	SCALE N.T.S.
DRAWN	AJM	DWG NO.
CHECKED	MJM	
APPROVED	MJM	
PROJECT	E16	7393

CADD FILE NO. 7393E16



## ELECTRICAL SPECIFICATIONS

### 1 GENERAL CONDITIONS

DO ALL WORK IN ACCORDANCE WITH ONTARIO ELECTRICAL SAFETY CODE, CURRENT EDITION, BASED UPON THE CANADIAN ELECTRICAL CODE, PART I, CSA STANDARD C22.1, AND ALL BULLETINS TO DATE.  
THE QUALITY OF THE MATERIALS AND WORKMANSHIP SHALL BE ACCEPTABLE TO THE ARCHITECT, OWNER AND ENGINEER.

### 2 SCOPE OF WORK

PROVIDE ALL MATERIALS EQUIPMENT AND LABOUR TO PROVIDE A COMPLETE OPERATING INSTALLATION AS DESIGNATED IN THIS SPECIFICATION AND AS INDICATED ON THE DRAWINGS EXCEPT WHERE OTHERWISE NOTED.  
THE SCOPE OF WORK INCLUDES, BUT IS NOT LIMITED TO, SUPPLY AND INSTALLATION OF THE FOLLOWING ITEMS:

- .1 MAIN SERVICE
- .2 POWER DISTRIBUTION
- .3 INTERIOR LIGHTING AND CONTROLS
- .4 EMERGENCY LIGHTING AND EXIT SIGNAGE
- .5 FEEDERS AND OVER CURRENT PROTECTION FOR MECHANICAL EQUIPMENT
- .6 FIRE ALARM SYSTEM
- .7 BACKUP GENERATOR

### 3 INSURANCE

MAINTAIN INSURANCE TO FULLY PROTECT THE OWNER, CONTRACTOR AND ENGINEER FROM ANY AND ALL CLAIMS UNDER THE WORKMEN'S COMPENSATION ACT, ALSO ALL INSURANCE AS NOTED WITHIN ARCHITECTURAL GENERAL CONDITIONS, POST PROJECT NOTIFICATION AT THE SITE IN ACCORDANCE WITH MINISTRY OF LABOUR REQUIREMENTS.

### 4 PERMITS, FEES AND INSPECTION

PAY ALL ELECTRICAL SAFETY AUTHORITY (ESA) FEES ASSOCIATED WITH PERMIT, INSPECTION AND EQUIPMENT APPROVAL.  
NOTIFY ENGINEER OF CHANGES REQUIRED BY ELECTRICAL SAFETY AUTHORITY PRIOR TO MAKING CHANGES.  
FURNISH CERTIFICATES OF ACCEPTANCE FROM ESA AND AUTHORITIES HAVING JURISDICTION OF COMPLETION OF WORK TO ENGINEER.

### 5 DRAWINGS

PREPARE WITHOUT EXTRA COST, ANY LARGE SCALE INTERERENCE DRAWINGS WHICH MAY BE REQUIRED BY THE EXAMINING AUTHORITIES OR THE ENGINEER.  
PRIOR TO PROCEEDING WITH THE WORK; EXAMINE DRAWINGS BY OTHER TRADES INCLUDING ARCHITECTURAL AND MECHANICAL.

WHERE DISCREPANCIES ARE NOTED BETWEEN THE DRAWINGS AND/OR SPECIFICATIONS, CONTACT ENGINEER FOR RESOLUTION BEFORE STARTING ON THAT PART OF THE WORK.

### 6 SHOP DRAWINGS AND PRODUCT DATA

'SHOP DRAWINGS' MEANS DRAWINGS, DIAGRAMS, ILLUSTRATIONS, SCHEDULES, PERFORMANCE, CHARTS, BROCHURES, AND OTHER DATA WHICH ARE TO BE PROVIDED BY CONTRACTOR TO ILLUSTRATE DETAILS OF A PORTION OF THE WORK.  
INDICATE MATERIALS, METHODS OF CONSTRUCTION, AND ATTACHMENT OR ANCHORAGE, NECESSARY FOR COMPLETION OF WORK.  
ADJUSTMENTS MADE ON SHOP DRAWINGS BY OWNER OR ENGINEER ARE NOT INTENDED TO CHANGE CONTRACT PRICE.  
MAKE CHANGES IN SHOP DRAWINGS AS OWNER OR ENGINEER MAY REQUIRE, SUBMIT 6 COPIES OR 1 GOOD QUALITY DIGITAL COPY OF PRODUCT DATA SHEETS OR BROCHURES FOR LIGHTING FIXTURES, LIGHTING CONTROLS, EMERGENCY LIGHTING, EXIT SIGNS, POWER DISTRIBUTION EQUIPMENT AND FIRE ALARM COMPONENTS.  
PROVIDE 1 HARD COPY AND 1 DIGITAL COPY OF MAINTENANCE MANUALS COMPLETE WITH WARRANTY, CERTIFICATE OF INSPECTION BY ESA, FIRE ALARM VERIFICATION REPORT, AND COPY OF ALL PRODUCT LITERATURE AND MAINTENANCE INFORMATION.

### 7 AS BUILT DRAWINGS

PROVIDE TWO MARKED COPIES OF "AS-BUILT" DRAWINGS SHOWING ALL CHANGES TO THE ORIGINAL DESIGN AND SYSTEMS AS INSTALLED. ALL CHANGES SHALL BE MARKED CLEARLY AND NEATLY.

### 8 CUTTING AND PATCHING

ELECTRICAL CONTRACTOR SHALL PERFORM ALL CUTTING AND PATCHING REQUIRED FOR THE WORK OF THIS DIVISION. CUTTING AND DRILLING SHALL BE PERFORMED IN A MANNER SO AS TO CAUSE LITTLE DAMAGE AS POSSIBLE. ELECTRICAL CONTRACTOR SHALL BE RESPONSIBLE AND PAY FOR ANY DAMAGE CAUSED TO THE BUILDING BY WORK OF THIS DIVISION.

### 9 SUPPORTS AND HANGERS

PROVIDE STRUCTURAL SUPPORTS HANGERS BRACKETS AND INSERTS REQUIRED FOR INSTALLATION OF EQUIPMENT AND CONDUIT. PROVIDE CONDUIT FOR ALL SERVICES PENETRATING THE FLOOR SLAB. SEAL ALL PENETRATIONS THROUGH FIRE WALLS AND FLOOR SLABS WITH AN APPROVED NON-SHRINK, FIREPROOF AND WATERPROOF FIRESTOPPING MATERIAL APPROVED BY THE ARCHITECT.

### 10 EQUIPMENT AND MATERIAL

ALL MATERIALS USED THROUGHOUT SHALL BE NEW, C.S.A. APPROVED AND OF ONE MANUFACTURE FOR LIKE EQUIPMENT. OBTAIN AND PAY FOR SPECIAL ELECTRICAL SAFETY AUTHORITY INSPECTION OF SPECIFIED NON-C.S.A. ELECTRICAL EQUIPMENT.

### 11 CARE, OPERATION AND STARTUP

INSTRUCT OPERATING PERSONNEL IN THE OPERATION, CARE AND MAINTENANCE OF EQUIPMENT.

### 12 CO-ORDINATION

CO-ORDINATE WITH OTHER TRADES, INCLUDING MECHANICAL SYSTEMS, SO AS NOT TO INTERFERE WITH THE WORK OR SCHEDULE OF OTHER TRADES.

### 13 IDENTIFICATION

PROVIDE LAMACOID NAMEPLATES AND TYPEWRITTEN DIRECTORIES FOR ALL NEW PANELS.

### 14 WARRANTY

UPON COMPLETION OF THE WORK, PROVIDE A WRITTEN ONE YEAR GUARANTEE COVERING MATERIALS AND WORKMANSHIP. REPAIR OR REPLACE, WITHOUT COST TO THE OWNER, ANY DEFECTS IN WORKMANSHIP OR MATERIALS WHICH IN THE OPINION OF THE OWNER, ARE NOT DUE TO MISUSE OR NEGLECT.

### 15 CONDUITS

.1 RIGID GALVANIZED STEEL CONDUIT TO BE USED WHERE SUBJECT TO MECHANICAL DAMAGE.  
.2 ELECTRICAL METALLIC TUBING (EMT) WITH COUPLINGS TO BE USED EXCEPT WHERE EMBEDDED IN CONCRETE OR SUBJECT TO UNDUE MOISTURE OR MECHANICAL DAMAGE.  
.3 PVC CONDUIT WHERE EMBEDDED IN CONCRETE OR BELOW GRADE.  
.4 FOR UNDERGROUND CONDUITS, SLOPE CONDUITS TO PROVIDE DRAINAGE.  
.5 FLEXIBLE ALUMINUM CONDUIT WITH WEATHERPROOF COVERING TO BE USED WHERE SUBJECT TO VIBRATION OR STRAIN RELIEF.  
.6 INSTALL CONDUITS TO CONSERVE HEADROOM IN EXPOSED LOCATIONS AND CAUSE MINIMUM INTERFERENCE IN SPACES THROUGH WHICH THEY PASS.  
.7 CONCEAL CONDUITS EXCEPT IN MECHANICAL AND ELECTRICAL SERVICE ROOMS AND IN UNFINISHED AREAS.  
.8 MINIMUM CONDUIT SIZE FOR LIGHTING AND POWER CIRCUITS SHALL BE 1/2".  
BEND CONDUIT COLD. REPLACE IF KINKED OR FLATTENED MORE THAN 1/10TH OF ITS ORIGINAL DIAMETER.  
.9 MECHANICALLY BEND STEEL CONDUIT OVER 3/4" Dia.  
.10 FIELD THREADS ON RIGID CONDUIT MUST BE OF SUFFICIENT LENGTH TO DRAW CONDUITS UP TIGHT.  
.11 INSTALL FISH CORD IN EMPTY CONDUITS.  
.12 RUN 2-1" SPARE CONDUITS UP TO CEILING SPACE AND 2-1" SPARE CONDUITS DOWN TO CEILING SPACE FROM EACH FLUSH MOUNTED PANEL. TERMINATE THESE CONDUITS IN 6" x 6" x 4" JUNCTION BOXES IN CEILING SPACE OR IN CASE OF AN EXPOSED CONCRETE SLAB, TERMINATE EACH CONDUIT IN FLUSH CONCRETE SURFACE TYPE BOX.

### 13 REMOVE AND REPLACE BLOCKED CONDUIT SECTIONS.

### 14 DRY CONDUITS OUT BEFORE INSTALLING WIRE.

### 15 RUN CONDUITS PARALLEL OR PERPENDICULAR TO BUILDING LINES.

### 16 LOCATE CONDUITS BEHIND INFRARED OR GAS FIRED HEATERS WITH MINIMUM 5' CLEARANCE.

### 17 GROUP CONDUITS WHEREVER POSSIBLE ON SUSPENDED OR SURFACE CHANNELS.

### 18 DO NOT PASS CONDUITS THROUGH STRUCTURAL MEMBERS EXCEPT AS INDICATED.

### 19 DO NOT LOCATE CONDUITS LESS THAN 3" PARALLEL TO HOT WATER LINES WITH MINIMUM OF 1" AT CROSSOVERS.

### 20 FOR CONDUITS IN CAST-IN-PLACE CONCRETE, LOCATE TO SUIT REINFORCING STEEL. INSTALL IN CENTRE ONE THIRD OF SLAB.

### 21 PROTECT CONDUITS FROM DAMAGE WHERE THEY STUB OUT OF CONCRETE.

### 22 INSTALL SLEEVES WHERE CONDUITS PASS THROUGH SLAB OR WALL.

### 23 PROVIDE OVERRSIZE SLEEVE FOR CONDUITS PASSING THROUGH WATERPROOF MEMBRANE, BEFORE MEMBRANE IS INSTALLED. USE COLD MASTIC BETWEEN SLEEVE AND CONDUIT.

### 24 DO NOT PLACE CONDUITS IN SLABS IN WHICH SLAB THICKNESS IS LESS THAN 4 TIMES CONDUIT DIAMETER.

### 25 FOR CONDUITS IN CAST-IN-PLACE CONCRETE, ENCASE CONDUITS COMPLETELY IN CONCRETE COVER AND ORGANIZE CONDUITS IN SLAB TO MINIMIZE CROSS-OVERS.

### 26 FOR CONDUITS IN CAST-IN-PLACE SLABS ON GRADE RUN CONDUITS 25mm AND LARGER BELOW SLAB AND ENCASED IN 75mm CONCRETE ENVELOPE. PROVIDE 50mm OF SAND OVER CONCRETE ENVELOPE BELOW FLOOR SLAB.

### 16 SPLITTERS, JUNCTION, PULL BOXES AND CABINETS

### 1. INSTALL SPLITTERS AND MOUNT PLUMB, TRUE AND SQUARE TO THE BUILDING LINES.

### 2. EXTEND SPLITTERS FULL LENGTH OF EQUIPMENT ARRANGEMENT EXCEPT WHERE INDICATED OTHERWISE.

### 3. INSTALL PULL BOXES IN INCONSPICUOUS BUT ACCESSIBLE LOCATIONS.

### 4. MOUNT CABINETS WITH NO OVERCURRENT DEVICE OPERATING HANDLE MORE THAN 1.7m ABOVE FINISHED FLOOR.

### 5. INSTALL PULL BOXES SO AS NOT TO EXCEED 30m OF CONDUIT RUN BETWEEN PULL BOXES.

### 6. SUPPORT PULL BOXES INDEPENDENTLY OF CONDUIT.

### 7. BOXES INSTALLED OUTDOORS SHALL BE WEATHERPROOF COMPLETE WITH GASKET.

### 17. INSTALLATION OF OUTLETS

### 1. THE DRAWINGS SHOW APPROXIMATE LOCATION OF OUTLETS, EXACT LOCATION SHALL BE COORDINATED ON THE SITE WITH OTHER TRADES, ARCHITECTURAL DRAWINGS, ETC.

### 2. OUTLETS INACCURATELY LOCATED SHALL BE READJUSTED OR RELOCATED AT THE CONTRACTOR'S EXPENSE.

### 3. UNLESS OTHERWISE NOTED ON THE DRAWING LOCATE OUTLETS AS FOLLOWS:

### 2. RECEPTACLES, TELEPHONE AND ALARM OUTLETS (18") 450mm ABOVE FINISHED FLOOR.

### 3. OUTLETS OVER COUNTER (45") 1143mm ABOVE FLOOR OR AS DIRECTED BY OWNER OR ARCHITECT.

### 4. OUTLETS IN MECHANICAL, ELECTRICAL AND TELEPHONE ROOMS (47") 1200mm ABOVE FLOOR.

### 5. LIGHT SWITCHES MAXIMUM (47") 1200mm ABOVE FLOOR.

### 6. RACEWAYS SHALL BE EMT UNLESS OTHERWISE NOTED.

### 7. MANUAL PULL STATION (47") 1200mm ABOVE FLOOR.

### 18. WIRE AND CABLE

### .1 MINIMUM SIZE OF CONDUCTORS SHALL BE #12 AWG.

### .2 CONDUCTORS SHALL BE COPPER, SIZED AS INDICATED, WITH 600V INSULATION OF CROSS LINKED THERMOSET POLYETHYLENE MATERIAL RW90-XLPE.

### .3 SIZE OF WIRING FOR BRANCH CIRCUITS GREATER THAN 30m IN LENGTH SHALL BE #10 AWG UNLESS OTHERWISE INDICATED ON THE PLANS.

### .4 WIRES TO BE COLOURED AS FOLLOWS:

### 12V DC BLUE

### 120V AC NEUTRAL WHITE

### 120V AC SWITCHED BLACK OR RED

### 120V AC LINE BLACK

### .5 USE MATERIALS AND METHODS APPROVED BY THE ONTARIO ELECTRICAL SAFETY CODE FOR USE IN NON-COMBUSTIBLE CONSTRUCTION.

### .6 ARMoured CABLE TYPE AC90 (BX) WITH INTERLOCKING ARMOUR FABRICATED FROM ALUMINUM STRIP C/W COPPER INSULATED CONDUCTORS, SIZE AS INDICATED, TO BE USED IN CONCEALED WALL AND CEILING CAVITIES.

### 19. GROUNDING

### .1 INSTALL COMPLETE PERMANENT, CONTINUOUS GROUNDING SYSTEM INCLUDING, ELECTRODES, CONDUCTORS, CONNECTORS, ACCESSORIES AS INDICATED TO CONFORM TO REQUIREMENTS OF ESA, ENGINEER, AND LOCAL AUTHORITY HAVING JURISDICTION OVER THE INSTALLATION. WHERE EMT IS USED, RUN BOND WIRE IN CONDUIT.

### .2 INSTALL CONNECTORS IN ACCORDANCE WITH MANUFACTURER'S INSTRUCTIONS.

### .3 PROTECT EXPOSED GROUNDING CONDUCTORS FROM MECHANICAL INJURY.

### .4 MAKE BURIED CONNECTIONS, AND CONNECTIONS TO ELECTRODES, USING COPPER CAD WELDING PROCESS CONNECTORS.

### .5 USE MECHANICAL CONNECTORS FOR GROUNDING CONNECTIONS TO EQUIPMENT PROVIDED WITH LUGS.

### .6 SOLDERED JOINTS NOT PERMITTED.

### .7 INSTALL BONDING WIRE FOR FLEXIBLE CONDUIT, CONNECTED AT BOTH ENDS TO GROUNDING BUSHING, SOLDERLESS LUG, CLAMP OR CUP WASHER AND SCREW.

### 20. DISCONNECT SWITCHES

.1 FUSIBLE, AND NON-FUSIBLE, DISCONNECT SWITCH SWITCHES IN ENCLOSURE, SIZE AS INDICATED.  
.2 PROVISION FOR PADLOCKING IN OFF SWITCH POSITION BY THREE LOCKS.  
.3 MECHANICALLY INTERLOCKED DOOR TO PREVENT OPENING WHEN HANDLE IN ON POSITION.  
.4 FUSES: SIZE AS INDICATED. PROVIDE THREE SPARE FUSES OF EACH TYPE AND SIZE INSTALLED UP TO AND INCLUDING 600A, AND SIX SPARE FUSES OF EACH TYPE AND SIZE INSTALLED UP TO AND INCLUDING 600A. PROVIDE SUITABLE SIZED CABINET TO STORE SPARE FUSES.  
.5 FUSEHOLDERS: SUITABLE WITHOUT ADAPTORS, FOR TYPE AND SIZE OF FUSE INDICATED.  
.6 QUICK-MAKE, QUICK-BREAK ACTION.  
.7 ON-OFF SWITCH POSITION INDICATION ON SWITCH ENCLOSURE COVER.  
.8 ENCLOSURES SHALL BE RATED EEMAC 1 EXCEPT FOR WEATHERPROOF ENCLOSURES WHICH SHALL BE EEMAC 3.

### 21. PANEL BOARDS

.1 PANELBOARDS SHALL BE THE PRODUCT OF ONE MANUFACTURER. SIEMENS, CUTLER HAMMER AND SCHNEIDER ARE ACCEPTABLE.  
.2 INSTALL CIRCUIT BREAKERS IN PANELBOARDS BEFORE SHIPMENT.  
.3 SEQUENCE PHASE BUSSING WITH ODD NUMBER BREAKERS ON LEFT AND EVEN ON RIGHT, WITH EACH BREAKER IDENTIFIED BY PERMANENT NUMBER IDENTIFICATION AS TO CIRCUIT NUMBER AND PHASE.  
.4 PANELBOARDS: MAINS, NUMBER OF CIRCUITS, AND NUMBER AND SIZE OF BRANCH CIRCUIT BREAKERS AS INDICATED ON DRAWINGS.  
.5 TWO KEYS FOR EACH PANELBOARD AND KEY PANELBOARDS ALIKE.  
.6 ALUMINUM OR COPPER BUS WITH NEUTRAL OF SAME AMPERE RATING AS MAINS.  
.7 MAINS: SUITABLE FOR BOLT-ON BREAKERS.  
.8 TRIM WITH CONCEALED FRONT BOLTS AND HINGES.  
.9 TRIM AND DOOR FINISH: BAKED GREY ENAMEL.  
.10 TWO AND THREE POLE BREAKER OPERATION SHALL BE BY MEANS OF A COMMON TRIP AND A SINGLE HANDLE. A TIE HANDLE CONNECTING TWO OR THREE SINGLE POLE BREAKERS WILL NOT BE ACCEPTED.

### 22. ELECTRIC MOTORS EQUIPMENT AND CONTROLS

.1 CONTROL WIRING AND CONDUIT IS SPECIFIED BY ELECTRICAL EXCEPT FOR CONDUIT, WIRING AND CONNECTIONS BELOW 50V WHICH ARE RELATED TO CONTROL SYSTEMS SPECIFIED BY MECHANICAL AND SHOWN ON MECHANICAL DRAWINGS.  
.2 ELECTRICAL SHALL CHECK ALL MOTOR CONNECTION FOR CORRECT PHASE ROTATION, WHERE APPLICABLE.

### 23. LIGHTING FIXTURES

.1 PROVIDE LIGHT FIXTURES AS SHOWN ON LIGHTING SCHEDULE ON THE DRAWINGS. ENSURE THAT ALL EQUIPMENT IS EQUAL TO THE PRODUCTS SPECIFIED IN ALL RESPECTS.  
.2 LOCATE AND INSTALL LUMINAIRES AS INDICATED.  
.3 JUNCTION BOXES IN SUSPENDED CEILING SPACES SHALL BE ACCESSIBLE THROUGH THE FIXTURES OR BY REMOVABLE CEILING.  
.4 FOR SUSPENDED CEILING INSTALLATIONS SUPPORT LUMINAIRES INDEPENDENTLY OF CEILING BY AIRCRAFT CABLE.  
.5 ALIGN LUMINAIRES MOUNTED INDIVIDUALLY PARALLEL OR PERPENDICULAR TO BUILDING GRID.

### 24. INSTALLATION OF OUTLETS

.1 THE DRAWINGS SHOW APPROXIMATE LOCATION OF OUTLETS, EXACT LOCATION SHALL BE COORDINATED ON THE SITE WITH OTHER TRADES, ARCHITECTURAL DRAWINGS, ETC. OUTLETS INACCURATELY LOCATED SHALL BE READJUSTED OR RELOCATED AT THE CONTRACTOR'S EXPENSE. UNLESS OTHERWISE NOTED ON THE DRAWING LOCATE OUTLETS AS FOLLOWS:  
1.1 RECEPTACLES, TELEPHONE AND ALARM OUTLETS (12") 305mm ABOVE FINISHED FLOOR.  
1.2 OUTLETS OVER COUNTER (45") 1143mm ABOVE FLOOR OR CO-ORDINATION.  
1.3 OUTLETS IN MECHANICAL, ELECTRICAL AND TELEPHONE ROOMS (48") 1220mm ABOVE FLOOR.  
1.4 LIGHT SWITCHES NOT LESS THAN (35.4") 900mm AND NOT MORE THAN (43") 1100mm ABOVE FLOOR.  
2. RACEWAYS SHALL BE EMT UNLESS OTHERWISE NOTED.  
3. SUPPORT OUTLET BOXES, JUNCTION BOXES, CONDUIT AND THE LIKE.  
4. LABEL ALL OUTLETS WITH THE PANEL AND CIRCUIT NUMBER FROM WHICH IT IS FED

### 25. RECEPTACLES

.1 WHITE DUPLEX RECEPTACLES CSA TYPE 5-15R, 125V, 20A, T-SLOT, U GROUND.  
.2 WHITE COVER PLATES.  
.3 IF RECEPTACLE IS SURFACE MOUNTED USE CAST BOX.

### 26. EQUIPMENT FOR EMERGENCY LIGHTING

.1 SUPPLY VOLTAGE: 120V AC  
.2 OUTPUT VOLTAGE: 12V DC  
.3 OPERATIONS TIME: 60 MINUTES MINIMUM  
.4 CABINET: SUITABLE FOR DIRECT OR SHELF MOUNTING TO WALL C/W KNOCKOUTS FOR CONDUIT, REMOVABLE OR HINGED FRONT PANEL FOR EASY ACCESS TO BATTERIES.

### 27. TELEPHONE/COMPUTER RACEWAY SYSTEM

.1 PROVIDE EMPTY CONDUIT SYSTEMS FOR TELEPHONE AND DATA AS SHOWN ON THE DRAWINGS.  
.2 WHERE CONDUITS NOT SHOWN ON DRAWINGS PROVIDE CONDUITS FROM OUTLET BOX TO ACCESSIBLE CEILING SPACE.  
.3 RACEWAYS SHALL BE EMT