

NOTES:

1. ACTUAL LAYOUT OF KITCHEN CABINETS MAY DIFFER FROM PLAN
2. APPARENT SIZE OF FRONT PORCH FOR INDICATION ONLY
3. ALL CONSTRUCTION MUST COMPLY WITH THE FOLLOWING:

2018 INTERNATIONAL RESIDENTIAL CODE (IRC)

2018 INTERNATIONAL MECHANICAL CODE (IMC)

2018 UNIFORM PLUMBING CODE

2018 WASHINGTON STATE ENERGY CODE
4. BRACED WALLS: ALL EXTERIOR WALLS SHALL BE CONTINUOUSLY SHEATHED WITH 7/16" OSB PANELS.
5. EXHAUST FANS: SEE SH 9 FOR CFM AND LOCATIONS.
6. SMOKE AND CO ALARMS: SEE SHEET 9 FOR LOCATIONS.
7. GARAGE OPENING: CONTINUOUS SHEATHED PORTAL FRAMED BRACING. SEE SH 7B, DETAIL G.

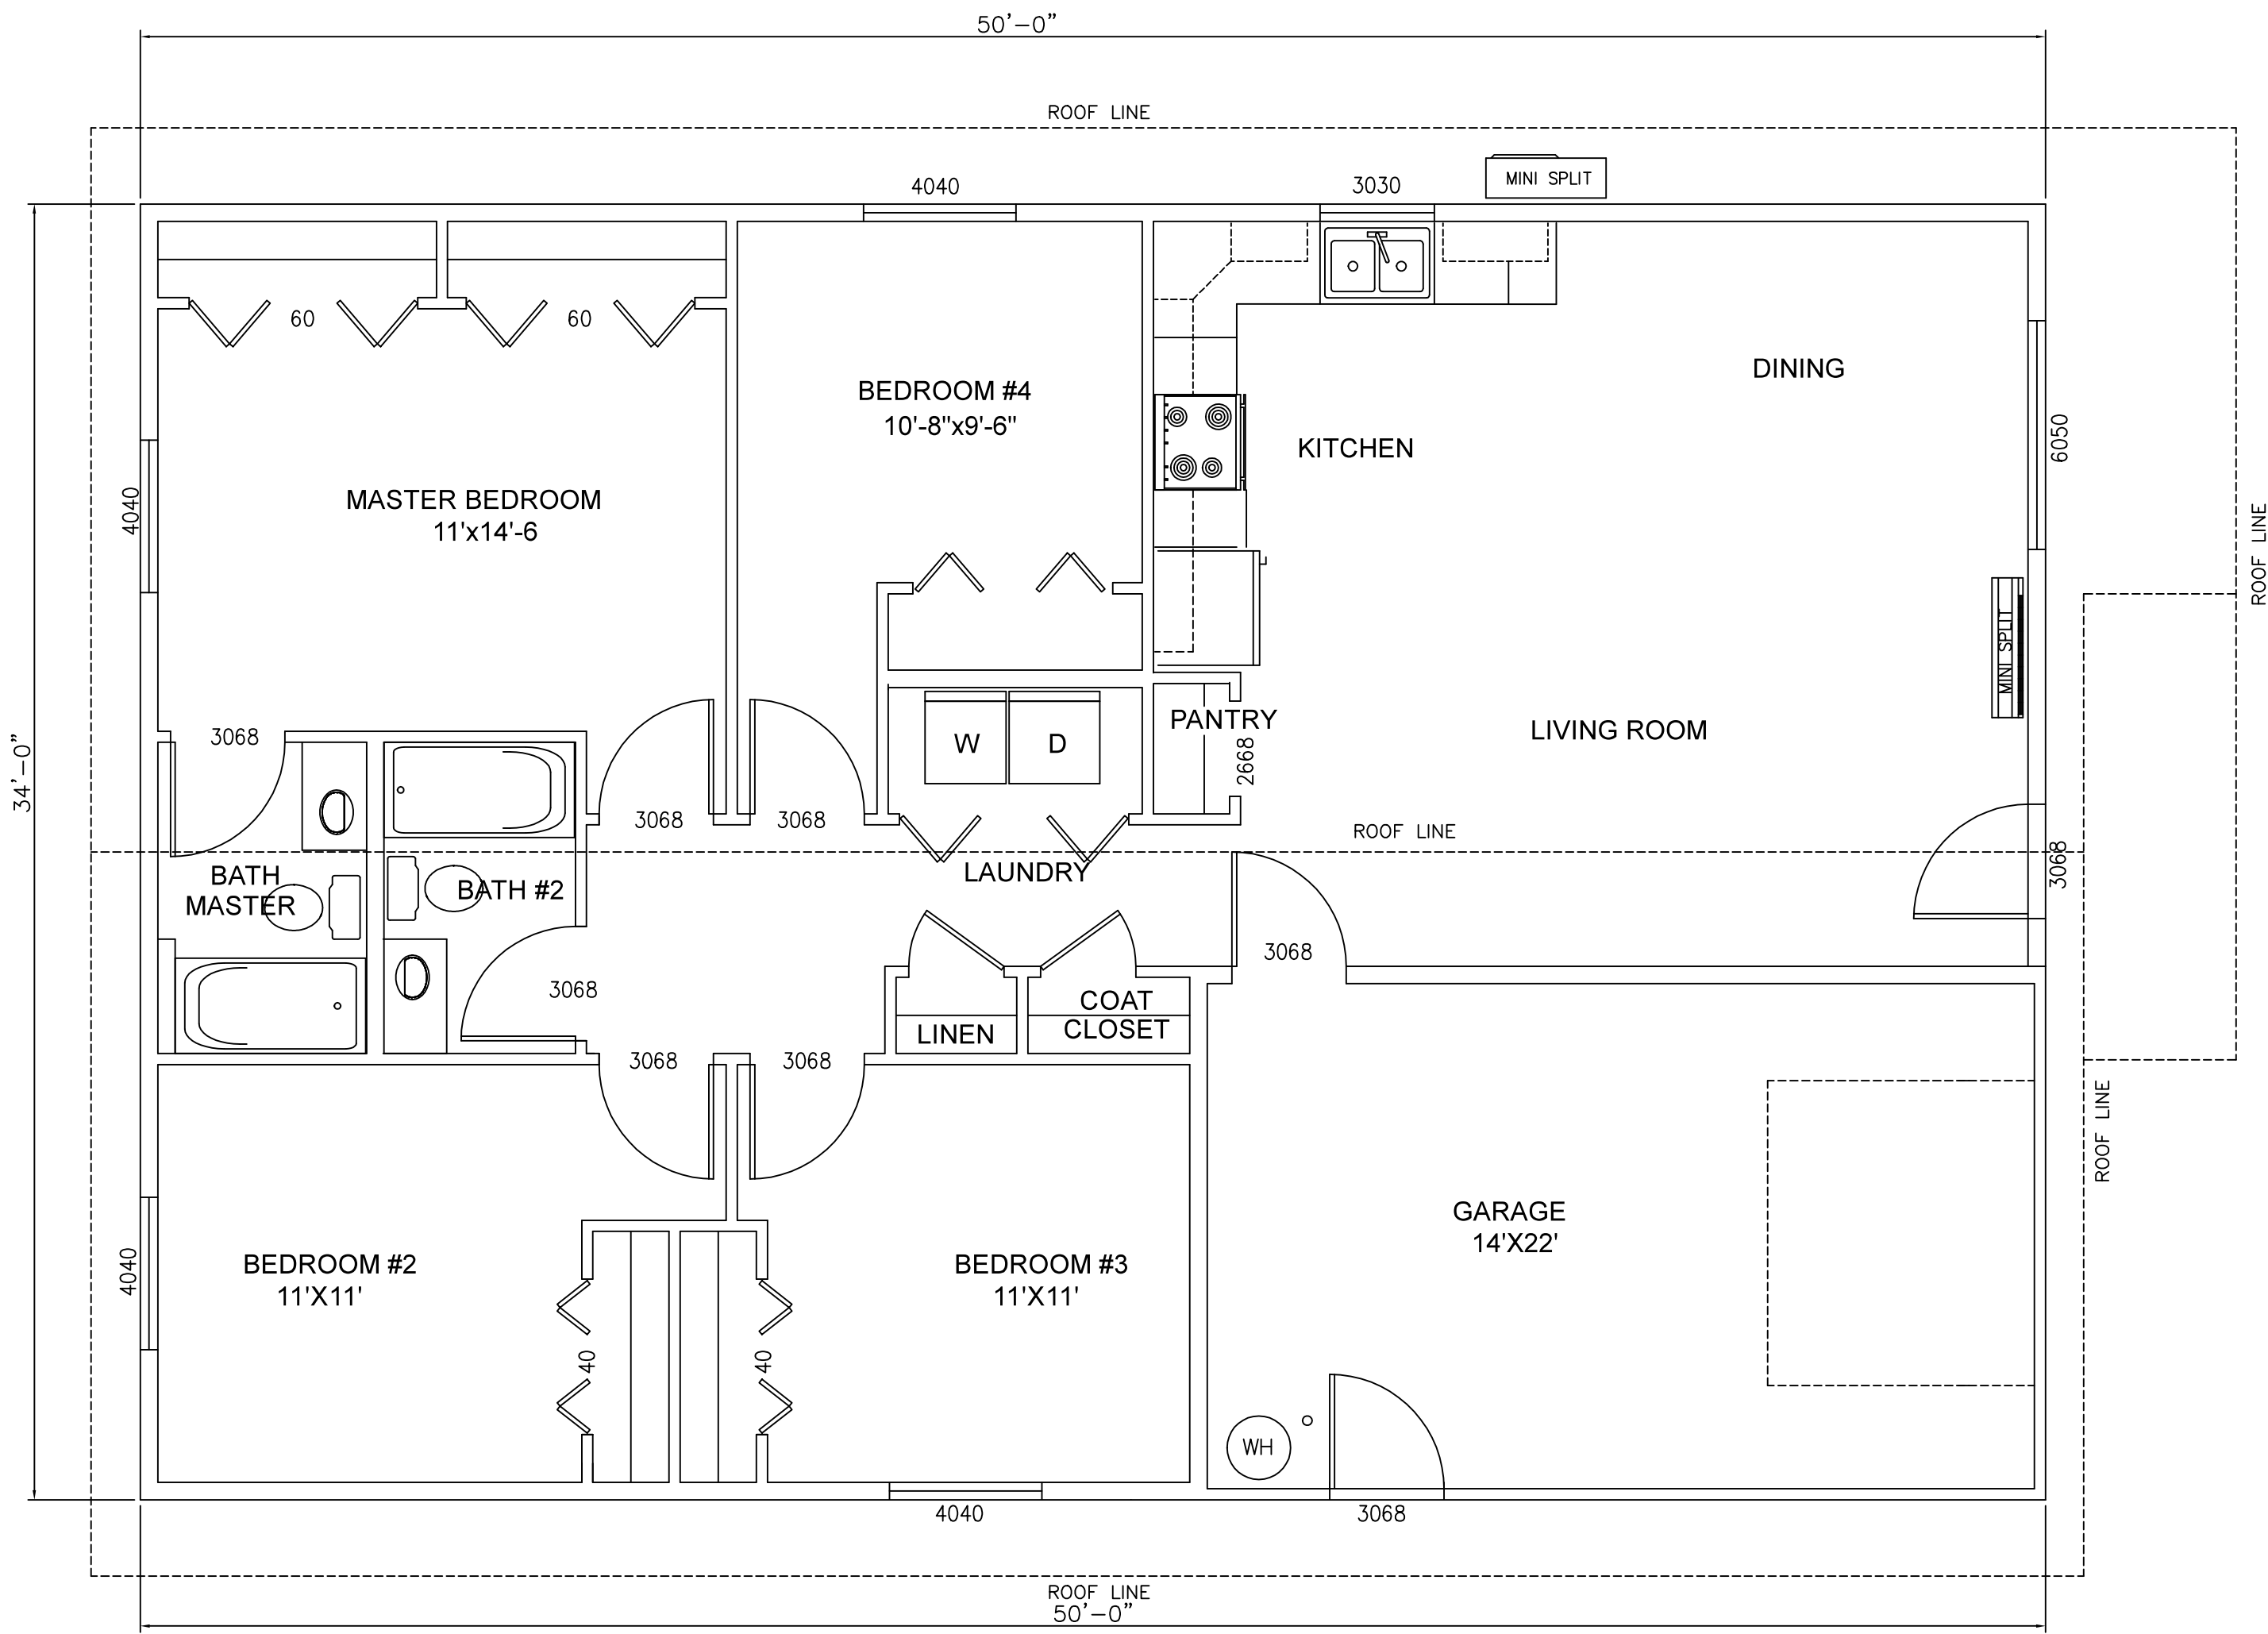


TABLE 406.2  
FUEL NORMALIZATION CREDITS

SYSTEM TYPE	DESCRIPTION OF PRIMARY HEATING SOURCE	CREDITS
4	For heating system based on electric resistance with a ductless mini-split heat pump system in accordance with Section R403.7.1 including the exception	0.5

TABLE 406.3  
ENERGY CREDITS


OPTION	DESCRIPTION	CREDIT(S)
1.1	EFFICIENT BUILDING ENVELOPE 1.1: Prescriptive compliance is based on Table R402.1.1 with the following modifications: Vertical fenestration U = 0.24	0.5
2.1	AIR LEAKAGE CONTROL AND EFFICIENT VENTILATION 2.1: Compliance based on R402.4.1.2: Reduce the tested air leakage to 3.0 air changes per hour maximum at 50 Pascals or For R-2 Occupancies, optional compliance based on Section R402.4.1.2: Reduce the tested air leakage to 0.3 cfm/sf maximum at 50 Pascals and  All whole house ventilation requirements as determined by Section M1507.3 of the International Residential Code or Section 403.8 off the International Mechanical Code shall be met with a high efficiency fan(s) (maximum 0.35 watts/cfm), not interlocked with the furnace fan (if present) . Ventilation systems using a furnace including an ECM motor are allowed, provided that they are controlled to operate at low speed in ventilation only mode.  To qualify to claim this credit, the building permit drawings shall specify the option being selected and the maximum tested building air leakage, and shall show the qualifying ventilation system and its control sequence of operation.	0.5
3.4	HIGH EFFICIENCY HVAC EQUIPMENT 3.4: Ductless mini-split heat pump system, zonal control: In homes where the primary space heating system is zonal electric heating, a ductless mini-split heat pump system with a minimum HSPF of 10.0 shall be installed and provide heating to the largest zone of the housing unit.  To qualify to claim this credit, the building permit drawings shall specify the option being selected and shall specify the heating equipment type and the minimum equipment efficiency.	1.5



House Number:	TCP-4B2B-U	Drawn:	PDR	Date:	06MAY23	Title:					
For:		Checked:		Date:		GENERAL FLOOR PLAN					
		Approved:		Date:		Sheet:	1	Rev:	2	Scale:	1/4" = 1'



NOTES:

- 6" X 24" STEM WALL WITH INDEPENDENT 4" SLAB
- 14" X 7" FOOTING BENEATH STEMWALL
- SEE SHEET 6 FOR SECTION DETAILS
- SEE SHEET 6 FOR REBAR SCEDULE
- SEE SHEET 3 FOR J-BOLT PLAN
- 6" x 6" MESH OPTIONAL IN SLAB
- FRONT AND SIDE PATIO SLABS ARE SEPERATE POURS
- GIVEN DIMENSIONS OF FRONT/SIDE PATIOS FOR INDICATION ONLY

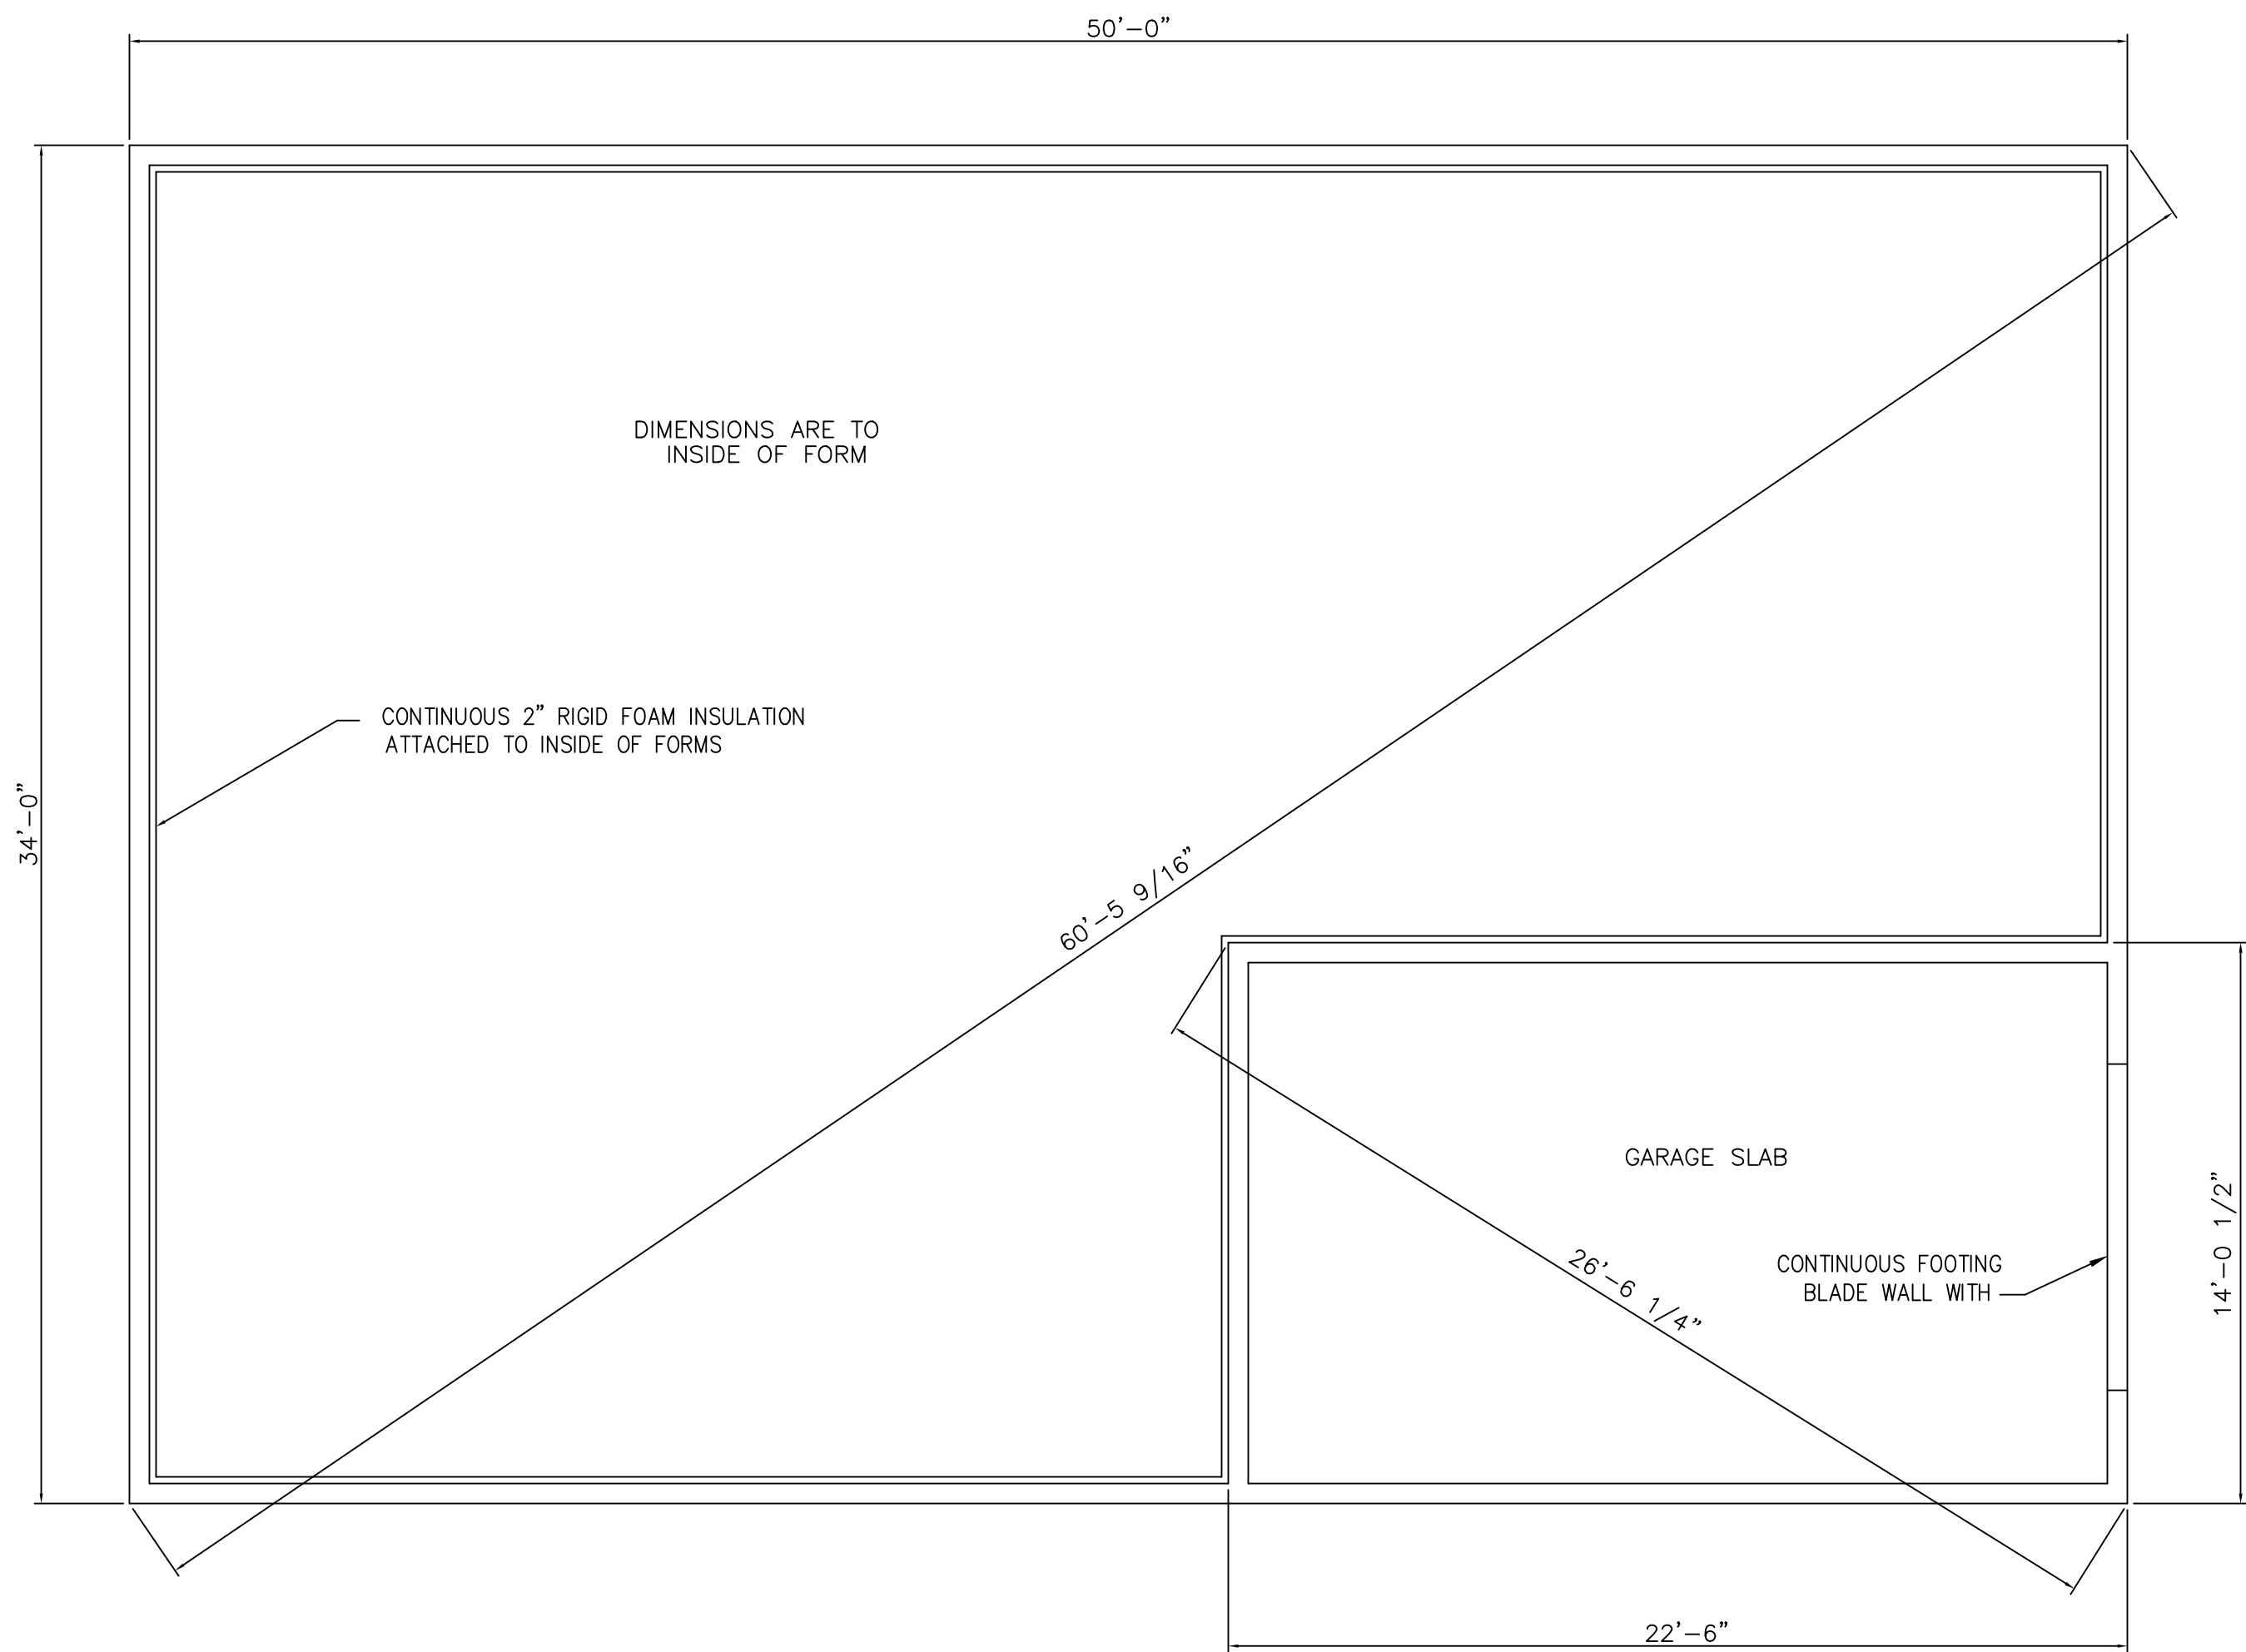

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House Number:	TCP-4B2B-U	Drawn:	PDR	Date:	06MAY23	Title:				FOUNDATION AND MISC. CONCRETE PLAN	
	For:		Checked:		Date:						
			Approved:		Date:	Sheet:	2	Rev:	2	Scale:	1/4" = 1'

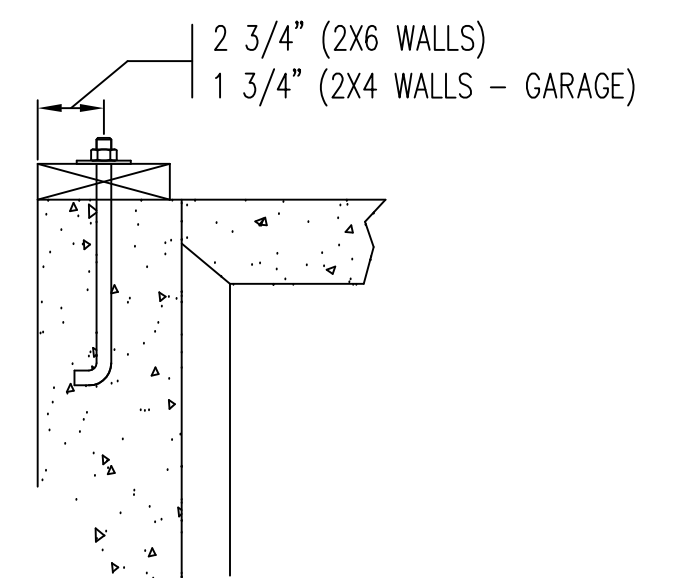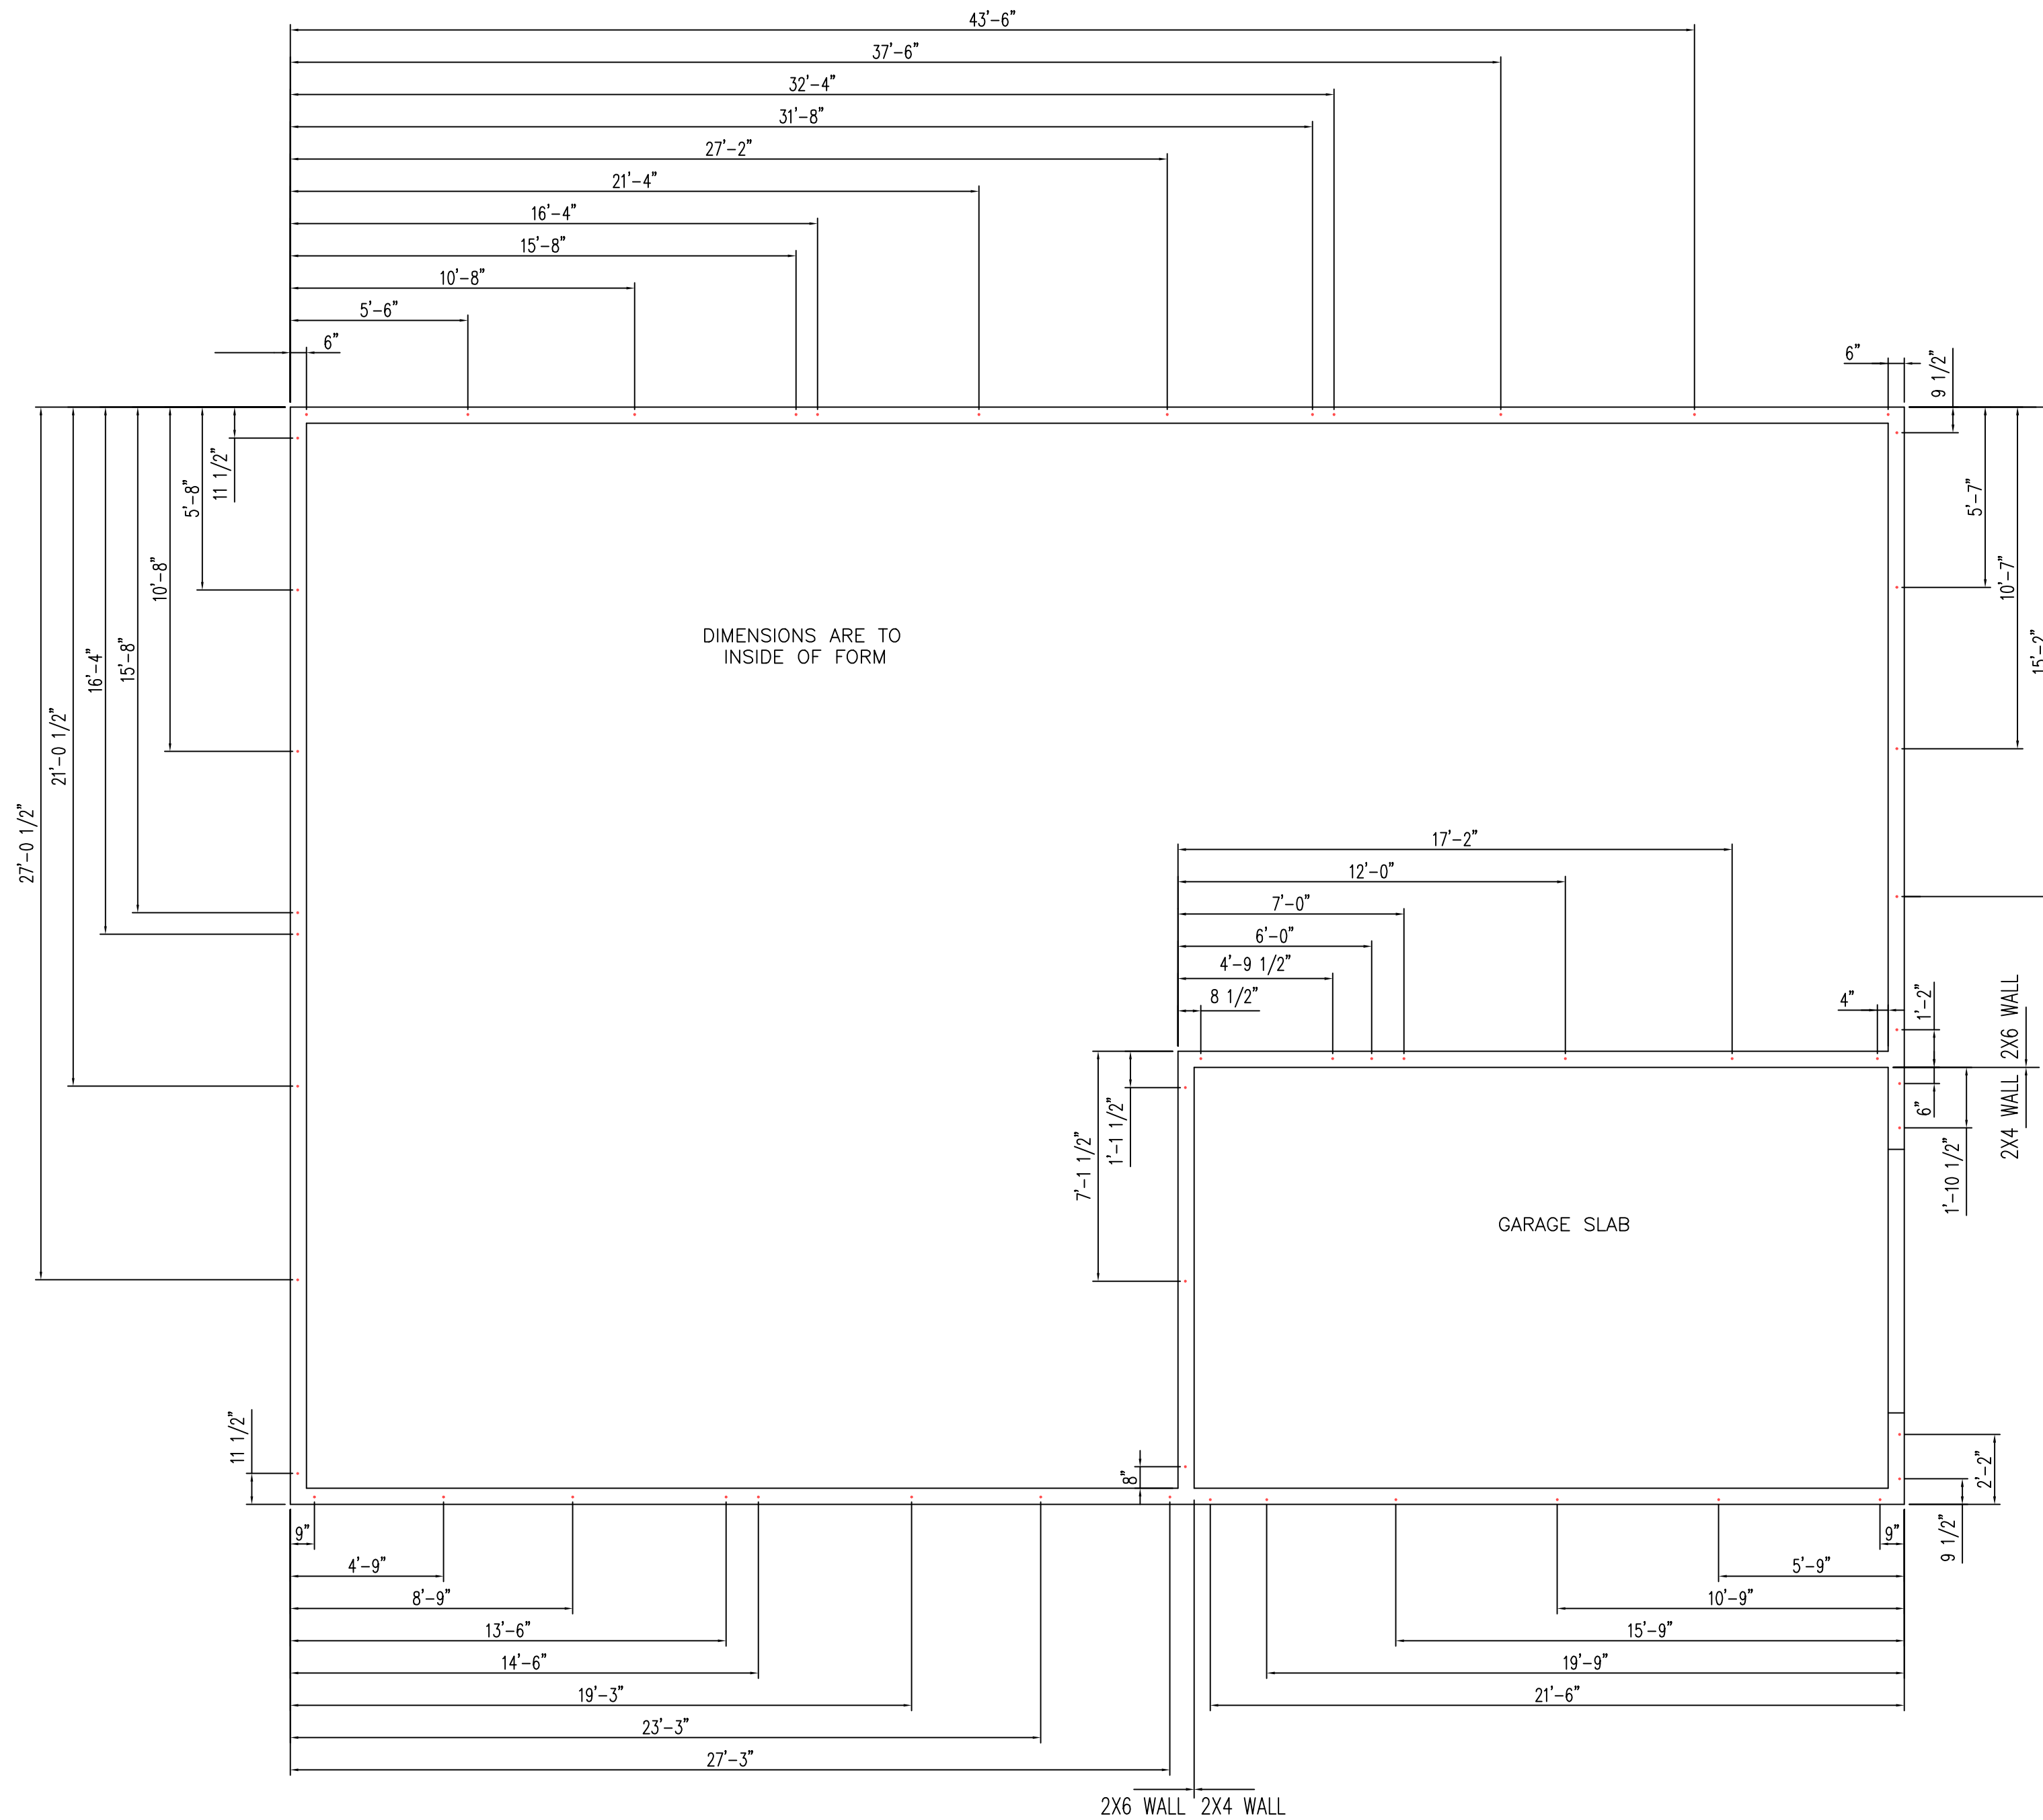

J-BOLT PLACEMENT



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Habitat for Humanity

House Number: TCP-4B2B-U

For:

Drawn: PDR

Checked:

Approved:

Date: 06MAY23

Date:

Date:


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J-BOLT LAY-OUT PLAN





Sheet: 3

Rev: 2

Scale: 1/4" = 1'

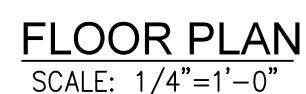

SUPPORT, MDF, 1X4 (11/16" X 3 1/2") 66" ABOVE FLOOR  
SHELF, PARTICLE BOARD, BULLNOSE, 1X16 (3/4" X 15 1/4")  
SHELF BRACKET, 10" X 12"

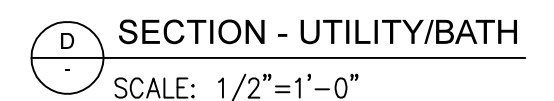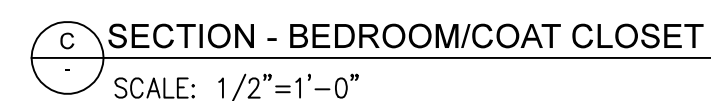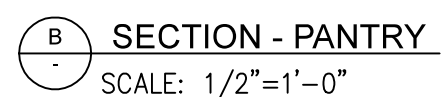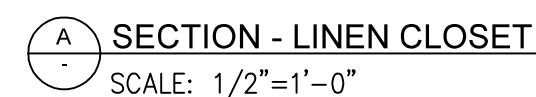

1. ACTUAL LAYOUT OF KITCHEN CABINETS MAY DIFFER FROM PLAN



Scale: **NOTED**



10. BORE 1-1/2" HOLE THRU STUDS 14" ABOVE  
SLAB PRIOR TO INSTALLING SHEATHING.  
INSTALL 3/4" PVC ELBOW WITH 6" PIPE  
STUBS AS SHOWN FOR MINI SPLIT CONDENSATE.



Scale:  $1/4" = 1'$

Scale:  $1/4" = 1'$



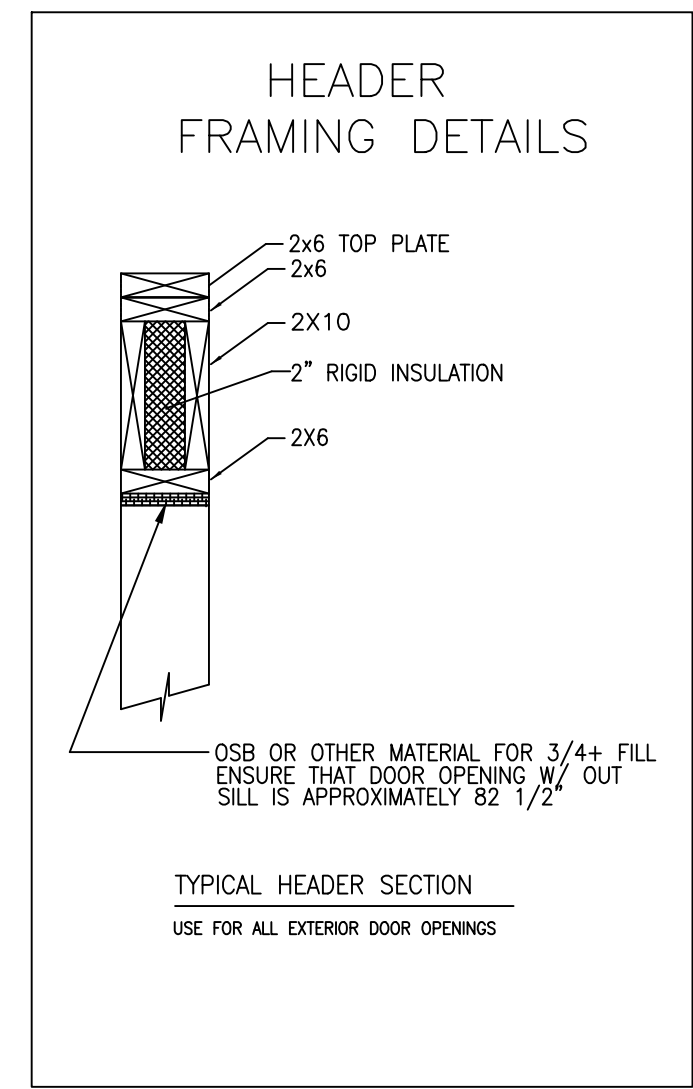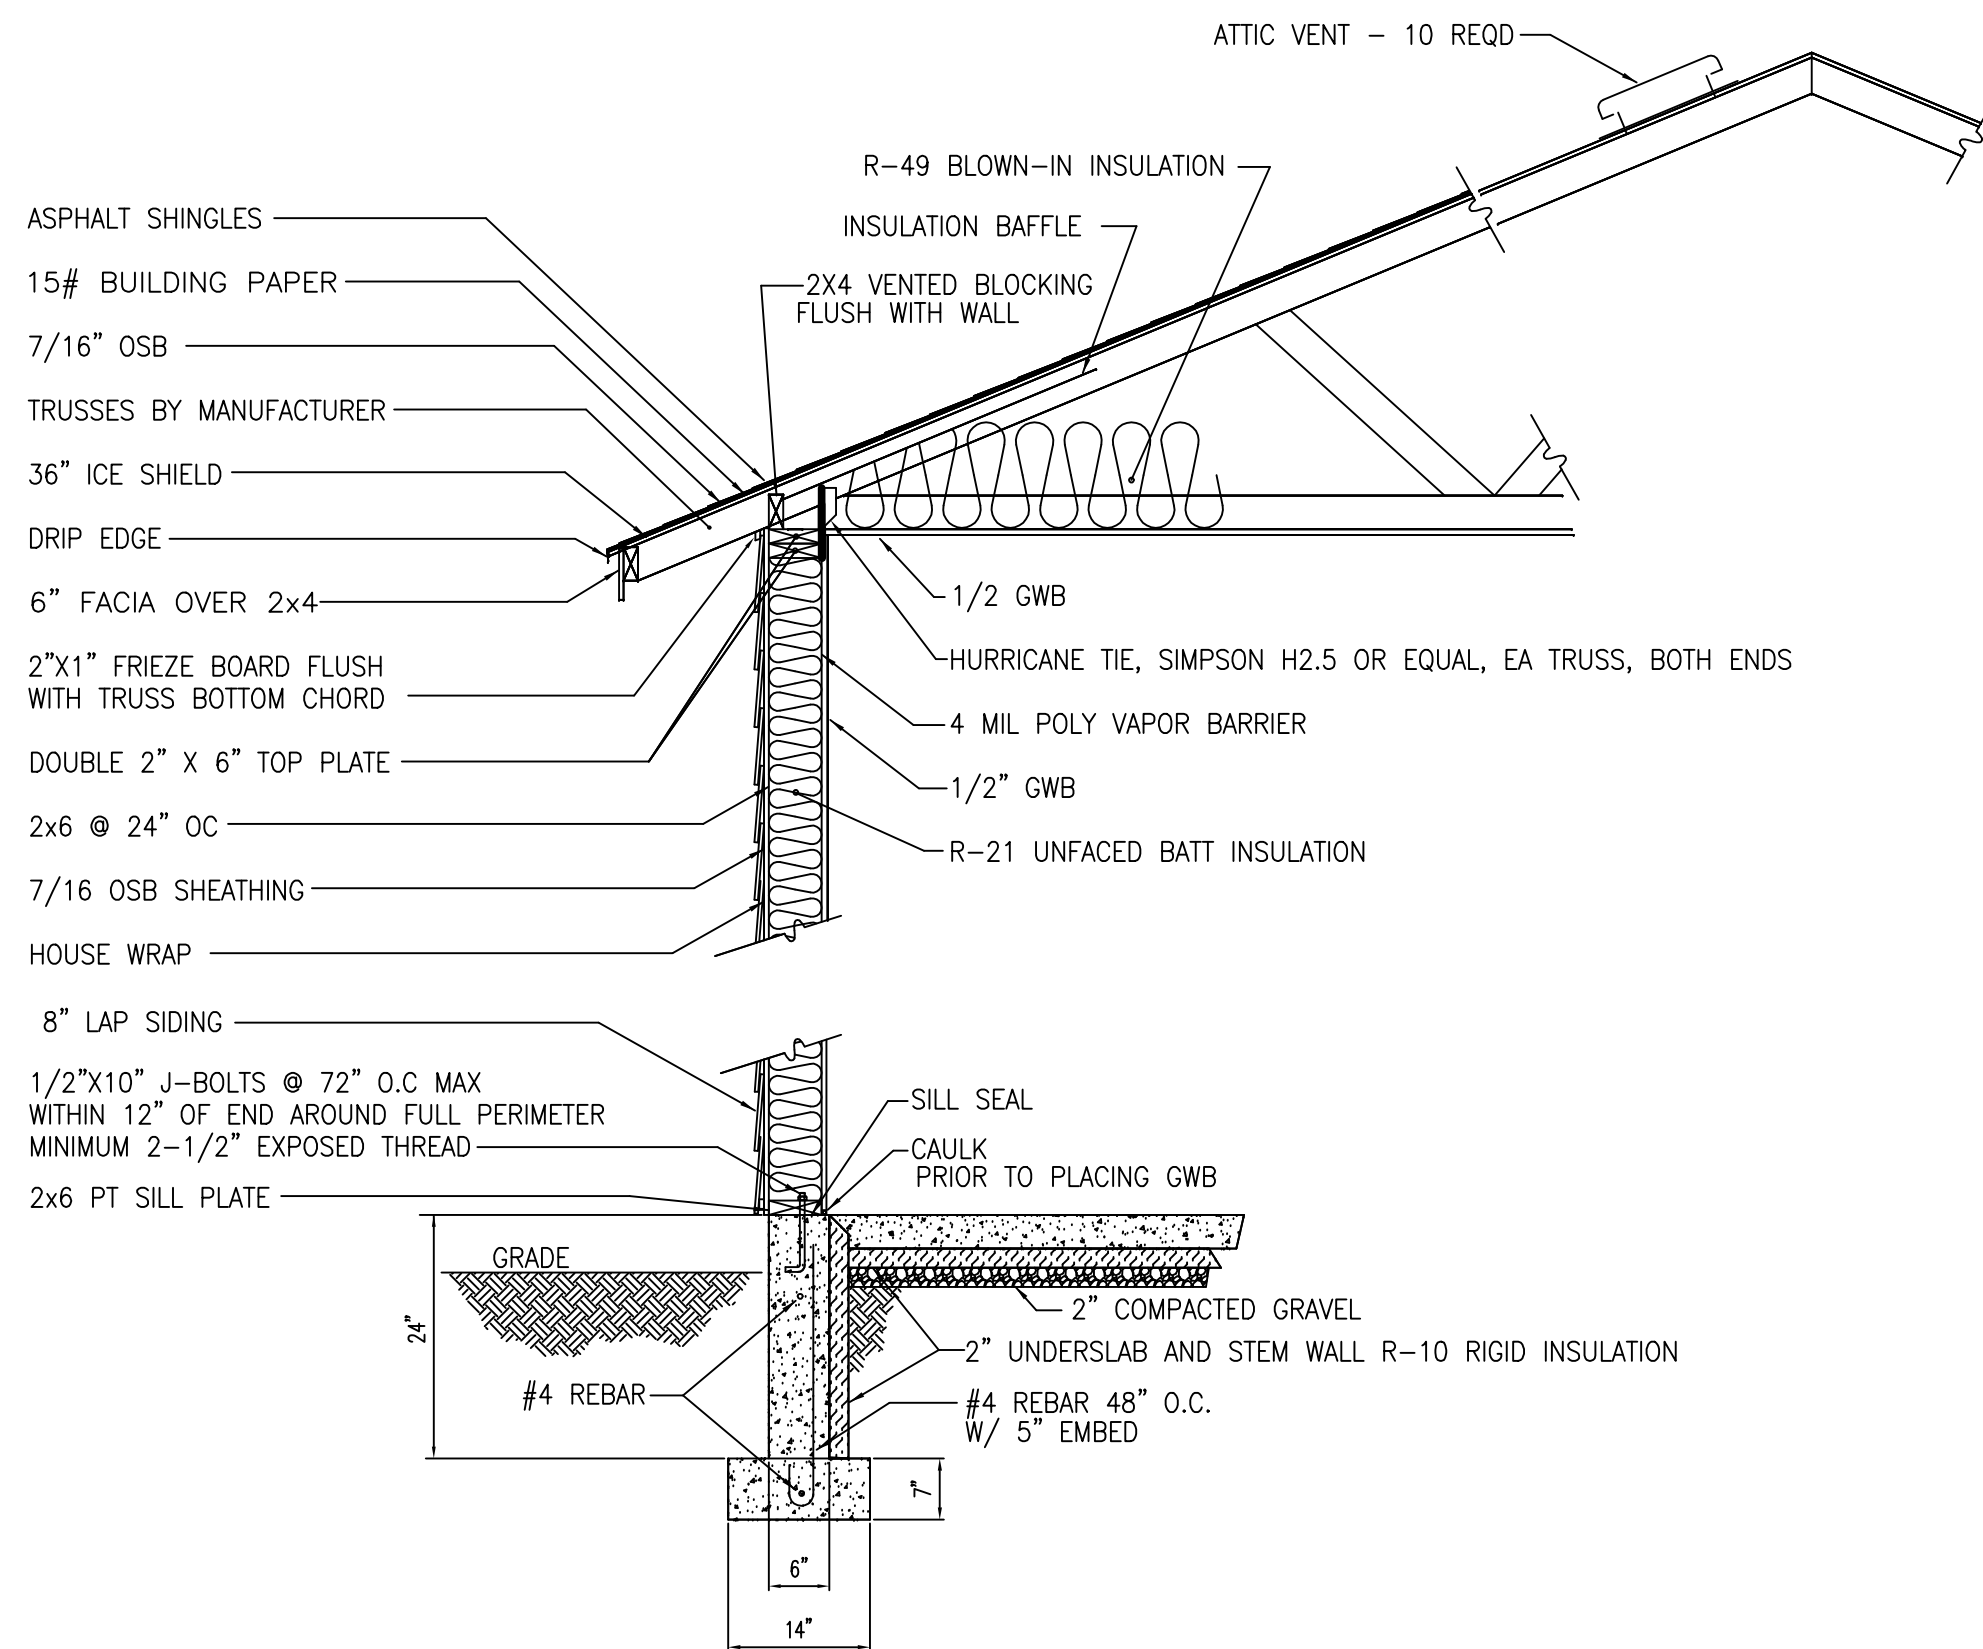



NOTES:

- 1.CONCRETE SLAB WITH STEMWALL FOUNDATION OVERLAIN ON 2" RIGID FOAM INSULATION W/ TAPED JOINTS  
2" COMPACTED GRAVEL UNDER INSULATION FOAM
- 2.FOOTING MINIMUM OF 7" THICK AND 14" WIDE
- 3.STEMWALL 6" WIDE
- 4.REINFORCEMENT: 2 #4 REBAR HORIZONTAL (WITHIN 12" OF TOP OF STEMWALL AND CENTERED W/IN FOOTING) AND VERT. #4 REBAR 48" O.C. W/ 5" WET SET
- 5.OPEN SOFFIT, 24" OVERHANG SIDEWALLS, 12" GABLE ENDS
- 6.2" X 4" BLOCKING, BIRD BLOCKING, IN TRUSS BAYS
- 7.TRUSS ANCHORS PER MANUFACTURER SPEC.
- 8.EXTERIOR WALLS AND INTERIOR PARTITIONS 8' TALL




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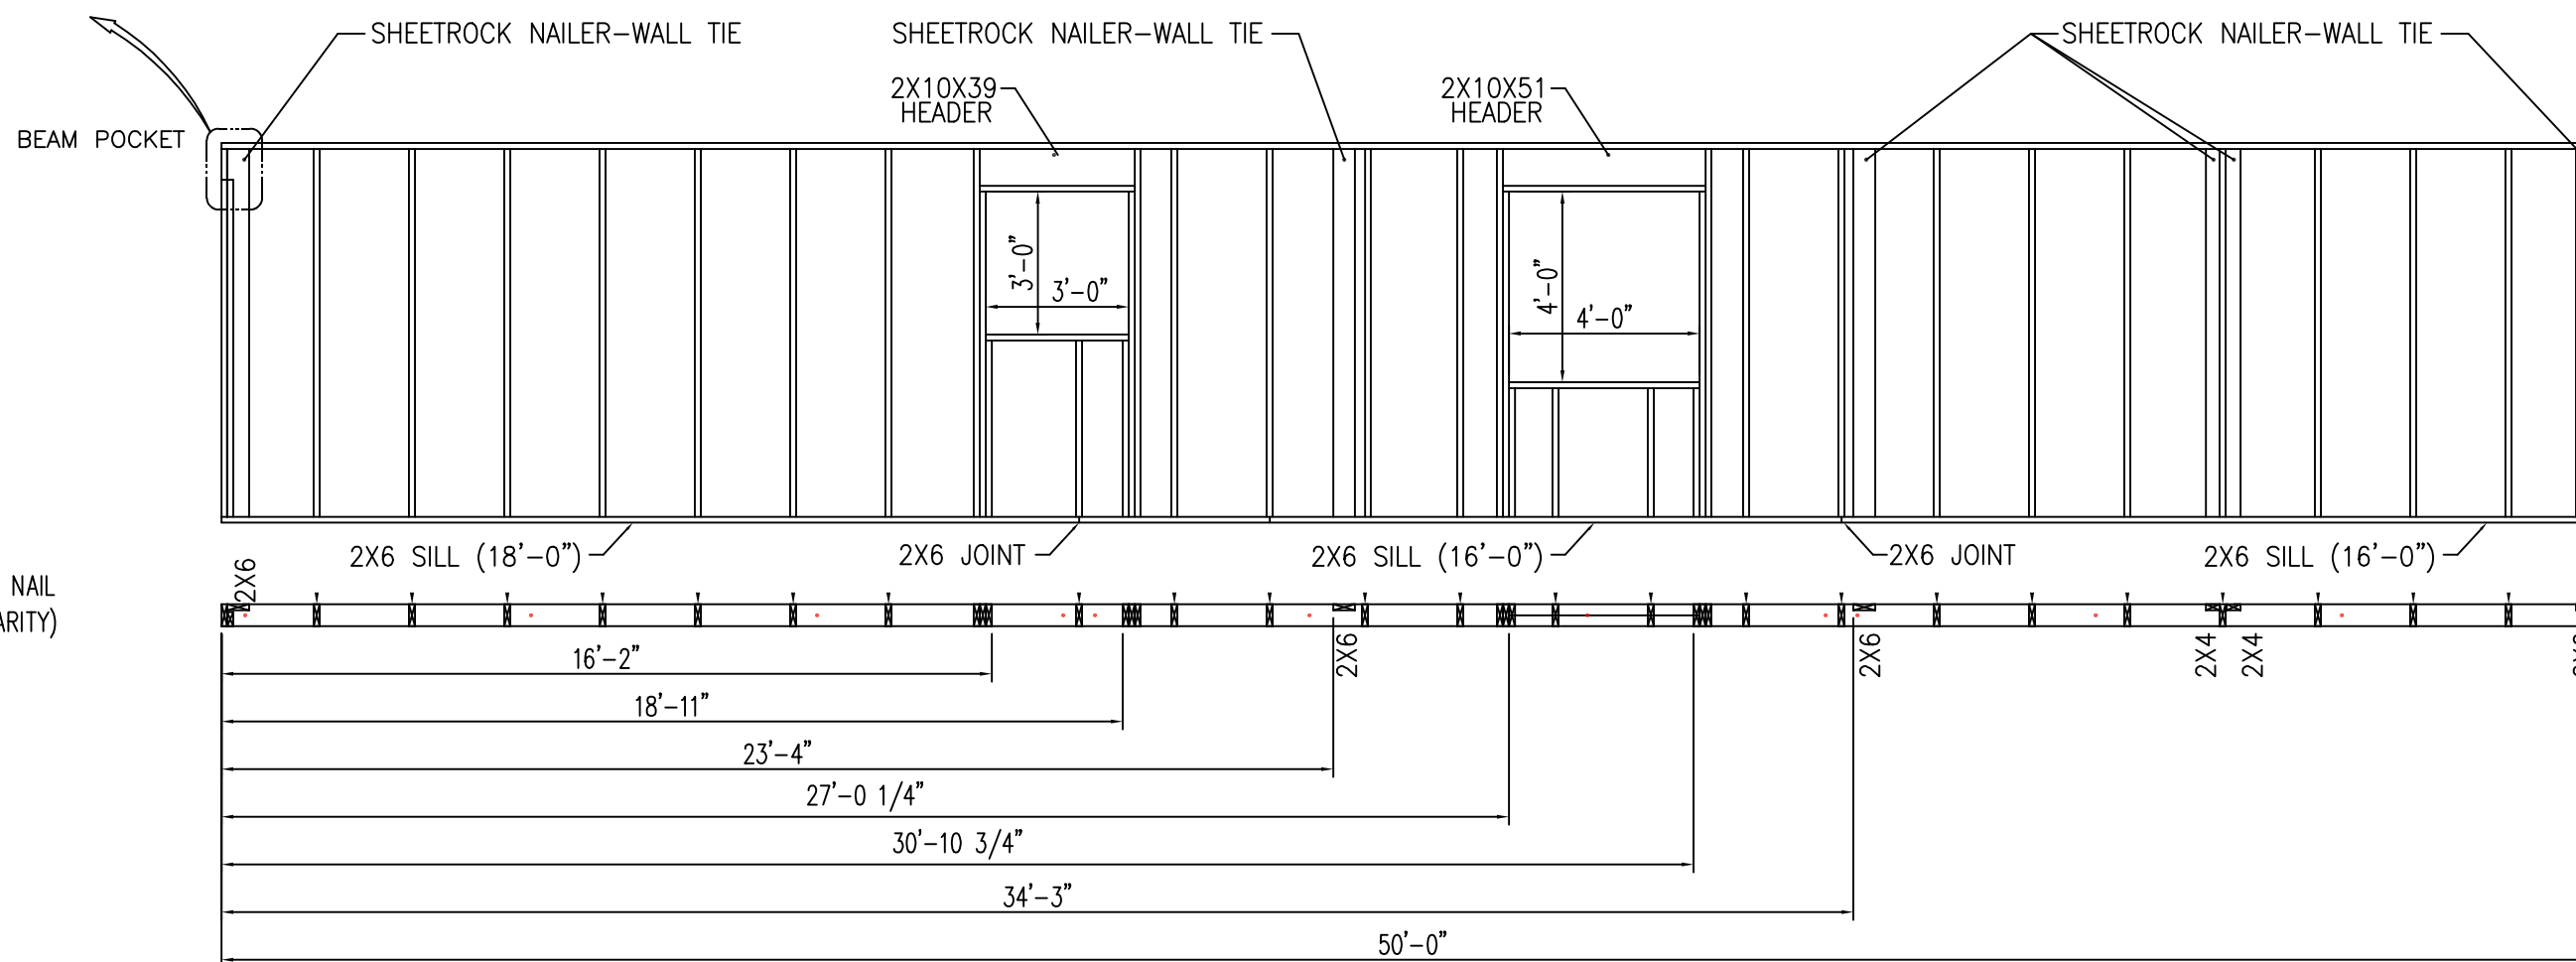
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For:		Checked:		Date:					
		Approved:		Date:		Sheet:	6	Rev:	2
						Scale: 1/4" = 1'			

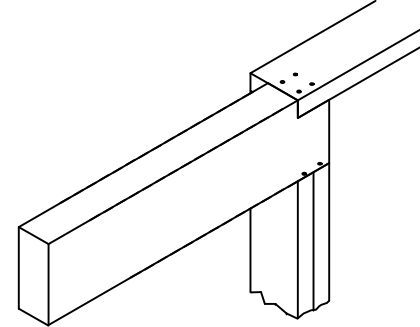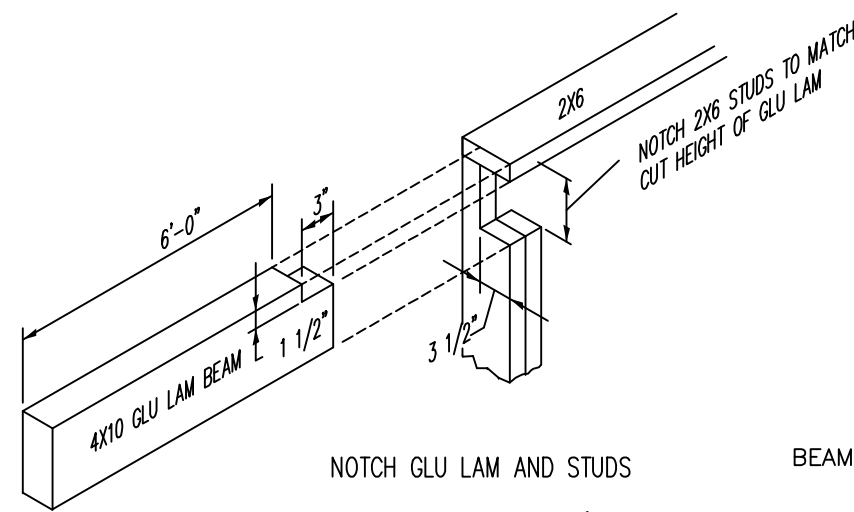


AFTER WALL IS STOOD UP, INSERT GLU LAM AND NAIL  
(TEMPORARY SUPPORT POST NOT SHOWN FOR CLARITY)

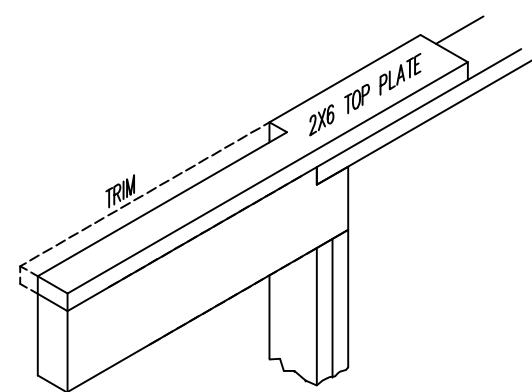


ADD TOP PLATE, TRIM AS REQUIRED





**A** EXTERIOR WALL DETAIL  
5 INDICATES STUD ON 24" CENTER

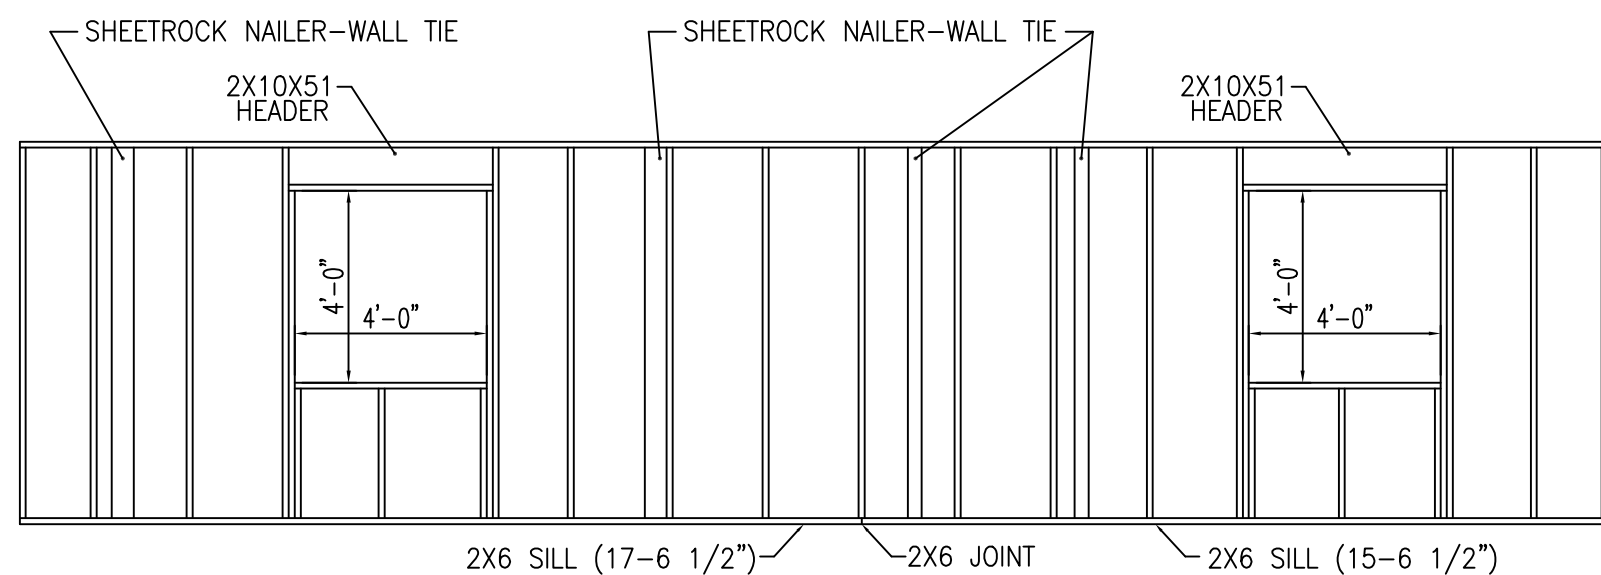

**B** EXTERIOR WALL DETAIL  
5 INDICATES STUD ON 24" CENTER

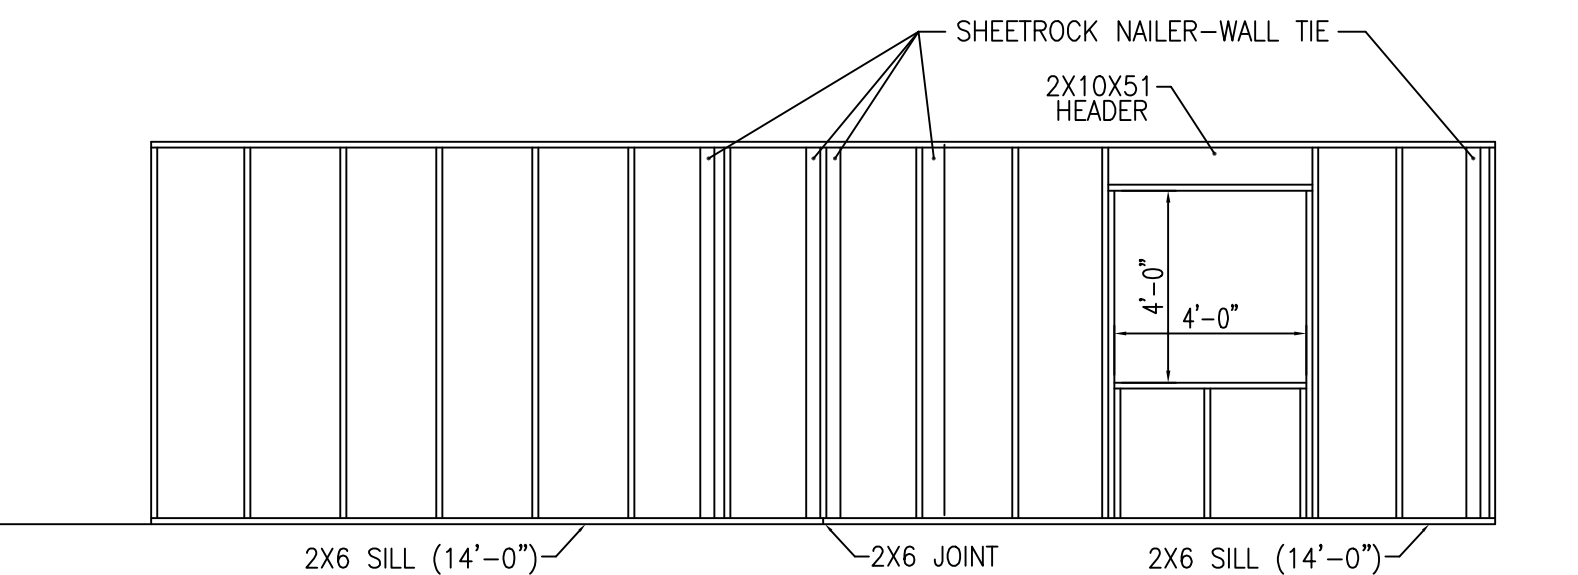


**C** EXTERIOR WALL DETAIL  
5 INDICATES STUD ON 24" CENTER

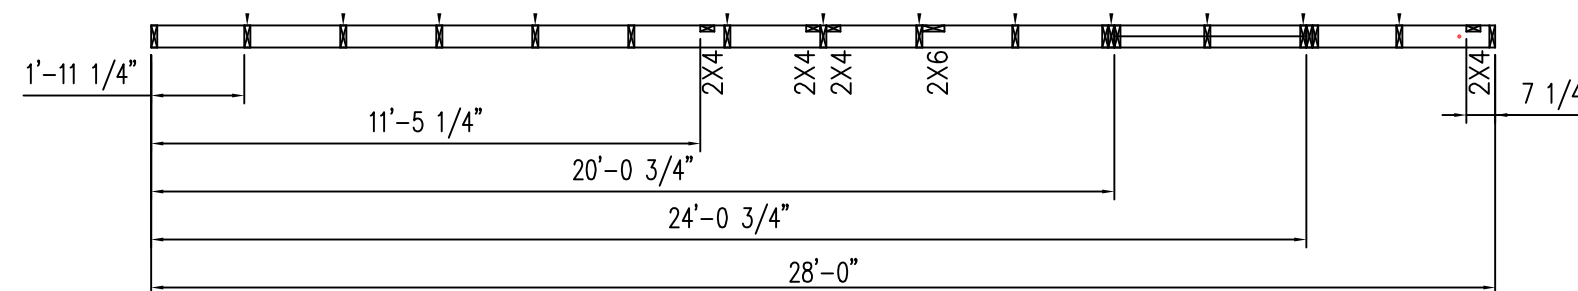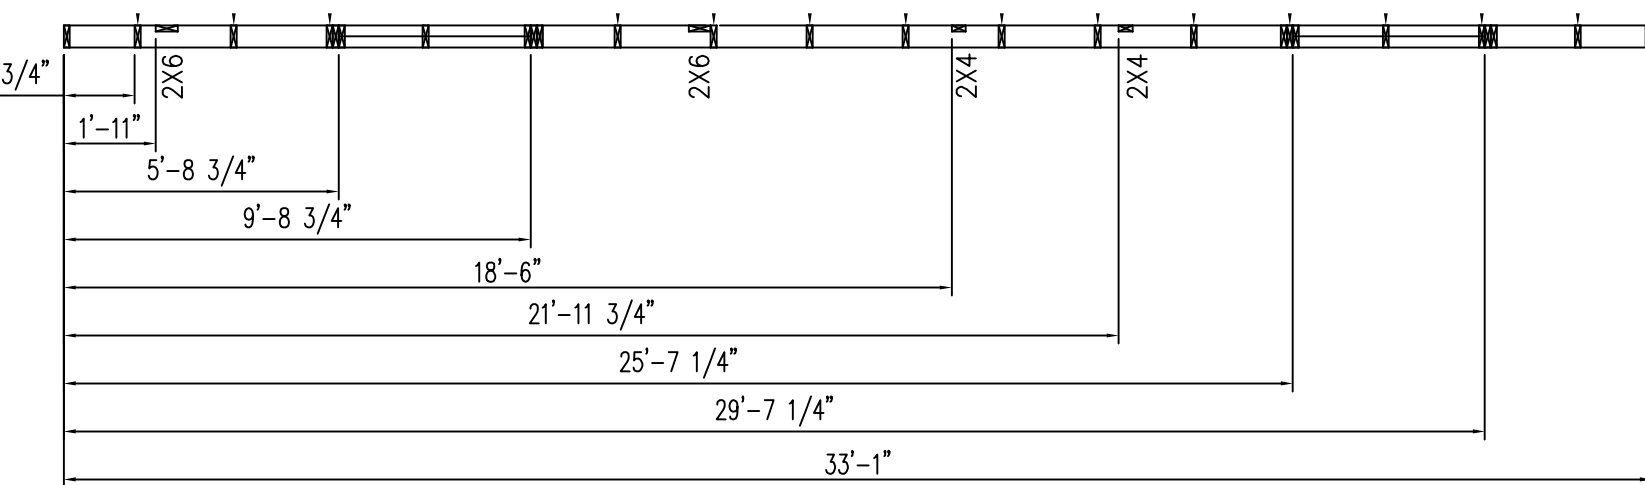


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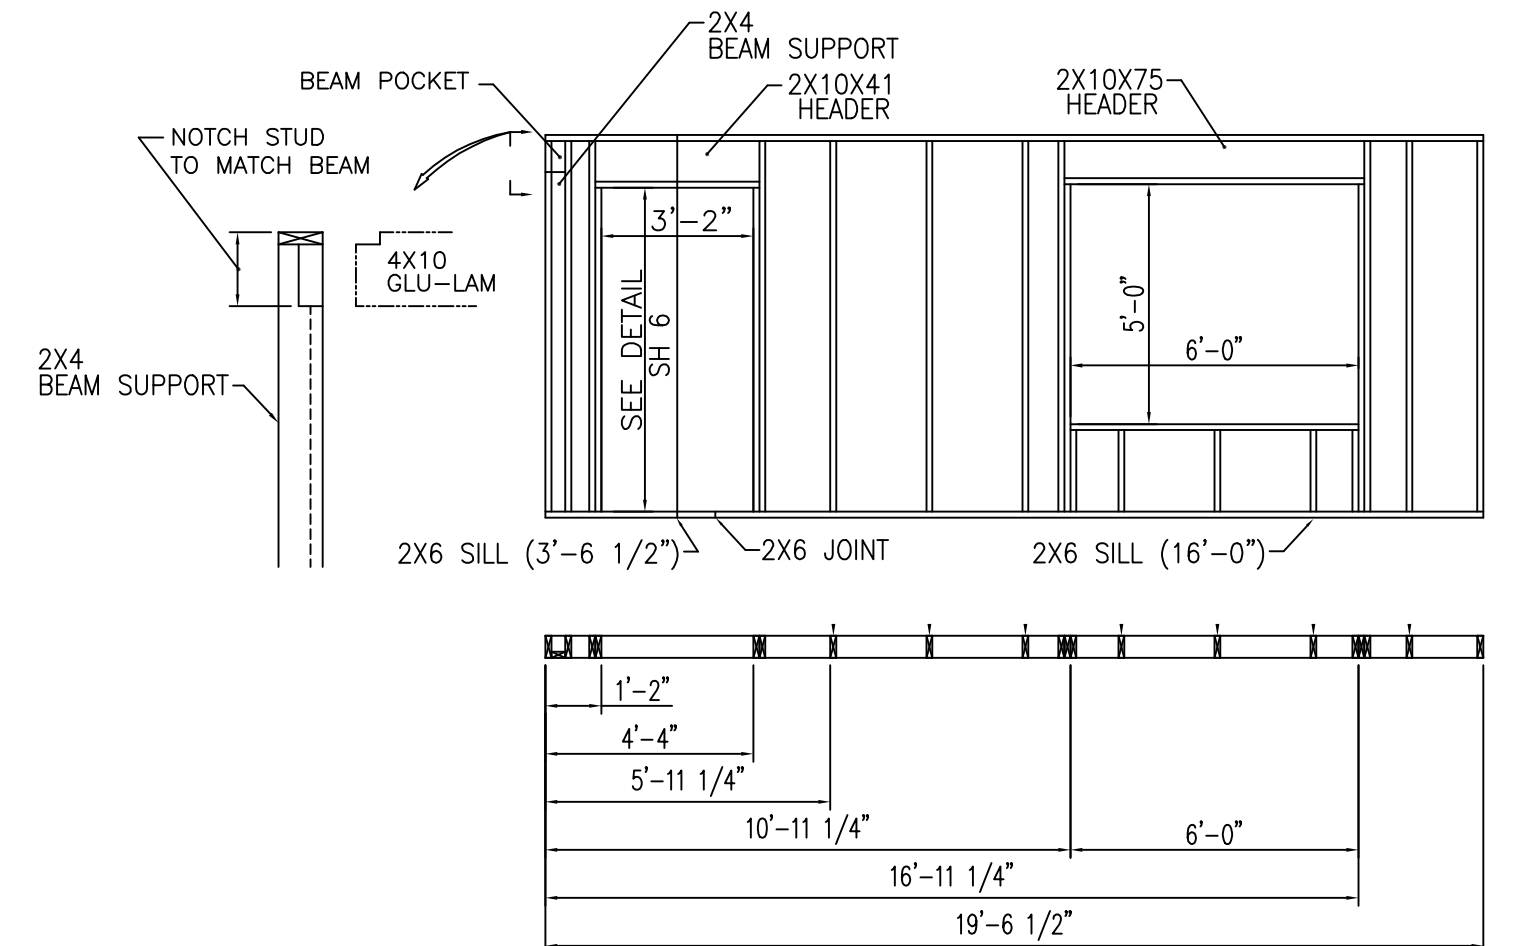
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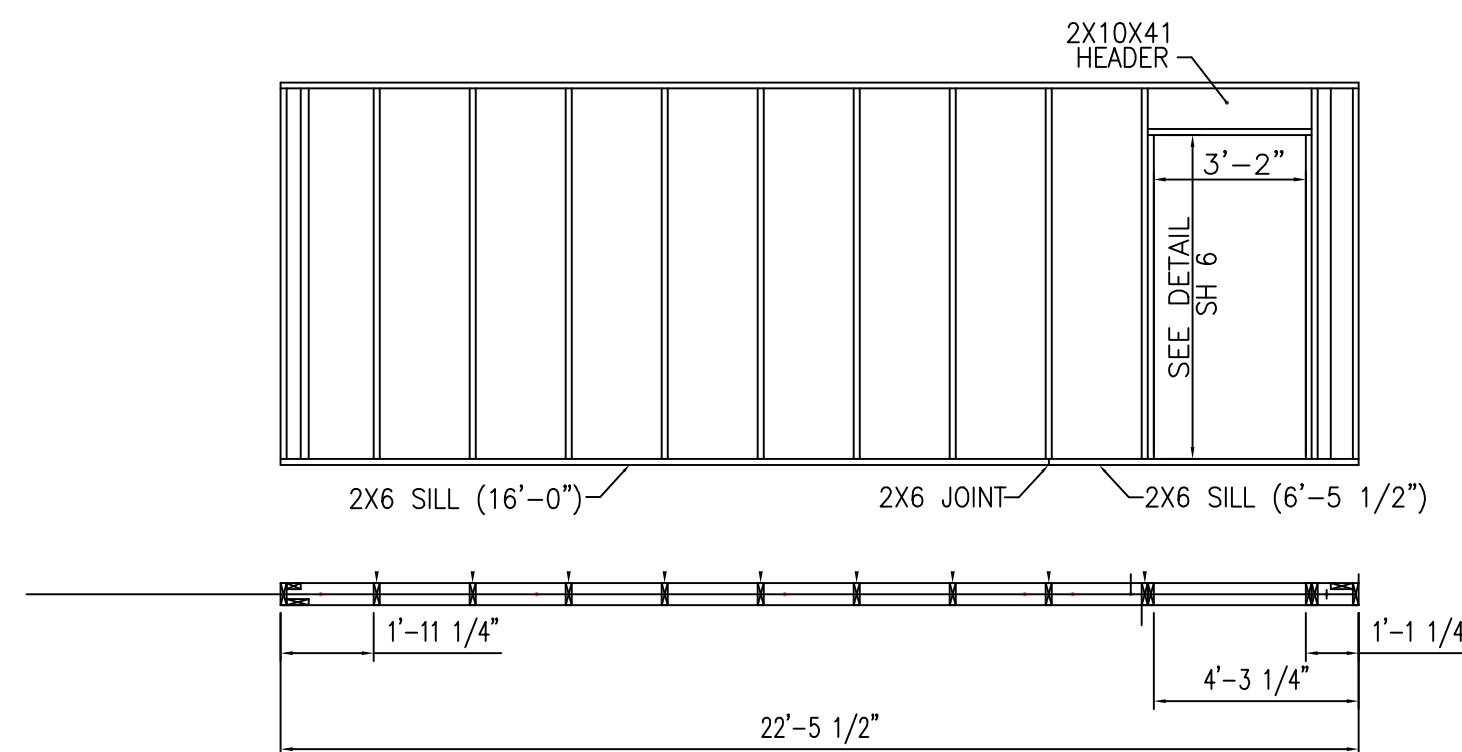
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\*INDICATES STUD ON 24" CENTER

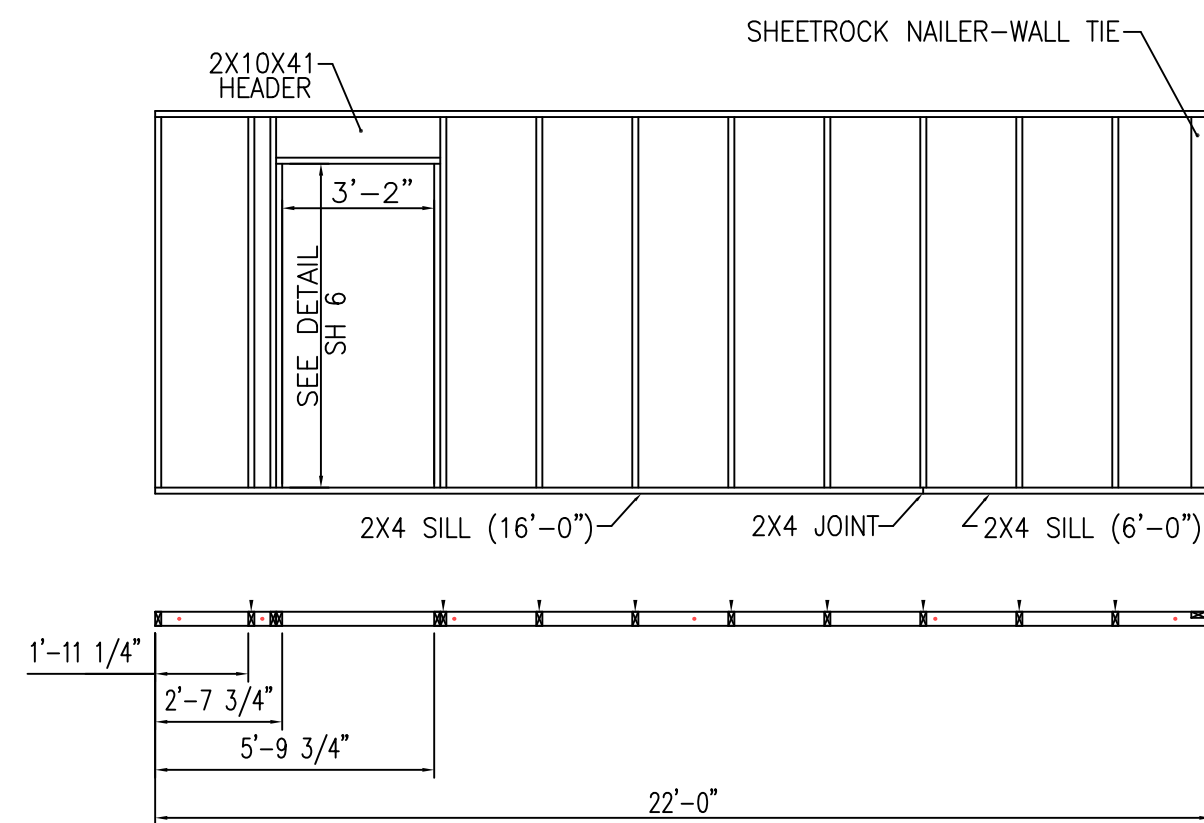


**E**  
5 EXTERIOR WALL DETAIL  
\*INDICATES STUD ON 24" CENTER

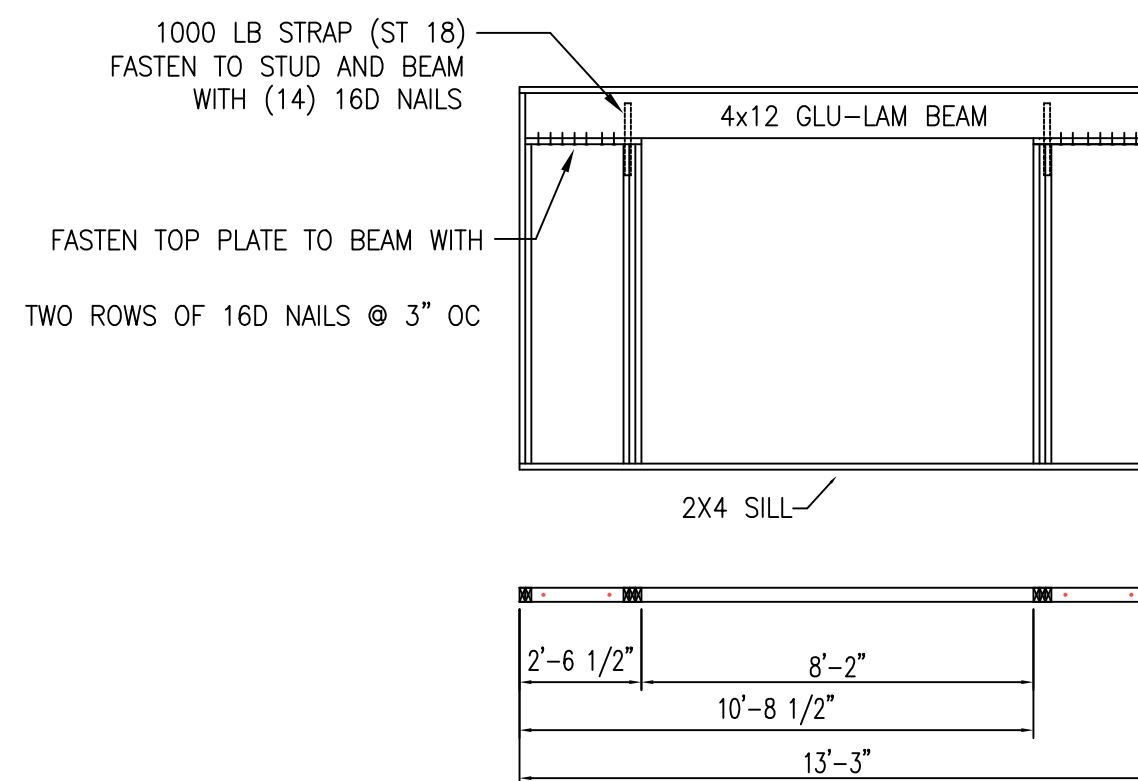

**F**  
5 EXTERIOR WALL DETAIL  
\*INDICATES STUD ON 24" CENTER



**G**  
5 EXTERIOR WALL DETAIL  
\*INDICATES STUD ON 24" CENTER

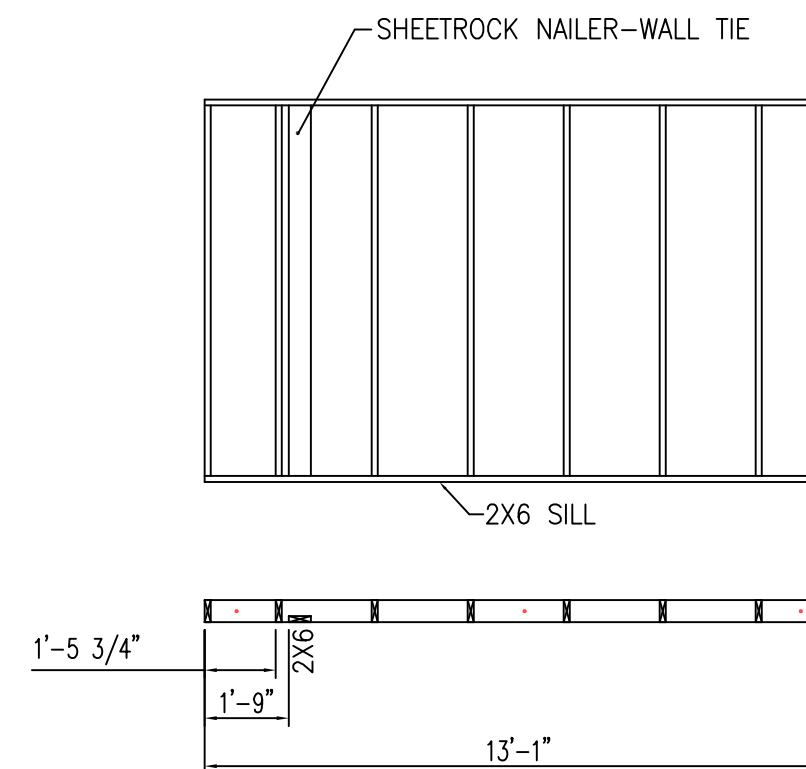

**H**  
5 EXTERIOR WALL DETAIL  
\*INDICATES STUD ON 24" CENTER



SCALE IN FEET



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House Number: TCP-4B2B-U

For:

Drawn: PDR

Checked:

Approved:

Date: 06MAY23

Date:

Date:

Title:


WALL LAY-OUT DETAILS  
D - H

Sheet: 7B


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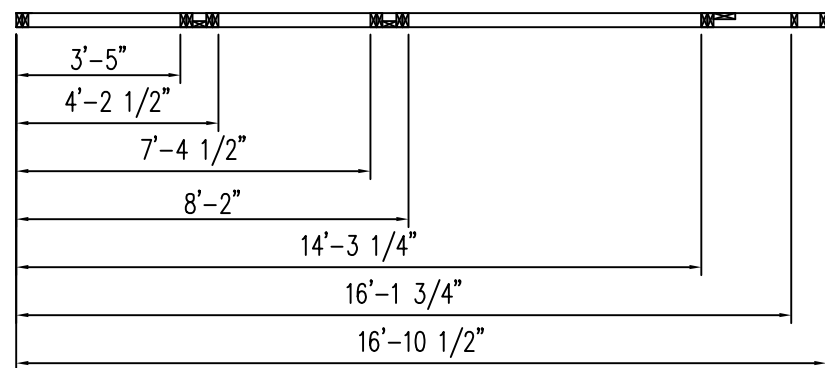
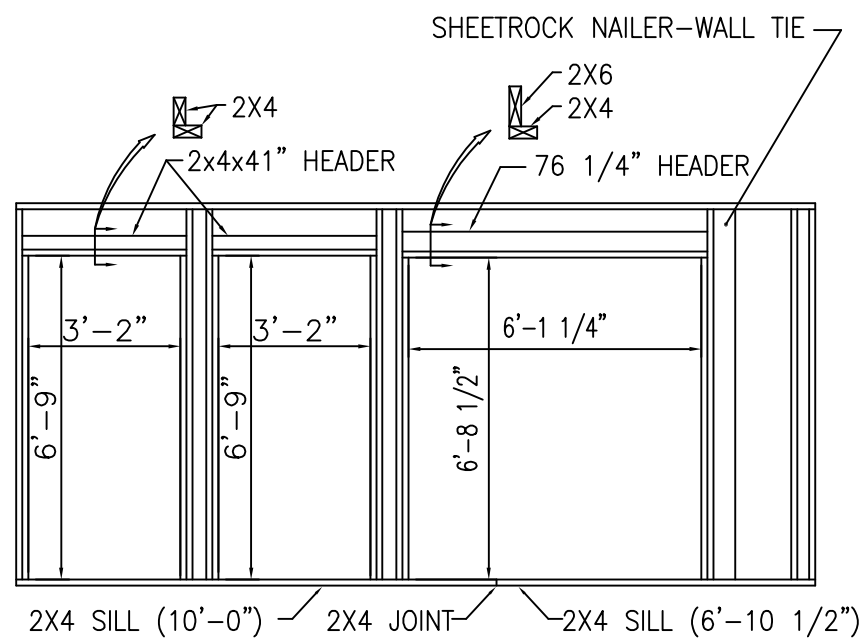


I INTERIOR WALL DETAIL  
J INTERIOR WALL DETAIL  
K INTERIOR WALL DETAIL \*INDICATES STUD ON 16" CENTER  
L INTERIOR WALL DETAIL \*INDICATES STUD ON 16" CENTER  
M INTERIOR WALL DETAIL  
N INTERIOR WALL DETAIL \*INDICATES STUD ON 16" CENTER


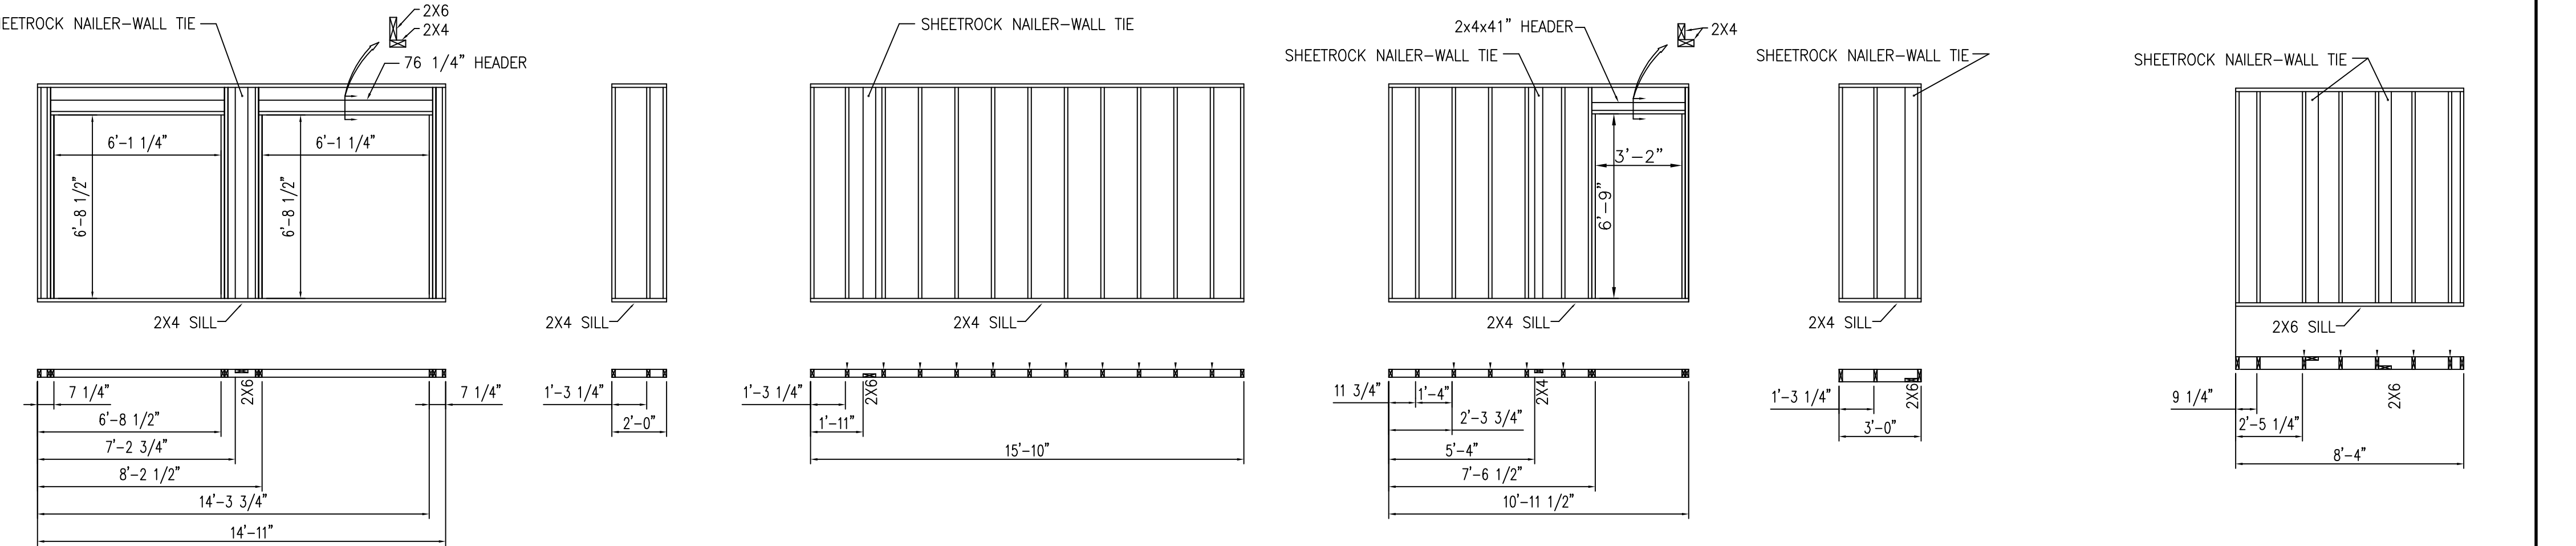


O INTERIOR WALL DETAIL \*INDICATES STUD ON 16" CENTER  
P INTERIOR WALL DETAIL \*INDICATES STUD ON 16" CENTER  
Q INTERIOR WALL DETAIL \*INDICATES STUD ON 16" CENTER  
R INTERIOR WALL DETAIL  
S INTERIOR WALL DETAIL \*INDICATES STUD ON 16" CENTER





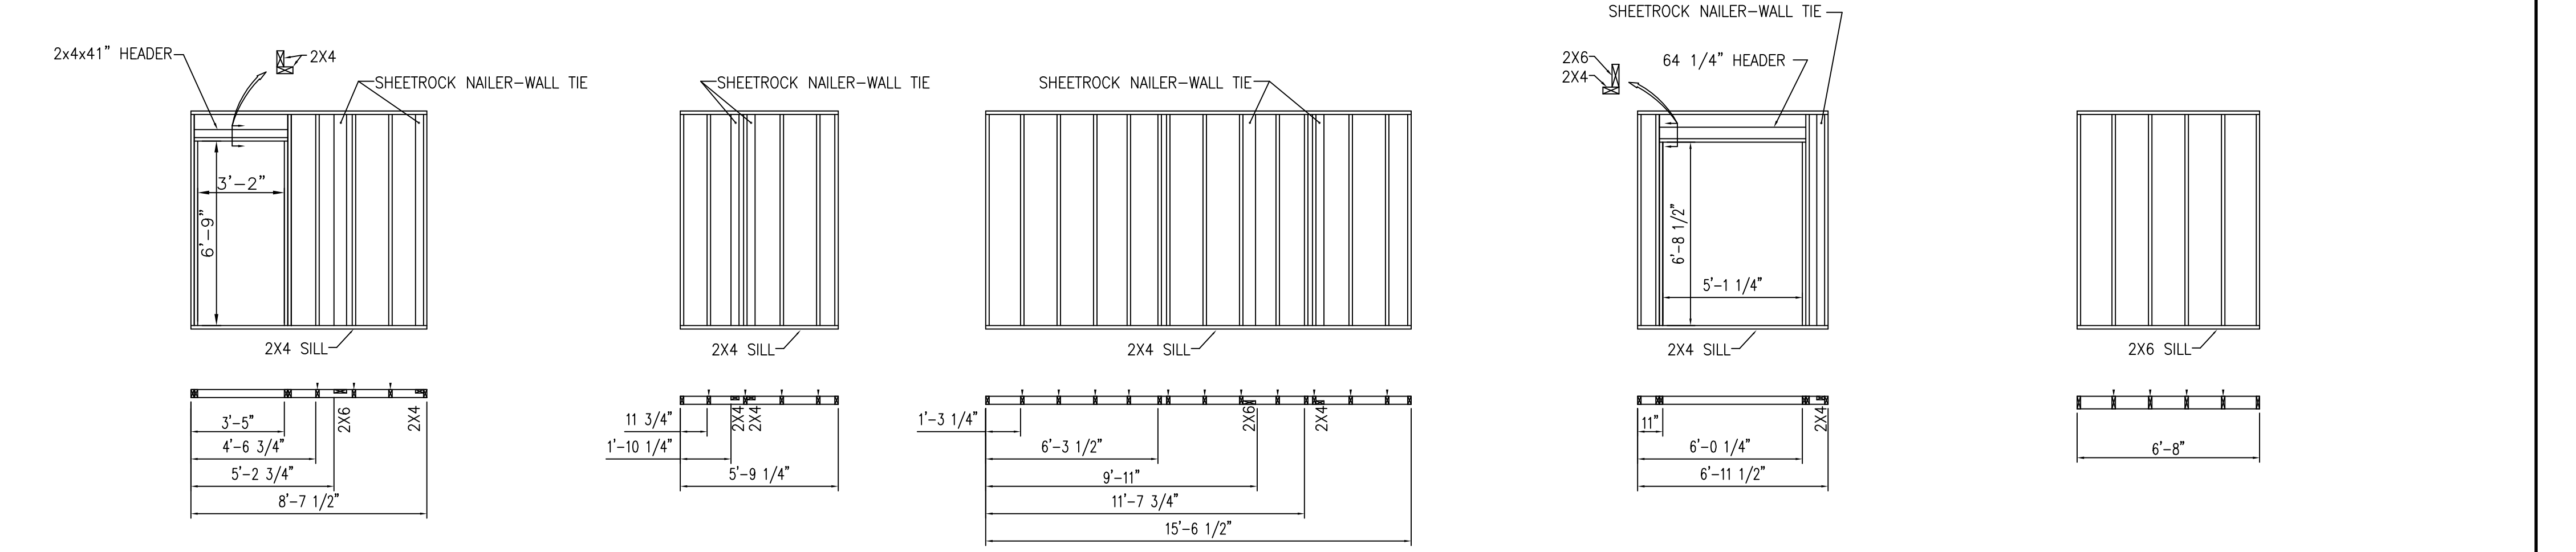



**T**  
5  
INTERIOR WALL DETAIL  
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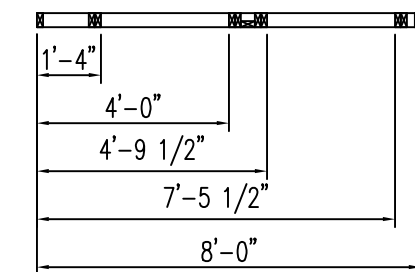
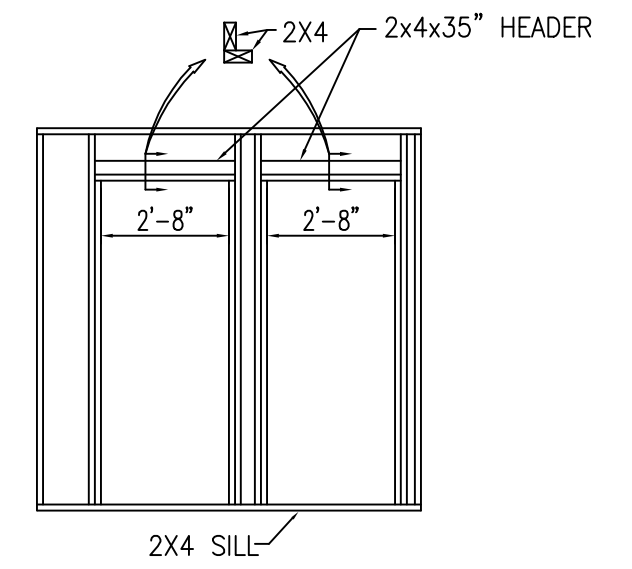
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INTERIOR WALL DETAIL

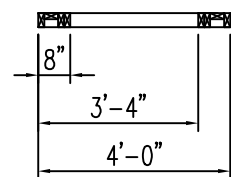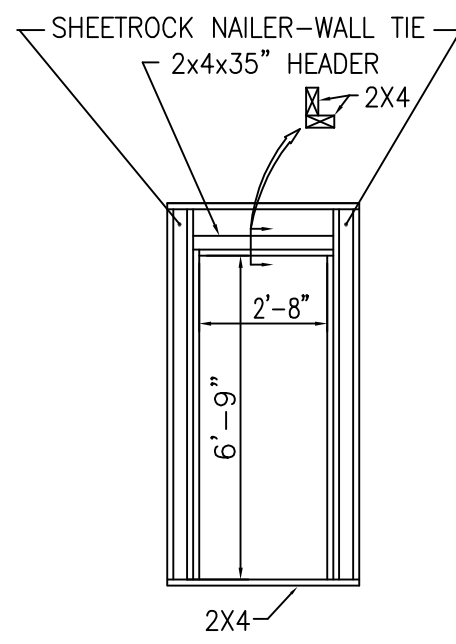



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INTERIOR WALL DETAIL

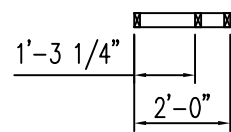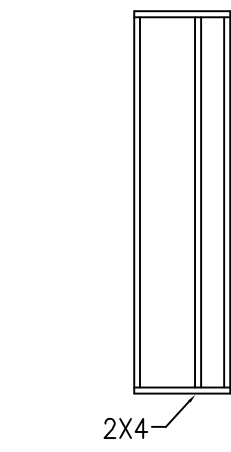



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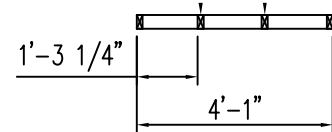
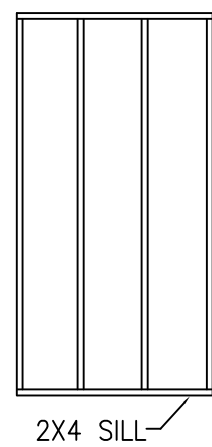
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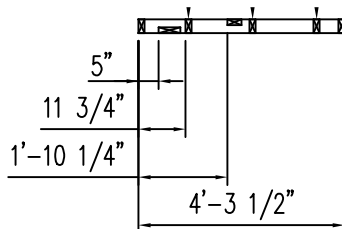
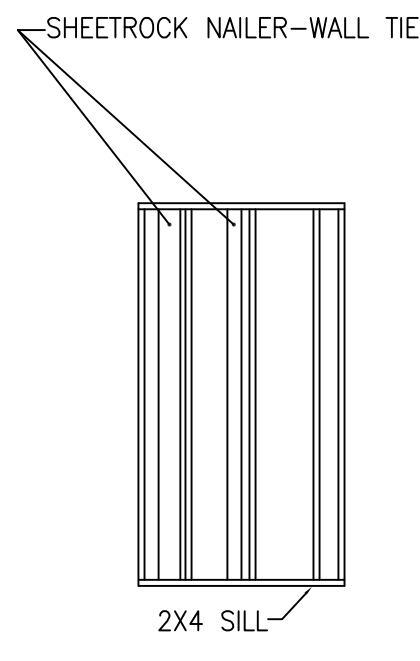
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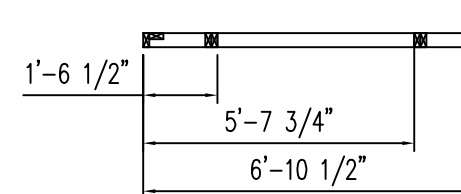
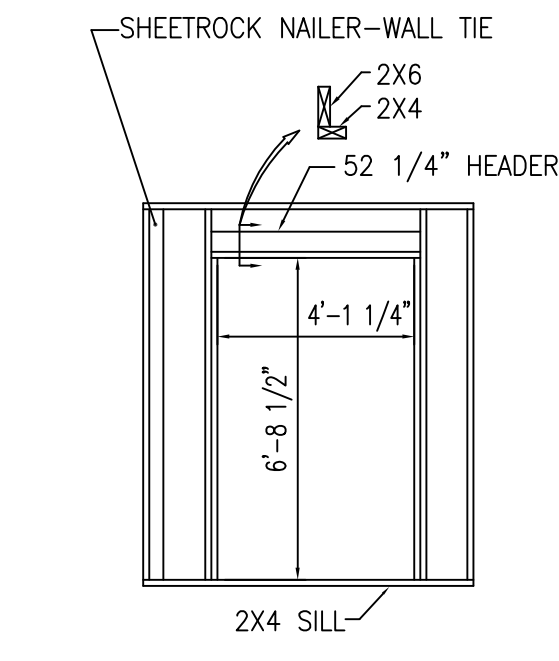
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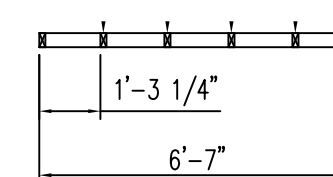
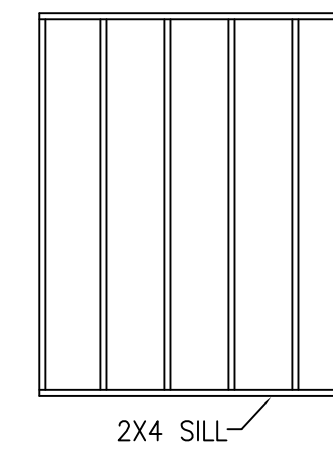
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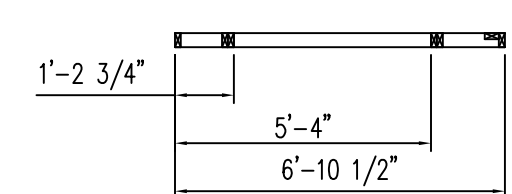
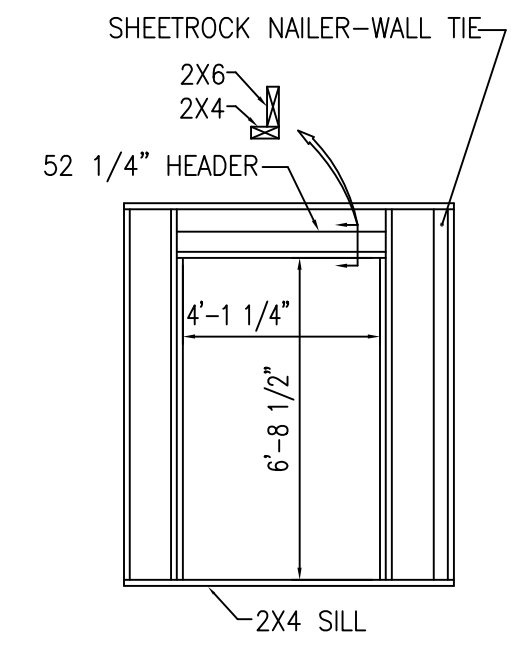
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INTERIOR WALL DETAIL  
\*INDICATES STUD ON 16" CENTER

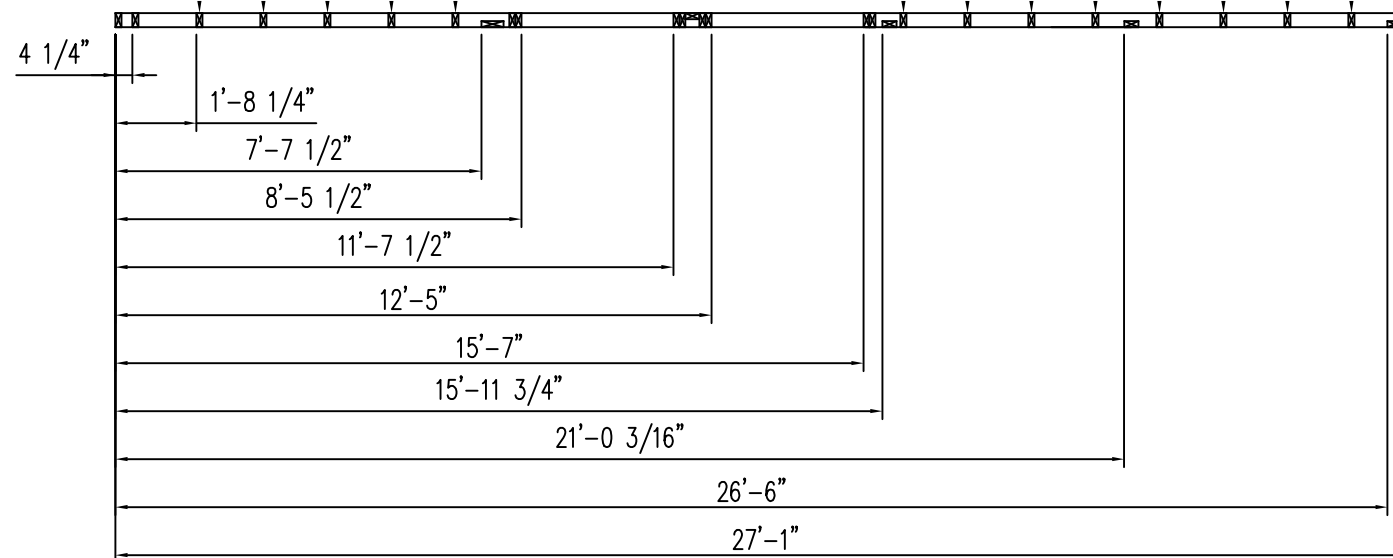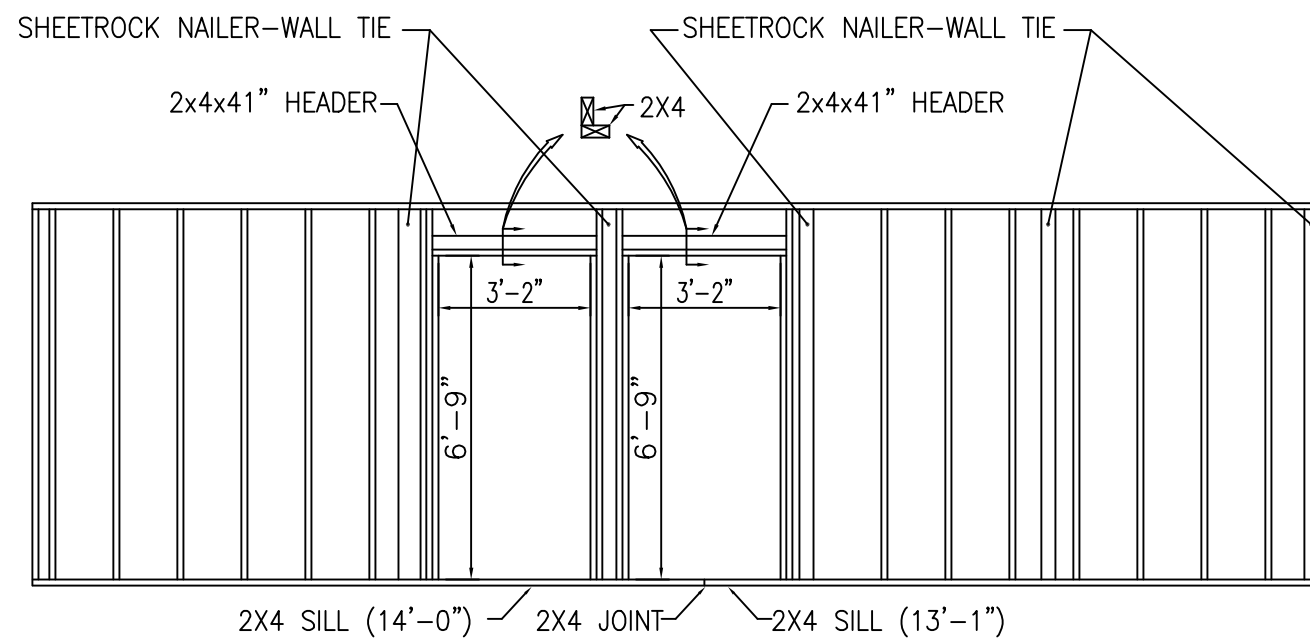

**AC**  
5  
INTERIOR WALL DETAIL

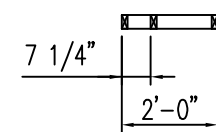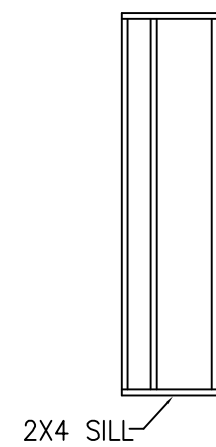

**AD**  
5  
INTERIOR WALL DETAIL  
\*INDICATES STUD ON 16" CENTER

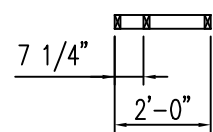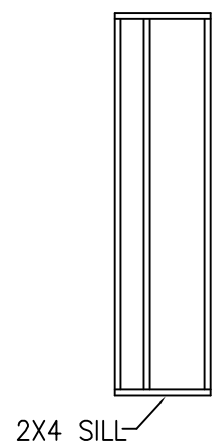

**AE**  
5  
INTERIOR WALL DETAIL  
\*INDICATES STUD ON 16" CENTER



Tri-County Partners  
Habitat for Humanity

House Number: TCP-4B2B-U

For:

Drawn: PDR

Checked:

Approved:

Date: 06MAY23

Date:

Date:


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WALL LAY-OUT DETAILS  
T - AE


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Rev: 2


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House Number: TCP-4B2B-U	Drawn: PDR	Date: 06MAY23	Title: ELEVATIONS FRONT, REAR		
For:	Checked:	Date:			
	Approved:	Date:	Sheet: 8A	Rev: 2	Scale: 1/4" = 1'



- NOTES:
- OSB SHEATHING UNDER LAP SIDING ON CONDITIONED SPACES
  - LAP SIDING ON FRONT FACADE & GABLES
  - T-111 SIDING WHERE INDICATED
  - 5/4 TRIM MATERIAL ON WINDOWS AND OUTSIDE CORNERS
  - 2"x2" CEDAR TRIM ON INSIDE CORNERS
  - 2"x2" CEDAR TRIM CENTER OF GABLES
  - 6" LAP SIDING FOR FASCIA
  - APPARENT SIZE OF FRONT/REAR PATIOS FOR INDICATION ONLY
  - SIDING TYPE TO BE DETERMINED BY BUILDING COMMITTEE
  - ROOFING COLOR AND TYPE DETERMINED BY BUILDING COMMITTEE

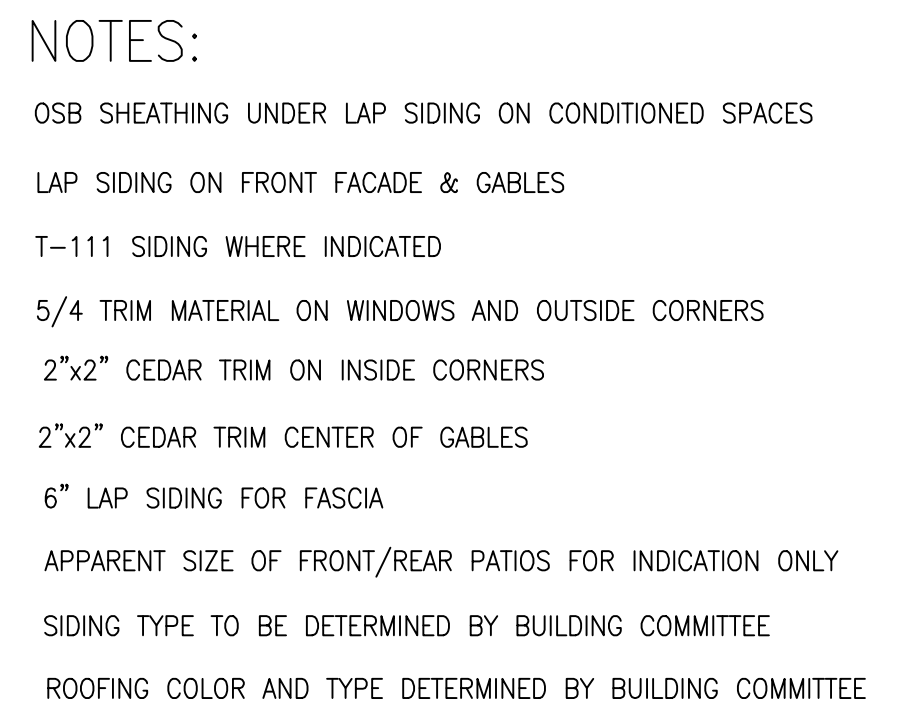
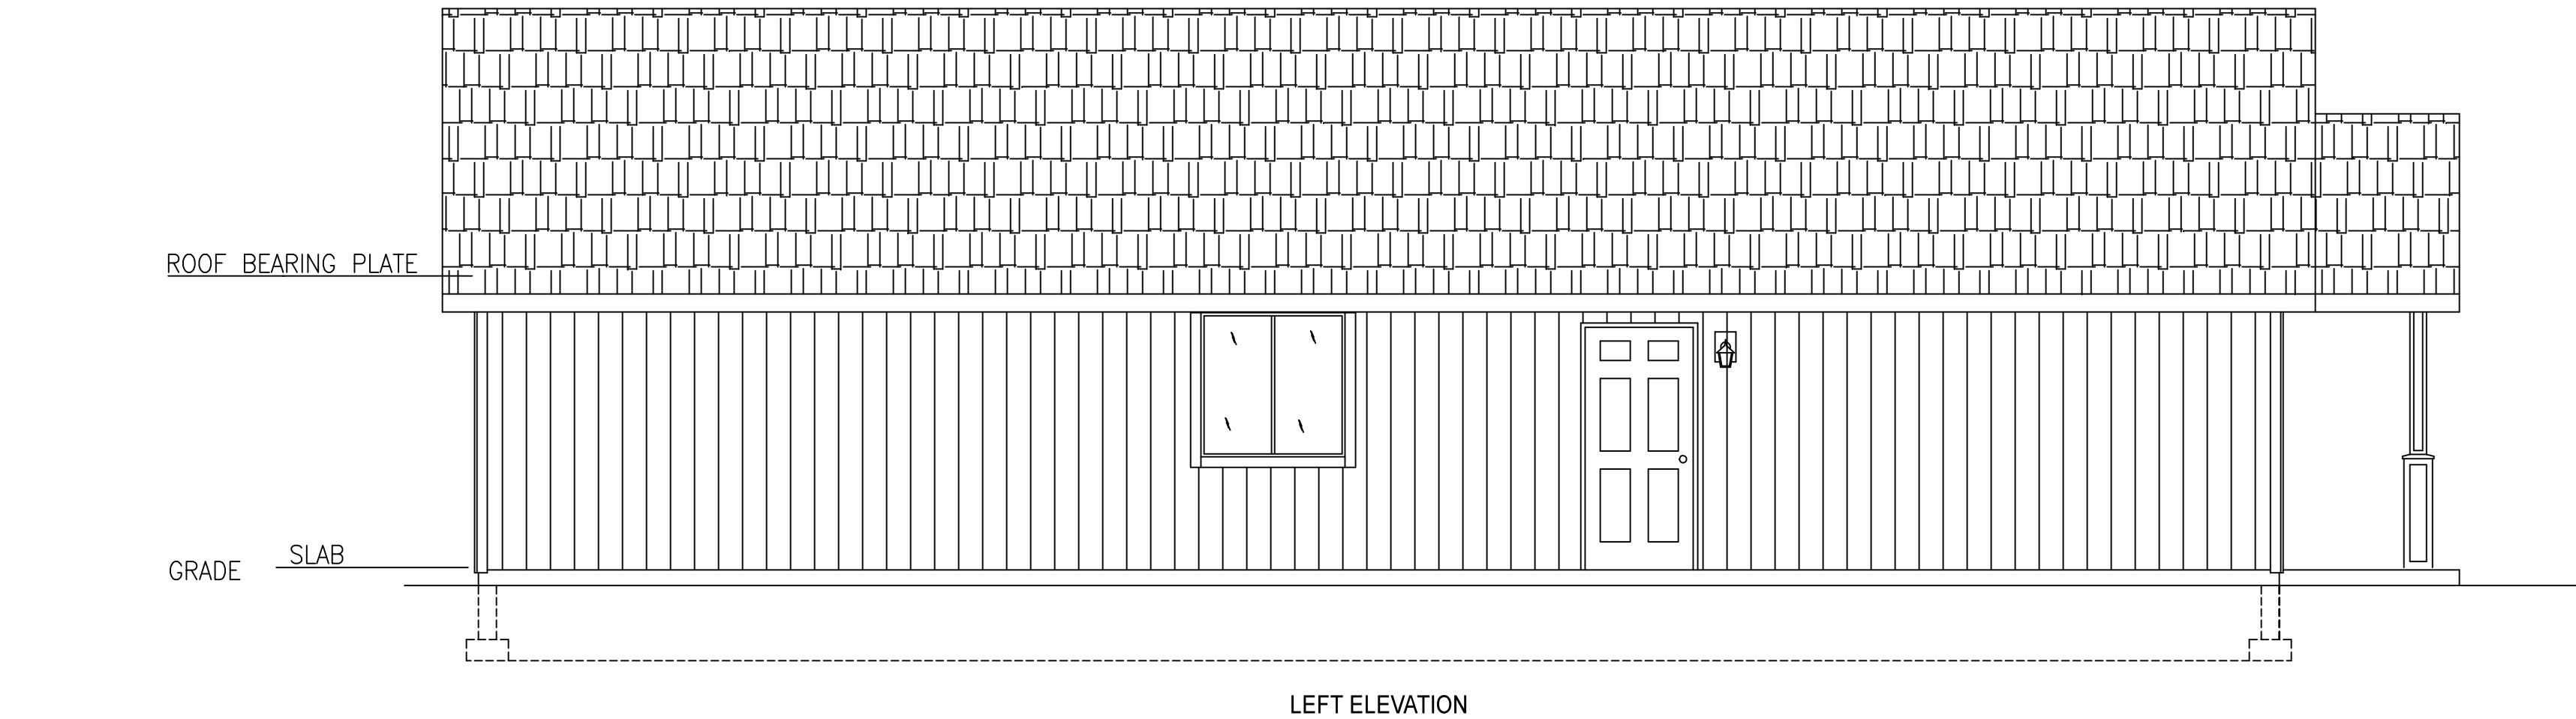
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House Number:	TCP-4B2B-U	Drawn:	PDR	Date:	06MAY23	ELEVATIONS RIGHT, LEFT			
For:		Checked:		Date:					
		Approved:		Date:		Sheet:	8B	Rev:	2
						Scale: 1/4" = 1'			

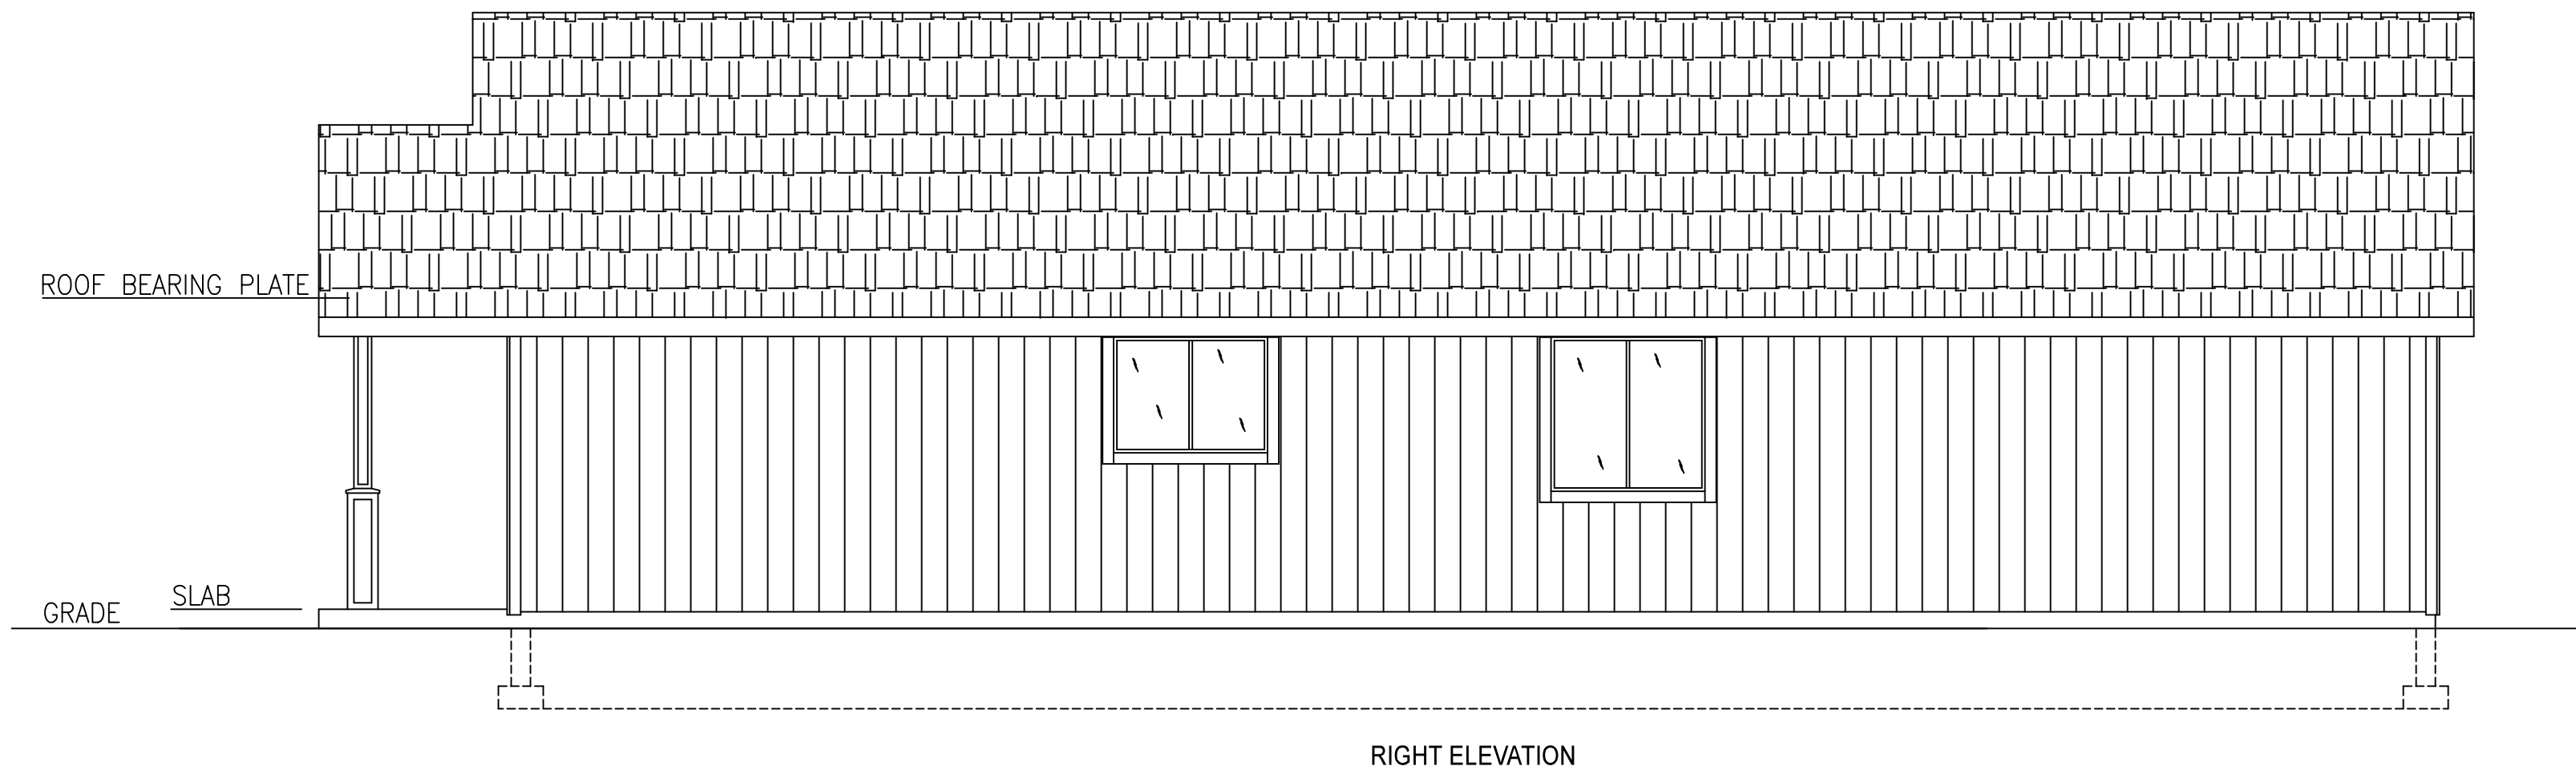NOTES:


- ⦿<sub>A</sub> EXHAUST FAN
- ⦿<sub>B</sub> WATER HEATER BRANCH CIRCUIT
- ⦿<sub>C</sub> KITCHEN EXHAUST FAN 100 CFM
- ⦿<sub>D</sub> MINI-SPLIT HEATING SYSTEM
- ⦿<sub>E</sub> DRYER BRANCH CIRCUIT
- ◼ DOOR CHIME PUSH BUTTON
- CH DOOR CHIME
- ⦿<sub>WP</sub> WEATHERPROOF GFCI PROTECTED
- GFCI GFCI PROTECTED CIRCUIT
- ⦿<sub>R</sub> 220V RANGE RECEPTACLE
- 3 CONDUCTOR RACEWAY
- ⦿<sub>T</sub> RECEPTACLE FOR DOOR CHIME TRANSFORMER  
85" TO BOTTOM OF BOX
- ⦿<sub>W</sub> DEDICATED RECEPTACLE FOR DISHWASHER.  
LOCATE UNDER SINK.
- SURFACE MOUNTED CEILING FIXTURE
- WALL MOUNTED FIXTURE
- <sub>SD</sub> SMOKE DETECTOR
- <sub>SD/CO</sub> COMBO SD/CARBON MONOXIDE DETECTOR
- <sub>HD</sub> HEAT DETECTOR

NOTES

1. REINFORCE ALL BEDROOM CEILING BOXES FOR CEILING FAN (CF)
2. HFH WILL PROVIDE SE PANEL, BREAKERS, AND LIGHT FIXTURES
3. HVAC CONTRACTOR WILL PROVIDE EXHAUST FANS, DUCT WORK, AND MINI SPLIT
4. ELECTRICAL CONTRACTOR TO FURNISH AND INSTALL CADET-TYPE THERMOSTAT CONTROLLED WALL HEATER IN EACH BEDROOM. LOCATE THERMOSTAT 60" ABOVE FLOOR
5. ELECTRICAL CONTRACTOR TO PROVIDE 3 TEMPORARY RECEPTACLES FOR CONSTRUCTION
6. LOCATE RECEPTACLES FOR DISHWASHER AND DISPOSAL UNDER SINK (SWITCH FOR DISPOSAL AT SINK)
7. LOCATE RECEPTACLES FOR WASHER AND DRYER 46" TO TOP OF BOX
8. LOCATE RECEPTACLE FOR MICROWAVE 79" TO TOP OFF BOX

ATTENTION:

THE SOLE PURPOSE OF THIS DRAWING IS TO ASSIST THE ELECTRICAL CONTRACTOR/ADMINISTRATOR. THE DRAWING IS NOT PRESENTED AS BEING A CODE COMPLIANT DESIGN FOR THIS RESIDENCE.

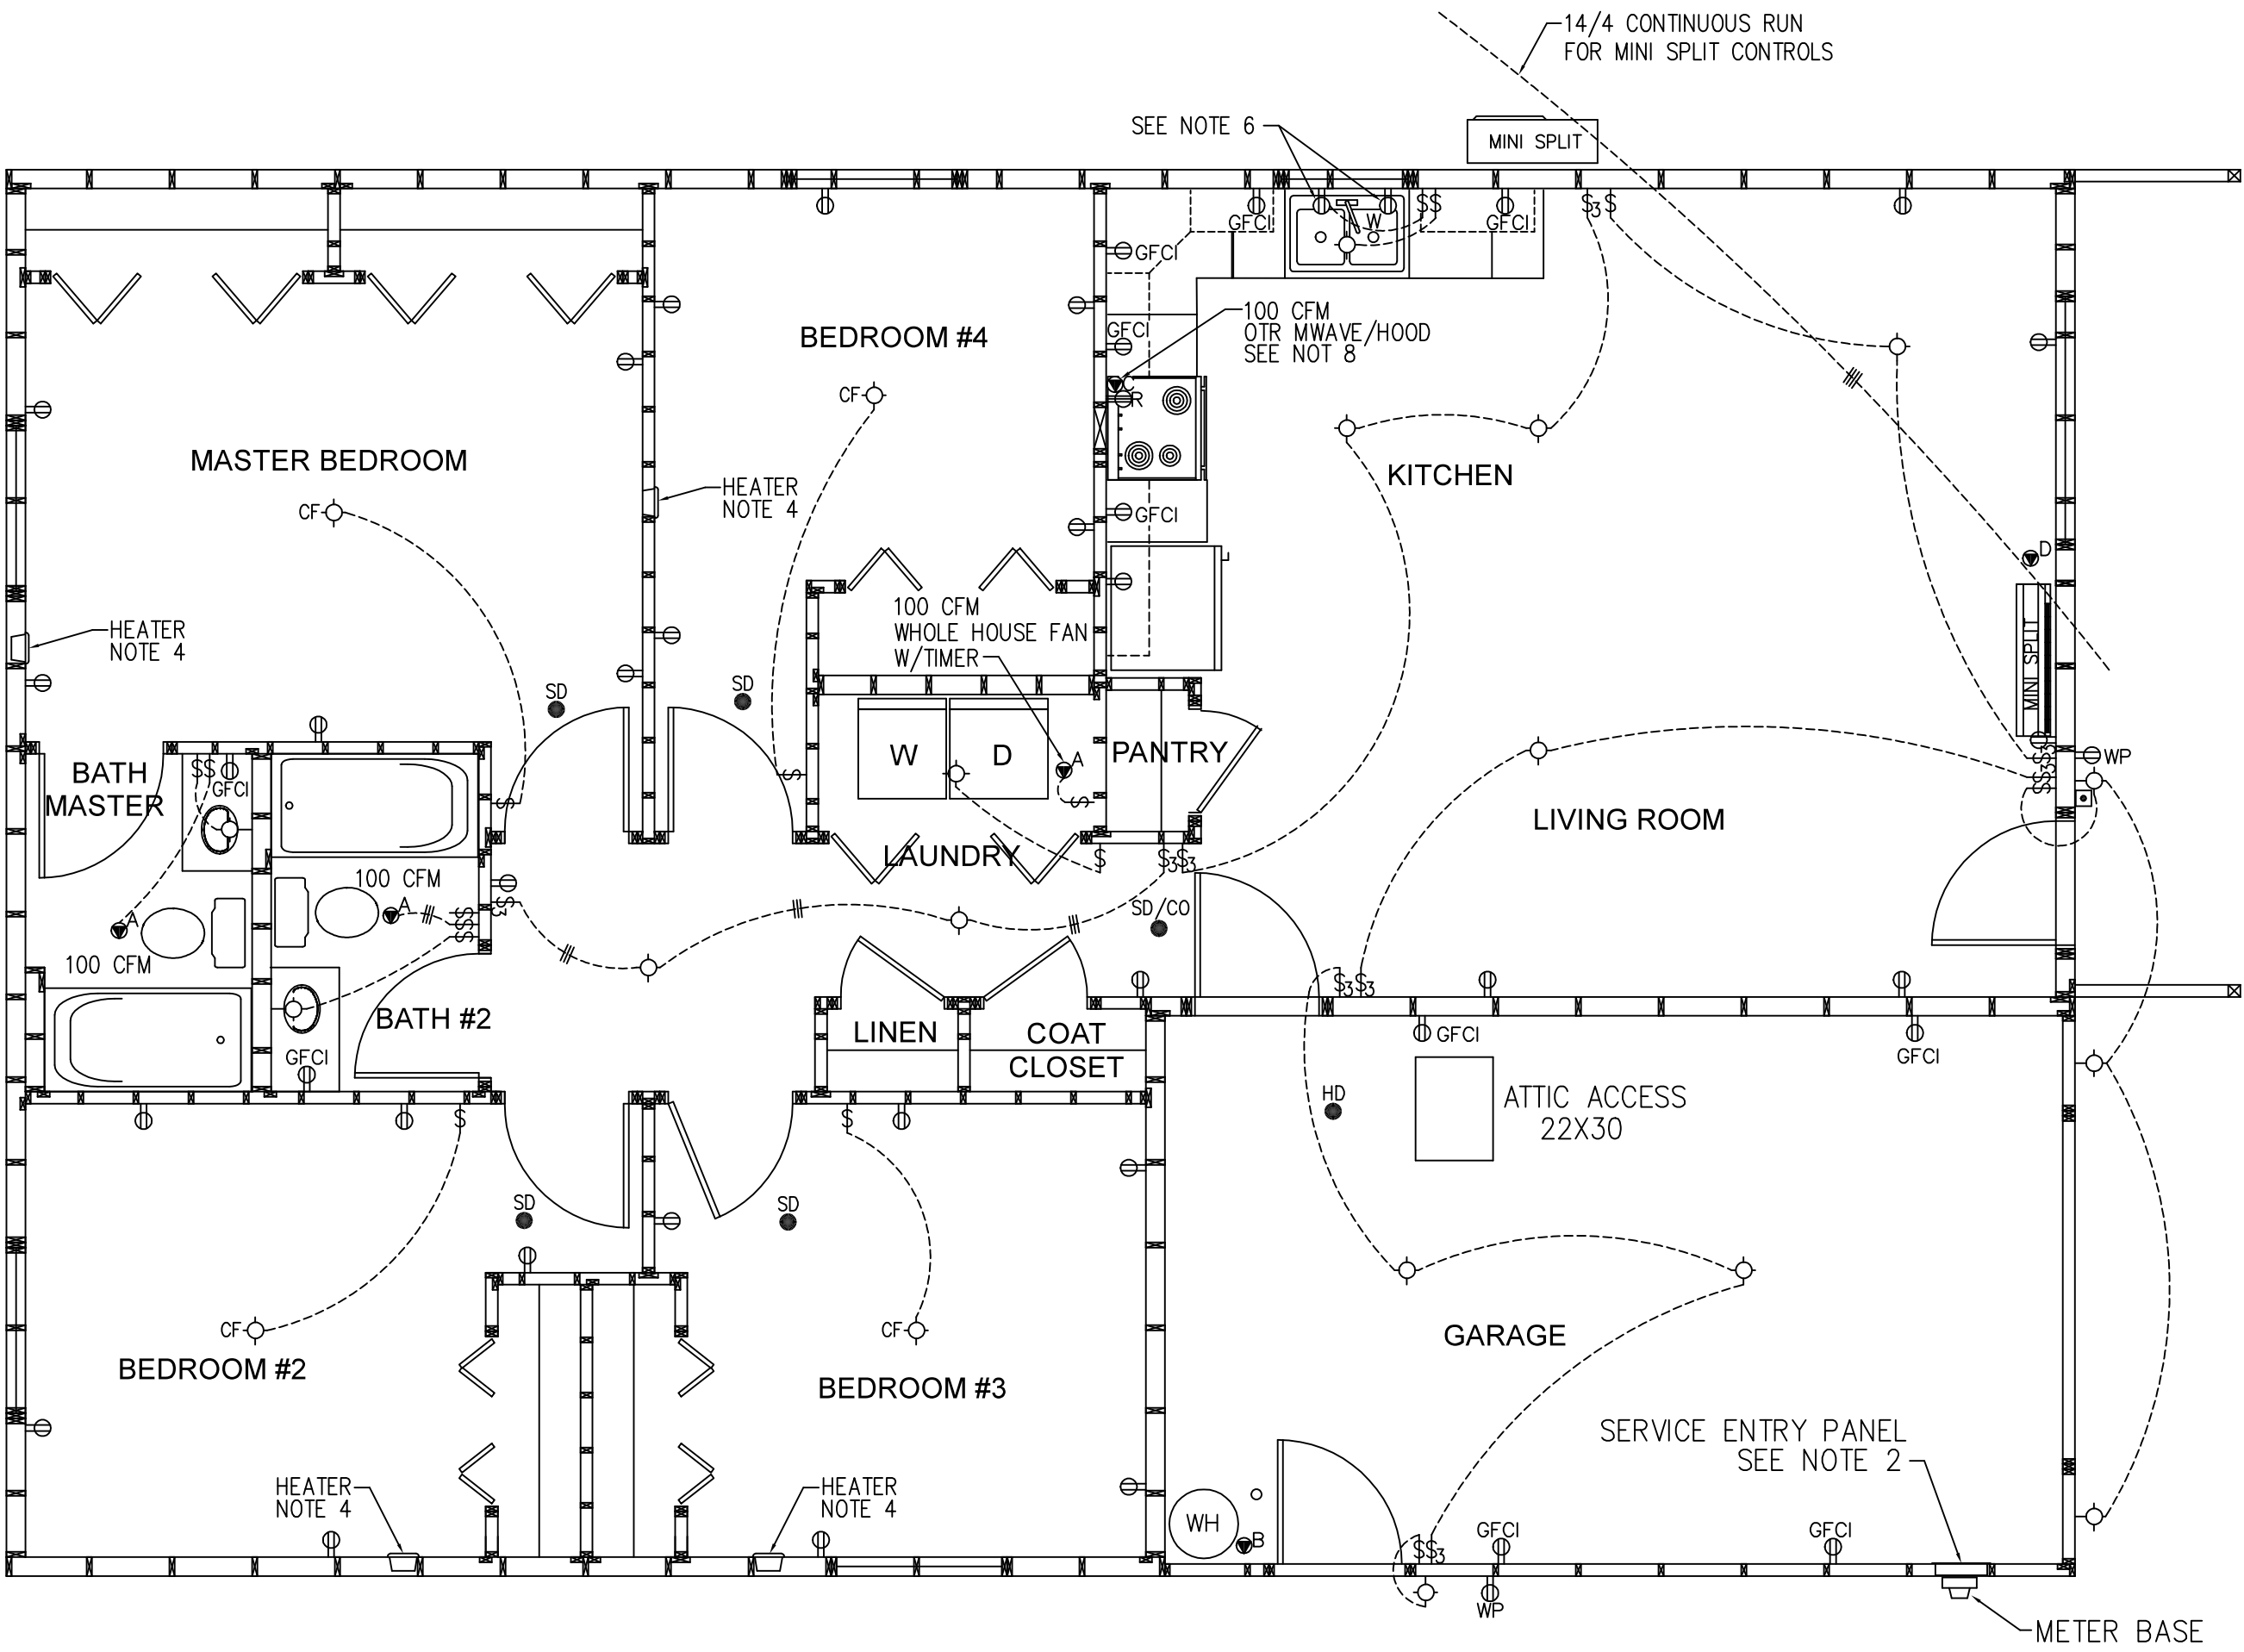


Tri-County Partners  
Habitat for Humanity

House Number:	TCP-4B2B-U	Drawn:	PDR	Date:	06MAY23	Title:  ELECTRICAL PLAN		
For:		Checked:		Date:				
		Approved:		Date:		Sheet:	9	Rev: 2
						Scale: 1/4" = 1'		



NOTES:

- DIMENSIONS FROM INSIDE OF FORM
- HOUSE SHUT OFF VALVE TO LOCATED IN WASHER/DRYER ALCOVE
- HOSE BIBS IN FRONT AND REAR
- HOSE BIBS TO BE ANTI-FREEZE & ANTI-SYPHON TYPE

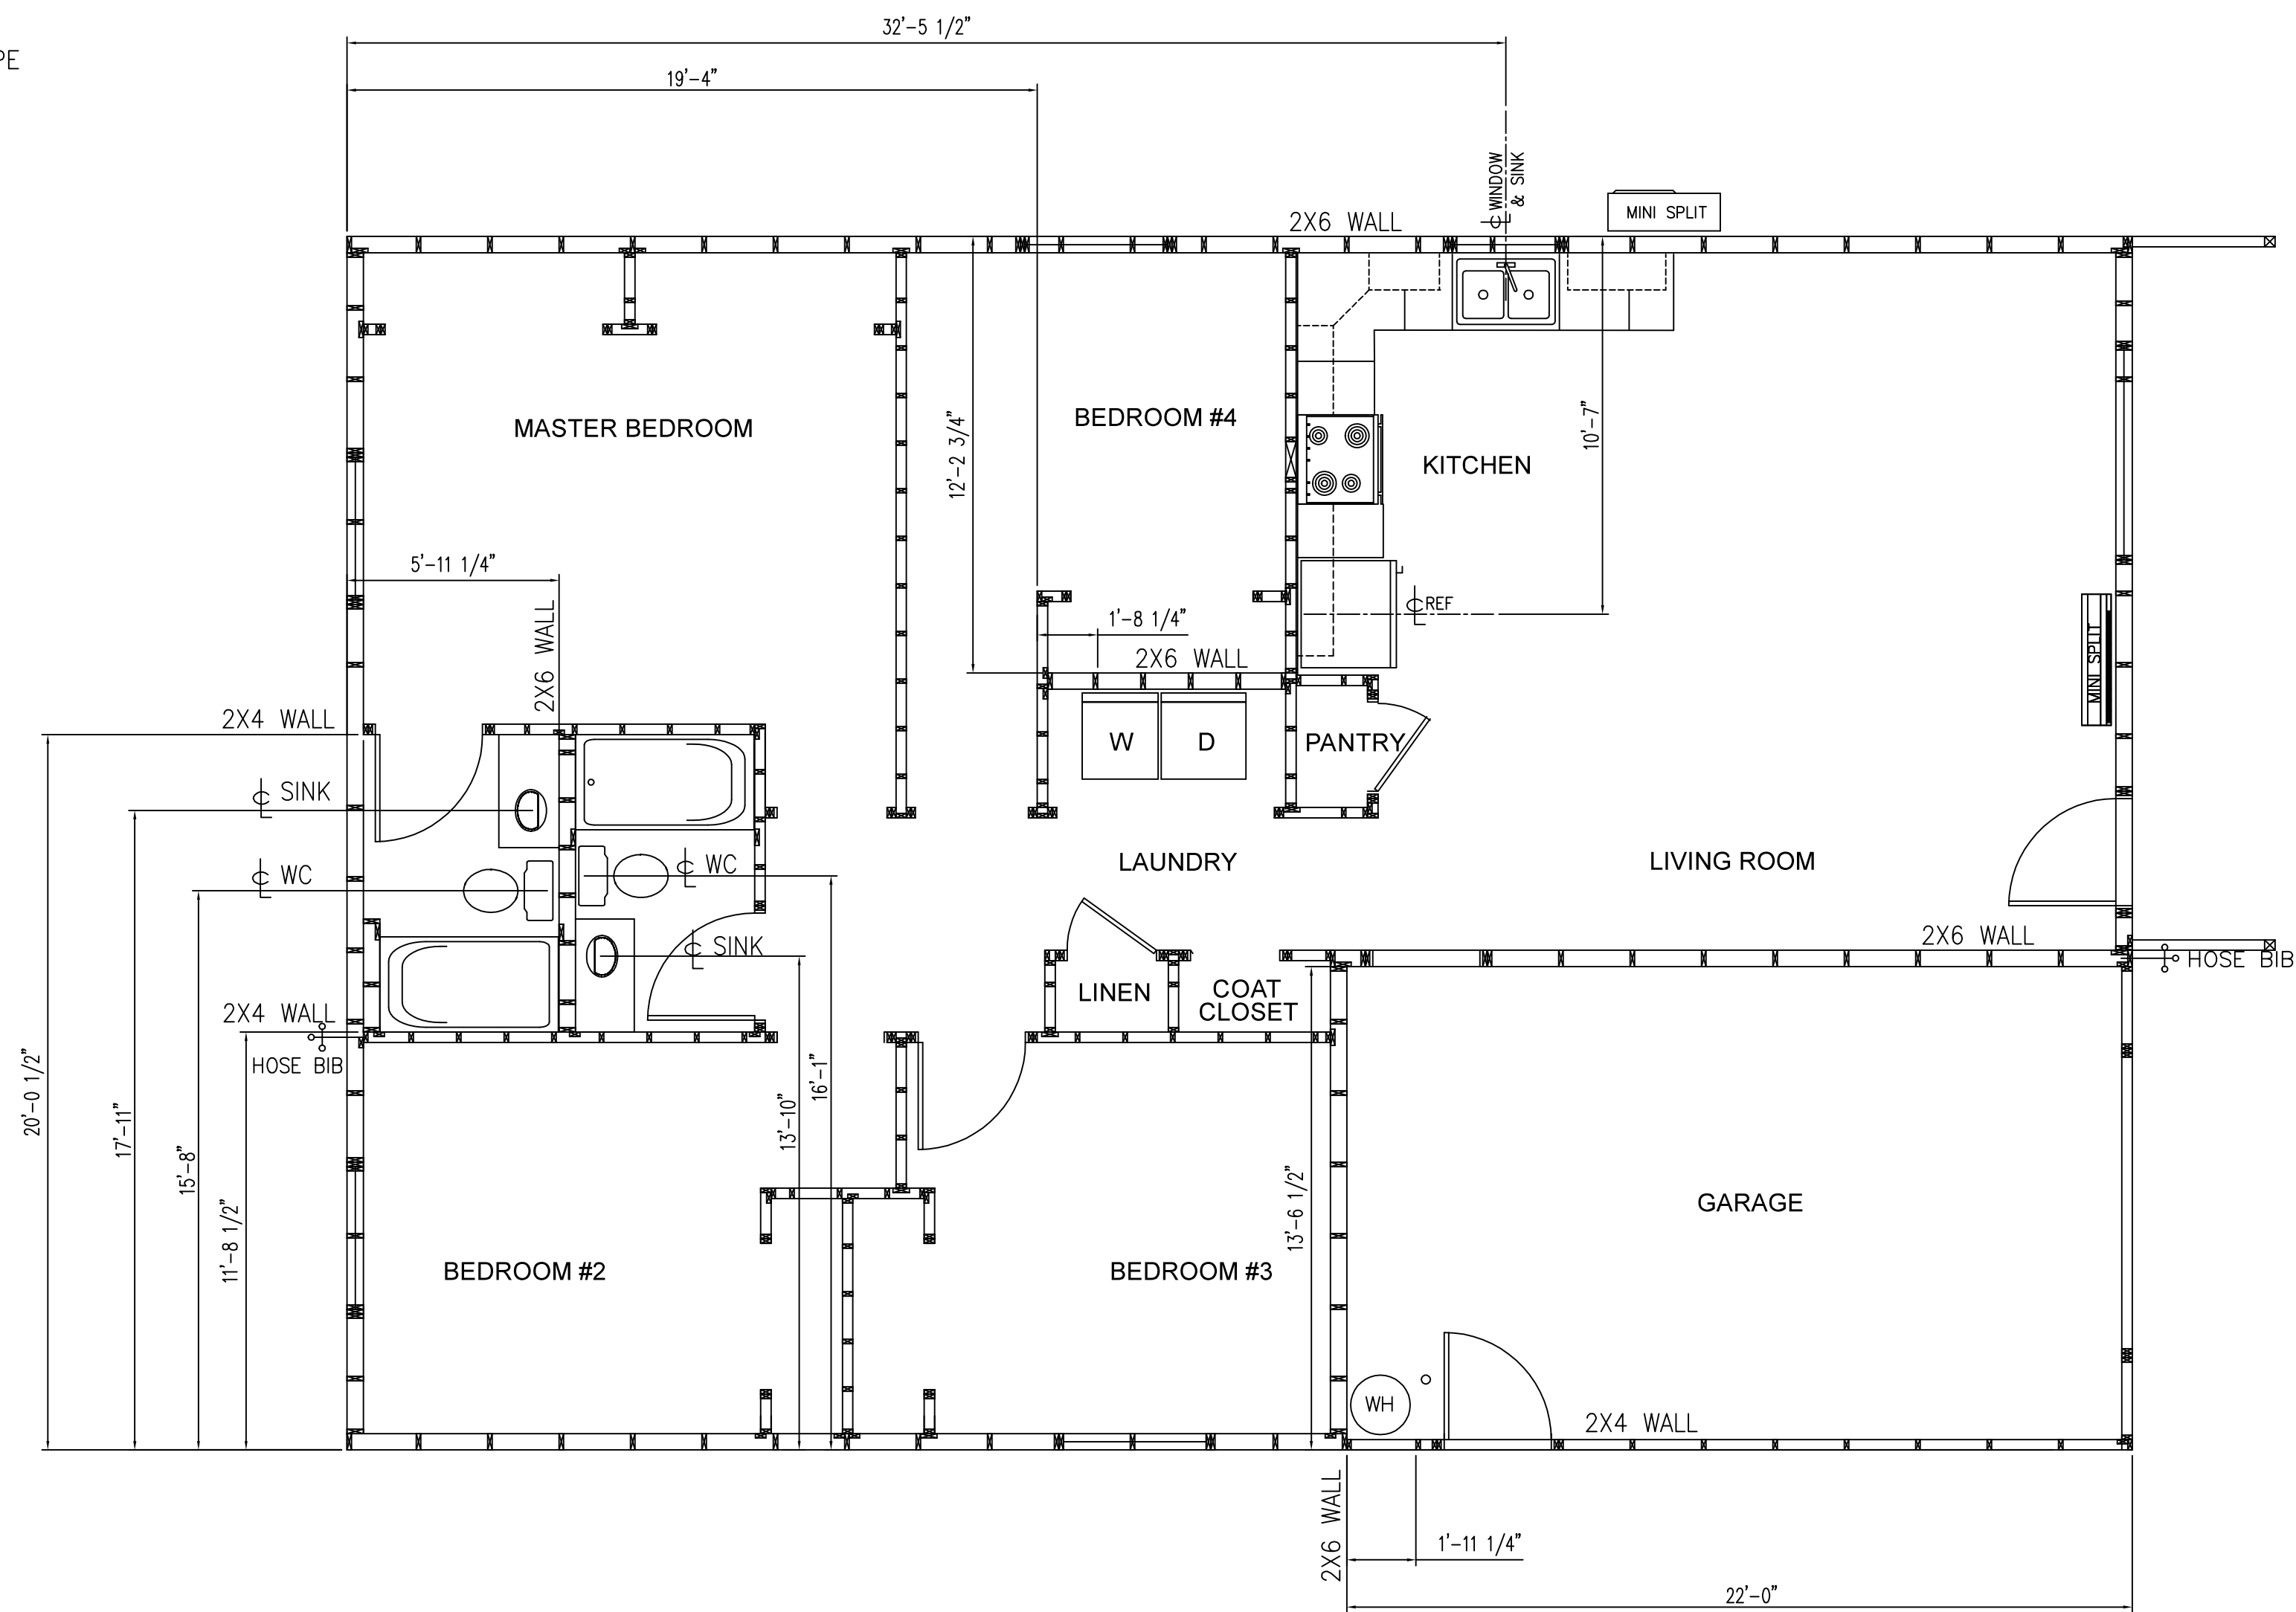


ATTENTION:  
THE SOLE PURPOSE OF THIS DRAWING TO ASSIST  
IN THE EXCAVATION FOR UNDER SLAB PLUMBING.



Tri-County Partners  
Habitat for Humanity

House Number:	TCP-4B2B-U	Drawn:	PDR	Date:	06MAY23	Title: UNDER SLAB PLUMBING LAY-OUT			
For:		Checked:		Date:					
		Approved:		Date:		Sheet:	10	Rev:	2
						Scale: 1/4" = 1'			

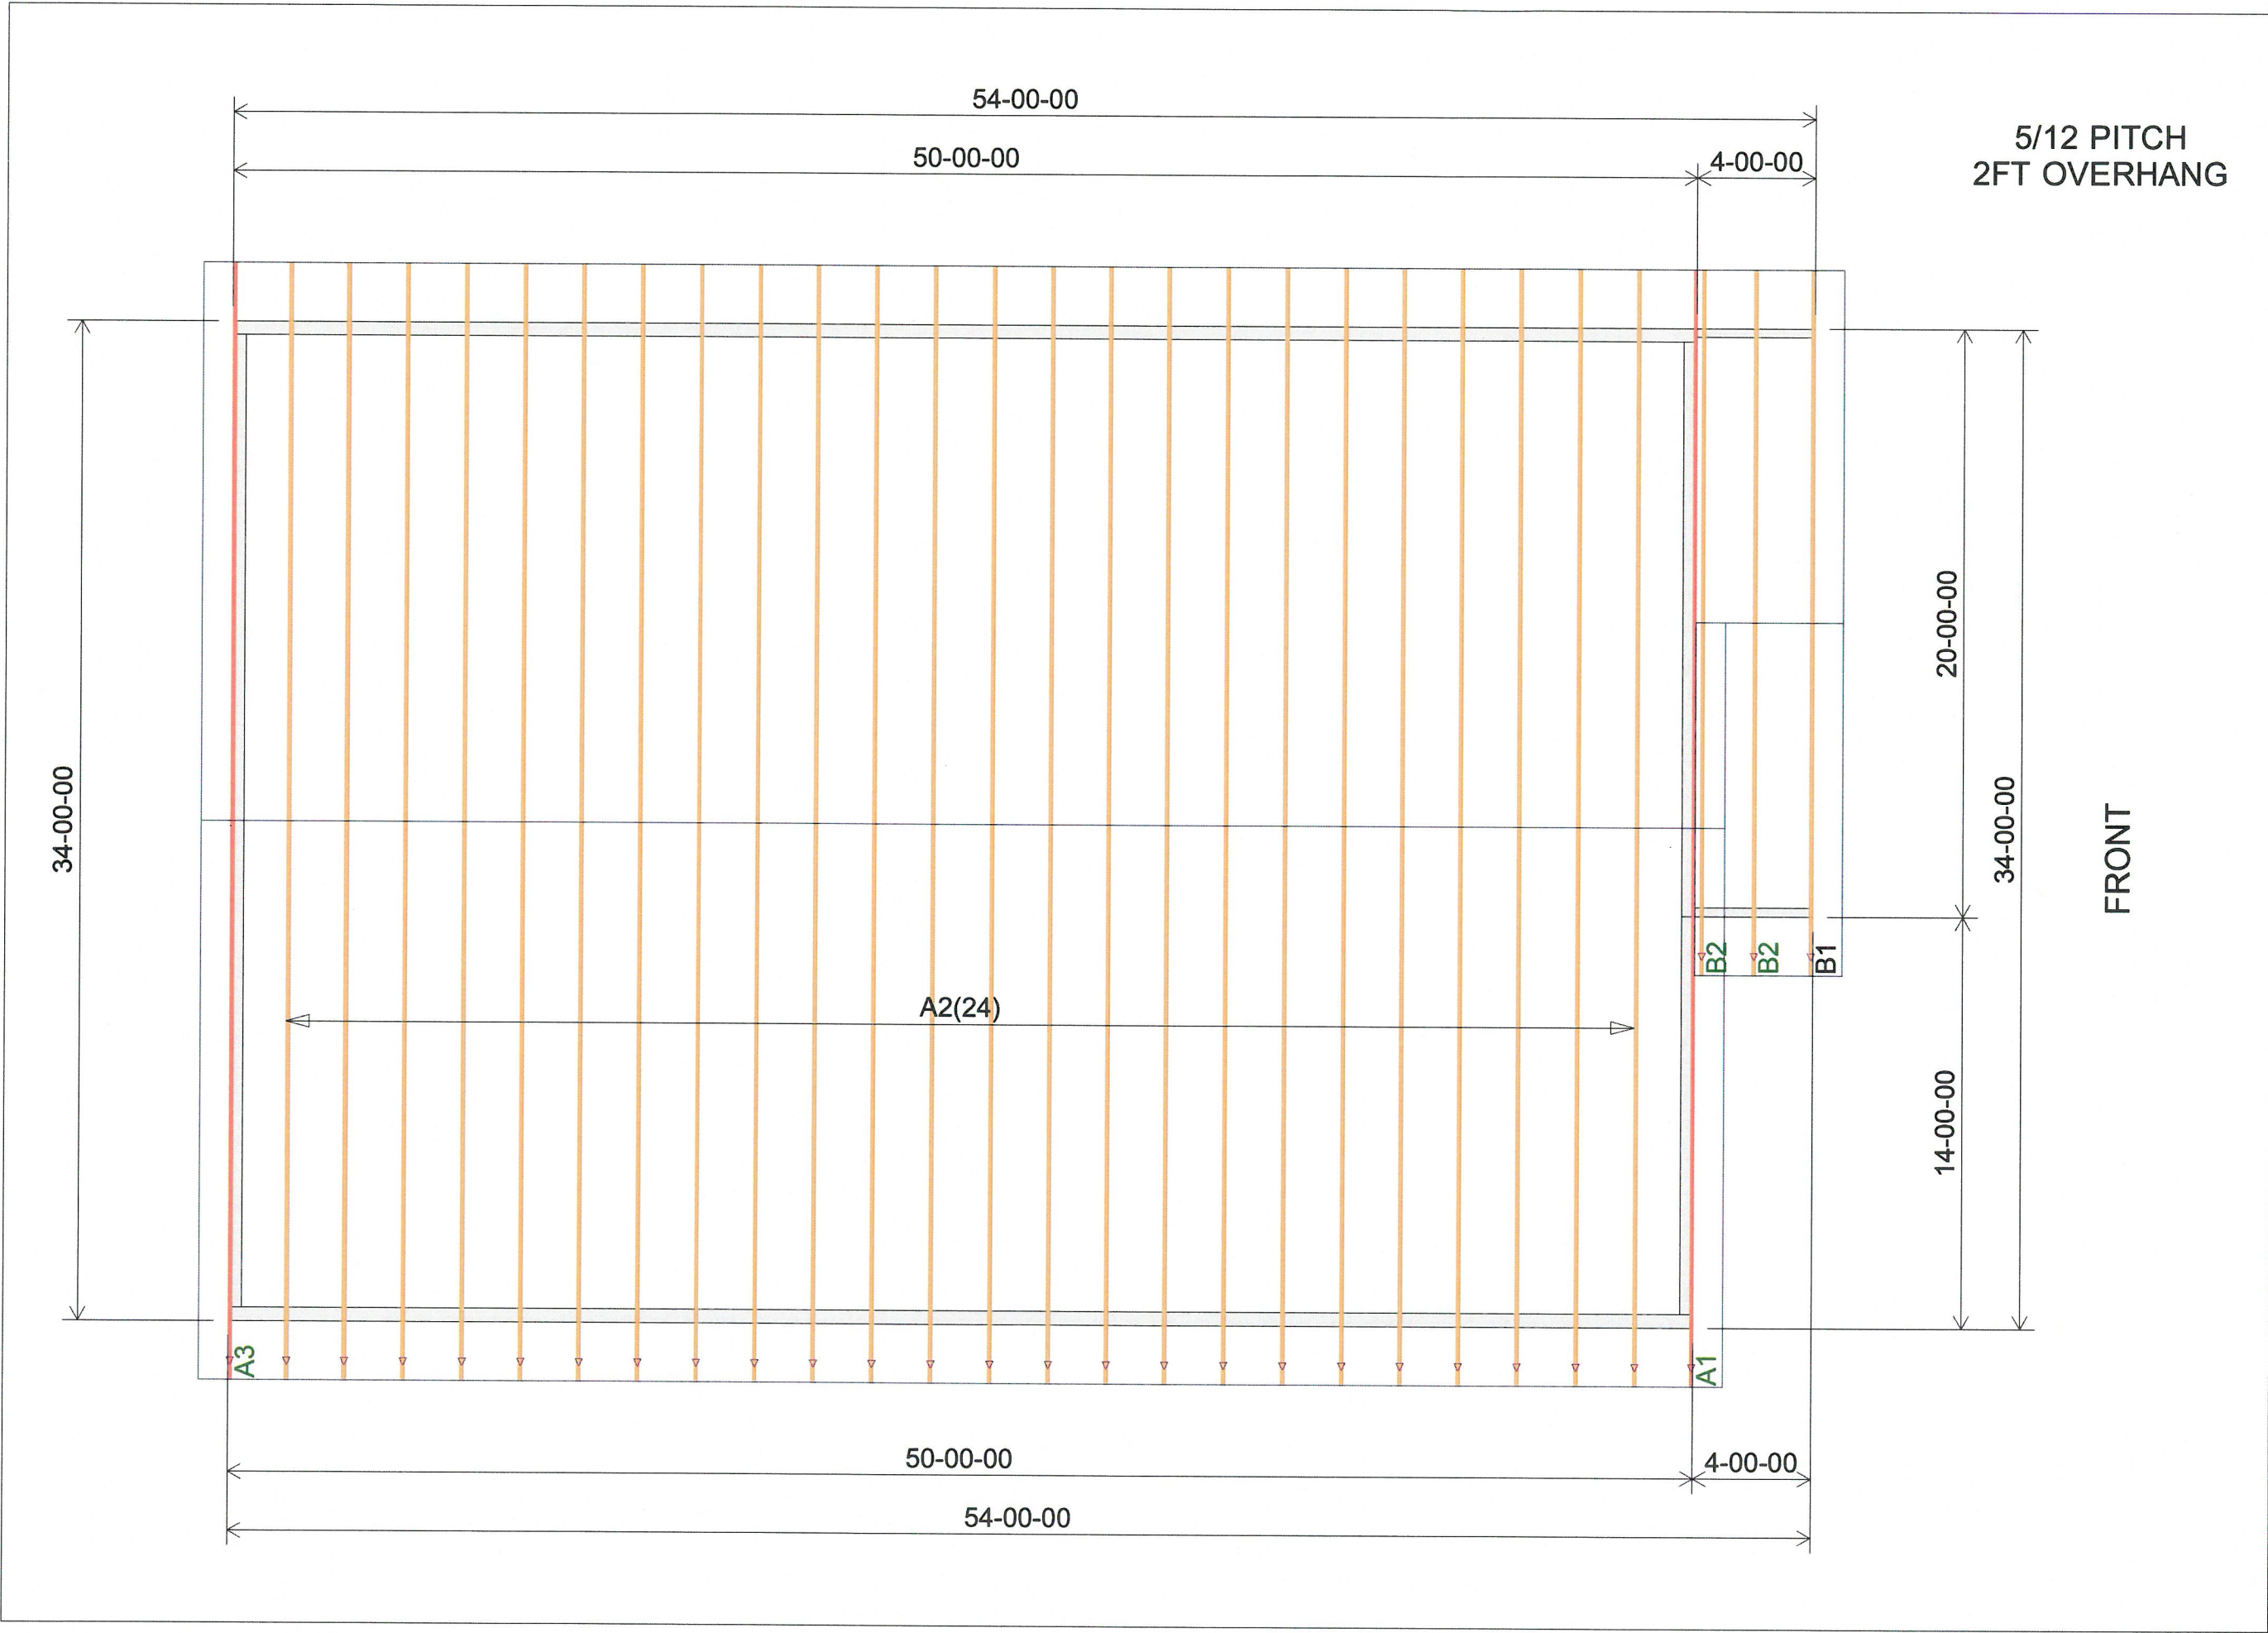

FRONT

<div></div>	
<div>Sales Rep: Larry Goodwin Drawn by: Larry Goodwin Date: 11/10/2022</div>	
<div></div>	
<div>Customer: Habitat for Humanity Job Name: 919 N. WEHE Habitat: 903 N. WEHE Job Number: J1129876 Plan: TCP-4B2B</div>	
<div>Drawing Type: Roof Trusses Loading TC/LL = 25 PSF TC/DL= 8 PSF BC/DL= 7 PSF WIND = 110 mph 'C'</div>	<div>Approved by:</div>
<div>Sheet Number: <b>1 of 1</b></div>	