GENERAL NOTES (NCC 2019 BCA Vol 2)

- All materials and work practices shall comply with, but not limited to the Building Regulations 2018, the National Construction Code Series 2019 Vol 2 and all relevant current Australian Standards (as amended)
- All materials and construction practice shall meet the Performance Requirements of the National Construction Code. Where an alternative solution is proposed then prior to implementation or installation it first must be assessed and approved by the Relevant Building Surveyor as meeting the Performance Requirements of the National Construction Code.
- Glazing including safety glazing shall be installed to a size, type and thickness so as to comply with:
 - NCC 2019 Part 3.6 for Class 1 and 10 buildings within a design wind speed of not more than N3, and
 - NCC 2019 Part B1.4 for Class 2 to 9 buildings
- Waterproofing of wet areas, being bathrooms, showers, shower rooms, laundries, sanitary compartments and the like shall be provided in accordance with AS 3740-2010: Waterproofing of Wet Areas in Residential
- These Drawings shall be read in conjunction with any House Energy Rating (HERS) report and shall be constructed in accordance with the stamped plans endorsed by the accredited Thermal Performance Assessor without alteration. Refer to energy rating report by ...
- Energy rating requirements:
 - All external windows and doors to be weathersealed
 - All new exhaust fans to be self-sealing
 - Ensure that new downlights are installed with approved non-ventilated downlight covers that minimise insulation and ventilation loss
 - -Window glazing as per schedule
 - -All gaps and cracks sealed
- Insulation Value:
 - Floors R
 - Internal Walls R
 - External Walls R
 - Ceilings R
- Step sizes (other than for spiral stairs) to be:
 - Risers (R) 190mm maximum and 115mm minimum
 - Going (G) 355mm maximum and 240mm minimum
 - 2R + 1G = 700mm maximum and 550mm minimum
 - With less than 125mm gap between open treads
- All treads, landings and the like to have non slip finish or suitable non-skid strip near edge of nosing.
- Provide balustrades where change in level exceeds 1000mm above the surface beneath landings, ramps and/or treads. Balustrades (other than tensioned wire balustrades) to be:
 - 1000mm min, above finished surface level of balconies, landings or the like, and
 - 865mm min. above finished surface level of stair nosing or ramp, and
 - Vertical with less than 125mm gap between, and
 - Any horizontal element within the balustrade between 150mm and 760mm above the floor must not facilitate climbing where changes in level exceeds 4000mm above the surface beneath landings, ramps
 - Wire balustrade construction to comply with NCC 2019 Volume 2 Part 3.9.2.5 for Class 1 and 10 Buildings and NCC 2019 Volume 1 Part D2.16 for other Classes of Buildings.
- Hand rails to be 865mm minimum above stair nosing and 1,000mm above finished floor levels of landings.
- Window sizes nominated are nominal only. Actual size may vary according to manufacturer. Windows to be flashed all around.
- Where the building (excludes a detached Class 10) is located in a termite prone area the area to underside of building and perimeter is to be treated against termite attack. Termite protection to comply with NCC 2019 Volume 2 Part 3.1.3 Table 3.1.3.1 for Class 1 and 10 Buildings.
- - Up to 1400mm long to be 100mm x 100mm (1 No. H.D. Wire)
 - 1401mm to 1800mm long to be 100mm x 100mm (2 No. H.D. Wires)
 - 1801mm to 3000mm long to be 125mm x 125mm (2 No. H.D. Wires)
 - 100mm x 100mm stumps exceeding 1200mm above ground level to be braced where no perimeter base brickwork provided.
- For buildings in marine or other exposure environments shall have masonry units, mortar and all built in components and the like complying with the durability requirements of Table 4.1 of AS4773.1-2010 'Masonry' in small buildings' Part 1: Design

- All stormwater to be taken to the legal point of discharge to the Relevant Authorities approval.
- These drawings shall be read in conjunction with all relevant structural and all other consultants drawings/details and with any other written instructions issued in the course of the contract.
- Site plan measurements in metres all other measurements in millimetres u.n.o.
- Figured dimensions take precedence over scaled dimensions
- The Builder shall take all steps necessary to ensure the stability and general water tightness of all new and/or existing structures during all works.
- The Builder and Subcontractors shall check and verify all dimensions, setbacks, levels and specifications and all other relevant documentation prior to the commencement of any works. Report all discrepancies to
- Installation of all services shall comply with the respective supply authority requirements.
- The Builder and Subcontractor shall ensure that all stormwater drains, sewer pipes and the like are located at a sufficient distance from any buildings footing and/or slab edge beams so as to prevent general moisture penetration, dampness, weakening and undermining of any building and its footing system.
- These plans have been prepared for the exclusive use by the Client of Mont-Eltham Building Design Ptv Ltd ('The Designer') for the purpose expressly notified to the Designer. Any other person who uses or relies on these plans without the Designer's written consent does so at their own risk and no responsibility is accepted by the Designer for such use and/or reliance.
- The approval by this office of a substitute material, work practice, variation or the like is not an authorisation for its use or a contract variation. Any said variations must be accepted by all parties to the agreement and where applicable the Relevant Building Surveyor prior to implementing the said variation.

STORMWATER

- 90mm DIA. Class 6 UPVC stormwater line laid to a minimum grade of 1:100 and connected to the legal point of stormwater discharge. Provide inspection openings at 9000mm C/C and at each change of direction.
- The cover to underground stormwater drains shall be not less than
 - 100mm under soil
 - 50mm under paved or concrete areas
 - 100mm under unreinforced concrete or paved driveways
 - 75mm under reinforced concrete driveways

SITE ENVIRONMENT DESIGN INFORMATION

Site Bushfire Attack Assessment (simplified method)

This property IS NOT located in a bushfire prone area.

Site Classification

Site classification as Class: (Insert soil classification) Refer to soil report No: (Insert soil report number) By: (Insert Soil Engineer)

Design gust wind speed / wind classification

Building tie-downs to be provided in accordance with AS1684-2010 for an assumed design gust wind speed / wind classification of 33m/s (subject to confirmation on site by Relevant Building Surveyor at first inspection) refer to AS1684 for construction requirements.

Climate Zone

Climate zone for thermal design / thermal performance assessment : Zone 6.

Corrosion protection of built-in structural members

Provide corrosion protection of built-in structural steel members such as steel lintels, shelf angles, connectors. accessories (other than wall ties) in accordance with NCC 2019 Volume 2 Table 3.4.4.7 suitable for an Environment Classification of LOW.

Corrosion protection for sheet roofing

Provide corrosion protection for sheet roofing in accordance with NCC 2019 Volume 2 Table 3.5.1.1 suitable for an Environment Classification of LOW.

AUTHORITIES / CONSULTANTS

Municipality Name: MERRI-BEK CITY COUNCIL Ph: 9240 1111

Sewerage Authority Name: YARRA VALLEY WATER Ph: 1300 304 688

Structural Engineer

Geotechnical Engineer Name: Ph:

Thermal Performance Assessor Name:

Ph:

PRELIMINARY



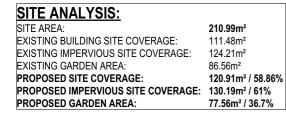
p: (03) 9439 7788

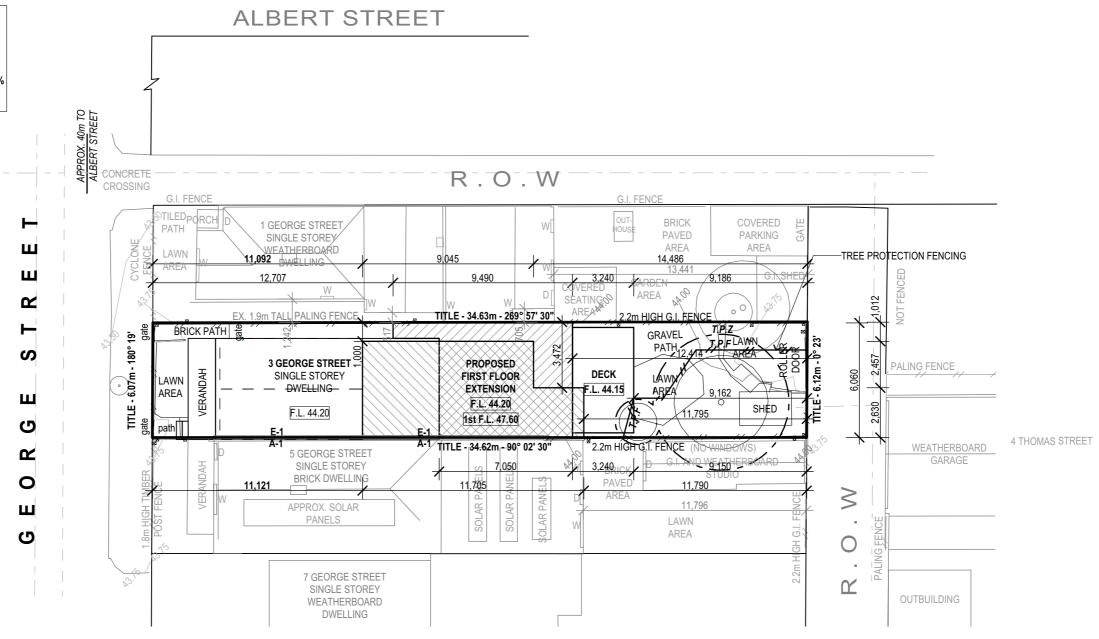
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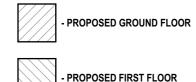
building practitioner m. read DP-AD578

General Notes			rev	rision:	designed:	E.Jeona	scale: as shown @ A3	
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FOR FULL SETOUT DIMENSIONS REFER TO ENDORSED TOWN PLANNING PLANS

D.P - DOWNPIPE
CONNECT ALL NEW DOWNPIPES TO EXISTING STORMWATER
SYSYEM CONNECTED TO LEGAL POINT OF DISCHARGE IN
ACCORDANCE WITH AS3500.3 2018

PLANNING REPORT

FOR PLANNING REPORT REFER TO THE REPORT DATED OCTOBER 2022 BY MULTIPLY TOWN PLANNING

ALL GROUND LEVELS WITHIN 1m TO SLOPE AWAY FROM DWELLING 1:50 FALL IN ACCORDANCE WITH **BCA 3.1.3.3**

MONT-ELTHAM BUILDING DESIGN

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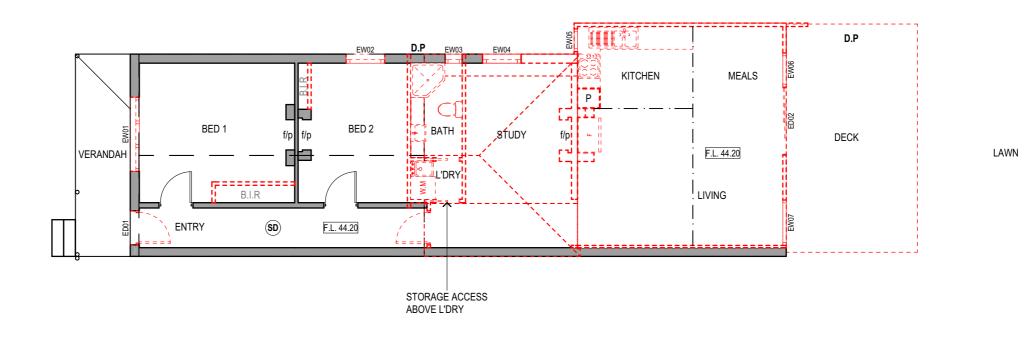


building practitioner m. read DP-AD578

ALL DIMENSIONS & LEVELS TO BE CHECKED & VERIFIED BEFORE WORK COMMENCES

Site Plan		rev	ision:	designed: E.Jeong		scale: as shown @ A3		
		1	Response to RFI-1					
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	EXISTING WINDOW & DOOR SCHEDULE											
ID	HEIGHT	WIDTH	FRAME MATERIAL	U.V VALUE	S.H.G.C	OPENING STYLE	COMMENTS					
ED01	2,100	820	TIMBER			SWING						
ED02	2,100	1,800	TIMBER			SLIDING						
EW01	1,270	1,960	METAL			CASEMENT						
EW02	1,900	1,020	TIMBER			DOUBLE HUNG						
EW03	1,850	450	TIMBER			AWNING	TO BE REMOVED					
EW04	1,900	1,020	TIMBER			DOUBLE HUNG	TO BE REMOVED					
EW05	1,050	600	TIMBER			AWNING	TO BE REMOVED					
EW06	2,100	900	TIMBER			AWNING	TO BE REMOVED					
EW07	2,100	1,200	TIMBER			AWNING	TO BE REMOVED					





BUILDER TO PROP EXISTING STRUCTURE AS REQUIRED BEFORE ANY WORKS COMMENCE

ALL WALLS, DOORS, WINDOWS & FIXTURES SHOWN DASHED RED ARE TO BE REMOVED / DEMOLISHED ALL SOLID INFILLED WALLS ARE TO BE RETAINED

MONT-ELTHAM p: (03) 9439 7788 f: (03) 9431 0697 e: admin@montelthamdrafting.com.au BUILDING DESIGN

75 grand boulevard, montmorency 3094



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ALL DIMENSIONS & LEVELS TO BE CHECKED & VERIFIED BEFORE WORK COMMENCES

Existing Ground Floor Plan		revision:		designed:	E.Jeona	scale: as shown @ A3		
Existing Ground Floor Plan			1	Response to RFI-1				
			2	Response to RFI-2	drawn:	I Chavez	iob no: 03553	03553-21
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LEGEND

SD	SMOKE DETECTOR
EF	EXHAUST FAN
W.M	WASHING MACHINE
F	FRIDGE

SD - SMOKE DETECTOR/ALARM

SMOKE DETECTORS/ALARMS TO BE HARDWIRED. INTERCONNECTED & INSTALLED WITH BATTERY BACK UP IN ACCORDANCE WITH AS3786

CJ - CONTROL JOINTS

UNLESS DETAILED OTHERWISE IN ENGINEERING DRAWINGS OR SOIL REPORT PROVIDE CONTROL JOINTS IN BRICKWORK AT NO MORE THAN 6m CENTERS ACCORDING TO NCC 2019 PART 3.3.1.8

OVERALL HEIGHT BETWEEN FINISHED FLOOR LEVELS TO BE VERIFIED PRIOR TO ORDERING THE MANUFACTURE OF STAIRS

STAIR SPECIFICATIONS:

RISERS 190mm MAXIMUM & 115mm MINIMUM GOING 355mm MAXIMUM & 250mm MINIMUM 125mm MAXIMUM GAP TO OPEN TREADS BALUSTRADES TO BE 1000mm MINIMUM ABOVE FINISHED SURFACE LEVEL OF BALCONIES, LANDINGS OR THE LIKE & 865mm MINIMUM ABOVE FINISHED SURFACE LEVEL OF STAIR NOSING & VERTICAL WITH A 125mm MAXIMUM GAP BETWEEN STAIRS TO HAVE A CONTINUOUS HANDRAIL MIN 865mm ABOVE TREADS IN ACCORDANCE WITH AS1288-2006 ALL TREADS AND LANDINGS FINISHED WITH SLIP RESISTANCE

FOR ALL STRUCTURAL MEMBERS REFER TO ENGINEER'S DRAWINGS BY ...

CLARIFICATION NOT LESS THAN P3 OR R11 FOR

DRY SURFACE AND P4 OR R11 FOR WET SURFACE

ANY SARKING INSTALLED IN THE EXTERNAL WALLS MUST BE VAPOUR PERMEABLE & COMPLY WITH AS4200.

ALL EXHAUST FANS CONNECTED TO LIGHT SWITCH AND DUCTED TO OUTSIDE AIR AND ACHIEVE A MINIMUM FLOW RATE OF 25L/s TO BATHROOMS/SANITARY COMPARTMENTS AND 40L/s TO LAUNDRY/KITCHEN

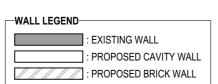
SHOWER BASES ARE TO BE TILED WITHOUT STEP UP & WATERPROOFED IN ACCORDANCE WITH AS3740.2010 & PART 3.8.1 OF THE NCC2019 FALL FLOOR AREA OF SHOWER & WITHIN 1.5M OF WASTE POINT TO FALL 1:100 TO FLOOR WASTE

PROVIDE SUB-FLOOR VENTILATION IN ACCORDANCE WITH B.C.A. PART 3.4.1



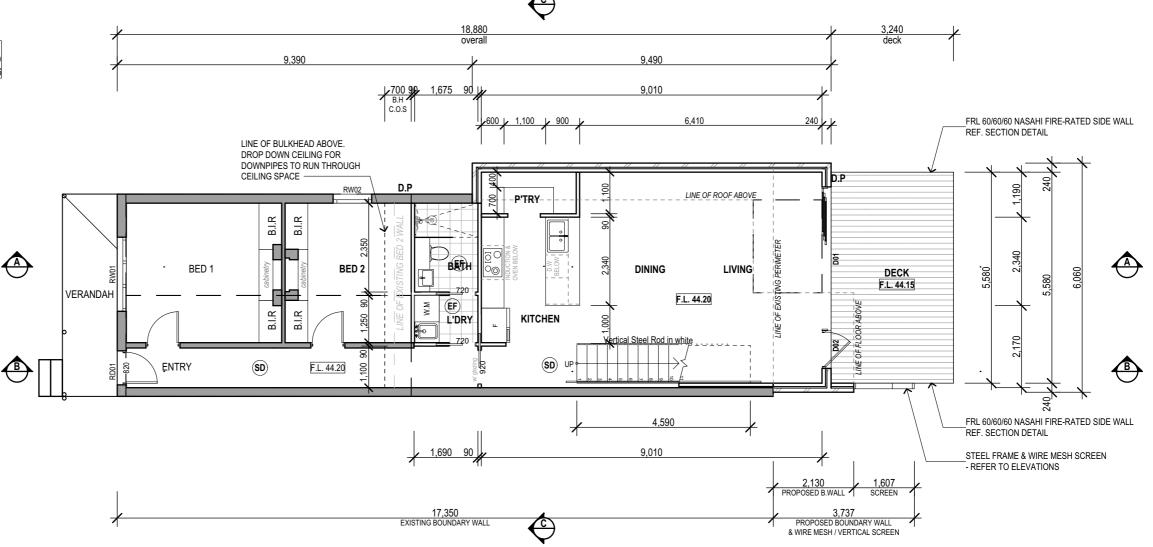
PROPOSED GROUND FLOOR PLAN

SCALE 1:100





CONTRACTOR TO INSPECT THE SITE PRIOR TO EXECUTION OF THE CONTRACT



TO CONFIRM THE SCOPE OF WORKS; RISING DAMP, CRACK WHICH MIGHT BE CAUSED BY GROUND WATER DOWN THE SIDE WAY - REPAIR WORKS BREAKDOWN TO BE PROVIDED



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building practitione
m. read DP-AD578

ALL DIMENSIONS & LEVELS
TO BE CHECKED & VERIFIED
BEFORE WORK COMMENCES

Proposed Ground Floor Plan			rev	ision:	designed:	E.Jeong	scale: as s	hown @ A3
			1	Response to RFI-1				
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project:	Proposed works to	client:	3	Amendments			•	
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	Brunswick	Frederick			issue set:	W.D.02	sheet	4 OF 12

LEGEND

(SD) SMOKE DETECTOR

EF EXHAUST FAN

SD - SMOKE DETECTOR/ALARM

SMOKE DETECTORS/ALARMS TO BE HARDWIRED, INTERCONNECTED & INSTALLED WITH BATTERY BACK UP IN ACCORDANCE WITH AS3786

OVERALL HEIGHT BETWEEN FINISHED FLOOR LEVELS TO BE VERIFIED PRIOR TO ORDERING THE MANUFACTURE OF STAIRS

STAIR SPECIFICATIONS:

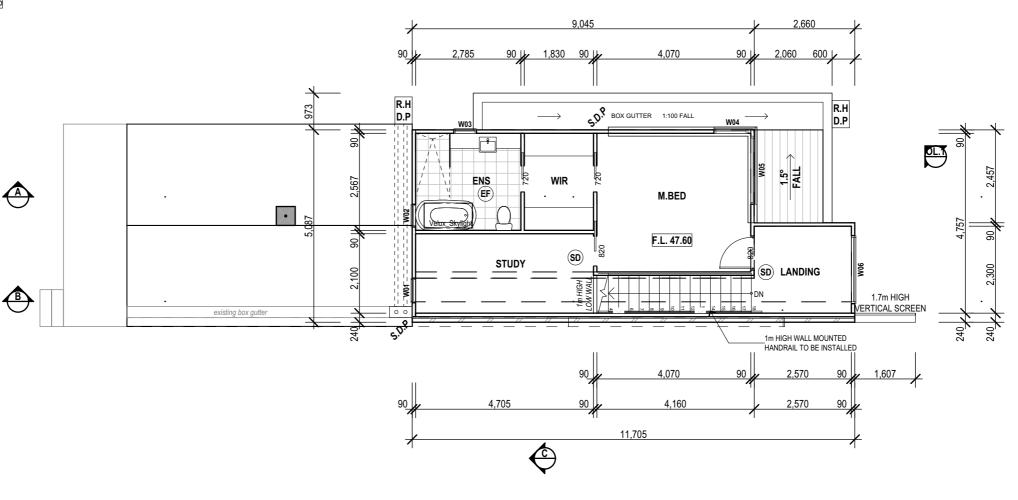
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STAIRS TO HAVE A CONTINUOUS HANDRAIL MIN 865mm ABOVE
TREADS IN ACCORDANCE WITH AS1288-2006
ALL TREADS AND LANDINGS FINISHED WITH SLIP RESISTANCE
CLARIFICATION NOT LESS THAN P3 OR R11 FOR
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ANY SARKING INSTALLED IN THE EXTERNAL WALLS MUST BE VAPOUR PERMEABLE & COMPLY WITH AS4200.

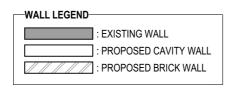
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SHOWER BASES ARE TO BE TILED WITHOUT STEP UP & WATERPROOFED IN ACCORDANCE WITH AS3740.2010 & PART 3.8.1 OF THE NCC2019 FALL FLOOR AREA OF SHOWER & WITHIN 1.5M OF WASTE POINT TO FALL 1:100 TO FLOOR WASTE









PRELIMINARY



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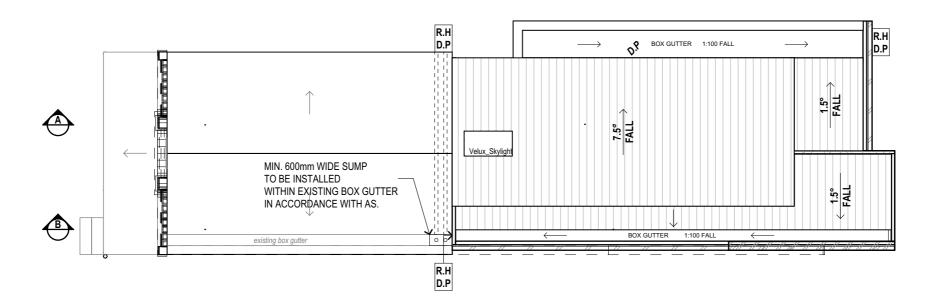
building practitioner m. read DP-AD578

Proposed First Floor Plan			rev	ision:	designed:	E.Jeona	scale: as shown @ A	
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D.P - DOWNPIPE

CONNECT ALL NEW DOWNPIPES TO EXISTING STORMWATER SYSYEM CONNECTED TO LEGAL POINT OF DISCHARGE IN ACCORDANCE WITH AS3500.3 2018





B

PRELIMINARY

LEGEND

PROPOSED SHEET ROOF @ SPECIFIED ROOF PITCH (builder to confirm pitch onsite)

EXISTING SHEET ROOFING TO REMAIN (builder to verify pitch onsite)





PROPOSED ROOF PLAN

SCALE 1:100



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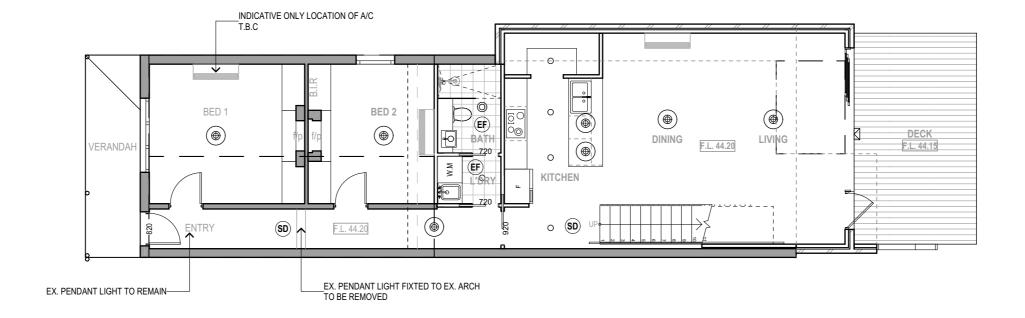


building practitioner m. read DP-AD578

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ᆫ	E	GEND	41/11	Mr.	₹0,		
(Ē	EXHAUST FAN	1	N/A	N/A		
S	D	SMOKE DETECTOR	1	N/A	N/A		
(SELECTED PENDENT LIGHT	1	75w	75w		
()	SELECTED BATHROOM LIGHT	1	32w	32w		
_)	LED DOWN LIGHT	16	9w	144w		
T	ЭΤ	AL INTERNAL	144v	144w - 2.4w p/m²			
_ Z	7	SELECTED EXTERNAL WALL LIGHT	1	35w	35w		
T	ЭΤ	AL WATTS EXTERNAL	35w	- 3.5w	p/m²		

TO BE UPDATED



IMPORTANT NOTES

- LOCATION, SPECS OF LIGHTINGS TO BE CONFIRMED PRIOR TO ORDERING REVERSE-CYCLE AIRCONDITIONING TO BE INSTALLED. LOCATION, SPECS TO BE CONFIRMED PRIOR TO ORDERING
- ARTIFICIAL LIGHTING MUST NOT EXCEED THE ALLOWANCE OF:
- 5 W/m² IN A CLASS 1 BUILDING: AND
- 4 W/m² ON A VERANDAH, BALCONY OR THE LIKE ATTACHED TO A CLASS 1 BUILDING 3 W/m² IN A CLASS 10a BUILDING ASSOCIATED WITH A CLASS 1 BUILDING



PROPOSED GROUND FLOOR PLAN - LIGHTING

SCALE 1:100



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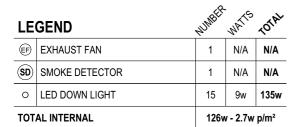
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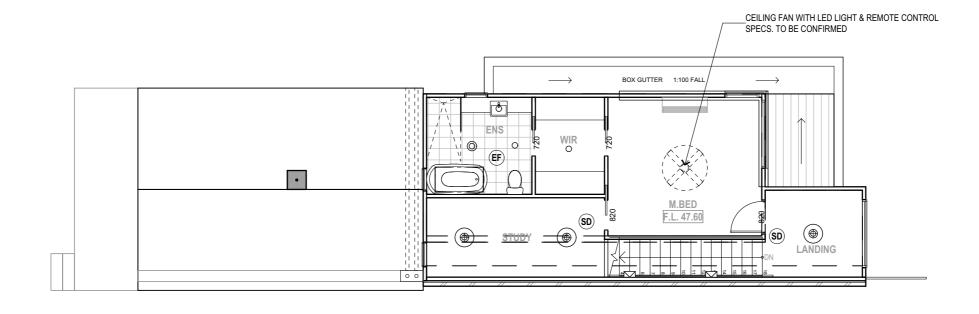
building practitioner m. read DP-AD578

ALL DIMENSIONS & LEVELS TO BE CHECKED & VERIFIED BEFORE WORK COMMENCES

Proposed Ground Floor Plan - Lighting			revision:		designed: E.Jeong		scale: as s	hown @ A3
			1	Response to RFI-1				
			2	Response to RFI-2	drawn:	J.Chavez	iob no	03553-21
project:	Proposed works to	client:	3	Amendments		0.0114402	JOD 110.	00000 21
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TO BE UPDATED



IMPORTANT NOTES

LOCATION, SPECS OF LIGHTINGS TO BE CONFIRMED PRIOR TO ORDERING REVERSE-CYCLE AIRCONDITIONING TO BE INSTALLED. LOCATION, SPECS TO BE CONFIRMED PRIOR TO ORDERING

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- 4 W/m² ON A VERANDAH, BALCONY OR THE LIKE ATTACHED TO A CLASS 1 BUILDING 3 W/m² IN A CLASS 10a BUILDING ASSOCIATED WITH A CLASS 1 BUILDING



PROPOSED FIRST FLOOR PLAN - LIGHTING

SCALE 1:100



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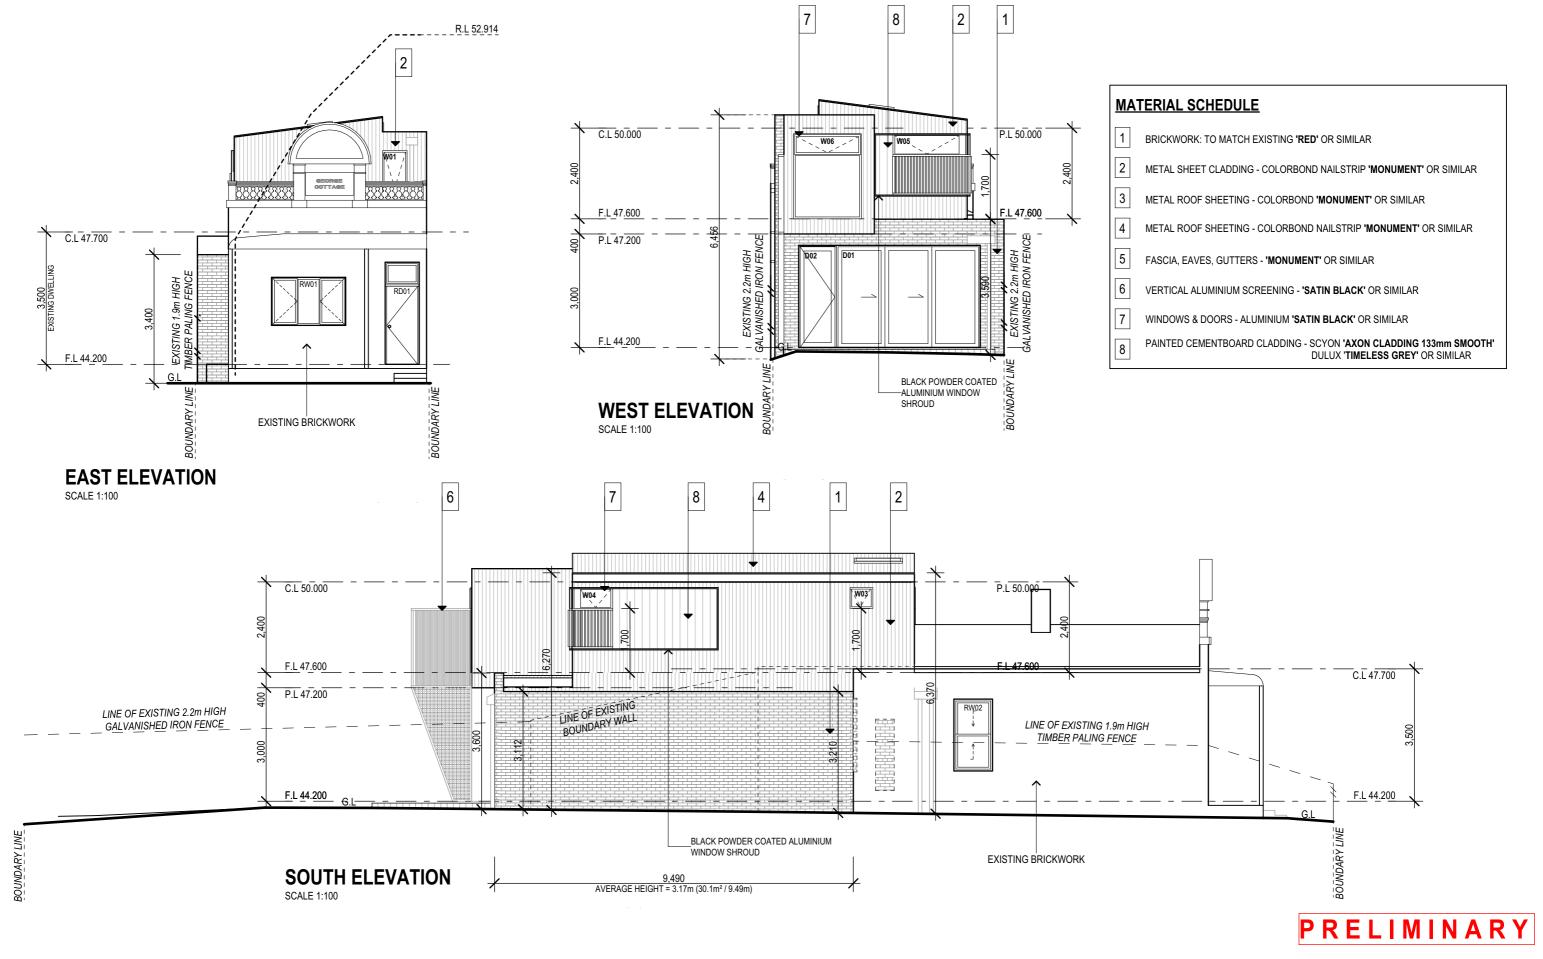
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ALL DIMENSIONS & LEVELS TO BE CHECKED & VERIFIED BEFORE WORK COMMENCES

Dranged First Floor Plan Lighting		rev	rision:	designed:	E.Jeona	scale: as s	hown @ A3	
Proposed First Floor Plan - Lighting			1	Response to RFI-1				
			2	Response to RFI-2	drawn:	J.Chavez	iob no:	03553-21
project:	Proposed works to	client:	3	Amendments			•	
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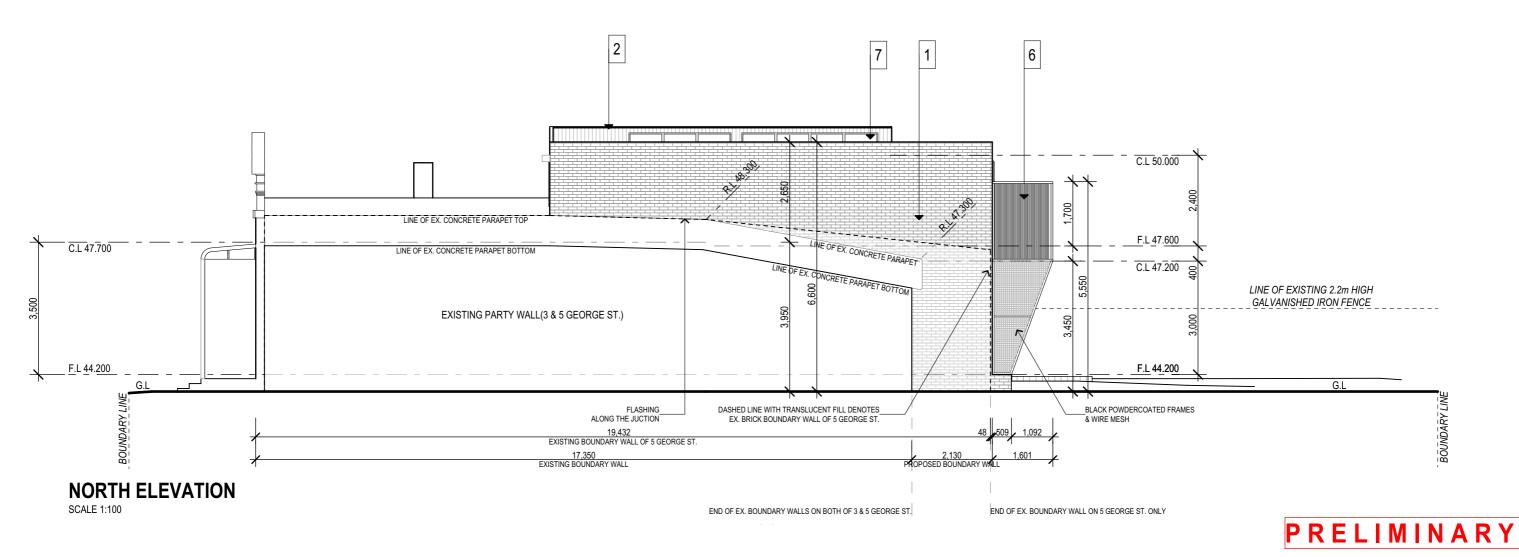


building practitioner m. read DP-AD578

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	PROPOSED WINDOW & DOOR SCHEDULE																	
ID	D01	D02	RD01	RW01	RW02	W01	W02	W03	W04	W05	W06	W07	W08	W09	W10	W11	W12	W13
HEIGHT	2,700	2,700	2,100	1,270	1,900	1,200	550	550	1,650	1,650	2,250	300	300	300	300	300	300	300
WIDTH	3,800	920	820	1,960	1,020	650	600	600	900	1,800	1,800	900	900	900	900	900	900	900
FRAME MATERIAL	ALUMINIUM	ALUMINIUM	TIMBER	TIMBER	TIMBER	ALUMINIUM												
GLAZING	DOUBLE GLAZING	DOUBLE	DOUBLE	DOUBLE	DOUBLE	DOUBLE	DOUBLE	DOUBLE	DOUBLE	DOUBLE	DOUBLE	DOUBLE	DOUBLE	DOUBLE	DOUBLE	DOUBLE	DOUBLE	DOUBLE
U.V VALUE																		
S.H.G.C																		
OPENING STYLE	SLIDING	SWING	SWING, FIXED	SIDE HUNG, FIXED	DOUBLE HUNG	AWNING	AWNING	AWNING	FIXED	FIXED	AWNING	FIXED						
COMMENTS																		
Elevation									E	E		F	F	F	F	F	F	F

NOTE: ALL GLAZING TO COMPLY WITH AS1288, ALL WINDOWS & DOORS TO BE SITE CHECKED & MEASURED BY OWNER & BUILDER BEFORE ORDERING FROM MANUFACTURER. FOR ALL GLAZING VALUES PLEASE REFER TO THE ENERGY RATING REPORT BY



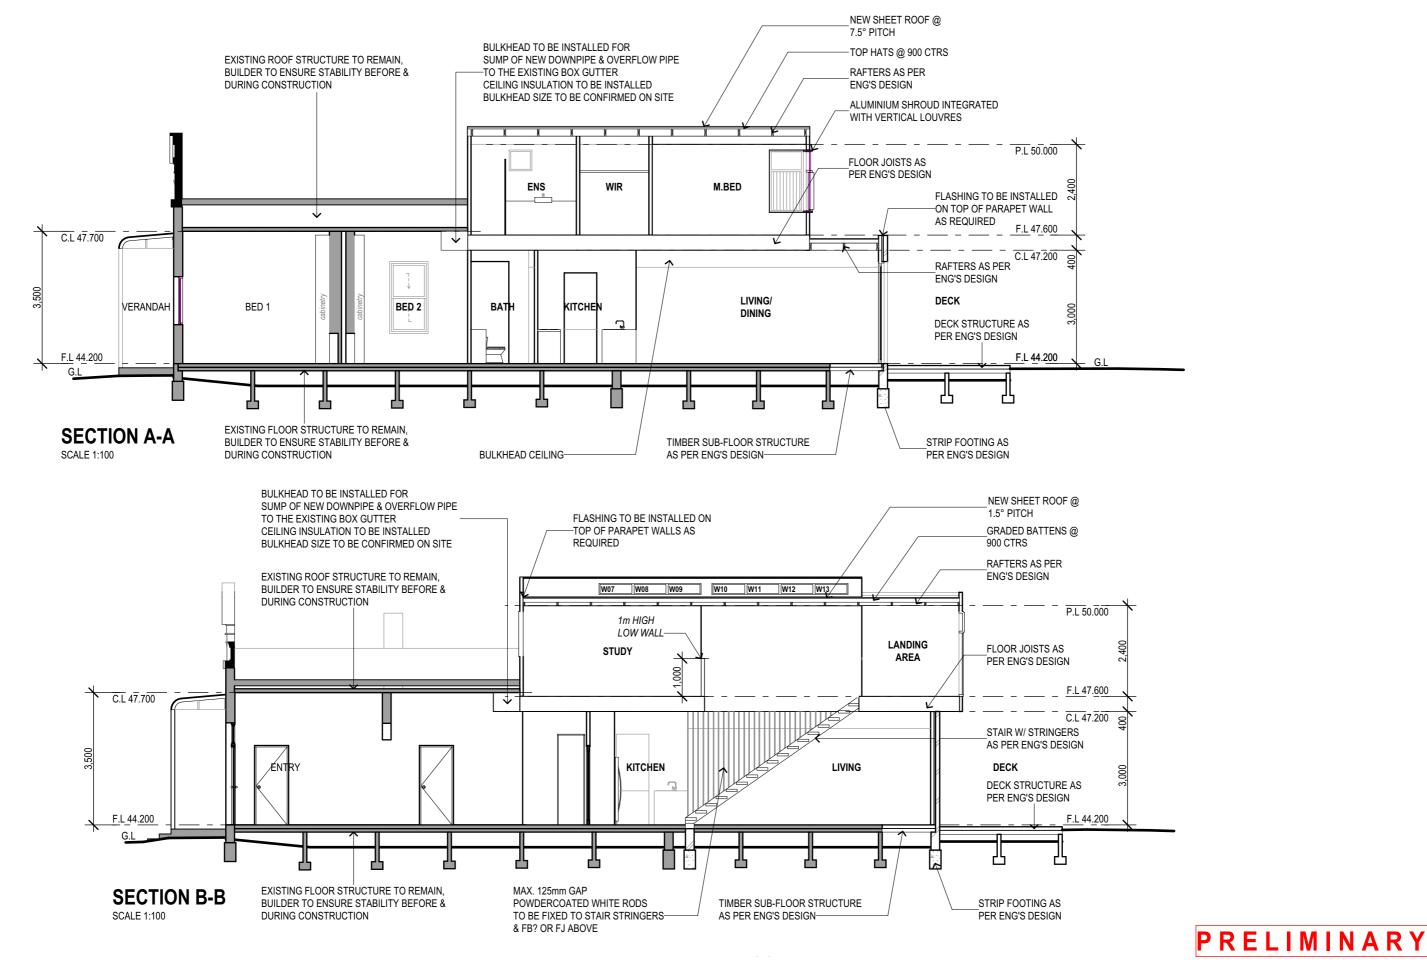


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building practitioner m. read DP-AD578

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			2	Response to RFI-2	drawn:	J.Chavez	ioh no:	0359	53-21
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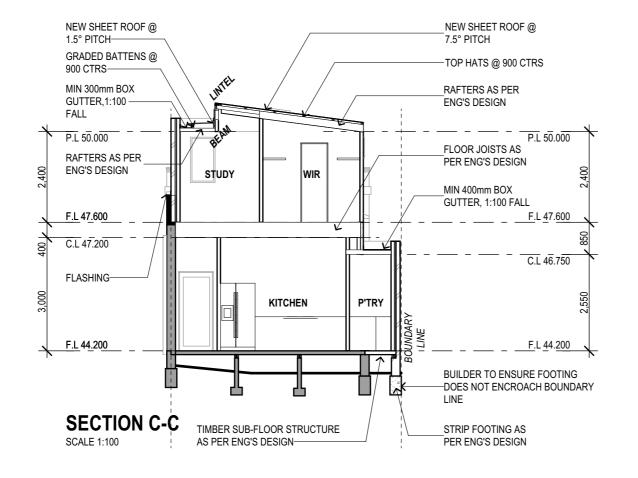
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building practitioner m. read DP-AD578

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FOR ALL STRUCTURAL MEMBERS REFER TO ENGINEER'S DRAWINGS BY ..

TIMBER FRAME SPEC

SINGLE OR UPPER STOREY LOAD-BEARING WALLS 70x90 MGP10 TOP PLATE 45x90 MGP10 BOTTOM PLATE 90x35 MGP10 STUDS @ 450mm CTRS. UPTO 2700mm HIGH 90x45 MGP10 STUDS @ 450mm CTRS. UPTO 3000mm HIGH STUDS TO BE ALIGNED WITH OR BLOCKED TO FLOOR JOISTS UNDER NOGGINGS @ 1250ctr's LOWER STOREY LOAD-BEARING WALLS 70x90 MGP10 TOP PLATE 45x90 MGP10 BOTTOM PLATE 90x45 MGP10 STUDS @ 450mm CTRS. UPTO 2550mm HIGH

STUDS TO BE ALIGNED WITH OR BLOCKED TO FLOOR JOISTS UNDER NOGGINGS @ 1250ctr's

LINTELS SINGLE OR UPPER STOREY LOAD-BEARING WALLS AS PER ENG'S DESIGN LOWER STOREY LOAD-BEARING WALLS AS PER ENG'S DESIGN

JAMB STUDS SINGLE OR UPPER STOREY LOAD-BEARING WALLS AS PER ENG'S DESIGN LOWER STOREY LOAD-BEARING WALLS AS PER ENG'S DESIGN

PRELIMINARY



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building practitioner m. read DP-AD578

Sections			rev	ision: Response to RFI-1	designed:	E.Jeong	scale: as s	hown @ A3
	Proposed works to		2	Response to RFI-2 Amendments	drawn:	J.Chavez	job no:	03553-21
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