PLAN IDENT.	SPECIF	ICATIONS			REMARKS *				
	MODEL	LOCATION	SIZE	MANUFACTURE					
S-1	HVS W/ DAMPER	CEILING	24 × 24	HART & COOLEY	T-BAR DROP-IN DIFFUSER 4 WAY AIR FLOW				
5-2	RHD45	II	12 × 6	П	45° DEFLECTION FACE BARS WITH OPPOSED BLADE DAMPER				
6-3	ARED2C	11	12 × 12	П	2 WAY ALUMINUM CEILING DIFFUSER WITH DAMPER				
6-4	ARED	II	24 × 24	П	4 WAY ALUMINUM CEILING DIFFUSER WITH DAMPER				
6-5	LS SERIES	II	24 × 6	П	LS-3-15-0-30×8-SA WAY AIR FLOW				
5-6	LS SERIES	11	36 × 4	П	LS-3-15-0-36×4-SA WAY AIR FLOW				
6- 7	LS SERIES	11	48 × 6	П	LS-3-15-0-48×6-SA 1 WAY AIR FLOW				
5-8	ARED4	II	12 × 12	п	4 WAY ALUMINUM CEILING DIFFUSER WITH DAMPER				
5-9	LS SERIES	11	36 × 6	П	LS-3-15-0-36×6-SA 2 WAY AIR FLOW				
S-1Ø	ARED3	II	12 × 12	П	3 WAY ALUMINUM CEILING DIFFUSER WITH DAMPER				
R-1	RE5T	CEILING	24 × 24	П	T-BAR DROP-IN GRILLE				
R-2	RE5	II	24 × 6	II	GYPSUM CEILING RETURN AIR GRILLE				
R-3	RE5	II	36 × 6	II	GYPSUM CEILING RETURN AIR GRILLE				
R-4	RE5	П	24 × 24	II	GYPSUM CEILING RETURN AIR GRILLE				
WPL-1	153 <i>0Z</i> F	EXTERIOR WALL	12 × 12	HART & COOLEY	WEATHER PROOF LOUVER WITH GREENHECK ES-30 BACKDRAFT DAMPER				
WPL-2	1530ZF	11	18 × 12	II	WEATHER PROOF LOUVER WITH GREENHECK ES-30 BACKDRAFT DAMPER				
WPL-3	1530ZF	II	24 × 12	II .	WEATHER PROOF LOUVER WITH GREENHECK ES-30 BACKDRAFT DAMPER				
WPL-4	1530ZF	II .	30 × 12	П	WEATHER PROOF LOUVER WITH GREENHECK ES-30 BACKDRAFT DAMPER				
EG-I	RH45	CEILING	12 × 12	П	EXHAUST GRILL				
EG-2	RH45	CEILING	18 × 12	П	EXHAUST GRILL				
TG-1	TGF	WALL	12 × 6	П	TRANSFER GRILL				

	PTAC SCHEDULE										
	MODEL	BTUH	<i>YO</i> LTAGE	CFM	HEAT KW	AMPS	WINDOW SLEEVE	DRAIN KIT	ELECTRIC SUB BASE	THERMOSTAT	MANUFACTURER
PTAC-1	AZ65HØ7DAD	7,000	208-1-60	250 - 409	3.5	2Ø	RABTIB	RADIØ	RAK204E20	INNCOM BY	GE
PTAC-2	AZ65HØ9DAD	9,000	208-1-60	300 - 409	3.6	2Ø	RABTIB	RADIØ	RAK204E20	HONEYWELL	GE

IEXHAUST FAN NOTES:

IST-4TH FLOOR GUEST ROOM EXHAUST GRILLS DUCTED TO ROOF TRUSSES AND DUCTED IN THE ROOF TRUSSES TO THE ERU.

NOTE: 2 WITH RADIATION DAMPERS

NOTE: 3 INTERLOCKED WITH POOL DEHUMIDIFICATION SYSTEM WITH MANUAL OVERRIDE.

NOTE: 4 INTERLOCKED WITH FURNACE WITH MANUAL OVERRIDE.

NOTE: 5 THERMOSTATS TO BE SET AT 80° WITH MANUEL OVERRIDE, MOUNT THERMOSTAT AT 1" BELOW CEILING.

NOTE: 6 INTERLOCKED WITH LIGHTS.

NOTE: 1 MOTION SENSOR WITH 10 MINUTE DELAY OFF

NOTE: 8 SURFACE MOUNTED WITH EXPOSED DUCTWORK

FIRE DAMPER REQUIRED FOR EVERY EXHAUST FAN WHERE IT PENETRATES A FIRE RATED

ALL EXHAUST FAN DUCTS SHALL BE RUN WITH A MINIMUM 26 GAUGE GALVANIZED METAL AND FIRE CAULKED AT ALL PENETRATIONS THROUGH PRECAST.

CONNECT EXHAUST RUNS TO THE MAIN EXHAUST DUCT AT A 45° ANGLE.

ALL EXHAUST FANS TO HAVE BACK DRAFT DAMPERS

SPECIFICATIONS


FURNISH AND INSTALL, HIGH EFFICIENCY, NATURAL GAS FIRED, VERTICAL UPFLOW, HEATING/COOLING, FURNACE UNITS, AC-* CAPACITIES TO BE AS SHOWN ON THE PLAN SCHEDULE, FURNACE FANS SHALL RUN CONTINUOUS. CORRESPONDING ELECTRIC REMOTE OUTDOOR AIR COOLED CONDENSING UNITS PLAN IDENTIFICATIONS, ACC-+ SCHEDULED AND LOCATED ON THE PLANS. UNITS SHALL HAVE AN AFUE OF 92 AND SHALL BE EQUIPPED WITH EVAPORATOR COILS, RELAYS, AND STATS. INDOOR UNITS SHALL BE VENTED THROUGH WALL. EACH UNIT SHALL HAVE INTAKE AND EXHAUST USING 4" PVC OR AS APPROVED BY THE MANUFACTURER.

ALL MAIN DUCT TO BE RIGID GALVANIZED IRON AS APPROVED BY SMACNA AND WRAPPED WITH I" FIBERGLASS INSULATION. ALL BRANCH DUCTS TO BE JACKETED FLEXIBLE FIBERGLASS WITH VOLUME DAMPERS, LENGTH OF BRANCH NOT TO EXCEED 8'-0".

ALL SUPPLY AIR CEILING DIFFUSERS SHALL BE HART & COOLEY SQUARE LOUVER FACED , CFM, SIZE AND PATTERN AS SHOWN AND SCHEDULED ON THE DRAWINGS, ARE DIFFUSERS. ALL RETURN AIR GRILLES SHALL BE HART & COOLEY TYPE HY SERIES.

ALL TOILET EXHAUST FANS TO BE CEILING TYPE AS MANUFACTURED BY PANASONIC, HORIZONTAL DISCHARGE INTO THE AREA SHOWN ON THE DRAWINGS

PROVIDE UV PROTECTIVE COATING COVERING ON ALL ELASTOMERIC PIPE INSULATION WHERE EXPOSED TO SUNLIGHT

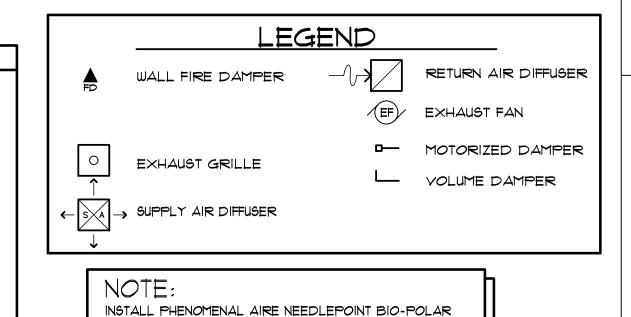

GUESTROOM MANAGEMENT SYSTEM (GRMS)

IONIZATION (COLD PLASMA) SERIES RS6.0 IN THE RETURN

AIR DUCT 8 FEET FROM THE UNIT OR JUST AFTER THE LAST

DIGITAL THERMOSTAT IS THE ROOM CONTROLLER OF THE GUESTROOM MANAGEMENT SYSTEM. IT OCCUPANCY BASED GUESTROOM MANAGEMENT AND CONTROLS HVAC SYSTEM, HUMIDITY, HAS OC BASED MASTER LIGHTING RELAY CONTROL AND INTEGRATES WITH THE GUESTROOM ENTRY DOOR LOCK. THE SYSTEM IS FULLY NETWORKED AND INTEGRATES WITH BMS AND/OR PMS, HAS HOTEL OPERATORS CONSOLE, AND CAN BE EITHER WIRED OR WIRELESS INTEGRATION.

GRMS INTEGRATORS:

RETURN BRANCH LINE.

TO ENSURE PROPER COORDINATION BETWEEN ELECTRICAL AND MECHANICAL SECTIONS AND PROPER EXECUTION OF DESIGN A GRMS SYSTEM INTEGRATOR IS REQUIRED. INCLUDE THE FOLLOWING:

INTEGRATE ALL ASPECTS OF GUESTROOM FUNCTIONALITY INCLUDING GUESTROOM HVAC, RFID LOCK, LIGHTING CONTROL, AND ANY OTHER GUEST AMENITIES AS REQUIRED.

RESPONSIBILITIES: DESIGN, INSTALLATION, PROJECT MANAGEMENT, PROCUREMENT AND COMMISSIONING OF THE GRMS.

MAJOR

LAUNDRY

LOBBY/WORK / REGISTRATION

MEETING ROOM

FITNESS

PBX

WATER ROOM

BREAKFAST / BUFFET

ENSURE THAT ALL SERVER-TO-SERVER INTERFACES ARE ESTABLISHED AND OPERATIONAL FOR COMPLETE INTER-OPERABILITY BETWEEN GUESTROOM FUNCTIONS AND PMS, BMS AND GRMS.

OFFER FULL MAINTENANCE AND SERVICE AGREEMENT FOR PROJECTS.

MARRIOTT PREFERRED INTEGRATOR: SMARTCON SOLUTIONS LLC, TOM MIRANTE (844) 633-2412 OR THOMAS@SMARTCONSOLUTIONS.COM

	LOBBY & LO	OUNGE		HOTELS: LOBBIES/P	REFUNCTION	1115	30	34	7.5	0.06	323.7		0	0		
2	REGISTRATION			OFFICES: RECEPTION	N AREAS	1145	30	0	5	0.06	0 345.4	350	0	0	300	
	WORK ROC	WORK ROOM AND OFFICES		OFFICES: OFFICE SPACES		278	5	1	5	0.06	21.68	1	0	0		
		ROOM 120A		HOTELS: CONFEREN		512	50	25	5	0.06	155.72	155	0	0	130	
	BREAKFAST			FOOD AND BEVERA					+ -	0.00	200.72					
4	BUFFET	<u> </u>		FOOD AND BEVERA	GE SERVICE:	1174	70	82	7.5	0.18	826.32	850	0	0	880	
5	FITNESS			DINING ROOMS SPORTS AND AMUSEMENT: HEALTH CLUB/WEIGHT ROON		607	10	6	20	0.06	156.42	160	0	0	190	NEGATIVE PRESSURE
6	PBX			NO REQUIREMENT	THI NOON	66	0	0	0	0	0	0	0	0	66	
	WATER RO	OOM		NO REQUIREMENT		318.7						100	0	0	150	
	ENGINEERI			OFFICES: OFFICE SPA	ACES	0	5	0	5	0.06	0	100	0	0	66	
	FOOD PREF			FOOD AND BEVERAGE SERVICE: KITCHENS (COOKING)		334	0	0	0	0	0	100	0.7	233.8	250	NEGATIVE PRESSURE
10	ELECTRICAI	.L	NO REQUIREMENT		,	108	0	0	0	0	0	0	0	0	90	NEGATIVE PRESSURE
	POOL		С	SPORTS & AMUSEN SWIMMING POOLS AREA) WET DECK		1001		0	0	0.5	500.5	460	0	0	580	STAND ALONE DEHUMIDIFICATION SYSTEM WET DECK 710 * .5 = 355 CFM REQUIRED
Ī	POOL EQUI	IPMENT		NO REQUIREMENT		144		0				100	0	0	114	
	FIRST FLOC	OR CORRIDOR		PUBLIC SPACES: CO	RRIDOR	1539	0	0	0	0.06	92.34	400	0	0	90	2 AIR CHANGES PER HOUR
Ī	MENS AND WOMENS			PUBLIC SPACES: TOILETS PUBLIC		120 0	0		0	0	0	150	50CFM/WC	100	160	50CFM PER WATERCLOSET/URINAL REQUIRED, NEGATIVE PRESSURE
	STORAGE			NO REQUIREMENT								150	0	0	66	
	SECOND FL	LOOR CORRIDOR		PUBLIC SPACES: CO	RRIDOR	1539		0		0.06	92.34	400	0	0	90	2 AIR CHANGES PER HOUR
0	GUEST LAU	UEST LAUNDRY		DRY CLEANERS, LAU COIN-OPERATED LA		54	20	1	7.5	0.06	10.74	75	0	0	90	NEGATIVE PRESSURE
MAU	HOUSEKEEPING			NO REQUIREMENT		43						225	0	0	66	
	THIRD FLOOR CORRIDOR			PUBLIC SPACES: CO	RRIDOR	1539		0		0.06	92.34	400	0	0	90	2 AIR CHANGES PER HOUR
	HOUSEKEEPING AND STORAGE FOURTH FLOOR CORRIDOR		SE SE	NO REQUIREMENT								75	0	0	66	
				PUBLIC SPACES: CORRIDOR				0		0.06	92.34	400	0	0	90	2 AIR CHANGES PER HOUR
	HOUSEKEE	PING AND STORAG	SE SE	NO REQUIREMENT		43						75	0	0	66	
	KING		28	HOTELS: BEDROOM	/LIVING RM	210	10	2	5	0.06	22.6	30	50CFM/RM	50	50	EXHAUST FAN OPERATES INTERMITTENLY
	KING ALT E	NTRY	6	HOTELS: BEDROOM	/LIVING RM	260	10	2	5	0.06	25.6	30	50CFM/RM	50	50	EXHAUST FAN OPERATES INTERMITTENLY
	KING ACC KING SUITE KING SUITE LONG		1	1 HOTELS: BEDROOM/LIVING RM		418	10	4	5	0.06	45.08	45	50CFM/RM	50	50	EXHAUST FAN OPERATES INTERMITTENLY
			16	16 HOTELS: BEDROOM/LIVING RM		386	10	3	5	0.06	38.16	40	50CFM/RM	50	50	EXHAUST FAN OPERATES INTERMITTENLY
			16	16 HOTELS: BEDROOM/LIVING RM		260	10	2	5	0.06	25.6	30	50CFM/RM	50	50	EXHAUST FAN OPERATES INTERMITTENLY
	ACC. KING	SUITE	1	HOTELS: BEDROOM	/LIVING RM	495	10	4	5	0.06	49.7	50	50CFM/RM	50	50	EXHAUST FAN OPERATES INTERMITTENLY
	QUEEN QU	JEEN SHOWER	32	HOTELS: BEDROOM	/LIVING RM	329	10	3	5	0.06	34.74	35	50CFM/RM	50	50	EXHAUST FAN OPERATES INTERMITTENLY
	ALT ENTRY	A QUEEN QUEEN	3	HOTELS: BEDROOM	/LIVING RM	363	10	3	5	0.06	36.78	40	50CFM/RM	50	50	EXHAUST FAN OPERATES INTERMITTENLY
	ALT ENTRY	B QUEEN QUEEN	3	HOTELS: BEDROOM	/LIVING RM	352	10	3	5	0.06	36.12	40	50CFM/RM	50	50	EXHAUST FAN OPERATES INTERMITTENLY
	ACC. QUEE	N QUEEN ROLL-IN	1	HOTELS: BEDROOM	/LIVING RM	467	10	4	5	0.06	48.02	50	50CFM/RM	50	50	EXHAUST FAN OPERATES INTERMITTENLY
	ACC QUEEN	N QUEEN	1	HOTELS: BEDROOM	/LIVING RM	467	10	4	5	0.06	48.02	50	50CFM/RM	50	50	EXHAUST FAN OPERATES INTERMITTENLY
	QUEEN QU	JEEN SUITE	1	HOTELS: BEDROOM	/LIVING RM	484	10	4	5	0.06	49.04	50	50CFM/RM	50	50	EXHAUST FAN OPERATES INTERMITTENLY
	QUEEN QU	JEEN SUITE ACC	1	HOTELS: BEDROOM	/LIVING RM	494	10	4	5	0.06	49.64	50	50CFM/RM	50	50	EXHAUST FAN OPERATES INTERMITTENLY
												0150			6496	1.25%
												8150				POSITIVE PRESSURE IN ENTIRE BUILDING
	ſ							=\	<u>'LL ALIC</u> T	EANI G						
	,	- ASI				م	ECIFICATION:			TAN 3	CHEDULE	1	ı			
		PLAN IDENT.	MODEL	CFM	ELEC	· · · · · · · · · · · · · · · · · · ·		•	DISCHARGE		CONTROL		CTURE	REMARKS *		
IT ALLOWS F	_{=0R}		Y-0511VF1	50	115-1-60	6.2	CEILING	1		CONTINUO		PANAS	SONIC	L	INEN STORAC	<u>. </u>
OCCUPANCY	Y		G-1	35			"	1	II	CONTINUO		11 11				
OR LOCK. 1	THE		-G 1	25		1	1	1		CONTINUO		 				2ND ATILELOOPS

VENTILATION COMPLIANCE SUMMARY 23116 (03-13-24)

25

(NET)

SQFT

632

OCCUPANCY CLASSIFICATION

DRY CLEANERS, LAUNDRIES:

GENERAL:BREAK ROOM (PER

HOTELS: LOBBIES/PREFUNCTION

COMMERCIAL LAUNDRY

ASHRAE 62.1 2016)

ROOM NAME

AUNDRY

BREAK ROOM

LOBBY & LOUNGE

DENSITY

#/1000 SQFT

30

RATE PER RATE PER

CFM | CFM/SQFT

34 | 7.5 | 0.06 | 323.7 |

0.06

TOTAL

REQUIRED

187.8

150

37.84

PROVIDED

EXHAUST AIRFLOW

REQUIRED

0.00

REMARKS

NEGATIVE PRESSURE

200

PLAN				SPE	CIFICATIONS	•		REMARKS *			
IDENT.	MODEL	CFM	ELEC	WATTS	LOCATION	DISCHARGE	CONTROL	MANUFACTURE	REI IARNO T		
EF-1	FV-Ø511 / F1	50	115-1-60	6.2	CEILING	II	CONTINUOUS	PANASONIC	LINEN STORAGE		
EG-2	EG-1	35			11	11	CONTINUOUS	П	NOTE: 1 & 2 GUEST ROOMS IST FLOOR		
EG-3	EG-1	35			11	II	CONTINUOUS	П	NOTE: 1 & 2 GUEST ROOMS 2ND - 4TH FLOORS		
EF-4	FV-Ø511 / F1	80	11	9.9	11	II	CONTINUOUS	П	PUBLIC RESTROOMS		
EF-5	FV-15NLFS1	130	11	21.1	11	11	CONTINUOUS	П	NOTE: 4 MEETING ROOM		
EF-6	FV-Ø511VF1	110	П	21.1	11	II	MANUAL	П	NOTE: 6 ENGINEERING		
EF-1	FY-1115YQ1	150	П	28.4	П	II	THERMOSTAT	П	NOTE: 5 VENDING / ICE		
EF-8	FV-Ø511VF1	110	П	21.1	11	11	THERMOSTAT	П	NOTE: 5 ELECTRICAL		
EF-9	FV-Ø511VF1	110	П	21.1	11	11	CONTINUOUS	П	NOTE: 4 WORK AREA		
EF-1Ø	FV-3ØVQ3	29Ø	11	.53 AMPS	11	II	MANUAL	П	NOTE: 6 FOOD PREP		
EF-II (2)	FV-4@NLF1	440	Ш	55.5	П	II	CONTINUOUS	П	NOTE: 4 BREAKFAST		
EF-12	FV-20VQ3	190	Ш	42	П	II	CONTINUOUS	П	NOTE: 6 LAUNDRY		
EF-13	FV-Ø511VF1	110	11	21.1	П	II	CONTINUOUS	п	NOTE: 4 EMPLOYEE LOUNGE		
EF-14	FV-1115/Q1	150	П	28.4	П	11	MANUAL	П	NOTE: 6 GUEST LAUNDRY		
EF-15	FV-20VQ3	190	Ш	42	П	II	MANUAL	П	NOTE: 6 FITNESS		
EF-16	FV-Ø511VF1	110	11	21.1	П	II	THERMOSTAT	П	NOTE: 5 PBX		
EF-17	FV-1115/Q1	150	Ш	28.4	П	II	THERMOSTAT	П	NOTE: 5 WATER		
EF-18	FV-Ø511VF1	110	11	21.1	11	II	THERMOSTAT	п	NOTE: 5 CORNER MARKET		
EF-19	FV-Ø511VF1	110	11	21.1	П	II	THERMOSTAT	п	NOTE: 5 LINEN STORAGE / STORAGE		
EF-2Ø	FY-20YQ3	190	11	42.0	П	II	THERMOSTAT	п	NOTE: 5 POOL EQUIPMENT ROOM		
EF-21	(2) FY-30YQ3	29Ø	11	.53 AMPS	П	II	NOTE: 3	п	NOTE: 3 POOL ROOM		
EF-22	FY-20YQ3	190	II	.35 AMPS	П	II	CONTINUOUS	П	NOTE: 4 LOUNGE		

THERMOSTAT ON EXHAUST FAN IS TO PREVENT OVERHEATING. THERMOSTAT SETTING ON EXHAUST FAN IS TO BE SET AT 80° WITH MANUAL OVERRIDE. THERMOSTAT TO BE MOUNTED AT 1'-0" AFF.

IDENT

ACC-2

2)ACC-4

ACC-5

ACC-6

ACC-8

ACC-9

ACC-11

NOTE

115-1-60 NOTE: 4 ACC-3

NOTE 1

NOTE 1

NOTE 1

NOTE 1

NOTE 1

NOTE 1

OUTDOOR UNITS

COOLING

48*,000*

60,000

3*0,000*

(2)48*,000*

60,000

12,000

18*,000*

18*,000*

3*0,000*

12*,000*

40,200

208-3-60

208-1-60

208-3-60

208-1-60

208-1-60

208-1-60

208-1-60

208-3-60

HEATING & COOLING EQUIPMENT SCHEDULE

HP POWER

115-1-60

115-1-60

115-1-60

115-1-60

DC 24V

DC 24V

DC 24V

DC 24V

208-3-60

INDOOR UNITS

HEATING

BTUH INPUT

60,000

100,000

40*,000*

(2)80,000

80,000

19,000

19,000

34*,000*

20/6 KW

COOLING

48*,000*

60,000

3*0,000*

(2)48,000

60,000

12*,000*

18,000

18,000

30,000

12,000

43.1 (MBH)

GENERAL NOTES:

THE MECHANICAL CONTRACTOR SHALL VERIFY ALL DUCT SIZING AND COORDINATE LAYOUT WITH STRUCTURAL SYSTEM

COORDINATE DUCT LOCATIONS WITH PLUMBING CONTRACTOR

SEE SHEET M-16 TO SIZE DUCT FOR MAKE-UP AIR UNIT LOCATED ON ROOF

ALL GRILLES WITHOUT VOLUME DAMPERS SHALL BE FURNISHED WITH APPOSED BLADE LOUVERS FURNISH A FLEXIBLE CONNECTION BETWEEN DUCTWORK AND AIR HANDLER

FURNISH LOW AMBIENT CONTROLS IN EXTERIOR CONDENSERS.

BUILDING VENTS & PIPES SHALL BE PAINTED TO MATCH THE BUILDING COLOR - ALL EXTERIOR PENETRATIONS TO BE COORDINATED TO ABOVE OR BELOW EXTERIOR MOLDINGS

THE MECHANICAL CONTRACTOR SHALL FURNISH AND INSTALL ALL CONDENSER PADS EXCEPT AS SHOWN ON FOUNDATION

FURNISH AND INSTALL LOCKABLE COVERS ON ALL THERMOSTATS IN PUBLIC LOCATIONS.

I DAY PROGRAMABLE THERMOSTATS AS MFR BY HONEWELL WITH LOCKABLE COVERS IN PUBLIC LOCATIONS

PROVIDE 10 FEET OF ACOUSTICALLY LINED SUPPLY AND RETURN DUCT MAINS FOR EACH AC UNIT (15 FEET RECOMMENDED FOR MEETING ROOMS.

0	ENGINEERING	AC-8	423 - 635	100
٥	FOOD PREP	AC-9	TØ5 - 92Ø	200
0	ELECTRICAL	AC-10	320 - 425	
11	POOL	AC-11	1750	450

1)	FIELD INSTALL CONDENSATE PUMP IN FAN COILS UNITS

IDENT

AC-3

1,600

2,000

1000

3,2*00*

423 - 635

AC-5 | 1042 - 1483

AC-6 320 - 425

3) PROVIDE SCR CONTROL FOR ALL ELECTRIC HEAT ABOVE 5KW AND A TWO-STEP CONTROL FOR ELECTRIC BELOW 5KW 4) PROVIDE 10 FEET OF ACOUSTICALLY LINED SUPPLY AND RETURN DUCT MAINS FOR EACH AHU WHERE POSSIBLE

O/A

35Ø

160

FURNACES ARE SEALED COMBUSTION (DIRECT-VENT) SYSTEM

MITSUBISHI PKA-A12HA7 | AVENDRA HOTELSTAT 5-10505

THERMOSTAT

DEBONAIR 33CSSN2-MH

DEBONAIR 33C66N2-MH

DEBONAIR 33CSSN2-MH

DEBONAIR 33C66N2-MH

DEBONAIR 33C66N2-MH

AVENDRA HOTELSTAT 5-10505

AVENDRA HOTELSTAT 5-1050

AVENDRA HOTELSTAT 5-10505

AVENDRA HOTELSTAT 5-10505

BRYANT CAPVP4817

BRYANT CAPYP6021

BRYANT CAPVP3014

2)BRYANT CAPVP4817

BRYANT CAPYP6021

20/6 KW DUCT HEATER SERESCO

AGATWNDTEØ1A

FOR LINE SETS OVER 50' TO BE UPSIZED

INDOOR UNIT

BRYANT 9165A48060517

BRYANT 9165A6Ø100521

BRYANT 9165A30040514

2)BRYANT 916SA48060S1

BRYANT 9165A60080521

MITSUBISHI PKA-A12HA7

MITSUBISHI PKA-AISHAT

MITSUBISHI PKA-AISHAT

MITSUBISHI PKA-A30KA7

NE-004-VP-I-A2NTII72EIC2AE0

RCHITECTURA

BY MARRIOTT

JOB TITLE

 $\overline{\simeq}$ \mathcal{L}

 \sum

JOB NO.

05/30/25

REVISIONS



OUTDOOR UNIT

BRYANT 123APAØ48

BRYANT 123APA060

BRYANT 123ANA030

(2)BRYANT 123APAØ48

BRYANT 123APA060

MITSUBISHI PUY-AI2NKAT

MITSUBISHI PUZ-AISNKAT

MITSUBISHI PUZ-AISNKAT


MITSUBISHI PUY-AI2NKAT

NC-B-IV-CUCSM-V

MITSUBISHI PUZ-A30KAT

SHEET NO. SCHEDULE

& DETAILS

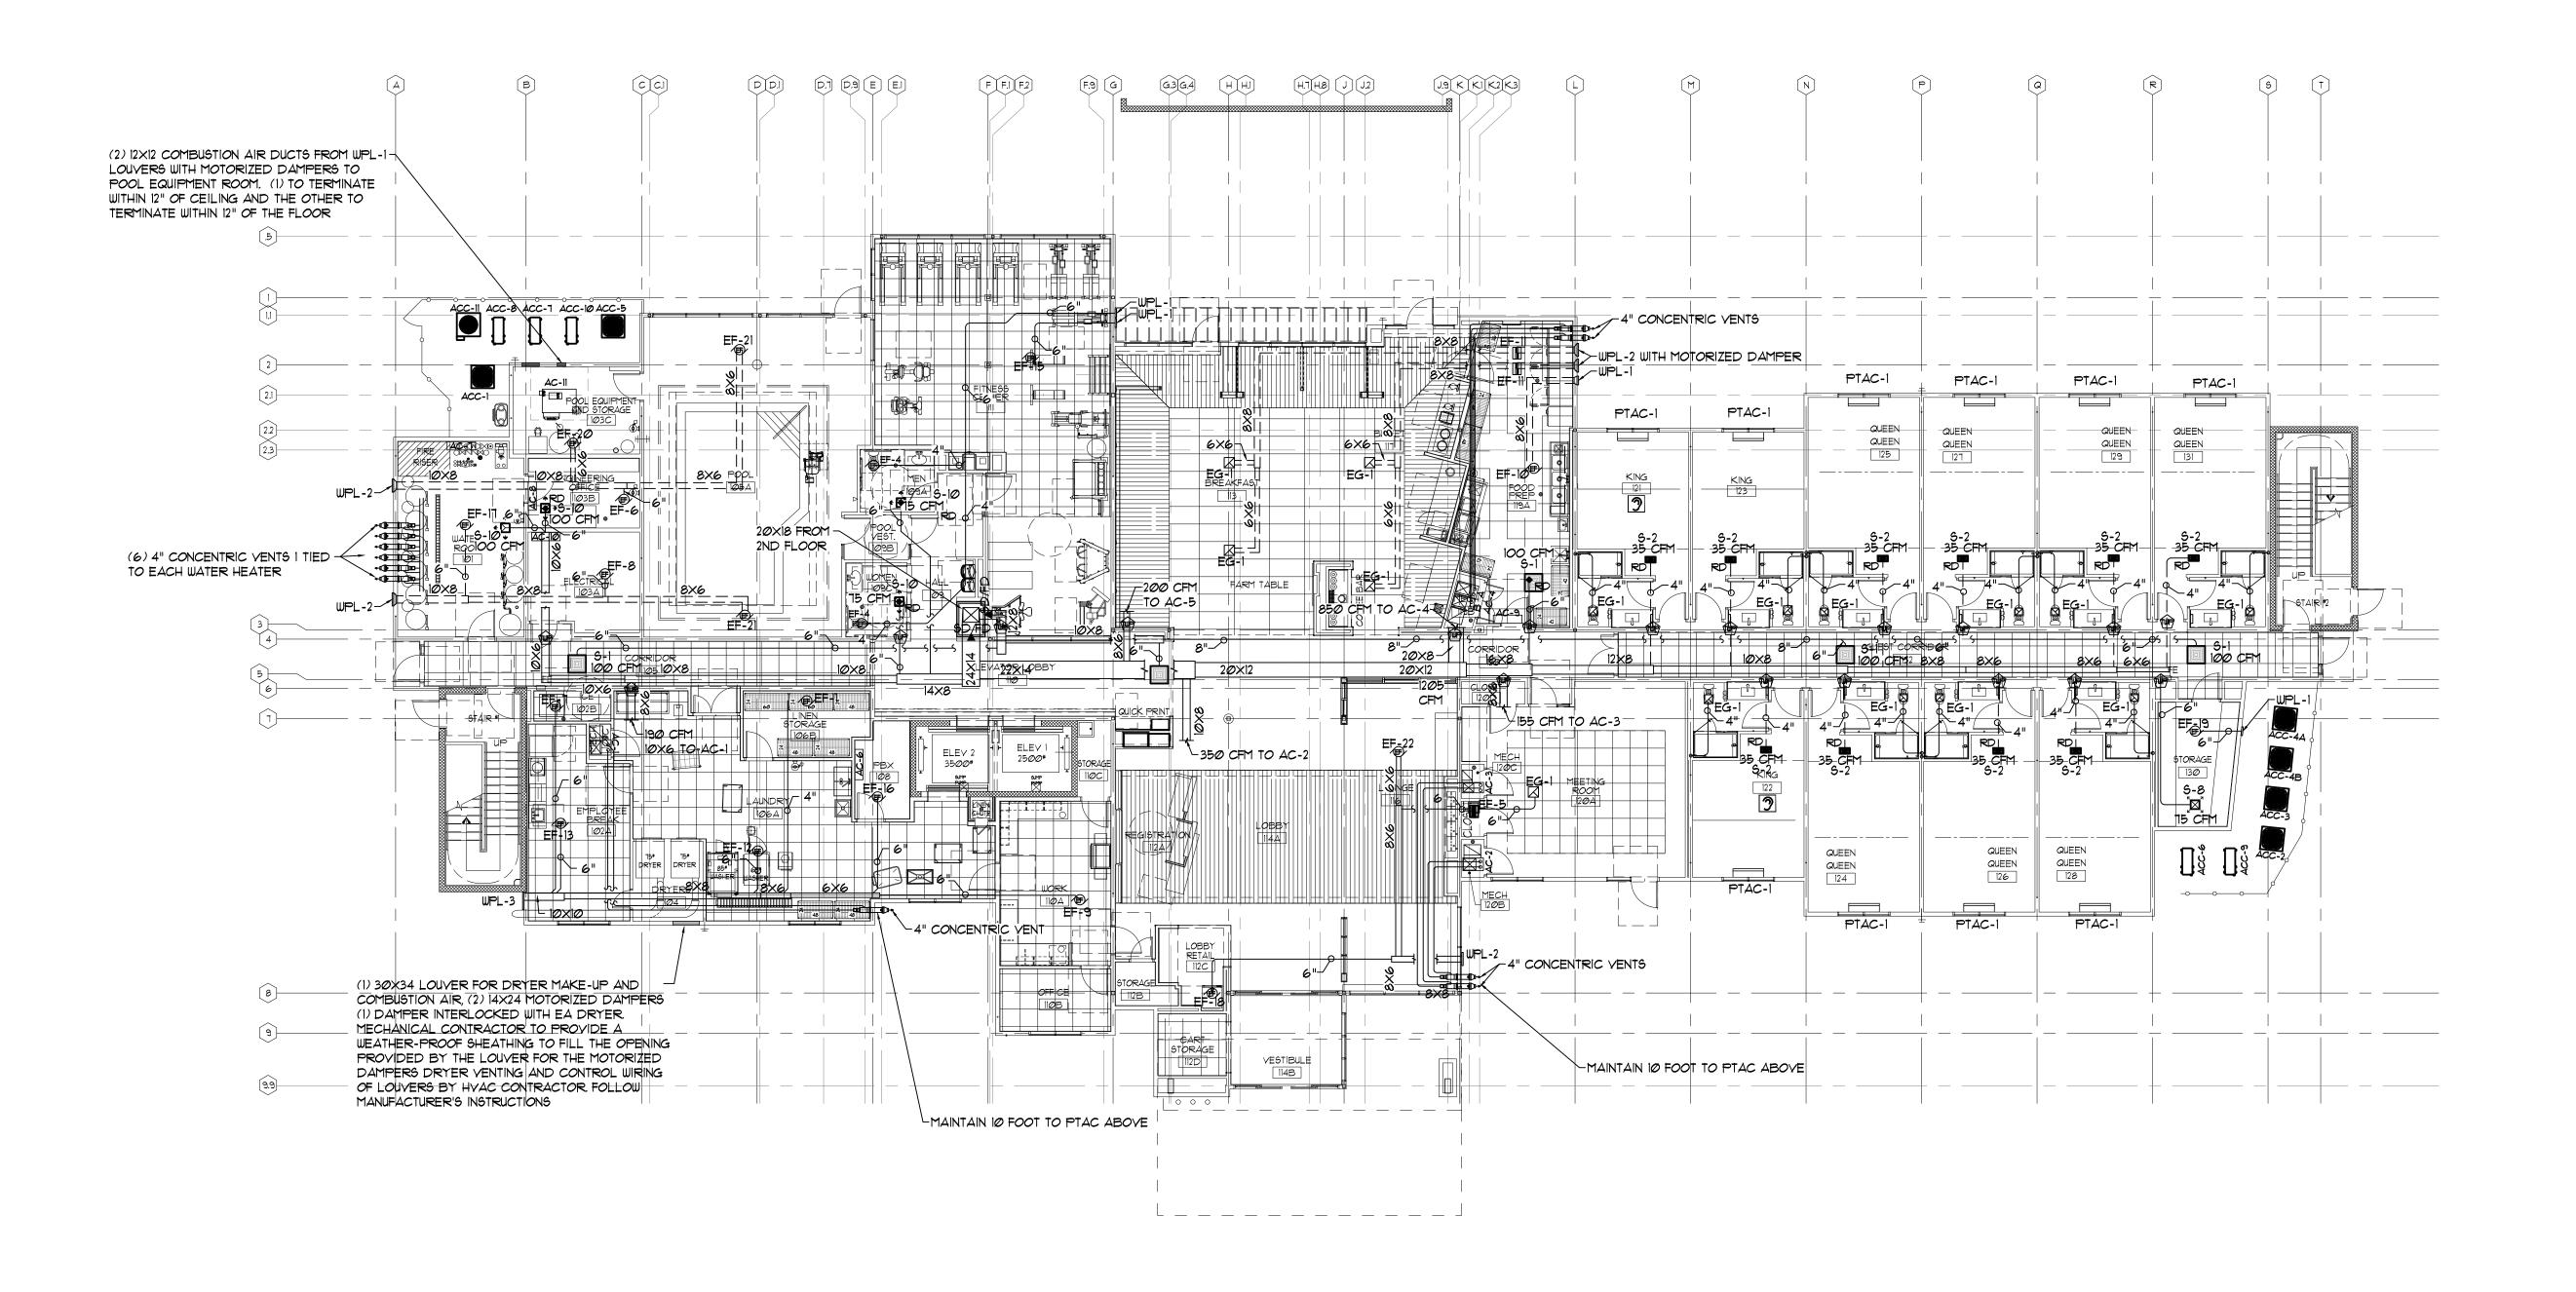



G ROUP ARCHITECTURAL 201 S. Nappanee St. Elkhart Indiana

Fairfield BY MARRIOTT

JOB TITLE

RRIOT

ΒY

MA 709607 AIRFIELD Marf

JOB NO.

24126


DATE 05/30/25

REVISIONS



SHEET NO.

FIRST FLOOR

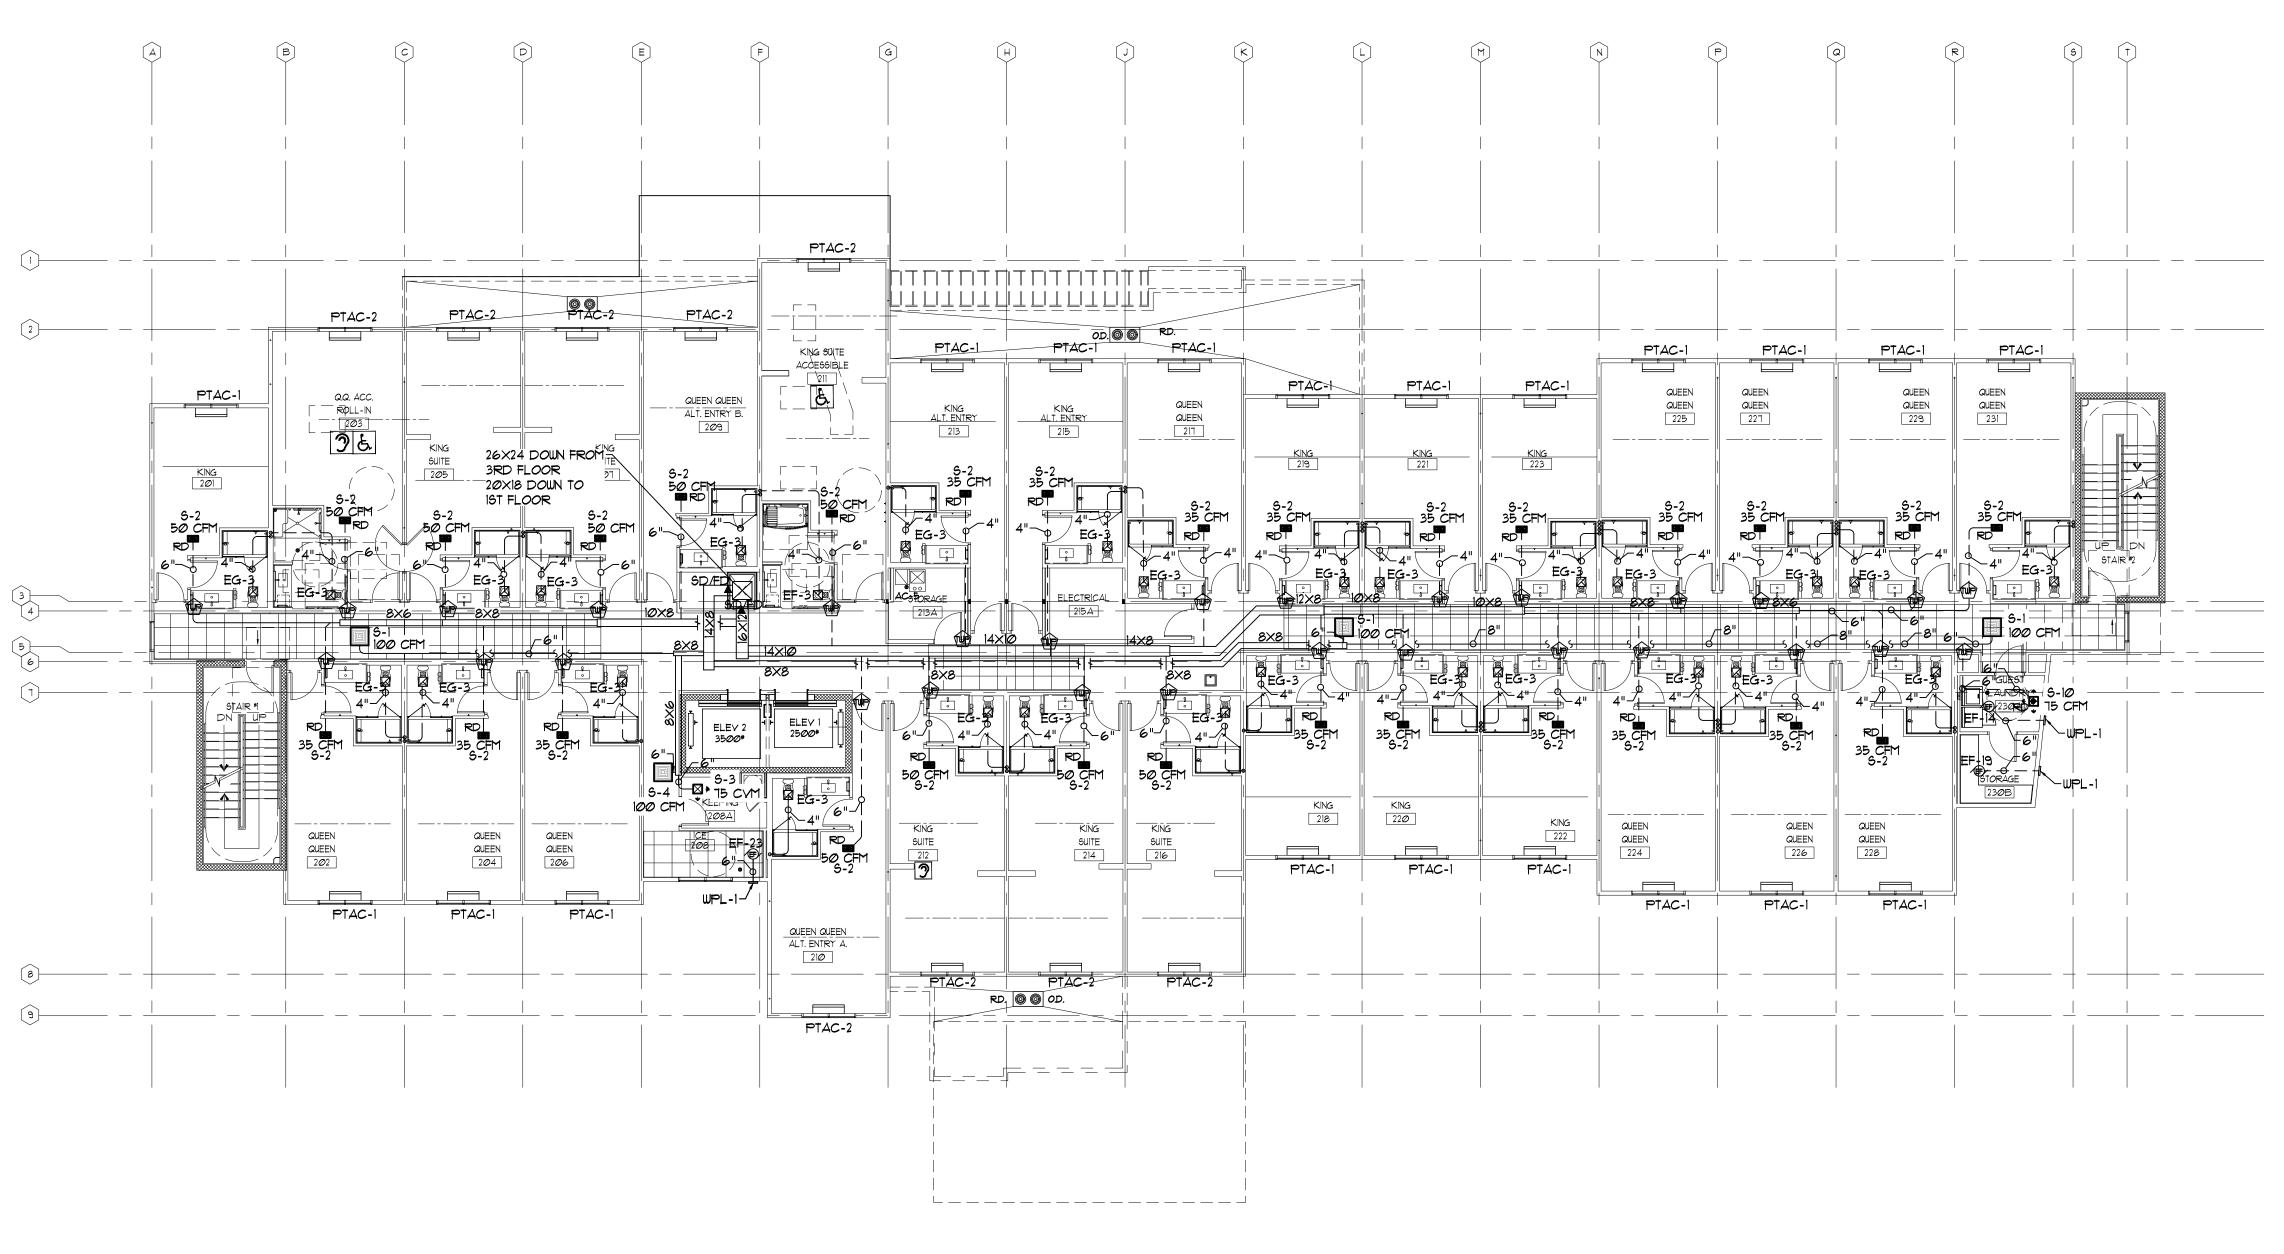

SECOND FLOOR PLAN

9CALE: 3/32" = 1'-0"

ARCHITECTURAL GROUP III

201 S. Nappanee St. Elkhart Indiana 46514-1953 • 574/293-0008
architecturalgroup3.com

Fairfield BY MARRIOTT

JOB TITLE

MARRIOTT 170960 N, IN

FAIRFIELD BY MARI
MARRIOTT #70960
PENDLETON, IN
A NEW 97 ROOM HOTE

JOB NO. 24126


DATE 05/30/25

REVISIONS



SHEET NO.

M1.2 SECOND FLOOR PLAN

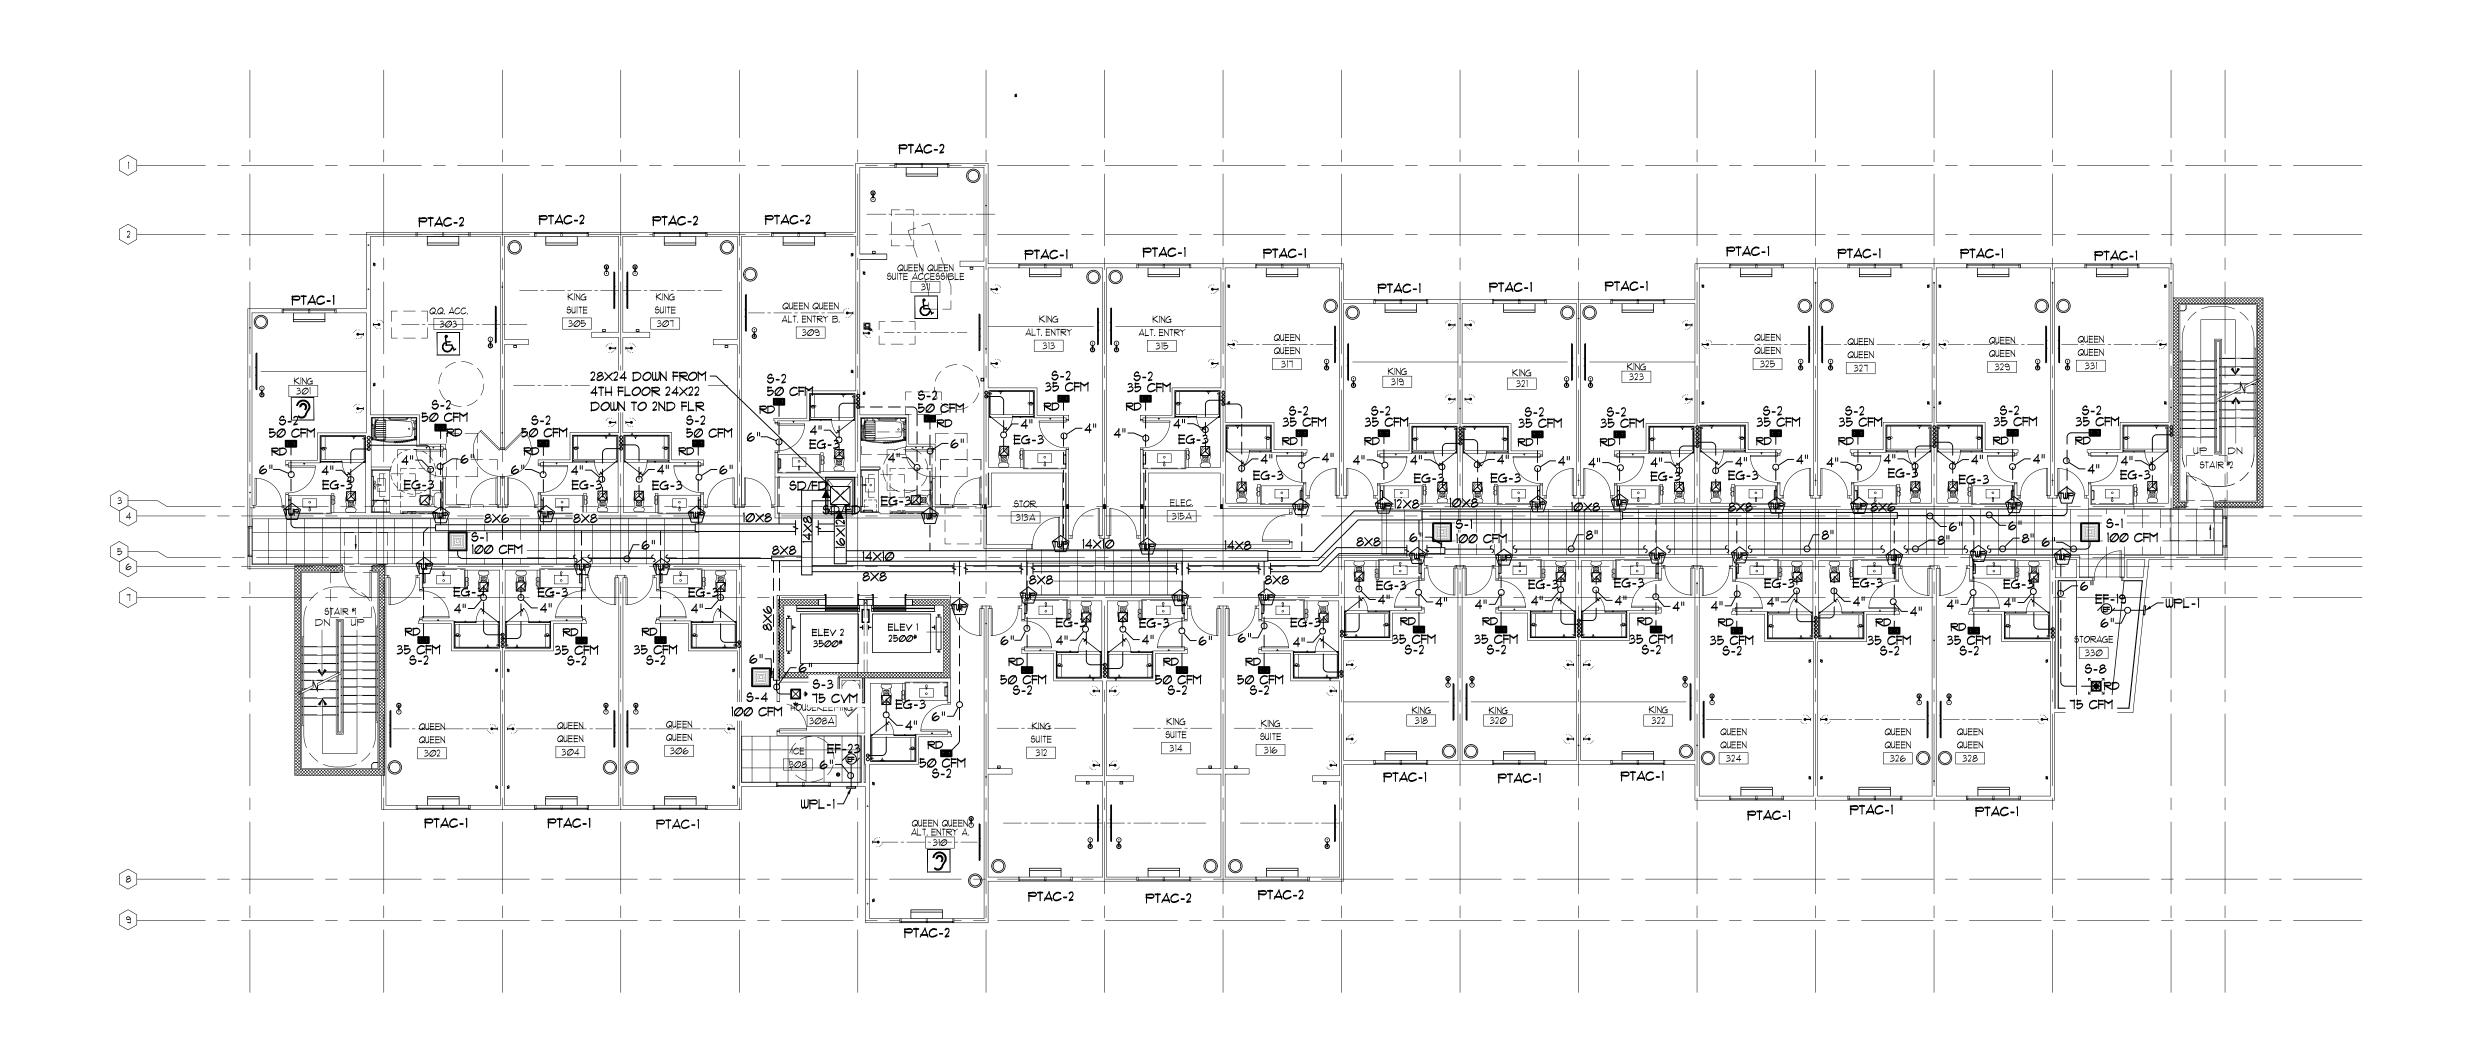

THIRD FLOOR PLAN

9CALE: 3/32" = 1'-0"

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Fairfield BY MARRIOTT

JOB TITLE

FAIRFIELD BY MARRIOTT
MARRIOTT #70960
PENDLETON, IN
A NEW 97 ROOM HOTEL

JOB NO. 24126


DATE 05/30/25

REVISIONS



SHEET NO.

M1.3
THIRD FLOOR

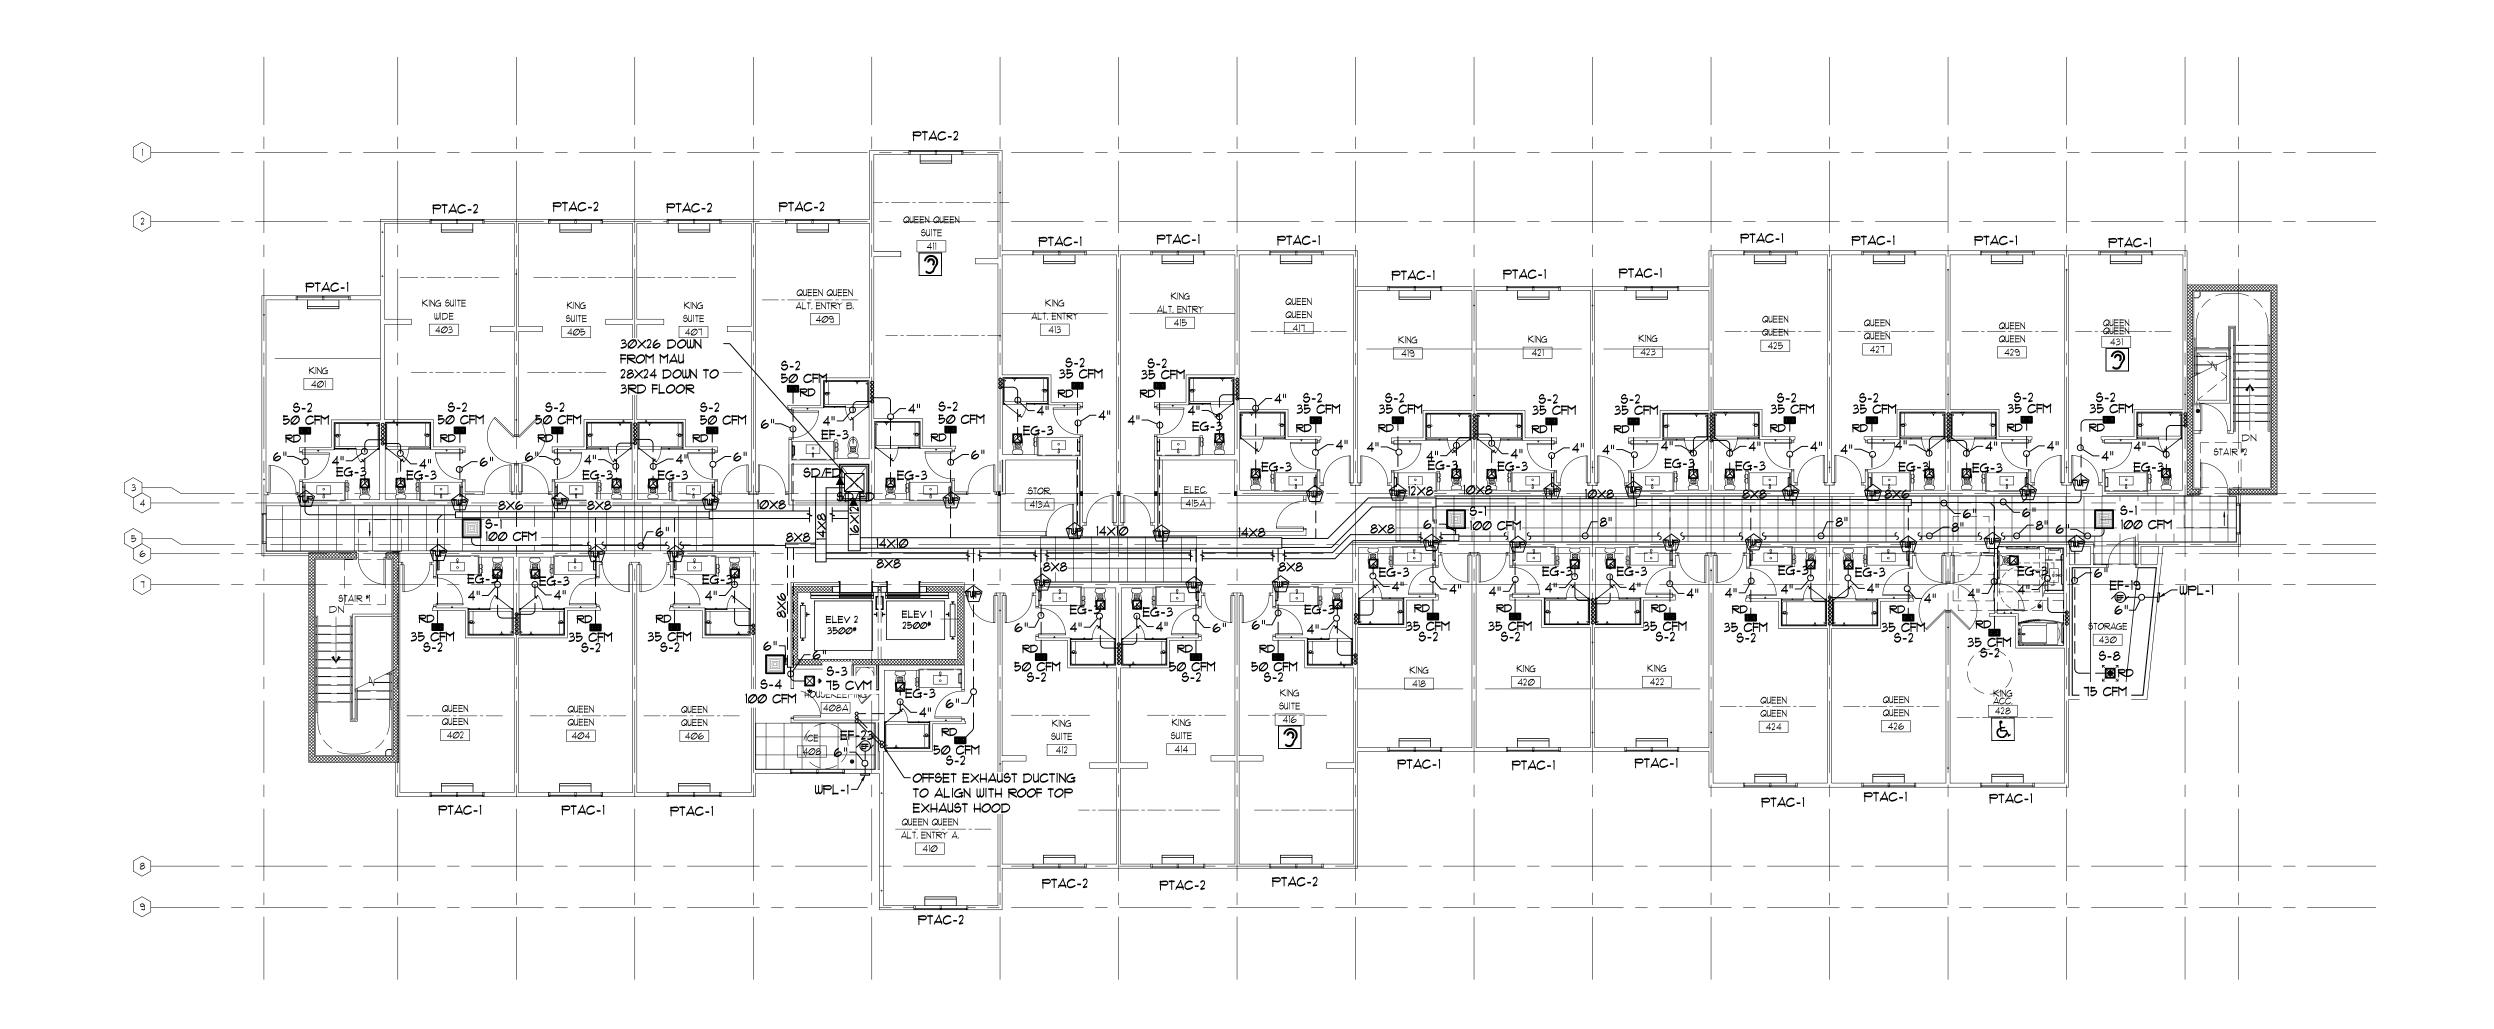

FOURTH FLOOR PLAN

9CALE: 3/32" = 1'-0"

ARCHITECTURAL GROUP III
201 S. Nappanee St. Elkhart Indiana 46514-1953 • 574/293-0008

Fairfield BY MARRIOTT

JOB TITLE

MARRIOTT 470960 N, IN

FAIRFIELD BY MAR
MARRIOTT #70960
PENDLETON, IN
A NEW 97 ROOM HOT

JOB NO. 24126


DATE 05/30/25

REVISIONS



SHEET NO.

M1.4

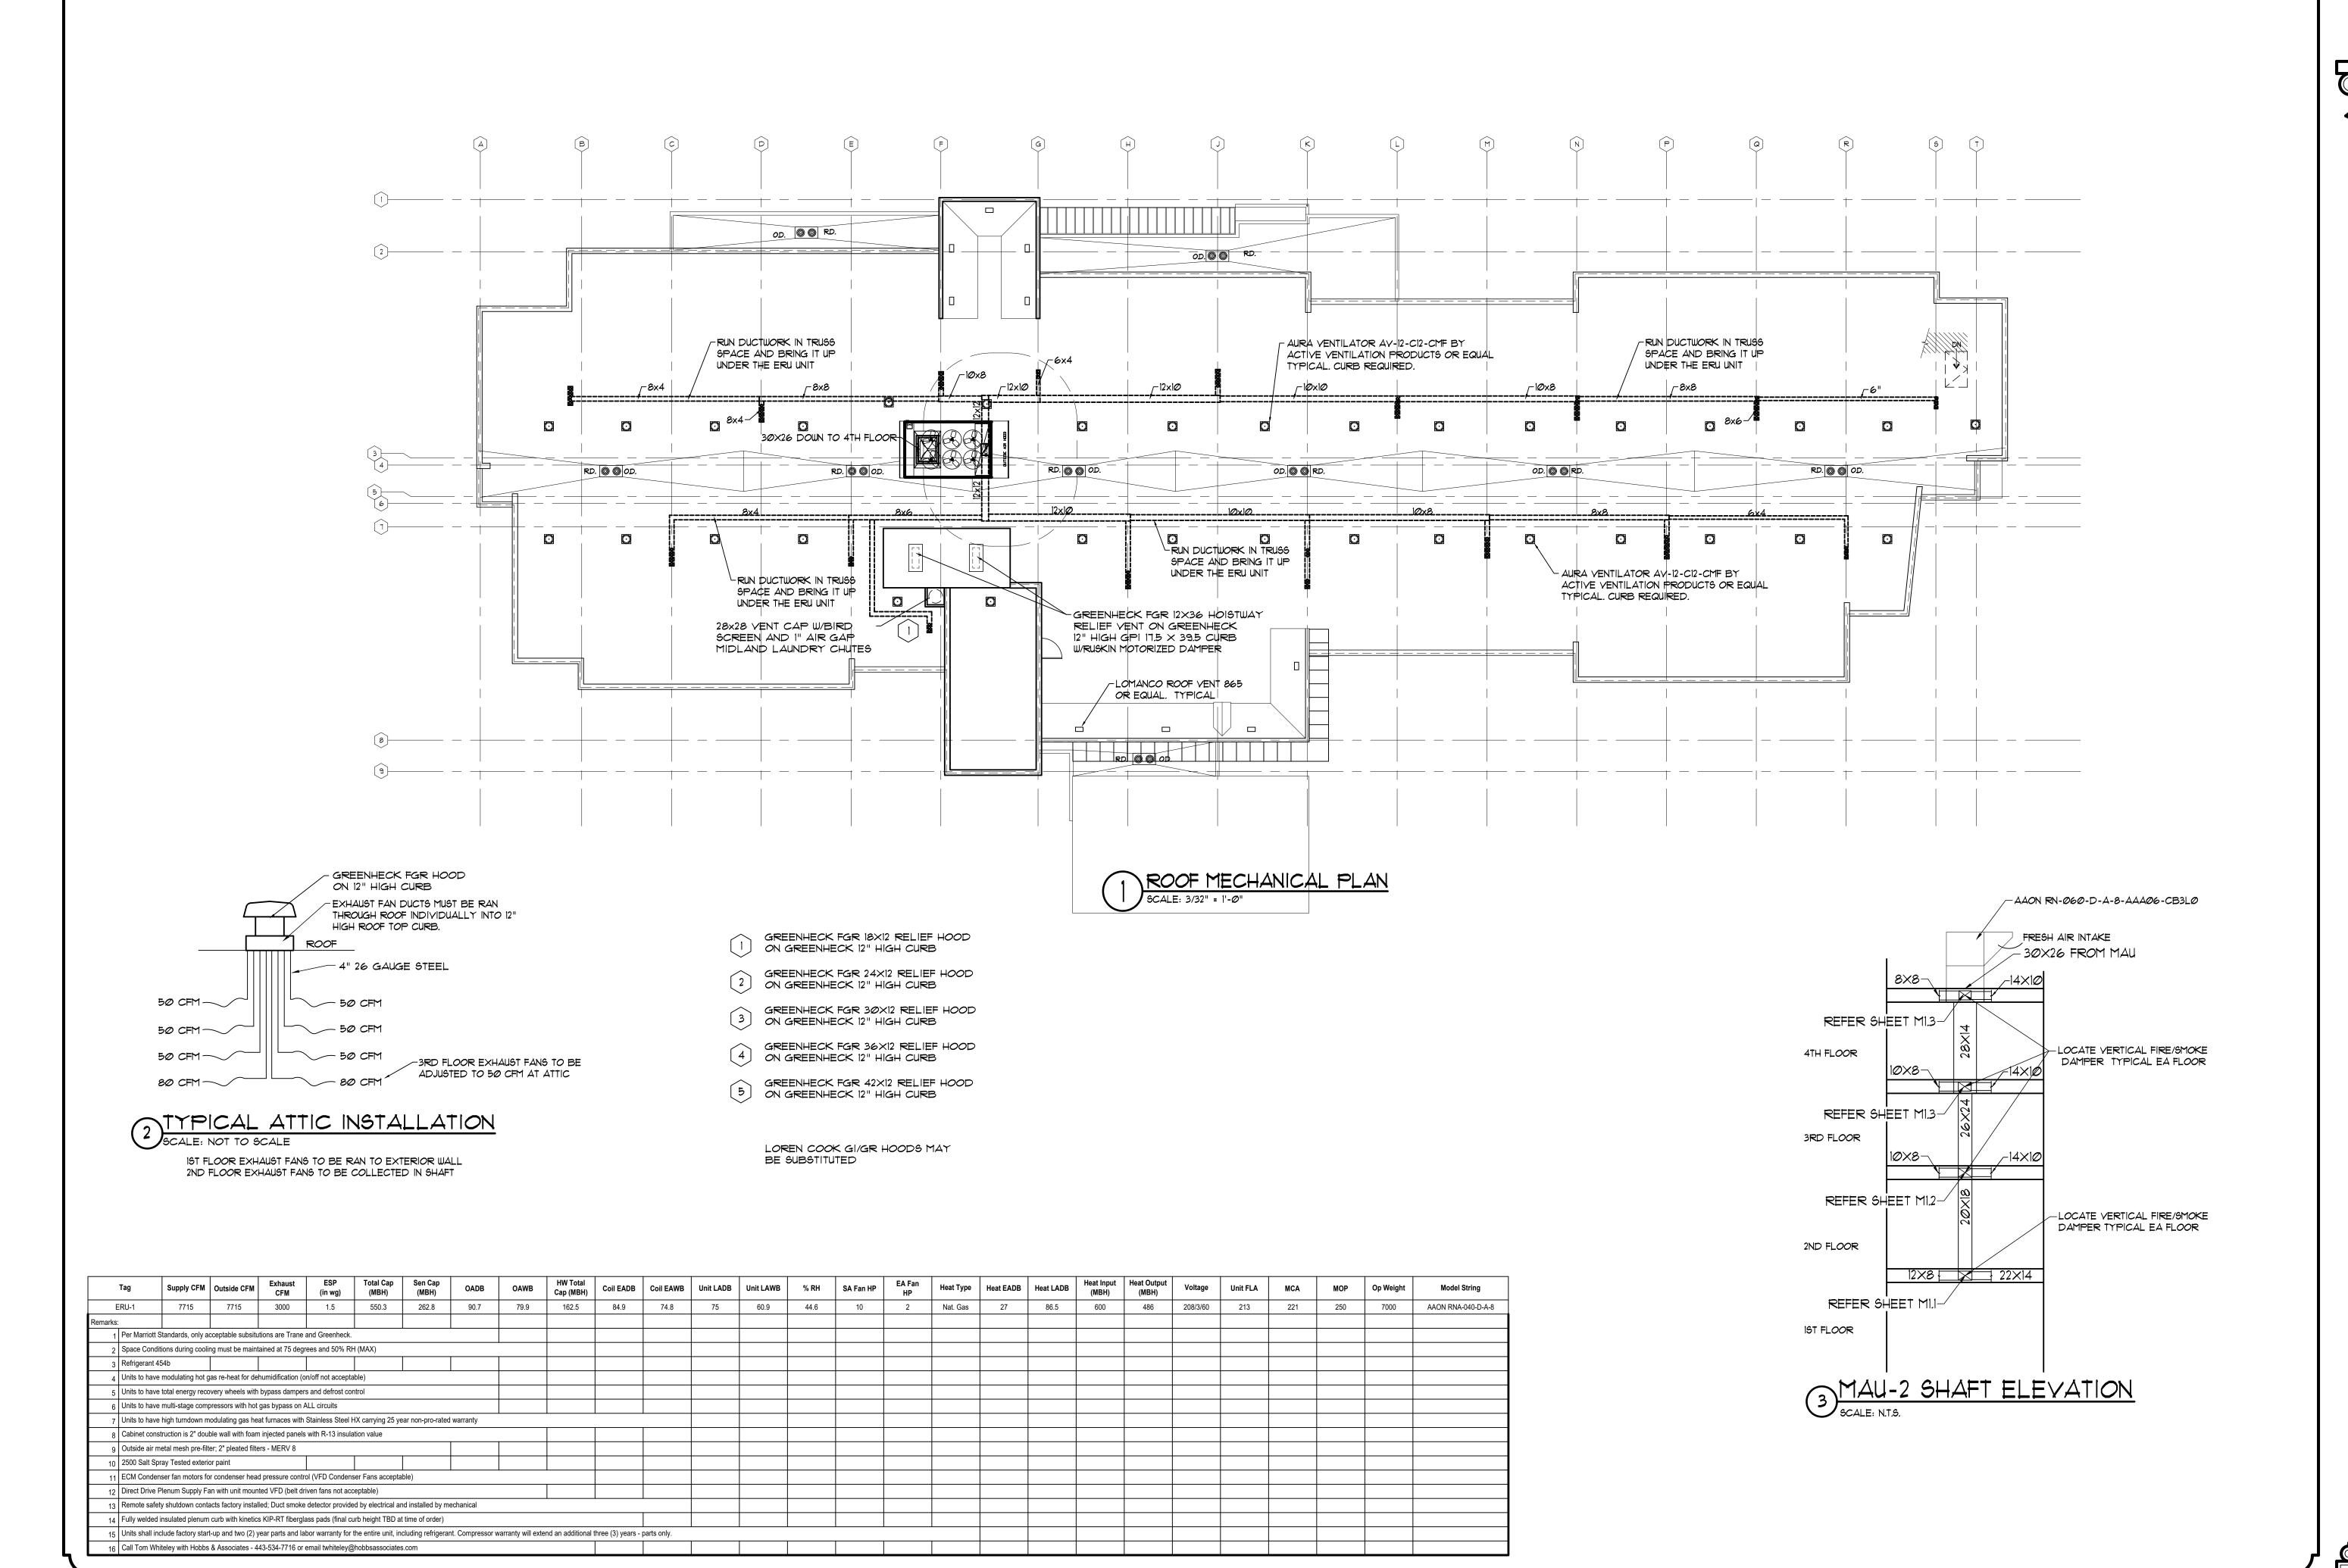

ARCHITECTURAL GROUP III
201 S. Nappanee St. Elkhart Indiana 46514-1953 • 574/293-0008

Fairfield

JOB TITLE

D BY MARRIOTT ARRIOTT #70960

PENDLETON, IN

PAIRFIE NO.

DATE 05/30/25

24126

REVISIONS



SHEET NO.

M1.5

