


ROOM FINISHES SCHEDULE					
ROOM No.	ROOM NAME	FLOOR	WALL (LOW LEVEL)	WALL CLADDING (HIGH LEVEL)	CEILING REMARKS
101	STORAGE AREA	O	O	O	O

SBC BUILDING CLASSIFICATION SCHEDULE					
CODE REQUIREMENTS					
OCCUPANCY CLASSIFICATION		S			
TYPE OF CONSTRUCTION		II-B			
PROPOSED ACTUAL BUILDING AREAS AND HEIGHT (TO HIGHEST POINT)		AREA = 112.36 Sqm HEIGHT = 6.45m			
FIRE RESISTANT RATING FOR EACH STRUCTURAL ELEMENT (TABLE 601 & TABLE 602)		SEE FLOOR PLAN			

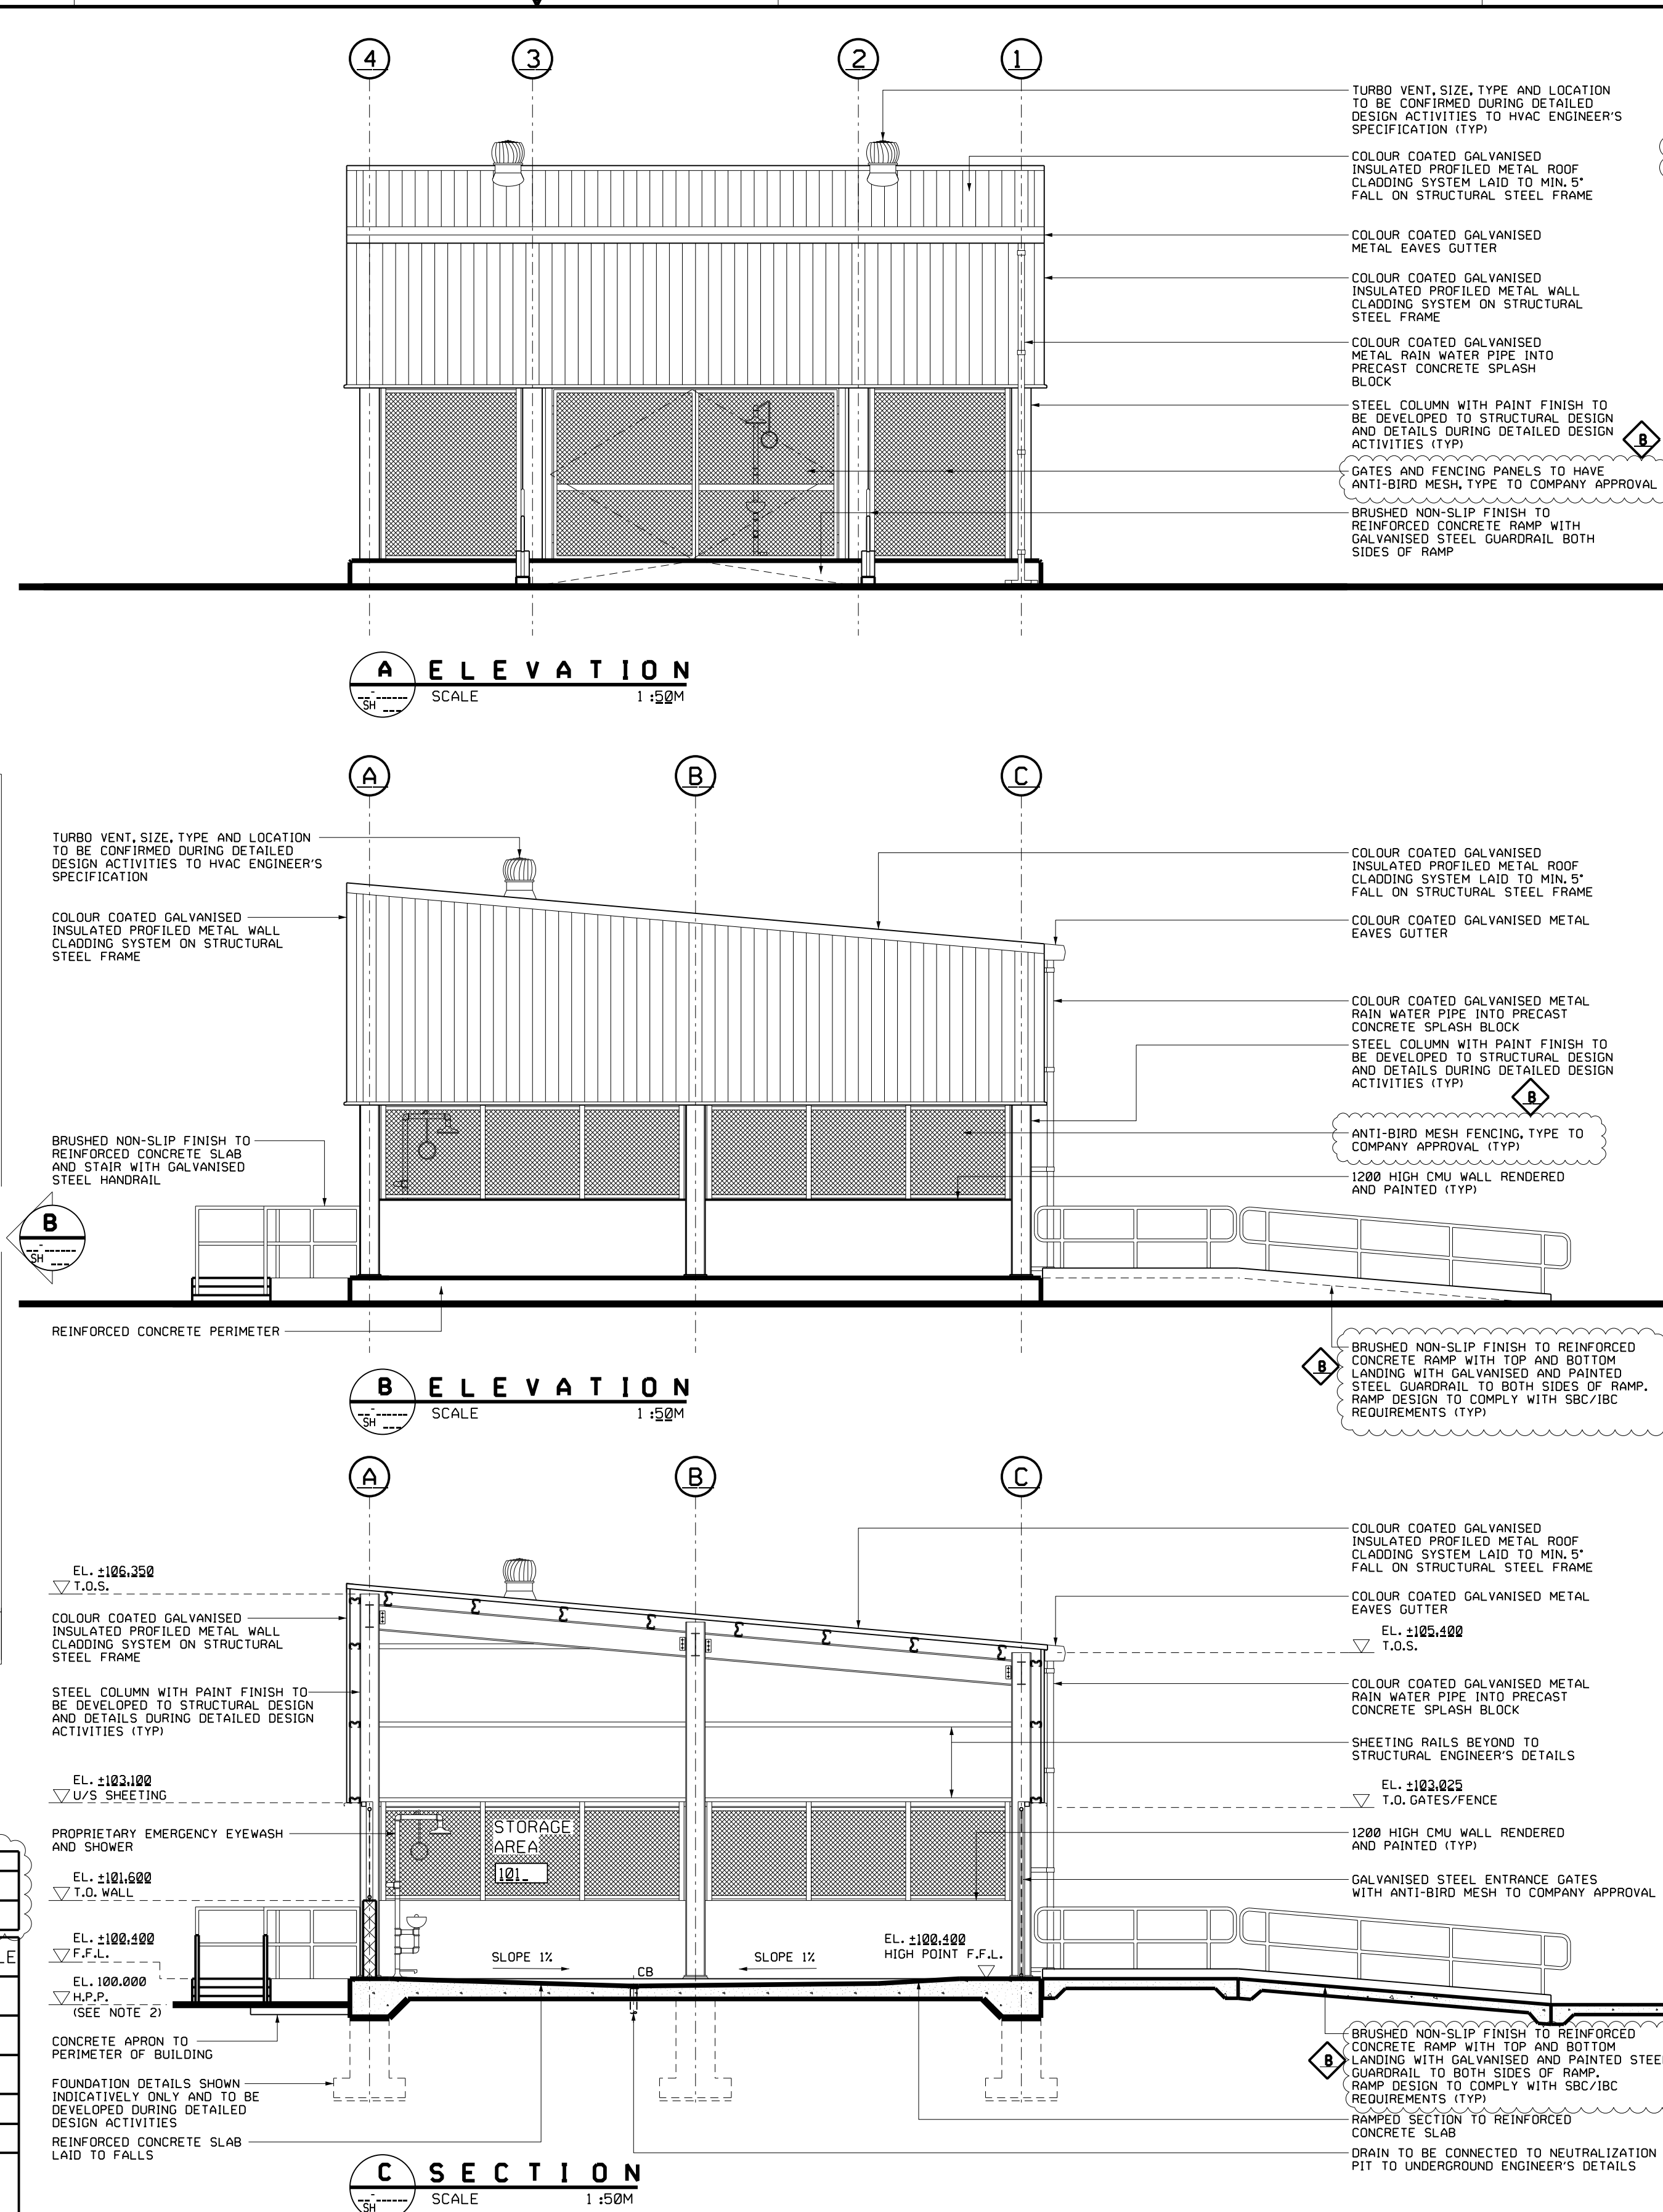

NOTES:

- ALL DIMENSIONS ARE IN MILLIMETERS. ALL LEVELS ARE IN METERS UNLESS NOTED OTHERWISE.
- H.P.P. VARIES. ALL ELEVATIONS SHOWN ARE RELATIVE TO H.P.P. REFER TO UNIT PLOT PLANS FOR H.P.P. DETAILS.
- DO NOT SCALE THIS DRAWING.
- THIS DRAWING SHALL BE READ IN CONJUNCTION WITH BUILDING DESIGN SPECIFICATION PP-824402 AND BRA REPORT PP-834983 FOR BUILDING DESIGN, BLAST RESISTANCE, FIRE SAFETY AND PROJECT SPECIFIC REQUIREMENTS.
- CONTRACTOR SHALL REVIEW AND CONFIRM THE IBC/SBC CLASSIFICATION SCHEDULE AND CODE REQUIREMENTS DURING DETAILED DESIGN ACTIVITIES.
- SHELTER DESIGN SHOWN, IS PRELIMINARY ONLY AND SHALL BE FURTHER DEVELOPED DURING DETAILED DESIGN ACTIVITIES FOR COMPANY'S APPROVAL.
- CONTRACTOR MAY PROPOSE ALTERNATIVE STRUCTURAL DESIGN ARRANGEMENTS TO MEET PROJECT STANDARDS AND REQUIREMENTS, SUBJECT TO COMPANY'S APPROVAL.
- CONTRACTOR SHALL CONFIRM THE VOLUME AND TYPE OF CHEMICALS TO BE STORED IN EACH CHEMICAL SHELTER WITH COMPANY AND PROPOSE RELEVANT SAFETY MEASURES DURING DETAILED DESIGN ACTIVITIES.
- FINAL LOCATION OF THE CHEMICAL SHELTER SHALL BE EVALUATED DURING DETAILED DESIGN ACTIVITIES. LOCATION TO BE DOWNWIND UNLESS AGREED BY THE COMPANY OTHERWISE.
- THE UNDERGROUND DRAINAGE SCHEMATICS, INCLUDING ALL OILY SUMP COLLECTION POINTS, ARE INDICATED ON UNDERGROUND DRAWINGS.
- EPC CONTRACTOR SHALL BE RESPONSIBLE FOR DEVELOPING THE FINAL DETAILED DESIGN DRAWINGS IN ACCORDANCE WITH THE PROJECT STANDARDS AND SPECIFICATION.
- EMERGENCY EYE WASH STATION TO BE PROVIDED IN ACCORDANCE WITH SAES-B-069

LEGEND

- IN-SITU CONCRETE
- ELEVATIONS IN PLAN
- ROOM NUMBER
- CB - CATCH BASIN
- COP - CLEAN OUT POINT
- EL. - ELEVATION
- EW/S - EMERGENCY EYE WASH & SHOWER
- F.F.L. - FINISHED FLOOR LEVEL
- H.P.P. - HIGH POINT PAVING
- RWP - RAIN WATER PIPE
- T.O.S. - TOP OF STEEL
- U/S - UNDERSIDE

REFERENCE DRAWINGS

GAS PLANT PLOT PLAN JFCP PHASE II	PP-014104-001
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KEY PLAN

HOLD

REV	DATE	BY	CHKD	APP	PRJ	PRO	HSE	CIV	ELE	COM	CON
01	02/02/23										
01	09/07/22	SD	MB	SR							
AFW	DATE	BY	CHKD	APP	PRJ	PRO	HSE	CIV	ELE	COM	CON

0 1.0 2.0 3.0 4.0 5.0 METERS

SCALE: 1:500

REVISION VALIDATION

THIS REVISION NO. **B** IS COVERED, FOR ALL APPROVAL AND CERTIFICATION REQUIREMENTS, PER SAES-334, UNDER DRAWING COMPLETION CERTIFICATE NO: **10-14815-0001-000**

DESIGN CERTIFICATION	REVIEW FOR KEY DRAWINGS	OTHER
ENG./DATE TBA TBA	CHECKED (SAUDI ARAMCO) OPERATIONS/DATE BY/DATE	
REV NO./DATE B 02/02/23	REVISION DESCRIPTION ISSUED FOR PROPOSAL	

JOB ORDER/REV NO. **10-14815-0001**

THIS REVISION IS NOT TO BE USED FOR CONSTRUCTION UNTIL CERTIFIED AND DATED

SAUDI ARABIAN OIL COMPANY

FLOOR PLAN		ARC
CHEMICAL SHELTER PLAN ELES SEC		
JFCP INLET, STORAGE AND EXPORT		
JAFURAH		SAUDI ARABIA
PLANT NO. 863 R	INDEX PP-474050	DRAWING NUMBER 001 B