


NOTES


1. CONCRETE TO BE GRADE C35/45 WITH A WATER CEMENT RATIO 0.4. MIN. CEMENT CONTENT 380kg/m³. AGGREGATE MAX. SIZE 20mm. ALL IN ACCORDANCE WITH BS8500 (BS EN206).
2. REINFORCEMENT TO BE GRADE B500B OR B500C CONFORMING TO BS4449.
3. BAR SCHEDULE AND BENDING TO CONFORM TO BS8666.
4. COVER TO BE 55mm MIN. PROPRIETARY SPACERS TO BE UTILISED.
5. REINFORCEMENT MAY BE REPOSITIONED SLIGHTLY TO CLEAR DUCTS WHEN NECESSARY.
6. BARS INTERSECTING HOLES SHOULD BE CUT ON SITE AND HOLES TRIMMED. SEE CN 13916
7. THIS DRAWING RELATES TO THE GREATEST DEPTH JRCX11D FOR VARIATIONS IN BAR QUANTITIES FOR REDUCED DEPTH CHAMBERS SEE BAR SCHEDULE SHEET.

BAR NOTATION


BAR NOTATION		7	B	12	04	150
No. OF BARS	_____					
TYPE OF STEEL	_____					
DIA OF BARS	_____					
BAR MARK	_____					
SPACING	_____					

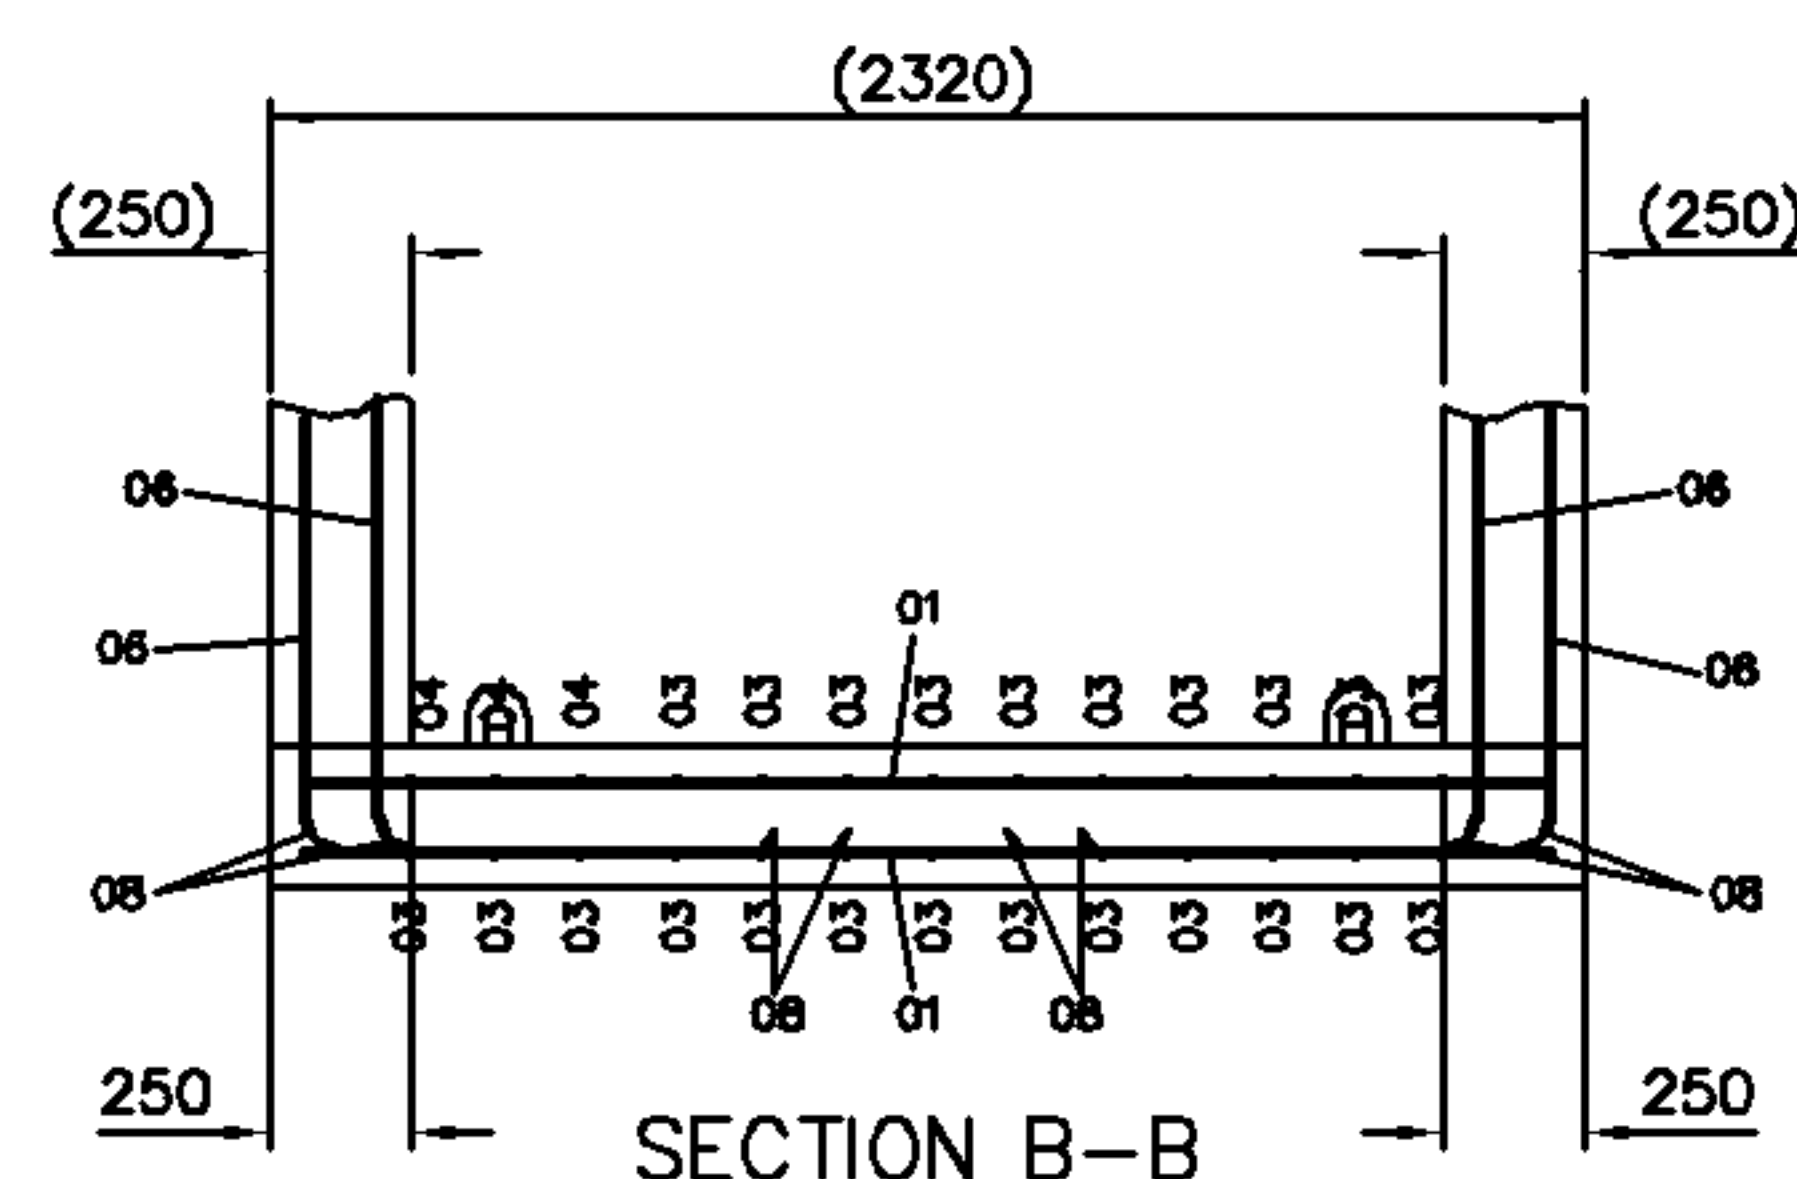


SECTION B-B

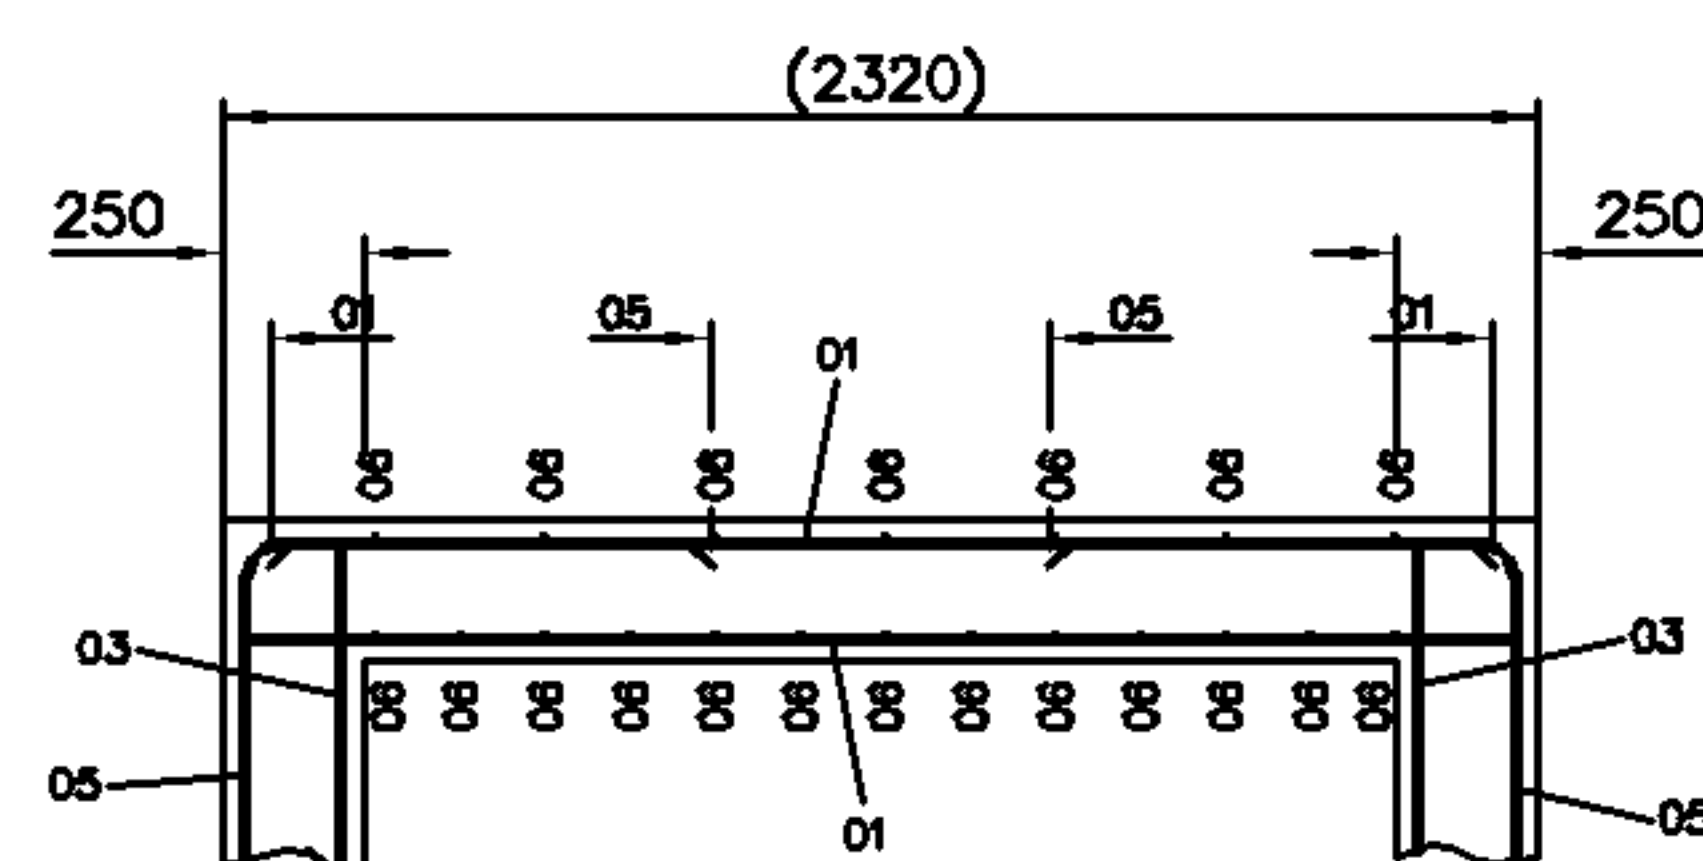


SECTION D-D

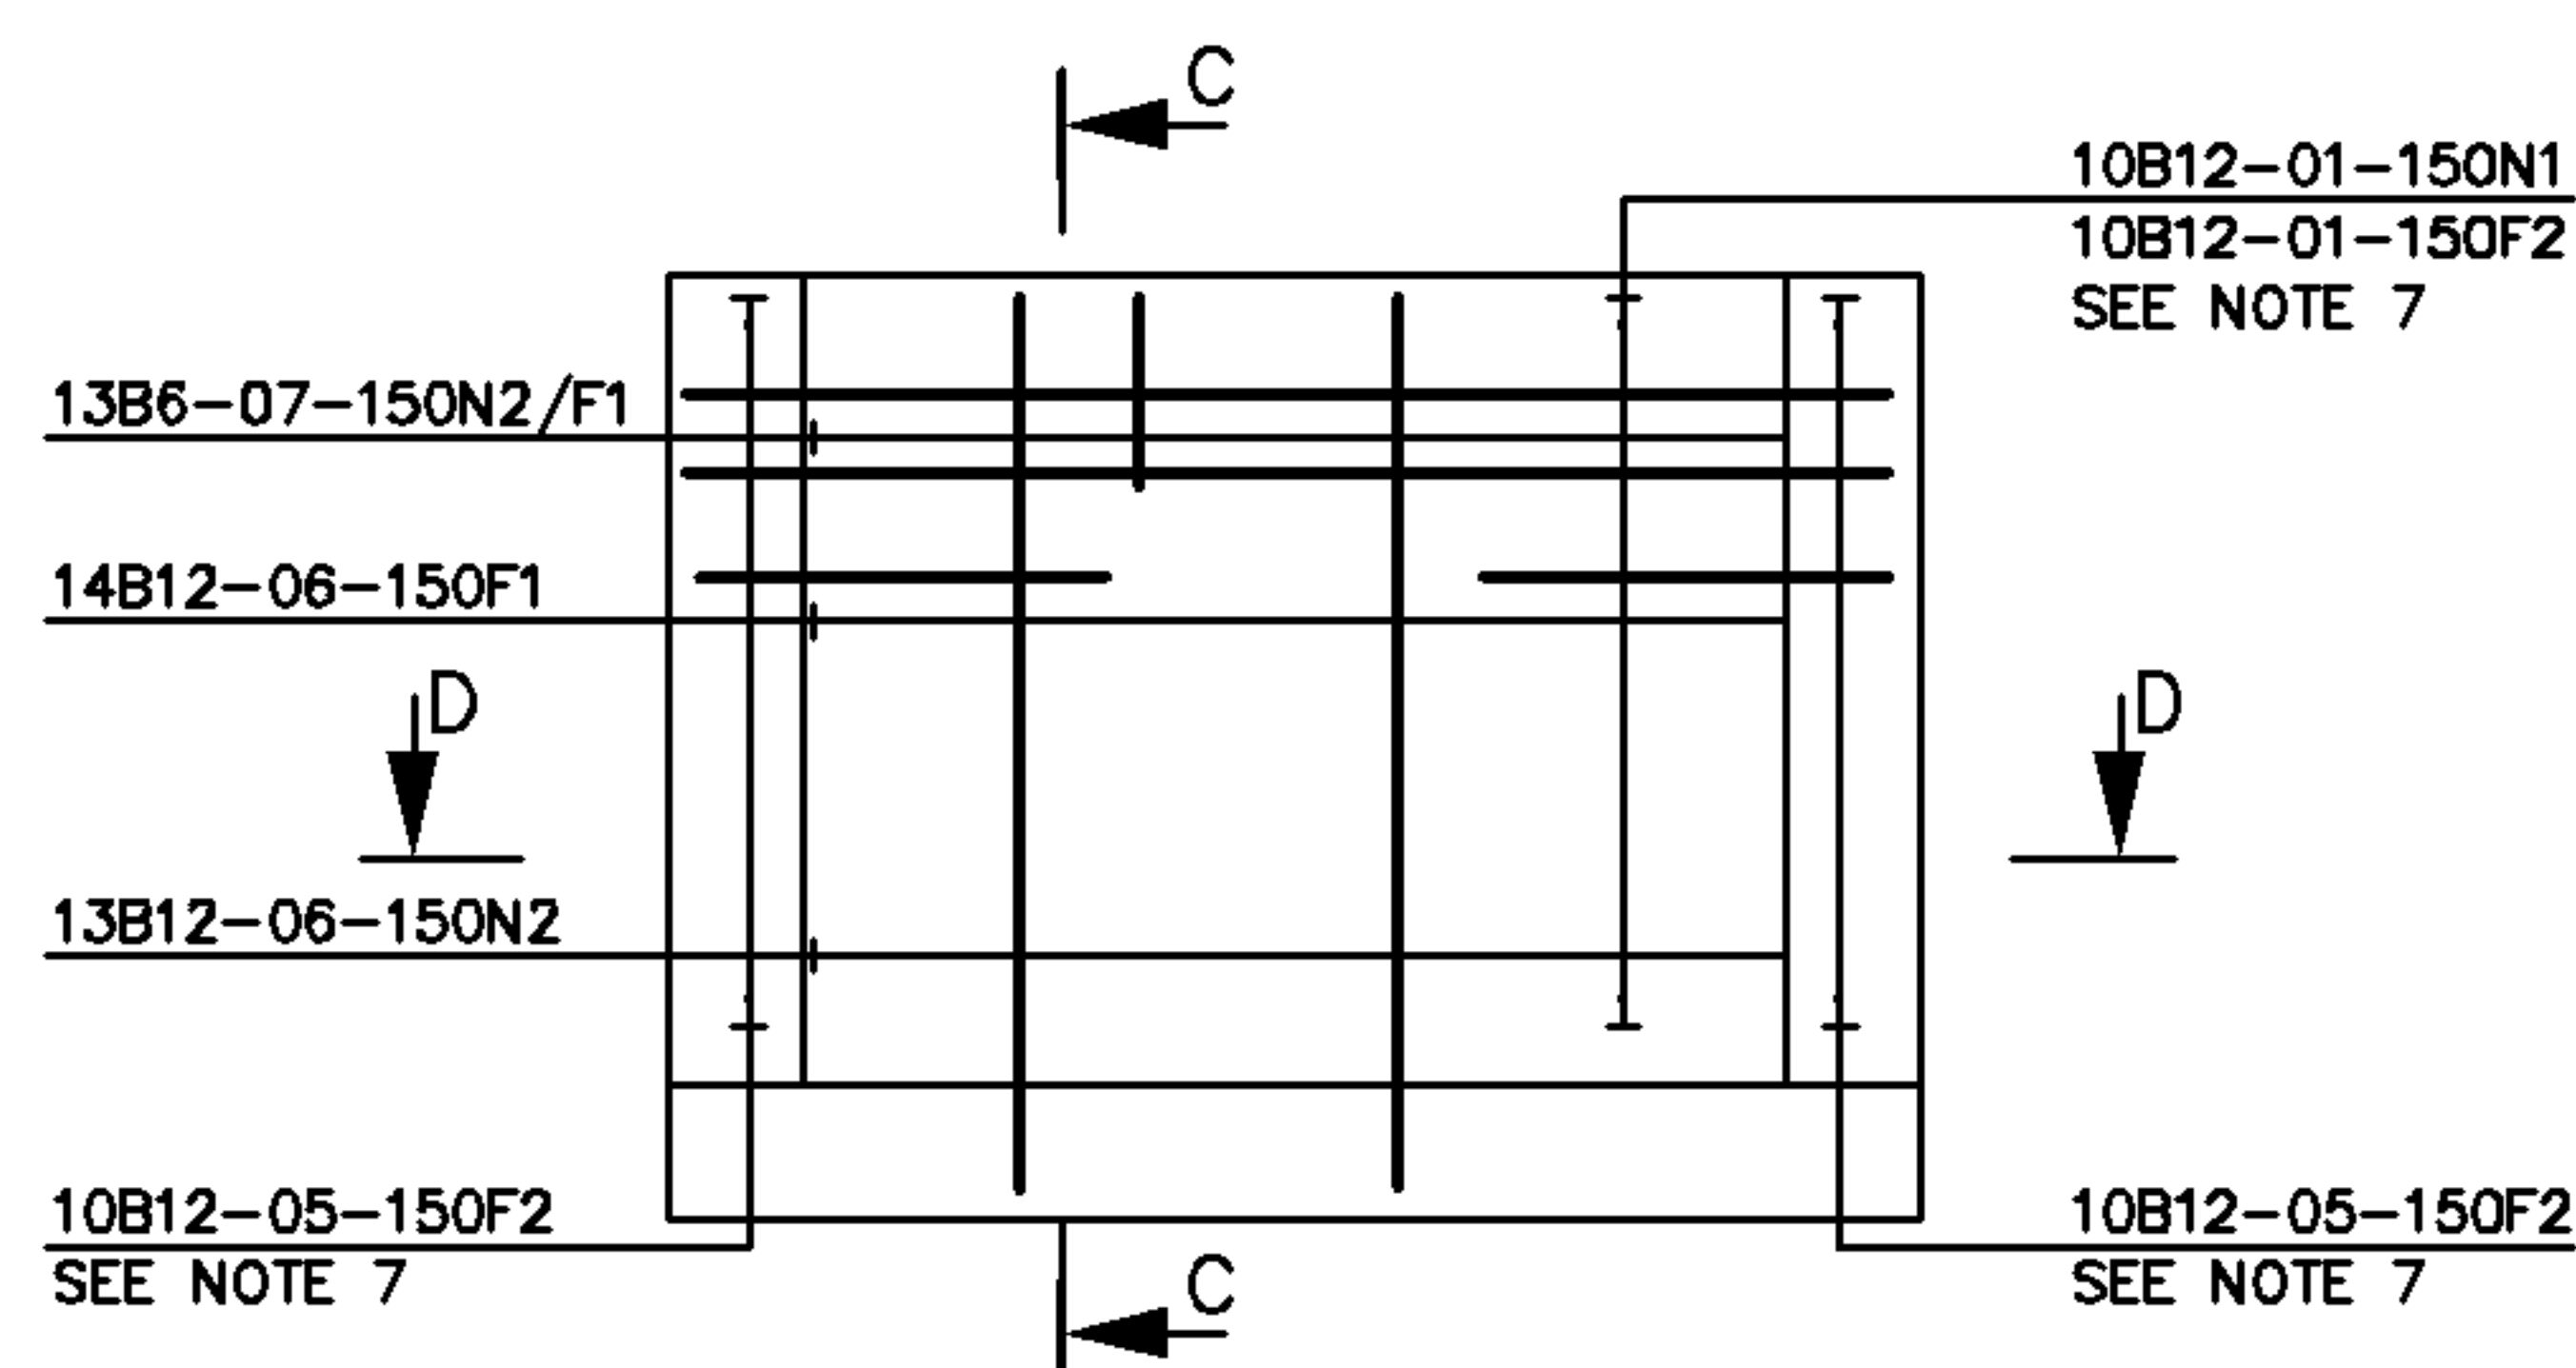FLOOR


SIDE WALL

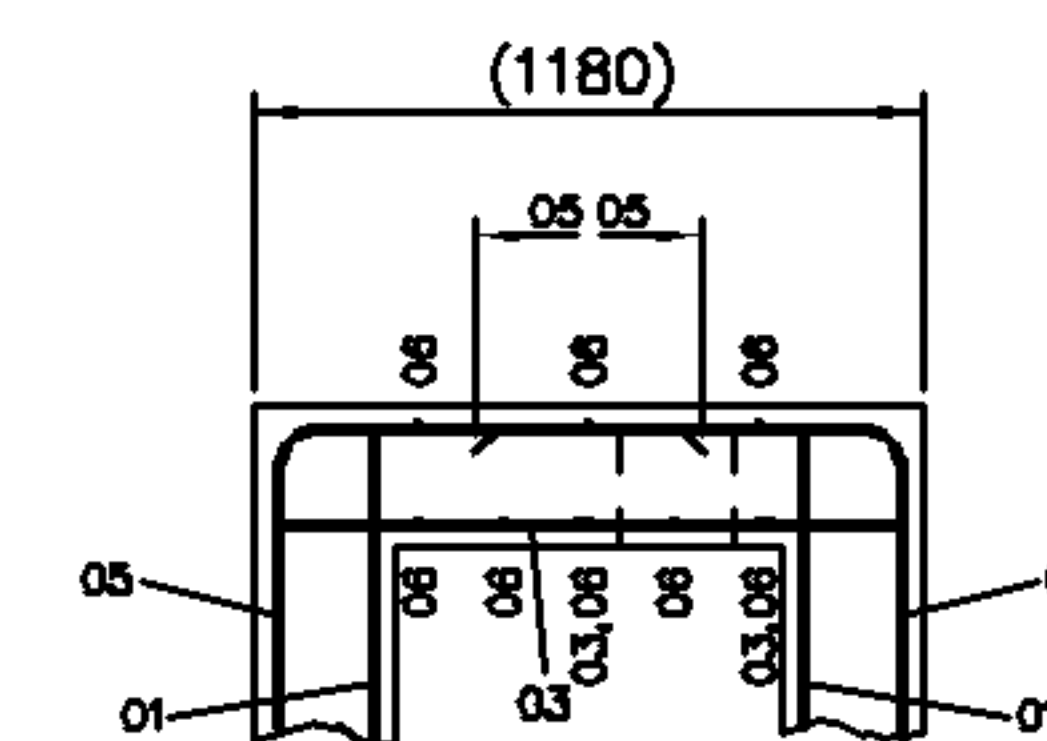


END WALL

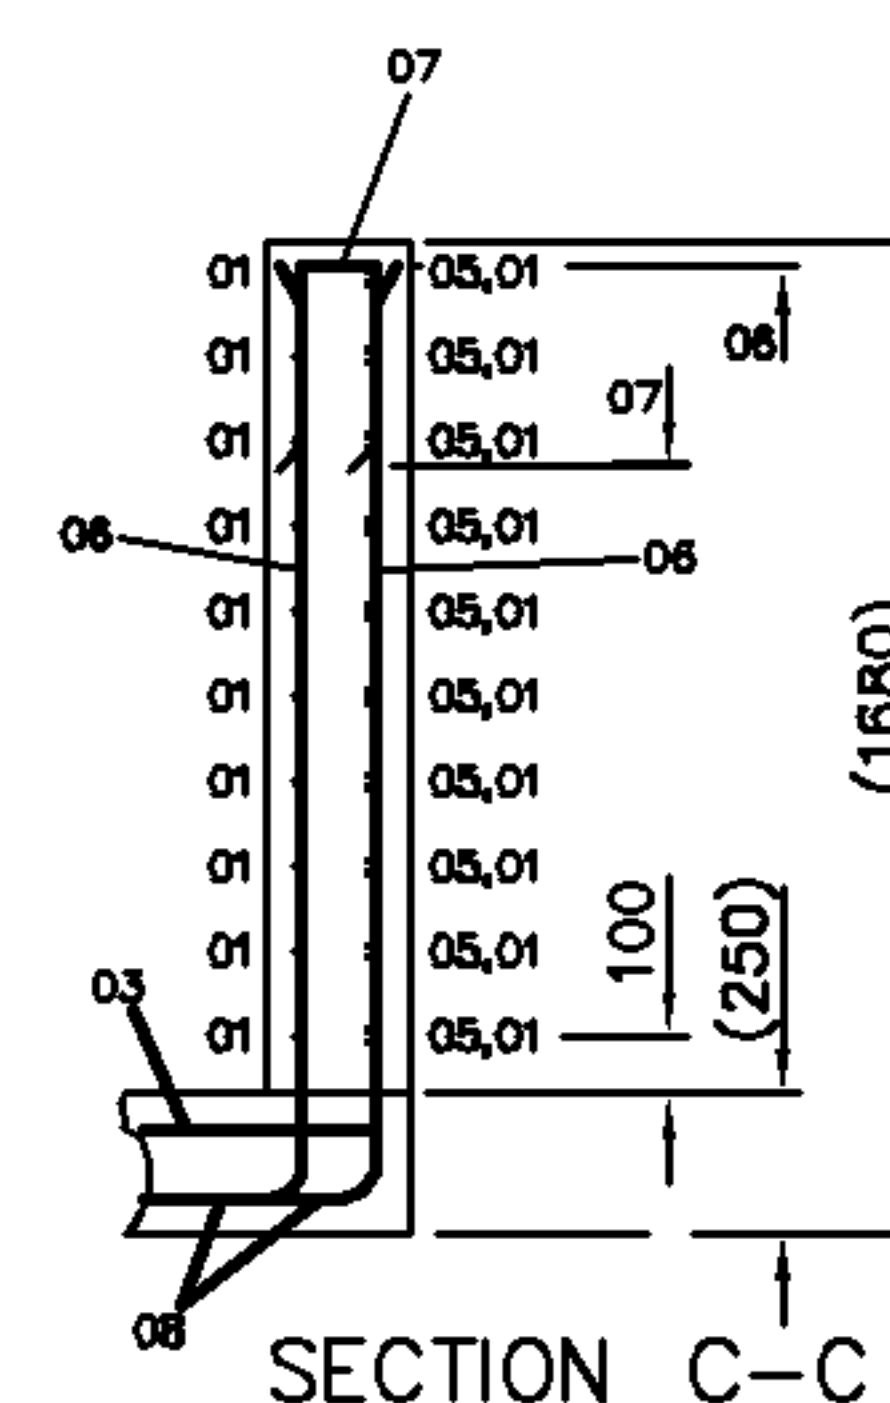

SECTION C-C

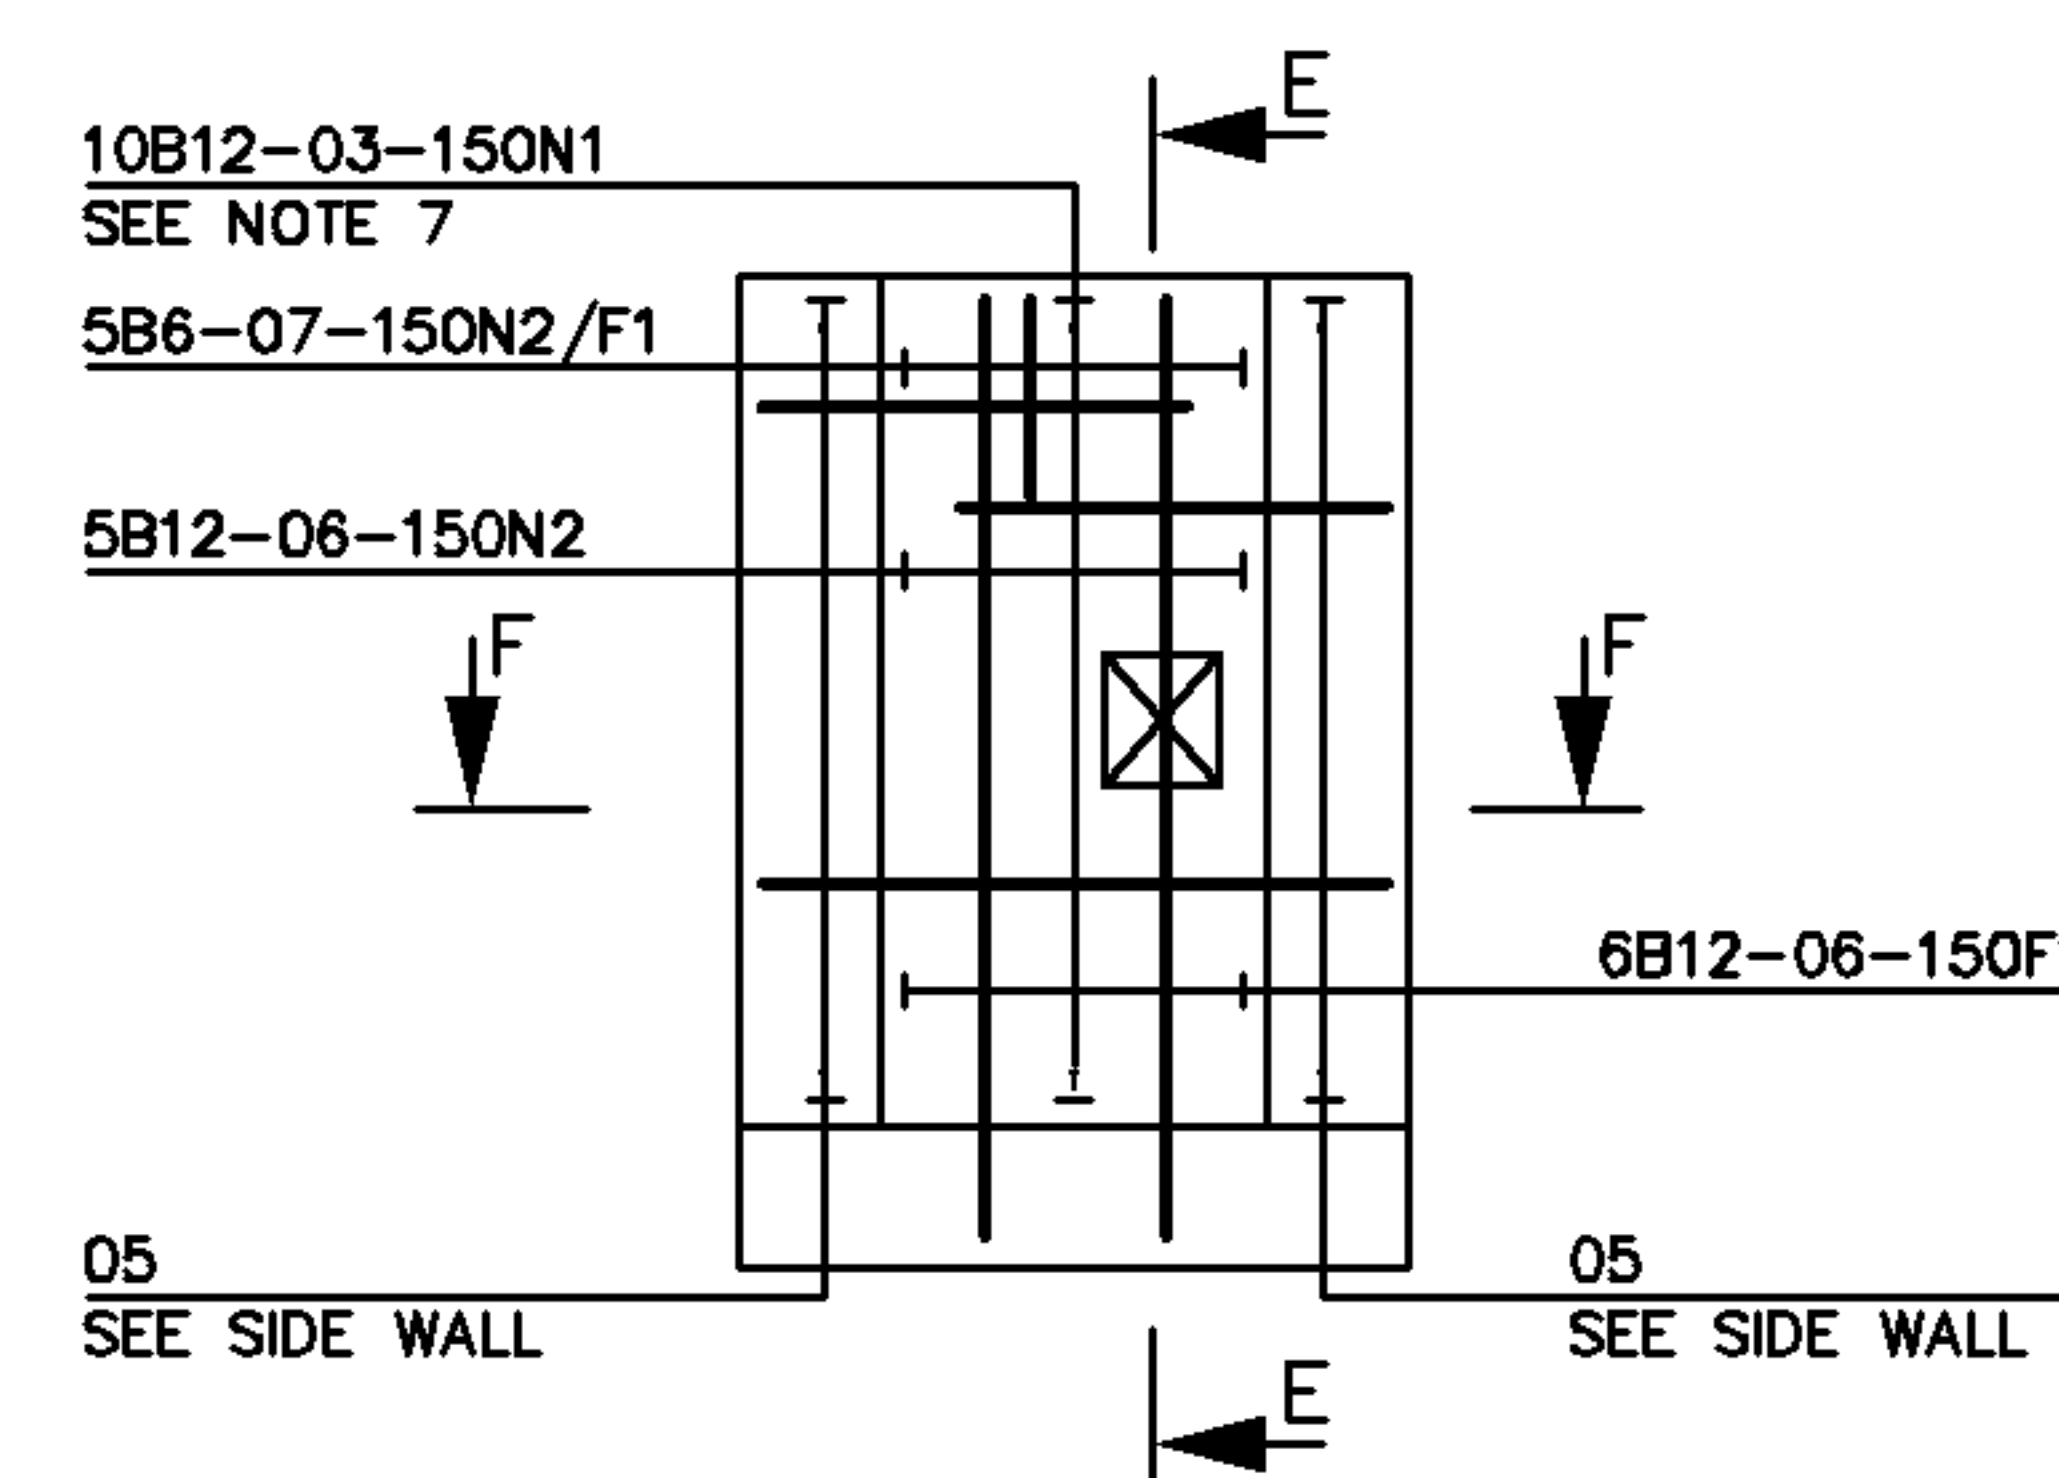

SECTION F-F

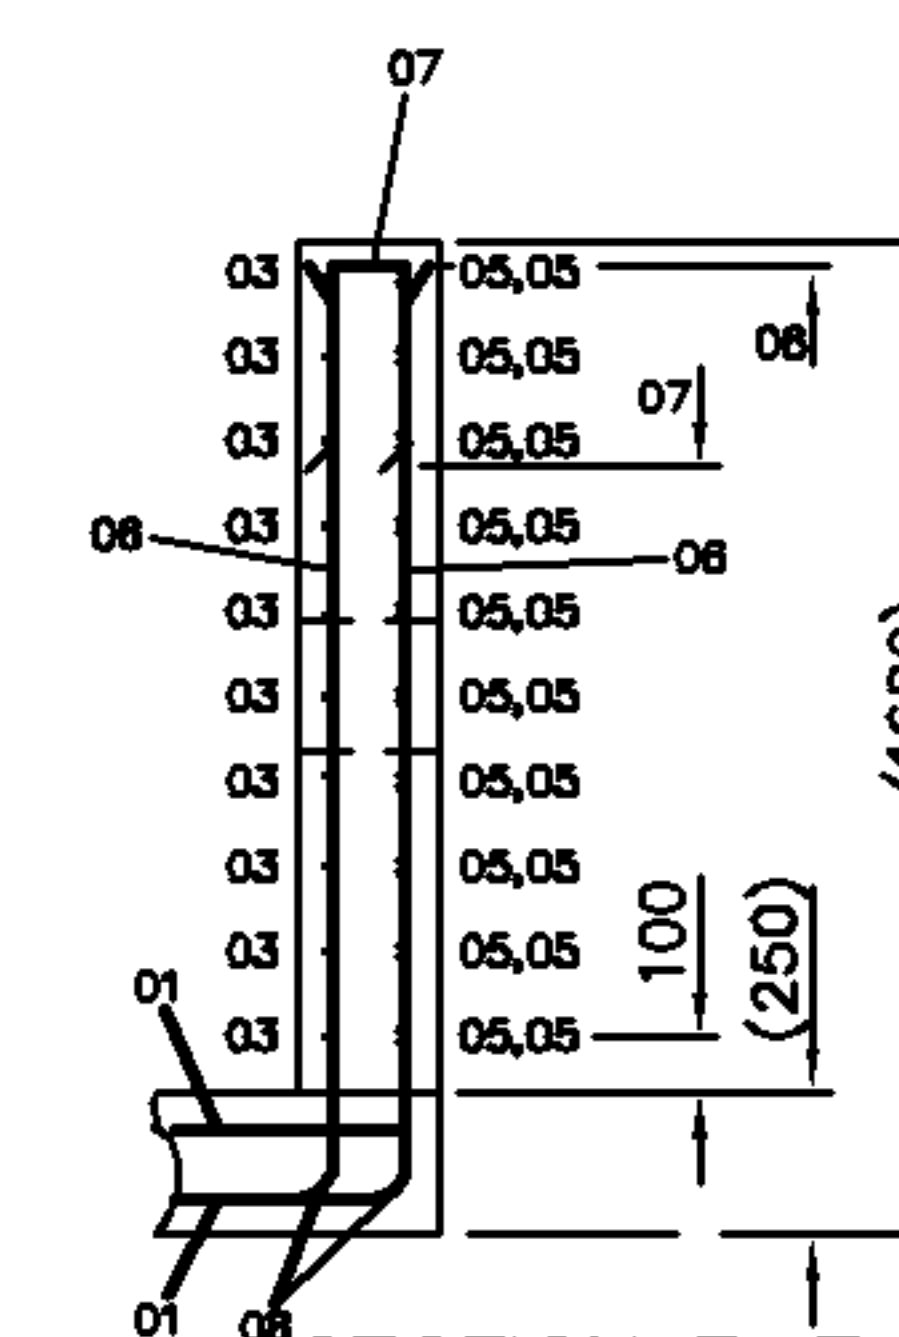

SECTION E-E

DIMENSIONS IN mm UNLESS OTHERWISE STATED

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DO NOT SCALE

ORIGINAL SCALE 1:20

A1 A2	DRN D.FRANCIS CKD M.E.COX	ANY MODIFICATION TO THE DRAWING OR THE USE OF ALTERNATIVE ITEMS TO THOSE SPECIFIED <u>MUST</u> BE AGREED WITH THE DESIGNER.	MATERIAL -	OMS Drawing Review Drawing number amended to 02 of 03	H	TOLERANCES TO BS8666 & BS EN1992 CN15456.	JOINT BOX REINFORCEMENT DETAIL JRCX11A, JRCX11B, JRCX11C AND JRCX11D		REFERENCES SEE NOTES BS4449-REINFORCEMENT SPEC.	
	CERTIFICATION DESIGNER K.G.STANLEY CLIENT N/A		FINISH -							
DATE 06/09/88				BT	OMS	20.08.15				
				AMENDMENT		ISSUE	Openreach	ALA944	CN 14159	SHT 02 OF 03