

<u>NOTES</u>

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DATE 04/07/94


- 1. THIS DRAWING TO BE READ IN CONJUNCTION WITH ALL OTHER DRAWINGS, DOCUMENTATION AND SPECIFICATIONS RELATING TO THIS MANHOLE STRUCTURE TYPE CONSTRUCTION
- 2. REINFORCEMENT TO BE GRADE B500B OR B500C CONFORMING TO BS4449: 2005 (REFER CLAUSE 1712 SHW).
- 3. BAR SCHEDULE AND BENDING TO CONFORM TO BS8666.
- 4. MINIMUM COVER 55mm TO ANY CONCRETE FACE PROPRIETARY APPROVED SPACERS TO BE UTILISED.


ANY MODIFICATION TO THE DRAWING

OR THE USE OF ALTERNATIVE

BE AGREED WITH THE DESIGNER.

- 5. BARS INTERSECTING HOLES TO BE CUT ON SITE AND TRIMMED TO CN13916
- 6. ADDITIONAL BARS MAY BE UTILISED TO TIE / SUPPORT MAIN BARS AS REQUIRED.
- 7. MAX BAR SPACING TO BE 150mm.

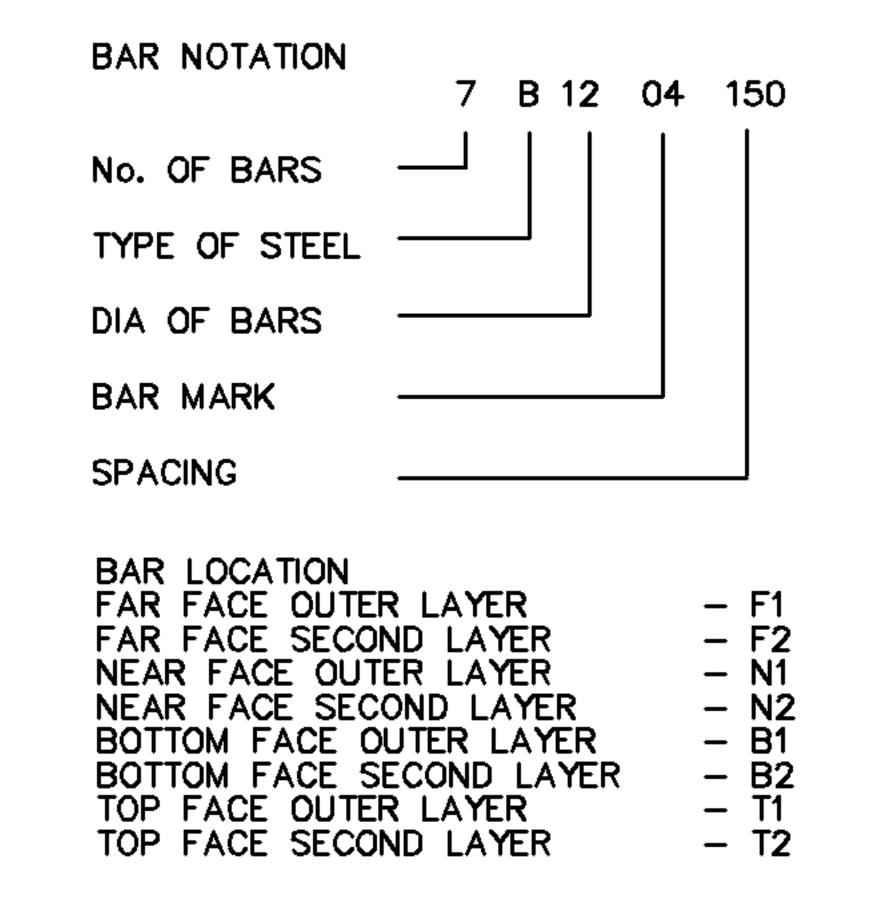

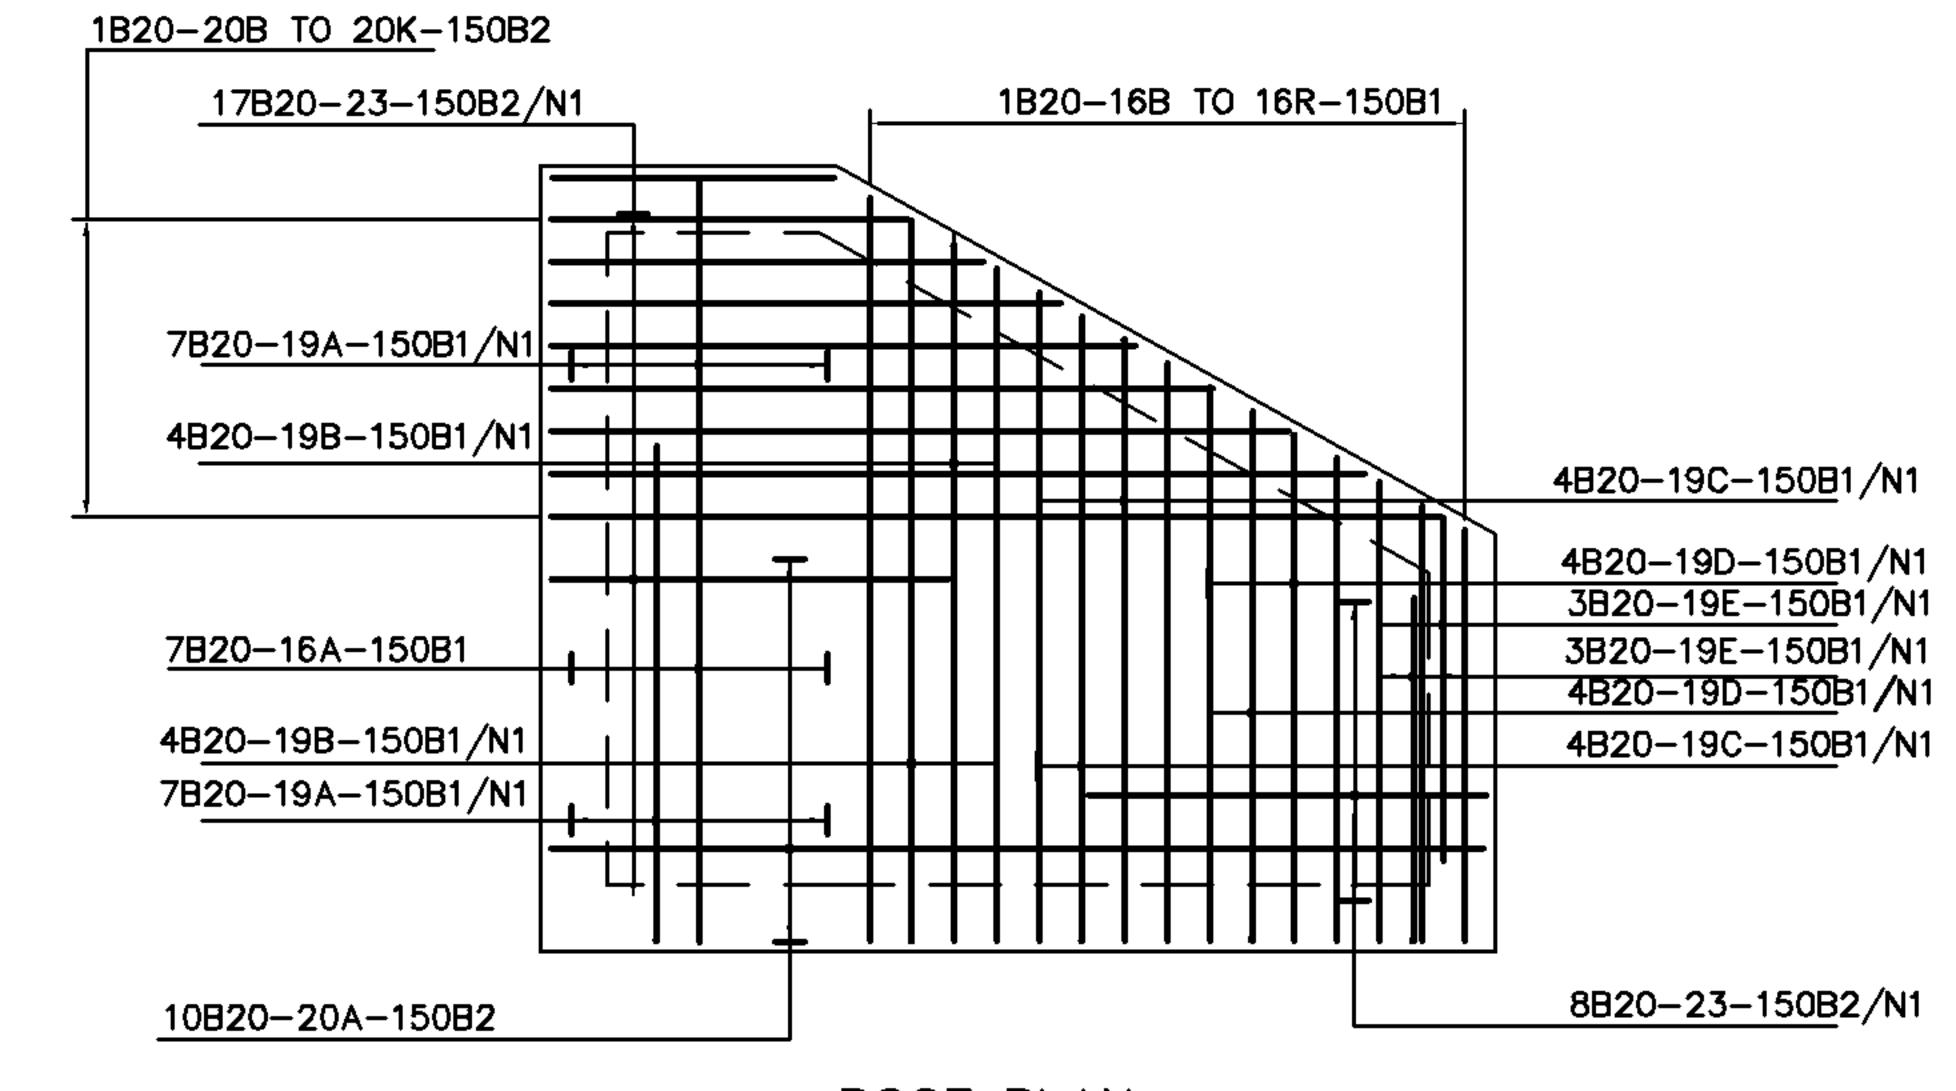

ROOF PLAN LOWER LAYERS

© British Telecommunications plc 1994 DIMENSIONS IN mm UNLESS OTHERWISE STATED DO NOT SCALE ORIGINAL SCALE 1:20 MATERIAL OMS Drawing Review TOLERANCES TO SPECS REFERENCES STANDARD BS8666, BS5606, BS EN1992 CN15456. SPECS: BS8666, Drawing number amended to 04 of 08 MANHOLE MRX510A,510B,510C BS EN1992 DRGS: CN15456. ROOF REINFORCEMENT **FINISH** VARIOUS LOCATIONS 23.08.15 SHT 04 OF 08 CN 14940 ALA944 ISSUE Openreach **AMENDMENT**