Approved Building Consent Documents


Please Note: A copy of the stamped approved documents must be available on site for all inspections.

Inspection booking timeframes

·										
Call received	before 3pm inspection	after 3pm inspection								
	will be done	will be done								
Monday	Wednesday	Thursday								
Tuesday	Thursday	Friday								
Wednesday	Friday	Monday								
Thursday	Monday	Tuesday								
Friday	Tuesday	Wednesday								

Building inspections and enquiries phone: 03 347 2839

Please ensure all work for inspection is ready the day before. Incomplete work requiring re-inspection will incur an additional inspection fee.

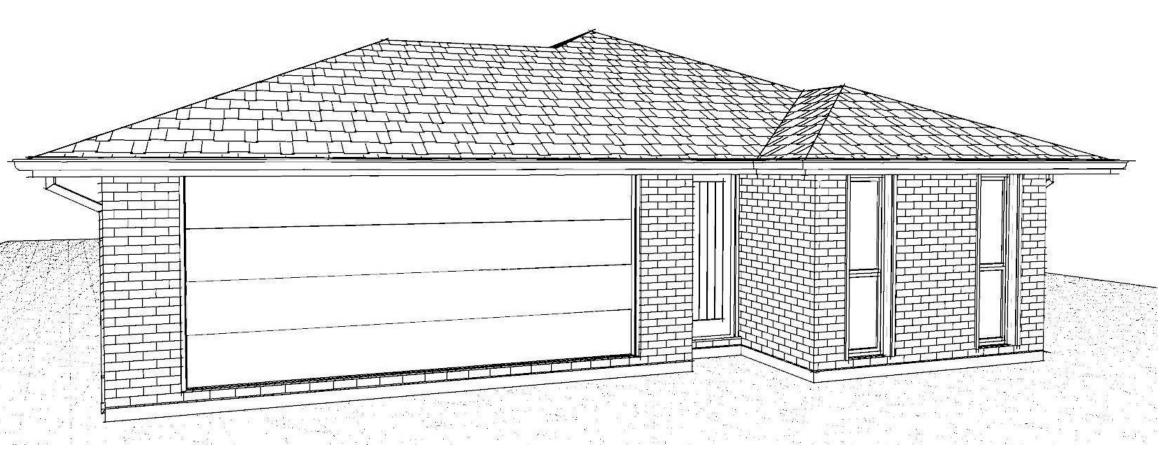

Contents: Sheet 1: **Cover Sheet** Sheet 2: Site Plan Sheet 3: Floor Plan Sheet 4: Elevations Sheet 5: **Elevations** Sheet 6: **Cross Sections** Sheet 7: Roof Plan Sheet 8: Set Out Dimensions Sheet 9: Foundation Plan Sheet 10: RibRaft Plan Drainage Plan Sheet 11: Bracing Plan Sheet 12: Lighting Plan Sheet 13: Sheet 14: Framing Details Sheet 15: Framing Details Sheet 16: **Construction Details** Sheet 17: **Construction Details** Sheet 18: **Construction Details** Sheet 19: **Construction Details** Plumbing Details Sheet 20: Sheet 21: **Bathroom Details** Sheet 22: Truss Design Sheet 23: Truss Design

Planning Approved

2/08/2023 andre.salvador

All dimensions are to be check and confirmed prior to any construction

Plans are to be read in conjunction with Specifications and all supporting documentation



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Verify all dimensions, sizes and levels on site prior to commencing any work. Any discrepancies are to be confirmed with Signature Homes Ltd.

Refer to attached Specifications for further

All work is to comply with the NZBC
Acceptable Solutions, NZS 3604:2011 and Authority bylaws.

SITE INFORMATION

Site Area:

872m²

Floor Area (veneer): 141.76m² / 16.26% Roof Area: 168.91m² / 19.37%


Wind Earthquake

Exposure N4 at 200m (up to 1.5kPa) Snow

Note: The dimensions shown are from cladding to boundary. Refer to sheet 8 for foundation to boundary dimensions.

Sediment control and site safety requirements are noted in the attached Specifications.

Provide safety fencing to perimeter of site, permanent or temporary, to comply with

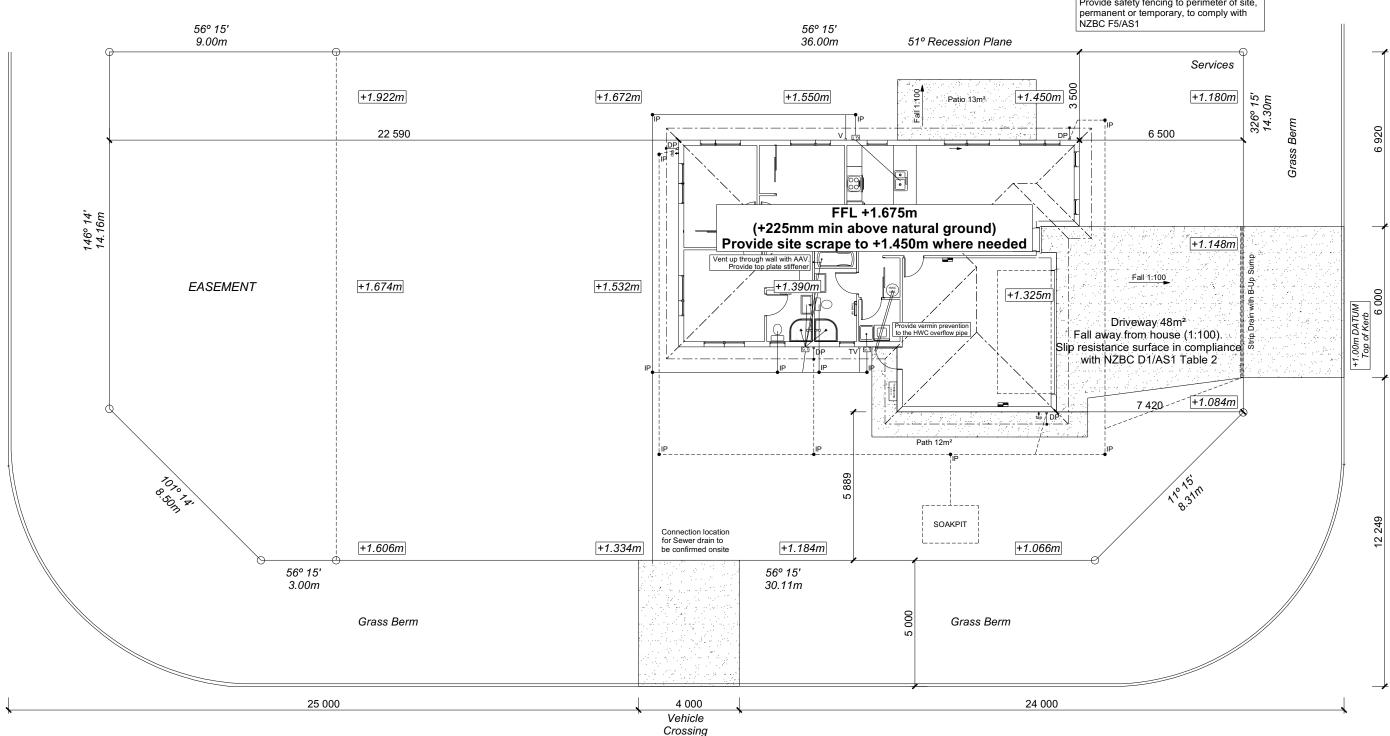

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COONEY AVENUE



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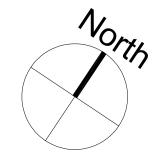
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Job Numb	Number: Original Plan: Sheet Name:		CONSENT PLANS			Sheet No.:				
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15 670



ROOF & WALL CLADDINGS

Roof: 25° Pressed Metal Tiles Walls: 70 Series Brick Veneer with a 50mm cavity

DWELLING AREAS

Framing Area: 135.27m² (Perimeter: 53.60m) Veneer Area: 141.76m² (Perimeter: 54.56m) Roof Area: 168.91m² (Perimeter: 57.22m)

SMOKE ALARMS (hush type) Domestic Smoke Alarms to be fitted within 3.0m of sleeping areas and on Escape routes as indicated on plan. To comply with one of the following standards: UL 217, ULC-S531, AS 3786, BS 5446 (part 1).

FLOOR PLAN NOTES

Dimensions shown are to the frame, GIB thickness not shown. Mechanical ventilation to comply with G4/AS1 Air Seals to have PEF rod & low expansion foam

All windows and doors centered in room unless shown otherwise Laundering facilities provided complying with G2/SA1 1.0

Provide sealant under skirting and paint

to concrete around tub & W/M fixtures



WALL FRAMING Stud Height: 2400 mm (2455mm to u/s of bottom chord)

KITCHEN HOB

Electric Hobs

Internal Height: 1980mm (leaves) Leaf widths as shown on the plan (R/O +80mm) Type: Hollow core flush panel Front Door Type: Latitude Aluminium

WINDOW JOINERY Low-E/4 with Argon Gas Double Glazed Thermally Broken Aluminium Joinery Standard single glazing to Garage

INTERNAL TRIMS Scotia: 55mm GIB Coving (excluding garage) Skirting: 60x12mm Pine, single bevel edge Architrave: N/A

SHELVING Shelf & Rails to all wardrobes 4 shelves to Linen cupboard

DRAWING NOTES

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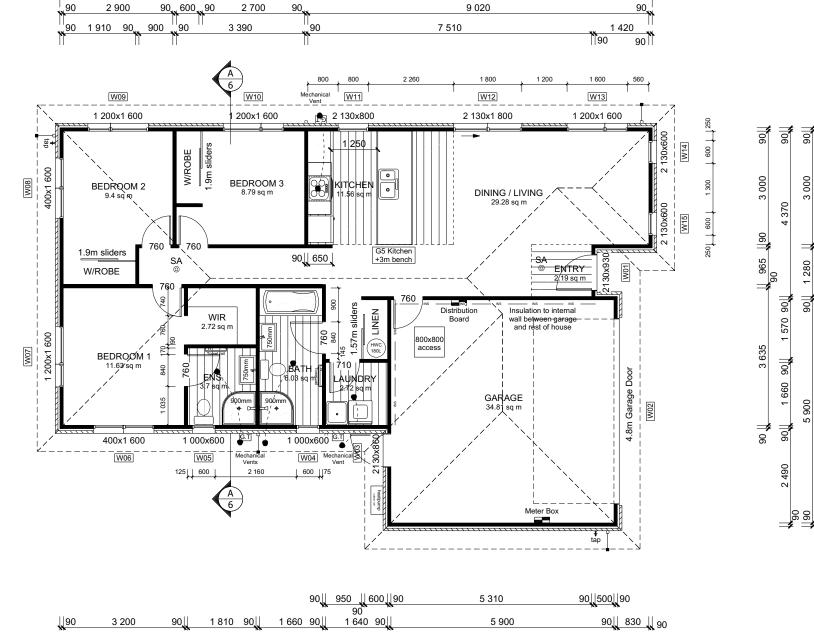
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Refer to attached Specifications for further

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CONSENT PLANS Original Plan: 172870 **FLOOR PLAN** Rifleman

1 910



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Vester Villalon Lot 8, DP 580863 1 Bob Reid Crescent Darfield

Print Date

Date: Reason:
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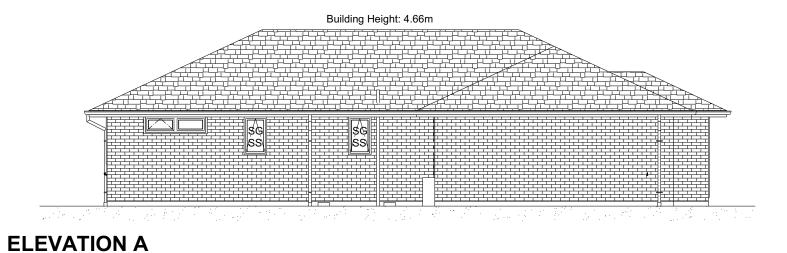
3 of 23 sheets

Sheet No.:

BC231153

Building

BUILDING ENVELOPE RISK MATRIX **ELEVATION B** RISK CRITERIA RISK SCORE Wind Zone lumber of Stories Low Roof Wall Junction Eaves Width Medium Building Envelope Low Decks & Balconies





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Vester Villalon Lot 8, DP 580863 1 Bob Reid Crescent Darfield

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CONSENT PLANS Date: Reason: 12-07-2023 Initial Consent Plans

Sheet No.: of 23 sheets

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ROOF & WALL CLADDINGS Roof: 25° Pressed Metal Tiles Walls: 70 Series Brick Veneer with a 50mm cavity

ELEVATION LEGEND

Safety Stays Safety Glass TV Terminal Vent

ELEVATION NOTES


Coloured Steel Quad Gutter Coloured Steel185 Fascia Downpipe :Colorsteel Rectangular 75x55mm Soffits : Hardiflex 4.5mm


Joinery: Low-E/4 Double Glazed

Thermally Broken Aluminium Joinery Standard single glazing to Garage

All egress points to have a maximum step down of 190mm. Access routs to have slip resistance surface in compliance with NZBC D1/AS1 Table 2 and to have a 1:100 fall away from the building SCORE

Building

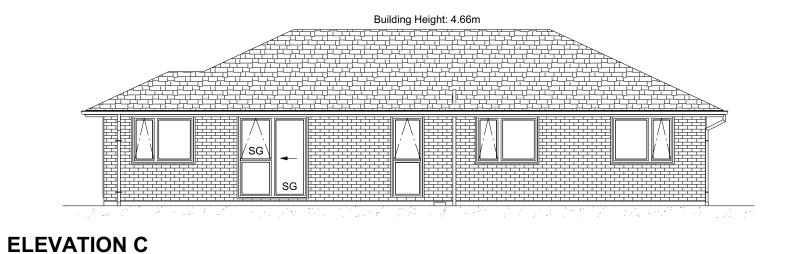

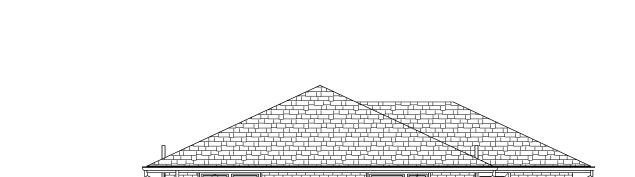

ELEVATION D

All dimensions are to be check and confirmed prior to any construction

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Vester Villalon Lot 8, DP 580863 1 Bob Reid Crescent Darfield

172870

Original Plan: Rifleman Print Date:

ELEVATIONS

1:100

CONSENT PLANS Date: Reason:
12-07-2023 Initial Consent Plans

ROOF & WALL CLADDINGS Roof: 25° Pressed Metal Tiles Walls: 70 Series Brick Veneer with a 50mm cavity

> Safety Stays Safety Glass

Terminal Vent

Coloured Steel Quad Gutter

Thermally Broken Aluminium Joinery

Standard single glazing to Garage

Coloured Steel185 Fascia Downpipe :Colorsteel Rectangular 75x55mm Soffits : Hardiflex 4.5mm Joinery: Low-E/4 Double Glazed

All egress points to have a maximum step down of 190mm. Access routs to have slip resistance surface

in compliance with NZBC D1/AS1 Table 2

and to have a 1:100 fall away from the building


ELEVATION LEGEND

ELEVATION NOTES

TV

Sheet No.: 5 of 23 sheets

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CROSS SECTION A-A

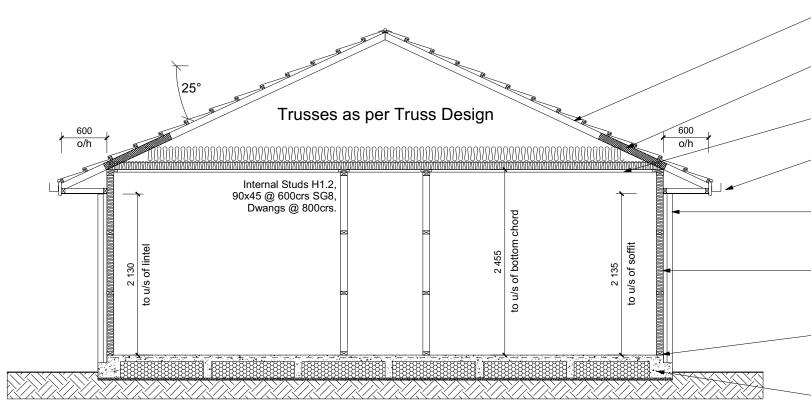50x40 SG8 H1.2 @ 370crs, fixings 2/90 x 3.15 gun nail

Insulation guards to eave perimeter to

Pressed metal tile roofing on self supporting ThermaKraft 215 roof underlay and tile battens

maintain 25mm ventilation requirement.

13mm Std. GIB ceiling lining (Aqualine to wet areas) to underside of 70x35mm H1.2 ceiling battens @ 600mm crs with 1x layer of R3.2 & 1x layer of R3.6 Pink Batts insulation.

Coloured steel fascia & gutter system with 4.5mm Hardies soffit lining.

70 Series brick veneer with a 50mm cavity.

Masons Barricade building wrap on stud framing with R2.6 Pink Batts insulation & 10mm Std. GIB wall lining (Aqualine to wet areas).

Studs H1.2, 90x45 @ 600crs SG8, Dwangs @ 800crs (exterior & interior loadbearing walls)

125mm x 12mm thru bolt with 50mm square washer at 900mm crs on all external walls and interior load bearing walls (Bolts also 150mm for each end of bottom plate) minimum cover 40mm. DPC between bottom plate & floor slab.

Firth RibRaft foundation design in accordance with the Firth RibRaft Technical manual attached.

DRAWING NOTES

ROOF & WALL CLADDINGS

Roof: 25° Pressed Metal Tiles

Walls: 70 Series Brick Veneer
with a 50mm cavity

CROSS SECTION NOTES

Low-E/4 Double Glazed

of E2/AS1.

INSULATION

3604:2011 & table 20 of E2/AS1.

Building wrap is to comply with E2/AS1 & NZS 3604:2011.
Flashing materials must be selected based on environmental exposure. Refer to NZS

Flashing tape must have proven compatibility with the selected wrap & other materials with which it comes into contract as per table 21

Fixings shall comply with NZS 3604:2011 Section 4 Durability Tables 4.1-4.3 Unless stated otherwise, timber members on drawings are to be a minimum of SG8 strength graded as per NZS3604:2011.

Thermally Broken Aluminium Joinery Standard single glazing to Garage

Ceiling: Pink Batts R3.2 + R3.6 Ceiling Batts Wall: Pink Batts R 2.6 Wall Batts

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Sheet No.:

6

of 23 sheets

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Vester Villalon Lot 8, DP 580863 1 Bob Reid Crescent Darfield


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ROOF CLADDING

Roofing: 25° Pressed Metal Tiles Tile Battens: 50x40 SG8 H1.2 @ 370crs,

fixings 2/90 x 3.15 gun nail

ROOF PLAN NOTES

Gutter: Coloured Steel Quad Gutter Fascia: Coloured Steel 185 Fascia Downpipes: Colorsteel Rectangular 75x55mm Soffits: Hardiflex 4.5mm

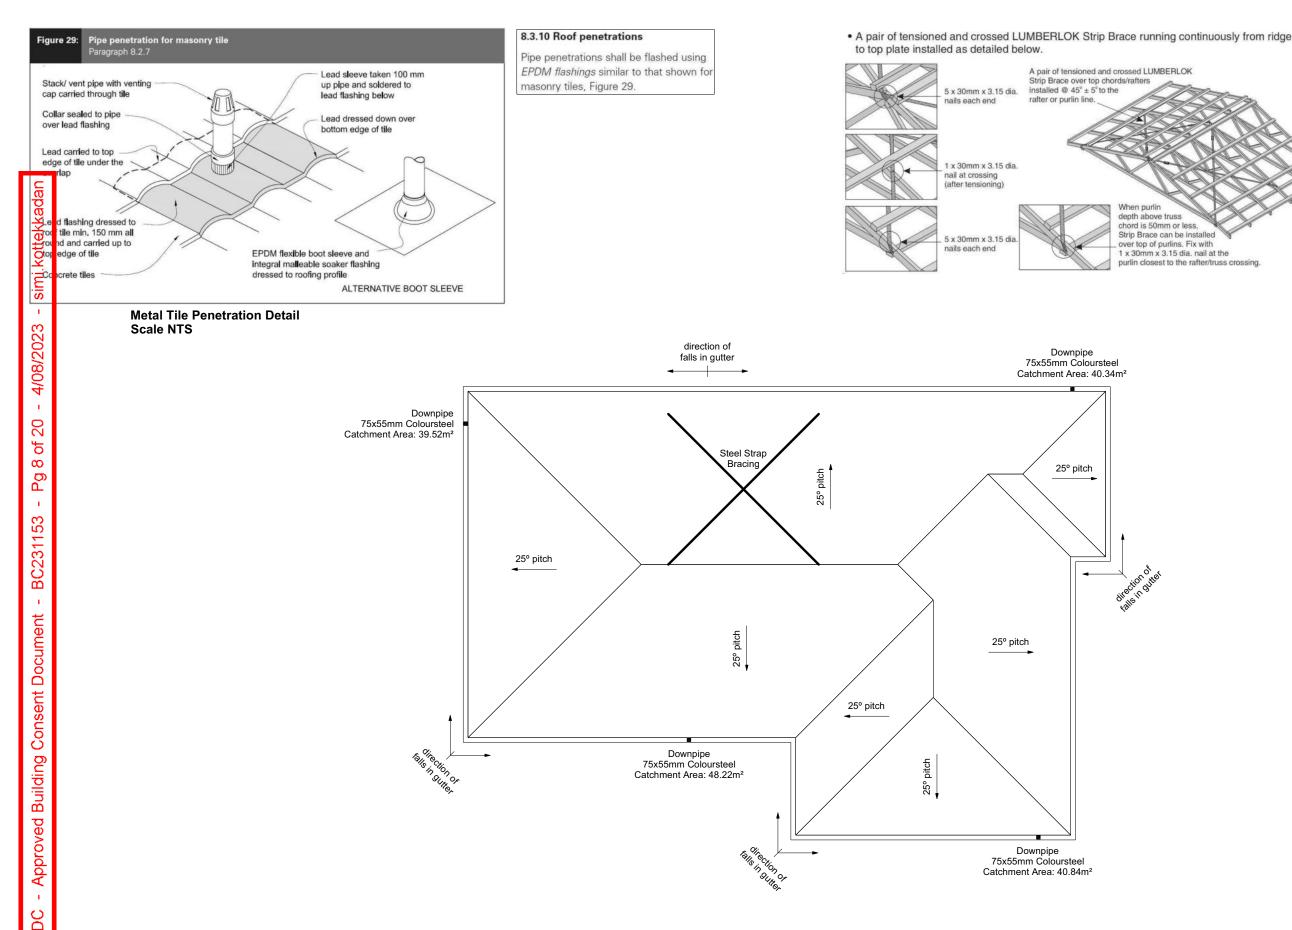Underlay: Thermakraft 215 roof underlay

Downpipes: 75x55 Rectangle Colorsteel As per NZBC E1/AS1 Table 5 75x55 down pipes can collect up to 60m² of 0-25° roof plan area.

Use Coloured steel Quad Gutter As per NZ Metal Roof and Wall Cladding Code of Practice Version 2 section 8 the above gutter with a cross sectional area of 5550mm² can collect up to 60m² of 0-25° roof plan area. Refer to the specifications for exact calculations.

Use Lumberlock top plate fixing chart attached to the main specifications to determine top plate fixings.

Sheet No.:

of 23 sheets

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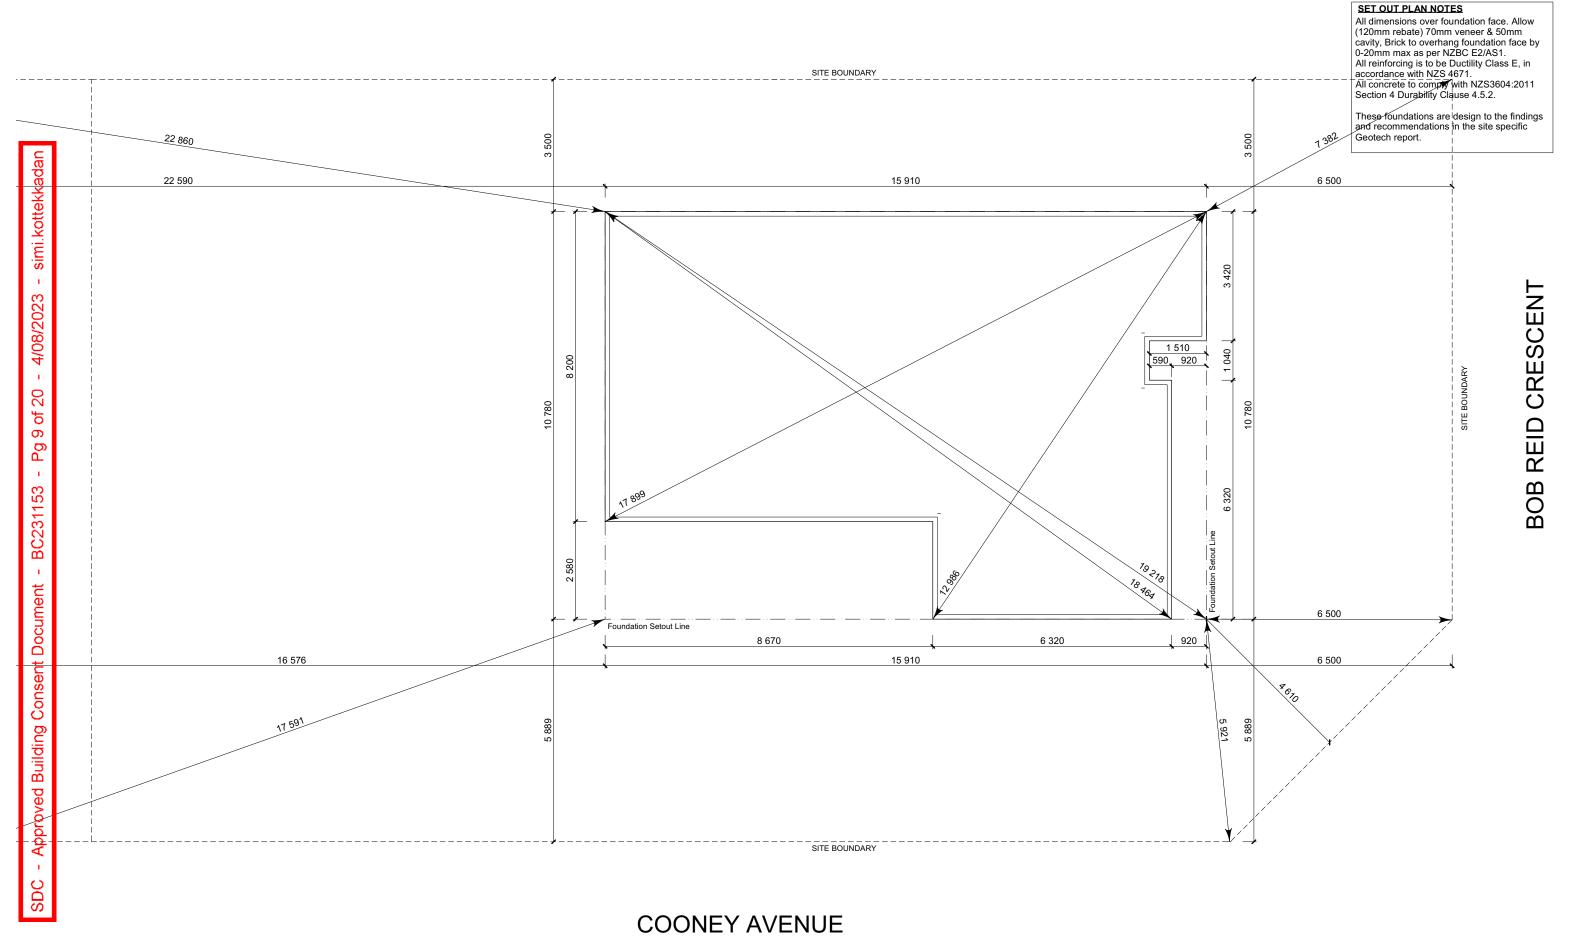


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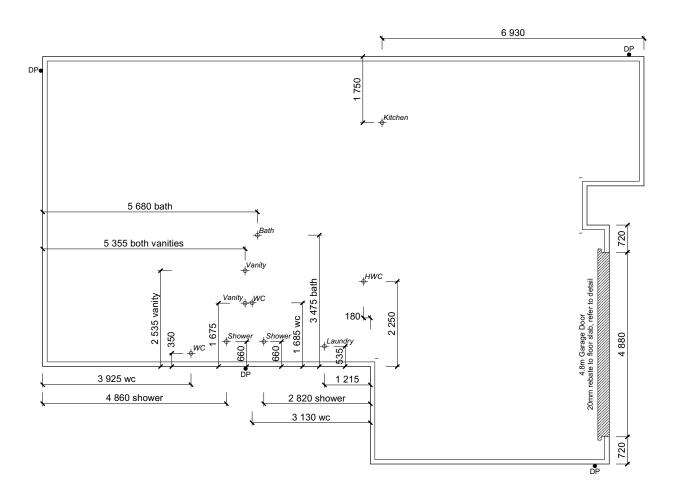
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FFL +1.675m (+225mm min above natural ground) Provide site scrape to +1.450m where needed

United Steel [Wireplus] SE62Plus to entire slab



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Vester Villalon Lot 8, DP 580863 1 Bob Reid Crescent Darfield

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FOUNDATION PLAN NOTES

to confirm offset.

slab thickenings

Foundation Area:

Ratio:

All dimensions over foundation face. Allow (120mm rebate) 70mm veneer & 50mm cavity, Brick to overhang foundation face by 0-20mm max as per NZBC E2/AS1.

W/C location indicated on plan has assumed a 140mm offset from internal frame line, please consult manufacturer's documentation

Contractor to consult manufacturer's documentation to determine the correct location for all wastes positioned through floor

Earth bar to be bonded to the reinforcing mesh Refer to Truss design for exact location of

All reinforcing is to be Ductility Class E, in accordance with NZS 4671.
All concrete to comply with NZS3604:2011 Section 4 Durability Clause 4.5.2.

These foundations are design to the findings and recommendations in the site specific

2.60

AREA TO PERIMETER RATIO


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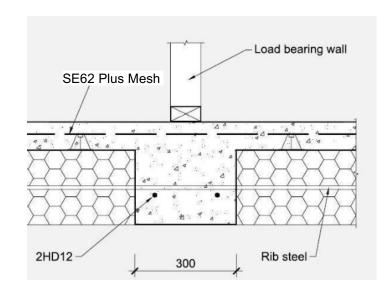
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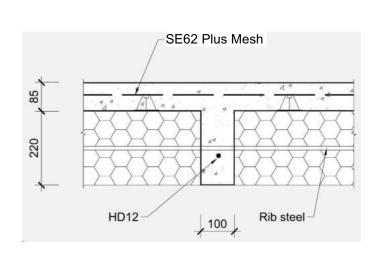
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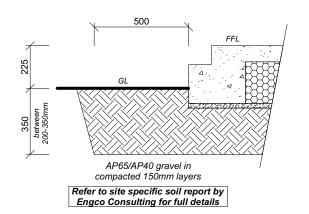
United Steel [Wireplus] SE62Plus to entire slab


TC1 Firth RaftMix Concrete foundation design in accordance with the Firth RibRaft Technical Manual & Codemark attached.







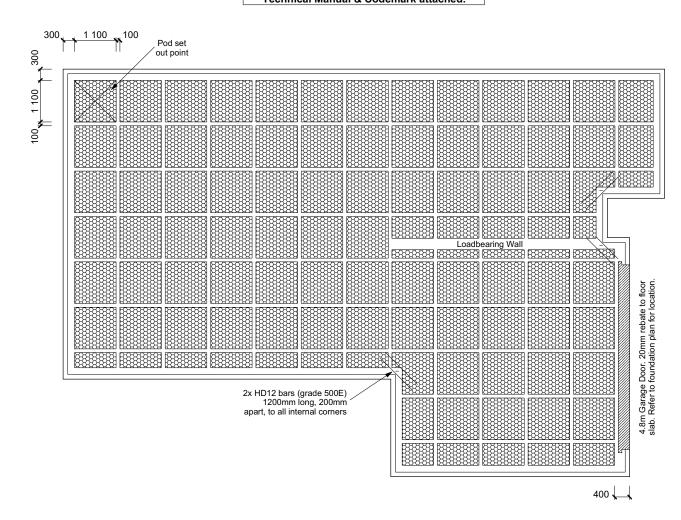

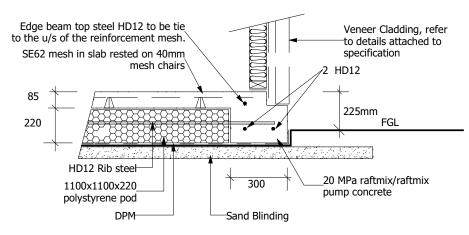

Ribraft Edgebeam Detail (Rebate) Scale 1:20

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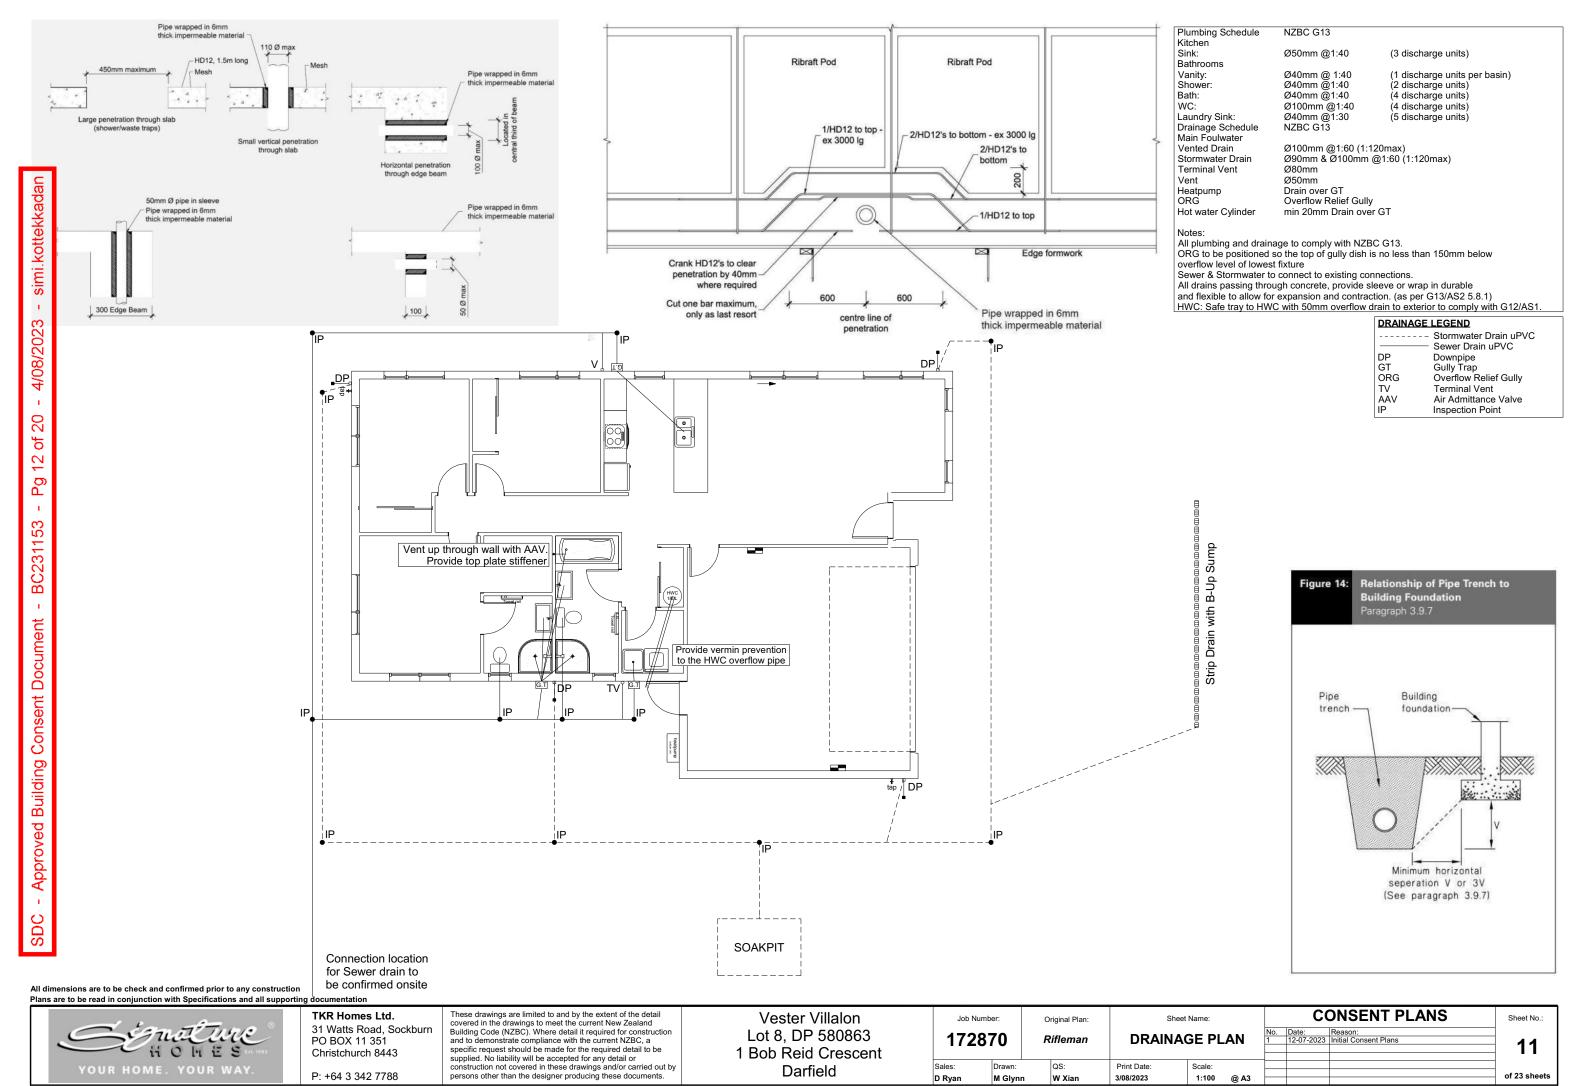
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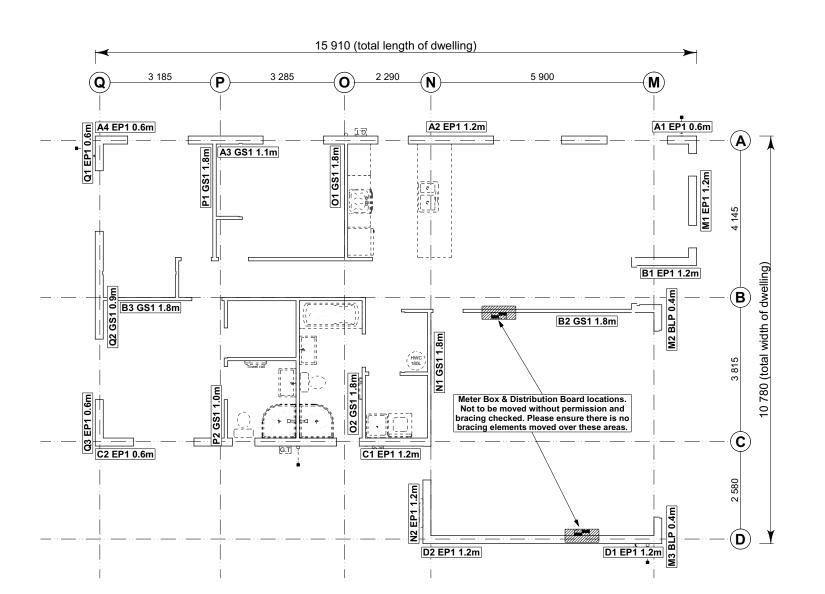


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8.7.3.4


Each wall that contains one or more wall bracing elements shall be connected at the top plate level, either directly, or through a framing member in the line of the wall, to external walls at right angles to it. Top plate fixing(s) of the capacity in tension or compression along the line of the wall bracing element are given as follows:

- For each wall containing wall bracing elements with a total bracing capacity of not more than 125 bracing units: to at least one such external wall by a fixing as shown in figure 8.16 of 6 kN capacity;
- (b) For each wall containing wall bracing elements with a total bracing capacity of not more than 250 bracing units: to at least 2 external walls by fixings as shown in figure 8.16 each of 6 kN capacity;
- For each wall containing wall bracing elements with a total bracing capacity of more than 250 bracing units: to at least 2 external walls by fixings as shown in figure 8.16 each having a rating of not less than 2.4 kN per 100 bracing units.

BRACING PLAN NOTES

Wall bracing designed in accordance with NZS 3604:2011 & GIB Ezybrace system Refer to attached calculations.

Bracing Designed to: Wind: High Earthquake: 2

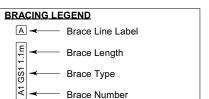

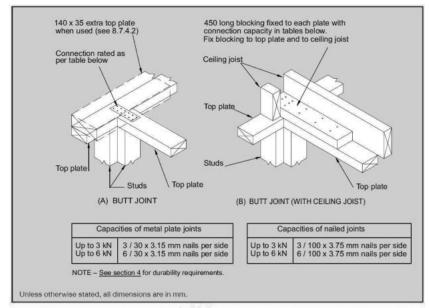


Figure 8.16 - Connecting top plates to external walls at right angles - Walls containing bracing (see 8.7.3.4)

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	1	1.80		2.4	GS1-N	GIB®	124	108		
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									171 OK	179 OK

Single I aval Across Resistance Sheet

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Single Level Along Resistance Sheet


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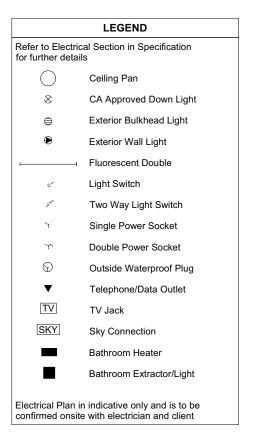
Vester Villalon Lot 8, DP 580863 1 Bob Reid Crescent Darfield

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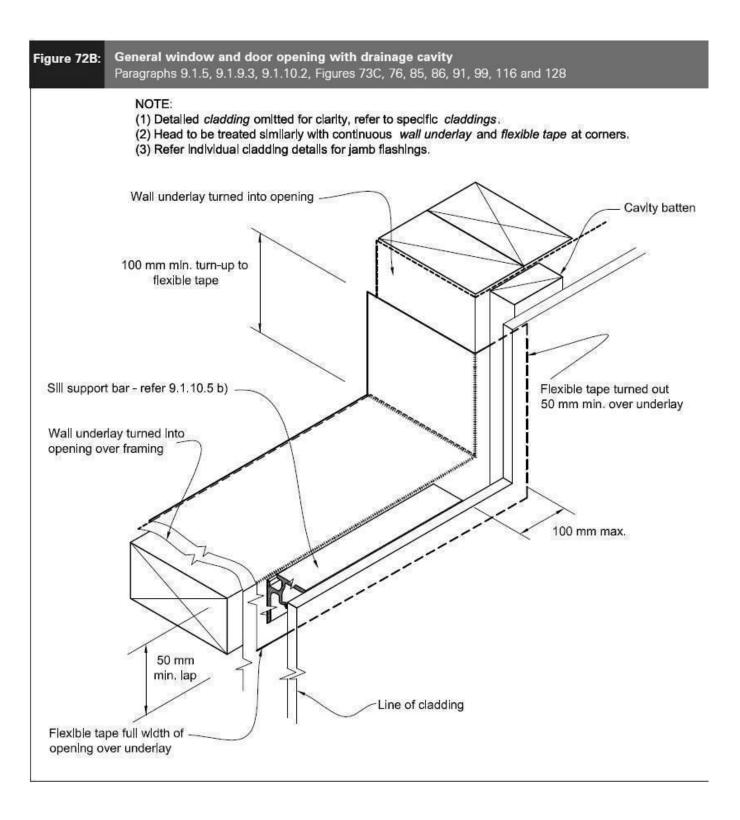
Christchurch 8443 P: +64 3 342 7788 These drawings are limited to and by the extent of the detail covered in the drawings to meet the current New Zealand Building Code (NZBC). Where detail it required for construction and to demonstrate compliance with the current NZBC, a specific request should be made for the required detail to be supplied. No liability will be accepted for any detail or construction not covered in these drawings and/or carried out by persons other than the designer producing these documents.


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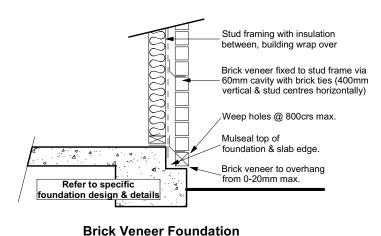
Vester Villalon Lot 8, DP 580863 1 Bob Reid Crescent Darfield

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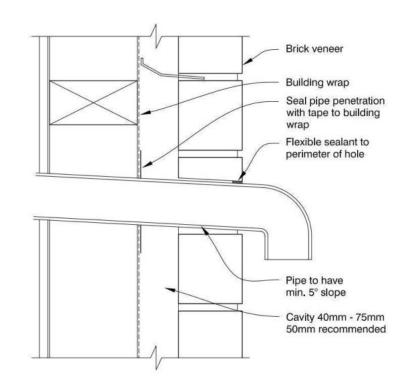
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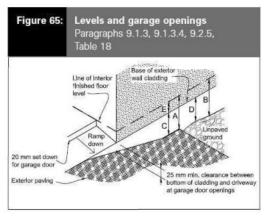


Building wrap staple fixed to studframe @ 300crs max, wrap to be fixed horizontally with upper sheets to lap over lower sheet, allow 75mm cover min. End laps to be over stud, allow 150mm min lap (Support building wrap with Polypropylene tape at 300 mm centres)

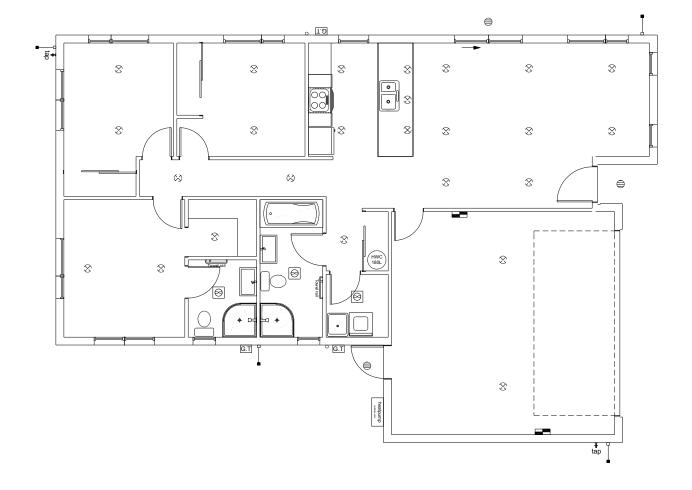
125mm x 12mm thru bolt with 50mm square washer at 900mm crs on all external walls and interior load bearing walls (Bolts also 150mm for each end of bottom plate) minimum cover 40mm. DPC between bottom plate & floor slab.


Stud framing to slab Scale 1:20

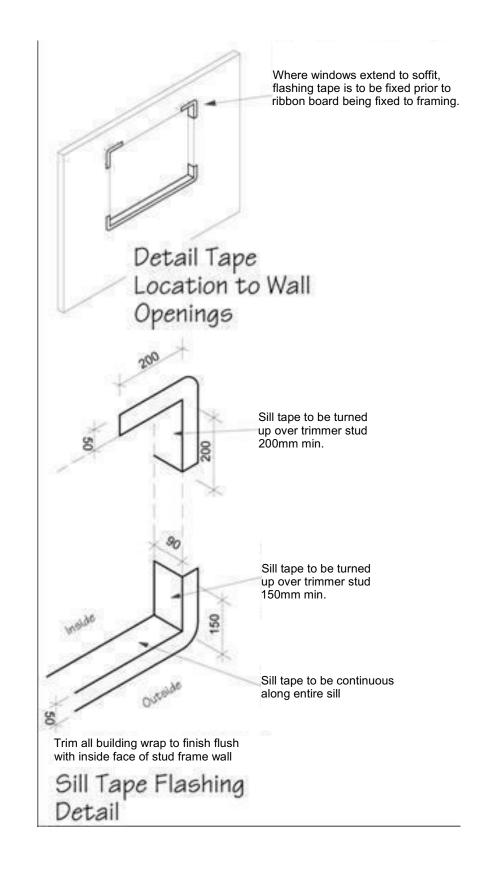




Scale 1:20

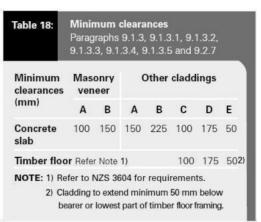

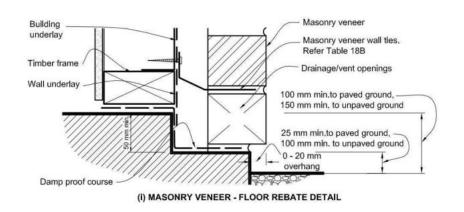

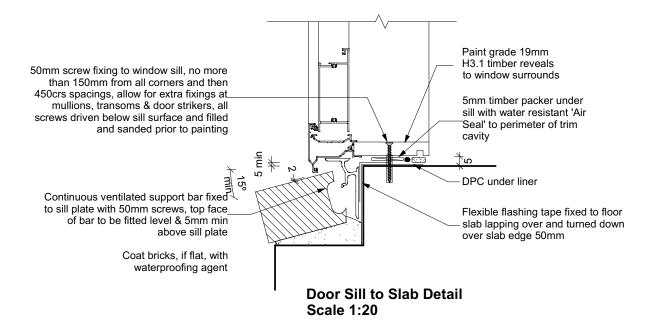

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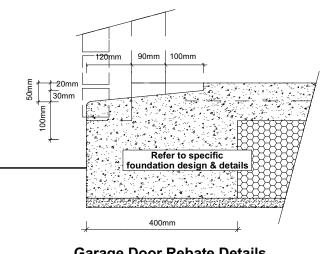
Vester Villalon Lot 8, DP 580863 1 Bob Reid Crescent Darfield

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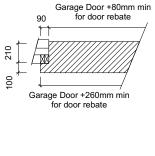
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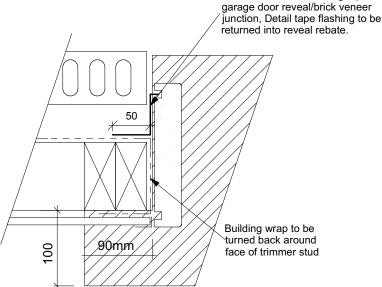
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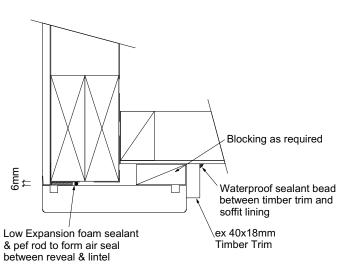


Garage Door Rebate Details Scale 1:10







Garage Door Jamb Detail Scale 1:5




Garage Door Head to Soffit Scale 1:5

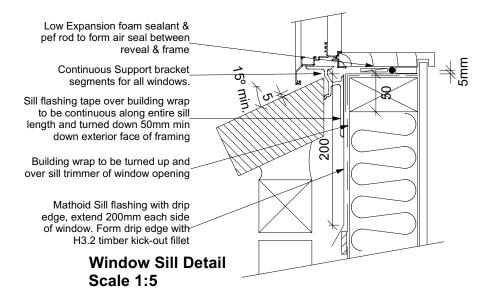

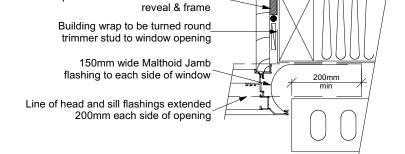

Low Expansion foam sealant & pef rod to form air seal between

Window Jamb Detail Scale 1:5

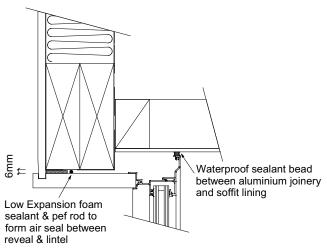

Window Head to Soffit Detail Scale 1:5




Install windows and doors using pairs of minimum 75 x 3.15 galvanised jolt head nails or 8 gauge x 65 mm stainless steel screws, through reveals into surrounding *framing* at:

 a) Maximum 450 mm centres along sills, jambs and heads, and

9.1.10.8 Attachments for windows

b) Maximum 150 mm from reveal ends.

Install packers between reveals and *framing* at all fixing points, except between head reveals and lintels.

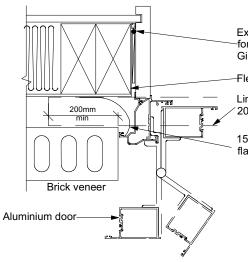

Expandable foam sealant on pef rod to form air seal between cavity system and Gibboard lining

Flexible flashing tape in corners

Line of head and sill flashings extended 200mm each side of opening

150mm wide Malthoid Jamb flashing to each side of window

Door Jamb Detail Scale 1:5

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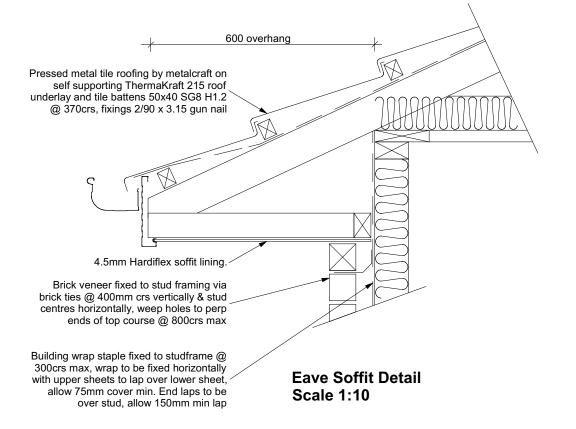
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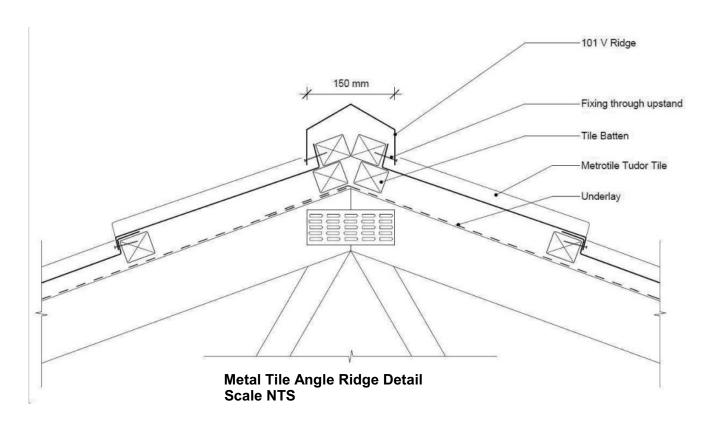
Masons 40 Below flashing tape to


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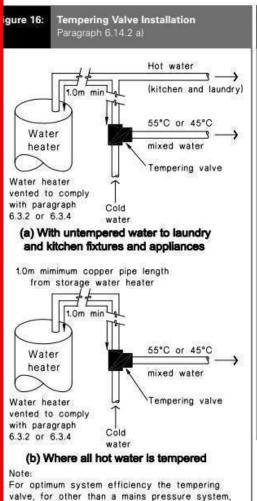
Vester Villalon Lot 8, DP 580863 1 Bob Reid Crescent Darfield

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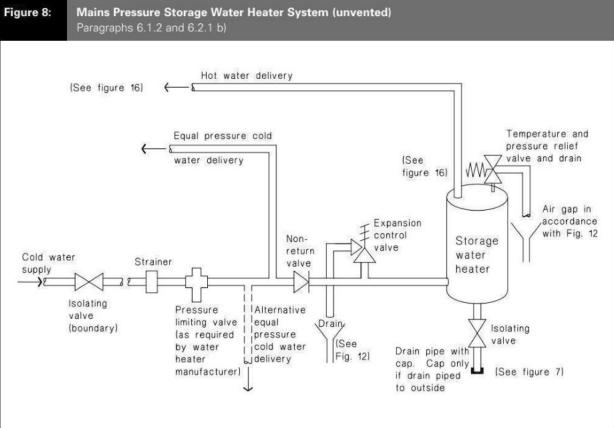



may be located as low as practicable to achieve the manufacturer's recommended head, at the

1.0m minimum copper pipe length from storage

tempering valve.

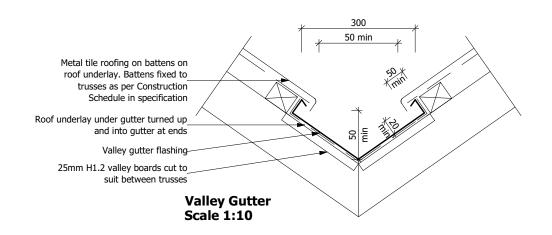water heater.



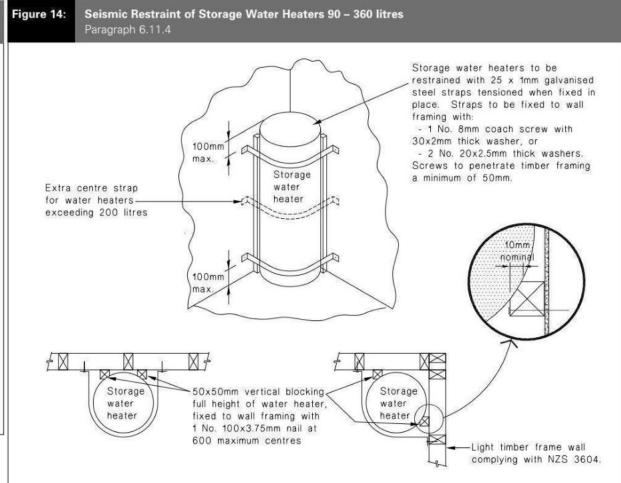

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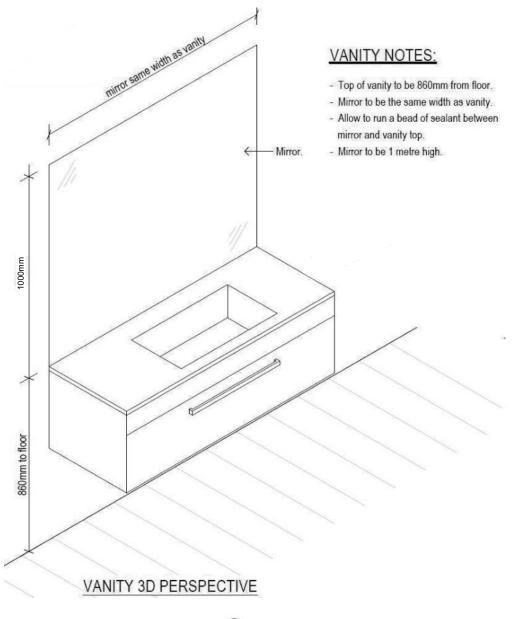



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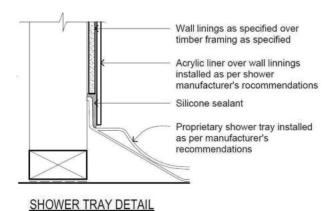
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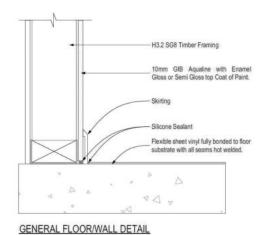
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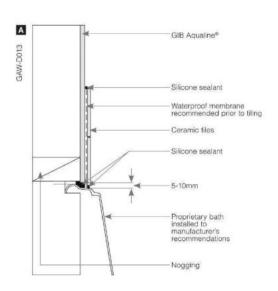






-Silicone sealant required - see bath manufacturer's details manufacturer's instruction

GIB Aqualine® Silicone sealant or tile edge bead recommended prior to tiling Silicone sealant Proprietary bath installed to manufacturer's recommendations

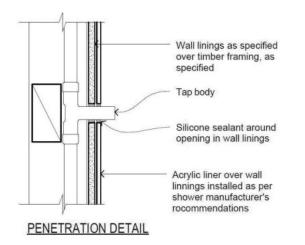

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GIB Aqualine with Aqua Proof

waterproofing membrane and tiles over

GIB Aqualine with Aqua Proof waterproofing membrane and tiles over

Silicone sealant or tile

edge bead

Flooring as per

Job Number: 172870		Original Plan:	Sheet Name: BATHROOM DETAILS			C	Sheet No	
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ales: Ryan	Drawn: M Glynn	QS: W Xian	Print Date: 3/08/2023	Scale: NTS @ A3				of 23 she