215 High Street Private Bag 1005 Rangiora 7440, New Zealand

**Phone** 0800 965 468

**BC No: 230421** 

#### SITE DETAILS:

34 HIGGINS STREET

WOODEND

#### **LEGAL:**

**LOT 660** 

#### AS BUILT TRUSS LAYOUT REQUIRED -

This must be received by the Building Unit **AT LEAST** 10 WORKING DAYS PRIOR to the Structure Pre-Roof Pre-Wrap Inspection

Truss "As-Built" Designs may be sent to: buildinginfo@wmk.govt.nz

# Approved Building Consent Documents and Plans (Full set)

# On Site Copy

- These plans and specifications must be kept on site during construction, and made available to the building officer on request. Failure to do so will mean an automatic failure of the building inspection and will necessitate re-booking the inspection at the applicant's expense.
- All boundary survey pegs must be located and flagged by the owner before work is commenced.

## Inspections

For bookings or building enquiries please phone the Building Unit on:

03 311 8906

or

#### Email inspection bookings to: bcbooking@wmk.govt.nz

- Please refer to your inspection schedule for details of inspections to be carried out.
- At least 2-3 full working days' notice should be given when booking an inspection.
- Please be advised that it may not always be possible to carry out the inspection within the time frame you require.
- Provision is to be made to allow access.
- The Code Compliance Certificate will be issued once the:
  - Final inspection has been carried out and passed.
  - Audit of WDC building consent file has been completed.
  - Payment of any outstanding invoices is received.

# **Shaw and Anderson House**

ENGCO
Consulting Engineers

Higgins Street, Ravenswood (Lot 660)

TC2 RIBRAFT DRAWINGS

File Number 23000.054

Sheet No.	Rev	Date Issued	Sheet Title
S1	-	21/04/2023	General Notes
S2	=	21/04/2023	RibRaft Layout Foundation Plan
S3	-	21/04/2023	Typical Foundation Sections
S4	-	21/04/2023	Typical Foundation Sections
S5	-	21/04/2023	Typical Services Penetration Details

Issue Register

Date Description

21/04/2023 For Consent

WAIMAKARIRI DISTRICT COUNCIL
Plans and specifications APPROVED in accordance
with the Building Act 2004, clause 49 and the Building
Regulations 1992, Clause 3
BC230421 24/05/2023 co-michaelmo

#### CONSENT ISSUED BC230421 - Page 3 of 31

contractor shall verify all dimensions before commencing work BC230421

#### **GENERAL**

- These drawings are not to be used for construction until the plan (sheet S2) is signed by the main contractor.
- Do not scale. Refer any discrepancies to the Architect.
- These drawings are to be read in conjunction with the Architects drawings.
- The builder shall be responsible for any damage to works during construction.
- The sand blinding layer shall be 20mm min. & 50mm max. to aid levelling & to prevent rocking of pods.
- Vapour barrier to be 0.25mm (250 micron) polythene complying with NZS 4229 / NZS 3604.
- · Finished ground level adjacent to slab to be protected from wind, water erosion and undermining.

#### **FOUNDATIONS**

GEOTECHNICAL REFERENCE:

Geotechnical Report

**ENGCO** 

Ref. No: 23000.054

Dated: 4-Apr-23

Bearing: 200KPa

Refer:

- · For assumed allowable bearing capacity refer to calculations/installer guide. Unless otherwise noted in documentation.
- If there is any doubt about the integrity of the material on which the slab is to be founded -Supervising Engineer must be notified immediately.

#### · All workmanship & materials to conform to NZS 3109, NZS 4210 & local authority

- Minimum covers to reinforcement:
- Exposed to earth 75mm.

CONCRETE

- Protected by vapour barrier 50mm.
- Not exposed to weather except for a brief period during construction 25mm.
- No holes or chases other than those specified are to be made in the slab without the approval of Engco.
- All concrete shall have 20mm nominal maximum aggregate size & 120mm slump & shall comply with NZS 3109.
- All concrete to be mechanically vibrated & carefully worked around the reinforcement & into the corners of the formwork.
- Ribraft make-up to be

85mm Floor Slab - 220mm pods (25MPa min. TC2 Dramix 4D 80/60 Fibre Mix) G500E SE-62 Ductile mesh on 40mm chairs

The design Fibre mix shall be supplied so that the residual flexural tensile stresses f<sub>R,1</sub> & f<sub>R4,K</sub> shall be 1.5 MPa & 1.0 MPa respectively.

#### REINFORCEMENT

• All reinforcing shall be New Zealand sourced and conform to AS/NZS 4671 :2001 in grade 300 or grade 500E.

- All bends to be made cold without fracture.
- · All reinforcing shall be deformed type unless otherwise stated.
- Grade 500E deformed bars shall be designated 'H', Grade 300 deformed bars shall be designated 'D' and Grade 300 round bars shall be designated 'R'.

Minimum bar lap.		H12 bars	H16 bars
	L	720mm	900m

- All reinforcement to be fixed & tied where necessary in its specified position.
- Welding of steel is not permitted.
- Spacers:
  - Edge at 1200mm ctrs (one on edge & two on corners, typically).
  - Internal one on each side of pod (typically).
- All mesh shall comply with AS/NZS 4671 & shall conform with elongation requirements exceeding 10%.
- All mesh shall lap a minimum of 250mm (end extensions not included in lap length).

#### **INSPECTIONS**

Inform ENGCO consulting 48 hours in advance of any inspections required for code compliance certification.


Contact ENGCO - Ph. 03 366 7955 & quote ENGCO Ref. No.

#### **INSPECTIONS REQUIRED**

1. Confirm bearing at excavation - by ENGCO

2. Contractor to supply (4) N.D. Tests at finished compacted surface if depth of fill is greater than 400mm.


3. Pre-pour of slab - by Engco

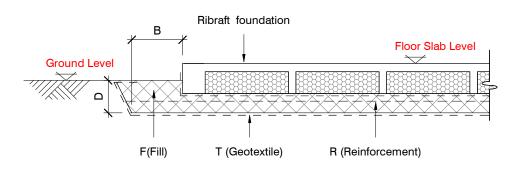

#### **BUILDING PLATFORM**

	BUILDING PLATFORM TABLE:
В	500mm
D	300 mm bgl (approx). Remove organic topsoil.
Т	N/A
R	N/A
F	AP40 or AP65 fill - 95% Dry Density. Compact in 150mm layers max.

Refer Architectural drawings for Finished Floor Level

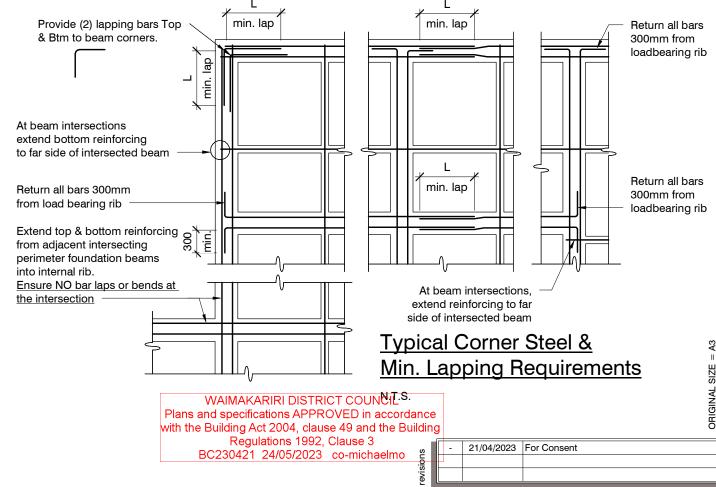





#### **Shaw and Anderson House**

Higgins Street, Ravenswood (Lot 660)

**General Notes** 

23000.054 A. Cayzer M. Cusiel appyd **S1** 21/04/23


Locations shown of internal floor beam thickenings are indicative only. It shall be the responsibility of the Contractor to ensure that they are located centrally under the load

bearing walls to which they pertain.

Under no circumstance should pipework for services be run longitudinally in 100mm ribs. Similarly they should not be run along perimeter foundations nor internal floor beam thickenings

Vertical or horizontal penetrations through the foundation edge beam or floor beam thickenings must be made through the middle third of the member. Vertical penetrations should not be made through 100 mm ribs.

Refer to Architects drawings for floor slab, set downs, steps, rebates, holding down bolts, cast-in componentry and the like.

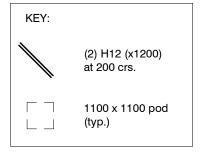

85mm Floor Slab - 220mm pods (25MPa min, TC2 Dramix 4D 80/60 Fibre Mix) G500E SE-62 Ductile mesh on 40mm chairs

The design Fibre mix shall be supplied so that the residual flexural tensile stresses f<sub>R,1</sub> & f<sub>R4,K</sub> shall be 1.5 MPa & 1.0 MPa respectively.

All Mesh shall lap a minimum of 250mm (end of extensions not included.


WAIMAKARIRI DISTRICT COUNCIL Plans and specifications APPROVED in accordance with the Building Act 2004, clause 49 and the Building Regulations 1992, Clause 3 BC230421 24/05/2023 co-michaelmo

#### 16540 9250 4720 910 1660 TYP EDGE BEAM S3 - 8 🕇 5 5 S4 S4 S4 S3 6 1 S3 S4 1790 480 H12 (x3000) S3 (Typ. at each rib) 2-H12, 50 mm spacing 400 (x3000mm long) to the top of the ribs in the garage in the direction shown only 15510

#### RIBRAFT FOUNDATION LAYOUT PLAN

1:100

Confirm all dimension with Architects drawings

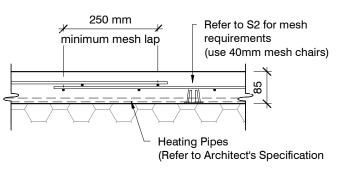

## TYPICAL MESH LAP & CHAIR REQUIREMENTS

office@engco.nz **Consulting Engineers** 




#### **Shaw and Anderson House**


Higgins Street, Ravenswood (Lot 660)

RibRaft Layout Foundation Plan


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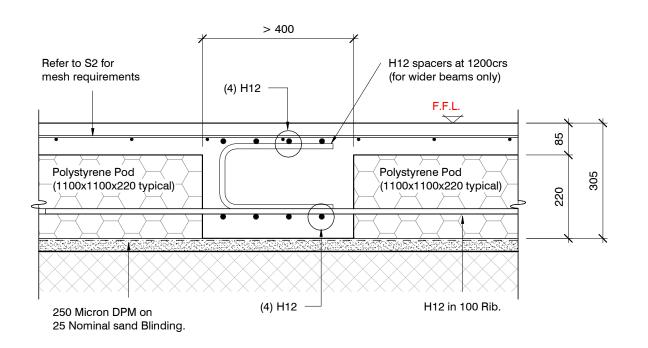
M. Cusiel appyd S2 21/04/23



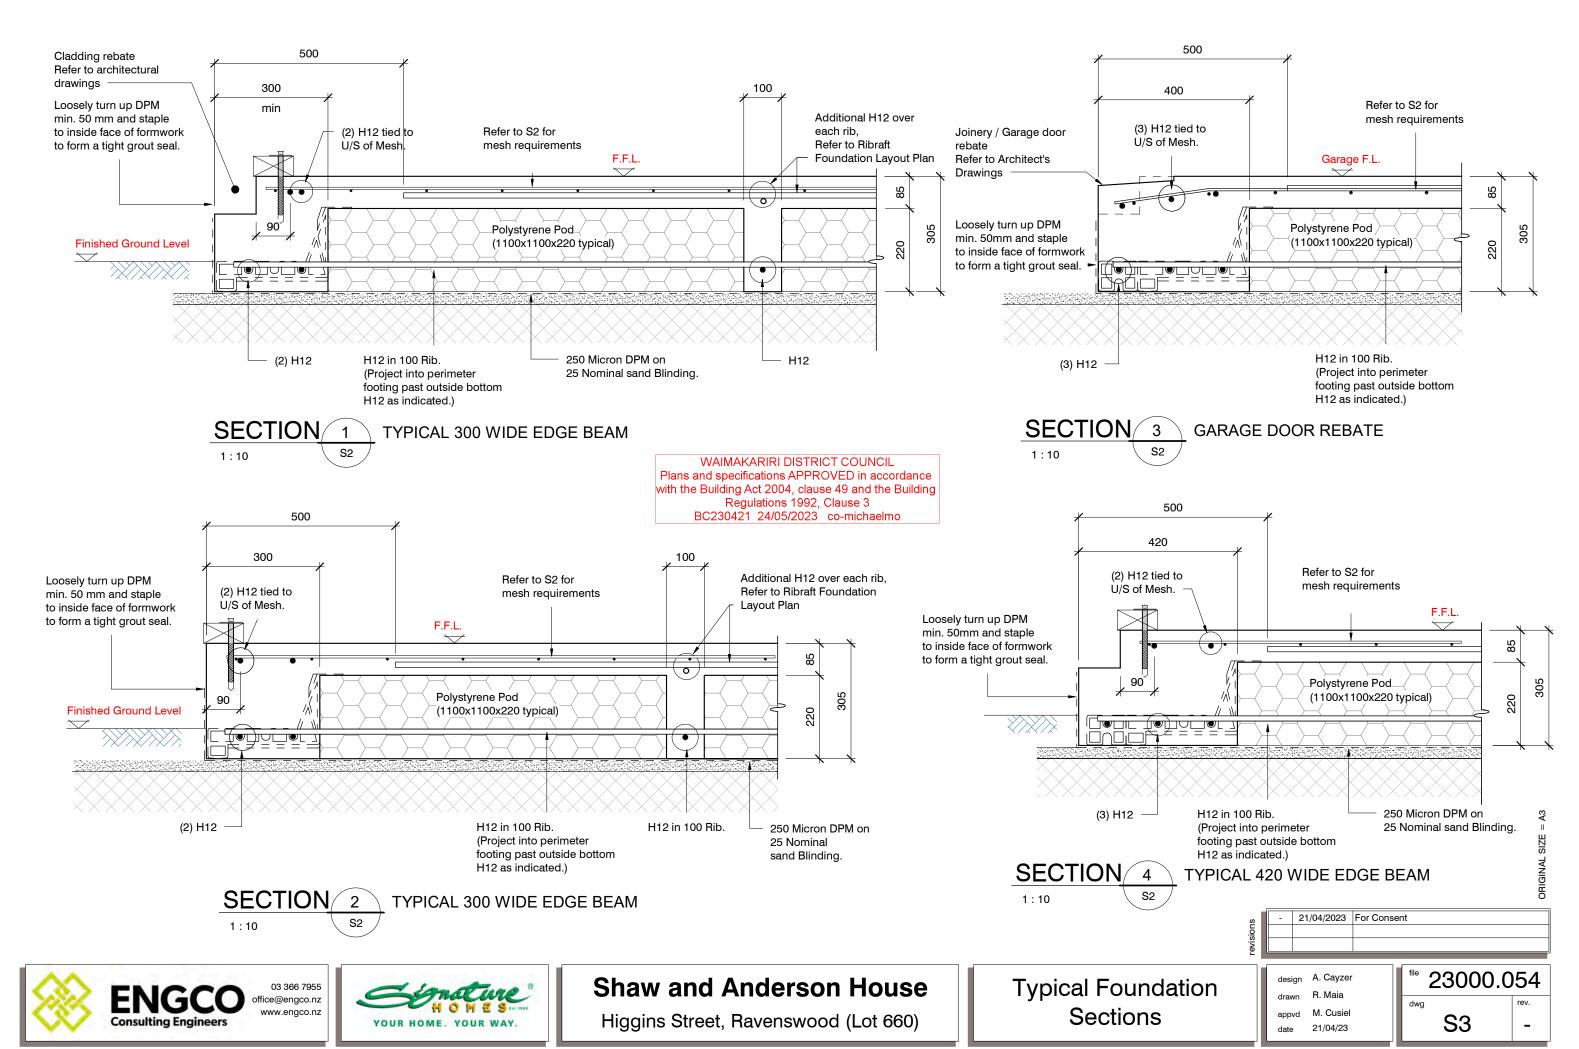

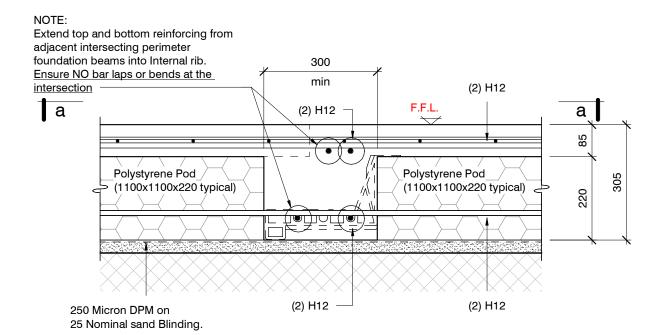SECTION/ TYPICAL 300mm wide INTERNAL BEAM 1:10



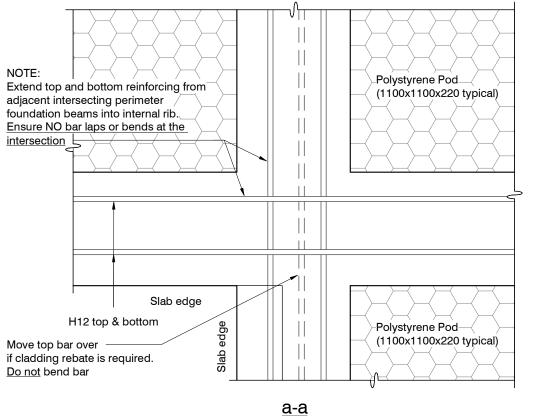

SECTION 6 1:10

INTERNAL BEAM GREATER THAN 400 WIDE

WAIMAKARIRI DISTRICT COUNCIL Plans and specifications APPROVED in accordance with the Building Act 2004, clause 49 and the Building Regulations 1992, Clause 3 BC230421 24/05/2023 co-michaelmo

> 21/04/2023 For Consent A. Cayzer

office@engco.nz **Consulting Engineers** 





**Shaw and Anderson House** 


Higgins Street, Ravenswood (Lot 660)


**Typical Foundation Sections** 

23000.054 M. Cusiel appyd **S4** 21/04/23

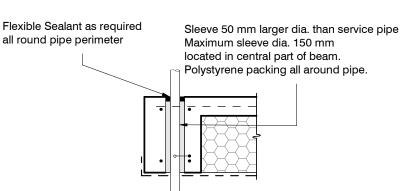

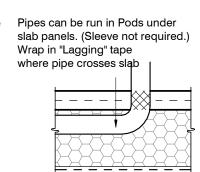

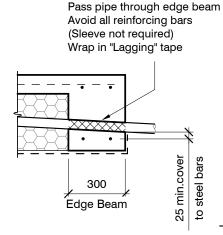

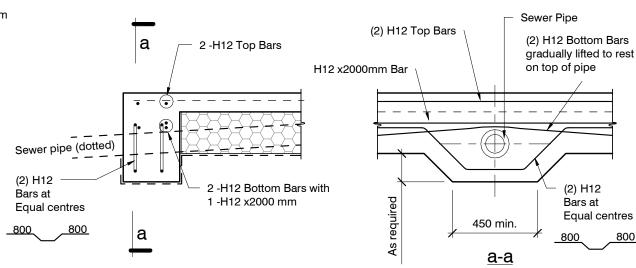


#### **SLAB SERVICES PENETRATION DETAIL**

#### PIPE NOTE:


No separation required where pipes are fully contained within slab. Sleeve all drains that pass through the base of the slab.

PENETRATIONS NOTE: Where penetrations through Floor Slab exceed 450 mm Square, Crack Control Bars will be required.

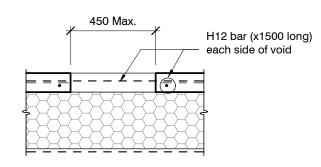

# TYPICAL SECTION LOCALISED DEEPENING OF FOUNDATION BEAM TO ACCOMMODATE TOILET WASTE PIPE

#### LARGE SLAB PENETRATION DETAIL

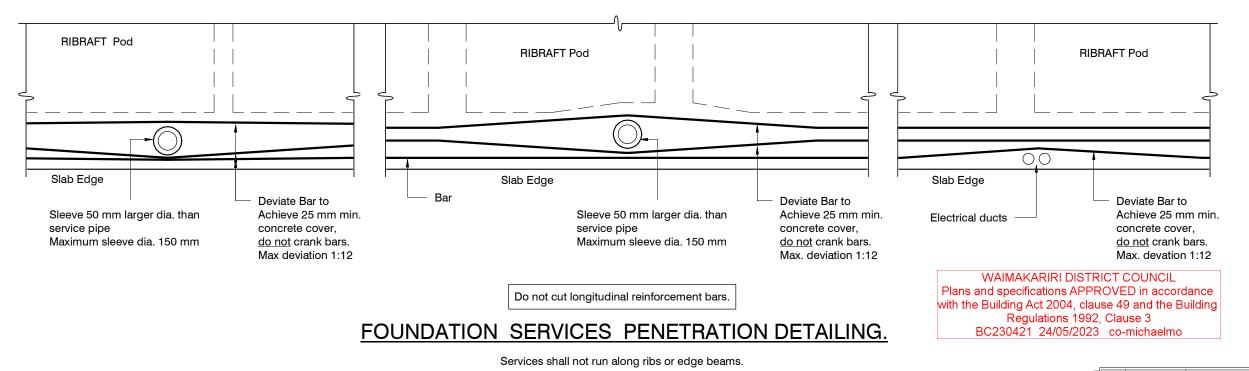







#### **Shaw and Anderson House**

Higgins Street, Ravenswood (Lot 660)

Typical Services
Penetration Details

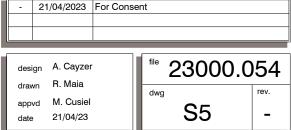

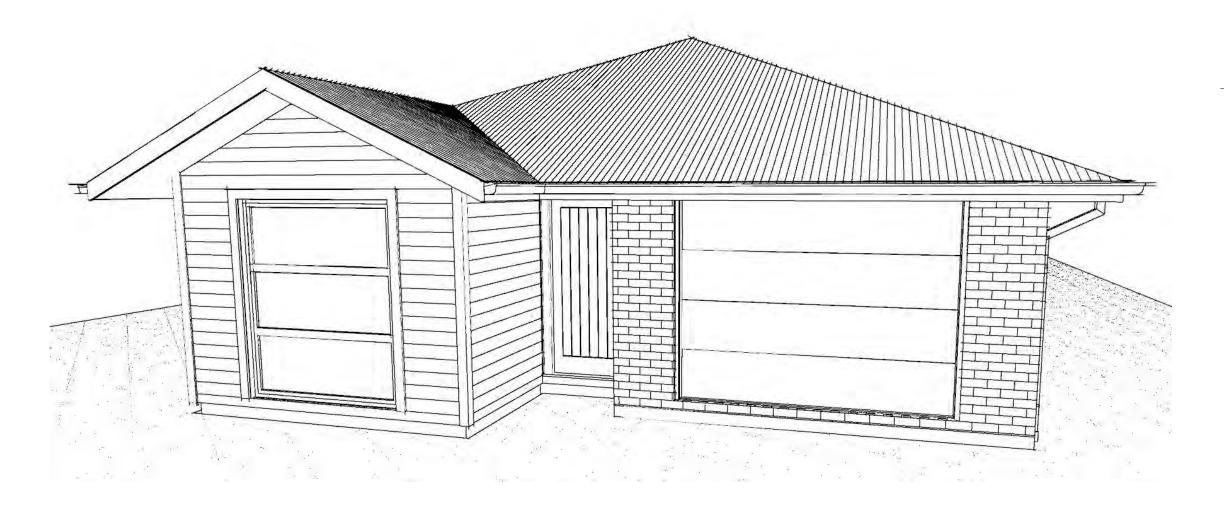

Contents: Sheet 1: **Cover Sheet** Sheet 2: Site Plan Sheet 3: Floor Plan Sheet 4: Elevations Sheet 5: Elevations Sheet 6: **Cross Sections** Sheet 7: Roof Plan Sheet 8: **Set Out Dimensions** Sheet 9: Foundation Plan Sheet 10: Drainage Plan Sheet 11: Bracing Plan Lighting Plan Sheet 12: Sheet 13: Framing Details Sheet 14: Framing Details Sheet 15: **Construction Details** Sheet 16: **Construction Details** Sheet 17: **Construction Details** Sheet 18: **Construction Details** Sheet 19: **Construction Details** Sheet 20: **Construction Details** Sheet 21: **Bathroom Details** Sheet 22: **Plumbing Details** Truss Design Sheet 23: Sheet 24: Truss Design

WAIMAKARIRI DISTRICT COUNCIL
Plans and specifications APPROVED in accordance
with the Building Act 2004, clause 49 and the Building
Regulations 1992, Clause 3
BC230421 24/05/2023 co-michaelmo

All dimensions are to be check and confirmed prior to any construction

Plans are to be read in conjunction with Specifications and all supporting documentation



TKR Homes Ltd. 31 Watts Road, Sockburn PO BOX 11 351 Christchurch 8443

P: +64 3 342 7788

These drawings are limited to and by the extent of the detail covered in the drawings to meet the current New Zealand Building Code (NZBC). Where detail it required for construction and to demonstrate compliance with the current NZBC, a specific request should be made for the required detail to be supplied. No liability will be accepted for any detail or construction not covered in these drawings and/or carried out by persons other than the designer producing these documents.

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DRAINAGE LEGEND

Stormwater DN100mm uPVC Sewer Drain DN100mm uPVC Downpipe

DP GT ORG TV Gully Trap Overflow Relief Gully Terminal Vent
Air Admittance Valve AAV Inspection Point

Exposure N 4 at 50m (up to 1kPa) Snow

cladding to boundary. Refer to sheet 8 for foundation to boundary dimensions.

Sediment control and site safety requirements are noted in the attached Specifications.

SITE INFORMATION

Floor Area (veneer)

Site Area:

Roof Area


Earthquake

Wind

Building Consent BC230421 Received 24/05/2023

138.50m² / 31.91%

166.48m<sup>2</sup> / 38.36%

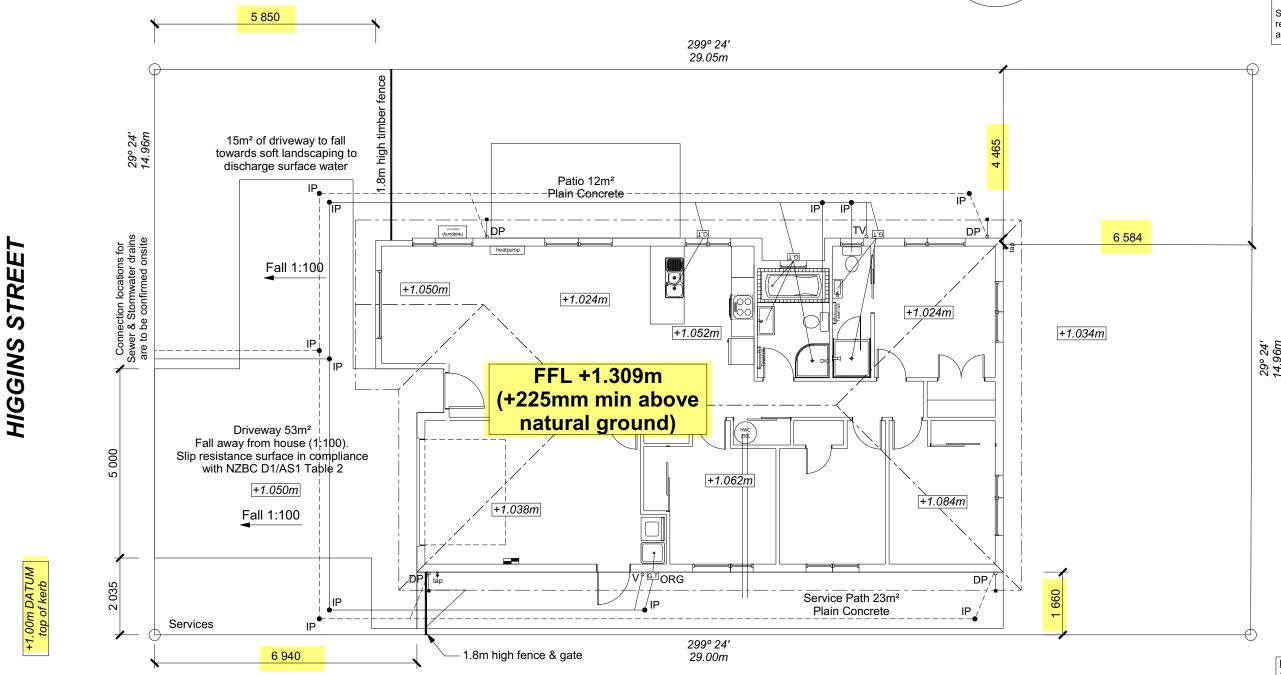

Provide safety fencing to perimeter of site - permanent or temporary to comply with NZBC F5/AS1

I hereby confirm that the building has been set out in accordance with consented site plans and the finisher loor level complies with the minimum level indicated

WAIMAKARIRI DISTRICT COUNCIL Plans and specifications APPROVED in accordance with the Building Act 2004, clause 49 and the Building Regulations 1992, Clause 3 BC230421 24/05/2023 co-michaelmo

#### **DRAWING NOTES**

These drawings are subject to copyright and remain the property of Signature Homes Ltd.

Verify all dimensions, sizes and levels on site prior to commencing any work. Any discrepancies are to be confirmed with

Refer to attached Specifications for further

All work is to comply with the NZBC Acceptable Solutions, NZS 3604:2011 and Local Authority bylaws.

2

All dimensions are to be check and confirmed prior to any construction Plans are to be read in conjunction with Specifications and all supporting doct



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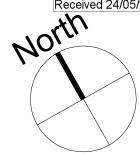
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Penny Shaw & Stuart Anderson Lot 660 34 Higgins Street Ravenswood, Woodend

Sheet Name: Original Plan: Snipe 131371 SITE PLAN Print Date

1:100

**CONSENT PLANS** Sheet No.: o. Date: Reason: 04-04-2023 Initial Consent Plans of 24 sheets



#### **ROOF & WALL CLADDINGS**

Roof: 25° Corrugate Longrun Walls: 70 Series Brick Veneer with a 50mm cavity

James Hardie Linea Weatherboards (facing boards) with a 20mm cavity

#### **DWELLING AREAS**

Framing Area: 133.02m² (Perimeter: 52.51m) Veneer Area: 138.50m² (Perimeter: 53.47m) Roof Area: 166.48m² (Perimeter: 54.83m)

SMOKE ALARMS (hush type) Domestic Smoke Alarms to be fitted within 3.0m of sleeping areas and on Escape routes as indicated on plan. To comply with one of the following standards: UL 217, ULC-S531, AS 3786, BS 5446 (part 1).

#### **FLOOR PLAN NOTES**

Dimensions shown are to the frame. GIB thickness not shown. Mechanical ventilation to comply with G4/AS1 Air Seals to have PEF rod & low expansion foam All windows and doors centered in room unless

shown otherwise Laundering facilities provided complying with G2/SÃ1 1.0

Provide sealant under skirting and paint to concrete around tub & W/M fixtures

WALL FRAMING Stud Height: 2400 mm (2455mm to u/s of bottom chord)

FLOOR FINISHES Carpet & Vinyl

KITCHEN HOB

Internal Height: 1980mm (leaves) Leaf widths as shown on the plan (R/O +80mm)
Type: Hollow core flush panel Front Door Type: Latitude Aluminium

WINDOW JOINERY Low-E Double glazed aluminum Standard single glazing to Garage

INTERNAL TRIMS
Scotia: 50mm GIB Coving (excluding garage)
Skirting: 60x12mm Pine, single bevel edge Architrave: N/A

Shelf & Rails to all wardrobes 4 shelves to Linen cupboard

#### **DRAWING NOTES**

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Verify all dimensions, sizes and levels on site prior to commencing any work. Any discrepancies are to be confirmed with

Refer to attached Specifications for further information

All work is to comply with the NZBC Acceptable Solutions, NZS 3604:2011 and Local Authority bylaws.

Sheet No.:

3

of 24 sheets

TKR Homes Ltd.

specific request should be made for the required detail to be supplied. No liability will be accepted for any detail or construction not covered in these drawings and/or carried out by persons other than the designer producing these documents.

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Penny Shaw & Stuart Anderson Lot 660 34 Higgins Street

Original Plan: Snipe 131371

**CONSENT PLANS** Sheet Name: o. Date: Reason: 04-04-2023 Initial Consent Plans **FLOOR PLAN** Print Date 24/05/2023 1:100

with the Building Act 2004, clause 49 and the Building Regulations 1992, Clause 3

BC230421 24/05/2023 co-michaelmo

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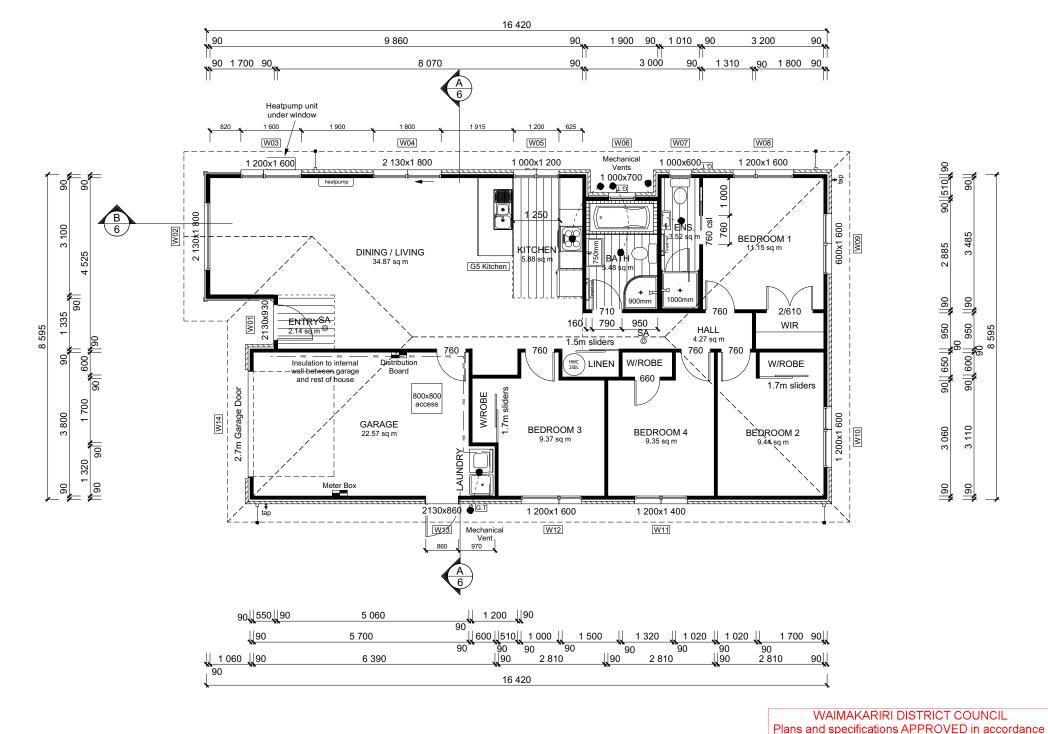
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All dimensions are to be check and confirmed prior to any construction


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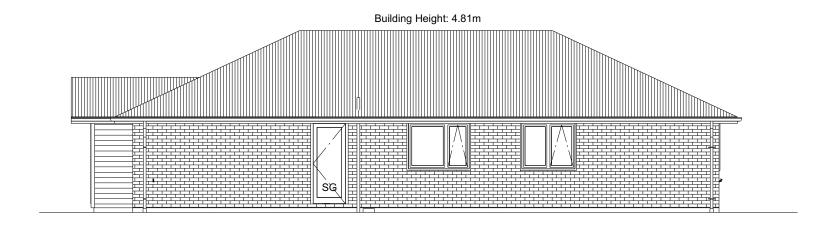
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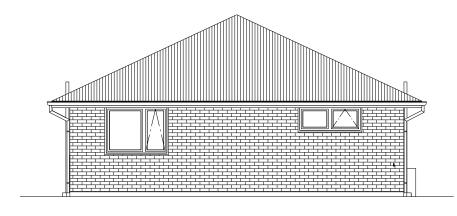
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#### CONSENT ISSUED BC230421 - Page 11 of 31





#### **ELEVATION A**

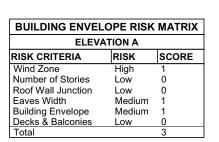

#### BUILDING ENVELOPE RISK MATRIX **ELEVATION B** RISK CRITERIA RISK SCORE Wind Zone High Number of Stories Low Roof Wall Junction Eaves Width Medium Building Envelope Low Decks & Balconies Low

#### **ELEVATION B**

WAIMAKARIRI DISTRICT COUNCIL
Plans and specifications APPROVED in accordance
with the Building Act 2004, clause 49 and the Building
Regulations 1992, Clause 3
BC230421 24/05/2023 co-michaelmo

ROOF & WALL CLADDINGS Roof : 25° Corrເປັດລະ230421 Walls : 70 Series Brick Veneer with a 50mm cavity

**ELEVATION LEGEND** 

**ELEVATION NOTES** 

SS SG MB

TV

James Hardie Linea Weatherboards (facing boards) with a 20mm cavity

Safety Stays

Safety Glass Meter Box

Terminal Vent

Joinery: Low-E Double glazed aluminum

All egress points to have a maximum step down of 190mm.

Access routs to have slip resistance surface

and to have a 1:100 fall away from the building

in compliance with NZBC D1/AS1 Table 2

Gutter: Coloured Steel Quad Gutter Fascia: Coloured Steel185 Fascia Downpipes: Colorsteel Rectangular 75x55mm Soffits: Hardiflex 4.5mm

All dimensions are to be check and confirmed prior to any construction

Plans are to be read in conjunction with Specifications and all supporting documentation





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P: +64 3 342 7788

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Job Num	ber:	Original Plan:	Sh	eet Name:			C	ONSENT PLANS	Sheet No.:
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#### BUILDING ENVELOPE RISK MATRIX **ELEVATION D** RISK CRITERIA RISK SCORE Wind Zone High Number of Stories Low Roof Wall Junction Eaves Width Medium Building Envelope Medium Decks & Balconies Low

#### **ELEVATION D**

**ELEVATION C** 

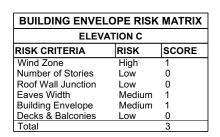WAIMAKARIRI DISTRICT COUNCIL
Plans and specifications APPROVED in accordance
with the Building Act 2004, clause 49 and the Building
Regulations 1992, Clause 3
BC230421 24/05/2023 co-michaelmo

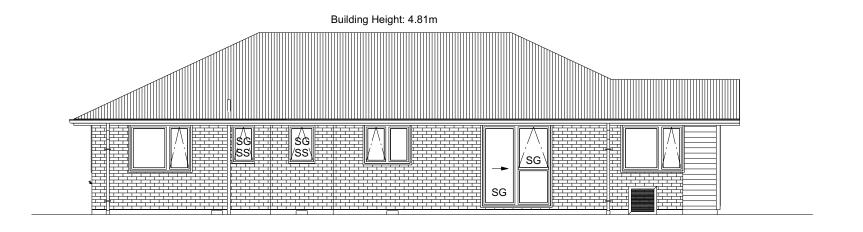ROOF & WALL CLADDINGS

Roof: 25° Corrugate Longrun

Walls: 70 Series Brick Veneer

with a 50mm cavity

**ELEVATION LEGEND** 

**ELEVATION NOTES** 

SS SG MB

TV

James Hardie Linea Weatherboards (facing boards) with a 20mm cavity

Safety Stays Safety Glass Meter Box

Terminal Vent

Joinery: Low-E Double glazed aluminum

All egress points to have a maximum step down of 190mm.

Access routs to have slip resistance surface

and to have a 1:100 fall away from the building

Building Consent BC230421

Sheet No.:

5

of 24 sheets

Received 24/05/2023

in compliance with NZBC D1/AS1 Table 2

Gutter : Coloured Steel Quad Gutter Fascia : Coloured Steel185 Fascia Downpipes : Colorsteel Rectangular 75x55mn Soffits : Hardiflex 4.5mm

All dimensions are to be check and confirmed prior to any construction

Plans are to be read in conjunction with Specifications and all supporting documentation




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#### CONSENT ISSUED BC230421 - Page 13 of 31



Corrugate Longrun roofing on self supporting ThermaKraft 215 roof underlay on 70x45mm SG8 H1.2 Purlins @ 900crs fixings 1/10g selfdrilling screw, 80mm long

13mm Std. GIB ceiling lining (Aqualine to wet areas) to underside of 70x35mm H1.2 ceiling battens @ 600mm crs with R3.6 Pink Batts

Coloured steel fascia & gutter system with 4.5mm Hardies soffit lining.

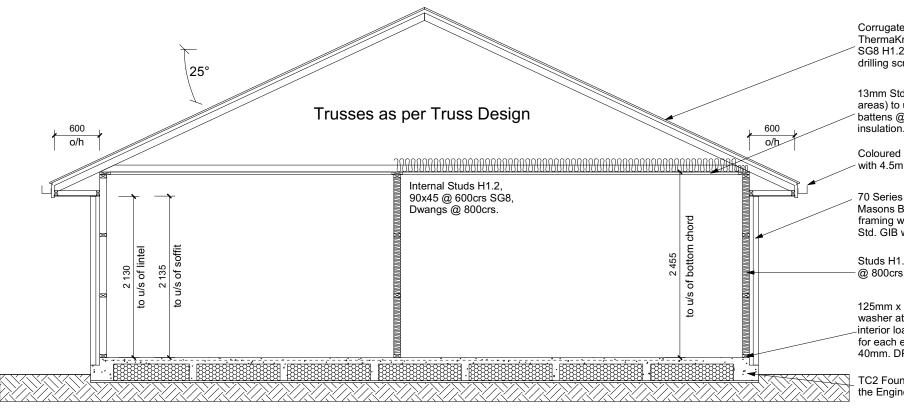
70 Series brick veneer with a 50mm cavity. Masons Barricade building wrap on stud framing with R2.6 Pink Batts insulation & 10mm Std. GIB wall lining (Aqualine to wet areas).

Studs H1.2, 90x45 @ 600mm crs SG8, Dwangs @ 800crs (exterior & interior loadbearing walls)

125mm x 12mm thru bolt with 50mm square washer at 900mm crs on all external walls and interior load bearing walls (Bolts also 150mm for each end of bottom plate) minimum cover 40mm. DPC between bottom plate & floor slab.

TC2 Foundations as per the Engineers Design

#### **CROSS SECTION A-A**

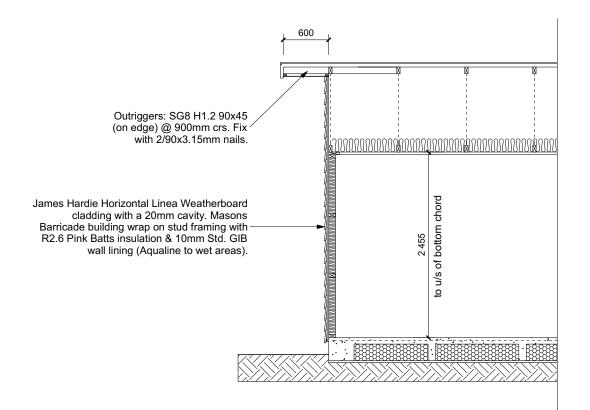

Regulations 1992, Clause 3 BC230421 24/05/2023 co-michaelmo

WAIMAKARIRI DISTRICT COUNCIL Plans and specifications APPROVED in accordance with the Building Act 2004, clause 49 and the Building

1:50

#### **DRAWING NOTES**

**ROOF & WALL CLADDINGS** Roof: 25° Corru**B.623.04r2**n1 Walls: 70 Series Brick Veneer with a 50mm cavity

**CROSS SECTION NOTES** 

of E2/AS1.

INSULATION

Building wrap is to comply with E2/AS1 & NZS 3604:2011. Flashing materials must be selected based on

environmental exposure. Refer to NZS 3604:2011 & table 20 of E2/AS1.

Flashing tape must have proven compatibility with the selected wrap & other materials with which it comes into contract as per table 21

Fixings shall comply with NZS 3604:2011 Section 4 Durability Tables 4.1-4.3

strength graded as per NZS3604:2011.

Ceiling: Pink Batts R3.6 Ceiling Batts Wall: Pink Batts R 2.6 Wall Batts

Joinery: Low-E Double glazed aluminum

Unless stated otherwise, timber members on drawings are to be a minimum of SG8

James Hardie Linea Weatherboards

(facing boards) with a 20mm cavity

These drawings are subject to copyright and remain the property of Signature Homes Ltd.

Verify all dimensions, sizes and levels on site prior to commencing any work. Any discrepancies are to be confirmed with Signature Homes Ltd.

Refer to attached Specifications for further information

Local Authority bylaws.

Sheet No.:

6

of 24 sheets

All work is to comply with the NZBC Acceptable Solutions, NZS 3604:2011 and

sions are to be check and confirmed prior to any construction Plans are to be read in conjunction with Specifications and all supporting doc



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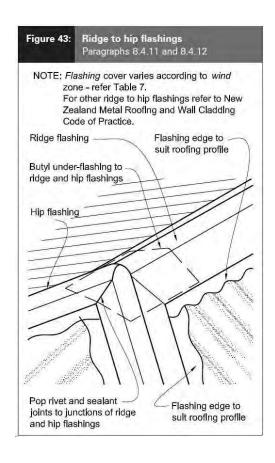
**CROSS SECTION B** 


Penny Shaw & Stuart Anderson Lot 660 34 Higgins Street Ravenswood, Woodend

Sheet Name: Original Plan: Snipe 131371 **CROSS SECTIONS** Print Date


M Glynn

**CONSENT PLANS** Date: Reason: 04-04-2023 Initial Consent Plans



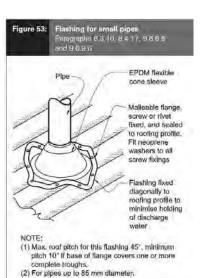

# CONSENT ISSUED BC230421 - Page 14 of 31 crossed LUMBERLOK Strip Brace running continuously from ridge to top plate installed as detailed below. A pair of tensioned and crossed LUMBERLOK

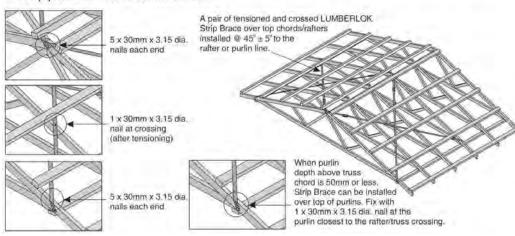

direction of Downpipe Downpipe 75x55mm Coloursteel falls in gutter 75x55mm Coloursteel Catchment Area: 33.59m² Catchment Area: 40.15m<sup>2</sup> Steel Strap Bracing Steel Strap pitch 25° 25° direction of falls in gutter 25° pitch 25° pitch 25° Downpipe Downpipe 75x55mm Coloursteel 75x55mm Coloursteel direction of Catchment Area: 46.73m<sup>2</sup> Catchment Area: 45.98m² falls in gutter

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Regulations 1992, Clause 3
BC230421 24/05/2023 co-michaelmo

ROOF CLADDING Roofing: 25° Corrugate Longruh

**ROOF PLAN NOTES** 

Soffits: Hardiflex 4.5mm

2/ 60x3.15mm nails.

0-25° roof plan area.

capacity.

as per E2 Table 11.

Downpipes: Colorsteel Rectangular 75x55mm

Underlay: Thermakraft 215 roof underlay

Roof Bracing: Diagonally opposed pair 25x1mm galv straps with 8Kn tension

After tensioning strap, fix to each rafter with

Fold down strap and fix with 3/ 60x3.15mm

Downpipes: 75x55 Rectangle Colorsteel As per NZBC E1/AS1 Table 5 75x55 down pipes can collect up to 60m² of

Use Coloured steel Quad Gutter As per NZ Metal Roof and Wall Cladding Code of Practice Version 2 section 8 the above gutter with a cross sectional area

of 5550mm2 can collect up to 60m2 of

Use Lumberlock top plate fixing chart

attached to the main specifications to determine top plate fixings.

0-25° roof plan area. Refer to the

specifications for exact calculations

nails each into the top chord and into the top

Gutter: Coloured Steel Quad Gutter

Fascia: Coloured Steel 185 Fascia

70x45 SG8 H1.2 @ 900crs, fixings 1/10g self-drilling screw, 80mm long. End span of purlins to be 600crs

All dimensions are to be check and confirmed prior to any construction

Plans are to be read in conjunction with Specifications and all supporting documentation



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Job Nun	nber:	Original Plan:	Sh	eet Name:			C	ONSENT PLANS	Sheet No.:
1313	871	Snipe	ROC	F PLAN	1	No.	Date: 04-04-2023	Reason: Initial Consent Plans	7
Sales: R Gould	Drawn: M Glynn	QS: E Gould	Print Date: 4/04/2023	Scale: 1:100	@ A3				of 24 sheets

#### SET OUT PLAN BOTES 0421


All dimensions over foundation face. Allow (120mm rebate) 70mm veneer & 50mm cavity, Brick to overhang foundation face by 0-20mm max as per NZBC E2/AS1. All reinforcing is to be Ductility Class E, in accordance with NZS 4671. All concrete to comply with NZS3604:2011 Section 4 Durability Clause 4.5.2.

These foundations are design to the findings and recommendations in the site specific Geotech report.

Sheet No.:

8

of 24 sheets

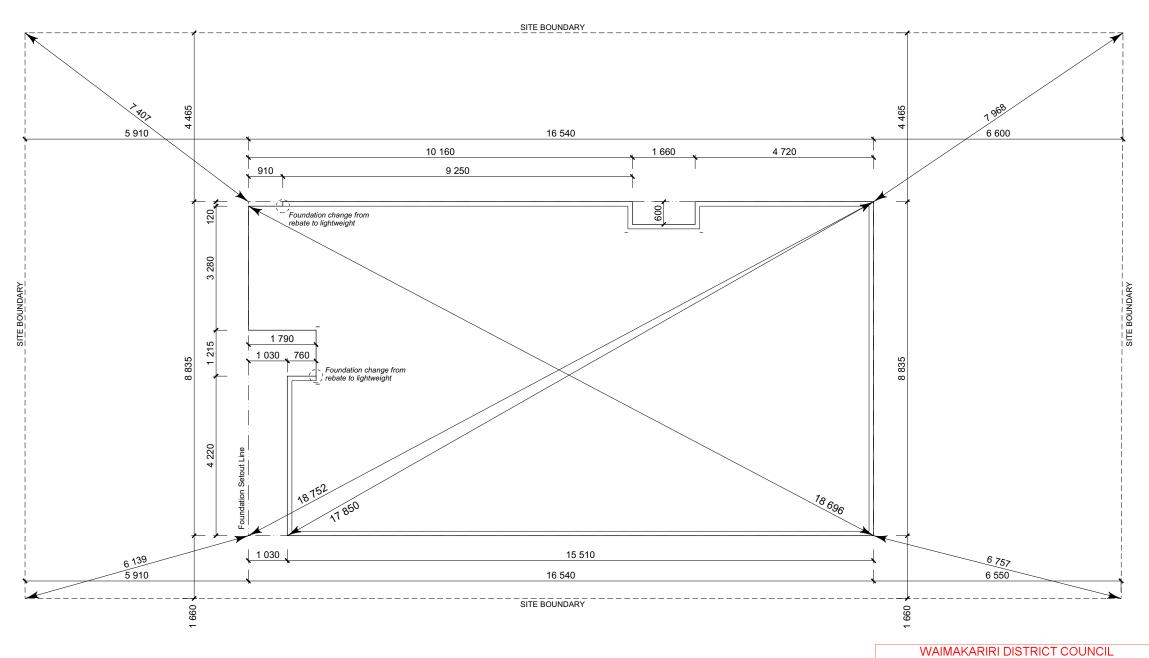

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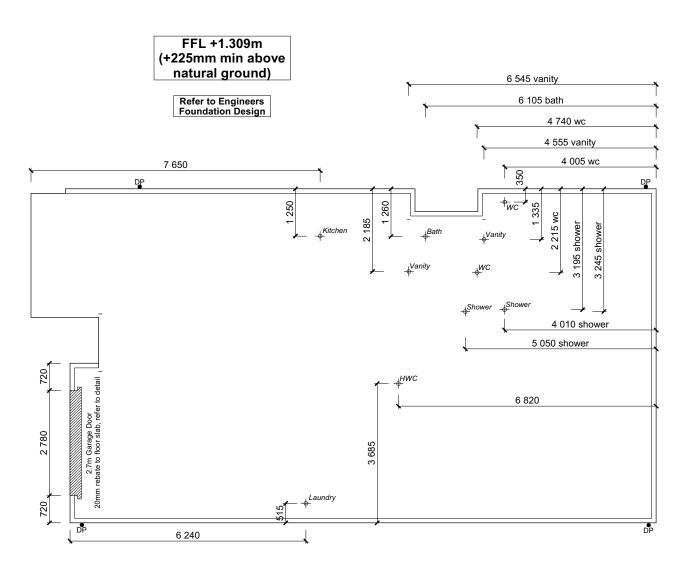
HIGGINS STREET



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Job Numb	Job Number: Original Plan:		Sheet Name:			CONSENT PLANS			
131371		Snipe	SETOUT D	IMENS	SIONS	No.		Reason: Initial Consent Plans	
Sales: R Gould	Drawn:	QS: E Gould	Print Date: 4/04/2023	Scale: 1:100	@ A3				



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Job Num 1313		Original Plan: <b>Snipe</b>		eet Name:
Sales: R Gould	Drawn:	QS: E Gould	Print Date: 4/04/2023	Scale: 1:100 @ A3

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04-04-2023 Initial Consent Plans 9 of 24 sheets

FOUNDATION PEANINGTES 1

0-20mm max as per NZBC E2/AS1. W/C location indicated on plan has assumed a 140mm offset from internal frame line, please consult manufacturer's documentation to confirm offset. Contractor to consult manufacturer's documentation to determine the correct location for all wastes positioned through floor slabs.
Earth bar to be bonded to the reinforcing mesh Refer to Truss design for exact location of

All dimensions over foundation face. Allow (120mm rebate) 70mm veneer & 50mm cavity, Brick to overhang foundation face by

All reinforcing is to be Ductility Class E, in accordance with NZS 4671.

All concrete to comply with NZS3604:2011 Section 4 Durability Clause 4.5.2.


These foundations are design to the findings

AREA TO PERIMETER RATIO Foundation Area: 138.50m<sup>2</sup>

2.59

and recommendations in the site specific Geotech report.

Perimeter: Ratio:

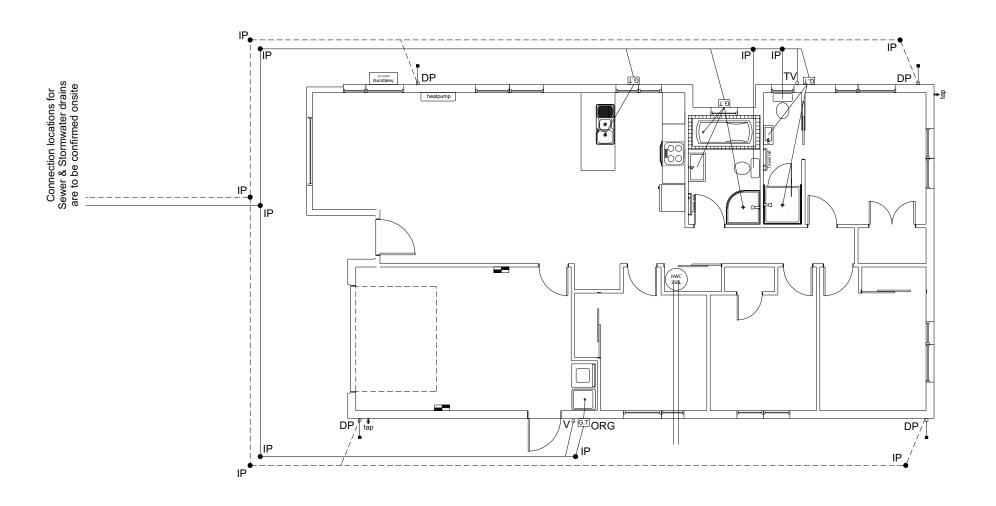


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M Glynn

Plumbing Schedule NZBC G13 BC230421 Kitchen Ø50mm @1:40 Sink: (3 discharge units) Bathrooms Vanity: Ø40mm @ 1:40 (1 discharge units per basin) Shower: Ø40mm @1:40 (2 discharge units) Bath: Ø40mm @1:40 (4 discharge units) Ø100mm @1:40 Ø40mm @1:30 NZBC G13 WC: (4 discharge units) Laundry Sink: Drainage Schedule Main Foulwater (5 discharge units) Ø100mm @1:60 Ø100mm @1:60 (1:120max) Ø80mm Vented Drain Stormwater Drain Terminal Vent Drain over DP Heatpump Overflow Relief Gully ORG to be positioned so the top of gully dish is no less than 150mm below overflow level of lowest fixture Sewer and Stormwater to connect to existing connections. All plumbing and drainage to comply with NZBC G13. All drains passing through concrete, provide sleeve or wrap in durable and flexible to allow for expansion and contraction. (as per G13/AS2 5.8.1)
HWC: Safe tray to HWC with 50mm overflow drain to exterior to comply with G12/AS1.

#### DRAINAGE LEGEND

Stormwater DN100mm uPVC Sewer Drain DN100mm uPVC Downpipe GT ORG TV AAV Gully Trap Overflow Relief Gully Terminal Vent Air Admittance Valve Inspection Point

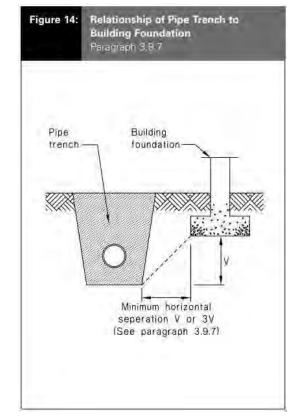

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Job N	umber:	Original Plan:	5	Sheet Name:
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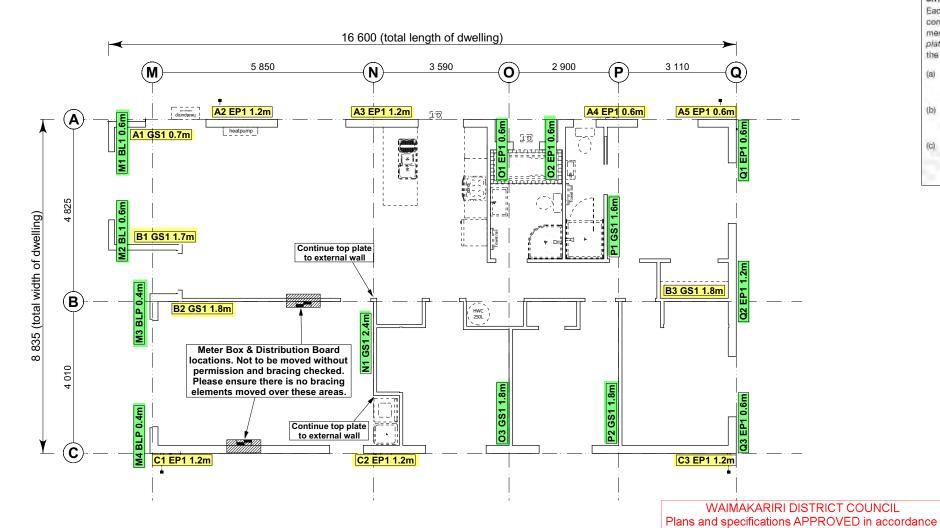
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1 04-04-2023 Initial Consent Plans

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**CONSENT PLANS** Sheet No.: 10 of 24 sheets

#### CONSENT ISSUED BC230421 - Page 18 of 31



#### 8.7.3.4

Each wall that contains one or more wall bracing elements shall be connected at the top plate level, either directly, or through a framing member in the line of the wall, to external walls at right angles to it. Top plate fixing(s) of the capacity in tension or compression along the line of the wall bracing element are given as follows:

- (a) For each wall containing wall bracing elements with a total bracing capacity of not more than 125 bracing units: to at least one such external wall by a fixing as shown in figure 8.16 of 6 kN capacity;
- (b) For each wall containing wall bracing elements with a total bracing capacity of not more than 250 bracing units: to at least 2 external walls by fixings as shown in figure 8.16 each of 6 kN capacity;
- (c) For each wall containing wall bracing elements with a total bracing capacity of more than 250 bracing units: to at least 2 external walls by fixings as shown in figure 8.16 each having a rating of not less than 2.4 kN per 100 bracing units.

#### BRACING PLANENO 12580 421

Wall bracing designed in accordance with NZS 3604:2011 & GIB Ezybrace system Refer to attached calculations.

Bracing Designed to: Wind: High Earthquake: 2

# BRACING LEGEND A Brace Line Label Brace Length Brace Type Brace Number

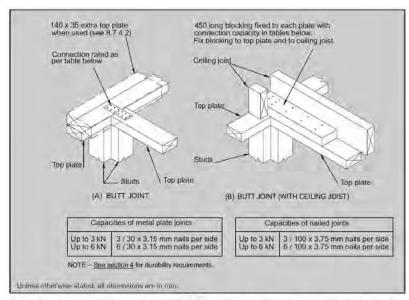


Figure 8.16 - Connecting top plates to external walls at right angles - Walls containing bracing (see 8.7.3.4)

#### Single Level Along Resistance Sheet Job Name: Shaw & Anderson EQ Wind 455 833 Achieved (BUs) 273% 155% 0.70 2.4 GS1-N 1.20 2.4 EP1 1.2 162 1,20 2.4 EP1 1.2 0.60 2.4 EP1 0.6 Ecoply® 63 EP1 0.6 443 OK 491 OK 1.80 2.4 GS1-N GIB® 124 366 OK 318 OK 2,4 1.20 EP1.1.2 Ecoply® 144 162 432 OK 486 OK

Job N	ame: Shaw	& Anders	on						Wind	EQ
									Den	nand
									547	833
									Acn	eved
Line	Element	Length	Angle	Stud HI	Type	Supplier	Wind	EQ	1112	1099
		(m)	(degrees)	(m)	1		(BUs)	(BUs)	131%	132%
	4-17-19	0.60		2.4	BL1-H	GIB@	59	61		
	- 2	0.60		2.4	BL1-H	GIB®	59	61		
M	3	0.40		2.4	BLP-H	GIB®	48	54		
	4	0.40		2.4	BLP-H	GIB@	48	54		
									215 DK	229 0
N	1-	2.40		2.4	GS1-N	GIB®	166	144		
14									166 OK	144 QF
	- 1	0.60		2.4	EP1 0.6	Ecoply®	57	63		
0	2	0.60		2.4	EP1 0.6	Ecoply®	57	63		
U	3	1,80		2.4	GS1-N	GIB®	124	108		
									238 OK	234 OH
-	- HE	1.60		2.4	GS1-N	GIB®	110	96		
P	2	1.80		2.4	GS1-N	GIB®	124	108		
									235 OK	204 OF
	1	0,60		2.4	EP1 0.6	Ecopty®	57	63		
0	2	1,20		2.4	EP1 1,2	Ecoply®	144	162		
Q	3	0.60		2.4	EP1 0.6	Ecoply®	57	63		

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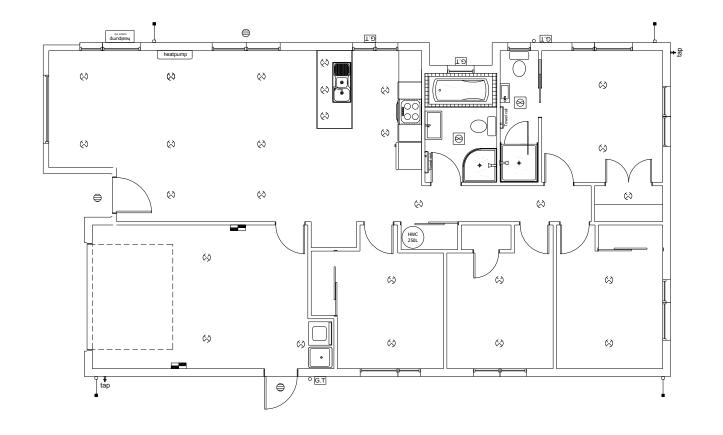
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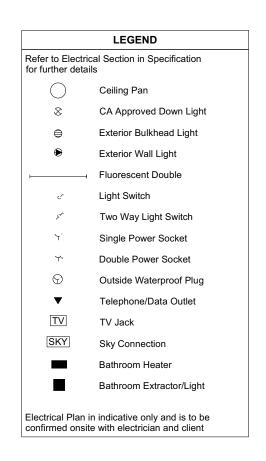
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Job Number:	0	Original Plan:	Sheet Name:			Sheet No.:		
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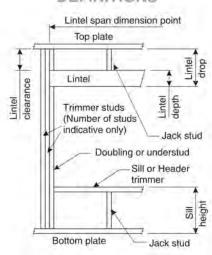
# LINTEL FIXING SCHEDULE

#### **ALTERNATIVE TO TABLE 8.14 & FIGURE 8.12** NZS 3604:2011

#### NOTE:

- \* All fixings are designed for vertical loads only. Dead loads include the roof weight and standard ceiling weight of 0.20kPa.
- Refer to Table 8.19 NZS 3604:2011 for nailing schedule to resist horizontal loads.
- \* These fixings assume the correct choice of rafter/truss to top plate connections have been made
- \* All fixings assume bottom plate thickness of 45mm maximum. Note: TYLOK options on timber species.
- \* Wall framing arrangements under girder trusses are not covered in this schedule.
- \* All timber selections are as per NZS 3604:2011.

#### DEFINITIONS




Li	ntel Sup	porting	Girder	Trusses		
Roof Tributary	L	ight Roo	of	He	eavy Ro	of
Area	V	ind Zon	ie	V	lind Zor	e
	L, M, H	VH	EH	L, M,	VH	EH
8.6m <sup>2</sup>	G	G	Н	G	G	Н
11.6m²	G	Н	H	G	G	H
12.1m <sup>2</sup>	G	Н	Н	G	Н	Н
15.3m²	н	Н		G	Н	Н
19.1m²	H		-0	G	Н	- 3
20.9m <sup>2</sup>	н	4.0		н	Н	15
21.8m²	н	2-1	-	н	29	-
34.3m <sup>2</sup>	0.07		-	н	31	

#### NOTES:


- 1. Roof Tributary Area = approx. 1/2 x (Total roof area on girder and rafter trusses supported by lintel)
- 2. Assumed girder truss is at mid-span or middle third span of lintel
- 3. Use similar fixings for both ends of lintel
- 4. All other cases require specific engineering design


Lintel	Loaded			nd Z					avy F		
Span (m)	Dimension (m) (See Fig. 1.3 NZS 3604:2011)	L	м	н	VH	ĖН	L.	М	н	VH	EH
	2.0	E	Е	E	F	F	E	E	E	E	F
	3.0	E	E	F	F	F	E	E	E	F	F
1.0	4.0	E	F	F	F	G	E	E	E	F	F
110	5.0	Ē	F	F	G	G	E	E	F	F	G
	6.0	Ē	F	F	G	G	E	E	F	F	G
	2.0	E	E	F	F	F	Ē	E	E	F	F
	3.0	E	E	F	F	F	E	E	F	F	F
1.2	4.0	E	F	F	G	G	E	E	F	F	G
1.12	5.0	E	F	F	G	G	E	E	F	F	G
	6.0	F	F	G	G	H	E	E	F	G	G
	2.0	E	E	F	F	F	Е	E	E	F	F
	3.0	E	F	F	F	G	E	E	F	F	F
1.5	4.0	E	F	F	G	G	E	E	F	F	G
	5.0	F	F	G	G	H	E	E	F	G	G
	6.0	F	F	G	H	H	E	E	F	G	H
	2.0	E	F	F	F	G	E	E	F	F	F
	3.0	E	F	F	G	G	E	E	F	F	G
2.0	4.0	F	F	G	G	H	E	E	F	G	G
	5.0	F	F	G	H	Н	E	E	F	G	H
	6.0	F	G	G	Н	Н	E	F	G	Н	Н
	2.0	E	F	F	G	G	E	E	E	F	G
	3.0	F	F	G	G	Н	E	E	E	G	G
2.4	4.0	F	F	G	H	Н	E	E	F	G	Н
	5.0	F	G	G	H	Н	E	E	G	H	H
	6.0 2.0	E	G	H	G	G	E	F	F	H	H
	3.0	F	F	G	Н	Н	E	E	E	G	Н
3.0	4.0	F	G	G	H	Н	E	F	G	Н	H
0.0	5.0	F	G	Н	Н	14	Ē	E	G	н	Н
	6.0	F	G	н	-		E	P	G	н	-
	2.0	F	F	G	G	Н	E	E	F	G	G
	3.0	F	F	G	Н	H	E	F	G	G	Н
3.6	4.0	F	G	H	H	4.	E	F	G	Н	Н
7.00	5.0	F	G	H	1	12.	E	F	G	H	
	6.0	G	H	Н	-6.		E	F	H	1.2	
	2.0	F	F	G	G	H	E	E	F	G	G
	3.0	F	G	Н	H		E	F	G	H	H
4.2	4.0	F	G	H	- 21	•	E	F	G	H	
	5.0	G	H	Н	140	*	E	E	H	-	-
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	2.0	F	F	G	Н	Н	E	E	E	G	Н
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4.5	3.4	F	G	H	Н		E	E	G	H	Н
	4.0 5.0	F	GH	Н			E	F	GH	H	
	6.0	G	Н		-		E	F	Н		
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	2.0	F	F	G	Н	Н	E	F	G	G	H
	3.0	F	G	H	Н	-	E	F	G	Н	H
5.1	3.5	F	G	H	18.1		E	F	G	H	
5.1	4.0	G	G	Н			E	F	H	H	
	5.0	G	Н	1	1	1.30	E	E	H	. 4	1.4
	6.0	G	H	Ud.	18.		E	G	H	-	-
	2.0	F	F	G	Н	Н	E	F	G	G	H
	2.8	F	G	Н	Н		E	F	G	H	H
5.4	3.0	F	G	Н			E	E	G	H	-
MC7	4.0	G	H	Н	*		E	F	H	*	-
	5.0 6.0	G	H	3	9		E	F	H	1	-
						190					4

#### LINTEL FIXING OPTIONS

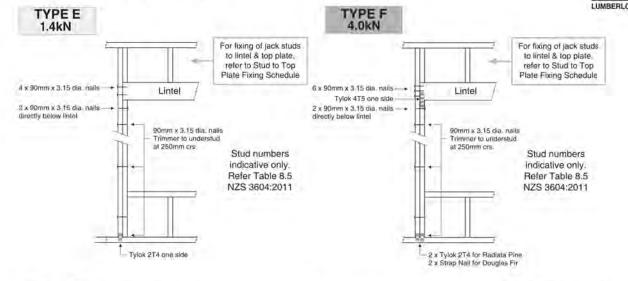

BC21

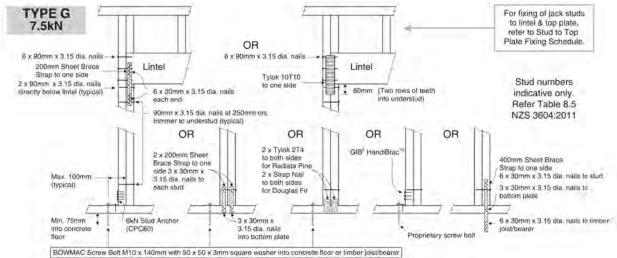

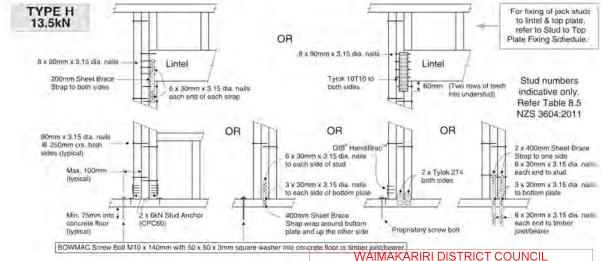

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Building Code (NZBC). Where detail it required for construction

Job Numb	er:	Ori	iginal Plan:	Sheet	Name:			C	ONSENT PLANS	Sheet No.:
1313	71		Snipe	FRAMING	DETA	AILS	No. 1	Date: 04-04-2023	Reason: Initial Consent Plans	13
Sales: R Gould	Drawn:		QS: E Gould	Print Date: 4/04/2023	Scale: NTS	@ A3				of 24 sheets




#### STUD TO TOP PLATE FIXING SCHEDULE

#### ALTERNATIVE TO TABLE 8.18 NZS 3604:2011

#### NOTE:

- \* All fixings are designed to resist vertical loads only. Dead loads include the roof weight and standard ceiling weight
- ★ Refer to Table 8.19 NZS 3604:2011 for nailing schedule to resist lateral loads.
- \* These fixings assume the correct choice of rafter/truss to top plate connections have been made.
- \* For gable end walls where the adjacent rafter/truss is located within 1200mm and with a maximum verge overhang of 750mm, select stud to top plate fixing using a loaded dimension of 1.5m.
- All fixings assume top plate thickness of 45mm maximum.
- \* Wall framing arrangements under girder trusses are not covered in this schedule.
- \* All timber selections are as per NZS 3604:2011.

#### LOADED DIMENSION DEFINITION

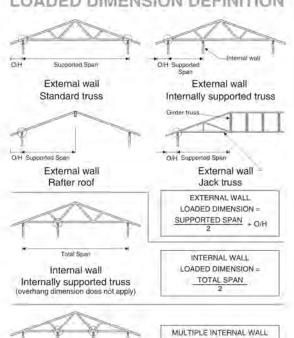

#### FIXING SELECTION CHART

Multiple internal walls


(Suitable for walls supporting roof members at 600, 900 or 1200mm crs.) Wind Zones L, M, H, VH, EH, as per NZS 3604:2011

Loaded Dimension (m) Stud Centres				Light Roof Wind Zone				Heavy Roof Wind Zone				
300mm	400mm	600mm	L	M	Н	VH	EH	L	M	H	VH	EH
3.0	2.3	1.5	Α	Α	В	В	В	Α	Α	В	В	В
4.0	3.0	2.0	Α	Α	В	В	В	Α	Α	В	В	В
5.0	3.8	2.5	Α	В	В	В	В	A	Α	В	В	В
6.0	4.5	3.0	Α	B	В	В	В	A	Α	В	В	В
7.0	5.3	3.5	Α	В	В	В	В	Α	Α	В	В	В
8.0	6.0	4.0	Α	В	В	В	В	A	Α	В	В	В
9.0	6.8	4.5	В	В	В	В	В	Α	A	В	В	В
10.0	7.5	5.0	В	В	В	В	В	Α	Α	В	В	В
11.0	8.3	5.5	В	В	В	В	В	Α	Α	В	В	В
12.0	9.0	6.0	В	В	В	В	В	A	Α	B	В	В

#### FIXING OPTIONS

#### **FIXING TYPE A** 0.7kN

2 x 90mm x 3.15 dia, plain steel wire nails driven vertically into stud.

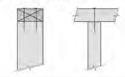

#### FIXING TYPE B CHOOSE ANY OF THE 3 OPTIONS BELOW

2 x 90mm x 3.15 dia, plain steel

2 x 90mm x 3.15 dia. plain steel wire nails driven vertically into stud.



wire nails driven vertically into stud.



2 x LUMBERLOK CPC40

Recommended for internal wall options to avoid lining issues.

2 x 90mm x 3.15 dia. plain steel wire nails driven vertically into stud.

LUMBERLOK

6kN Stud Anchor



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To calculate the number of B type fixings required, divide the wall length by the stud centres, add 1 to this figure and locate this number of fixings as evenly as possible along the wall length. This figure includes the start and end studs in each wall length.



SCAN FOR INSTALLATION VIDEO

https://vimeo.com/117353604

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Penny Shaw & Stuart Anderson Lot 660

Ravenswood, Woodend

34 Higgins Street

# 131371

## Original Plan: Snipe

#### FRAMING DETAILS Print Date NTS

#### **CONSENT PLANS** Sheet No. Date: Reason: 04-04-2023 Initial Consent Plans 14 of 24 sheets

# Max. Cavity Stud Screw Tie Long Screw Tie Short

(105mm)

90 SERIES BRICK BC230421

 All brick work must be constructed in accordance with NZS 4210:2001 Masonry Construction: Materials and Workmanship. Screw Ties must be applied accordingly and are not to be hammered into timber framing.

Water shedding shoulder prevents transfer of the moisture from tie to building.

- Nail hole for Oamaru Stone.

Angled neck encourages increased tie embedment in mortar.

1.2mm NZCC-SD Hot Dip Galvanised Steel

Type 17-12g x 35mm Hex Head Hot Dip Galvanised Screws

250 ties per box including screws

70 SERIES BRICK

Max. Cavity 50

Stud

Also available in Stainless Steel Grade 316 for Zone D.

#### SCREW TIES

#### FOR BRICK VENEER FIXING

Medium duty (EM) classification


Tested by BRANZ in accordance with AS/NZS 2699.1:2000

BRANZ test report No. ST0725 November 2007

 Suitable for both 'dry bedding' and encapsulated mortar Hot Dip Galvanised ties for Zones B & C, and Stainless Steel Grade 316 ties for

Zone D meet NZS 3604:2011 Sect. 4 Durability

Available in 85mm and 105mm sizes

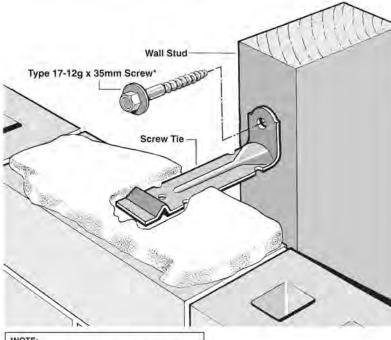


Use longer screws for fixing through Rigid Air Barrie (RAB). Maintain 35mm embedment in studs




General window and door opening with drainage cavity Paragraphs 9 1.5, 9.1.9.3, 9.1.10.2, Figures 73C, 76, 85, 86, 91, 99, 116 and 128


- (1) Detailed cladding omitted for clarity, refer to specific claddings.
- (2) Head to be treated similarly with continuous wall underlay and flexible tape at corners.
- (3) Refer Individual cladding details for jamb flashings.

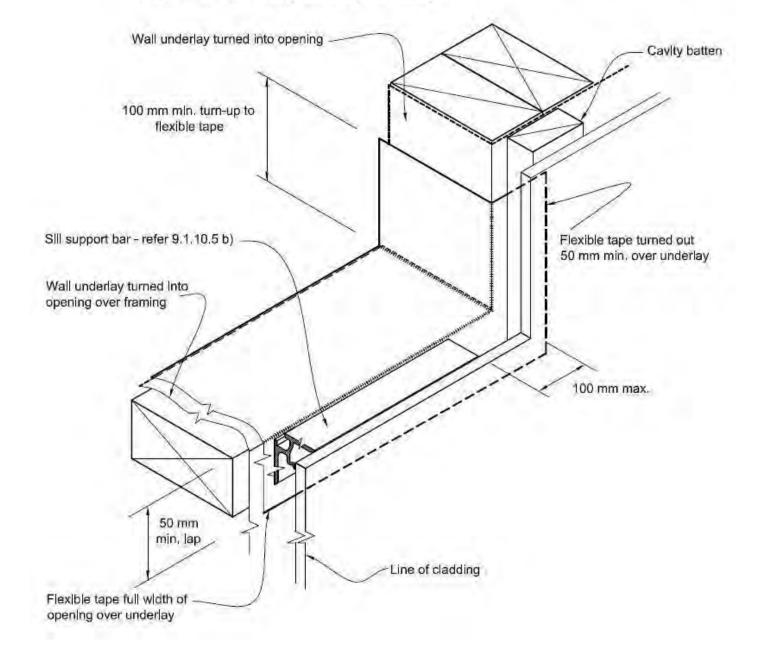

Where windows extend to soffit, flashing tape is to be fixed prior to ribbon board being fixed to framing.

Detail Tape Location to Wall Openings

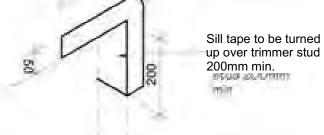

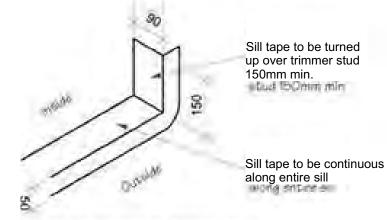

Trim all building wrap to finish flush with inside face of stud frame wall

Sill Tape Flashing Detail

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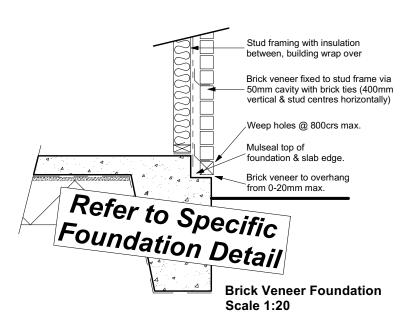
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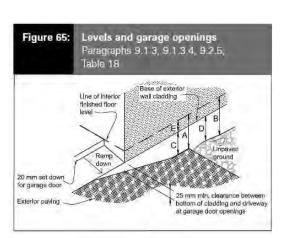
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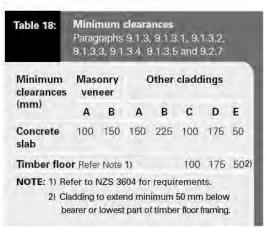
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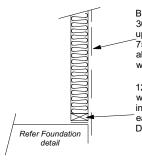
Job Number: <b>131371</b>		Original Plan: <b>Snipe</b>	CONS	neet Name: TRUCTION ETAILS	
ales:	Drawn:	QS:	Print Date:	Scale:	
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**CONSENT PLANS** Sheet No.: Date: Reason: 04-04-2023 Initial Consent Plans 15 of 24 sheets












Building wrap staple fixed to studframe @ 300crs max, wrap to be fixed horizontally with upper sheets to lap over lower sheet, allow 75mm cover min. End laps to be over stud, allow 150mm min lap (Support building wrap with Polypropylene tape at 300 mm centres)


125mm x 12mm thru bolt with 50mm square washer at 900mm crs on all external walls and interior load bearing walls (Bolts also 150mm for each end of bottom plate) minimum cover 40mm. DPC between bottom plate & floor slab.

### Stud framing to slab Scale 1:20

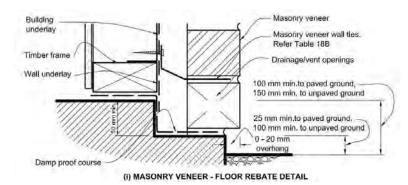

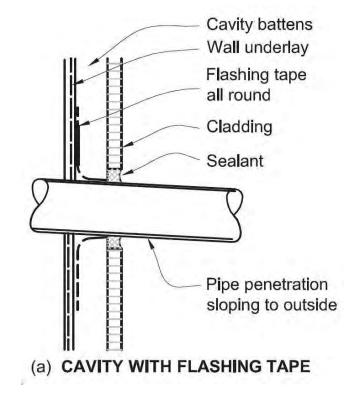

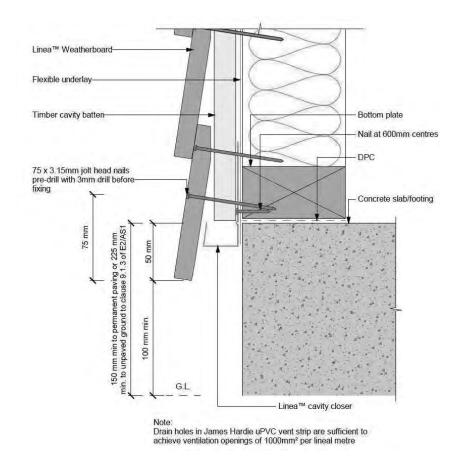

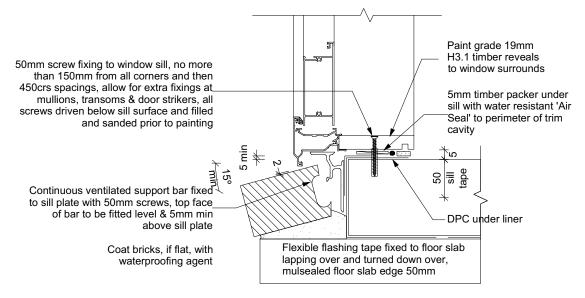

#### Door Sill to Slab Detail

Scale 1:20/AIMAKARIRI DISTRICT COUNCIL
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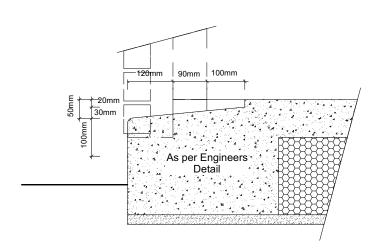
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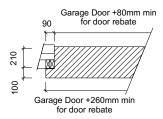
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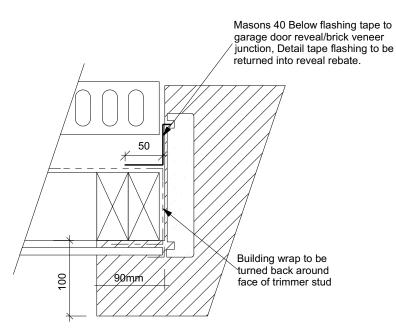
Penny Shaw & Stuart Anderson Lot 660 34 Higgins Street Ravenswood, Woodend

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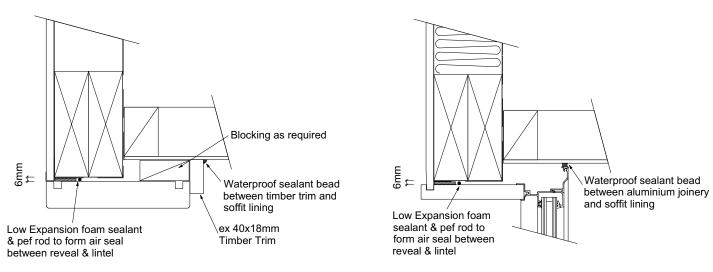


**Garage Door Rebate Details Scale 1:10** 





**Garage Door Jamb Detail** Scale 1:5




#### **Garage Door Head to Soffit** Scale 1:5

#### **Window Head to Soffit Detail** Scale 1:5

#### 9.1.10.8 Attachments for windows and doors

Install windows and doors using pairs of minimum 75 x 3.15 galvanised jolt head nails or 8 gauge x 65 mm stainless steel screws, through reveals into surrounding framing at:

- a) Maximum 450 mm centres along sills, jambs and heads, and
- b) Maximum 150 mm from reveal ends. Install packers between reveals and framing at all fixing points, except between head

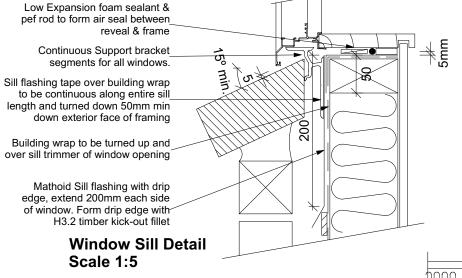


Low Expansion foam sealant & pef rod to form air seal betweenreveal & frame Building wrap to be turned round trimmer stud to window opening

150mm wide Malthoid Jamb flashing to each side of window

Line of head and sill flashings extended 200mm each side of opening

> **Window Jamb Detail** Scale 1:5

min

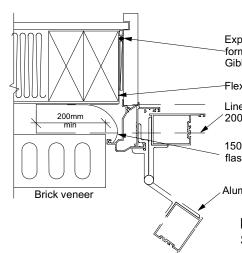

Expandable foam sealant on pef rod to form air seal between cavity system and

Flexible flashing tape in corners

Line of head and sill flashings extended 200mm each side of opening

150mm wide Malthoid Jamb flashing to each side of window

Aluminium door

reveals and lintels.

**Door Jamb Detail** Scale 1:5

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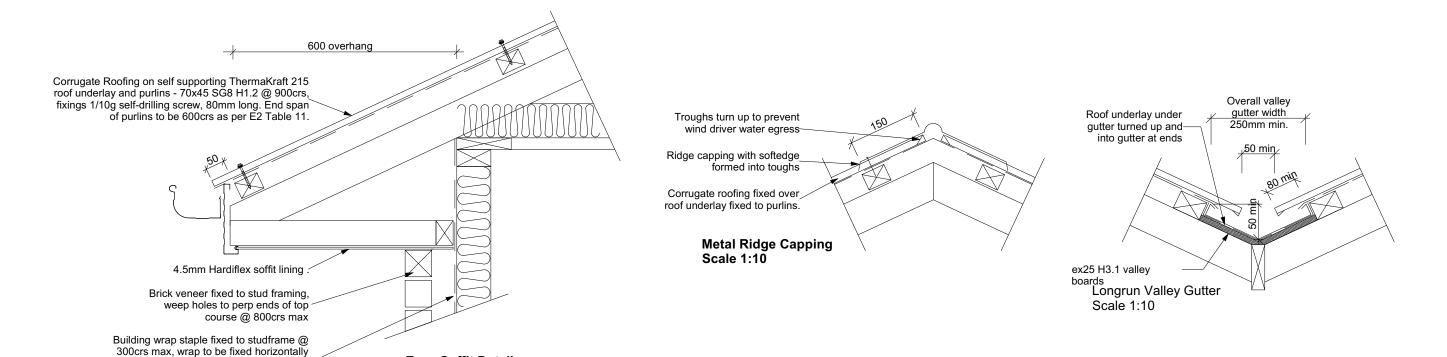
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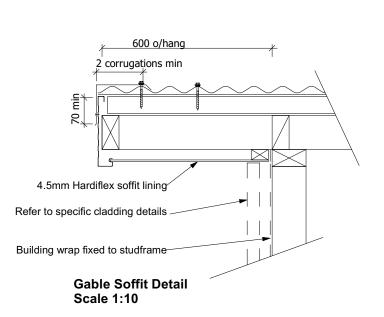
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Sheet Name Original Plan: **CONSTRUCTION** Snipe 131371 **DETAILS** Print Date As Shown @ A3


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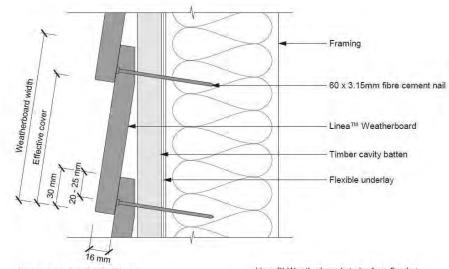




with upper sheets to lap over lower sheet, allow 75mm cover min. End laps to be

over stud, allow 150mm min lap



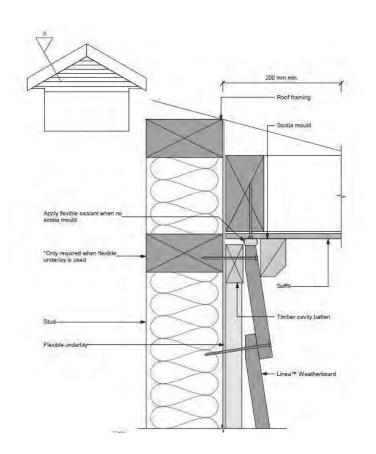

Concealed Nailing

Linea™ Weatherboards to be face fixed at corners and down window and door openings using jolt head nails at 90° to face, punch 2mm below surface and fill. Refer to fixing table 4

Note: Alternatively the scotia can be scribed and sealed to Linea™ Weatherboard and the soffit lining

For soffits more than 200mm the Linea™ Weatherboard can be neat cut and silicone sealed to angle of soffit

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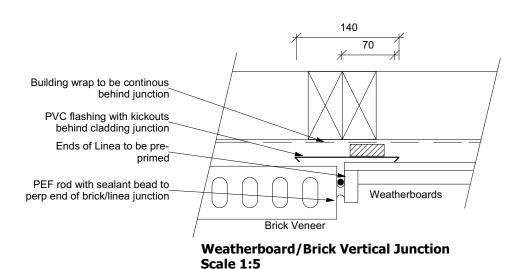
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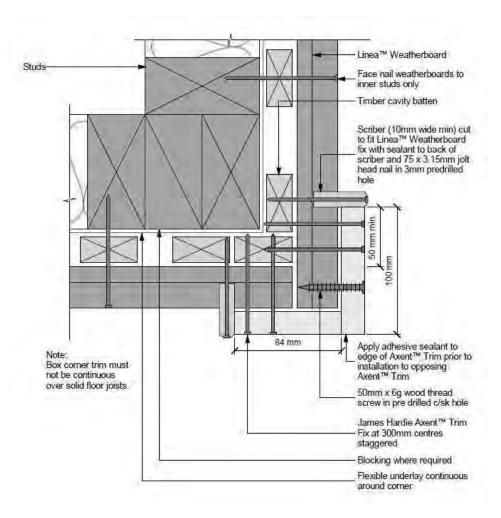
**Eave Soffit Detail** 


**Scale 1:10** 


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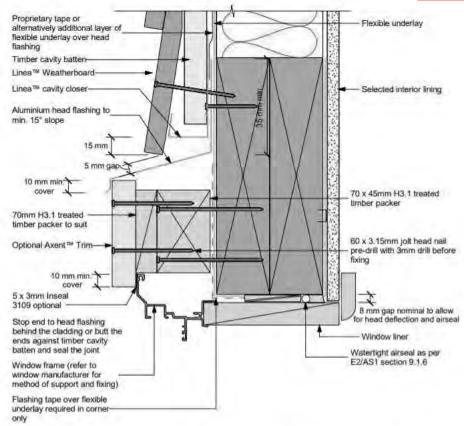
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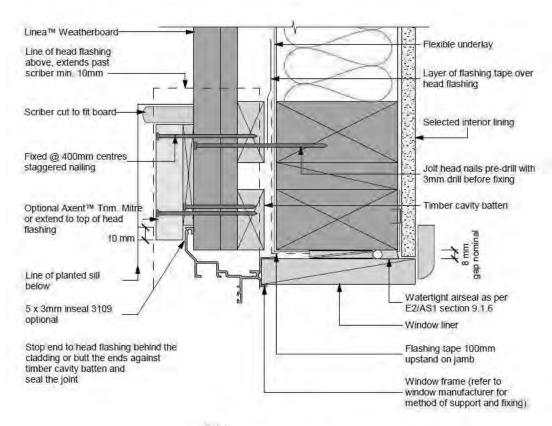
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**CONSENT PLANS** Sheet No.: Date: Reason:
04-04-2023 Initial Consent Plans 19 of 24 sheets


Linea™ Weatherboard-



- Sealant must be installed between head flashing and window flange in VH and EH wind zones and SED pressures
   Alternatively, the head flashings can be formed with stop ends as per E2/AS1
- Refer to Figure 22 for sealing end battens to head flashing

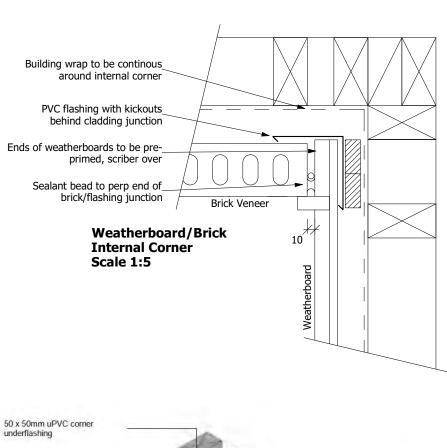

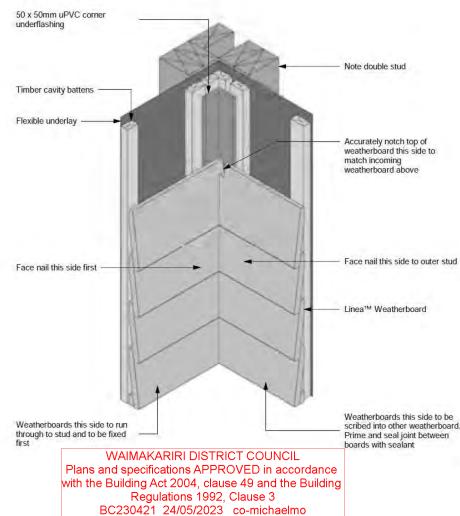· Site cut edges to be primed

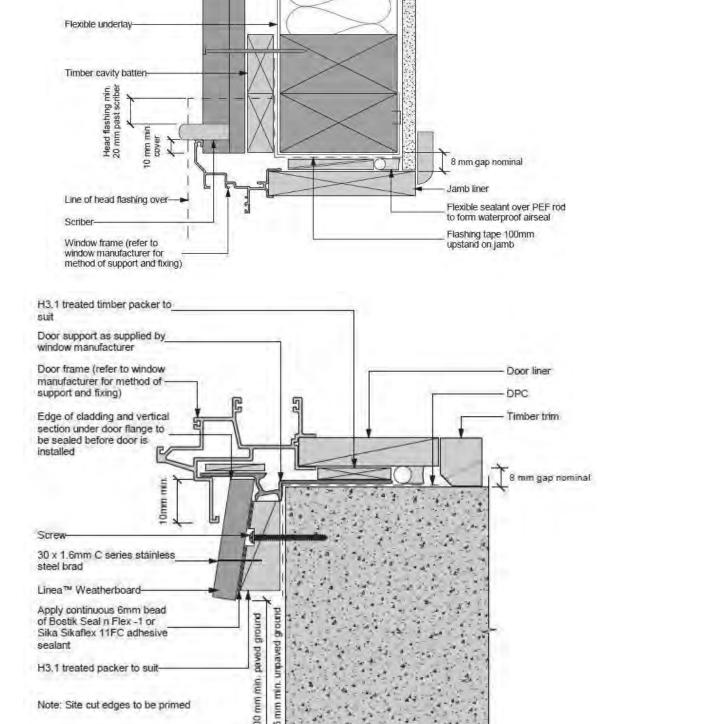

Refer to the manufacturer or supplier for technical information for these materials

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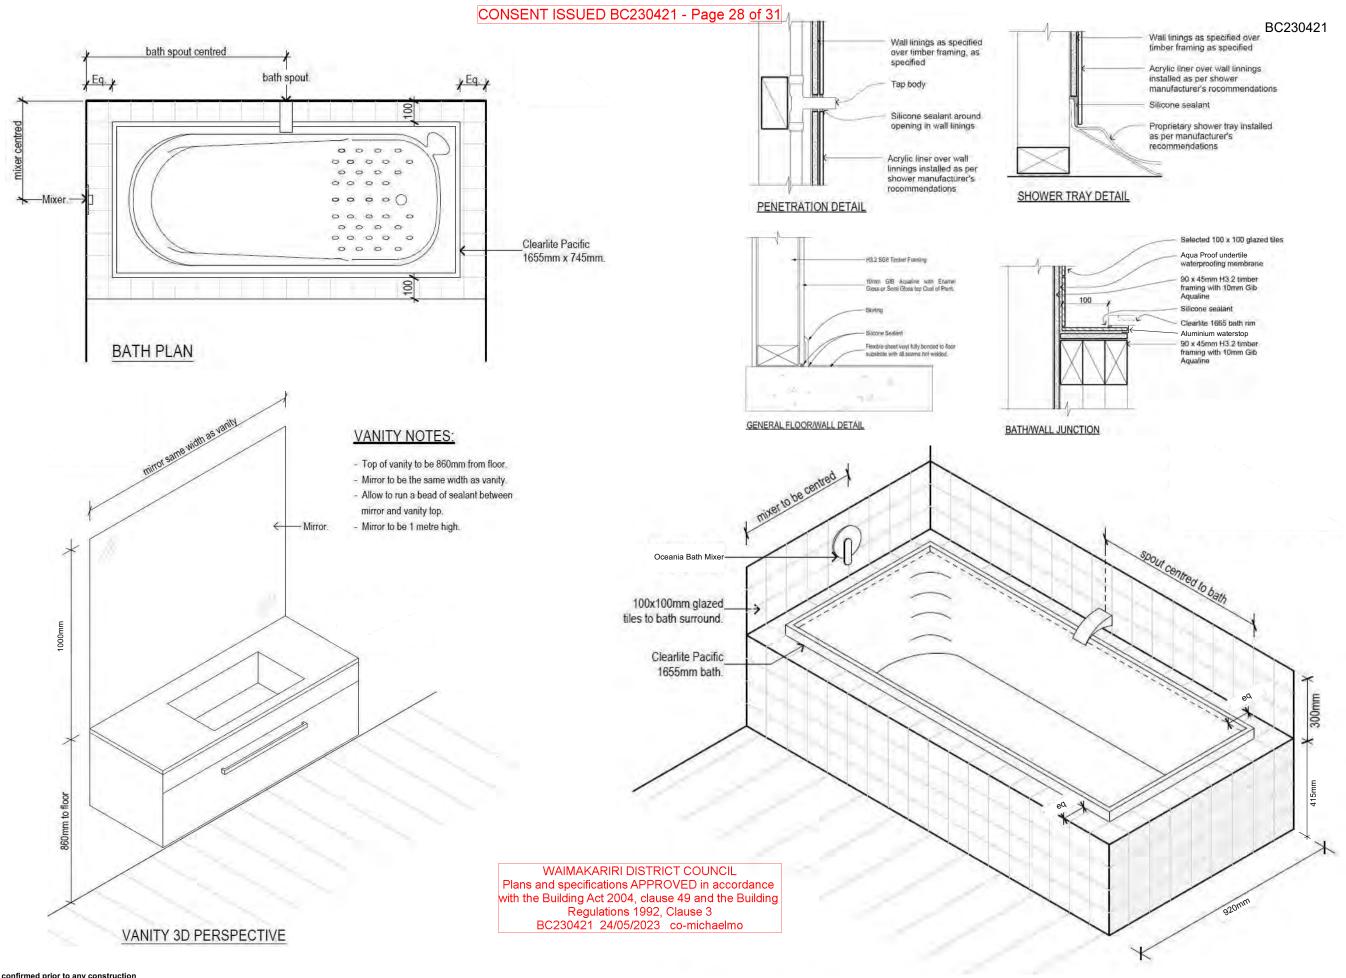
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Sheet No.:

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of 24 sheets




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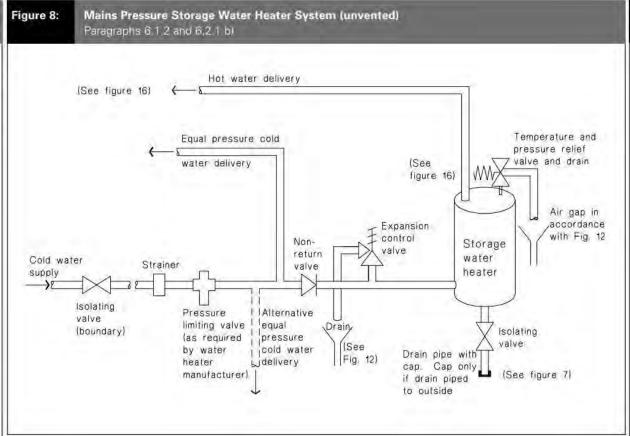
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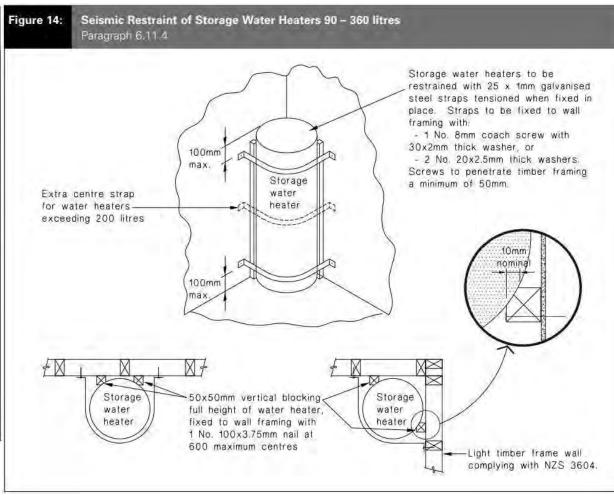
Christchurch 8443 P: +64 3 342 7788 These drawings are limited to and by the extent of the detail covered in the drawings to meet the current New Zealand Building Code (NZBC). Where detail it required for construction and to demonstrate compliance with the current NZBC, a specific request should be made for the required detail to be supplied. No liability will be accepted for any detail or construction not covered in these drawings and/or carried out by persons other than the designer producing these documents.

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Sales: R Gould	Drawn:	QS: E Gould	Print Date: 4/04/2023	Scale: NTS	@ A3				of 24 sheets





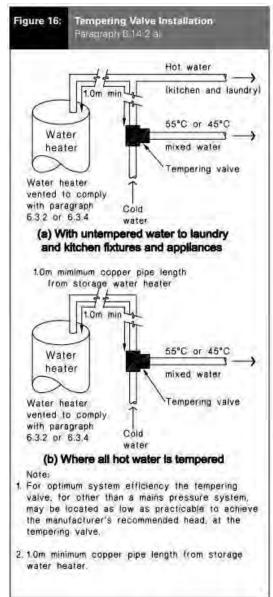

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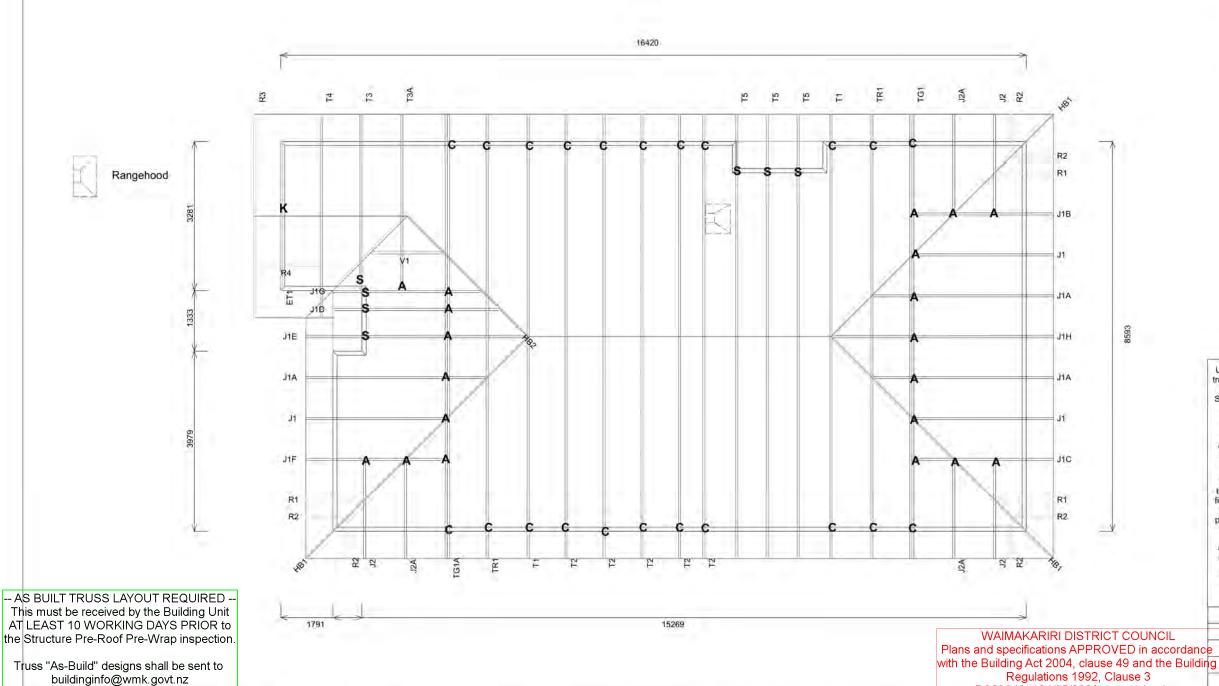
Job Number: <b>131371</b>		Original Plan:	She	Sheet Name:			CONSENT PLANS		
		Snipe	PLUMBIN	PLUMBING DETAILS		No. 1	Date: Reason: 04-04-2023 Initial Consent Plans		22
	Drawn: M Glynr	QS: E Gould	Print Date: 4/04/2023	Scale: NTS	@ A3				of 24 sheet

# **Buildable Consent** Layout

FTMA

For valley/saddle truss fixing unless stated otherwise use a pair of wire dogs at 900mm centres for up to and including a very high wind zone. Or a pair of CT200's at 900mm centres for extra high wind zone. This fixing is to meet the minimum requirements as per NZS3604.

**Building Partner** 



Truss Fixings

A = 47x90 Joist Hanger

B = 47x120 Joist Hanger

C = CT200 (pair)

D = 47x190 Joist Hanger

E = 95x165 Joist Hanger

F = SH-140 Split Hanger

G = SH-180 Split Hanger

H = SH-220 Split Hanger J = 2x6kN Strap (12kN)

K = 6kN Strap

L = Multigrip (single)

M = Multigrips (pair)

N = Nailon Plate (240x110x1)

P = 16kN Pack

Q = 9kN Pack

S = CPC 40 Single Cleat

T = CPC 40 Short (pair)

U = CPC 80 Single Cleat

V = 16kN Uplift

Z = Engineers Design

truss fixings are to use L/Lok product nail fasteners or Type 17 - 14g Hex Head Screws (as per the MiTek On-site Guide)

All truss to frame fixings require 2 additional 2/90x3.15dia skew nails.

All truss fixings not indicated as above must have 2 wire dogs for cross joints and 2/90x3,15dia nails for butt joins.

Fixings shown are for fixing trusses to the top plate. Any other point load uplift fixings down through the framing stud to too plate, stud to bottom plate, bottom plate to floor remain the responsibility of the architect / draughtsman.

Any roof loads as stated on this layout over 16kN lift are outside the scope of NZS3604, and the architect / draughtsperson is responsible for the design to transfer the loads to the

ground. Snow Zone: Christchurch (N4)

Wind Area: High TC Restraints: 900 mm Roof Material: Galv Iron 0.55mm Roof Pitch: 25.00 100,000 m Snow Altitude: sign Wind Speed: 44.0 m/s BC Restraints: 600 mm Standard Plaster Ground Snow Load: 0.900 kPa

Truss Centres: 900 mm

Sheet No.

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Job No: CH1385142C1

Customer: TKR Homes Limited | T/A Signature Homes Canterbury

Job Name: Shaw Anderson Lot 660 Ravenswood Wooden

Address: Lot 660 Ravenswood Wooden

If a gable truss requires a windbeam brace, the type of MiTek brace will be noted as such on the layout. The truss fixings can be substituted for other fixings of the same or greater capacity All verge framing to be fixed according to the MiTek On-Site Guide if not covered by NZS3604. If bottom chord restraints are 35mm Metal battens, then they must be fixed with either two nails or screws.

If the metal battens are fixed with a single nail or screw then 90x45mm bottom chords restraints will be required at 1800mm centres

All loads shown on this page regarding the truss fixings are characteristic loads

sions are to be check and confirmed prior to any construction

Drawn

Date:

SAPPHIRE

Every Facet an Advantage

Marinor Reves

21/03/2023



TKR Homes Ltd. 31 Watts Road, Sockburn PO BOX 11 351 Christchurch 8443

P: +64 3 342 7788

These drawings are limited to and by the extent of the detail covered in the drawings to meet the current New Zealand Building Code (NZBC). Where detail it required for construction specific request should be made for the required detail to be supplied. No liability will be accepted for any detail or construction not covered in these drawings and/or carried out by persons other than the designer producing these documents

Penny Shaw & Stuart Anderson Lot 660 34 Higgins Street Ravenswood, Woodend

**CONSENT PLANS** Sheet Name: Original Plan: Snipe Date: Reason: 04-04-2023 Initial Consent Plans 131371 TRUSS DESIGN Print Date NTS

BC230421 24/05/2023 co-michaelmo


BC230421

**Buildable Consent** Layout


All internal walls shown on this layout are considered to be loadbearing Lintel fixing specification remains the responsibility of the architect / draughtsper



**Building Partner** 

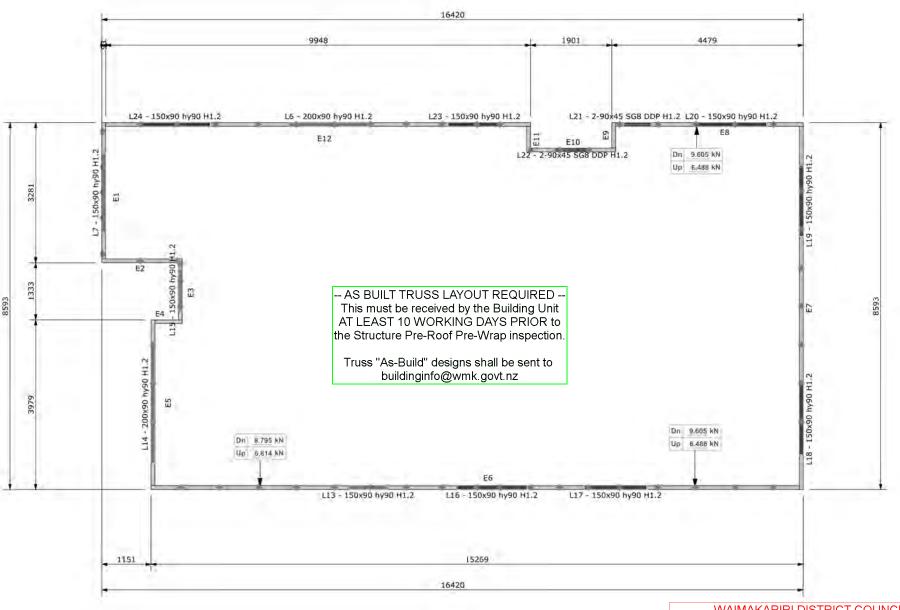

Lintel Fixings are as per the included reports.

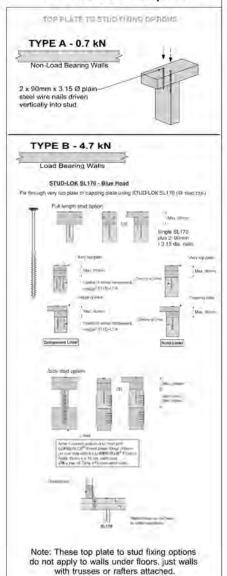

WAIMAKARIRI DISTRICT COUNCIL Plans and specifications APPROVED in accordance with the Building Act 2004, clause 49 and the Building Regulations 1992, Clause 3 BC230421 24/05/2023 co-michaelmo

The lintels have been sized using one of the following:

The MiTek SAPPHIRE Component Design Software. hy90, hyONE and hySPAN lintels have been sized using the designIT for houses - New Zealand series 6 software. GANGLAM and FLITCH BEAMS have been sized using the MiTek Beam Program V1.10 June 2011.

Unless otherwise stated the timber grade for all lintels is SG8. Lintels not shown are to be selected as per NZS3604: 2011 or designed by an engineer as required. The lintels have not been designed to support brick shelf angles. The Architect or Engineer is required to design all lintels supporting brick shelf angles.

SAPPHIRE Every Facet an Advantage

Drawn Marinor Reves Date: 21/03/2023

Job No: CH1385142C1

Customer: TKR Homes Limited | T/A Signature Homes Canterbury

Job Name: Shaw Anderson Lot 660 Ravenswood Wooden

Address: Lot 660 Ravenswood Wooden

standard slab), or the upward load is greater than 10kN. These loads are If no loads are shown, no thickening

Notification of point loaded lintels or point

loads on internal walls where the

downward load is higher than 8kN (85mm raft type slab) or 10kN (100mm

sions are to be check and confirmed prior to any construction

Plans are to be read in conjunction with Specifications and all supporting documentation



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Penny Shaw & Stuart Anderson Lot 660 34 Higgins Street

Ravenswood, Woodend

Original Plan: Snipe 131371

Print Date

Sheet Name: TRUSS DESIGN

NTS

**CONSENT PLANS** Date: Reason: 04-04-2023 Initial Consent Plans of 24 sheets

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