215 High Street Private Bag 1005 Rangiora 7440, New Zealand

Phone 0800 965 468

BC No: 230318

SITE DETAILS:

23 CHAMBERS AVENUE

WOODEND

LEGAL:

LOT 679 DP 585296

AS BUILT TRUSS LAYOUT REQUIRED -

This must be received by the Building Unit **AT LEAST** 10 WORKING DAYS PRIOR to the Structure Pre-Roof Pre-Wrap Inspection

Truss "As-Built" Designs may be sent to: buildinginfo@wmk.govt.nz

Approved Building Consent Documents and Plans (Full set)

On Site Copy

- These plans and specifications must be kept on site during construction, and made available to the building officer on request. Failure to do so will mean an automatic failure of the building inspection and will necessitate re-booking the inspection at the applicant's expense.
- All boundary survey pegs must be located and flagged by the owner before work is commenced.

Inspections

For bookings or building enquiries please phone the Building Unit on:

03 311 8906

or

Email inspection bookings to: bcbooking@wmk.govt.nz

- Please refer to your inspection schedule for details of inspections to be carried out.
- At least 2-3 full working days' notice should be given when booking an inspection.
- Please be advised that it may not always be possible to carry out the inspection within the time frame you require.
- Provision is to be made to allow access.
- The Code Compliance Certificate will be issued once the:
 - Final inspection has been carried out and passed.
 - Audit of WDC building consent file has been completed.
 - Payment of any outstanding invoices is received.



Signature Homes Ltd

New House

Lot 679 Ravenswood, Woodend

TC2 RIBRAFT DRAWINGS



File Number 23008.030

Sheet No.	Rev	Date Issued	Sheet Title
S1	-	07.03.2023	General Notes
S2	-	07.03.2023	RibRaft Layout Foundation Plan
S3	-	07.03.2023	Ribraft Details
S4	-	07.03.2023	Typical Services Penetration Details

Issue Register

Date Description

07.03.2023 Consent

WAIMAKARIRI DISTRICT COUNCIL
Plans and specifications APPROVED in accordance
with the Building Act 2004, clause 49 and the Building
Regulations 1992, Clause 3
BC230318 5/05/2023 co-michaelmo

CONSENT ISSUED BC230318 - Page 3 of 29

contractor shall verify all dimensions before commencing work BC230318

GENERAL

- These drawings are not to be used for construction until the plan (sheet S2) is signed by the main contractor.
- Do not scale. Refer any discrepancies to the Architect.
- These drawings are to be read in conjunction with the Architects drawings.
- The builder shall be responsible for any damage to works during construction.
- The sand blinding layer shall be 20mm min. & 50mm max. to aid levelling & to prevent rocking of pods.
- Vapour barrier to be 0.25mm (250 micron) polythene complying with NZS 4229 / NZS 3604.
- · Finished ground level adjacent to slab to be protected from wind, water erosion and undermining.

FOUNDATIONS

GEOTECHNICAL REFERENCE:

Ref. No: 23000.008

Bearing: 200KPa

Dated: 27 Feb 2023

Engco Consulting Engineers

Geotechnical Report

- For assumed allowable bearing capacity refer to calculations/installer guide. Unless otherwise noted in documentation.
- If there is any doubt about the integrity of the material on which the slab is to be founded -Supervising Engineer must be notified immediately.

· All workmanship & materials to conform to NZS 3109, NZS 4210 & local authority

- Minimum covers to reinforcement:
- Exposed to earth 75mm.

CONCRETE

- Protected by vapour barrier 50mm.
- Not exposed to weather except for a brief period during construction 25mm.
- No holes or chases other than those specified are to be made in the slab without the approval of Engco.
- All concrete shall have 20mm nominal maximum aggregate size & 120mm slump & shall comply with NZS 3109.
- All concrete to be mechanically vibrated & carefully worked around the reinforcement & into the corners of the formwork.
- Ribraft make-up to be

100mm Floor Slab - 220mm pods (25MPa TC2 Dramix 4D 80/60 Fibre Mix Concrete) G500E SE-62 Ductile mesh on 50mm chairs

The design Fibre mix shall be supplied so that the residual flexural tensile stresses f_{R,1} & f_{R4,K} shall be 1.5 MPa & 1.0 MPa respectively.

REINFORCEMENT

• All reinforcing shall be New Zealand sourced and conform to AS/NZS 4671 :2001 in grade 300 or grade 500E.

- All bends to be made cold without fracture.
- · All reinforcing shall be deformed type unless otherwise stated.
- Grade 500E deformed bars shall be designated 'H', Grade 300 deformed bars shall be designated 'D' and Grade 300 round bars shall be designated 'R'.

Minimum bar lap.		H12 bars	H16 bars
	L	720mm	900mm

- All reinforcement to be fixed & tied where necessary in its specified position.
- · Welding of steel is not permitted.
- Spacers:
- Edge at 1200mm ctrs (one on edge & two on corners, typically).
- Internal one on each side of pod (typically).
- All mesh shall comply with AS/NZS 4671 & shall conform with elongation requirements exceeding 10%.
- All mesh shall lap a minimum of 250mm (end extensions not included in lap length).

INSPECTIONS


Inform ENGCO consulting 48 hours in advance of any inspections required for code compliance certification.

Contact ENGCO - Ph. 03 366 7955 & quote ENGCO Ref. No.

INSPECTIONS REQUIRED

- 2. Contractor to supply (4) N.D. tests at mid height and finished compacted surface - if depth of fill is greater than 400mm


- 1. Confirm bearing at excavation by clients own Geotechnical Engineer
- 3. Pre-pour of slab by Engco

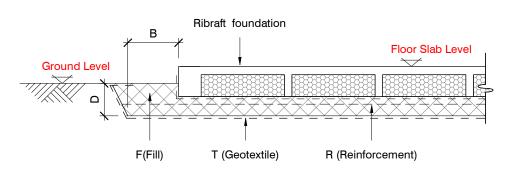

BUILDING PLATFORM

	BUILDING PLATFORM TABLE:								
В	500mm								
D	200mm bgl (approx) across building platform. Remove top soil and unsuitable fill								
Т	N/A								
R	N/A								
F	AP40 or AP65 - 95% Dry Density. Compact in 150mm layers max.								

Refer Architectural drawings for Finished Floor Level

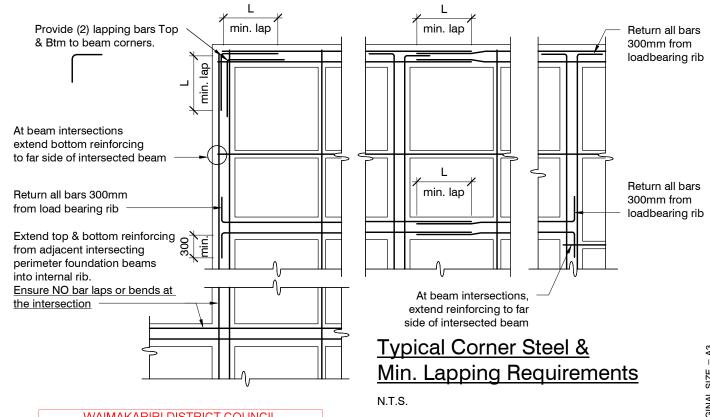

WAIMAKARIRI DISTRICT COUNCIL Plans and specifications APPROVED in accordance with the Building Act 2004, clause 49 and the Building Regulations 1992, Clause 3 BC230318 5/05/2023 co-michaelmo

07.03.2023 Consent





New House

Lot 679 Ravenswood, Woodend

General Notes

23008.030 N. Munro R. Houghton M. Cusiel appyd S1 March 2023


BC230318

Locations shown of internal floor beam thickenings are indicative only. It shall be the responsibility of the Contractor to ensure that they are located centrally under the load bearing walls to which they pertain.

Under no circumstance should pipework for services be run longitudinally in 100mm ribs. Similarly they should not be run along perimeter foundations nor internal floor beam thickenings

Vertical or horizontal penetrations through the foundation edge beam or floor beam thickenings must be made through the middle third of the member. Vertical penetrations should not be made through 100 mm ribs.


Refer to Architects drawings for floor slab, set downs, steps, rebates, holding down bolts, cast-in componentry and the like.

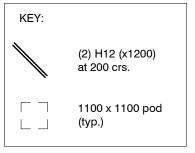

100mm Floor Slab - 220mm pods (25MPa TC2 Dramix 4D 80/60 Fibre Mix Concrete) G500E SE-62 Ductile mesh on 50mm chairs

The design Fibre mix shall be supplied so that the residual flexural tensile stresses f_{R,1} & f_{R4,K} shall be 1.5 MPa & 1.0 MPa respectively.


All Mesh shall lap a minimum of 250mm (end of extensions not included).

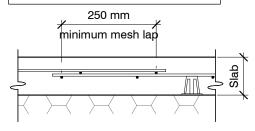

07.03.2023 Consent

design N. Munro R. Houghton M. Cusiel appyd

23008.030 S2

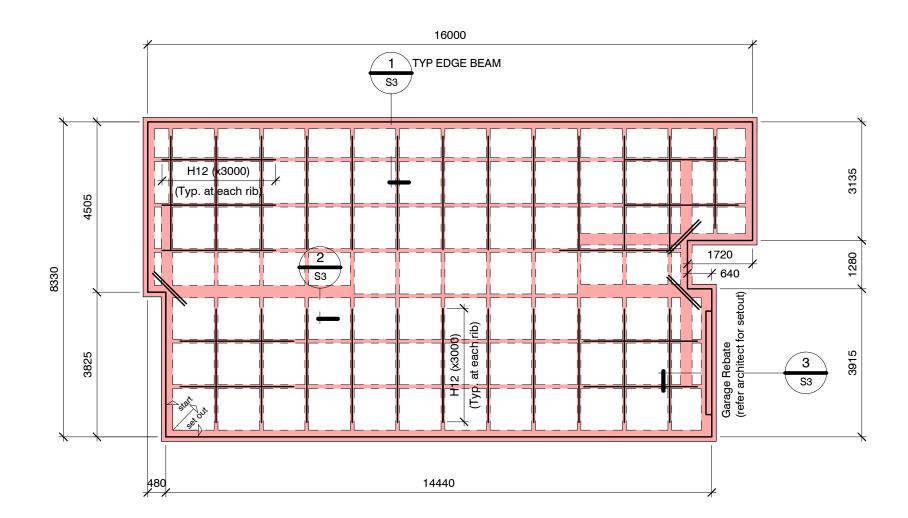

RIBRAFT FOUNDATION LAYOUT PLAN

Confirm all dimension with Architects drawings

WAIMAKARIRI DISTRICT COUNCIL Plans and specifications APPROVED in accordance with the Building Act 2004, clause 49 and the Building Regulations 1992, Clause 3 BC230318 5/05/2023 co-michaelmo


office@engco.nz **Consulting Engineers**




New House

Lot 679 Ravenswood, Woodend

RibRaft Layout Foundation Plan

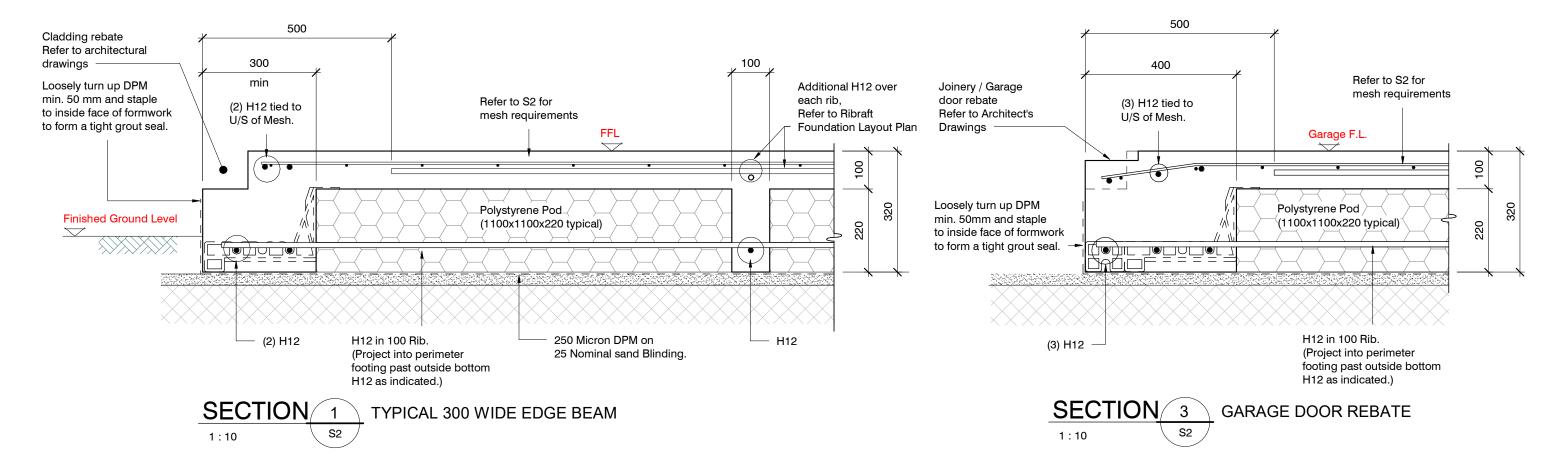

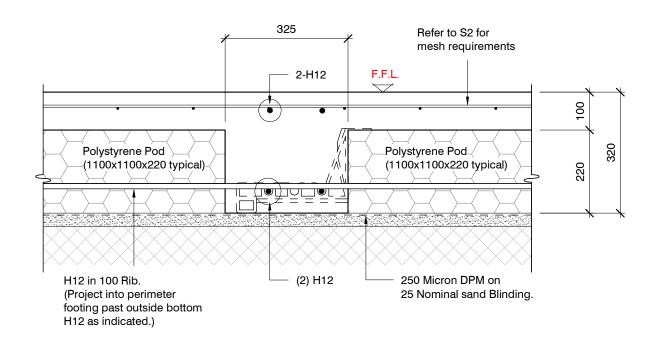

TYPICAL 300 WIDE INTERNAL BEAM

WAIMAKARIRI DISTRICT COUNCIL Plans and specifications APPROVED in accordance with the Building Act 2004, clause 49 and the Building Regulations 1992, Clause 3 BC230318 5/05/2023 co-michaelmo

> 23008.030 design N. Munro Ribraft Details R. Houghton

03 366 7955 office@engco.nz **Consulting Engineers**



SECTION/

1:10

2

New House

Lot 679 Ravenswood, Woodend

AUCKLAND | CHRISTCHURCH | NELSON | QUEENSTOWN

07.03.2023 Consent

M. Cusiel appyd March 2023


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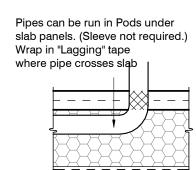
(2) H12


Bars at


800

Equal centres



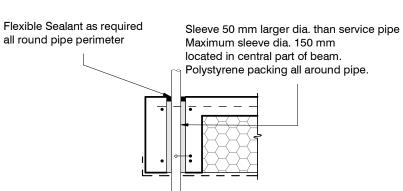

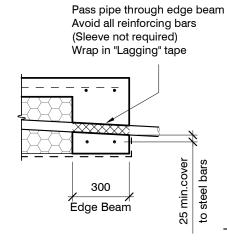

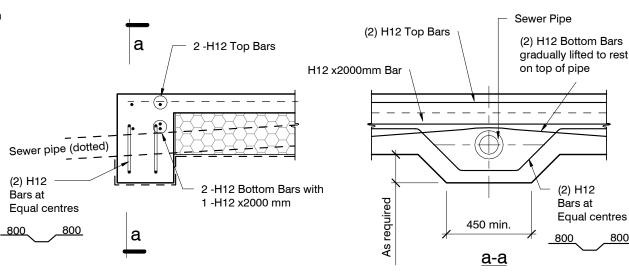


SLAB SERVICES PENETRATION DETAIL

PIPE NOTE:


No separation required where pipes are fully contained within slab. Sleeve all drains that pass through the base of the slab.

PENETRATIONS NOTE: Where penetrations through Floor Slab exceed 450 mm Square, Crack Control Bars will be required.

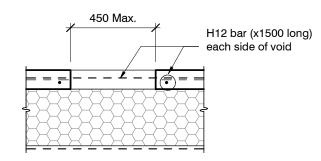

TYPICAL SECTION LOCALISED DEEPENING OF FOUNDATION BEAM TO ACCOMMODATE TOILET WASTE PIPE

LARGE SLAB PENETRATION DETAIL

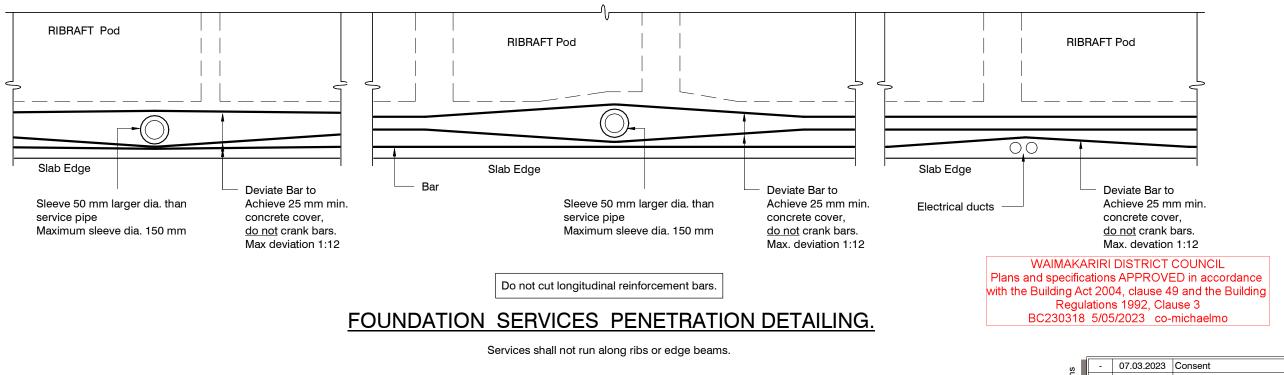






New House

Lot 679 Ravenswood, Woodend

Typical Services Penetration Details

23008.030 N. Munro R. Houghton M. Cusiel appyd **S4** March 2023

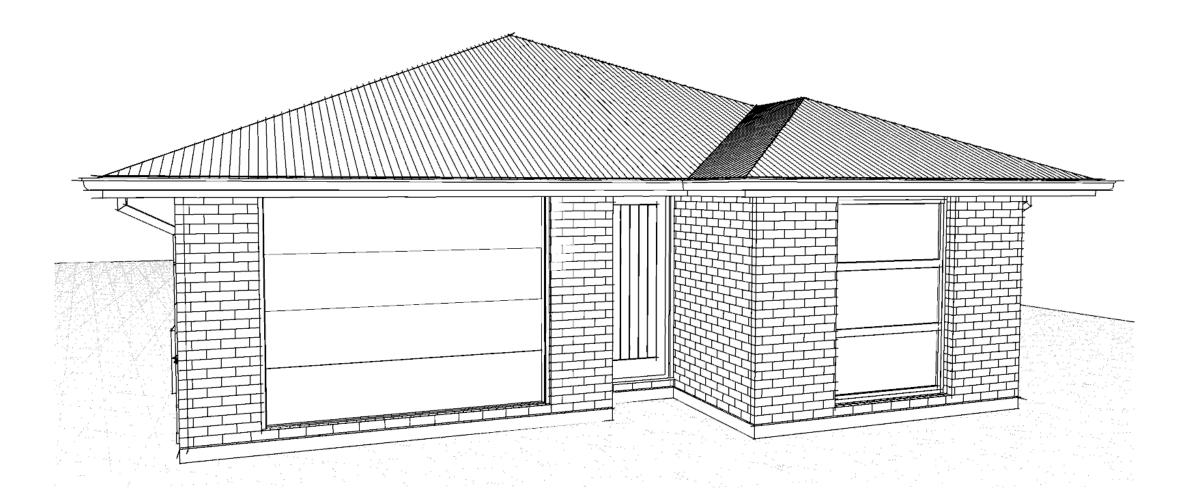

Contents: Sheet 1: **Cover Sheet** Sheet 2: Site Plan Floor Plan Sheet 3: Sheet 4: Elevations Sheet 5: Elevations Sheet 6: **Cross Sections** Sheet 7: Roof Plan Sheet 8: Set Out Dimensions Sheet 9: Foundation Plan Sheet 10: Drainage Plan Bracing Plan Sheet 11: Sheet 12: Lighting Plan Framing Details Sheet 13: Sheet 14: Framing Details Sheet 15: **Construction Details** Sheet 16: **Construction Details** Sheet 17: **Construction Details** Sheet 18: **Construction Details** Sheet 19: **Bathroom Details** Sheet 20: **Plumbing Details** Truss Design Sheet 21: Truss Design Sheet 22:

WAIMAKARIRI DISTRICT COUNCIL
Plans and specifications APPROVED in accordance
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Regulations 1992, Clause 3
BC230318 5/05/2023 co-michaelmo

All dimensions are to be check and confirmed prior to any construction

Plans are to be read in conjunction with Specifications and all supporting documentation




TKR Homes Ltd. 31 Watts Road, Sockburn PO BOX 11 351 Christchurch 8443

P: +64 3 342 7788

These drawings are limited to and by the extent of the detail covered in the drawings to meet the current New Zealand Building Code (NZBC). Where detail it required for construction and to demonstrate compliance with the current NZBC, a specific request should be made for the required detail to be supplied. No liability will be accepted for any detail or construction not covered in these drawings and/or carried out by persons other than the designer producing these documents.

Job Number:		Original Plan:		Sheet Name:			CONSENT PLANS				Sheet No.:
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SITE INFORMATION

Floor Area (veneer): 131.06m² / 32.77% Roof Area: 156.41m² / 39.10%

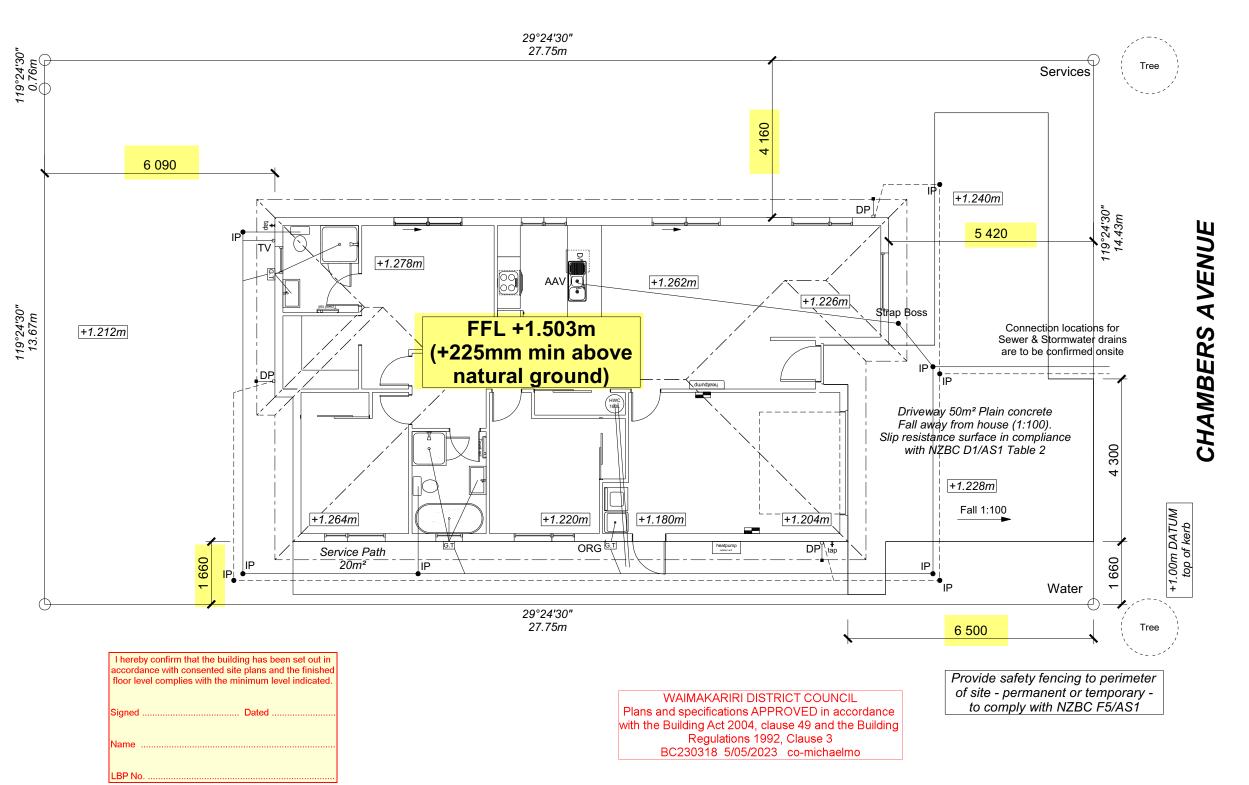Wind Earthquake Exposure

N 4 at 50m (up to 1kPa)

Note: The dimensions shown are from cladding to boundary. Refer to sheet 8 for foundation to boundary dimensions.

Sediment control and site safety requirements are noted in the attached Specifications.

DRAINAGE LEGEND

----- Stormwater DN100mm uPVC Sewer Drain DN100mm uPVC Downpipe GT ORG TV AAV Gully Trap Overflow Relief Gully Terminal Vent Air Admittance Valve Inspection Point

DRAWING NOTES

These drawings are subject to copyright and remain the property of Signature Homes Ltd.

Verify all dimensions, sizes and levels on site prior to commencing any work. Any discrepancies are to be confirmed with

Refer to attached Specifications for further

All work is to comply with the NZBC Acceptable Solutions, NZS 3604:2011 and

2

of 22 sheets

All dimensions are to be check and confirmed prior to any construction

Plans are to be read in conjunction with Specifications and all supporting docu



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These drawings are limited to and by the extent of the detail

covered in the drawings to meet the current New Zealand

Andrew Hannaway Lot 679 23 Chambers Avenue Ravenswood, Woodend

Original Plan: **KINGFISHER** 125083


Sheet Name: SITE PLAN Print Date

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Date: Reason: 05-04-2023 Initial Consent Plans

Local Authority bylaws. **CONSENT PLANS** Sheet No.:

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ROOF & WALL CLADDINGS

Roof: 25° Corrugate Longrun Walls: 70 Series Brick Veneer with a 50mm cavity

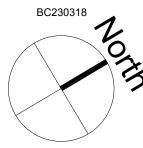DWELLING AREAS

Framing Area:125.01m² (Perimeter: 50.08m) Veneer Area: 131.06m² (Perimeter:50.90m) Roof Area: 156.41m² (Perimeter: 53.56m)

SMOKE ALARMS (hush type)

Domestic Smoke Alarms to be fitted within 3.0m of sleeping areas and on Escape routes as indicated on plan. To comply with one of the following standards: UL 217, ULC-S531, AS 3786, BS 5446 (part 1).

FLOOR PLAN NOTES

Dimensions shown are to the frame, GIB thickness not shown. Mechanical ventilation to comply with G4/AS1 Air Seals to have PEF rod & low expansion foan All windows and doors centered in room unless shown otherwise

Laundering facilities provided complying with G2/SA1 1.0

Provide sealant under skirting and paint to concrete around tub & W/M fixtures



Stud Height: 2400 mm (2455mm to u/s of bottom chord)

FLOOR FINISHES Carpet & Vinyl

KITCHEN HOB Electric Hobs

Internal Height: 1980mm (leaves) Leaf widths as shown on the plan (R/O +80mm) Type: Hollow core flush panel Front Door Type: Latitude Aluminium

WINDOW JOINERY Low-E Double glazed aluminum

Standard single glazing to Garage

INTERNAL TRIMS Scotia: 55mm GIB Coving (excluding garage) Skirting: 60x12mm Pine, single bevel edge Architrave: N/A

Shelf & Rails to all wardrobes except

4 shelves to Linen cupboard up to 1500mm

DRAWING NOTES


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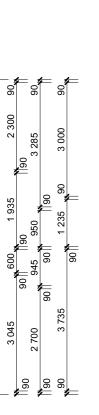
Verify all dimensions, sizes and levels on site prior to commencing any work. Any discrepancies are to be confirmed with Signature Homes Ltd.

Refer to attached Specifications for further


All work is to comply with the NZBC Acceptable Solutions, NZS 3604:2011 and Local Authority bylaws.

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All dimensions are to be check and confirmed prior to any construction Plans are to be read in conjunction with Specifications and all supporting doc

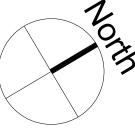

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Andrew Hannaway Lot 679 23 Chambers Avenue Ravenswood, Woodend

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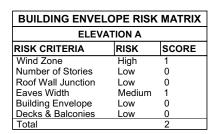
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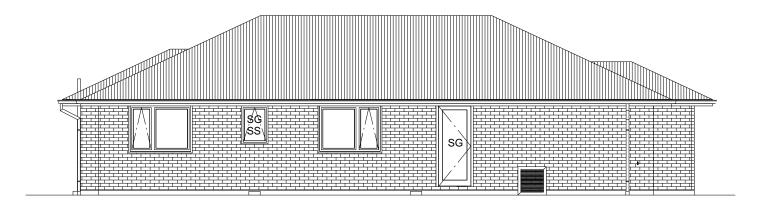
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FLOOR PLAN Print Date

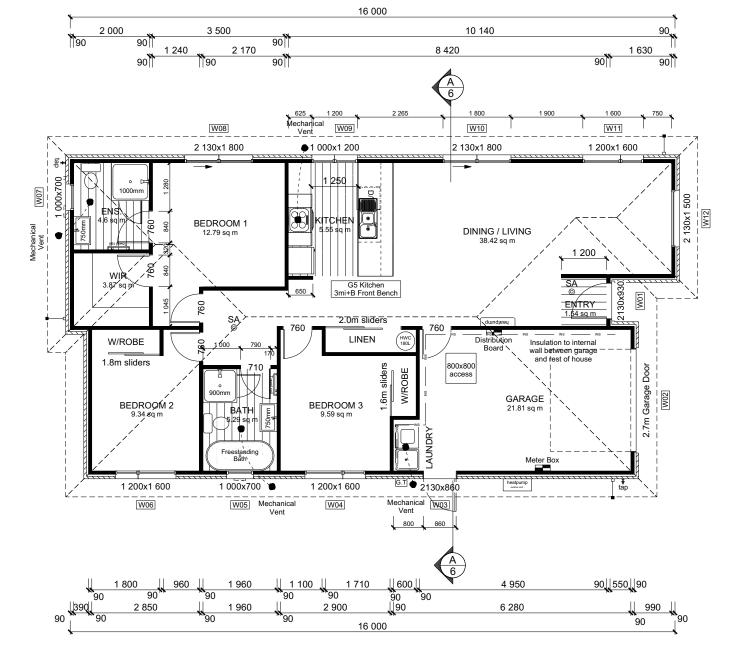
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CONSENT PLANS Sheet No.: lo. Date: Reason: 05-04-2023 Initial Consent Plans of 22 sheets





ELEVATION A

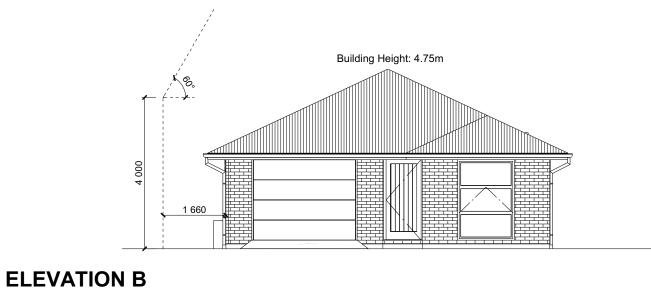

BUILDING ENVELOPE RISK MATRIX								
ELEVATION B								
RISK CRITERIA	RISK	SCORE						
Wind Zone	High	1						
Number of Stories	Low	0						
Roof Wall Junction	Low	0						
Eaves Width	Medium	1						
Building Envelope	Low	0						
Decks & Balconies	Low	0						
Total		2						

WAIMAKARIRI DISTRICT COUNCIL
Plans and specifications APPROVED in accordance
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Regulations 1992, Clause 3
BC230318 5/05/2023 co-michaelmo

ROOF & WALL CLADDINGS
Roof: 25° Corrugate corrugate
Walls: 70 Series Brick Veneer
with a 50mm cavity

ELEVATION LEGEND

ELEVATION NOTES

Soffits: Hardiflex 4.5mm

down of 190mm.

SS SG MB Safety Stays Safety Glass

Meter Box Terminal Vent

Gutter : Coloured Steel Quad Gutter Fascia : Coloured Steel185 Fascia Downpipes : Colorsteel Rectangular 75x55mn

Joinery : Low-E Double glazed aluminum

All egress points to have a maximum step

Access routs to have slip resistance surface in compliance with NZBC D1/AS1 Table 2 and to have a 1:100 fall away from the building

Sheet No.:

of 22 sheets

All dimensions are to be check and confirmed prior to any construction

Plans are to be read in conjunction with Specifications and all supporting documentation





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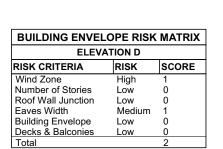
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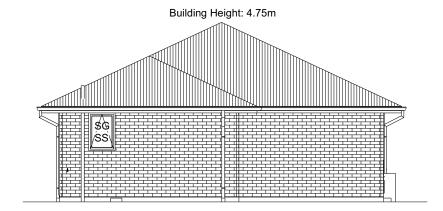
Andrew Hannaway
Lot 679
23 Chambers Avenue
Ravenswood, Woodend





ELEVATION C

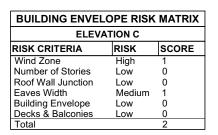

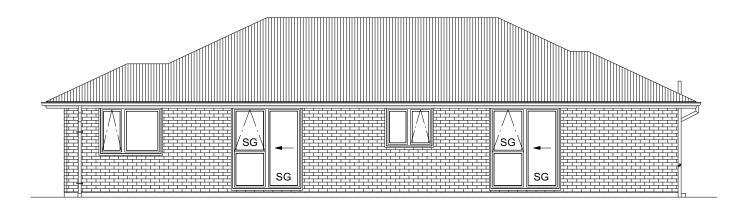

ELEVATION D

WAIMAKARIRI DISTRICT COUNCIL
Plans and specifications APPROVED in accordance
with the Building Act 2004, clause 49 and the Building
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BC230318 5/05/2023 co-michaelmo

ROOF & WALL GILGREINGS sent BC2303 18
Roof: 25° Corrugate Con 185/2023
Walls: 70 Series Brick Veneer
with a 50mm cavity

Safety Stays Safety Glass

Terminal Vent

Fascia : Coloured Steel185 Fascia Downpipes : Colorsteel Rectangular 75x55mm Soffits : Hardiflex 4.5mm Joinery : Low-E Double glazed aluminum

All egress points to have a maximum step down of 190mm.

Access routs to have slip resistance surface in compliance with NZBC D1/AS1 Table 2

and to have a 1:100 fall away from the building

Meter Box

Gutter: Coloured Steel Quad Gutter

ELEVATION LEGEND

ELEVATION NOTES

MB

TV

All dimensions are to be check and confirmed prior to any construction

Plans are to be read in conjunction with Specifications and all supporting documentation




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Job Numb	er:	0	riginal Plan:	Sheet	Name:		C	ONSENT PLANS	Sheet No.
125083		KINGFISHER		ELEVATIONS		No.	Date: 05-04-2023	Reason: Initial Consent Plans	5
ales:	Drawn:	_	QS:	Print Date:	Scale:				of 22 shee



Corrugate Longrun roofing on self supporting ThermaKraft 215 roof underlay on 70x45mm SG8 H1.2 Purlins @ 900crs fixings 1/10g selfdrilling screw, 80mm long

13mm Std. GIB ceiling lining (Aqualine to wet areas) to underside of 70x35mm H1.2 ceiling battens @ 600mm crs with R3.6 Pink Batts

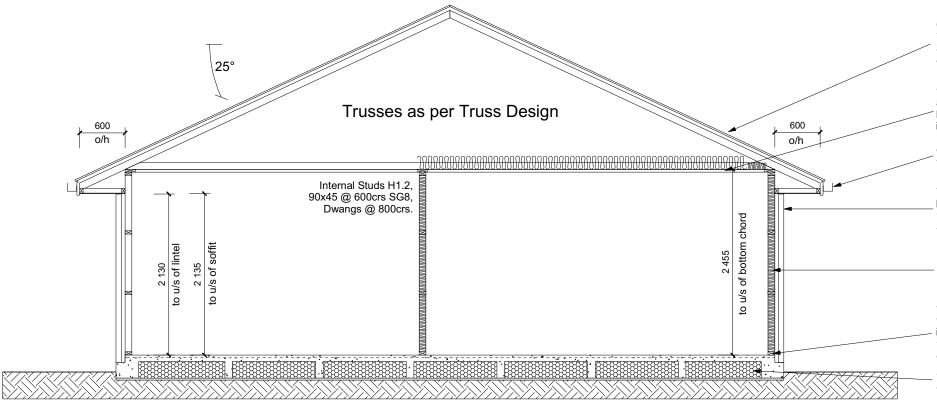Coloured steel fascia & gutter system with 4.5mm Hardies soffit lining.

70 Series brick veneer with a 50mm cavity. Masons Barricade building wrap on stud framing with R2.6 Pink Batts insulation & 10mm Std. GIB wall lining (Aqualine to wet areas).

Studs H1.2, 90x45 @ 600crs SG8, Dwangs @ 800crs (exterior & interior loadbearing walls)

125mm x 12mm thru bolt with 50mm square washer at 900mm crs on all external walls and interior load bearing walls (Bolts also 150mm for each end of bottom plate) minimum cover 40mm. DPC between bottom plate & floor slab.

TC2 Foundation in accordance with Engineers design

CROSS SECTION A-A

WAIMAKARIRI DISTRICT COUNCIL Plans and specifications APPROVED in accordance with the Building Act 2004, clause 49 and the Building Regulations 1992, Clause 3 BC230318 5/05/2023 co-michaelmo

DRAWING NOTES

ROOF & WALL CLADDINGS BC 230318 Roof: 25° Corrugate Longrun Walls: 70 Series Brick Veneer with a 50mm cavity

CROSS SECTION NOTES

3604:2011 & table 20 of E2/AS1.

of E2/AS1.

INSULATION

Building wrap is to comply with E2/AS1 & NZS 3604:2011. Flashing materials must be selected based on environmental exposure. Refer to NZS

Flashing tape must have proven compatibility with the selected wrap & other materials with which it comes into contract as per table 21

Fixings shall comply with NZS 3604:2011 Section 4 Durability Tables 4.1-4.3 Unless stated otherwise, timber members on drawings are to be a minimum of SG8 strength graded as per NZS3604:2011. Joinery: Low-E Double glazed aluminum

Ceiling: Pink Batts R3.6 Ceiling Batts Wall: Pink Batts R 2.6 Wall Batts

These drawings are subject to copyright and remain the property of Signature Homes Ltd.

Verify all dimensions, sizes and levels on site prior to commencing any work. Any discrepancies are to be confirmed with Signature Homes Ltd.

Refer to attached Specifications for further information

All work is to comply with the NZBC Acceptable Solutions, NZS 3604:2011 and Local Authority bylaws.

All dimensions are to be check and confirmed prior to any construction

Plans are to be read in conjunction with Specifications and all supporting do



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Andrew Hannaway Lot 679 23 Chambers Avenue Ravenswood, Woodend


Sheet Name: Original Plan: KINGFISHER 125083


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CONSENT PLANS Date: Reason: 05-04-2023 Initial Consent Plans


Sheet No.: 6 of 22 sheets



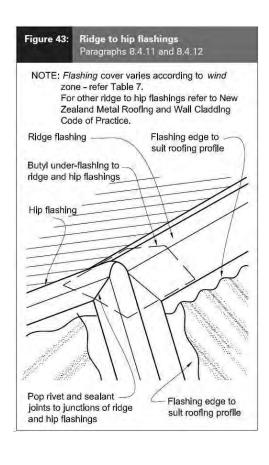

CONSENT ISSUED BC230318 - Page 13 of 29

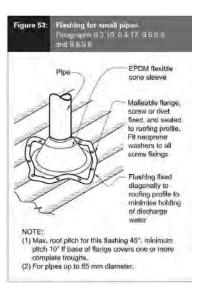* A pair of tensioned and crossed LUMBERLOK Strip Brace running continuously from ridge to top plate installed as detailed below.

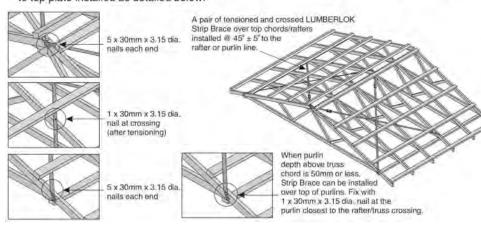

ROOF CLADDING

Roofing: 25° Corruggle 23/1935 pel Purlins: 70x45 SG8 H1.2 @ 900crs, fixings

1/10g self-drilling screw, 80mm long. End span of purlins to be 600crs as per E2 Table 11.

ROOF PLAN NOTES


Gutter: Coloured Steel Quad Gutter Fascia: Coloured Steel 185 Fascia Downpipes: Colorsteel Rectangular 75x55mm Soffits: Hardiflex 4.5mm

Underlay: Thermakraft 215 roof underlay

Downpipes: 75x55 Rectangle Colorsteel As per NZBC E1/AS1 Table 5 75x55 down pipes can collect up to 60m² of 0-25° roof plan area.

Use Coloured steel Quad Gutter As per NZ Metal Roof and Wall Cladding Code of Practice Version 2 section 8 the above gutter with a cross sectional area of 5550mm2 can collect up to 60m2 of 0-25° roof plan area. Refer to the specifications for exact calculations

Use Lumberlock top plate fixing chart attached to the main specifications to determine top plate fixings.

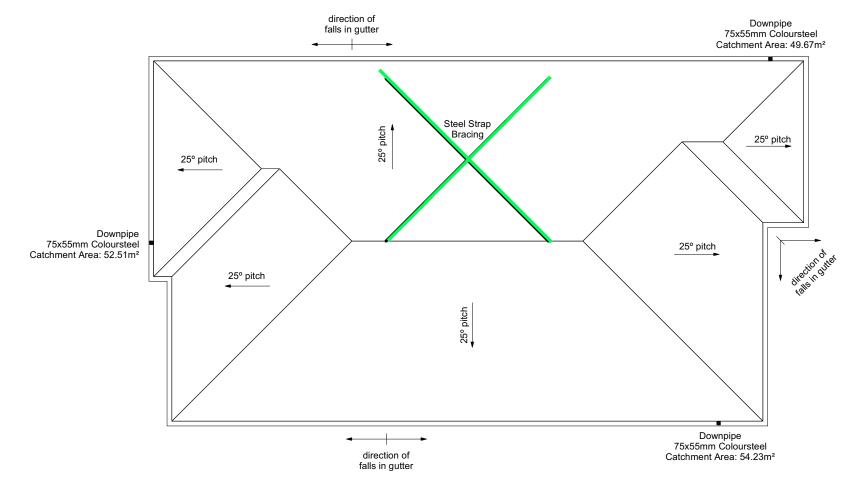

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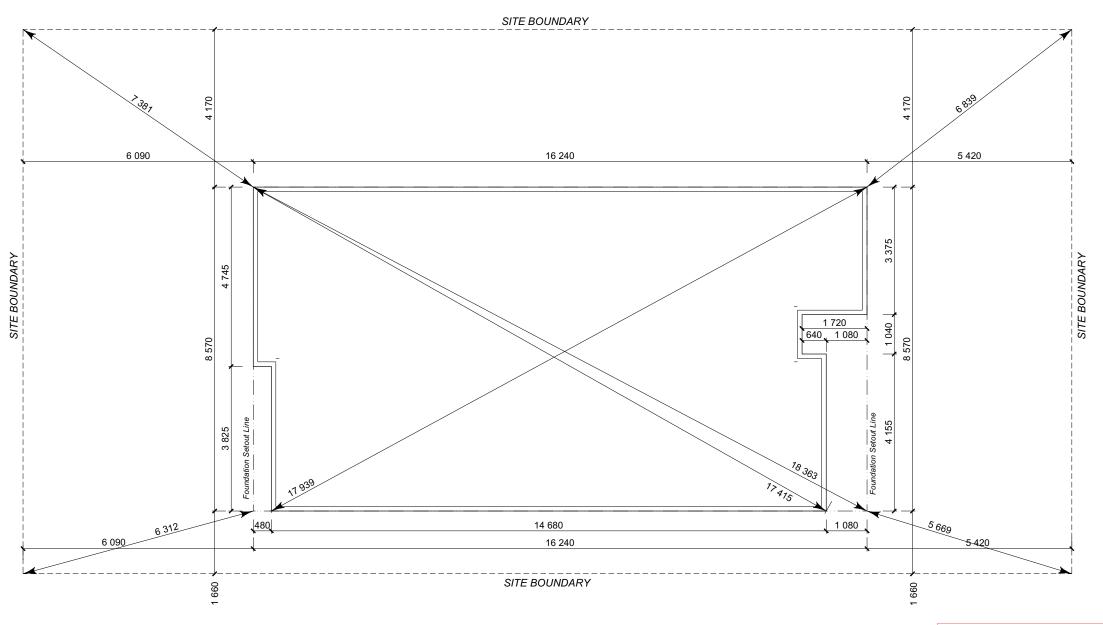
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Job Number: Original Plan:		Sheet Name:				CONSENT PLANS				
125083		KINGFISHER		ROOF PLAN			No.	Date: 05-04-2023	Reason: Initial Consent Plans	7
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Building Consent BC230318 Received 03/05/2023

SET OUT PLAN NO35\$30318
All dimensions over foundation face. Allow (120mm rebate) 70mm veneer & 50mm cavity, Brick to overhang foundation face by 0-20mm max as per NZBC E2/AS1. All reinforcing is to be Ductility Class E, in accordance with NZS 4671.
All concrete to comply with NZS3604:2011
Section 4 Durability Clause 4.5.2.

These foundations are design to the findings and recommendations in the site specific Geotech report.



WAIMAKARIRI DISTRICT COUNCIL Plans and specifications APPROVED in accordance with the Building Act 2004, clause 49 and the Building Regulations 1992, Clause 3 BC230318 5/05/2023 co-michaelmo

CHAMBERS AVENUE

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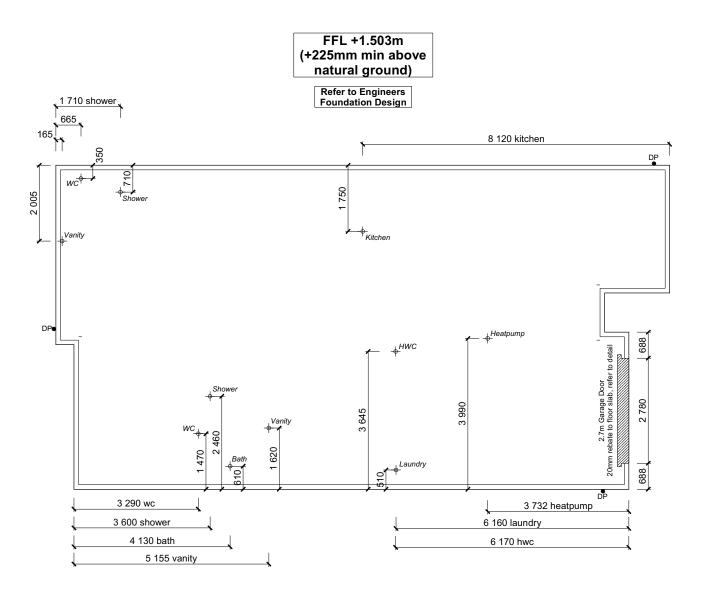


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FOUNDATION PLAN NOTES 8

All dimensions over foundation face. Allow (120mm rebate) 70mm veneer & 50mm cavity, Brick to overhang foundation face by 0-20mm max as per NZBC E2/AS1. W/C location indicated on plan has assumed a 140mm offset from internal frame line, please consult manufacturer's documentation to confirm offset.

Contractor to consult manufacturer's documentation to determine the correct location for all wastes positioned through floor slabs.
Earth bar to be bonded to the reinforcing

mesh Refer to Truss design for exact location of

All reinforcing is to be Ductility Class E, in accordance with NZS 4671. All concrete to comply with NZS3604:2011 Section 4 Durability Clause 4.5.2.

These foundations are design to the findings and recommendations in the site specific Geotech report.

AREA TO PERIMETER RATIO

Foundation Area: 131.06m² Perimeter: 2.57

WAIMAKARIRI DISTRICT COUNCIL Plans and specifications APPROVED in accordance with the Building Act 2004, clause 49 and the Building Regulations 1992, Clause 3 BC230318 5/05/2023 co-michaelmo

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Andrew Hannaway Lot 679 23 Chambers Avenue Ravenswood, Woodend

Job Nu	umber:	0	riginal Plan:	Sheet Name:			
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CONSENT PLANS No. Date: Reason:
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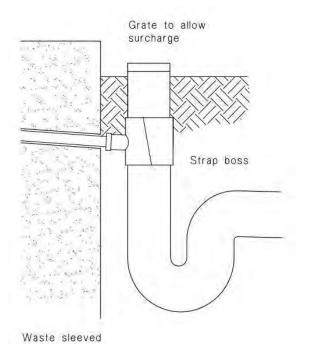
NZBC G13 Plumbing Schedule BC230318 Kitchen Ø50mm @1:40 Sink: (3 discharge units) Bathrooms Ø40mm @ 1:40 Ø40mm @1:40 Ø40mm @1:40 Ø100mm @1:40 Ø40mm @1:30 Vanity: (1 discharge units per basin) (2 discharge units) (4 discharge units) Shower: Bath: (4 discharge units) (5 discharge units) WC: Laundry Sink: Drainage Schedule NZBC G13 Main Foulwater Ø100mm @1:60 Ø100mm @1:60 (1:120max) Vented Drain Stormwater Drain Terminal Vent Ø80mm Ø50mm Vent Heatpump ORG Drain over GT Overflow Relief Gully min 20mm Drain over GT Hot water Cylinder All plumbing and drainage to comply with NZBC G13. ORG to be positioned so the top of gully dish is no less than 150mm below


overflow level of lowest fixture
Sewer & Stormwater to connect to existing connections.
All drains passing through concrete, provide sleeve or wrap in durable

and flexible to allow for expansion and contraction. (as per G13/AS2 5.8.1)

HWC: Safe tray to HWC with 50mm overflow drain to exterior to comply with G12/AS1.

DRAINAGE LEGEND ----- Stormwater DN100mm uPVC Sewer Drain DN100mm uPVC Downpipe Gully Trap Overflow Relief Gully DP . GT ORG Terminal Vent Air Admittance Valve Inspection Point AAV Strap Boss Connection locations for Sewer & Stormwater drains are to be confirmed onsite



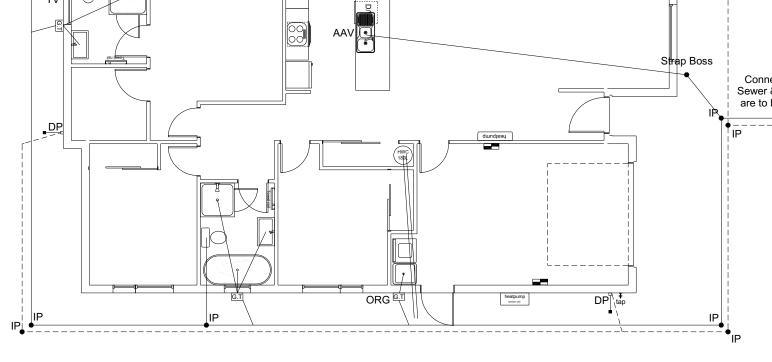

Regulations 1992, Clause 3 BC230318 5/05/2023 co-michaelmo

WAIMAKARIRI DISTRICT COUNCIL Plans and specifications APPROVED in accordance with the Building Act 2004, clause 49 and the Building

Relationship of Pipe Trench to Building Foundation Paragraph 3.9.7 Pipe Building trench foundation Minimum horizontal seperation V or 3V (See paragraph 3.9.7)

Sheet No.:

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c) Strap boss to riser

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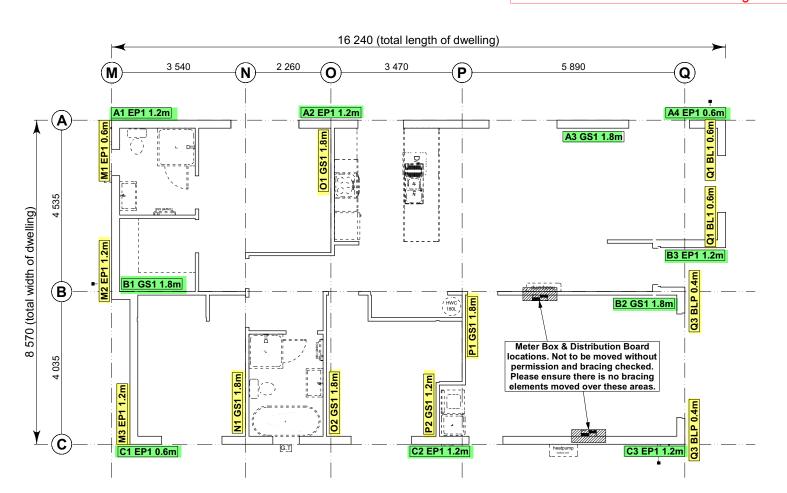
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	Job Number: 125083		Original Plan: KINGFISHER		Sheet Name:				CONSENT PLANS			
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through concrete

foundation



8.7.3.4

Each wall that contains one or more wall bracing elements shall be connected at the top plate level, either directly, or through a framing member in the line of the wall, to external walls at right angles to it. Top plate fixing(s) of the capacity in tension or compression along the line of the wall bracing element are given as follows:

- (a) For each wall containing wall bracing elements with a total bracing capacity of not more than 125 bracing units: to at least one such external wall by a fixing as shown in figure 8.16 of 6 kN capacity;
- For each wall containing wall bracing elements with a total bracing capacity of not more than 250 bracing units: to at least 2 external walls by fixings as shown in figure 8.16 each of 6 kN capacity;
- For each wall containing wall bracing elements with a total bracing capacity of more than 250 bracing units: to at least 2 external walls by fixings as shown in figure 8.16 each having a rating of not less than 2.4 kN per 100 bracing units.

BRACING PLAN NOTES 0318

Bracing Designed to:

Wind: High Earthquake: 2

Wall bracing designed in accordance with NZS 3604:2011 & GIB Ezybrace system Refer to attached calculations.

BRACING LEGEND A ← Brace Line Label Brace Length Brace Type

Brace Number

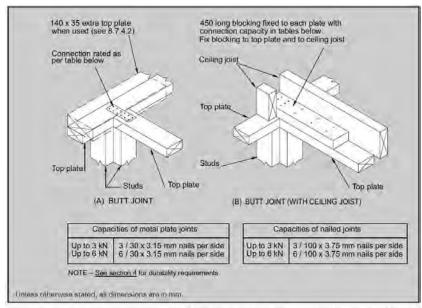


Figure 8.16 - Connecting top plates to external walls at right angles - Walls containing bracing (see 8.7.3.4)

Single Level Along Resistance Sheet Job Name: Andrew Hannaway Wind EQ Demand 435 798 Achieved (m) (BUs) (BUs) 277% 158% (degrees) 1.20 2.4 162 1.20 2.4 EP1 1.2 Ecoply® 162 2.4 GS1-N 124 108 1.80 GIB® 469 OK 495 OK 2.4 124 1.80 GS1-N GIB® 108 392 OK 378 OK 63 2.4 EP112 1.20 162 Ecoply® C 345 OK 387 OK

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Single Level Across Resistance Sheet

JOD N	ame: Andre	w Hannav	way						Wind	EQ
									Der	nand
									797	798
									Achi	eved
Line	Element	Length	Angle	Stud Ht.	Type	Supplier	Wind	EQ	1140	1120
	- =	(m)	(degrees)	(m)			(BUs)	(BUs)	143%	140%
	1	0.60		2.4	EP1 0.6	Ecoply®	57	63		
	2	1.20		2.4	EP1 1.2	Ecoply®	144	162		
M	3	1.20		2.4	EP1 1.2	Ecoply® -	144	162		
									345 OK	387 OK
N	1	1.80		2.4	GS1-N	GIB®	124	108		
-(3	The second								124 OK	108 OK
	1	1.80		2.4	GS1-N	GIB®	124	108		
0	2	1.80		2.4	GS1-N	GIB®	124	108		
									248 OK	216 OK
- 1		1.80		2.4	GS1-N	GIB®	124	108		-
P	2	1.20		2.4	GS1-N	GIB®	83	72		
									207 OK	180 OK
	- t -	0.60		2.4	BL1-H	GIB®	59	61		
	2	0.60		2.4	BL1-H	GIB®	59	61		
Q	-3	0:40		2.4	BLP-H	GIB®	48	54		
	4	0.40		2.4	BLP-H	GIB@	48	54		
									215 OK	229 OK

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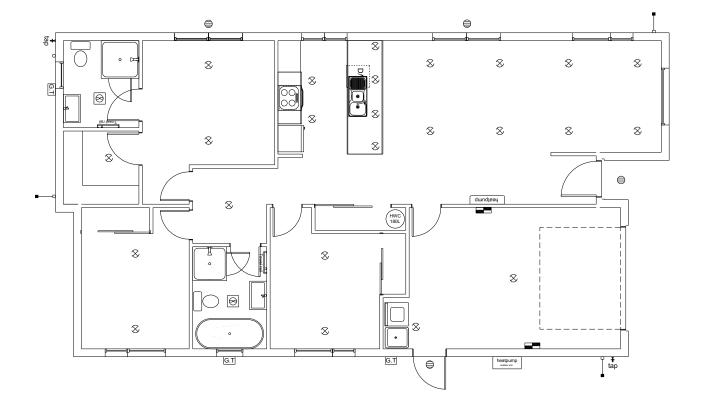



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WAIMAKARIRI DISTRICT COUNCIL
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Andrew Hannaway
Lot 679
23 Chambers Avenue
Ravenswood, Woodend

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LIGHTING PLAN

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1 05-04-2023 Initial Consent Plans

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of 22 sheets

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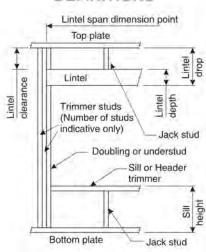
LINTEL FIXING SCHEDULE

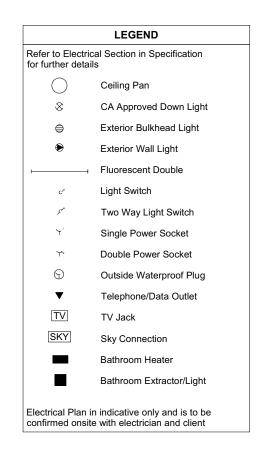ALTERNATIVE TO TABLE 8.14 & FIGURE 8.12 NZS 3604:2011

NOTE:

- * All fixings are designed for vertical loads only. Dead loads include the roof weight and standard ceiling weight of 0.20kPa.
- Refer to Table 8.19 NZS 3604:2011 for nailing schedule to resist horizontal loads.
- * These fixings assume the correct choice of rafter/truss to top plate connections have been made
- * All fixings assume bottom plate thickness of 45mm maximum. Note: TYLOK options on timber species.
- * Wall framing arrangements under girder trusses are not covered in this schedule.
- * All timber selections are as per NZS 3604:2011.

DEFINITIONS



Li	ntel Sup	porting	Girder	Trusses			
Roof Tributary Area	L	ight Roo	of	Heavy Roof			
	V	/ind Zon	ie	V	lind Zon	e	
	L, M, H	VH	EH	L, M,	VH	EH	
8.6m ²	G	G	Н	G	G	Н	
11.6m²	G	Н	H	G	G	H	
12.1m ²	G	Н	Н	G	Н	Н	
15.3m ²	Н	Н		G	Н	Н	
19.1m ²	н			G	Н	- 3	
20.9m ²	н	4.4		н	Н	15	
21.8m ²	н	-	-	Н	3-7		
34.3m ²	10.0	+5	-	H	*		


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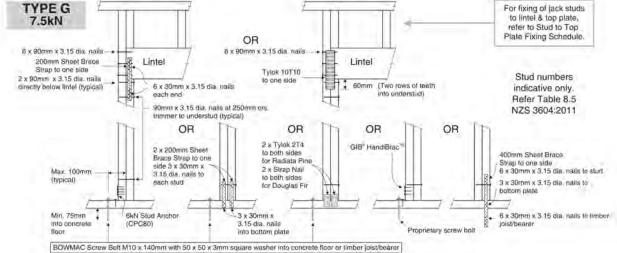
- 1. Roof Tributary Area = approx. 1/2 x (Total roof area on girder and rafter trusses supported by lintel)
- 2. Assumed girder truss is at mid-span or middle third span of lintel
- 3. Use similar fixings for both ends of lintel
- 4. All other cases require specific engineering design


Lintel	Loaded			nd Z					avy F		
Span (m)	Dimension (m) (See Fig. 1.3 NZS 3604:2011)	L	м	н	VH	ĖН	L.	М	н	VH	EH
	2.0	E	Е	E	F	F	E	E	E	E	F
	3.0	E	E	F	F	F	E	E	E	F	F
1.0	4.0	E	F	F	F	G	E	E	E	F	F
110	5.0	Ē	F	F	G	G	E	E	F	F	G
	6.0	Ē	F	F	G	G	E	E	F	F	G
	2.0	E	E	F	F	F	Ē	E	E	F	F
	3.0	E	E	F	F	F	E	E	F	F	F
1.2	4.0	E	F	F	G	G	E	E	F	F	G
1.12	5.0	E	F	F	G	G	E	E	F	F	G
	6.0	F	F	G	G	H	E	E	F	G	G
	2.0	E	E	F	F	F	Е	E	E	F	F
	3.0	E	F	F	F	G	E	E	F	F	F
1.5	4.0	E	F	F	G	G	E	E	F	F	G
	5.0	F	F	G	G	H	E	E	F	G	G
	6.0	F	F	G	H	H	E	E	F	G	H
	2.0	E	F	F	F	G	E	E	F	F	F
	3.0	E	F	F	G	G	E	E	F	F	G
2.0	4.0	F	F	G	G	H	E	E	F	G	G
	5.0	F	F	G	H	Н	E	E	F	G	H
	6.0	F	G	G	Н	Н	E	F	G	Н	Н
	2.0	E	F	F	G	G	E	E	E	F	G
	3.0	F	F	G	G	Н	E	E	E	G	G
2.4	4.0	F	F	G	H	Н	E	E	F	G	Н
	5.0	F	G	G	H	Н	E	E	G	H	H
	6.0 2.0	E	G	H	G	G	E	F	F	H	H
	3.0	F	F	G	Н	Н	E	E	E	G	H
3.0	4.0	F	G	G	H	Н	E	F	G	Н	H
0.0	5.0	F	G	Н	Н	14	Ē	E	G	н	Н
	6.0	F	G	н	-		E	P	G	н	-
	2.0	F	F	G	G	Н	E	E	F	G	G
	3.0	F	F	G	Н	H	E	F	G	G	Н
3.6	4.0	F	G	H	H	4.	E	F	G	Н	Н
7.00	5.0	F	G	H	1	12.	E	F	G	H	
	6.0	G	H	Н	-6.		E	F	H	1.2	
	2.0	F	F	G	G	H	E	E	F	G	G
	3.0	F	G	Н	H		E	F	G	H	H
4.2	4.0	F	G	H	- 21	•	E	F	G	H	
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	6.0	G	H	-			E	F	H	-	-
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	3.0	F	G	H	Н		E	F	G	H	H
4.5	3.4	F	G	H	Н		E	E	G	H	Н
	4.0 5.0	F	GH	Н			E	F	GH	Н	
	6.0	G	Н		-		E	F	Н		
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	3.0	F	G	Н	Н	-11	E	Ē	G	Н	Н
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	6.0	G	Н	1		1.0	E	F	Н	-	1.2
	2.0	F	F	G	Н	Н	E	F	G	G	H
	3.0	F	G	H	Н	-	E	F	G	Н	H
5.1	3.5	F	G	Н	18.1		E	F	G	H	
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	6.0	G	H	Ud.	18.		E	G	H	-	-
	2.0	F	F	G	Н	Н	E	F	G	G	H
	2.8	F	G	Н	Н		E	F	G	H	H
5.4	3.0	F	G	Н			E	E	G	H	-
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LINTEL FIXING OPTIONS







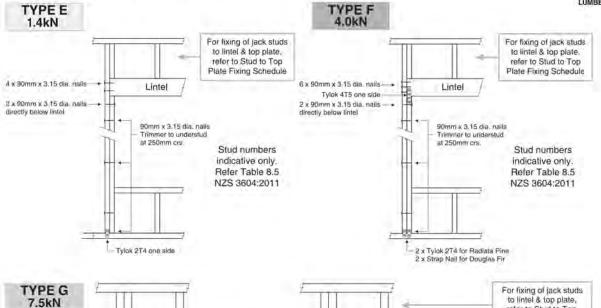
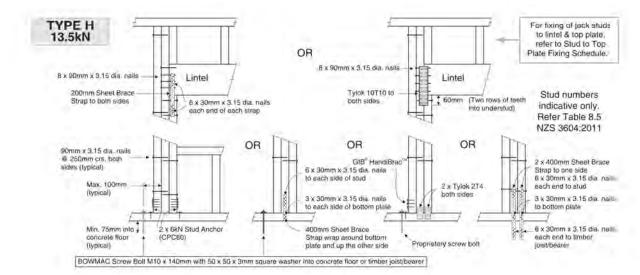
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Job Numb	er:	O	riginal Plan:	Sheet	Name:		C	ONSENT PLANS	Sheet No.:
125083		KINGFISHER		FRAMING	FRAMING DETAILS		No. Date: Reason: 1 05-04-2023 Initial Consent Plans		13
	Drawn: M Glyni		QS: A Villanueva	Print Date: 5/04/2023	Scale: NTS	@ A3			of 22 shee




STUD TO TOP PLATE FIXING SCHEDULE

ALTERNATIVE TO TABLE 8.18 NZS 3604:2011

NOTE:

- * All fixings are designed to resist vertical loads only. Dead loads include the roof weight and standard ceiling weight
- ★ Refer to Table 8.19 NZS 3604:2011 for nailing schedule to resist lateral loads.
- * These fixings assume the correct choice of rafter/truss to top plate connections have been made.
- ★ For gable end walls where the adjacent rafter/truss is located within 1200mm and with a maximum verge overhang. of 750mm, select stud to top plate fixing using a loaded dimension of 1.5m.
- All fixings assume top plate thickness of 45mm maximum.
- * Wall framing arrangements under girder trusses are not covered in this schedule.
- * All timber selections are as per NZS 3604:2011.

LOADED DIMENSION DEFINITION

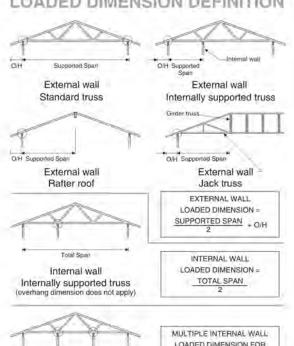

FIXING SELECTION CHART

Multiple internal walls


(Suitable for walls supporting roof members at 600, 900 or 1200mm crs.)
Wind Zones L, M, H, VH, EH, as per NZS 3604:2011

Loaded Dimension (m) Stud Centres				Light Roof Wind Zone					Heavy Roof Wind Zone				
300mm	400mm	600mm	L	M	Н	VH	EH	L	M	H	VH	EH	
3.0	2.3	1.5	Α	Α	В	В	В	Α	Α	В	В	В	
4.0	3.0	2.0	Α	Α	В	В	B	Α	Α	B	В	В	
5.0	3.8	2.5	Α	В	В	В	В	A	Α	В	В	В	
6.0	4.5	3.0	Α	В	В	В	В	A	Α	В	В	В	
7.0	5.3	3.5	Α	В	В	В	В	Α	Α	В	В	В	
8.0	6.0	4.0	A	В	В	В	В	A	Α	В	В	В	
9.0	6.8	4.5	В	В	В	В	В	Α	A	В	В	В	
10.0	7.5	5.0	В	В	В	В	В	Α	Α	В	В	В	
11.0	8.3	5.5	В	В	В	В	В	Α	A	В	В	В	
12.0	9.0	6.0	В	В	В	В	В	A	Α	B	В	В	

FIXING OPTIONS

FIXING TYPE A 0.7kN

2 x 90mm x 3.15 dia, plain steel wire nails driven vertically into stud.

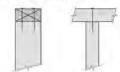

FIXING TYPE B CHOOSE ANY OF THE 3 OPTIONS BELOW


2 x 90mm x 3.15 dia, plain steel

2 x 90mm x 3.15 dia. plain steel wire nails driven vertically into stud.







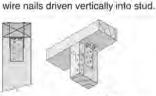

2 x LUMBERLOK CPC40

Recommended for internal wall options to avoid lining issues.

2 x 90mm x 3.15 dia. plain steel wire nails driven vertically into stud.



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To calculate the number of B type fixings required, divide the wall length by the stud centres, add 1 to this figure and locate this number of fixings as evenly as possible along the wall length. This figure includes the start and end studs in each wall length.



SCAN FOR INSTALLATION VIDEO

https://vimeo.com/117353604

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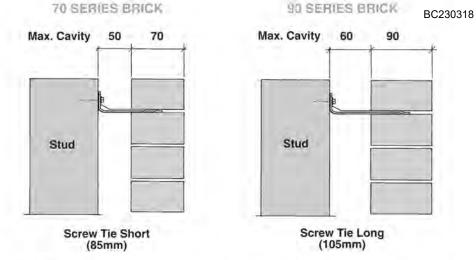
Andrew Hannaway Lot 679 23 Chambers Avenue Ravenswood, Woodend

125083

Original Plan: **KINGFISHER**

FRAMING DETAILS Print Date

CONSENT PLANS Sheet No. Date: Reason: 05-04-2023 Initial Consent Plans 14 of 22 sheets NTS



 All brick work must be constructed in accordance with NZS 4210:2001 Masonry Construction: Materials and Workmanship. Screw Ties must be applied accordingly and are not to be hammered into timber framing.

Water shedding shoulder prevents transfer of the moisture from tie to building.

- Nail hole for Oamaru Stone.

Angled neck encourages increased tie embedment in mortar.

1.2mm NZCC-SD Hot Dip Galvanised Steel

Type 17-12g x 35mm Hex Head Hot Dip Galvanised Screws

250 ties per box including screws

Also available in Stainless Steel Grade 316 for Zone D.

SCREW TIES

FOR BRICK VENEER FIXING

Medium duty (EM) classification


Tested by BRANZ in accordance with AS/NZS 2699.1:2000

BRANZ test report No. ST0725 November 2007


Suitable for both 'dry bedding' and encapsulated mortar


 Hot Dip Galvanised ties for Zones B & C, and Stainless Steel Grade 316 ties for Zone D meet NZS 3604:2011 Sect. 4 Durability

Available in 85mm and 105mm sizes

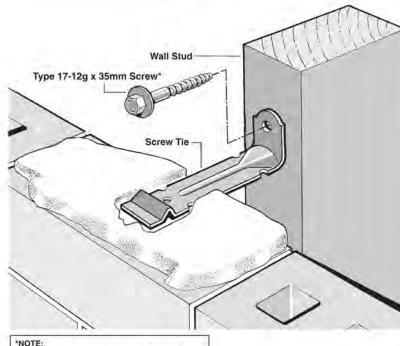

Use longer screws for fixing through Rigid Air Barrie (RAB). Maintain 35mm embedment in studs

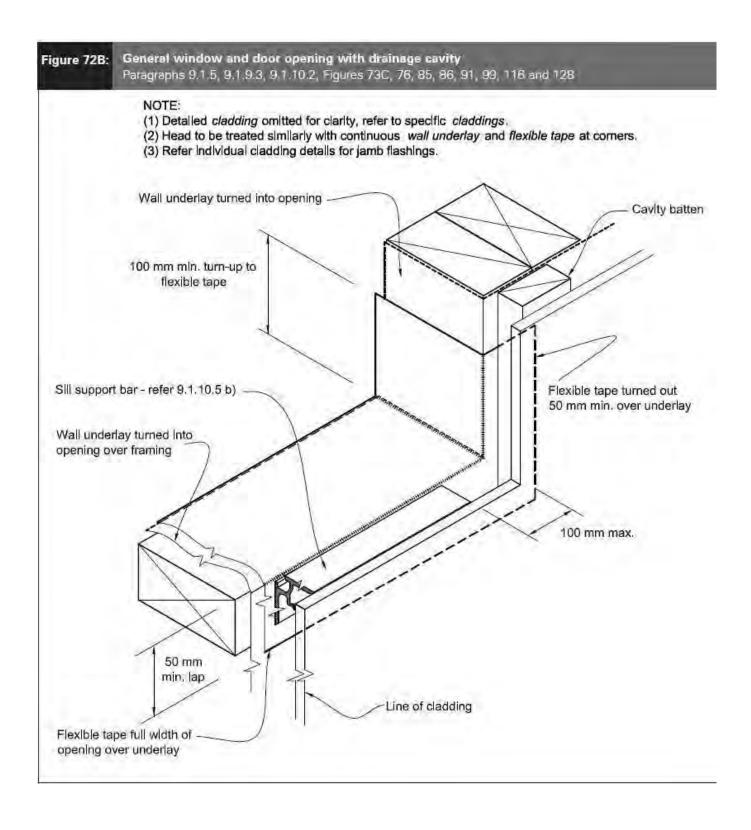

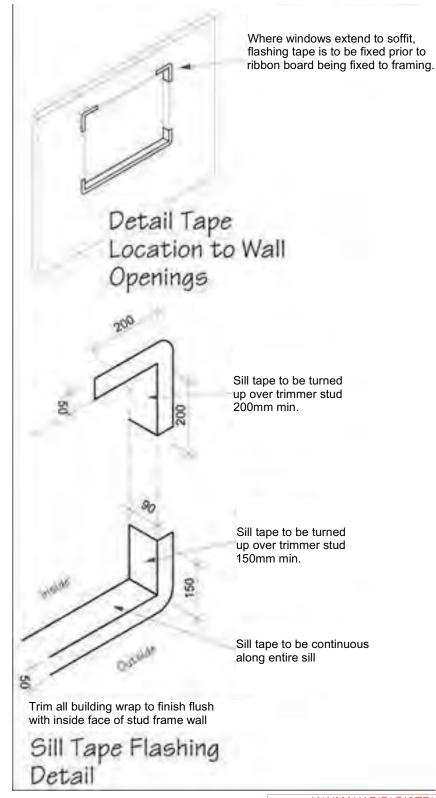

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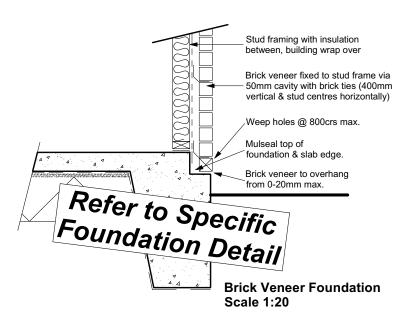
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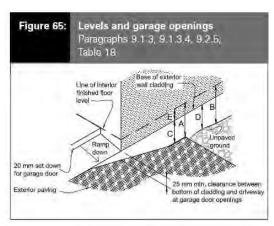
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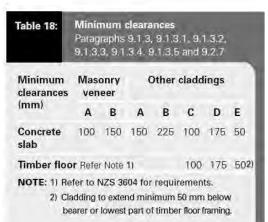
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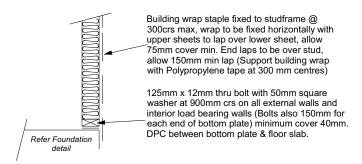
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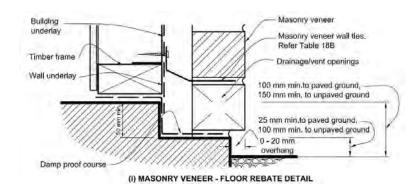










Stud framing to slab Scale 1:20



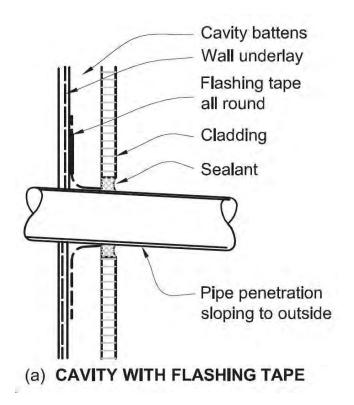

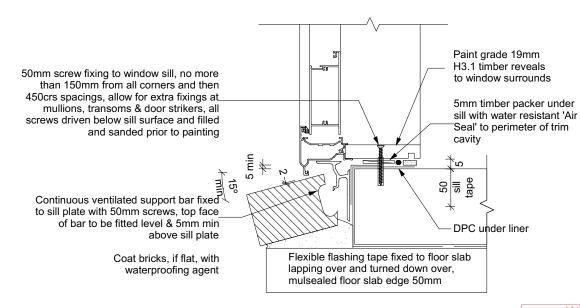

Door Sill to Slab Detail Scale 1:20

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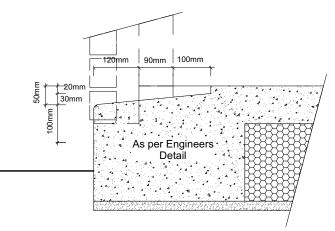
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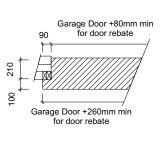
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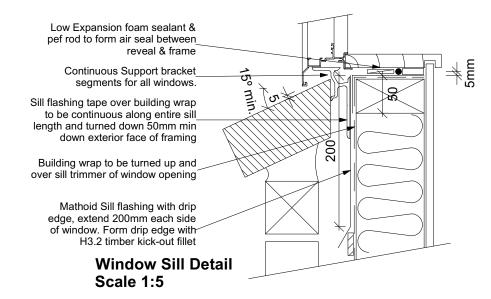
A Villanueva 5/04/2023

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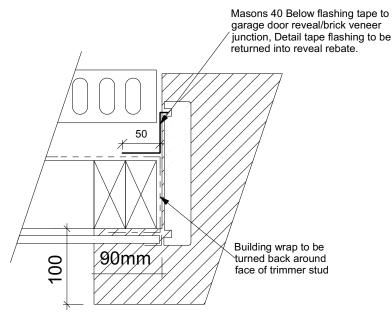


9.1.10.8 Attachments for windows and doors


Install windows and doors using pairs of minimum 75 x 3.15 galvanised jolt head nails or 8 gauge x 65 mm stainless steel screws, through reveals into surrounding *framing* at:

- a) Maximum 450 mm centres along sills, jambs and heads, and
- b) Maximum 150 mm from reveal ends.

Install packers between reveals and *framing* at all fixing points, except between head reveals and lintels.



Garage Door Jamb Detail Scale 1:5

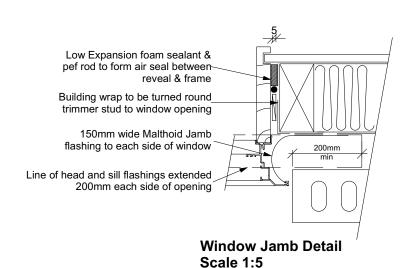

Expandable foam sealant on pef rod to form air seal between cavity system and Gibboard lining

Flexible flashing tape in corners

Line of head and sill flashings extended 200mm each side of opening

150mm wide Malthoid Jamb flashing to each side of window

Aluminium door

Door Jamb Detail Scale 1:5

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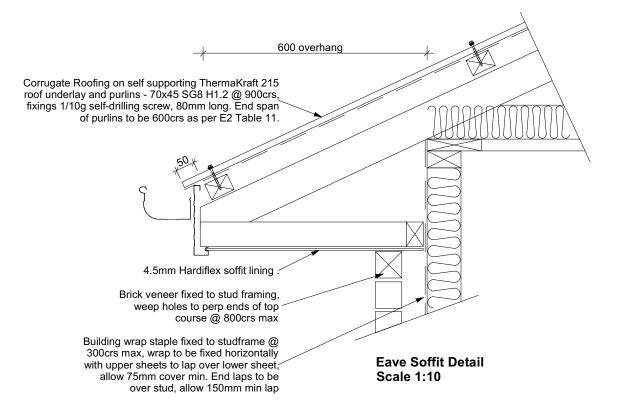
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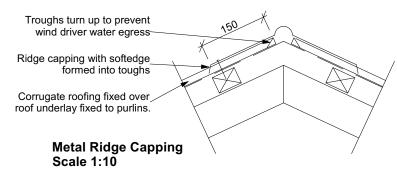
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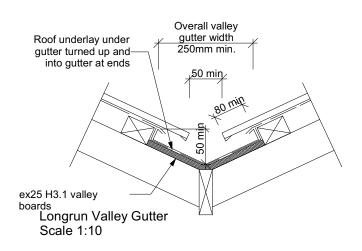
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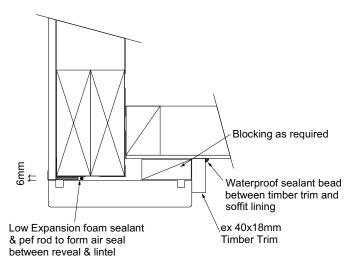
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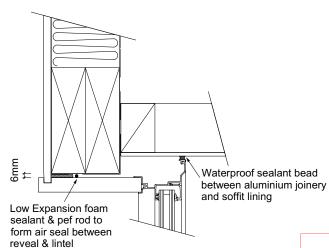








Garage Door Head to Soffit Scale 1:5



Window Head to Soffit Detail Scale 1:5

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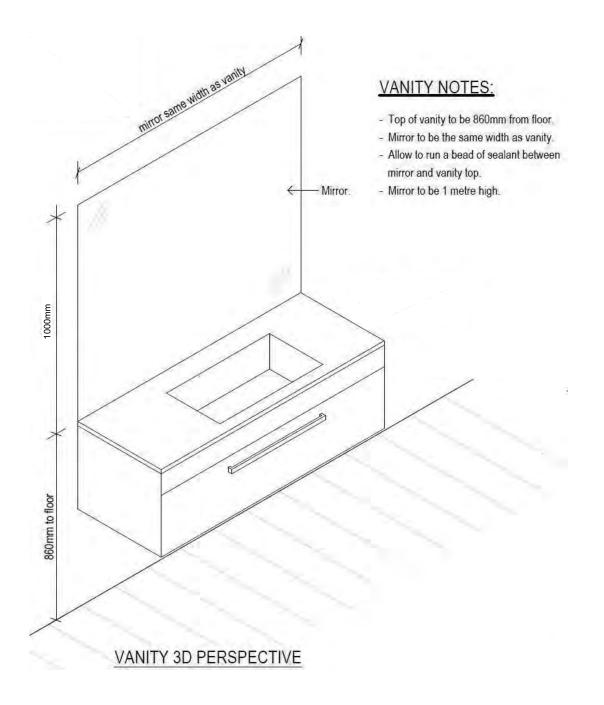
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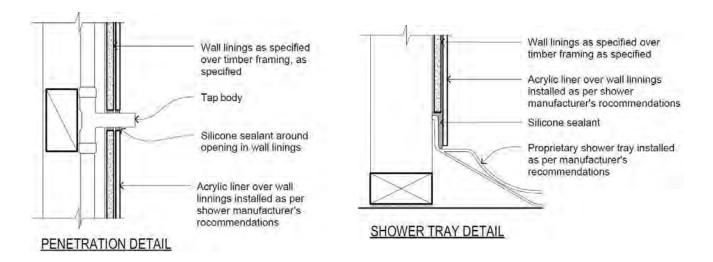
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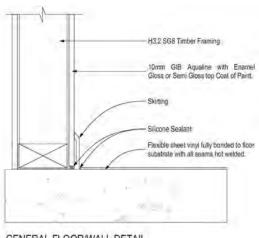
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GENERAL FLOOR/WALL DETAIL

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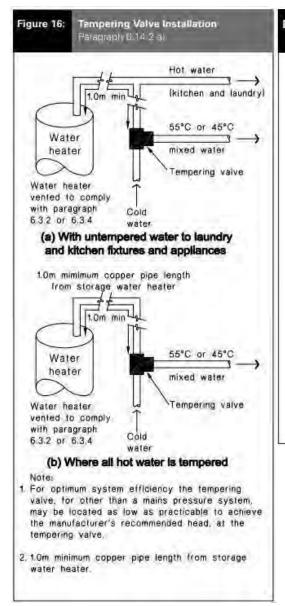



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Buildable Consent Layout


For valley/saddle truss fixing unless stated otherwise use a pair of wire dogs at 900mm centres for up to and including a very high wind zone. Or a pair of CT200's at 900mm centres for extra high wind zone. This fixing is to meet the minimum requirements as per NZS3604.


CONSENT ISSUED BC230318 - Page 27 of 29

Your BC230318 CARTERS **Building Partner**

-- AS BUILT TRUSS LAYOUT REQUIRED --This must be received by the Building Unit AT LEAST 10 WORKING DAYS PRIOR to the Structure Pre-Roof Pre-Wrap inspection

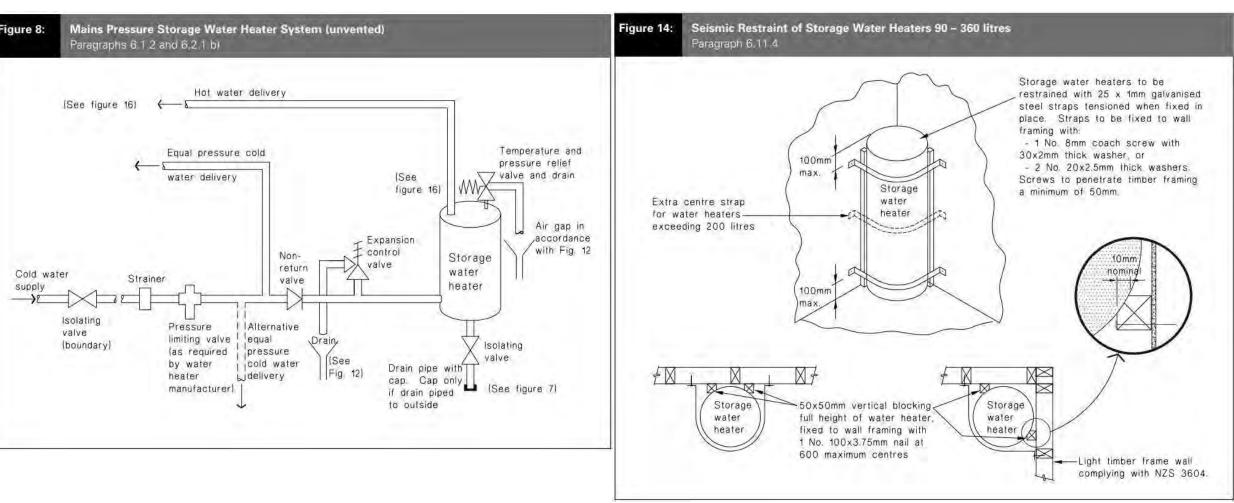Truss "As-Build" designs shall be sent to buildinginfo@wmk.govt.nz

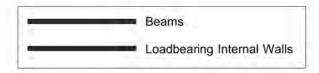

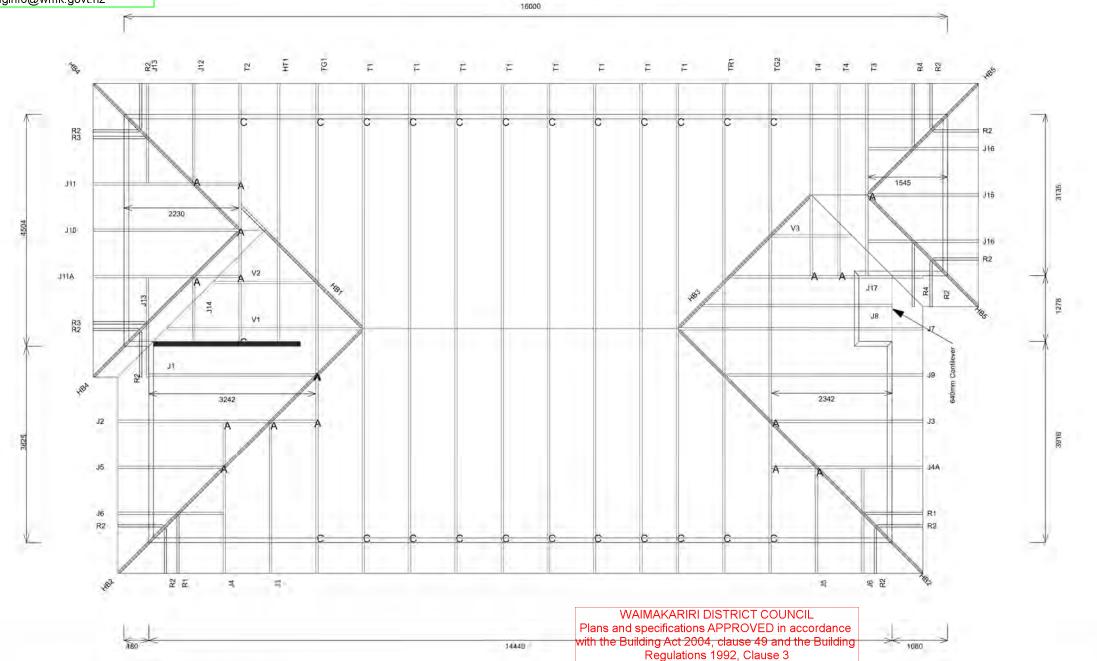

YOUR HOME. YOUR WAY

Job No: RG1378642C1

Customer: TKR Homes Limited | T/A Signature Homes Canterbury

Job Name: Hannaway Lot 679 Ravenswood

Address: Lot 679 Ravenswood

Woodend, Waimakariri District

If a gable truss requires a windbeam brace, the type of MiTek brace will be noted as such on the layout. The truss fixings can be substituted for other fixings of the same or greater capacity.

All verge framing to be fixed according to the MiTek On-Site Guide if not covered by NZS3604. If bottom chord restraints are 35mm Metal battens, then they must be fixed with either two nails or screws. If the metal battens are fixed with a single nail or screw then 90x45mm bottom chords restraints will be required at 1800mm centres

All loads shown on this page regarding the truss fixings are characteristic loads

Truss Fixings

A = 47x90 Joist Hanger B = 47x120 Joist Hanger

C = CT200 (pair)

D = 47x190 Joist Hanger

E = 95x165 Joist Hanger

F = SH-140 Split Hanger

G = SH-180 Split Hanger

H = SH-220 Split Hanger J = 2x6kN Strap (12kN)

K = 6kN Strap

L = Multigrip (single)

M = Multigrips (pair)

N = Nailon Plate (240x110x1)

P = 16kN Pack

Q = 9kN Pack

S = CPC 40 Single Cleat

T = CPC 40 Short (pair)

U = CPC 80 Single Cleat

V = 16kN Uplift

Unless otherwise indicated, all specified truss fixings are to use L/Lok product nail fasteners or Type 17 - 14g Hex Head Screws (as per the MiTek On-site Guide)

Z = Engineers Design

All truss to frame fixings require 2 additional 2/90x3.15dia skew nails.

All truss fixings not indicated as above must have 2 wire dogs for cross joints and 2/90x3.15dia nails for butt joins.

Fixings shown are for fixing trusses to the top plate. Any other point load uplift fixings down through the framing stud to top plate, stud to bottom plate, bottom plate to floor remain the responsibility of the architect / draughtsman.

Any roof loads as stated on this layout over 16kN lift are outside the scope of NZS3604, and the architect / draughtsperson is responsible for the design to transfer the loads to the

Snow Zone:	Christchurch (N4)		
Wind Area:	High		
TC Restraints:	400 mm		
Roof Material:	Metal Tiles		
Roof Pitch:	25.00 °		
Snow Altitude:	100.000 m		
Design Wind Speed:	44.0 m/s		
BC Restraints:	600 mm		
Ceiling Material:	Standard Plaster Board 13mm		
Ground Snow Load:	0.900 kPa		
Truss Centres:	900 mm		

Bruce Barrow

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BC230318 5/05/2023 co-michaelmo

Job Number: 125083			riginal Plan: I GFISHER	Sheet Name: TRUSS DESIGN				
	Sales: D Ryan	Drawn: M Glyni	n	QS: A Villanueva	Print Date: 5/04/2023	Scale: NTS @ A3		

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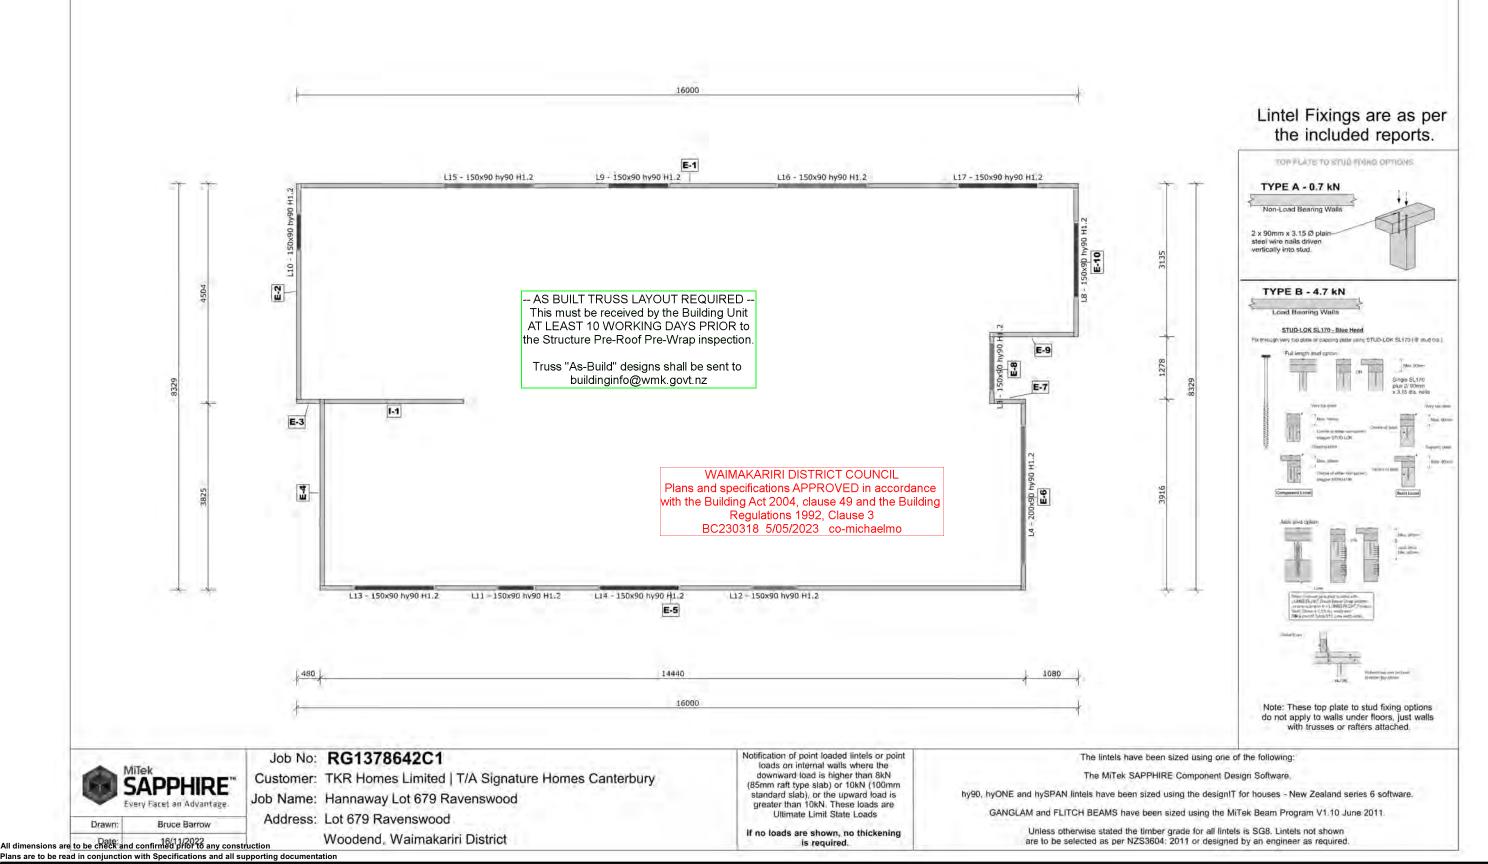
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Buildable Consent Layout

FTMA NEW ZEALAND

All internal walls shown on this layout are considered to be loadbearing Lintel fixing specification remains the responsibility of the architect / draughtsperson





H O H E S

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Job Number: 125083

Original Plan:

KINGFISHER

Sheet Name:
TRUSS DESIGN

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Print Date


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No. Date: Reason: Initial Consent Plans

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of 22 sheets

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Lot 679
23 Chambers Avenue
Ravenswood, Woodend

Job Number: Original Plan:

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KINGFISHER
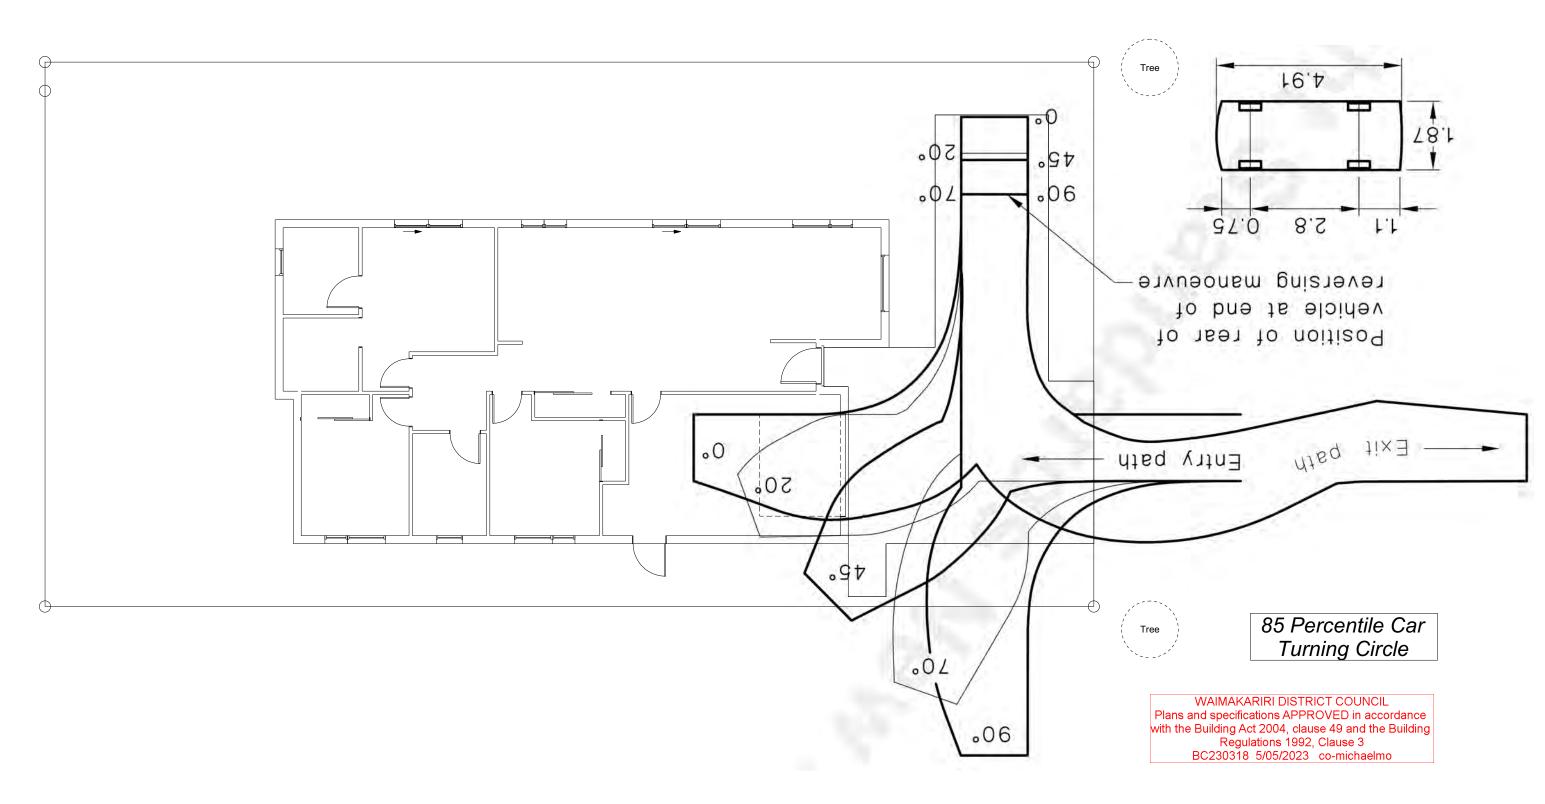
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Sheet No.:

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