215 High Street Private Bag 1005 Rangiora 7440, New Zealand

Phone 0800 965 468

BC No: 240219

SITE DETAILS:

46 CHAMBERS AVENUE

WOODEND

LEGAL:

LOT 878

AS BUILT TRUSS LAYOUT REQUIRED -

This must be received by the Building Unit **AT LEAST** 10 WORKING DAYS PRIOR to the Structure Pre-Roof Pre-Wrap Inspection

Truss "As-Built" Designs may be sent to: buildinginfo@wmk.govt.nz

Approved Building Consent Documents and Plans (Full set)

On Site Copy

- These plans and specifications must be kept on site during construction, and made available to the building officer on request. Failure to do so will mean an automatic failure of the building inspection and will necessitate re-booking the inspection at the applicant's expense.
- All boundary survey pegs must be located and flagged by the owner before work is commenced.

Inspections

For bookings or building enquiries please phone the Building Unit on:

03 311 8906

or

Email inspection bookings to: bcbooking@wmk.govt.nz

- Please refer to your inspection schedule for details of inspections to be carried out.
- At least 2-3 full working days' notice should be given when booking an inspection.
- Please be advised that it may not always be possible to carry out the inspection within the time frame you require.
- Provision is to be made to allow access.
 - The Code Compliance Certificate will be issued once the:
 - Final inspection has been carried out and passed.
 - Audit of WDC building consent file has been completed.
 - Payment of any outstanding invoices, including Development Contributions, are received.

BC240219
Building Name: New dwelling Location within Site: 4.920 m set back to front boundary Level/Unit Number: Single level detached dwelling
Compacted Hardfill - pre DPM - Engineer to also inspect excavation.
Foundation / Floor Slab - Engineer to inspect also.
Structure Pre Roof Pre Wrap -
Building Wrap & Sill Tape -
Mid Height Veneer -
Drains -
Preline & Plumbing -
Prestopping -
Final -

Please give at least 2-3 full working days' notice for the next required inspection, please be advised that it may not always be possible to carry out the inspection within the time frame you require.

Signature Homes Limited New House

Lot 878 Ravenswood, Woodend File Number 24008.013



TC2 RIBRAFT DRAWINGS

Issue Register

Rev	Date	Description
1	06.03.2024	Consent

Sheet List

Sheet No.	Rev	Date Issued	Sheet Title
S1	1	06.03.2024	General Notes
S2	1	06.03.2024	RibRaft Layout Foundation Plan
S3	1	06.03.2024	Foundation Details
S5	1	06.03.2024	Typical Services Penetration Details

WAIMAKARIRI DISTRICT COUNCIL
Plans and specifications APPROVED in accordance
with the Building Act 2004, clause 49 and the Building
Regulations 1992, Clause 3
BC 240219 5/04/2024 steved

CONSENT ISSUED BC240219 - Page 4 of 29

contractor shall verify all dimensions before commencing work

GENERAL

- These drawings are not to be used for construction until the plan (sheet S2) is signed by the main contractor.
- Do not scale. Refer any discrepancies to the Architect.
- These drawings are to be read in conjunction with the Architects drawings.
- The builder shall be responsible for any damage to works during construction.
- The sand blinding layer shall be 20mm min. & 50mm max. to aid levelling & to prevent rocking of pods.
- Vapour barrier to be 0.25mm (250 micron) polythene complying with NZS 4229 / NZS 3604.
- · Finished ground level adjacent to slab to be protected from wind, water erosion and undermining.

FOUNDATIONS

Refer:

Ref. No: 43918

Bearing: 200kPa

Dated: 02-07-2023

GEOTECHNICAL REFERENCE:

Davis Ogilvie

Geotechnical Assessment Report

- · For assumed allowable bearing capacity refer to calculations/installer guide. Unless otherwise noted in documentation.
- If there is any doubt about the integrity of the material on which the slab is to be founded -Supervising Engineer must be notified immediately.

CONCRETE

- · All workmanship & materials to conform to NZS 3109, NZS 4210 & local authority
- Minimum covers to reinforcement:
- Exposed to earth 75mm.
- Protected by vapour barrier 50mm.
- Not exposed to weather except for a brief period during construction 25mm.
- No holes or chases other than those specified are to be made in the slab without the approval of Engco.
- All concrete shall have 20mm nominal maximum aggregate size & 120mm slump & shall comply with NZS 3109.
- All concrete to be mechanically vibrated & carefully worked around the reinforcement & into the corners of the formwork.
- Ribraft make-up to be

100mm Floor Slab - 220 pods 25 MPa min. TC2 Dramix 4D 80/60 fibre mix G500E SE-62 Ductile mesh on 50mm chairs

The design Fibre mix shall be supplied so that the residual flexural tensile stresses f_{R,1} & f_{R4,K} shall be 1.5 MPa & 1.0 MPa respectively.

REINFORCEMENT

- All reinforcing shall be New Zealand sourced and conform to AS/NZS 4671 :2001 in grade 300 or grade 500E.
- All bends to be made cold without fracture.
- · All reinforcing shall be deformed type unless otherwise stated.
- Grade 500E deformed bars shall be designated 'H', Grade 300 deformed bars shall be designated 'D' and Grade 300 round bars shall be designated 'R'.

Minimum bar lap.		H12 bars	H16 bars
	L	720mm	900mm


- All reinforcement to be fixed & tied where necessary in its specified position.
- · Welding of steel is not permitted.
- Spacers:
- Edge at 1200mm ctrs (one on edge & two on corners, typically).
- Internal one on each side of pod (typically).
- · All mesh shall comply with AS/NZS 4671 & shall conform with elongation requirements exceeding 10%.
- All mesh shall lap a minimum of 250mm (end extensions not included in lap length).

INSPECTIONS

Inform ENGCO consulting 48 hours in advance of any inspections required for code compliance certification. Contact ENGCO - Ph. 03 366 7955 & quote ENGCO Ref. No.

- 1. Confirm bearing at excavation by ENGCO
- 2. Contractor to supply (4) N.D. Tests at finished compacted surface if depth of fill is greater than 400mm
- 3. Pre-pour of slab by ENGCO

INSPECTIONS REQUIRED

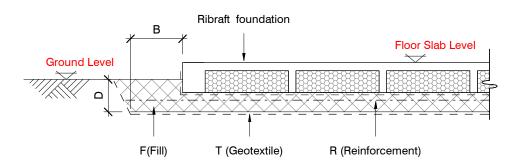


BUILDING PLATFORM

WAIMAKARIRI DISTRICT COUNCIL Plans and specifications APPROVED in accordance with the Building Act 2004, clause 49 and the Building Regulations 1992, Clause 3 BC 240219 5/04/2024 steved

	BUILDING PLATFORM TABLE:									
В	500mm									
D	300-600mm bgl (approx.)									
Т	N/A									
R	N/A									
F	AP40 or AP65 fill - 95% Dry Density. Compact in 150mm layers max.									

Refer Architectural drawings for Finished Floor Level

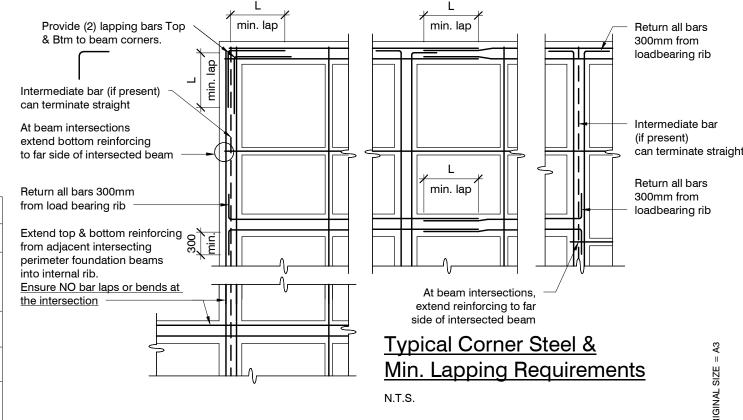





New House

Lot 878 Ravenswood, Woodend

General Notes

24008.013 B.Clark T.Guo M.Cusiel appyd S₁ March 2024

06.03.2024 Consent

necessary, are shown on the drawing.

Slab drawn to Architectural framing and DOES NOT ACCOUNT

Use Architectural drawings for any framing overhang

Control Joints, to control long term shrinkage cracking, if

In addition to these, in order to minimise the potential for early

shrinkage cracking where aesthetics is important, 25mm deep sawn joint may be positioned at major changes in the floor

plan shape and at a maximum recommended spacing of 5.0m.

300 Typ

S3

Garage Rebate

(refer architect for setout)

S3

For more information, refer to Section 6.2 of the Firth Ribraft

information which may affect slab dimensions.

OPTIONAL SHRINKAGE CRACKING CONTROL:

SLAB PLAN SETOUT:

FOR ANY OVERHANG.

Technical Manual

3

S3

S3

Locations shown of internal floor beam thickenings are indicative only. It shall be the


responsibility of the Contractor to ensure that they are located centrally under the load bearing walls to which they pertain.

contractor shall verify all dimensions before commencing work

Under no circumstance should pipework for services be run longitudinally in 100mm ribs. Similarly they should not be run along perimeter foundations nor internal floor beam thickenings

Vertical or horizontal penetrations through the foundation edge beam or floor beam thickenings must be made through the middle third of the member. Vertical penetrations


Refer to Architects drawings for floor slab, set

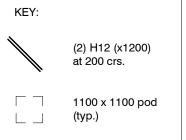

100mm Floor Slab - 220 pods


The design Fibre mix shall be supplied so that

All Mesh shall lap a minimum of 250mm

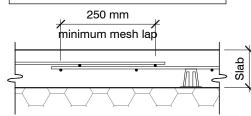

should not be made through 100 mm ribs.


downs, steps, rebates, holding down bolts, cast-in componentry and the like.

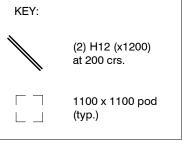

25 MPa min. TC2 Dramix 4D 80/60 fibre mix G500E SE-62 Ductile mesh on 50mm chairs

the residual flexural tensile stresses f_{R,1} & f_{R4,K} shall be 1.5 MPa & 1.0 MPa respectively.

(end of extensions not included).

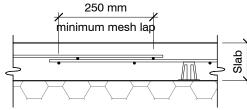

RIBRAFT FOUNDATION LAYOUT PLAN

H12 (x3000)

(Typ. at each rib)

3

S3

Refer Architects drawings for slab dimensions

WAIMAKARIRI DISTRICT COUNCIL Plans and specifications APPROVED in accordance with the Building Act 2004, clause 49 and the Building Regulations 1992, Clause 3 BC 240219 5/04/2024 steved

03 366 7955 office@engco.nz **Consulting Engineers**



New House

Lot 878 Ravenswood, Woodend

RibRaft Layout Foundation Plan

24008.013 B.Clark T.Guo

06.03.2024 Consent


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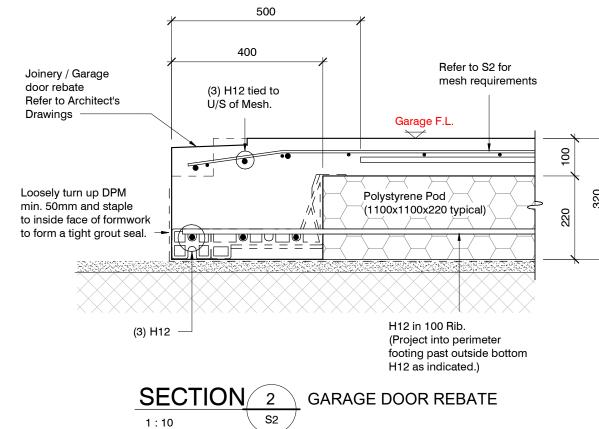
March 2024


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S2





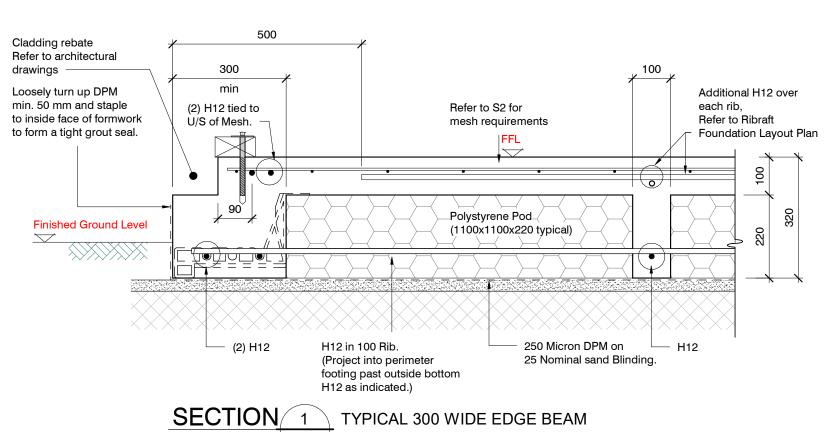

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1 06.03.2024 Consent

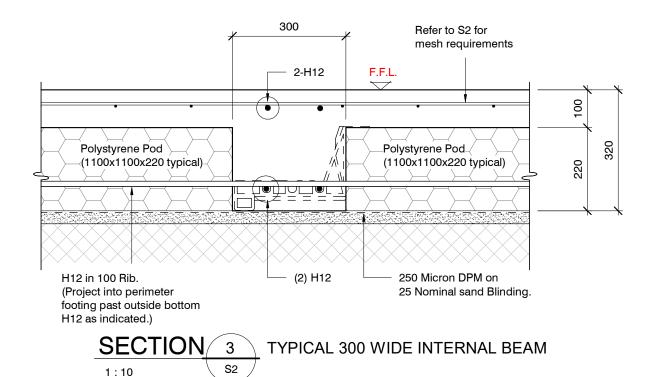design B.Clark

file 24008 013

ENGCO 03 366 7955 office@engco.nz www.engco.nz www.engco.nz

1:10



New House


CONSENT ISSUED BC240219 - Page 6 of 29


Lot 878 Ravenswood, Woodend


AUCKLAND | CHRISTCHURCH | NELSON | QUEENSTOWN


Foundation Details

| design | B.Clark | drawn | T.Guo | date | March 2024 | S3 | 1

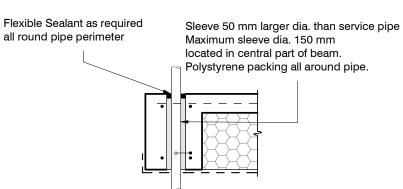

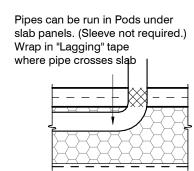

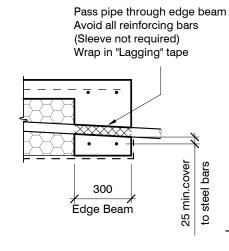

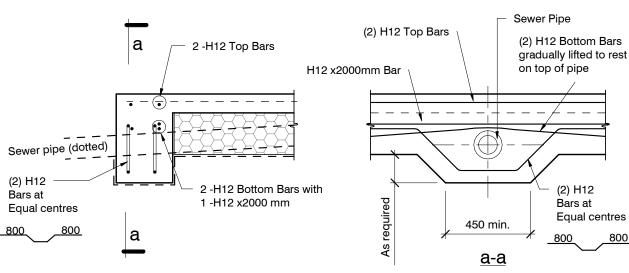


SLAB SERVICES PENETRATION DETAIL

PIPE NOTE:

No separation required where pipes are fully contained within slab. Sleeve all drains that pass through the base of the slab.


PENETRATIONS NOTE: Where penetrations through Floor Slab exceed 450 mm Square, Crack Control Bars will be required.

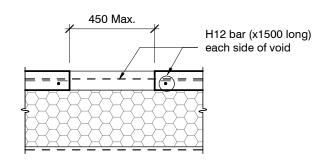

TYPICAL SECTION LOCALISED DEEPENING OF FOUNDATION BEAM

TO ACCOMMODATE TOILET WASTE PIPE

LARGE SLAB PENETRATION DETAIL

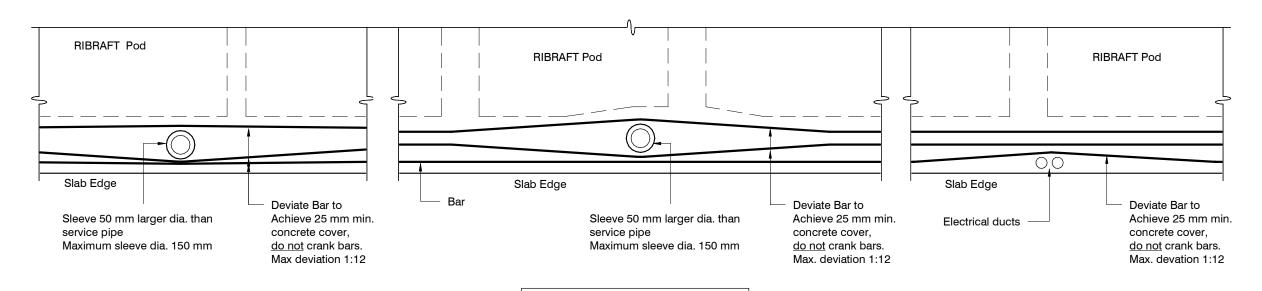

WAIMAKARIRI DISTRICT COUNCIL
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FOUNDATION SERVICES PENETRATION DETAILING.

Do not cut longitudinal reinforcement bars.

Services shall not run along ribs or edge beams.






New House

Lot 878 Ravenswood, Woodend

Typical Services
Penetration Details

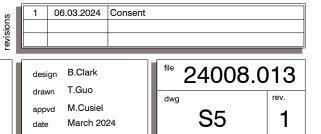

AUCKLAND | CHRISTCHURCH | NELSON | QUEENSTOWN



Contents: Sheet 1: **Cover Sheet** Sheet 2: Site Plan Sheet 3: Floor Plan Sheet 4: Elevations Sheet 5: **Elevations Cross Sections** Sheet 6: Sheet 7: Roof Plan Sheet 8: Set Out Dimensions Sheet 9: Foundation Plan Sheet 10: Drainage Plan Sheet 11: Bracing Plan Sheet 12: Lighting Plan Framing Details Sheet 13: Sheet 14: Framing Details Sheet 15: **Construction Details** Sheet 16: **Construction Details** Sheet 17: **Construction Details Construction Details** Sheet 18: Sheet 19: **Plumbing Details** Sheet 20: **Bathroom Details** Sheet 21: Truss Design Truss Design Sheet 22:

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All dimensions are to be check and confirmed prior to any construction

Plans are to be read in conjunction with Specifications and all supporting documentation



TKR Homes Ltd. 31 Watts Road, Sockburn PO BOX 11 351 Christchurch 8443

P: +64 3 342 7788

These drawings are limited to and by the extent of the detail covered in the drawings to meet the current New Zealand Building Code (NZBC). Where detail it required for construction and to demonstrate compliance with the current NZBC, a specific request should be made for the required detail to be supplied. No liability will be accepted for any detail or construction not covered in these drawings and/or carried out by persons other than the designer producing these documents.

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DRAWING NOTES

These drawings are subject to copyright and remain the property of Signature

Verify all dimensions, sizes and levels on site prior to commencing any work. Any discrepancies are to be confirmed with

Refer to attached Specifications for further

All work is to comply with the NZBC Acceptable Solutions, NZS 3604:2011 and Local Authority bylaws.

I hereby confirm that the building has been set out in cordance with consented site plans and the finished loor level complies with the minimum level indicated

CONSENT ISSUED BC240219 - Page 9 of 29

DRAINAGE LEGEND

Stormwater Drain uPVC Sewer Drain uPVC Downpipe

GT ORG Gully Trap Overflow Relief Gully TV Terminal Vent AAV Air Admittance Valve Inspection Point

Provide safety fencing to perimeter of site - permanent or temporary to comply with NZBC F5/AS1

SITE INFORMATION


Site Area 520m² Floor Area (veneer) : 131.06m² / 25.20%


Roof Area:

Wind Earthquake Exposure

Note: The dimensions shown are from cladding to boundary. Refer to sheet 8 for foundation to boundary dimensions

Sediment control and site safety requirements are noted in the attached Specifications.

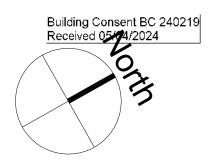

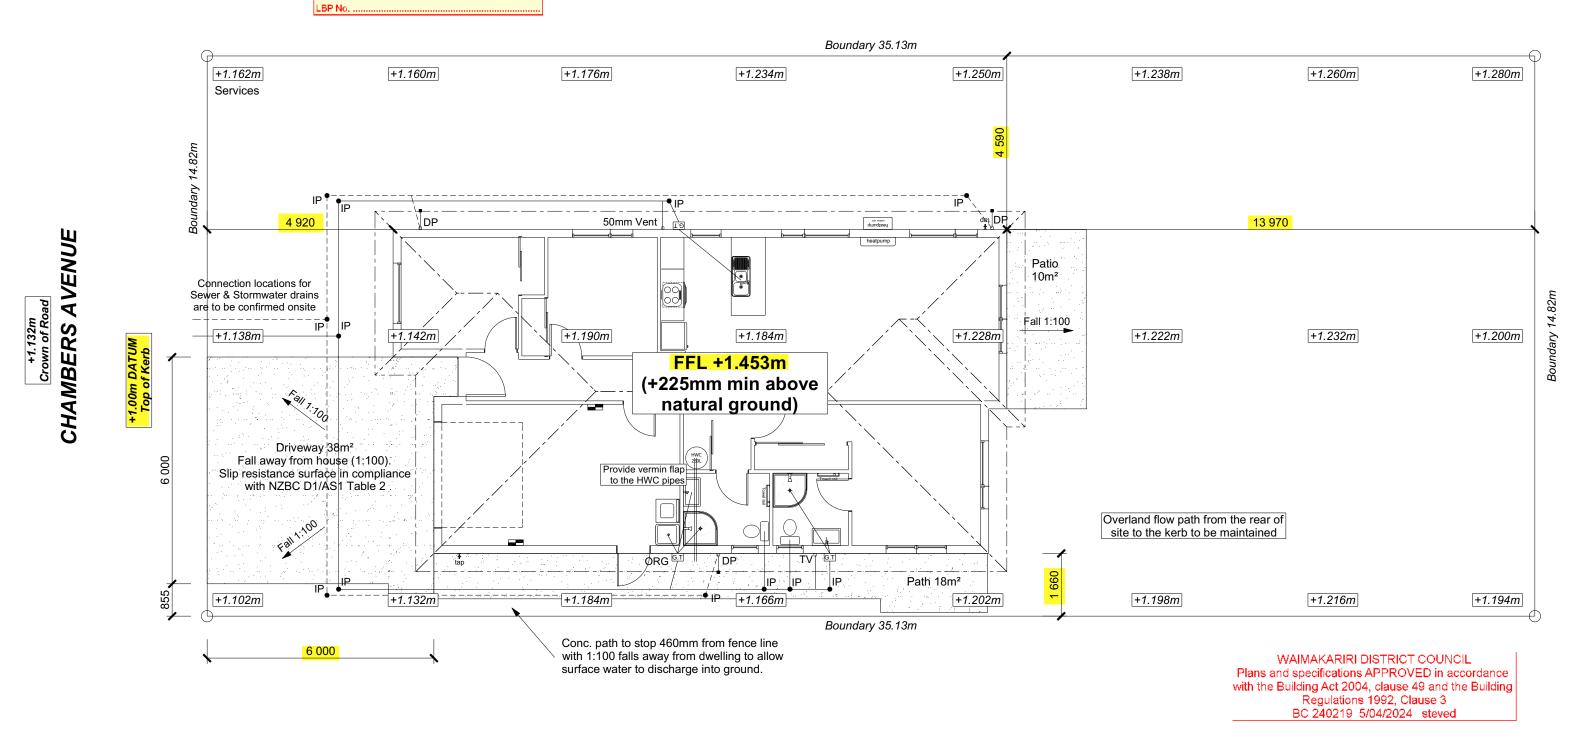

All dimensions are to be check and confirmed prior to any construction

Plans are to be read in conjunction with Specifications and all supporting doct





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ROOF & WALL CLADDINGS

Roof: 25° Pressed Metal Tiles Walls: 70 Series Brick Veneer (clay) with a 50mm cavity

DWELLING AREAS

Framing Area: 125.01m² (Perimeter: 49.94m) Veneer Area: 131.06m² (Perimeter: 50.90m) Roof Area: 156.47m² (Perimeter: 53.46m)

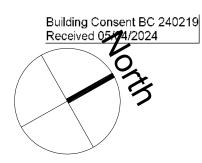SMOKE ALARMS (hush type) Domestic Smoke Alarms to be fitted within 3.0m of sleeping areas and on Escape routes as indicated on plan. To comply with one of the following standards: UL 217, ULC-S531, AS 3786, BS 5446 (part 1).

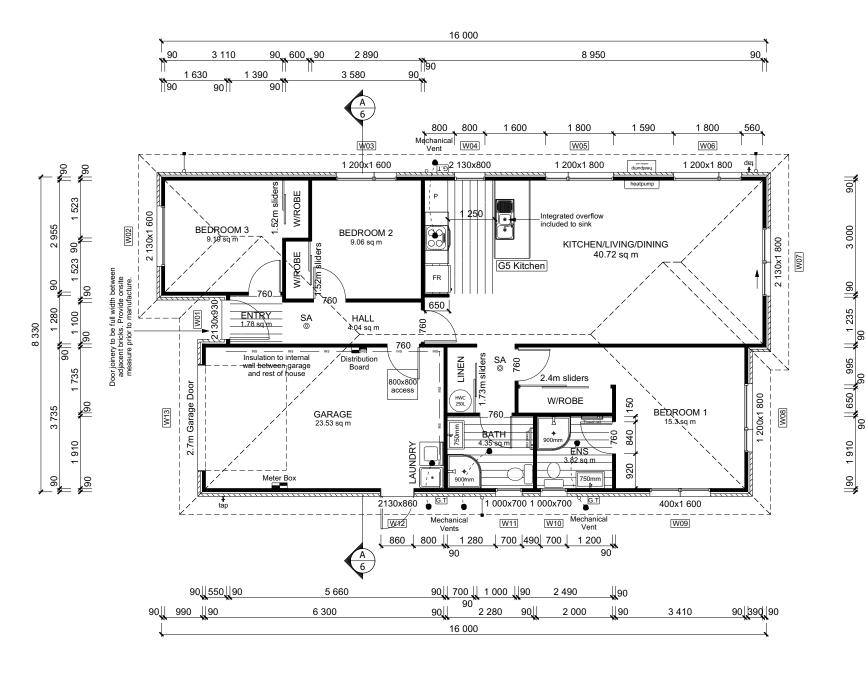FLOOR PLAN NOTES

Dimensions shown are to the frame, GIB thickness not shown. Mechanical ventilation to comply with G4/AS1 Air Seals to have PEF rod & low expansion foan All windows and doors centered in room unless shown otherwise

Laundering facilities provided complying with G2/SA1 1.0

Provide sealant under skirting and paint to concrete around tub & W/M fixtures



WALL FRAMING Stud Height: 2400 mm (2455mm to u/s of bottom chord)

FLOOR FINISHES Carpet & Vinyl Sheet

KITCHEN HOB Electric Hobs

DOORS

Internal Height: 1980mm (leaves) Leaf widths as shown on the plan (R/O +80mm) Type: Hollow core flush panel Front Door Type: Latitude Aluminium

ALUMINIUM WINDOW JOINERY

Double Glazed Low-E/4 with Argon Gas and Thermally Improved Spacers (R0.37) Standard single glazing to Garage

INTERNAL TRIMS

Scotia: 55mm GIB Coving (excluding garage) Skirting: 60x12mm Pine, single bevel edge

Shelf & Rails to all wardrobes 4 shelves to Linen cupboard

DRAWING NOTES

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Verify all dimensions, sizes and levels on site prior to commencing any work. Any discrepancies are to be confirmed with

Refer to attached Specifications for further information

All work is to comply with the NZBC Acceptable Solutions, NZS 3604:2011 and Local Authority bylaws.

of 22 sheets

CONSENT PLANS Sheet Name: Sheet No.: Original Plan: 3

1:100

WAIMAKARIRI DISTRICT COUNCIL Plans and specifications APPROVED in accordance with the Building Act 2004, clause 49 and the Building Regulations 1992, Clause 3 BC 240219 5/04/2024 steved

All dimensions are to be check and confirmed prior to any construction Plans are to be read in conjunction with Specifications and all supporting docu



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Darryl Harris Lot 878, DP 589336 46 Chambers Avenue Ravenswood, Woodend

Kingfisher 246623 **FLOOR PLAN** Print Date

M Glynn

Date: Reason:
12-03-2024 Initial Consent Plans

Building Consent BC 240219 Received 05/04/2024

ROOF & WALL CLADDINGS

Roof: 25° Pressed Metal Tiles

Walls: 70 Series Brick Veneer (clay)
with a 50mm cavity

ELEVATION LEGEND

SS Safety Stays
SG Safety Glass
TV Terminal Vent

ELEVATION NOTES

Gutter : Coloured Steel Quad Gutter Fascia : Coloured Steel 185 Fascia Downpipes : Colorsteel Rectangular 75x55mm

Soffits: Hardiflex 4.5mm
Joinery: Low-E double glazed joinery


Single glazing to Garage

All egress points to have a maximum step

Access routs to have slip resistance surface in compliance with NZBC D1/AS1 Table 2 and to have a 1:100 fall away from the building



SCORE

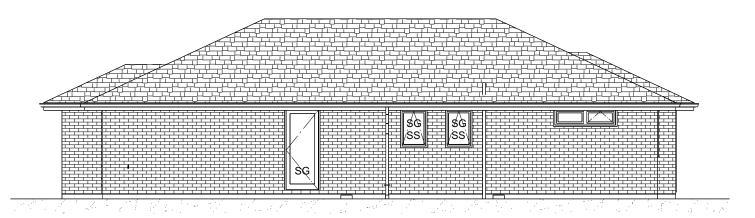

ELEVATION A



BUILDING ENVELOPE RISK MATRIX ELEVATION B RISK CRITERIA RISK SCORE Wind Zone High 1 Number of Stories Low 0 Roof Wall Junction Low 0 Eaves Width Medium 1 Building Envelope Low 0 Decks & Balconies Low 0 Total 2

BUILDING ENVELOPE RISK MATRIX

ELEVATION A

RISK

Medium Low

Low

RISK CRITERIA

Decks & Balconies
Total

Wind Zone Number of Stories Roof Wall Junction Eaves Width Building Envelope

ELEVATION B

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BC 240219 5/04/2024 steved

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ate:	Scale:						

Building Consent BC 240219 Received 05/04/2024

ROOF & WALL CLADDINGS

Roof: 25° Pressed Metal Tiles Walls: 70 Series Brick Veneer (clay) with a 50mm cavity

ELEVATION LEGEND

SS SG TV Safety Stays Safety Glass Terminal Vent

ELEVATION NOTES

Gutter: Coloured Steel Quad Gutter Coloured Steel 185 Fascia Fascia Downpipes : Colorsteel Rectangular 75x55mi

Hardiflex 4.5mm Joinery:

Low-E double glazed joinery Single glazing to Garage

All egress points to have a maximum step


Access routs to have slip resistance surface in compliance with NZBC D1/AS1 Table 2 and to have a 1:100 fall away from the building

PLANS

Sheet No.:

5

of 22 sheets

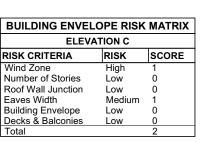


RISK CRITERIA

Roof Wall Junction Eaves Width Building Envelope

Decks & Balconies
Total

Wind Zone Number of Stories

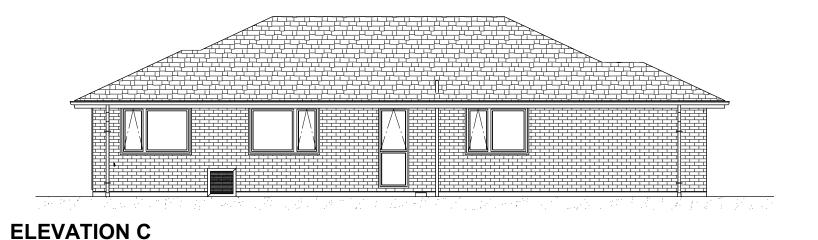



BUILDING ENVELOPE RISK MATRIX **ELEVATION D** RISK CRITERIA RISK SCORE Wind Zone Number of Stories Low Roof Wall Junction Eaves Width Medium Building Envelope Low Decks & Balconies

ELEVATION D

WAIMAKARIRI DISTRICT COUNCIL Plans and specifications APPROVED in accordance with the Building Act 2004, clause 49 and the Building Regulations 1992, Clause 3 BC 240219 5/04/2024 steved

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Plans are to be read in conjunction with Specifications and all supporting documentation



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ROOF & WALL CLADDINGS

CROSS SECTION NOTES

Building wrap is to comply with E2/AS1 & NZS 3604:2011.


Flashing materials must be selected based or environmental exposure. Refer to NZS 3604:2011 & table 20 of E2/AS1. Flashing tape must have proven compatibility

with the selected wrap & other materials with which it comes into contract as per table 21 of E2/AS1.

Fixings shall comply with NZS 3604:2011 Section 4 Durability Tables 4.1-4.3 Unless stated otherwise, timber members on drawings are to be a minimum of SG8 strength graded as per NZS3604:2011.

Joinery : Low-E double glazed Aluminium Joinery. Single glazing to Garage

Ceiling: Pink Batts R3.2 + R3.6 Ceiling Batts Wall: Pink Batts R2.6 Wall Batts

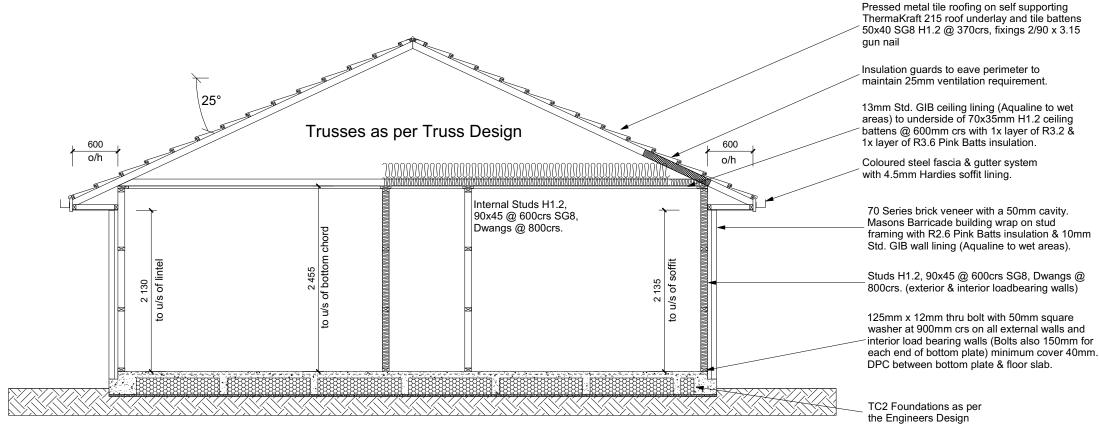

CROSS SECTION A-A

WAIMAKARIRI DISTRICT COUNCIL Plans and specifications APPROVED in accordance with the Building Act 2004, clause 49 and the Building Regulations 1992, Clause 3 BC 240219 5/04/2024 steved

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Darryl Harris Lot 878, DP 589336 46 Chambers Avenue Ravenswood, Woodend

Original Plan: Kingfisher 246623 M Glynn

Sheet Name:

CROSS SECTIONS Print Date

1:50

All work is to comply with the NZBC Acceptable Solutions, NZS 3604:2011 and Local Authority bylaws. **CONSENT PLANS** Sheet No.:

Signature Homes Ltd.

DRAWING NOTES

Homes Ltd.

information

Date: Reason: 12-03-2024 Initial Consent Plans

These drawings are subject to copyright and remain the property of Signature


Verify all dimensions, sizes and levels on

Refer to attached Specifications for further

site prior to commencing any work. Any discrepancies are to be confirmed with

of 22 sheets

6

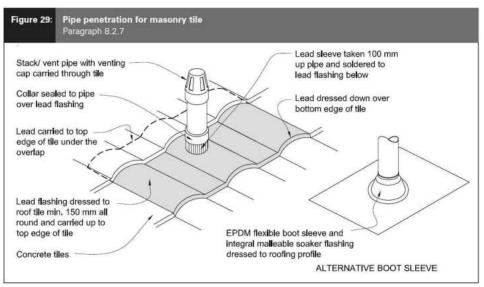


Metal Tile Penetration Detail Scale NTS

8.3.10 Roof penetrations

Pipe penetrations shall be flashed using EPDM flashings similar to that shown for masonry tiles, Figure 29.

CONSENT ISSUED BC240219 - Page 14 of 29

A pair of tensioned and crossed LUMBERLOK Strip Brace running continuously from ridge to top plate installed as detailed below. Building Consent BC 240219

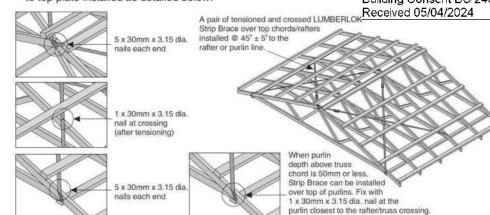

Downpipes: 75x55 Rectangle Colorsteel As per NZBC E1/AS1 Table 5 75x55 down pipes can collect up to 60m² of Use Coloured steel Quad Gutter

As per NZ Metal Roof and Wall Cladding Code of Practice Version 2 section 8 the above gutter with a cross sectional area of 5550mm2 can collect up to 60m2 of 0-25° roof plan area. Refer to the specifications for exact calculations

25° Pressed Metal Tiles

50x40 SG8 H1.2 @ 370crs,

fixings 2/90 x 3.15 gun nail

ROOF CLADDING

ROOF PLAN NOTES

Soffits: Hardiflex 4.5mm

Gutter: Coloured Steel Quad Gutter

Fascia: Coloured Steel 185 Fascia

Downpipes: Colorsteel Rectangular 75x55mm


Underlay: Thermakraft 215 roof underlay

Roofing:

Tile Battens :

Use Lumberlock top plate fixing chart attached to the main specifications to determine top plate fixings.

As per NZ Roofing COP, provide expansion joins to fascia & gutter every 9m for dark colours & 12m for light colours.

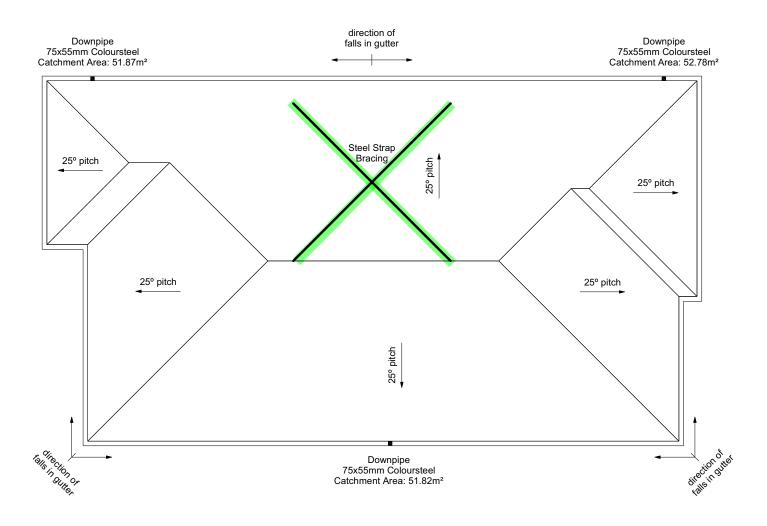

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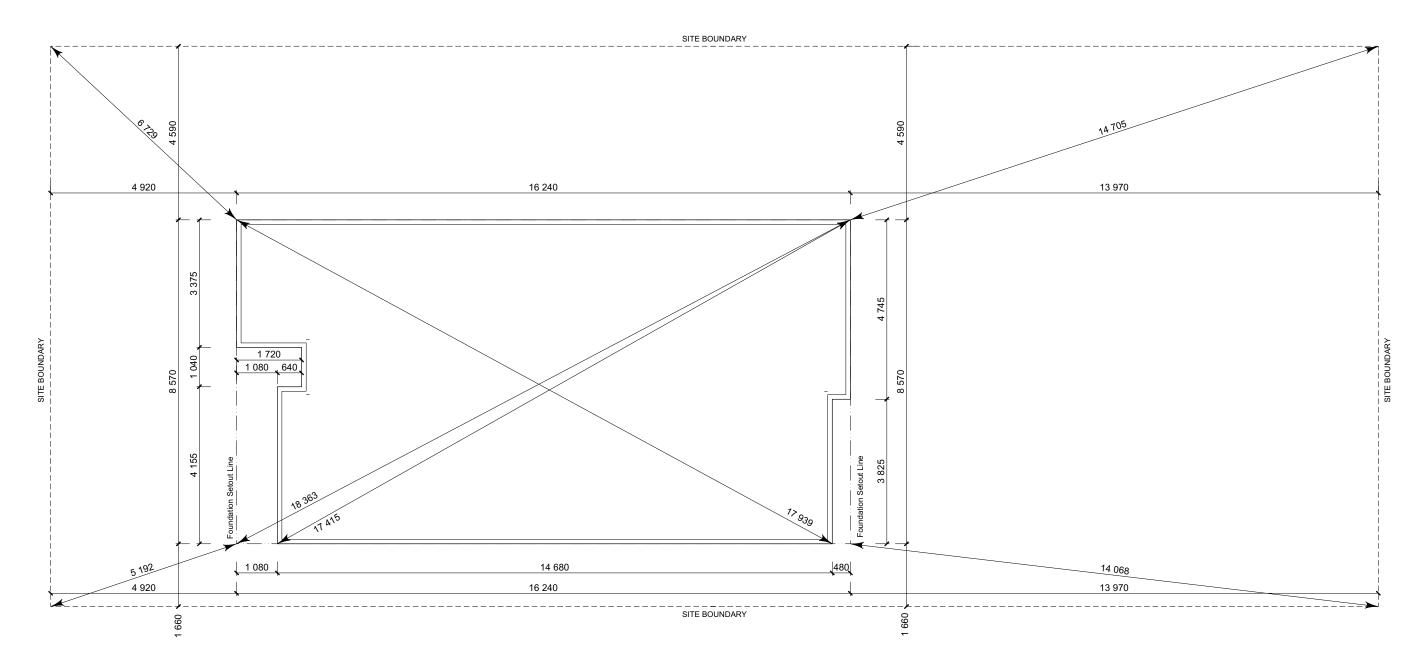
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SET OUT PLAN NOTES

All dimensions over foundation face. Allow (120mm rebate) 70mm veneer & 50mm cavity, Brick to overhang foundation face by 0-20mm max as per NZBC E2/AS1.
All reinforcing is to be Ductility Class E, in accordance with NZS 4671.
All concrete to comply with NZS3604:2011 Section 4 Durability Clause 4.5.2.

These foundations are design to the findings and recommendations in the site specific Geotech report.



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Darryl Harris Lot 878, DP 589336 46 Chambers Avenue Ravenswood, Woodend

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CHAMBERS AVENUE

FOUNDATION PLAN NOTES

All dimensions over foundation face. Allow (120mm rebate) 70mm veneer & 50mm cavity, Brick to overhang foundation face by 0-20mm max as per NZBC E2/AS1. W/C location indicated on plan has assumed a 140mm offset from internal frame line, please consult manufacturer's documentation to confirm offset.

Contractor to consult manufacturer's documentation to determine the correct location for all wastes positioned through floor slabs.
Earth bar to be bonded to the reinforcing

mesh Refer to Truss design for exact location of

All reinforcing is to be Ductility Class E, in accordance with NZS 4671. All concrete to comply with NZS3604:2011 Section 4 Durability Clause 4.5.2.

These foundations are design to the findings and recommendations in the site specific Geotech report.

AREA TO PERIMETER RATIO

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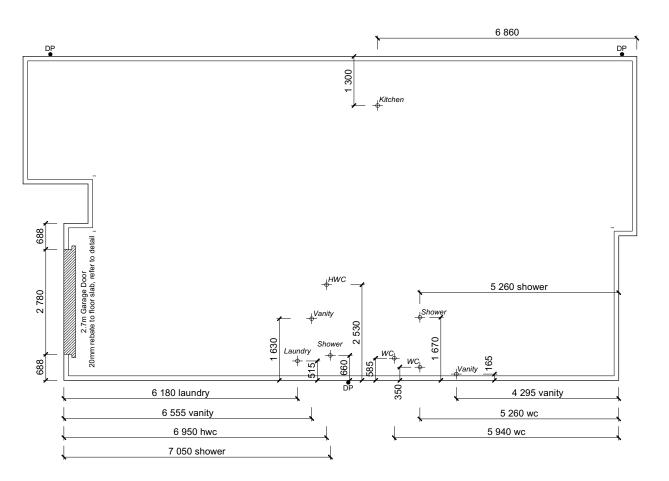
9

of 22 sheets

Foundation Area: 131.06m² Perimeter: 50.90m Ratio: 2.57

FFL +1.453m (+225mm min above natural ground)

> Refer to Engineers Foundation Design



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DRAINA	GE LEGEND
	Stormwater Drain uPVC
	— Sewer Drain uPVC
DP	Downpipe
GT	Gully Trap
ORG	Overflow Relief Gully
TV	Terminal Vent
ΛΛ\/	Air Admittance Valve

Inspection Point


NZBC G13 Plumbing Schedule Kitchen Ø50mm @1:40 Sink: (3 discharge units) Bathrooms Ø40mm @ 1:40 Ø40mm @1:40 Ø40mm @1:40 Vanity: (1 discharge units per basin) (2 discharge units) (4 discharge units) Shower Bath: Ø100mm @1:40 Ø40mm @1:30 (4 discharge units) (5 discharge units) WC: Laundry Sink: Drainage Schedule NZBC G13 Main Foulwater Ø100mm @1:60 (1:120max) Ø90mm & Ø100mm @1:60 (1:120max) Vented Drain Stormwater Drain Terminal Vent Ø80mm

Ø50mm


Drain over GT Overflow Relief Gully min 20mm Drain over GT

Vent Heatpump ORG

Hot water Cylinder

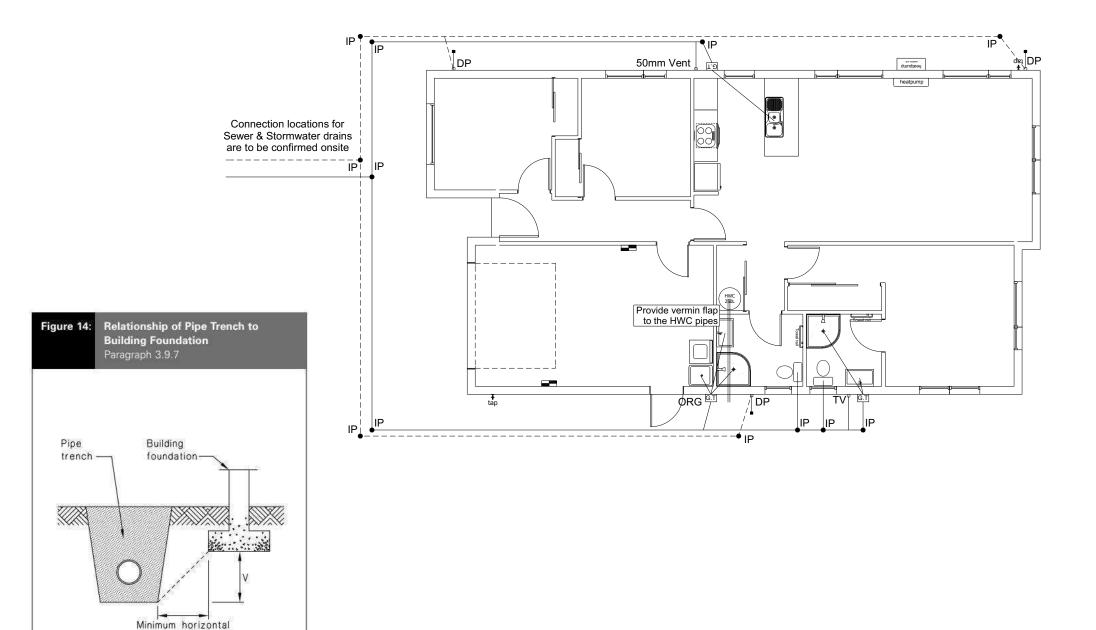

All plumbing and drainage to comply with NZBC G13. ORG to be positioned so the top of gully dish is no less than 150mm below overflow level of lowest fixture
Sewer & Stormwater to connect to existing connections.
All drains passing through concrete, provide sleeve or wrap in durable and flexible to allow for expansion and contraction. (as per G13/AS2 5.8.1) HWC: Safe tray to HWC with 50mm overflow drain to exterior to comply with G12/AS1.

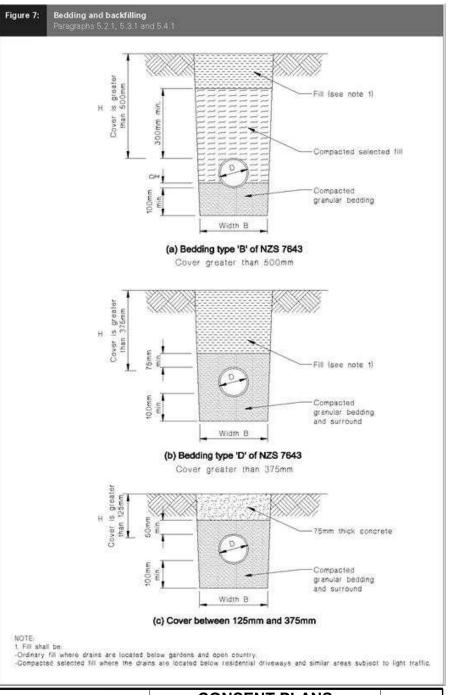

Sheet No.:

10

of 22 sheets

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seperation V or 3V (See paragraph 3.9.7)

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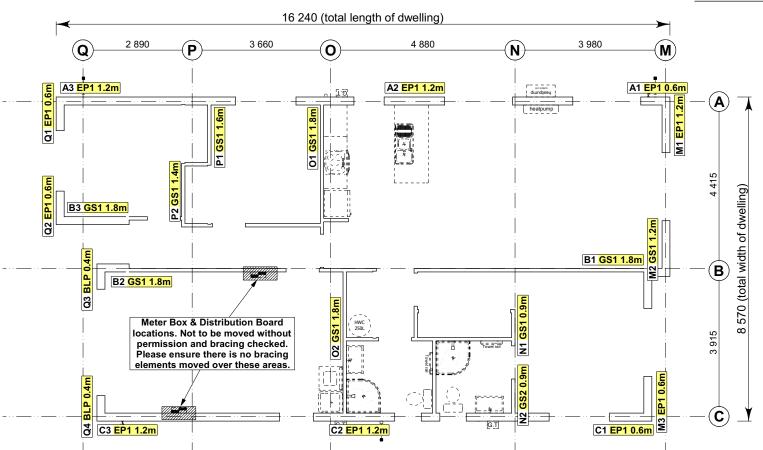
Regulations 1992, Clause 3

BC 240219 5/04/2024 steved

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Building Consent BC 240219 Received 05/04/2024



8.7.3.4


Each wall that contains one or more wall bracing elements shall be connected at the top plate level, either directly, or through a framing member in the line of the wall, to external walls at right angles to it. Top plate fixing(s) of the capacity in tension or compression along the line of the wall bracing element are given as follows:

- For each wall containing wall bracing elements with a total bracing capacity of not more than 125 bracing units: to at least one such external wall by a fixing as shown in figure 8.16 of 6 kN capacity;
- (b) For each wall containing wall bracing elements with a total bracing capacity of not more than 250 bracing units: to at least 2 external walls by fixings as shown in figure 8.16 each of 6 kN capacity;
- For each wall containing wall bracing elements with a total bracing capacity of more than 250 bracing units; to at least 2 external walls by fixings as shown in figure 8.16 each having a rating of not less than 2.4 kN per 100 bracing units.

BRACING PLAN NOTES

Wall bracing designed in accordance with NZS 3604:2011 & GIB Ezybrace system Refer to attached calculations.

Bracing Designed to: Wind: High Earthquake: 2

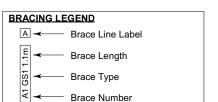

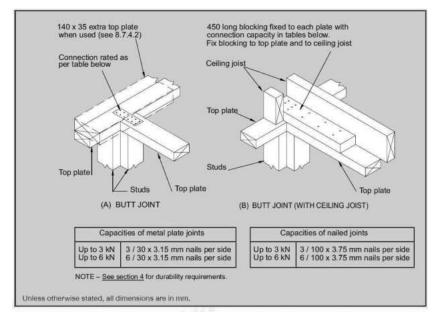


Figure 8.16 - Connecting top plates to external walls at right angles - Walls containing bracing (see 8.7.3.4)

Single Level Along Resistance Sheet

Job N	ame: Harris	5							Wind	EQ
									Den	nand
									437	787
									Achi	eved
Line	Element	Length	Angle	Stud Ht.	Type	Supplier	Wind	EQ	1063	1098
		(m)	(degrees)	(m)		1010	(BUs)	(BUs)	243%	140%
	-1	0.60		2.4	EP1 0.6	Ecoply®	57	63		
	2	1.20		2.4	EP1 1.2	Ecoply®	144	162		
A	3	1.20		2.4	EP1 1.2	Ecoply®	144	162		
			100						345 OK	387 OF
	1	1.80		2.4	GS1-N	GIB®	124	108		
	2	1.80		2.4	GS1-N	GIB®	124	108		
В	3	1.80		2.4	GS1-N	GIB®	124	108		lin.
									373 OK	324 OK
	1	0.60		2.4	EP1 0.6	Ecoply®	57	63		
С	2	1.20	1 1	2.4	EP1 1.2	Ecoply®	144	162		
C	3	1.20		2.4	EP1 1.2	Ecoply®	144	162	1	
									345 OK	387 OK

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Regulations 1992, Clause 3
BC 240219 5/04/2024 steved

Single Level Across Resistance Sheet

OD N	ame: Harris								Wind	EQ
									Den	nand
									816	787
									Achi	eved
Line	Element	Length	Angle	Stud Ht.	Type	Supplier	Wind	EQ	1086	1051
		(m)	(degrees)	(m)	1000	1013	(BUs)	(BUs)	133%	134%
	-1	1.20		2.4	EP1 1.2	Ecoply®	144	162		
	2	1.20		2.4	GS1-N	GIB®	83	72		
M	3	0.60		2.4	EP1 0.6	Ecoply®	57	63		
									284 OK	297 OK
	1	0.90		2.4	GS1-N	GIB®	57	53		
N	2	0.90		2.4	GS2-N	GIB®	80	71		9
									136 OK	124 OK
	1	1.80		2.4	GS1-N	GIB®	124	108		
0	2	1.80		2.4	GS1-N	GIB®	124	108		
									248 OK	216 OK
	1	1.60		2.4	GS1-N	GIB®	110	96		
P	2	1.40		2.4	GS1-N	GIB®	97	84		
									207 OK	180 OK
	1	0.60		2.4	EP1 0.6	Ecoply®	57	63		
	2	0.60		2.4	EP1 0.6	Ecoply®	57	63		
Q	3	0.40		2.4	BLP-H	GIB®	48	54		
	4	0.40		2.4	BLP-H	GIB®	48	54		
		7	12						211 OK	234 OK

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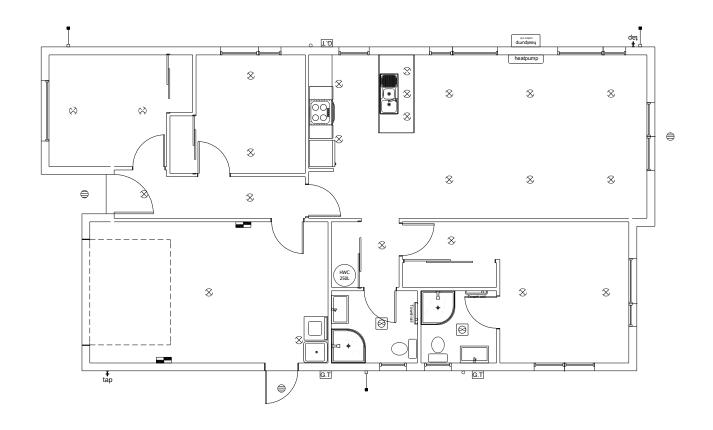



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Darryl Harris Lot 878, DP 589336 46 Chambers Avenue Ravenswood, Woodend

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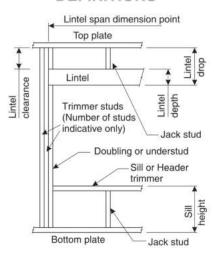
LINTEL FIXING SCHEDULE

ALTERNATIVE TO TABLE 8.14 & FIGURE 8.12 NZS 3604:2011

NOTE:

- * All fixings are designed for vertical loads only. Dead loads include the roof weight and standard ceiling weight of 0.20kPa.
- ★ Refer to Table 8.19 NZS 3604:2011 for nailing schedule to resist horizontal loads.
- * These fixings assume the correct choice of rafter/truss to top plate connections have been made
- * All fixings assume bottom plate thickness of 45mm maximum. Note: TYLOK options on timber species.
- * Wall framing arrangements under girder trusses are not covered in this schedule.
- ★ All timber selections are as per NZS 3604:2011.

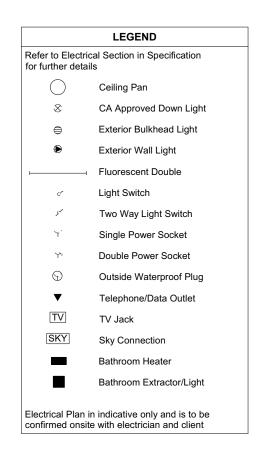DEFINITIONS




Li	ntel Sup	porting	Girder	Trusses					
Roof Tributary	L	ight Roc	of	Heavy Roof					
Area	V	ind Zon	ie	W	Wind Zone				
	L, M, H	VH	EH	L, M, H	VH	EH			
8.6m²	G	G	Н	G	G	Н			
11.6m²	G	Н	Н	G	G	Н			
12.1m ²	G	Н	Н	G	Н	Н			
15.3m²	Н	Н		G	Н	Н			
19.1m²	Н	-	-	G	Н	-:			
20.9m ²	Н	-	0.20	Н	Н	24			
21.8m ²	н	9	- 3	Н	-	-			
34.3m ²	201	-	S.=2	Н	-	-:			


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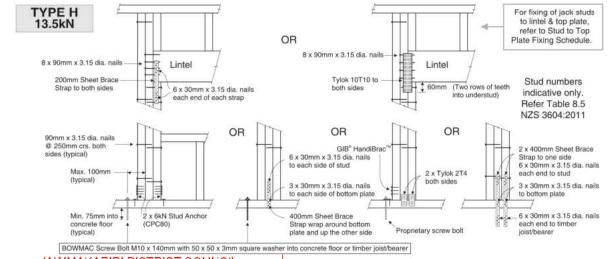
- 1. Roof Tributary Area = approx. 1/2 x (Total roof area on girder and rafter trusses supported by lintel)
- 2. Assumed girder truss is at mid-span or middle third span of lintel
- 3. Use similar fixings for both ends of lintel
- 4. All other cases require specific engineering design

Lintel	Loaded			tht R				Heavy Roof Wind Zone			
Span (m)	Dimension (m) (See Fig. 1.3 NZS 3604:2011)	L	М	Н	VH	EH	L	М	н	VH	EH
	2.0	Е	Е	E	F	F	Ε	E	E	E	F
	3.0	E	Ē	F	F	F	Ē	E	E	F	F
1.0	4.0	E	F	F	F	G	Ē	E	F	F	F
	5.0	E	F	F	G	G	E	E	F	F	G
	6.0	E	F	F	G	G	E	E	F	F	G
	2.0	E	E	F	F	F	Е	Е	E	F	F
	3.0	E	Е	F	F	F	Ε	E	F	F	F
1.2	4.0	E	F	F	G	G	E	E	F	F	G
	5.0	E	F	F	G	G	Е	E	F	F	G
	6.0	F	F	G	G	Н	E	E	F	G	G
	2.0	E	E	F	F	F	E	E	E	F	F
	3.0	E	F	F	F	G	E	E	F	F	F
1.5	4.0	E	F	F	G	G	E	E	F	F	G
	5.0	F	F	G	G	H	E	E	F	G	G
	6.0 2.0	F	F	G	H	H	E	E	F	G	H
	3.0	E	F	F	G	G	E	E	F	F	G
2.0	4.0	F	F	G	G	Н	E	E	F	G	G
2.0	5.0	F	F	G	Н	н	E	E	F	G	Н
	6.0	F	G	G	Н	Н	E	F	G	Н	Н
	2.0	E	F	F	G	G	E	E	F	F	G
	3.0	F	F	G	G	Н	E	E	F	G	G
2.4	4.0	F	F	G	Н	Н	E	E	F	G	Н
	5.0	F	G	G	Н	Н	E	F	G	Н	Н
	6.0	F	G	Н	Н	-	E	F	G	Н	Н
	2.0	E	F	F	G	G	E	E	F	F	G
	3.0	F	F	G	Н	Н	E	E	F	G	Н
3.0	4.0	F	G	G	Н	Н	E	F	G	Н	Н
	5.0	F	G	Н	Н	-	E	F	G	Н	Н
	6.0	F	G	Н	-		E	F	G	Н	
	2.0	F	F	G	G	H	E	E	F	G	G
3.6	3.0 4.0	F	F	G	H	H	E	F	G	G	H
3.0	5.0	F	G	Н	-	- 50	E	F	G	Н	-
	6.0	G	Н	Н		-	Ē	F	Н	-	
	2.0	F	F	G	G	Н	E	E	F	G	G
	3.0	F	G	Н	Н	-	E	F	G	Н	Н
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	5.0	G	Н	Н		*:	E	F	Н		
	6.0	G	Н	-	-	-	E	F	Н	9	
	2.0	F	F	G	Н	Н	E	E	F	G	Н
	3.0	F	G	Н	Н		E	F	G	Н	Н
4.5	3.4	F	G	Н	Н	- 20	E	F	G	Н	Н
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LINTEL FIXING OPTIONS





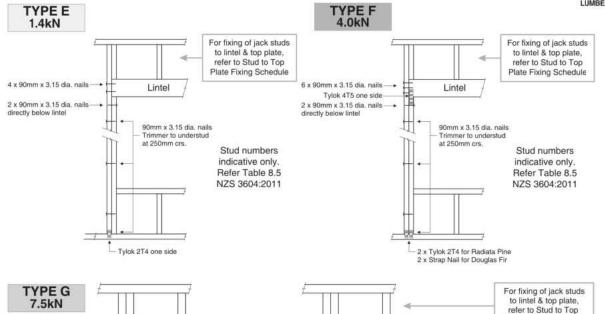
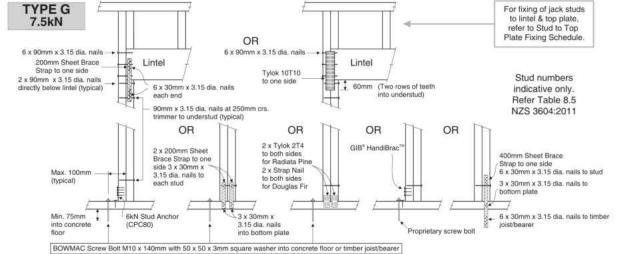
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Job Numb	er:	0	riginal Plan:	Sheet	Name:			C	ONSENT PLANS	Sheet No.:
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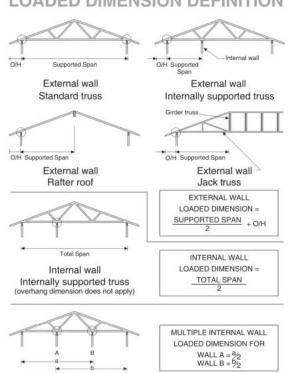


STUD TO TOP PLATE FIXING SCHEDULE

ALTERNATIVE TO TABLE 8.18 NZS 3604:2011

- * All fixings are designed to resist vertical loads only. Dead loads include the roof weight and standard ceiling weight of 0.20kPa.
- ★ Refer to Table 8.19 NZS 3604:2011 for nailing schedule to resist lateral loads.
- * These fixings assume the correct choice of rafter/truss to top plate connections have been made.
- ★ For gable end walls where the adjacent rafter/truss is located within 1200mm and with a maximum verge overhang of 750mm, select stud to top plate fixing using a loaded dimension of 1.5m.
- * All fixings assume top plate thickness of 45mm maximum.
- * Wall framing arrangements under girder trusses are not covered in this schedule.
- * All timber selections are as per NZS 3604:2011.

LOADED DIMENSION DEFINITION



FIXING SELECTION CHART

Multiple internal walls


(Suitable for walls supporting roof members at 600, 900 or 1200mm crs.) Wind Zones L, M, H, VH, EH, as per NZS 3604:2011

	Dimens tud Centre	4	Light Roof Wind Zone						Heavy Roof Wind Zone				
300mm	400mm	600mm	L	M	Н	VH	EH	L	M	Н	VH	EH	
3.0	2.3	1.5	Α	Α	В	В	В	Α	Α	В	В	В	
4.0	3.0	2.0	Α	Α	В	В	В	Α	Α	В	В	В	
5.0	3.8	2.5	Α	В	В	В	В	Α	Α	В	В	В	
6.0	4.5	3.0	Α	В	В	В	В	Α	Α	В	В	В	
7.0	5.3	3.5	Α	В	В	В	В	Α	Α	В	В	В	
8.0	6.0	4.0	Α	В	В	В	В	Α	Α	В	В	В	
9.0	6.8	4.5	В	В	В	В	В	Α	Α	В	В	В	
10.0	7.5	5.0	В	В	В	В	В	Α	Α	В	В	В	
11.0	8.3	5.5	В	В	В	В	В	Α	Α	В	В	В	
12.0	9.0	6.0	В	В	В	В	В	Α	Α	В	В	В	

FIXING OPTIONS

FIXING TYPE A 0.7kN

2 x 90mm x 3.15 dia. plain steel wire nails driven vertically into stud.

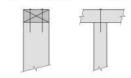

FIXING TYPE B CHOOSE ANY OF THE 3 OPTIONS BELOW

2 x 90mm x 3.15 dia. plain steel wire nails driven vertically into stud.










2 x 90mm x 3.15 dia. plain steel

wire nails driven vertically into stud.

2 x LUMBERLOK

Recommended for internal wall options to avoid lining issues

2 x 90mm x 3.15 dia. plain steel wire nails driven vertically into stud.

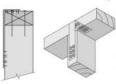



NOTE:

To calculate the number of B type fixings required, divide the wall length by the stud centres, add 1 to this figure and locate this number of fixings as evenly as possible along the wall length. This figure includes the start and end studs in each wall length.



SCAN FOR INSTALLATION VIDEO

Plus

https://vimeo.com/117353604

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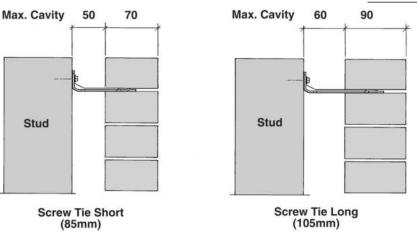
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70 SERIES BRICK

Building Consent BC 240219 90 SERIES BRIC Received 05/04/2024



* All brick work must be constructed in accordance with NZS 4210:2001 Masonry Construction: Materials and Workmanship, Screw Ties must be applied accordingly and are not to be hammered into timber framing.

* Water shedding shoulder prevents transfer of the moisture from tie to building.

* Nail hole for Oamaru Stone.

* Angled neck encourages increased tie embedment in mortar.

1.2mm NZCC-SD Hot Dip Galvanised Steel

Type 17-12g x 35mm Hex Head Hot Dip Galvanised Screws

250 ties per box including screws

WAIMAKARIRI DISTRICT COUNCIL

Also available in Stainless Steel Grade 316 for Zone D. Plans and specifications APPROVED in accordance


with the Building Act 2004, clause 49 and the Building

Regulations 1992, Clause 3 BC 240219 5/04/2024 steved

SCREW TIES FOR BRICK VENEER FIXING

★ Medium duty (EM) classification

- ★ Tested by BRANZ in accordance with AS/NZS 2699.1:2000
- * BRANZ test report No. ST0725 November 2007
- * Suitable for both 'dry bedding' and encapsulated mortar
- * Hot Dip Galvanised ties for Zones B & C, and Stainless Steel Grade 316 ties for Zone D meet NZS 3604:2011 Sect. 4 Durability
- * Available in 85mm and 105mm sizes

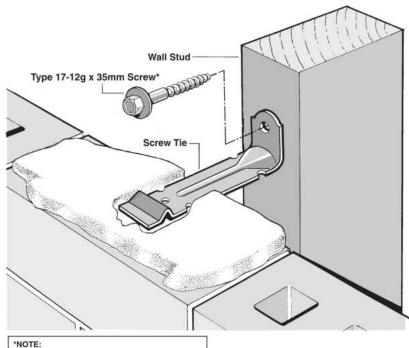


Use longer screws for fixing through Rigid Air Barrie (RAB). Maintain 35mm embedment in studs

Job Numb	oer:	Original Plan:		Sheet	Sheet Name:			CONSENT PLANS				
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of 22 sheets



Where windows extend to soffit, flashing tape is to be fixed prior to ribbon board being fixed to framing. Detail Tape Location to Wall Openings Sill tape to be turned up over trimmer stud 200mm min. Sill tape to be turned up over trimmer stud 150mm min. Sill tape to be continuous along entire sill Trim all building wrap to finish flush with inside face of stud frame wall Sill Tape Flashing Detail

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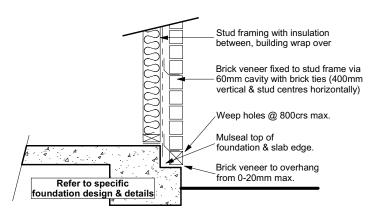

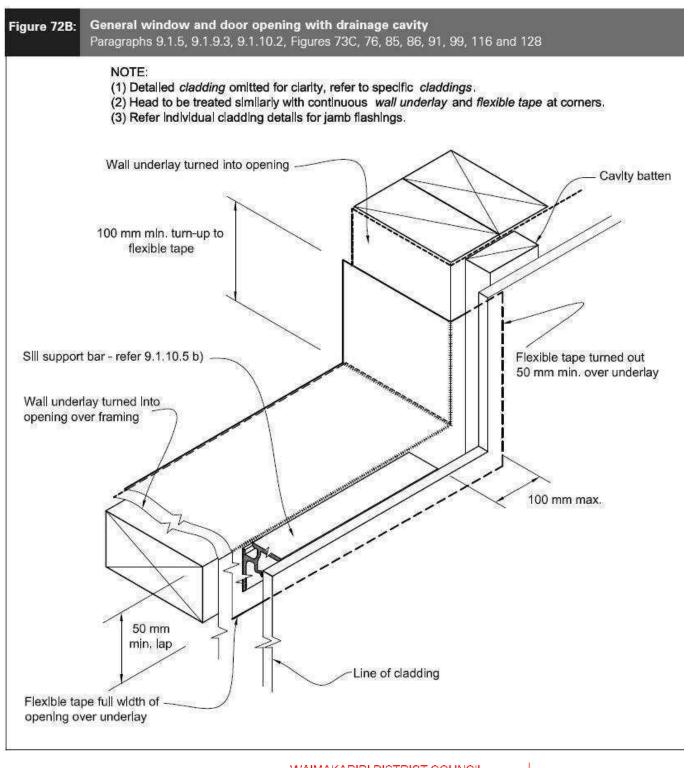
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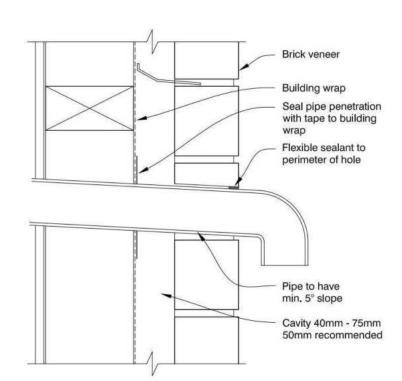
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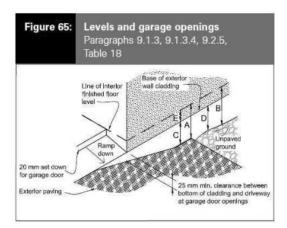


Brick Veneer Foundation Scale 1:20


Building wrap staple fixed to studframe @ 300crs max, wrap to be fixed horizontally with upper sheets to lap over lower sheet, allow 75mm cover min. End laps to be over stud, allow 150mm min lap (Support building wrap with Polypropylene tape at 300 mm centres 125mm x 12mm thru bolt with 50mm square washer at 900mm crs on all external walls and interior load bearing walls (Bolts also 150mm for each end of bottom plate) minimum cover 40mm. DPC between bottom plate & floor slab. Refer Foundation

Stud framing to slab **Scale 1:20**








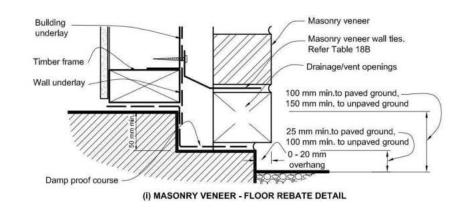

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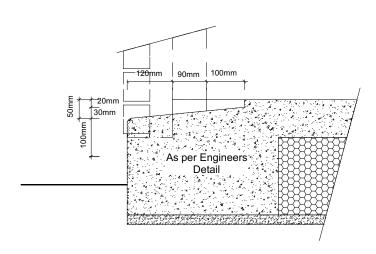

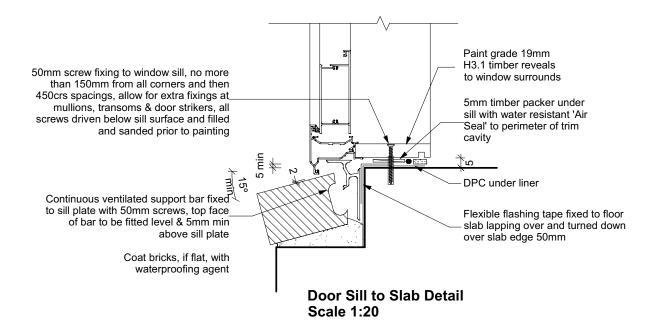
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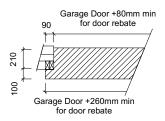
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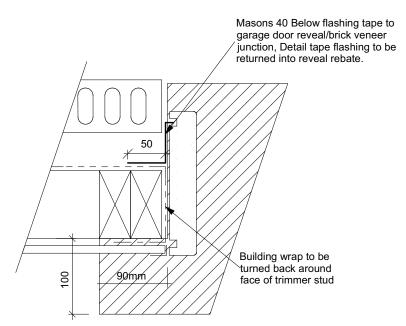
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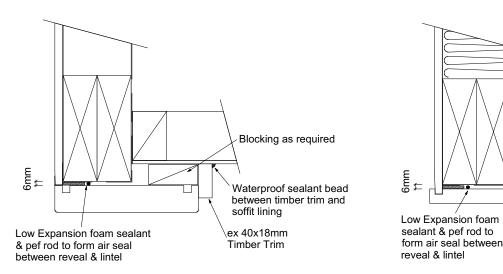
Garage Door Rebate Details Scale 1:10





Garage Door Jamb Detail Scale 1:5

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Garage Door Head to Soffit Scale 1:5

Window Head to Soffit Detail Scale 1:5

Low Expansion foam sealant & pef rod to form air seal between reveal & frame Continuous Support bracket segments for all windows. Sill flashing tape over building wrap to be continuous along entire sill length and turned down 50mm min down exterior face of framing Building wrap to be turned up and over sill trimmer of window opening Mathoid Sill flashing with drip edge, extend 200mm each side of window. Form drip edge with H3.2 timber kick-out fillet

Window Sill Detail Scale 1:5

pef rod to form air seal betweenreveal & frame

Building wrap to be turned round_ trimmer stud to window opening

Low Expansion foam sealant &

150mm wide Malthoid Jamb flashing to each side of window

Line of head and sill flashings extended 200mm each side of opening

Window Jamb Detail Scale 1:5


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9.1.10.8 Attachments for windows and doors

Install windows and doors using pairs of minimum 75 x 3.15 galvanised jolt head nails or 8 gauge x 65 mm stainless steel screws, through reveals into surrounding *framing* at:

- a) Maximum 450 mm centres along sills, jambs and heads, and
- b) Maximum 150 mm from reveal ends.

Install packers between reveals and *framing* at all fixing points, except between head reveals and lintels.

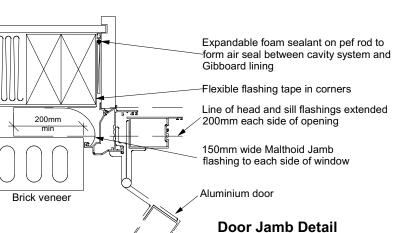

Scale 1:5

Waterproof sealant bead

and soffit lining

between aluminium joinery

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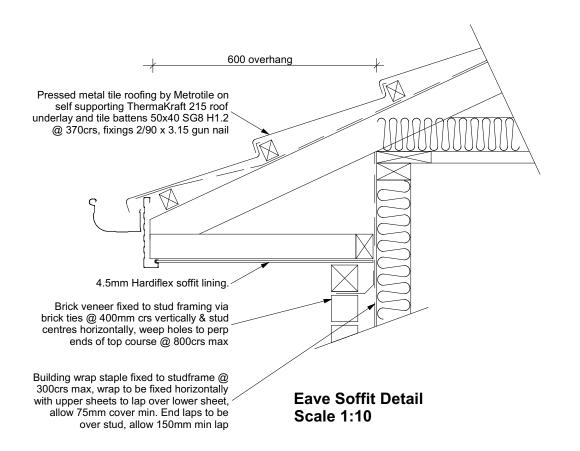
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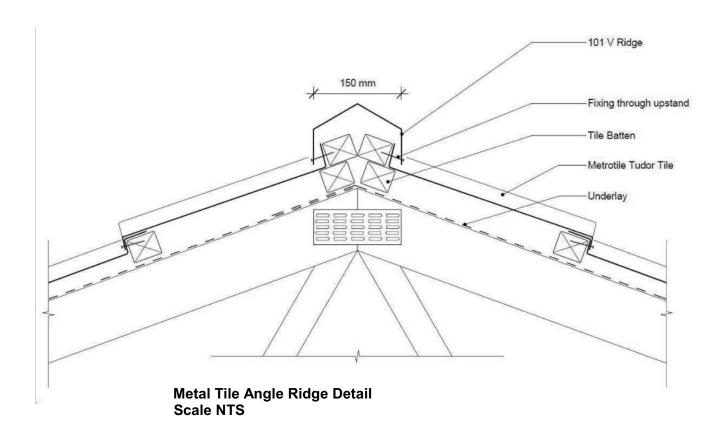
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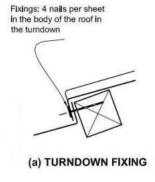
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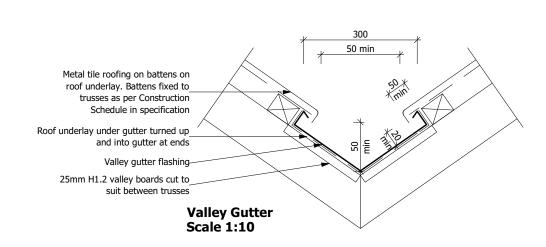


Neoprene washer under fixing

(b) CREST FIXING

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Metal Tile Fixing Detail Scale NTS



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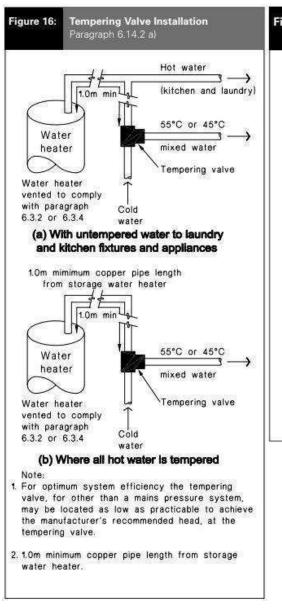
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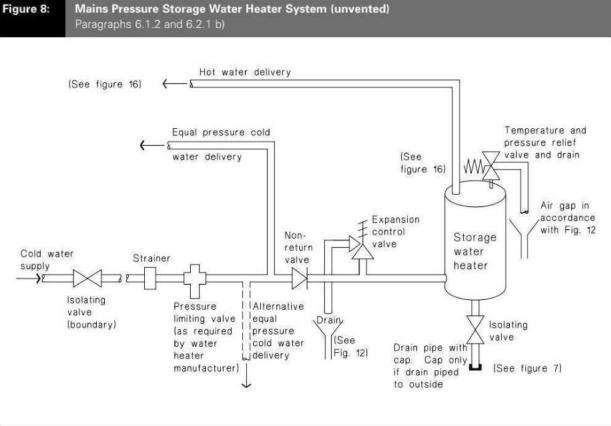
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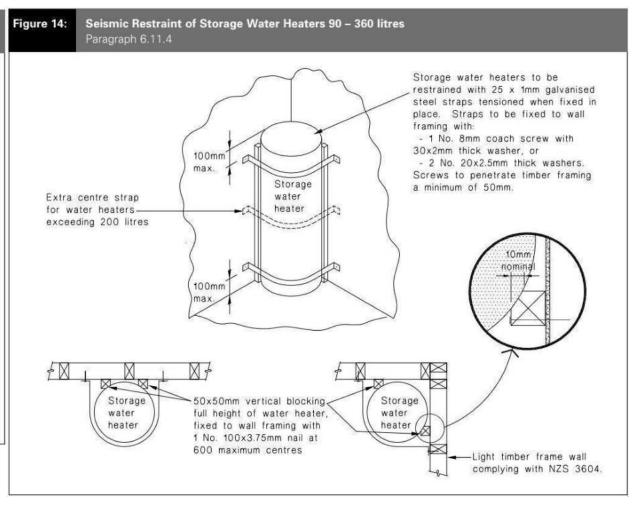
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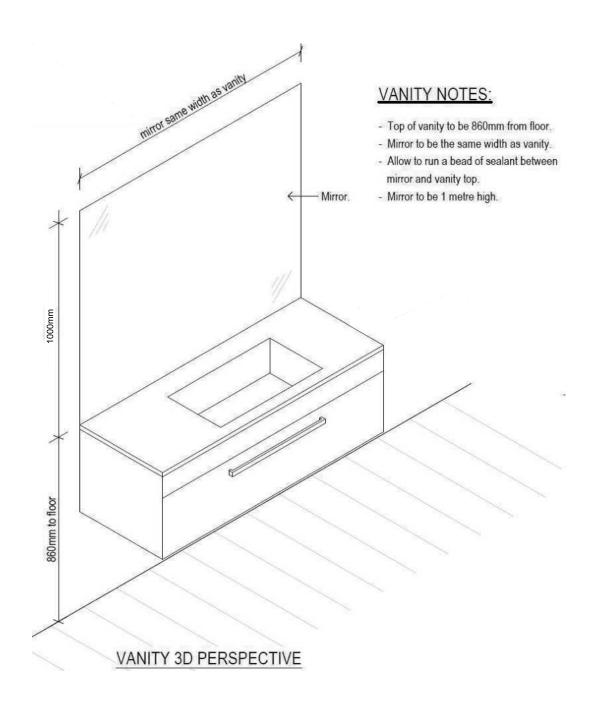



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H3.2 SG8 Timber Framing

10mm GIB Aqualine with Enamel Gloss or Semi Gloss top Coat of Paint.

60mm pine skirting board.
For Laundry: skirting to be pre primed with sealant under skirting and paint to concrete around tub & W/M fixtures.

Silicone Sealant
Flexible sheet vinyl fully bonded to floor substrate with all seams hot welded.

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Buildable Consent Layout

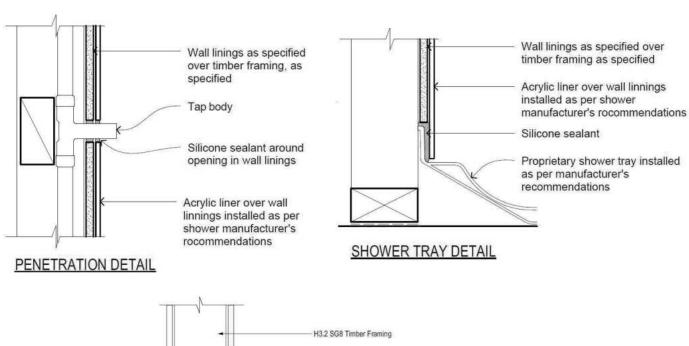

For valley/saddle truss fixing unless stated otherwise use a pair of wire dogs at 900mm centres for up to and including a very high wind zone. Or a pair of CT200's at 900mm centres for extra high wind zone. This fixing is to meet the minimum requirements as per NZS3604.

CARTERS


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- Dotted lines show top chords continuing up to hip board (No bottom chord below).





Truss Fixings

A = 47x90 Joist Hanger

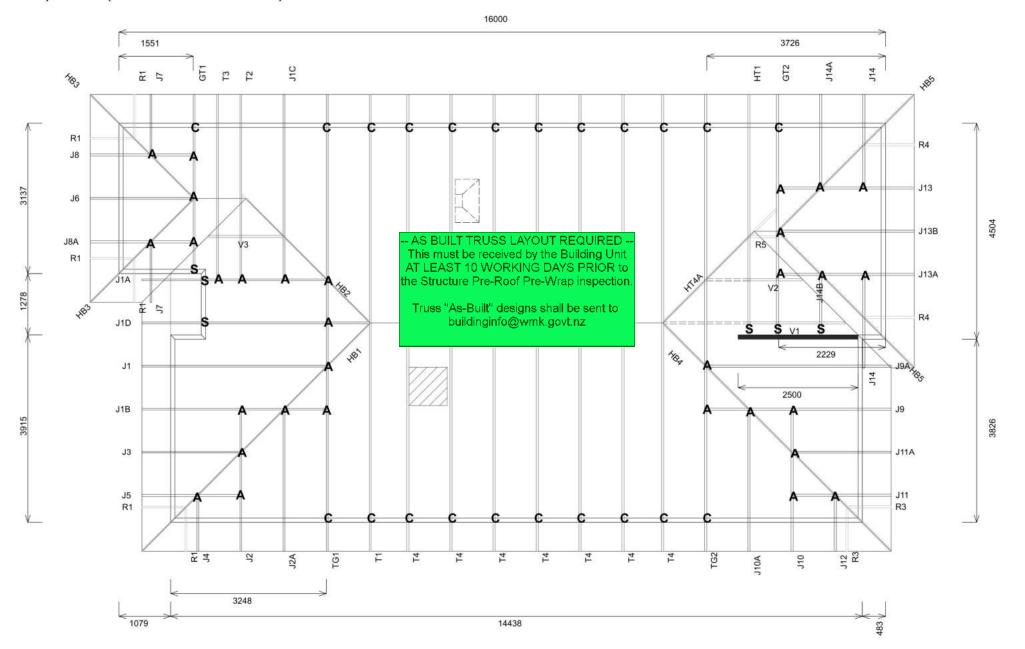B = 47x120 Joist Hanger

C = CT200 (pair)

D = 47x190 Joist Hanger

E = 95x165 Joist Hanger

F = SH-140 Split Hanger

G = SH-180 Split Hanger

H = SH-220 Split Hanger

J = 2x6kN Strap (12kN)

K = 6kN Strap

L = Multigrip (single)

M = Multigrips (pair)

N = Nailon Plate (240x110x1)

P = 16kN Pack

Q = 9kN Pack

S = CPC 40 Single Cleat

T = CPC 40 Short (pair)

U = CPC 80 Single Cleat

V = 16kN Uplift
Z = Engineers Design

Unless otherwise indicated, all specified

truss fixings are to use L/Lok product nail fasteners or Type 17 - 14g Hex Head Screws (as per the MiTek On-site Guide)

All truss to frame fixings require 2 additional 2/90x3.15dia skew nails.

All truss fixings not indicated as above must have 2 wire dogs for cross joints and 2/90x3.15dia nails for butt joins.

Fixings shown are for fixing trusses to the top plate. Any other point load uplift fixings down through the framing stud to top plate, stud to bottom plate, bottom plate to floor remain the responsibility of the architect / draughtsman.

Any roof loads as stated on this layout over 16kN lift are outside the scope of NZS3604, and the architect / draughtsperson is responsible for the design to transfer the loads to the

Snow Zone:	Christchurch (N4)
Wind Area:	High
TC Restraints:	400 mm
Roof Material:	Metal Tiles
Roof Pitch:	25.00 °
Snow Altitude:	100.000 m
Design Wind Speed:	44.0 m/s
BC Restraints:	600 mm
Ceiling Material:	Standard Plaster Board 13mm
Ground Snow Load:	0.900 kPa
Truss Centres:	900 mm

MiTek SAPPHIRE
Every Facet an Advantage.

Drawn: Kyle Samson

Date: 27/02/2024

Job No: RG1405424C1

Customer: TKR Homes Limited | T/A Signature Homes Canterbury

Job Name: Harris Lot 878

Address: 46 CHAMBERS AVENUE Woodend, WOODEND 7691 If a gable truss requires a windbeam brace, the type of MiTek brace will be noted as such on the layout. The truss fixings can be substituted for other fixings of the same or greater capacity.

All verge framing to be fixed according to the MiTek On-Site Guide if not covered by NZS3604.

If bottom chord restraints are 35mm Metal battens, then they must be fixed with either two nails or screws.

If the metal battens are fixed with a single nail or screw then 90x45mm bottom chords restraints will be required at 1800mm centres

All loads shown on this page regarding the truss fixings are characteristic loads

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31 Watts Road, Sockburn PO BOX 11 351 Christchurch 8443

covered in the drawings to meet the current New Zealand Building Code (NZBC). Where detail it required for construction and to demonstrate compliance with the current NZBC, a specific request should be made for the required detail to be supplied. No liability will be accepted for any detail or construction not covered in these drawings and/or carried out by persons other than the designer producing these documents.

These drawings are limited to and by the extent of the detail

Job Number: 246623		Original Plan:	Sh	Sheet Name:			CONSENT PLANS			
		Kingfisher	TRUSS DESIGN					Reason: Initial Consent Plans	21	
ales:	Drawn:	QS: W Xian	Print Date: 4/04/2024	Scale:	Δ3				of 22 she	

Building Partner

Buildable Consent Layout

FTMA

E12

L5 - 150x90 hy90 H1.2

All internal walls shown on this layout are considered to be loadbearing Lintel fixing specification remains the responsibility of the architect / draughtspers

Beams Loadbearing Walls Non Loadbearing Walls Slab thickening might not be required for internal walls, please check below

L12 - 150x90 hy90 H1.2

AS BUILT TRUSS LAYOUT REQUIRED

This must be received by the Building Unit AT LEAST 10 WORKING DAYS PRIOR to he Structure Pre-Roof Pre-Wrap inspection

Truss "As-Built" designs shall be sent to buildinginfo@wmk.govt.nz


WAIMAKARIRI DISTRICT COUNCIL Plans and specifications APPROVED in accordance with the Building Act 2004, clause 49 and the Building Regulations 1992, Clause 3 BC 240219 5/04/2024 steved

CARTERS

L10 - 150x90 hy90 H1.2 E11

L7 - 150x90 hy90 H1.2


Lintel Fixings are as per the included reports.

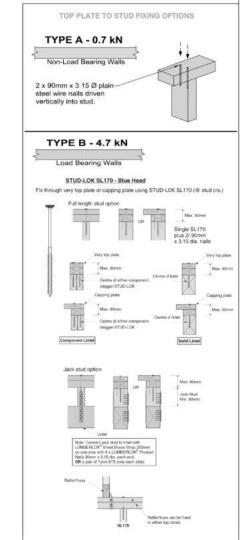

Note: These top plate to stud fixing options do not apply to walls under floors, just walls with trusses or rafters attached.

22

of 22 sheets

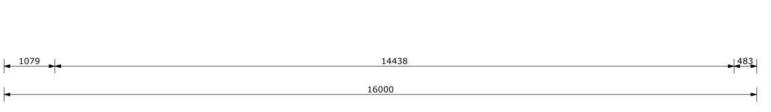

L4 - 2-90x45 SG8 DDP H1.2

SAPPHIRE Every Facet an Advantage

> Kyle Samson 27/02/2024

Job No: RG1405424C1

Customer: TKR Homes Limited | T/A Signature Homes Canterbury

Dn 8.036 kN Up 6.490 kN

Dn 8.948 kN Up 7.127 kN

Job Name: Harris Lot 878

Address: 46 CHAMBERS AVENUE Woodend, WOODEND 7691 Notification of point loaded lintels or point loads on internal walls where the downward load is higher than 8kN (85mm raft type slab) or 10kN (100mm standard slab), or the upward load is greater than 10kN. These loads are Ultimate Limit State Loads

L6 - 2-90x45 SG8 DDP H1.2

If no loads are shown, no thickening

The lintels have been sized using one of the following:

The MiTek SAPPHIRE Component Design Software.
hy90, hyONE and hySPAN lintels have been sized using the designIT for houses - New Zealand series 6 software.
GANGLAM and FLITCH BEAMS have been sized using the MiTek Beam Program V1.10 June 2011.

Unless otherwise stated the timber grade for all lintels is SG8. Lintels not shown are to be selected as per NZS3604: 2011 or designed by an engineer as required. The lintels have not been designed to support brick shelf angles. The Architect or Engineer is required to design all lintels supporting brick shelf angles.

All dimensions are to be check and confirmed prior to any construction

Date:

Plans are to be read in conjunction with Specifications and all supporting docu



TKR Homes Ltd. 31 Watts Road, Sockburn PO BOX 11 351

Christchurch 8443 P: +64 3 342 7788

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Job Number:		Original Plan:	Sheet Name:				CONSENT PLANS				
0.40000		16 6	TRUSS DESIGN			No.	Date:	Reason:			
246623		Kingfisher				1	12-03-2024	Initial Consent Plans			
											
ales:	Drawn:	QS:	Print Date:	Scale:							
		1	4/04/2024	NTC	0.40						
Gould	M Glyni	n W Xian	4/04/2024	NTS	@ A3						