Approved Building Consent Documents


Please Note: A copy of the stamped approved documents must be available on site for all inspections.

Inspection booking timeframes

| Call received | before 3pm inspection | after 3pm inspection | | | | | | | |
|---------------|-----------------------|----------------------|--|--|--|--|--|--|--|
| | will be done | will be done | | | | | | | |
| Monday | Wednesday | Thursday | | | | | | | |
| Tuesday | Thursday | Friday | | | | | | | |
| Wednesday | Friday | Monday | | | | | | | |
| Thursday | Monday | Tuesday | | | | | | | |
| Friday | Tuesday | Wednesday | | | | | | | |

Building inspections and enquiries phone: 03 347 2839

Please ensure all work for inspection is ready the day before. Incomplete work requiring re-inspection will incur an additional inspection fee.

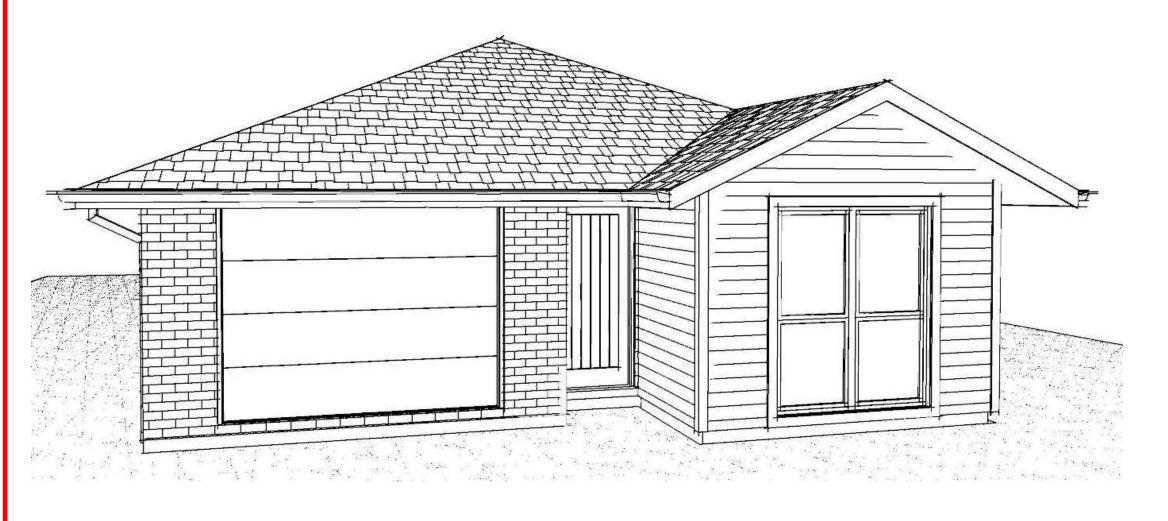

Contents: Sheet 1: **Cover Sheet** Sheet 2: Site Plan Sheet 3: Floor Plan Sheet 4: **Elevations** Sheet 5: Elevations Sheet 6: **Cross Sections** Sheet 7: Roof Plan Sheet 8: **Set Out Dimensions** Sheet 9: Foundation Plan Sheet 10: RibRaft Plan Sheet 11: Drainage Plan Sheet 12: **Bracing Plan** Sheet 13: Lighting Plan Framing Details Sheet 14: Framing Details Sheet 15: Sheet 16: **Construction Details** Sheet 17: **Construction Details** Sheet 18: **Construction Details** Sheet 19: **Construction Details** Sheet 20: **Construction Details** Sheet 21: **Construction Details** Sheet 22: **Bathroom Details** Sheet 23: **Plumbing Details** Truss Design Sheet 24: Truss Design Sheet 25:

All dimensions are to be check and confirmed prior to any construction

Plans are to be read in conjunction with Specifications and all supporting documentation





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SITE INFORMATION

Site Area : 516m² Floor Area (veneer) : 139.65m² / 27.06% Roof Area 166.57m² / 32.28%

Wind Earthquake

Exposure N 4 at 50m (up to 1kPa)

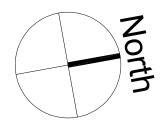Note: The dimensions shown are from cladding to boundary. Refer to sheet 8 for foundation to boundary dimensions

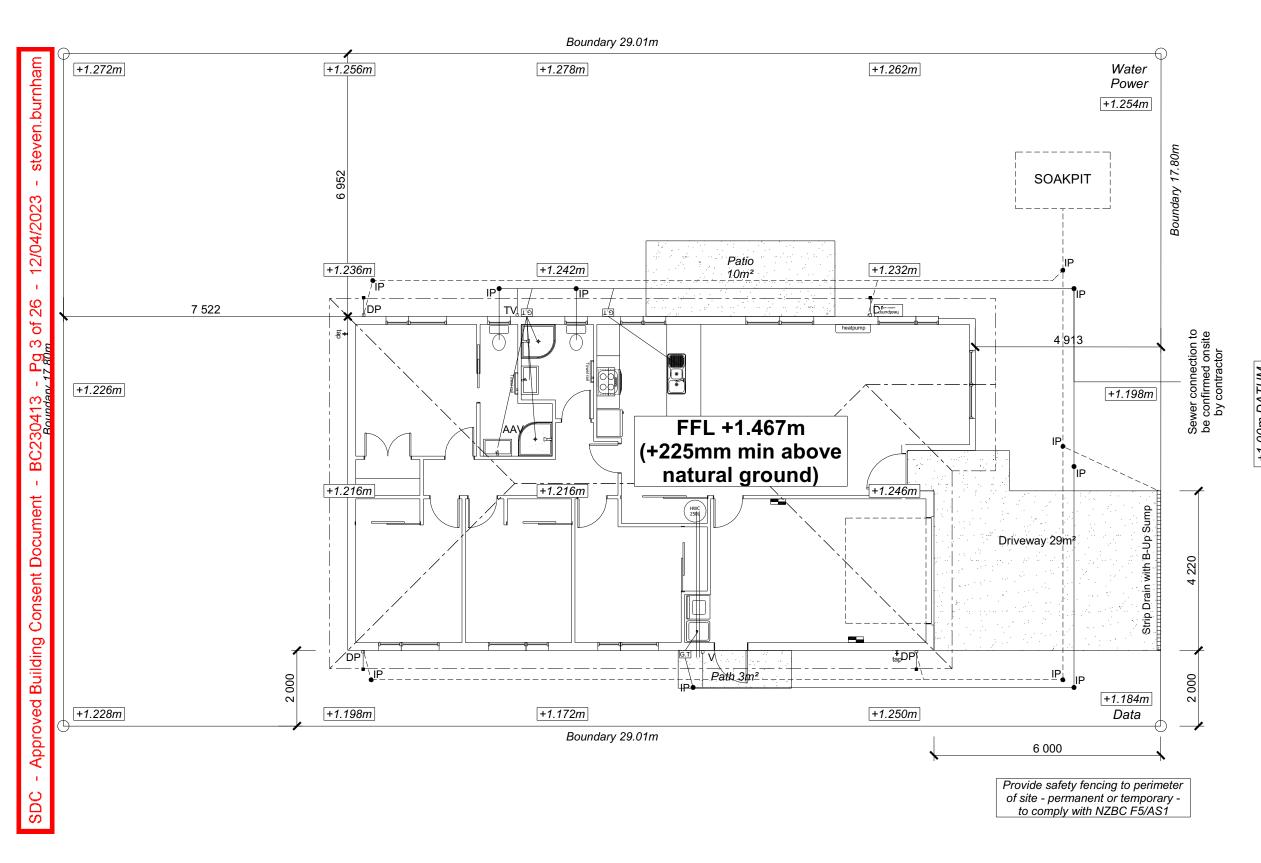Sediment control and site safety requirements are noted in the attached Specifications.

DRAINAGE LEGEND

EDGAR WAY

----- Stormwater DN100mm uPVC Sewer Drain DN100mm uPVC DP GT ORG TV AAV Downpipe Gully Trap Overflow Relief Gully Terminal Vent Air Admittance Valve

Inspection Point

Planning Approved

12/04/2023 downir

DRAWING NOTES

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Verify all dimensions, sizes and levels on site prior to commencing any work. Any discrepancies are to be confirmed with

Refer to attached Specifications for further

All work is to comply with the NZBC Acceptable Solutions, NZS 3604:2011 and Local Authority bylaws.

Sheet No.:

2

of 25 sheets

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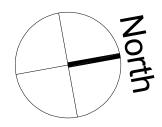
TKR Developments Limited Lot 655, DP 583250 12 Edgar Way Faringdon, Rolleston

Sheet Name: Original Plan: Snipe 170685 SITE PLAN Print Date:

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CONSENT PLANS Date: Reason:
20-03-2023 Initial Consent Plans







Roof: 25° Pressed Metal Tiles Walls: 70 Series Brick Veneer with a 50mm cavity

James Hardie Linea Weatherboards (Facing Boards) with a 20mm cavity

DWELLING AREAS

Framing Area: 134.32m² (Perimeter: 51.31m) Veneer Area: 139.65m² (Perimeter: 52.27m) Roof Area: 166.57m² (Perimeter: 54.83m)

SMOKE ALARMS (hush type)
Domestic Smoke Alarms to be fitted within 3.0m of sleeping areas and on Escape routes as indicated on plan. To comply with one of the following standards: UL 217, ULC-S531, AS 3786, BS 5446 (part 1).

FLOOR PLAN NOTES

Dimensions shown are to the frame, GIB thickness not shown. Air Seals to have PEF rod & low expansion foam All windows and doors centered in room unless

Laundering facilities provided complying with G2/SA1 1.0

Provide sealant under skirting and paint to concrete around tub & W/M fixtures

Stud Height: 2400 mm (2455mm to u/s of bottom chord) FLOOR FINISHES

Carpet & Vinyl KITCHEN HOB Electric Hobs

WALL FRAMING

DOORS Internal Height: 1980mm (leaves) Leaf widths as shown on the plan (R/O +80mm) Type: Hollow core flush panel Front Door Type: Latitude Aluminium

WINDOW JOINERY

Low-E Double glazed aluminum Standard single glazing to Garage

Scotia: 50mm GIB Coving (Excluding Garage) Skirting: 60x12mm Pine, single bevel edge Architrave: N/A

SHELVING

Shelf & Rails to all wardrobes 4 shelves to Linen cupboard

DRAWING NOTES

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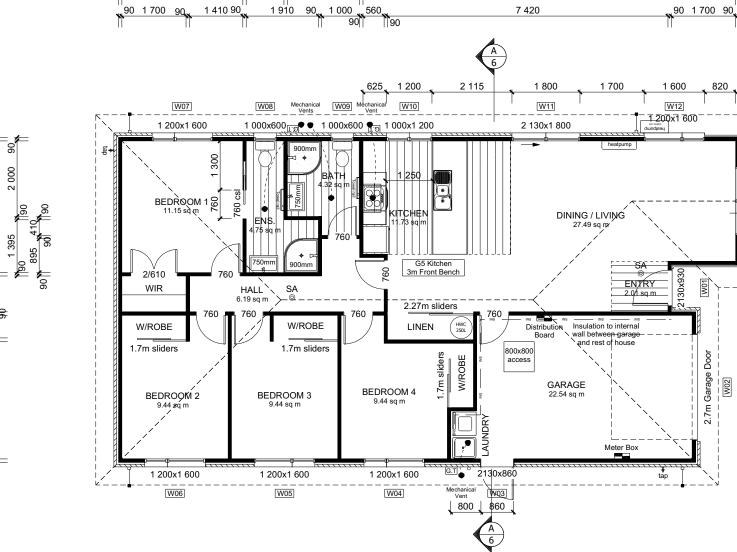
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CONSENT PLANS Original Plan: Snipe 170685 **FLOOR PLAN**

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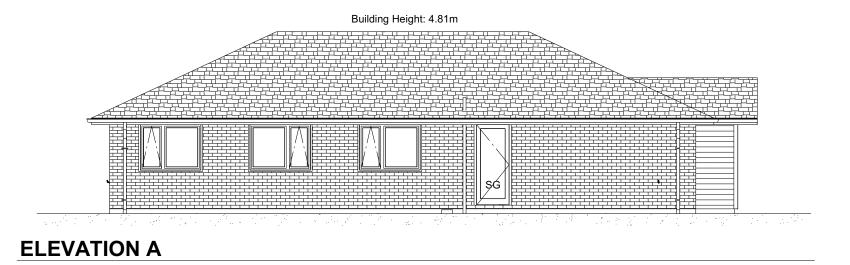
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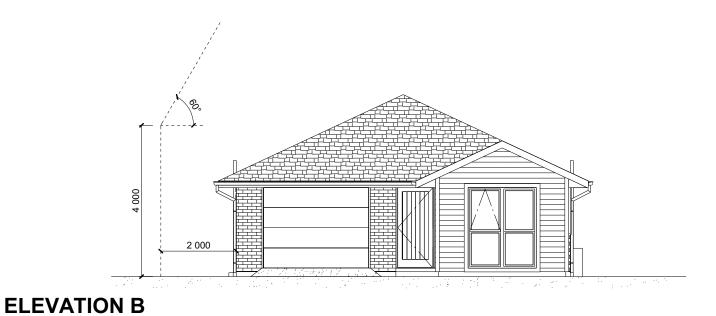
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BUILDING ENVELOPE RISK MATRIX ELEVATION A RISK CRITERIA RISK SCORE Wind Zone High 1 Number of Stories Low 0 Roof Wall Junction Low 0 Eaves Width Medium 1 Building Envelope Medium 1 Decks & Balconies Low 0 Total 3



BUILDING ENVELOPE RISK MATRIX ELEVATION B RISK CRITERIA RISK SCORE Wind Zone High 1 Number of Stories Low 0 Roof Wall Junction Low 0 Eaves Width Medium 1 Building Envelope Medium 1 Decks & Balconies Low 0 Total 3



Facade Wall (excluding garage) = 13.01m² Combined Glazing = 2.80m² Windows to Street = 21.52%

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ROOF & WALL CLADDINGS

Roof: 25° Pressed Metal Tiles
Walls: 70 Series Brick Veneer

ELEVATION LEGEND

ELEVATION NOTES

Soffits : Hardiflex 4.5mm

MB

TV

Safety Stays Safety Glass

Meter Box

Terminal Vent

Gutter : Coloured Steel Quad Gutter Fascia : Coloured Steel185 Fascia Downpipes : Colorsteel Rectangular 75x55mm

Joinery: Low-E Double glazed aluminum


All egress points to have a maximum step


down of 190mm.
Access routs to have slip resistance surface


in compliance with NZBC D1/AS1 Table 2


and to have a 1:100 fall away from the building

with a 50mm cavity
James Hardie Linea Weatherboards
(Facing Boards) with a 20mm cavity

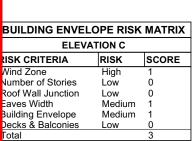

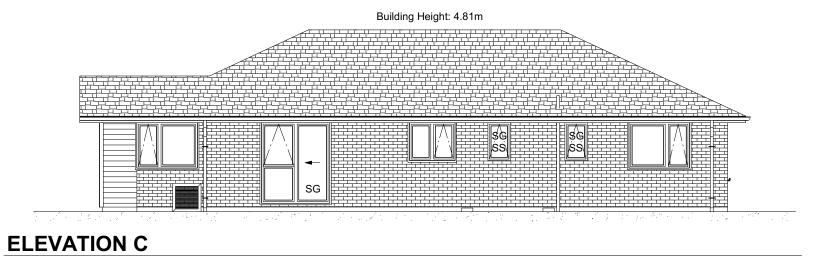

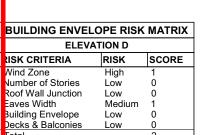

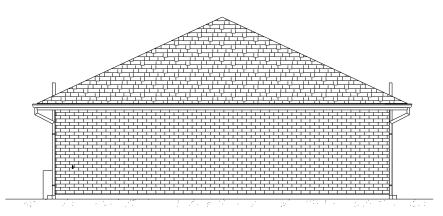

ELEVATION D

All dimensions are to be check and confirmed prior to any construction

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CONSENT PLANS

lo. Date: Reason:
20-03-2023 Initial Consent Plans

ROOF & WALL CLADDINGS

Roof: 25° Pressed Metal Tiles
Walls: 70 Series Brick Veneer

ELEVATION LEGEND

ELEVATION NOTES

Soffits : Hardiflex 4.5mm

MB

TV

Safety Stays Safety Glass

Meter Box

Gutter : Coloured Steel Quad Gutter Fascia : Coloured Steel185 Fascia Downpipes : Colorsteel Rectangular 75x55mn

Joinery: Low-E Double glazed aluminum

All egress points to have a maximum step down of 190mm. Access routs to have slip resistance surface

in compliance with NZBC D1/AS1 Table 2


and to have a 1:100 fall away from the building

with a 50mm cavity
James Hardie Linea Weatherboards
(Facing Boards) with a 20mm cavity

Sheet No.:

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Pressed metal tile roofing on self supporting ThermaKraft 215 roof underlay and tile battens 50x40 SG8 H1.2 @ 370crs, fixings 2/90 x 3.15

13mm Std. GIB ceiling lining (Aqualine to wet areas) to underside of 70x35mm H1.2 ceiling battens @ 600mm crs with R3.6 Pink Batts

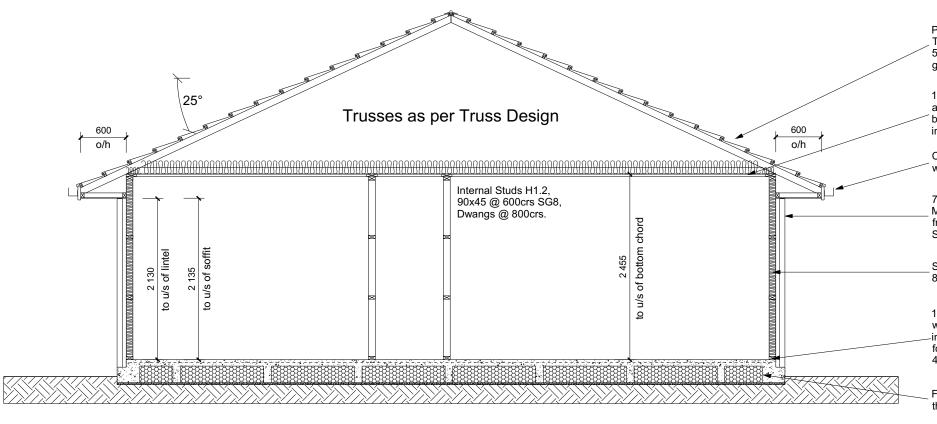Coloured steel fascia & gutter system with 4.5mm Hardies soffit lining.


70 Series brick veneer with a 50mm cavity. Masons Barricade building wrap on stud framing with R2.6 Pink Batts insulation & 10mm Std. GIB wall lining (Aqualine to wet areas).

Studs H1.2, 90x45 @ 600crs SG8, Dwangs @ 800crs (exterior & interior loadbearing walls)

125mm x 12mm thru bolt with 50mm square washer at 900mm crs on all external walls and interior load bearing walls (Bolts also 150mm for each end of bottom plate) minimum cover 40mm. DPC between bottom plate & floor slab.

Firth RibRaft foundation design in accordance with the Firth RibRaft Technical manual attached.

CROSS SECTION A-A

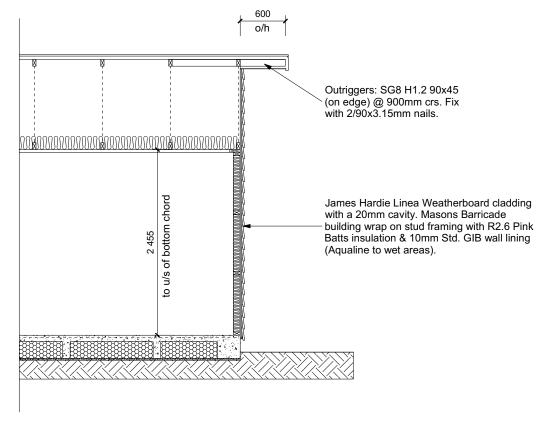

CROSS SECTION B

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Local Authority bylaws. **CONSENT PLANS** Date: Reason: 20-03-2023 Initial Consent Plans

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DRAWING NOTES

ROOF & WALL CLADDINGS Roof: 25° Pressed Metal Tiles Walls: 70 Series Brick Veneer

CROSS SECTION NOTES

NZS 3604:2011.

of E2/AS1.

INSULATION

Building wrap is to comply with E2/AS1 &

environmental exposure. Refer to NZS 3604:2011 & table 20 of E2/AS1.

Flashing materials must be selected based or

Flashing tape must have proven compatibility

with the selected wrap & other materials with which it comes into contract as per table 21

Fixings shall comply with NZS 3604:2011 Section 4 Durability Tables 4.1-4.3 Unless stated otherwise, timber members on

drawings are to be a minimum of SG8

strength graded as per NZS3604:2011.

Ceiling: Pink Batts R3.6 Ceiling Batts

Wall: Pink Batts R 2.6 Wall Batts

Joinery: Low-E Double glazed aluminum


with a 50mm cavity
James Hardie Linea Weatherboards (Facing Boards) with a 20mm cavity

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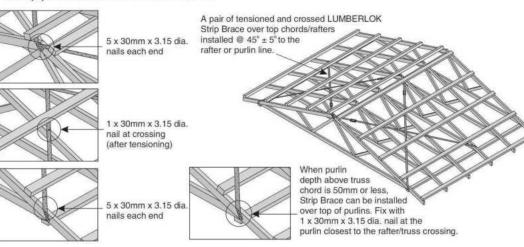
Verify all dimensions, sizes and levels on site prior to commencing any work. Any discrepancies are to be confirmed with

Refer to attached Specifications for further information

All work is to comply with the NZBC Acceptable Solutions, NZS 3604:2011 and

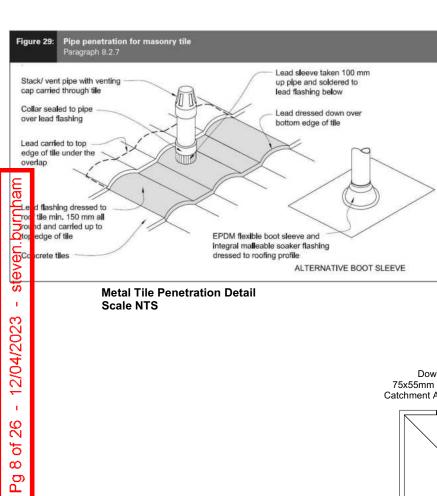

· A pair of tensioned and crossed LUMBERLOK Strip Brace running continuously from ridge to top plate installed as detailed below.



direction of Downpipe Downpipe falls in autter 75x55mm Coloursteel 75x55mm Coloursteel Catchment Area: 33.59m² Catchment Area: 40.15m² Steel Strap Bracino 25° 25° direction of falls in gutter 25° pitch 25° pitch 25° Downpipe 75x55mm Coloursteel 75x55mm Coloursteel direction of Catchment Area: 45.98m² Catchment Area: 46.73m² falls in gutter

ROOF CLADDING

Roofing: 25° Pressed Metal Tiles 50x40 SG8 H1.2 @ 370crs, Tile Battens

fixings 2/90 x 3.15 gun nail

ROOF PLAN NOTES

Gutter: Coloured Steel Quad Gutter Fascia: Coloured Steel 185 Fascia Downpipes: Colorsteel Rectangular 75x55mm Soffits: Hardiflex 4.5mm

Underlay: Thermakraft 215 roof underlay

Roof Bracing: Diagonally opposed pair 25x1mm galv straps with 8Kn tension capacity.

After tensioning strap, fix to each rafter with 2/ 60x3.15mm nails. Fold down strap and fix with 3/60x3.15mm

nails each into the top chord and into the top

Downpipes: 75x55 Rectangle Colorsteel As per NZBC E1/AS1 Table 5 75x55 down pipes can collect up to 60m² of 0-25° roof plan area.

Use Coloured steel Quad Gutter As per NZ Metal Roof and Wall Cladding Code of Practice Version 2 section 8 the above gutter with a cross sectional area of 5550mm2 can collect up to 60m2 of 0-25° roof plan area. Refer to the specifications for exact calculations

Use Lumberlock top plate fixing chart attached to the main specifications to determine top plate fixings.

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Sheet Name: Original Plan: 170685 Snipe **ROOF PLAN** Print Date


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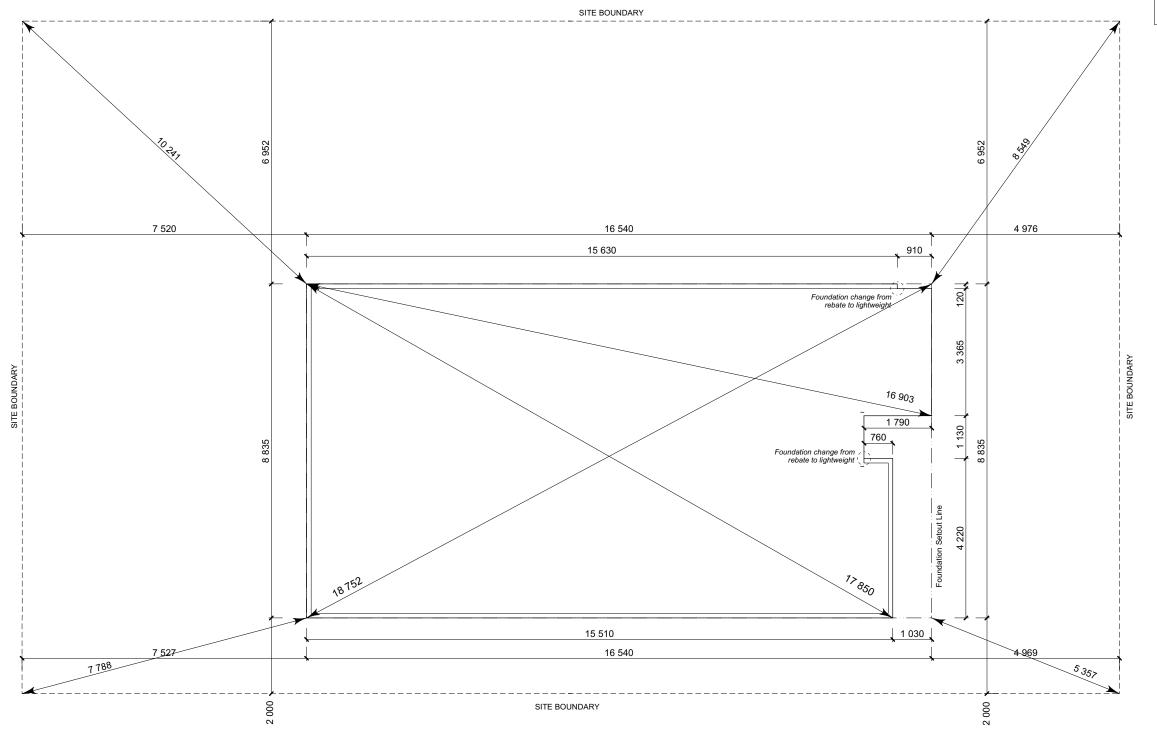
EDGAR WAY

8

of 25 sheets

All dimensions over foundation face. Allow (120mm rebate) 70mm veneer & 50mm cavity, Brick to overhang foundation face by 0-20mm max as per NZBC E2/AS1. All reinforcing is to be Ductility Class E, in accordance with NZS 4671.
All concrete to comply with NZS3604:2011
Section 4 Durability Clause 4.5.2.

These foundations are design to the findings and recommendations in the site specific Geotech report.

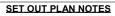

All dimensions are to be check and confirmed prior to any construction


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FOUNDATION PLAN NOTES

All dimensions over foundation face. Allow (120mm rebate) 70mm veneer & 50mm cavity, Brick to overhang foundation face by 0-20mm max as per NZBC E2/AS1. W/C location indicated on plan has assumed a 140mm offset from internal frame line, please consult manufacturer's documentation to confirm offset. Contractor to consult manufacturer's documentation to determine the correct location for all wastes positioned through floor slabs.
Earth bar to be bonded to the reinforcing

mesh Refer to Truss design for exact location of

All reinforcing is to be Ductility Class E, in accordance with NZS 4671. All concrete to comply with NZS3604:2011 Section 4 Durability Clause 4.5.2.

These foundations are design to the findings and recommendations in the site specific Geotech report.

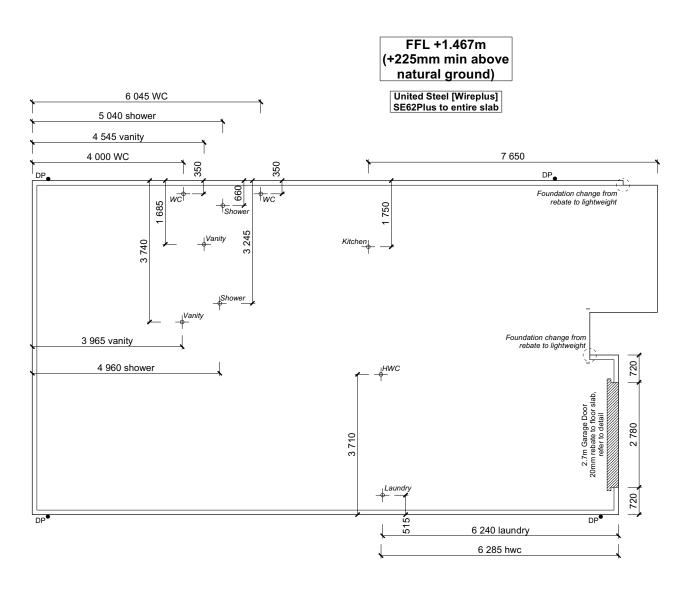Perimeter:

AREA TO PERIMETER RATIO


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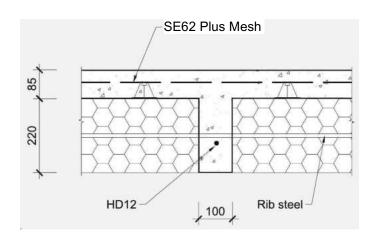
Foundation Area: 139.65m²


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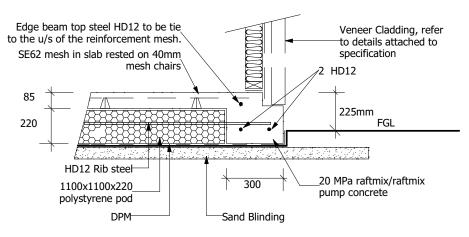
United Steel [Wireplus] SE62Plus to entire slab

TC1 Firth RaftMix Concrete foundation design in accordance with the Firth RibRaft Technical Manual & Codemark attached.






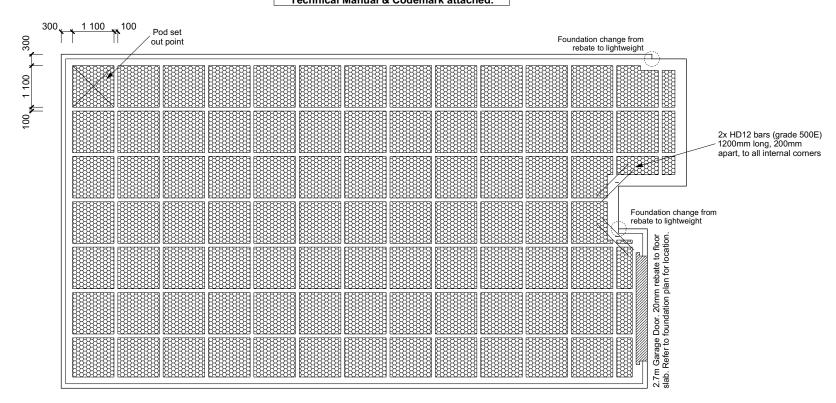

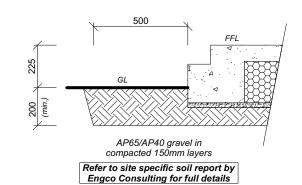

Ribraft Edgebeam Detail (Rebate) Scale 1:20

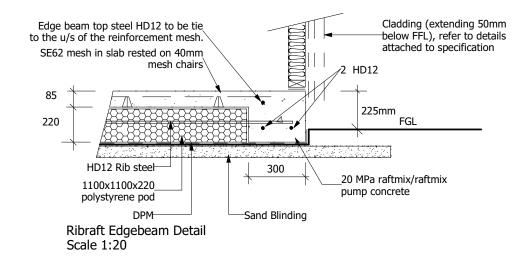

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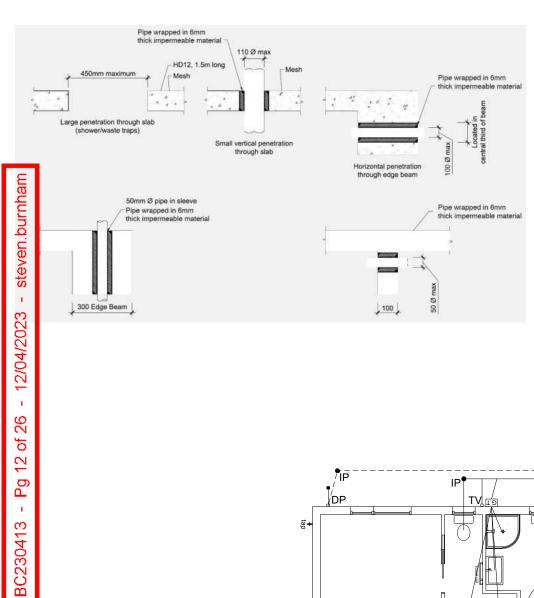



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Plumbing Schedule NZBC G13 Kitchen Ø50mm @1:40 (3 discharge units) Sink: Bathrooms Vanity: Ø40mm @ 1:40 (1 discharge units per basin) Shower: Ø40mm @1:40 (2 discharge units) Bath: Ø40mm @1:40 (4 discharge units) Ø100mm @1:40 Ø40mm @1:30 NZBC G13 WC: (4 discharge units) Laundry Sink: (5 discharge units) Drainage Schedule Vented Drain Ø100mm @1:60 Ø100mm @1:60 (1:120max) Ø80mm Stormwater Drain Terminal Vent Drain over DP Heatpump Overflow Relief Gully ORG to be positioned so the top of gully dish is no less than 150mm below overflow level of lowest fixture Sewer and Stormwater to connect to existing connections. All plumbing and drainage to comply with NZBC G13. All drains passing through concrete, provide sleeve or wrap in durable

and flexible to allow for expansion and contraction. (as per G13/AS2 5.8.1)
HWC: Safe tray to HWC with 50mm overflow drain to exterior to comply with G12/AS1.

DRAINAGE LEGEND ------ Stormwater DN100mm uPVC Sewer Drain DN100mm uPVC DP Downpipe GT Gully Trap ORG Overflow Relief Gully TV Terminal Vent AAV Air Admittance Valve

Inspection Point

DP Dep manus B-DS Surio

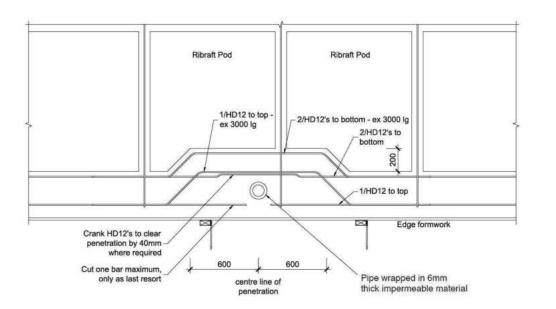Pipe Building foundation
Paragraph 3.9.7

Building foundation
Paragraph V

Minimum horizontal seperation V or 3V (See paragraph 3.9.7)

All dimensions are to be check and confirmed prior to any construction

Plans are to be read in conjunction with Specifications and all supporting documentation



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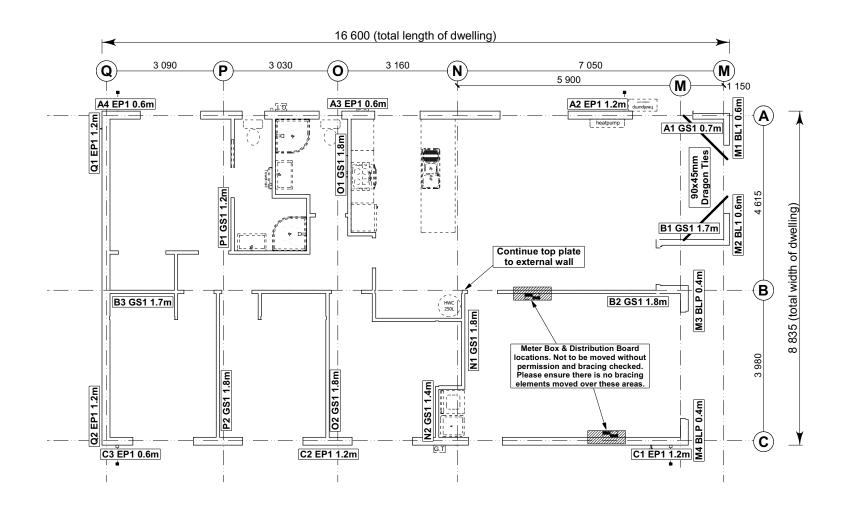
TKR Developments Limited Lot 655, DP 583250 12 Edgar Way Faringdon, Rolleston

| Job Nu | ımber: | Original Plan: | Sheet | Name: | | |
|--------|-------------------|----------------|------------------------|-----------------|----------|----------|
| 170 | 685 | Snipe | DRAINA | GE PLA | N | No. 1 |
| ales: | Drawn: M Glynn | QS: E Gould | Print Date: 20/03/2023 | Scale: 1:100 | @ A3 | |
| Goula | IVI GIYIIII | L Gould | 20/03/2023 | 1.100 | w A3 | |

Sewer connection to be confirmed onsite by contractor

SOAKPIT

Approved Building Consent Document



single Level Along Resistance Sheet b Name: TKR Developments Ltd Wind EQ 454 121% 219% 1.20 162 0.60 EP1 0.6 1.80 2.4 GS1-N GIB® 124 1.20 2.4 EP1 1.2 **Ecoply**® 144 345 OK 387 OK

| Job N | ame: TKR L | Developm | ents Ltd | | | | | 1 | Wind | EQ |
|-------|------------|----------|-----------|----------|---------|----------|-------|-------|--------|--------|
| | | | | | | | | | Der | nand |
| | | | | | | | | | 845 | 842 |
| | | | | | | | | | Ach | eved |
| Line | Element | Length | Angle | Stud Ht. | Type | Supplier | Wind | EQ | 1220 | 1178 |
| | | (m) | (degrees) | (m) | | | (BUs) | (BUs) | 144% | 140% |
| | .1 | 0.60 | | 2.4 | BL1-H | GIB® | 59 | 61 | | |
| | 2 | 0.60 | | 2.4 | BL1-H | GIB® | 59 | 61 | | |
| M | 4 | 0.40 | 1 1 | 2.4 | BLP-H | GIB® | 48 | 54 | | |
| | 4 | 0.40 | | 2.4 | BLP-H | GIB® | 48 | 54 | | |
| | | | | | | | | | 215 OK | 229 OF |
| | | 1.80 | | 2.4 | GS1-N | GIB® | 124 | 108 | | 0 |
| N | 2 | 1.40 | | 2.4 | GS2-N | GIB® | 137 | 120 | | |
| | | | - | 2 | | | | | 261 OK | 228 OF |
| | 1 | 1.80 | | 2.4 | GS1-N | GIB® | 124 | 108 | | |
| 0 | 2 | 1.80 | | 2.4 | GS1-N | GIB® | 124 | 108 | | |
| | | | | | | | | | 248 OK | 216 OF |
| | 1 | 1.20 | | 2.4 | GS1-N | GIB® | 83 | 72 | | |
| P | 2 | 1.80 | | 2.4 | GS1-N | GIB® | 124 | 108 | | |
| | | | | | | | | | 207 OK | 180 OF |
| | 1 | 1.20 | | 2.4 | EP1 1.2 | Ecoply® | 144 | 162 | | |
| Q | 2 | 1.20 | 15 | 2.4 | EP1 1.2 | Ecoply® | 144 | 162 | | |

8.7.3.4


Each wall that contains one or more wall bracing elements shall be connected at the top plate level, either directly, or through a framing member in the line of the wall, to external walls at right angles to it. Top plate fixing(s) of the capacity in tension or compression along the line of the wall bracing element are given as follows:

- (a) For each wall containing wall bracing elements with a total bracing capacity of not more than 125 bracing units: to at least one such external wall by a fixing as shown in figure 8.16 of 6 kN capacity;
- (b) For each wall containing wall bracing elements with a total bracing capacity of not more than 250 bracing units: to at least 2 external walls by fixings as shown in figure 8.16 each of 6 kN capacity;
- For each wall containing wall bracing elements with a total bracing capacity of more than 250 bracing units: to at least 2 external walls by fixings as shown in figure 8.16 each having a rating of not less than 2.4 kN per 100 bracing units.

BRACING PLAN NOTES

Wall bracing designed in accordance with NZS 3604:2011 & GIB Ezybrace system Refer to attached calculations.

Bracing Designed to: Wind: High Earthquake: 2

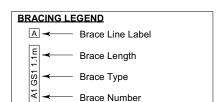


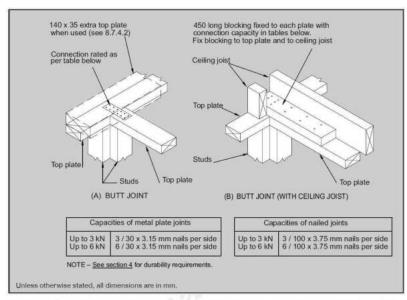


Figure 8.16 - Connecting top plates to external walls at right angles - Walls containing bracing (see 8.7.3.4)

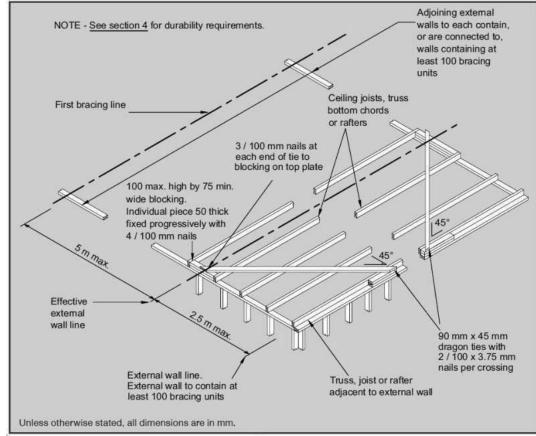

sions are to be check and confirmed prior to any construction

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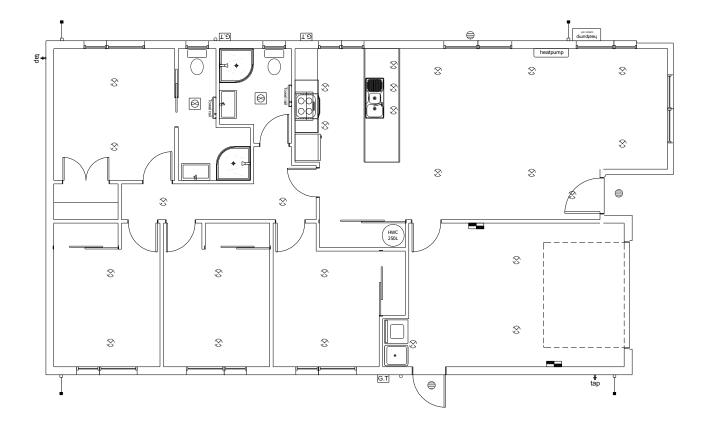
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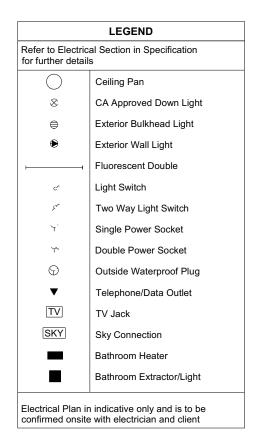
Original Plan: Snipe 170685

CONSENT PLANS Sheet No.: Date: Reason: 20-03-2023 Initial Consent Plans **BRACING PLAN 12** Print Date of 25 sheets M Glynn 1:100

steven.burnham

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Plans are to be read in conjunction with Specifications and all supporting documentation



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| Job Number: | | Original Plan: | Sheet | Name: | CONSENT PLANS | | | | | |
|-------------|---------|----------------|-------------|------------|---------------|------------|-----------------------|--|--|--|
| 4=00 | ~= | Cuina | | | No. | Date: | Reason: | | | |
| 170685 | | Snipe | LIGHTIN | IG PLAN | 1 | 20-03-2023 | Initial Consent Plans | | | |
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| | | | | | | | | | | |
| Sales: | Drawn: | QS: | Print Date: | Scale: | | | | | | |
| | | F 0 | 20/03/2023 | 4:400 0 40 | | | | | | |
| R Gould | M Glynn | E Gould | 20/03/2023 | 1:100 @ A3 | | | | | | |

Heavy Roof




LINTEL FIXING SCHEDULE

ALTERNATIVE TO TABLE 8.14 & FIGURE 8.12 NZS 3604:2011

NOTE:

- * All fixings are designed for vertical loads only. Dead loads include the roof weight and standard ceiling weight of 0.20kPa.
- ★ Refer to Table 8.19 NZS 3604:2011 for nailing schedule to resist horizontal loads.
- * These fixings assume the correct choice of rafter/truss to top plate connections have been made
- * All fixings assume bottom plate thickness of 45mm maximum. Note: TYLOK options on timber species.
- * Wall framing arrangements under girder trusses are not covered in this schedule.
- ★ All timber selections are as per NZS 3604:2011.

DEFINITIONS

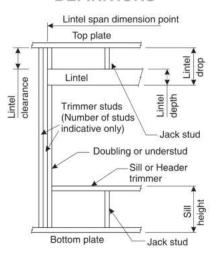

| Li | ntel Sup | porting | Girder | Trusses | | | | | |
|--------------------|------------|----------|--------|------------|-----------|------|--|--|--|
| Roof Tributary | L | ight Roc | of | Heavy Roof | | | | | |
| Area | V | ind Zon | ie | V | Wind Zone | | | | |
| | L, M, H | VH | EH | L, M, H | VH | EH | | | |
| 8.6m² | G | G | Н | G | G | Н | | | |
| 11.6m² | G | Н | Н | G | G | Н | | | |
| 12.1m² | G | Н | Н | G | Н | Н | | | |
| 15.3m² | Н | Н | | G | Н | Н | | | |
| 19.1m² | Н | - | - | G | Н | -: | | | |
| 20.9m² | Н | - | 0.20 | Н | Н | - 21 | | | |
| 21.8m ² | н | - | | Н | - | - | | | |
| 34.3m ² | | 1,-1 | 3.53 | Н | - | *: | | | |

NOTES:


- 1. Roof Tributary Area = approx. 1/2 x (Total roof area on girder and rafter trusses supported by lintel)
- 2. Assumed girder truss is at mid-span or middle third span of lintel
- 3. Use similar fixings for both ends of lintel
- 4. All other cases require specific engineering design


| Lintel | Loaded | | | tht R | | | | | avy F nd Z | | |
|-------------|--|-----|---|-------|-----|------|---|---|---------------|----|-----|
| Span (m) | Dimension (m) (See Fig. 1.3 NZS 3604:2011) | L | М | Н | VH | EH | L | М | Н | VH | Εŀ |
| | 2.0 | Е | E | E | F | F | Ε | E | E | E | F |
| | 3.0 | E | E | F | F | F | E | E | E | F | F |
| 1.0 | 4.0 | E | F | F | F | G | E | E | F | F | F |
| | 5.0 | E | F | F | G | G | Ε | E | F | F | G |
| | 6.0 | E | F | F | G | G | E | E | F | F | G |
| | 2.0 | E | E | F | F | F | E | E | E | F | F |
| | 3.0 | E | E | F | F | F | Ε | E | F | F | F |
| 1.2 | 4.0 | E | F | F | G | G | Е | E | F | F | G |
| | 5.0 | E | F | F | G | G | Ε | E | F | F | G |
| | 6.0 | F | F | G | G | Н | E | E | F | G | G |
| | 2.0 | E | E | F | F | F | E | E | E | F | F |
| | 3.0 | E | F | F | F | G | E | E | F | F | F |
| 1.5 | 4.0 | E | F | F | G | G | E | E | F | F | G |
| | 5.0 | F | F | G | G | Н | E | E | F | G | G |
| | 6.0 | F | F | G | Н | Н | E | E | F | G | Н |
| | 2.0 | E | F | F | F | G | E | E | F | F | F |
| | 3.0 | E | F | F | G | G | E | E | F | F | G |
| 2.0 | 4.0 | F | F | G | G | Н | E | E | F | G | G |
| | 5.0 | F | F | G | Н | Н | E | E | F | G | Н |
| | 6.0 | F | G | G | Н | Н | E | F | G | Н | Н |
| | 2.0 | E | F | F | G | G | E | E | F | F | G |
| | 3.0 | F | F | G | G | Н | E | E | F | G | G |
| 2.4 | 4.0 | F | F | G | Н | Н | E | E | F | G | Н |
| | 5.0 | F | G | G | Н | Н | E | F | G | Н | Н |
| | 6.0 | F | G | Н | Н | - | E | F | G | Н | Н |
| | 2.0 | E | F | F | G | G | E | E | F | F | G |
| | 3.0 | F | F | G | Н | Н | E | E | F | G | H |
| 3.0 | 4.0 | F | G | G | Н | Н | E | F | G | Н | Н |
| | 5.0 | F | G | Н | Н | -5 | E | F | G | Н | Н |
| | 6.0 | F | G | Н | - | -5 | E | F | G | H | - |
| | 2.0 | F | F | G | G | Н | E | E | F | G | G |
| | 3.0 | F | F | G | Н | Н | E | F | G | G | Н |
| 3.6 | 4.0 | F | G | Н | Н | * | E | F | G | Н | Н |
| | 5.0 | F | G | Н | | * | E | F | G | Н | |
| | 6.0 | G | Н | Н | | | E | F | H | | - |
| | 2.0 | F | F | G | G | Н | E | E | F | G | G |
| | 3.0 | F | G | Н | Н | * | E | F | G | Н | Н |
| 4.2 | 4.0 | F | G | Н | - | * | E | F | G | Н | |
| | 5.0 | G | Н | Н | - | * | E | F | Н | | * |
| | 6.0 | G | Н | - | - | - | E | F | Н | | |
| | 2.0 | F | F | G | Н | Н | E | E | F | G | Н |
| | 3.0 | F | G | Н | Н | | E | F | G | Н | Н |
| 4.5 | 3.4 | F | G | Н | Н | - 20 | E | F | G | Н | Н |
| | 4.0 | F | G | Н | - | - 20 | E | F | G | Н | - |
| | 5.0 | G | Н | - | - | 2 | E | F | Н | - | 2 |
| | 6.0 | G | Н | 12 | ¥ | | E | F | Н | - | - |
| | 2.0 | F | F | G | Н | Н | E | Е | F | G | Н |
| | 3.0 | F | G | Н | Н | - | E | F | G | Н | Н |
| 4.8 | 3.2 | F | G | Н | Н | - 12 | E | F | G | Н | Н |
| 4.0 | 4.0 | F | G | Н | = | 2 | E | F | Н | Н | - |
| | 5.0 | G | Н | | 2 | - | E | F | Н | | - |
| | 6.0 | G | Н | 2 | 2 | - | E | F | Н | - | - |
| | 2.0 | F | F | G | Н | Н | E | F | G | G | Н |
| | 3.0 | F | G | Н | Н | - | E | F | G | Н | Н |
| 5.1 | 3.5 | F | G | Н | - 2 | - 2 | E | F | G | Н | - 2 |
| J. 1 | 4.0 | G | G | Н | - 2 | 25 | E | F | Н | Н | - 2 |
| | 5.0 | G | Н | - | - | 2 | Ε | F | Н | - | - |
| | 6.0 | G | Н | - | - | - | E | G | Н | - | - |
| | 2.0 | F | F | G | Н | Н | E | F | G | G | H |
| | 2.8 | F | G | Н | Н | | E | F | G | Н | Н |
| 5.4 | 3.0 | F | G | Н | - | - | E | F | G | Н | - |
| 5.4 | 4.0 | G | Н | Н | | | E | F | Н | | |
| | 5.0 | G | Н | | | | E | F | Н | | |
| | 5.0 | 100 | | | | | | | | | |


Light Roof

LINTEL FIXING OPTIONS



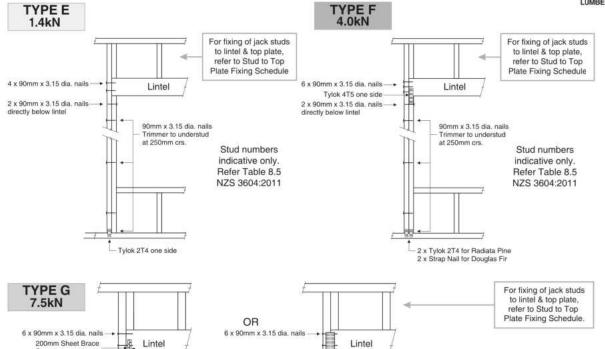

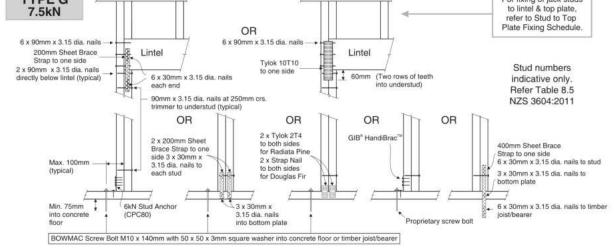

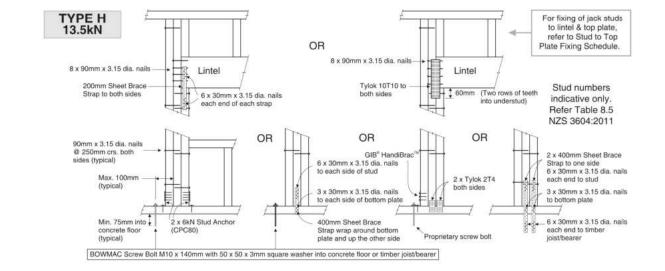

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| Job Numb | er: | Original Plan: | Sheet | Name: | C | ONSENT PLANS | Sheet No.: |
|-------------------|-------------------|----------------|------------------------|--------------------|---|----------------------------------|-----------------|
| 17068 | 85 | Snipe | FRAMING | DETAILS | | Reason: Initial Consent Plans | 14 |
| Sales: R Gould | Drawn: M Glynn | QS: E Gould | Print Date: 20/03/2023 | Scale: NTS @ A3 | | | of 25 sheet |




LUMBERLOK®

STUD TO TOP PLATE FIXING SCHEDULE

ALTERNATIVE TO TABLE 8.18 NZS 3604:2011

- * All fixings are designed to resist vertical loads only. Dead loads include the roof weight and standard ceiling weight
- ★ Refer to Table 8.19 NZS 3604:2011 for nailing schedule to resist lateral loads.
- * These fixings assume the correct choice of rafter/truss to top plate connections have been made.
- ★ For gable end walls where the adjacent rafter/truss is located within 1200mm and with a maximum verge overhang of 750mm, select stud to top plate fixing using a loaded dimension of 1.5m.
- * All fixings assume top plate thickness of 45mm maximum.
- * Wall framing arrangements under girder trusses are not covered in this schedule.
- * All timber selections are as per NZS 3604:2011.

LOADED DIMENSION DEFINITION

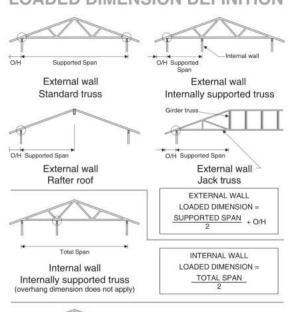

FIXING SELECTION CHART

(Suitable for walls supporting roof members at 600, 900 or 1200mm crs.) Wind Zones L, M, H, VH, EH, as per NZS 3604:2011


Multiple internal walls

| Loaded Dimension (m) Stud Centres | | | | 10000 | ght R | | | Heavy Roof Wind Zone | | | | |
|--------------------------------------|-------|-------|---|-------|-------|----|----|-------------------------|---|---|----|----|
| 300mm | 400mm | 600mm | L | M | Н | VH | EH | L | M | Н | VH | EH |
| 3.0 | 2.3 | 1.5 | Α | Α | В | В | В | Α | Α | В | В | В |
| 4.0 | 3.0 | 2.0 | Α | Α | В | В | В | Α | Α | В | В | В |
| 5.0 | 3.8 | 2.5 | Α | В | В | В | В | Α | Α | В | В | В |
| 6.0 | 4.5 | 3.0 | Α | В | В | В | В | Α | Α | В | В | В |
| 7.0 | 5.3 | 3.5 | Α | В | В | В | В | Α | Α | В | В | В |
| 8.0 | 6.0 | 4.0 | Α | В | В | В | В | Α | Α | В | В | В |
| 9.0 | 6.8 | 4.5 | В | В | В | В | В | Α | Α | В | В | В |
| 10.0 | 7.5 | 5.0 | В | В | В | В | В | Α | Α | В | В | В |
| 11.0 | 8.3 | 5.5 | В | В | В | В | В | Α | Α | В | В | В |
| 12.0 | 9.0 | 6.0 | В | В | В | В | В | Α | Α | В | В | В |

FIXING OPTIONS

FIXING TYPE A 0.7kN

2 x 90mm x 3.15 dia. plain steel wire nails driven vertically into stud.

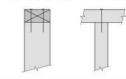

FIXING TYPE B CHOOSE ANY OF THE 3 OPTIONS BELOW

2 x 90mm x 3.15 dia. plain steel wire nails driven vertically into stud.









LUMBERLOK 6kN Stud Anchor




2 x 90mm x 3.15 dia. plain steel

wire nails driven vertically into stud.

2 x LUMBERLOK

Recommended for internal wall options to avoid lining issues

2 x 90mm x 3.15 dia. plain steel wire nails driven vertically into stud.

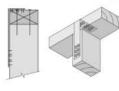

To calculate the number of B type fixings required, divide the wall length by the stud centres, add 1 to this figure and locate this number of fixings as evenly as possible along the wall length. This figure includes the start and end studs in each wall length.



SCAN FOR INSTALLATION VIDEO

LUMBERLOK

Stud Strap (one face only)

https://vimeo.com/117353604

sions are to be check and confirmed prior to any construction

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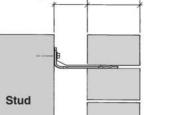
MULTIPLE INTERNAL WALL

LOADED DIMENSION FOR

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TKR Developments Limited Lot 655, DP 583250 12 Edgar Way Faringdon, Rolleston



Stud Screw Tie Long

90 SERIES BRICK

Max. Cavity

Screw Tie Short

70 SERIES BRICK

Max. Cavity 50

(105mm)

- * All brick work must be constructed in accordance with NZS 4210:2001 Masonry Construction: Materials and Workmanship. Screw Ties must be applied accordingly and are not to be hammered into timber framing.
- * Water shedding shoulder prevents transfer of the moisture from tie to building.
- * Nail hole for Oamaru Stone.
- * Angled neck encourages increased tie embedment in mortar.

1.2mm NZCC-SD Hot Dip Galvanised Steel

Type 17-12g x 35mm Hex Head Hot Dip Galvanised Screws


250 ties per box including screws

Also available in Stainless Steel Grade 316 for Zone D.

SCREW TIES


FOR BRICK VENEER FIXING


- ★ Medium duty (EM) classification
- ★ Tested by BRANZ in accordance with AS/NZS 2699.1:2000
- * BRANZ test report No. ST0725 November 2007
- * Suitable for both 'dry bedding' and encapsulated mortar
- * Hot Dip Galvanised ties for Zones B & C, and Stainless Steel Grade 316 ties for Zone D meet NZS 3604:2011 Sect. 4 Durability
- * Available in 85mm and 105mm sizes

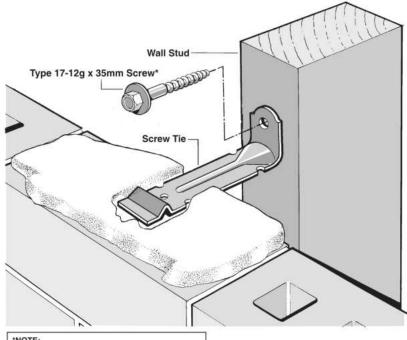

Use longer screws for fixing through Rigid Air Barrie (RAB). Maintain 35mm embedment in studs

CONSENT PLANS Sheet No. Original Plan: Snipe Date: Reason: 20-03-2023 Initial Consent Plans 170685 FRAMING DETAILS 15 Print Date of 25 sheets 20/03/2023 NTS

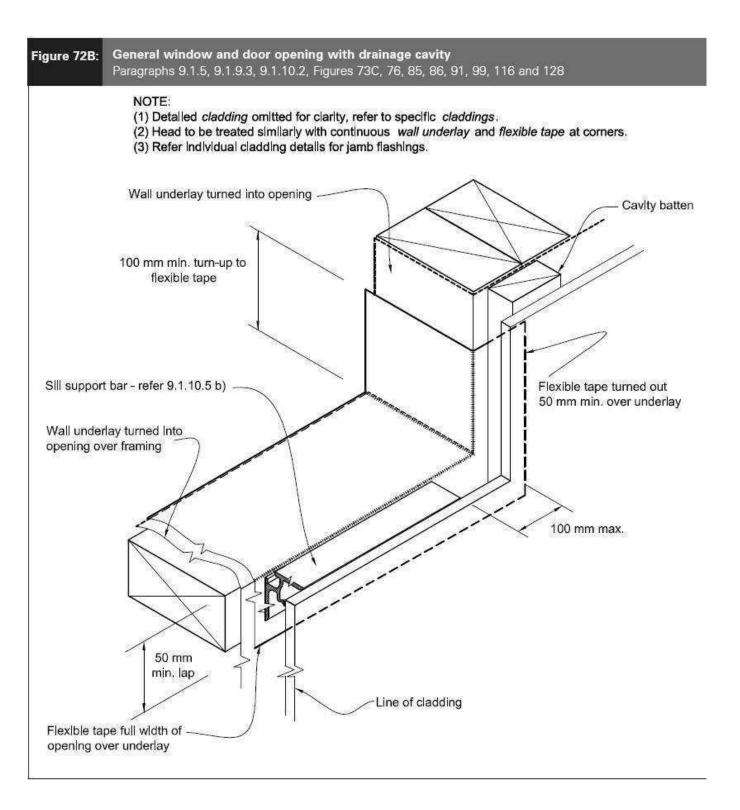

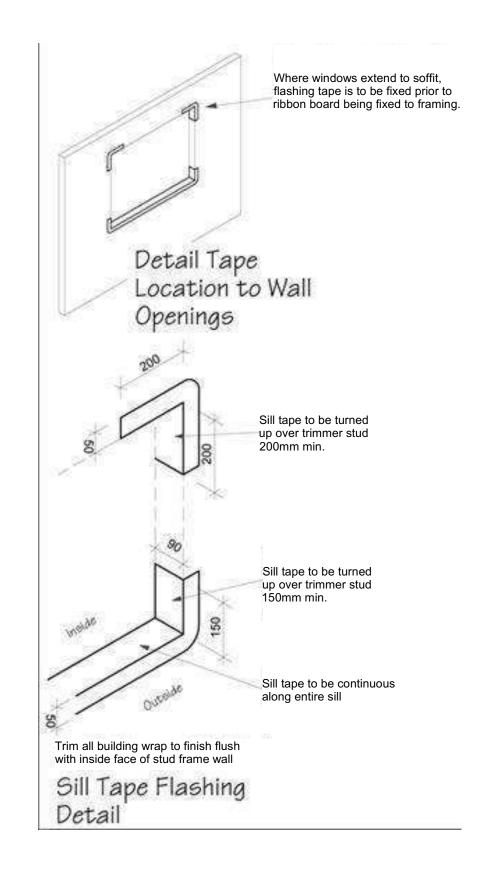

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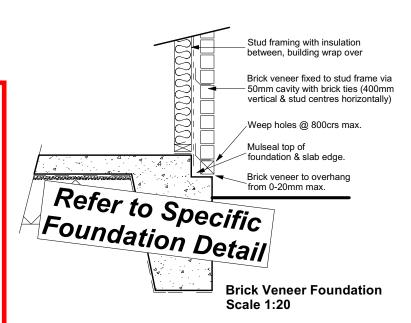
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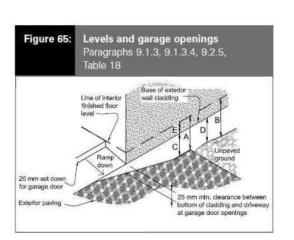
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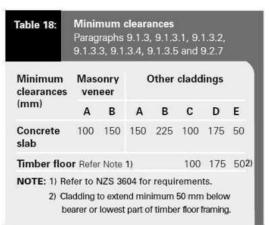
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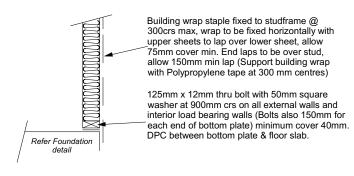
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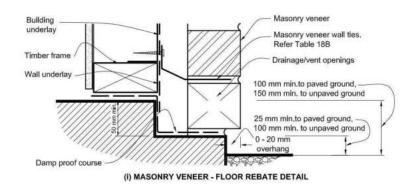











Stud framing to slab **Scale 1:20**



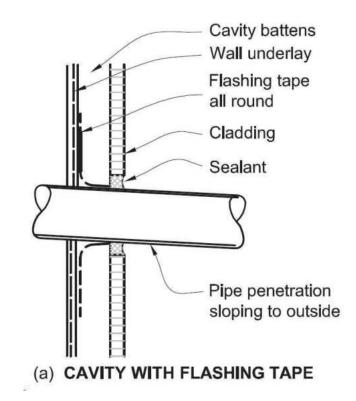

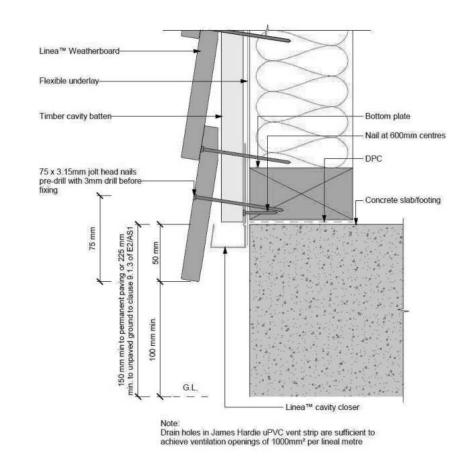

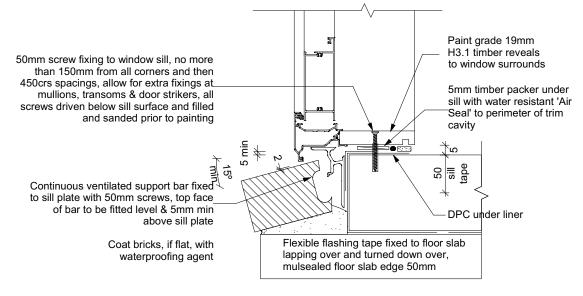

Door Sill to Slab Detail Scale 1:20

All dimensions are to be check and confirmed prior to any construction

Plans are to be read in conjunction with Specifications and all supporting do




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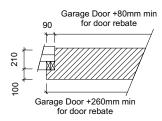
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Sheet Name: Original Plan: **CONSTRUCTION** Snipe 170685 **DETAILS** Print Date

CONSENT PLANS Sheet No.: Date: Reason: 20-03-2023 Initial Consent Plans 17 of 25 sheets As Shown @ A3




Garage Door Rebate Details Scale 1:10

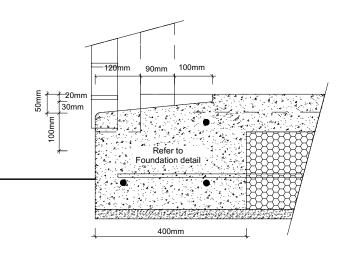


Masons Window sealing Tape to tape flashing to garage door reveal/brick veneer junction, Detail tape flashing to be returned into reveal rebate. Building wrap to be turned back .90mm 00 around face of trimmer stud. Provide Low Expansion foam sealant & pef rod to form air seal between reveal & frame


Garage Door Jamb Detail Scale 1:5

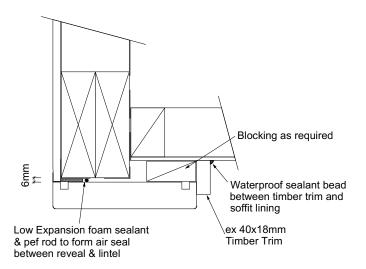

Garage Door Head to Soffit Scale 1:5

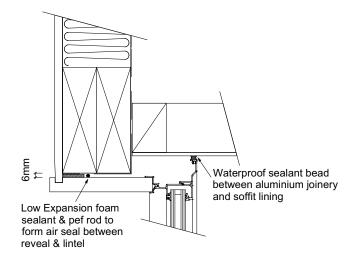

Window Head to Soffit Detail

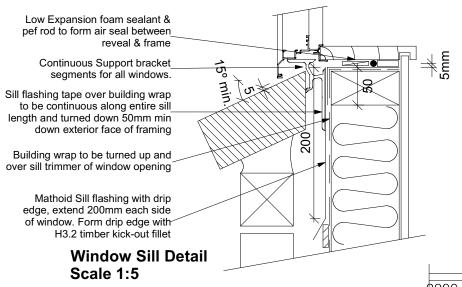

Scale 1:5

and doors

9.1.10.8 Attachments for windows

Install windows and doors using pairs of minimum 75 x 3.15 galvanised jolt head nails or 8 gauge x 65 mm stainless steel screws, through reveals into surrounding framing at:

- a) Maximum 450 mm centres along sills, jambs and heads, and
- b) Maximum 150 mm from reveal ends. Install packers between reveals and framing at all fixing points, except between head

reveals and lintels.

Expandable foam sealant on pef rod to form air seal between cavity system and Gibboard lining Flexible flashing tape in corners Line of head and sill flashings extended 200mm each side of opening 150mm wide Malthoid Jamb flashing to each side of window Aluminium door Brick veneer **Door Jamb Detail** Scale 1:5

Low Expansion foam sealant & pef rod to form air seal between reveal & frame Building wrap to be turned round_ trimmer stud to window opening 150mm wide Malthoid Jamb flashing to each side of window Line of head and sill flashings extended 200mm each side of opening

Window Jamb Detail Scale 1:5

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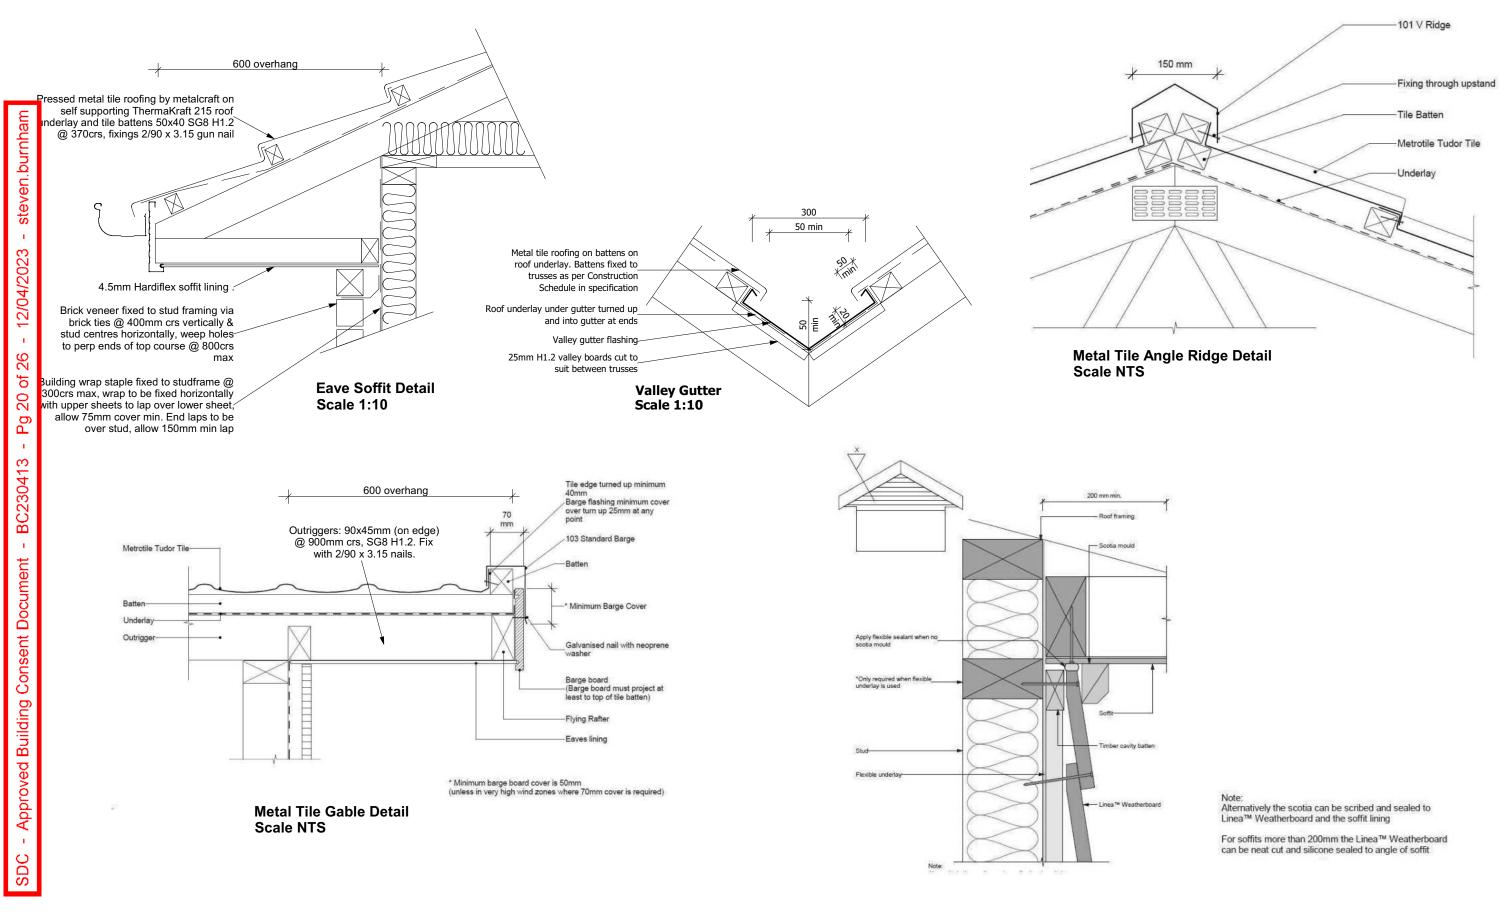
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Sheet Name: Original Plan: **CONSTRUCTION** Snipe 170685 **DETAILS** Print Date As Shown @ A3

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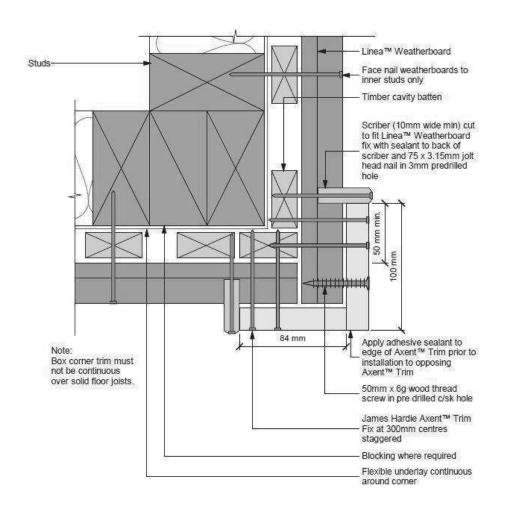
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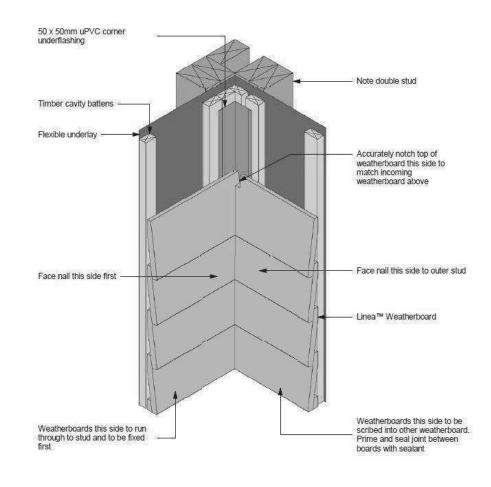
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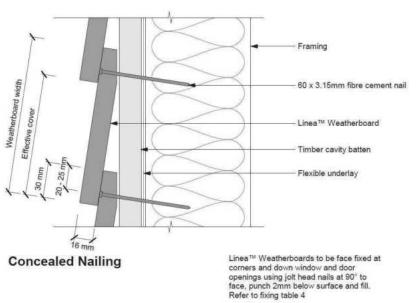
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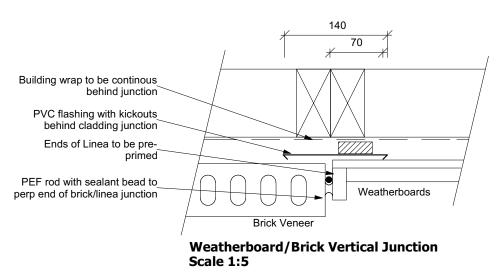
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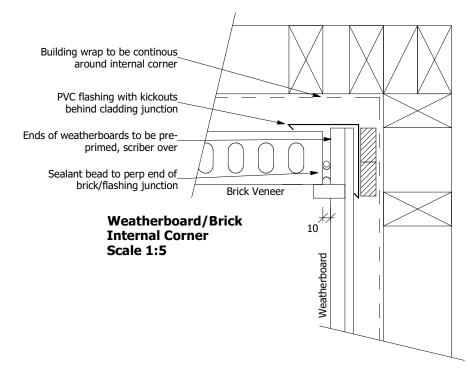
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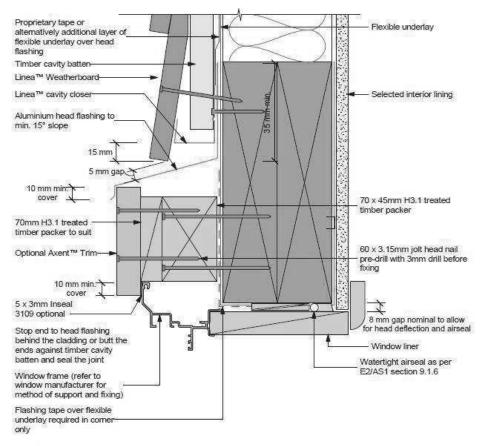
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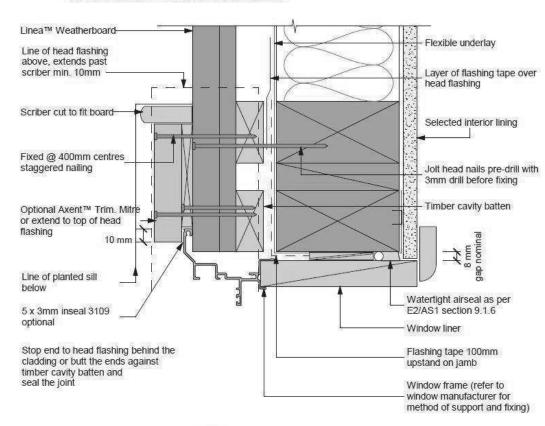
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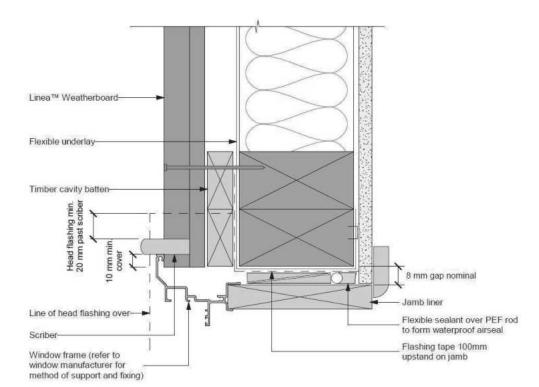
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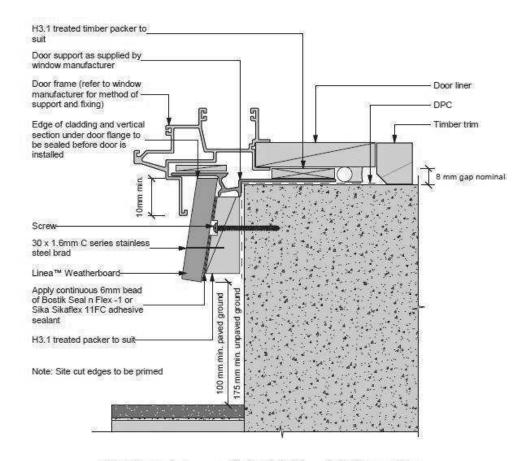
- Sealant must be installed between head flashing and window flange in VH and EH wind zones and SED pressures
 Alternatively, the head flashings can be formed with stop ends as per E2/AS1
- Refer to Figure 22 for sealing end battens to head flashing



Note:

· Site cut edges to be primed





Refer to the manufacturer or supplier for technical information for these materials

General notes for materials selection

- Flashing materials must be selected based on environmental exposure, refer to NZS 3604
 This 20 of the NZSO 524404.
- and Table 20 of the NZBC E2/AS1
- Flexible underlay must comply with acceptable solution E2/AS1
 Flexible underlay must comply with acceptable solution E2/AS1
 Flashing tape must have proven compatibility with the selected flexible underlay and other materials
- with which it comes into contact
- 4. Linea™ Weatherboard to have sealed butt joint over batten at each comer of opening

All dimensions are to be check and confirmed prior to any construction

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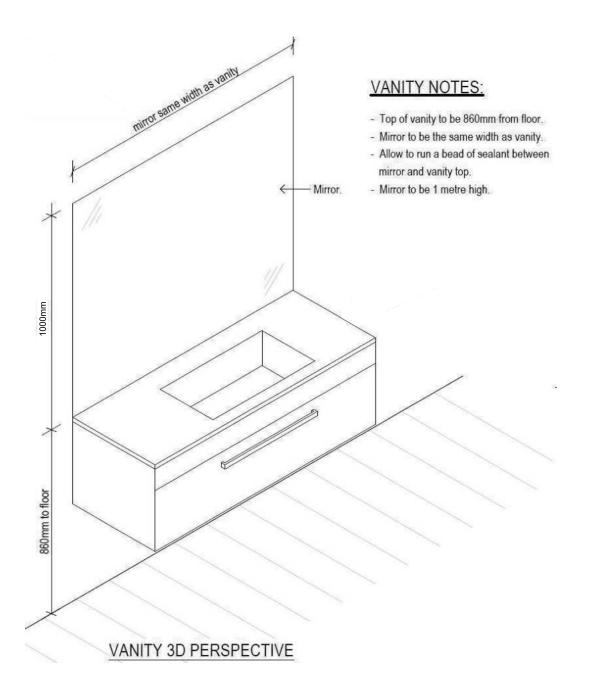



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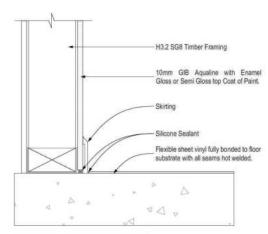
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GENERAL FLOOR/WALL DETAIL

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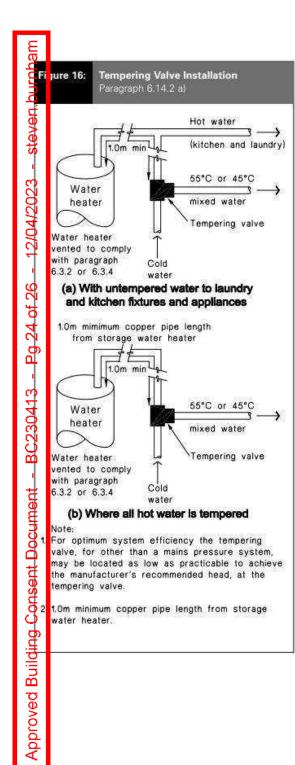



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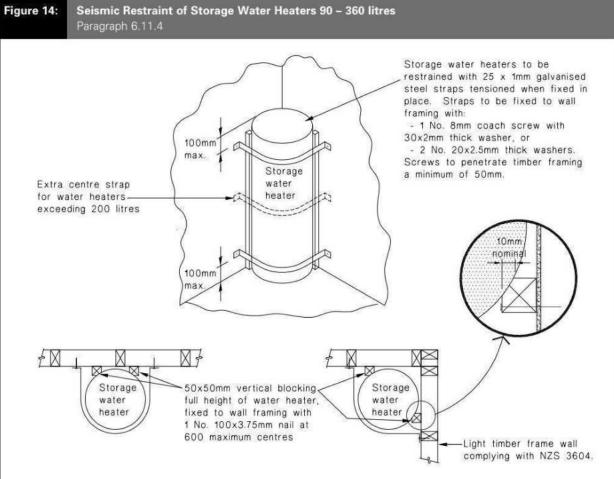
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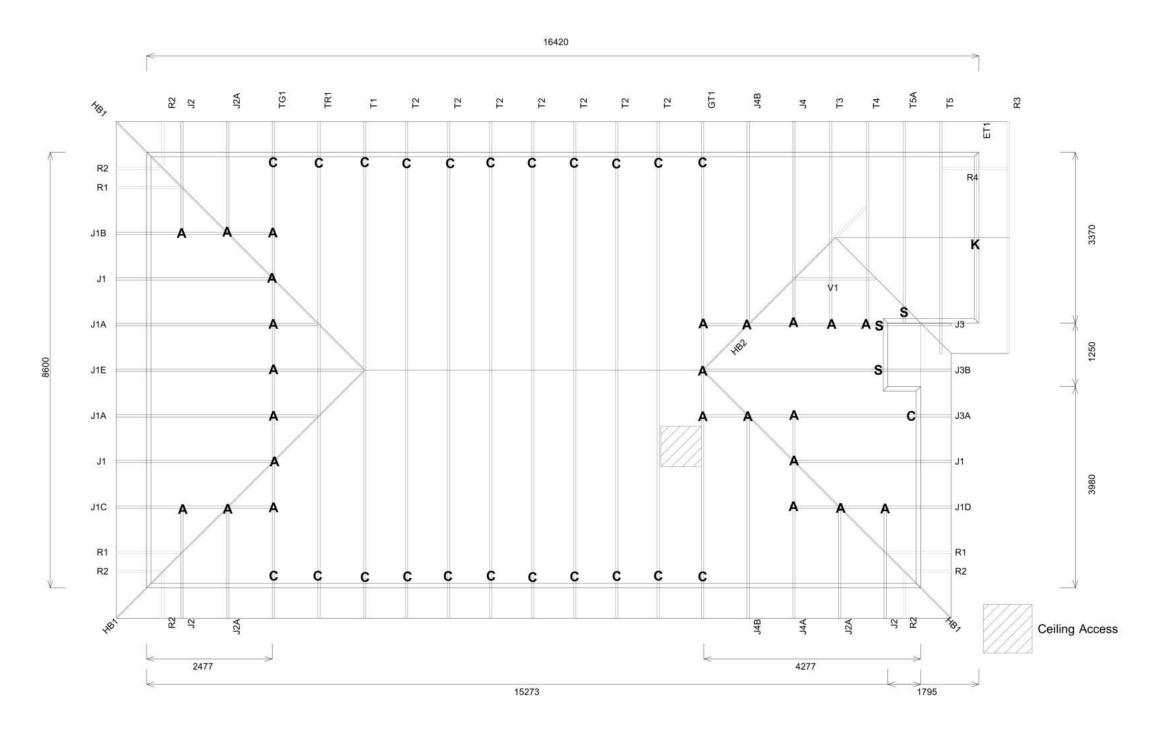
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Buildable Consent Layout



For valley/saddle truss fixing unless stated otherwise use a pair of wire dogs at 900mm centres for up to and including a very high wind zone. Or a pair of CT200's at 900mm centres for extra high wind zone. This fixing is to meet the minimum requirements as per NZS3604.

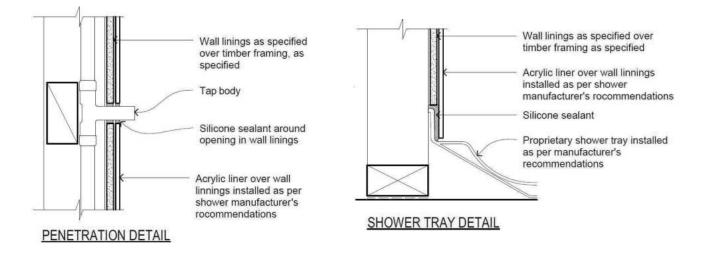

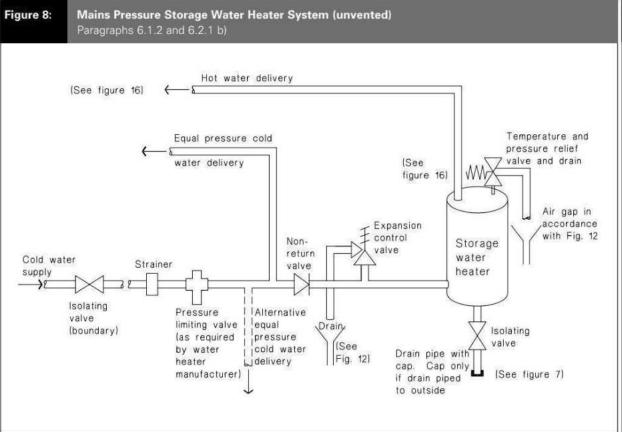

| Truss Fixings |
|------------------------------|
| A = 47x90 Joist Hanger |
| B = 47x120 Joist Hanger |
| C = CT200 (pair) |
| D = 47x190 Joist Hanger |
| E = 95x165 Joist Hanger |
| F = SH-140 Split Hanger |
| G = SH-180 Split Hanger |
| H = SH-220 Split Hanger |
| J = 2x6kN Strap (12kN) |
| K = 6kN Strap |
| L = Multigrip (single) |
| M = Multigrips (pair) |
| N = Nailon Plate (240x110x1) |
| P = 16kN Pack |
| Q = 9kN Pack |
| S = CPC 40 Single Cleat |
| T = CPC 40 Short (pair) |
| U = CPC 80 Single Cleat |
| V = 16kN Uplift |
| Z = Engineers Design |

Unless otherwise indicated, all specified truss fixings are to use L/Lok product nail fasteners or Type 17 - 14g Hex Head Screws (as per the MiTek On-site Guide)

All truss to frame fixings require 2 additional 2/90x3.15dia skew nails

All truss fixings not indicated as above must have 2 wire dogs for cross joints and 2/90x3.15dia nails for butt joins.

Fixings shown are for fixing trusses to the top plate. Any other point load uplift fixings down through the framing stud to top plate, stud to bottom plate, bottom plate to floor remain the responsibility of the architect / draughtsman

Any roof loads as stated on this layout over 16kN lift are outside the scope of NZS3604, and the architect / draughtsperson is responsible for the design to transfer the loads to the ground.

| Snow Zone: | (N4) |
|--------------------|--------------------------------|
| Wind Area: | High |
| TC Restraints: | 400 mm |
| Roof Material: | Metal Tiles |
| Roof Pitch: | 25.00 ° |
| Snow Altitude: | 100.000 m |
| Design Wind Speed: | 44.0 m/s |
| BC Restraints: | 600 mm |
| Ceiling Material: | Standard Plaster Board 13mm |
| Ground Snow Load: | 0.900 kPa |
| Truss Centres: | 900 mm |

Drawn Grace Tarnate

16/03/2023

Job No: CH1384651C1

Customer: TKR Homes Limited | T/A Signature Homes Canterbury

Job Name: TKR Developments

Address: Lot 655 Westwood Rolleston

If a gable truss requires a windbeam brace, the type of MiTek brace will be noted as such on the layout. The truss fixings can be substituted for other fixings of the same or greater capacity.

All verge framing to be fixed according to the MiTek On-Site Guide if not covered by NZS3604.

If bottom chord restraints are 35mm Metal battens, then they must be fixed with either two nails or screws.

If the metal battens are fixed with a single nail or screw then 90x45mm bottom chords restraints will be required at 1800mm centres

All loads shown on this page regarding the truss fixings are characteristic loads

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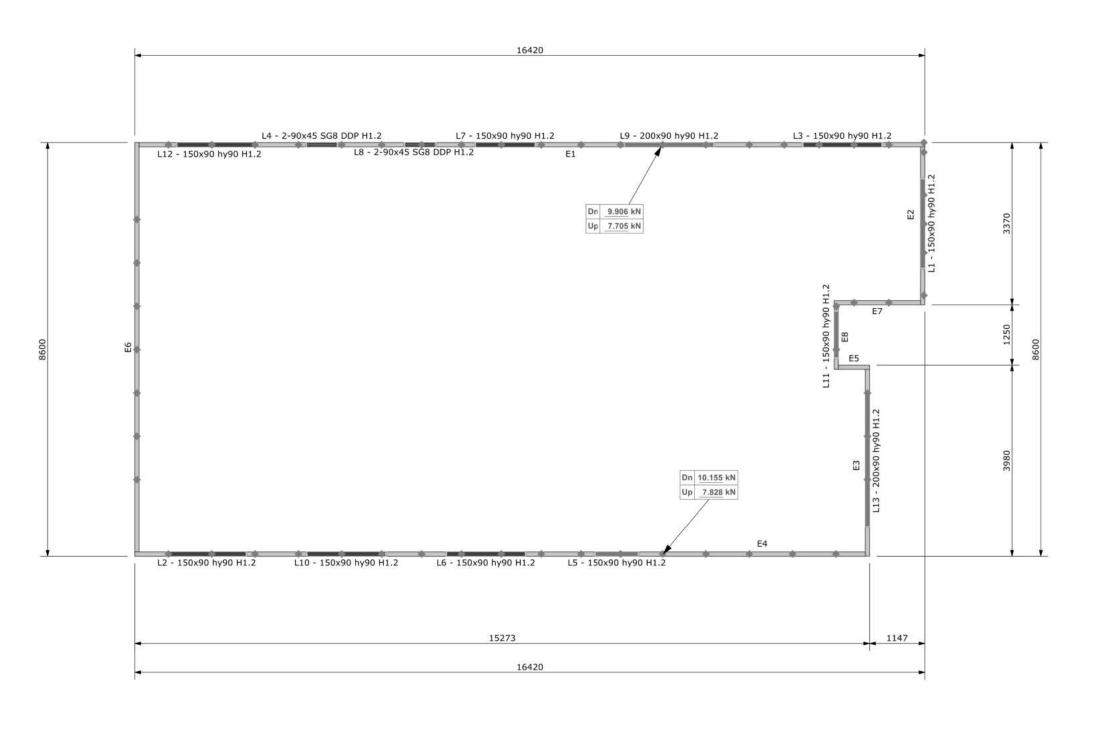
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Buildable Consent Layout




All internal walls shown on this layout are considered to be loadbearing Lintel fixing specification remains the responsibility of the architect / draughtsperson





Lintel Fixings are as per the included reports.

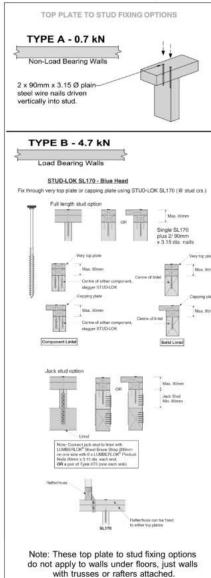

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of 25 sheets



16/03/2023

Job No: CH1384651C1

Customer: TKR Homes Limited | T/A Signature Homes Canterbury

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Notification of point loaded lintels or point loads on internal walls where the downward load is higher than 8kN (85mm raft type slab) or 10kN (100mm standard slab), or the upward load is greater than 10kN. These loads are Ultimate Limit State Loads

If no loads are shown, no thickening is required.

The lintels have been sized using one of the following:

The MiTek SAPPHIRE Component Design Software. hy90, hyONE and hySPAN lintels have been sized using the designIT for houses - New Zealand series 6 software. GANGLAM and FLITCH BEAMS have been sized using the MiTek Beam Program V1.10 June 2011.

Unless otherwise stated the timber grade for all lintels is SG8. Lintels not shown are to be selected as per NZS3604: 2011 or designed by an engineer as required. The lintels have not been designed to support brick shelf angles. The Architect or Engineer is required to design all lintels supporting brick shelf angles.

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