## Osbourne (N1)

Area: 393.900 m<sup>2</sup> / 4239sq/ft (structural / excluding garage)

DRG NO	REV	DRAWING TITLE	SCALE	SHEET	DATE	REV DATE
N1-A-00	<b>C</b> 7	Drawing Index	N/A	A3		12-12-22
N1-A-01	C2	Sub-structure plan (3 storey)	1:50	A1	19-05-21	01-03-22
N1-A-02	C3	Ground floor plan	1:50	A1	19-05-21	06-04-22
N1-A-03	C2	First floor plan	1:50	A1	19-05-21	03-10-22
N1-A-04	C1	Second floor plan	1:50	A1	19-05-21	03-02-22
N1-A-05	C1	Joist plan	1:50	A1	08-07-21	03-02-22
N1-A-06	C1	Roof plan	1:50	A1	08-07-21	03-02-22
N1-A-07	C1	Sections	1:50	A1	08-07-21	03-02-22
N1-A-08	C1	Front + Side elevations	1:50	A1	08-07-21	03-02-22
N1-A-09	C1	Rear + Side elevations	1:50	A1	08-07-21	03-02-22
N1-A-10	C4	M&E layout	1:50	A1	10-09-21	15-11-22
N1-A-11	C3	M&E layout	1:50	A1	10-09-21	12-12-22
N1-A-12	C3	Floor finishes	-	A1	10-09-21	16-09-22
N1-A-13	C2	Cloaks, bathroom and en-suite Detailed Layouts and Elevations	1:20 / 50	A1	10-09-21	16-09-22
N1-A-14	C1	Cloaks, bathroom and en-suite Detailed Layouts and Elevations	1:20 / 50	A1	10-09-21	03-02-22
N1-A-15	C3	Sales plans	1:50	A1	03-11-21	16-09-22
N1-A-16	C1	Oriel bay window detail	1:20	A1	03-11-21	03-02-22

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C7	Updates as noted on plans.	12-12-22	CW
C6	Updates as noted on plans.	15-11-22	CW
C5	Updates as noted on plans.	03-10-22	CW
C4	Updates as noted on plans.	16-09-22	CW
C3	Updates as noted on plans.	06-04-22	CW
C2	Updates as noted on plans.	01-03-22	CW
C1	Issued for CONSTRUCTION	03-02-22	CW
T1 / T6	Issued for TENDER	10-09-21 / 18-01-22	CW
REV:	REVISION DESCRIPTION	DATE	AUTHOR



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Edenstone Group Building 102, Wales 1, Business Park Magor NP26 3DG

PROJECT DETAILS:

Land North Of Lisvane Road

HOUSETYPE NAME:

Osbourne (N1)


DRAWING TITLE:

**Cover Sheet** 

scale: 1:50 @ A3	DATE: Aug 2021	DRAWN BY:	CHECKED BY:
JOB NO: 801	DRAWING NO: N1-A-00		REVISION:

STATUS:

CONSTRUCTION

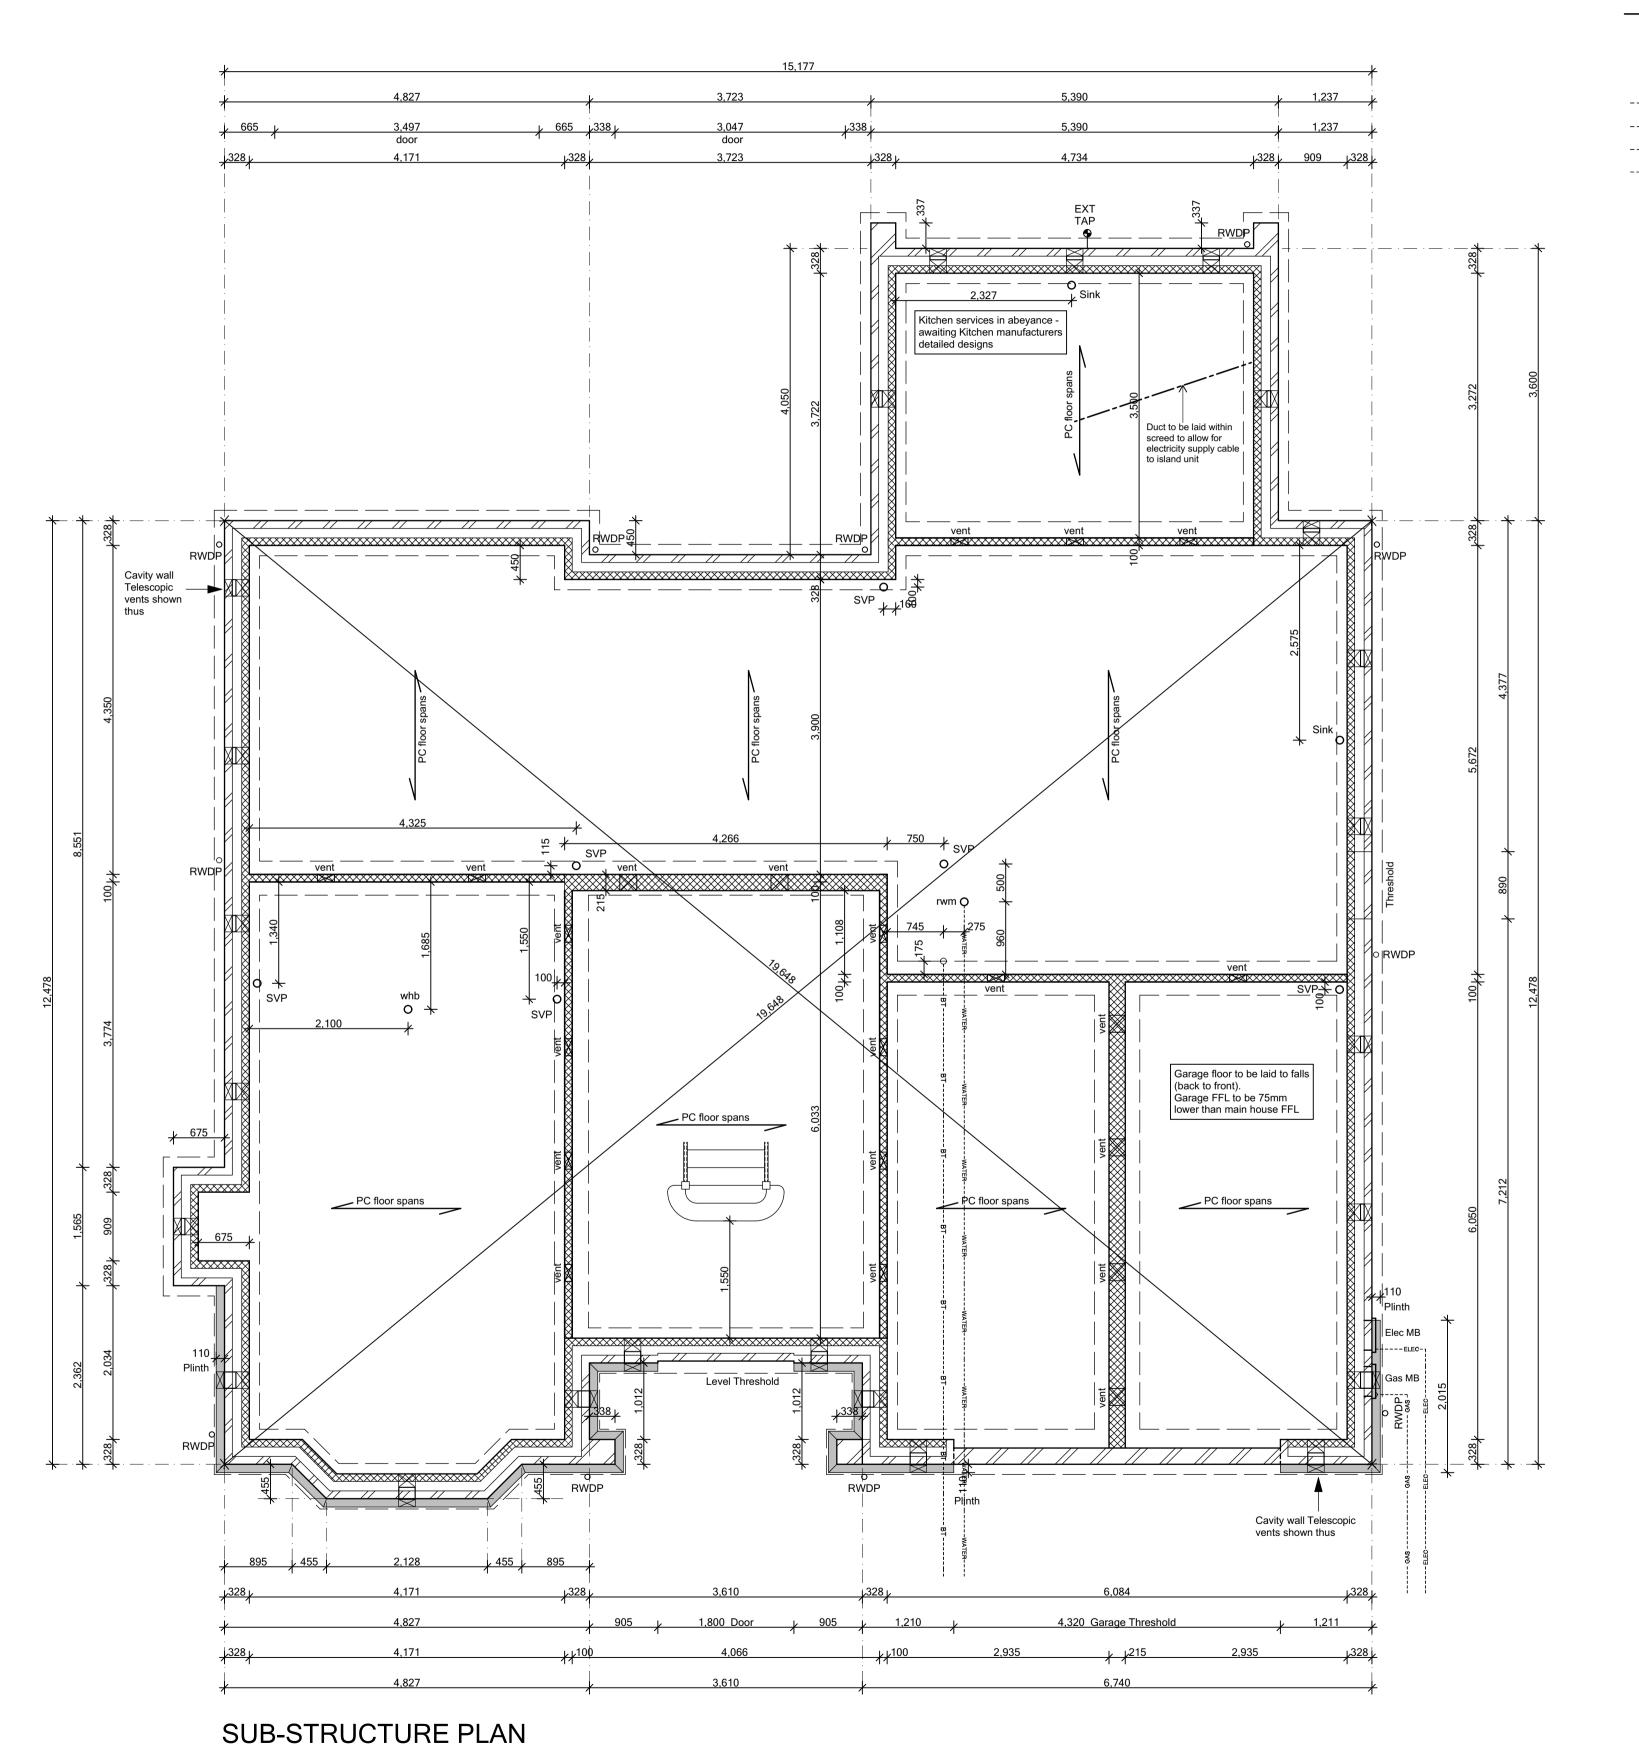

### GROUNDWORKS legend

Insulated incoming Water service to Rising Water Main 750mm EXTERNAL WALLS BELOW DPC 328mm cavity wall construction for a minimum of 3 courses BGL. To be positioned 125mm below dpc comprising of 103mm FL quality outer leaf min from inner skin of the external brickwork with a 128mm cavity & 100mm blockwork as noted by the Structural Engineer.
FOR FURTHER DETAILS REFER TO ENGINEERS DRAWINGS ----- ELEC-- Incoming Electric service ----- GAS - Incoming Gas service INTERNAL WALLS BELOW DPC Internal walls to be 100 / 215mm blockwork ----- BT- Incoming BT service FOR FURTHER DETAILS REFER TO ENGINEERS DRAWINGS ---- vm-- Incoming Virgin media service Soil and Vent Pipe 100mm Proprietary telescopic vents. Vents to be positioned between dia with rest bend beams. Air bricks to be located 450mm from any corner and spaced @ max 2000mm cts. (1912.5mm brick dim) Stub stack 100mm dia with rest bend and Durgo The openings should be not less than either 1500mm²/M run of external wall or 500mm²/M² of floor area, whichever gives the greater opening area. Any pipes needed to carry ventilating air should have a diameter of at least 100mm. Ventilation Sealed floor connector for WC openings should incorporate suitable grilles which prevent the entry of vermin. Sealed floor connector Based on a vent with 6000mm<sup>2</sup> opening area for Wash Hand Basin  $66.5 (x1500 \text{mm}^2/\text{M}) = 17 \text{ vents}$ Sealed floor connector 183  $(x500 \text{mm}^2/\text{M}^2)$  = 16 vents for Sink Perimeter/Area (PA) ratio = 0.35 Sealed floor connector for Shower STRUCTURAL ENGINEERS DRAWINGS TAKE PRECEDENCE OVER THIS DRAWING. ALWAYS CROSS CHECK WITH STRUCTURAL ENGINEERS Back Inlet Gully DRAWINGS. ALTERNATIVE SLAB, FOUNDATIONS, ADDITIONAL SLEEPERWALLS ETC MAY BE REQUIRED DEPENDING ON SITE CONDITIONS.

THIS SPECIFICATION IS A CONDENSED VERSION AND SHOULD BE READ IN CONJUNCTION WITH THE FULL SPECIFCATION INCLUDED IN THE HOUSE TYPE PACK

C2 Duct to kitchen island added C1 Issued for CONSTRUCTION 01-03-22 CW 03-02-22 CW 05-11-21 General updates to Clients comment.
Issued for TENDER 22-10-21 10-09-21 REV: REVISION DESCRIPTION Architectural Consultants CLIENT: Edenstone Group Building 102, Wales 1, Business Park Magor NP26 3DG PROJECT DETAILS: Land North of Lisvane Road HOUSETYPE NAME: OSBOURNE (N1) DRAWING TITLE: Sub-Structure Plan DRAWN BY: CHECKED BY

Plot No. As - 3. Ha - .


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 May 2021
 AD


 JOB NO:
 DRAWING NO:
 REVISION:

 801
 N1-A-01
 C2

 STATUS:


 CONSTRUCTION

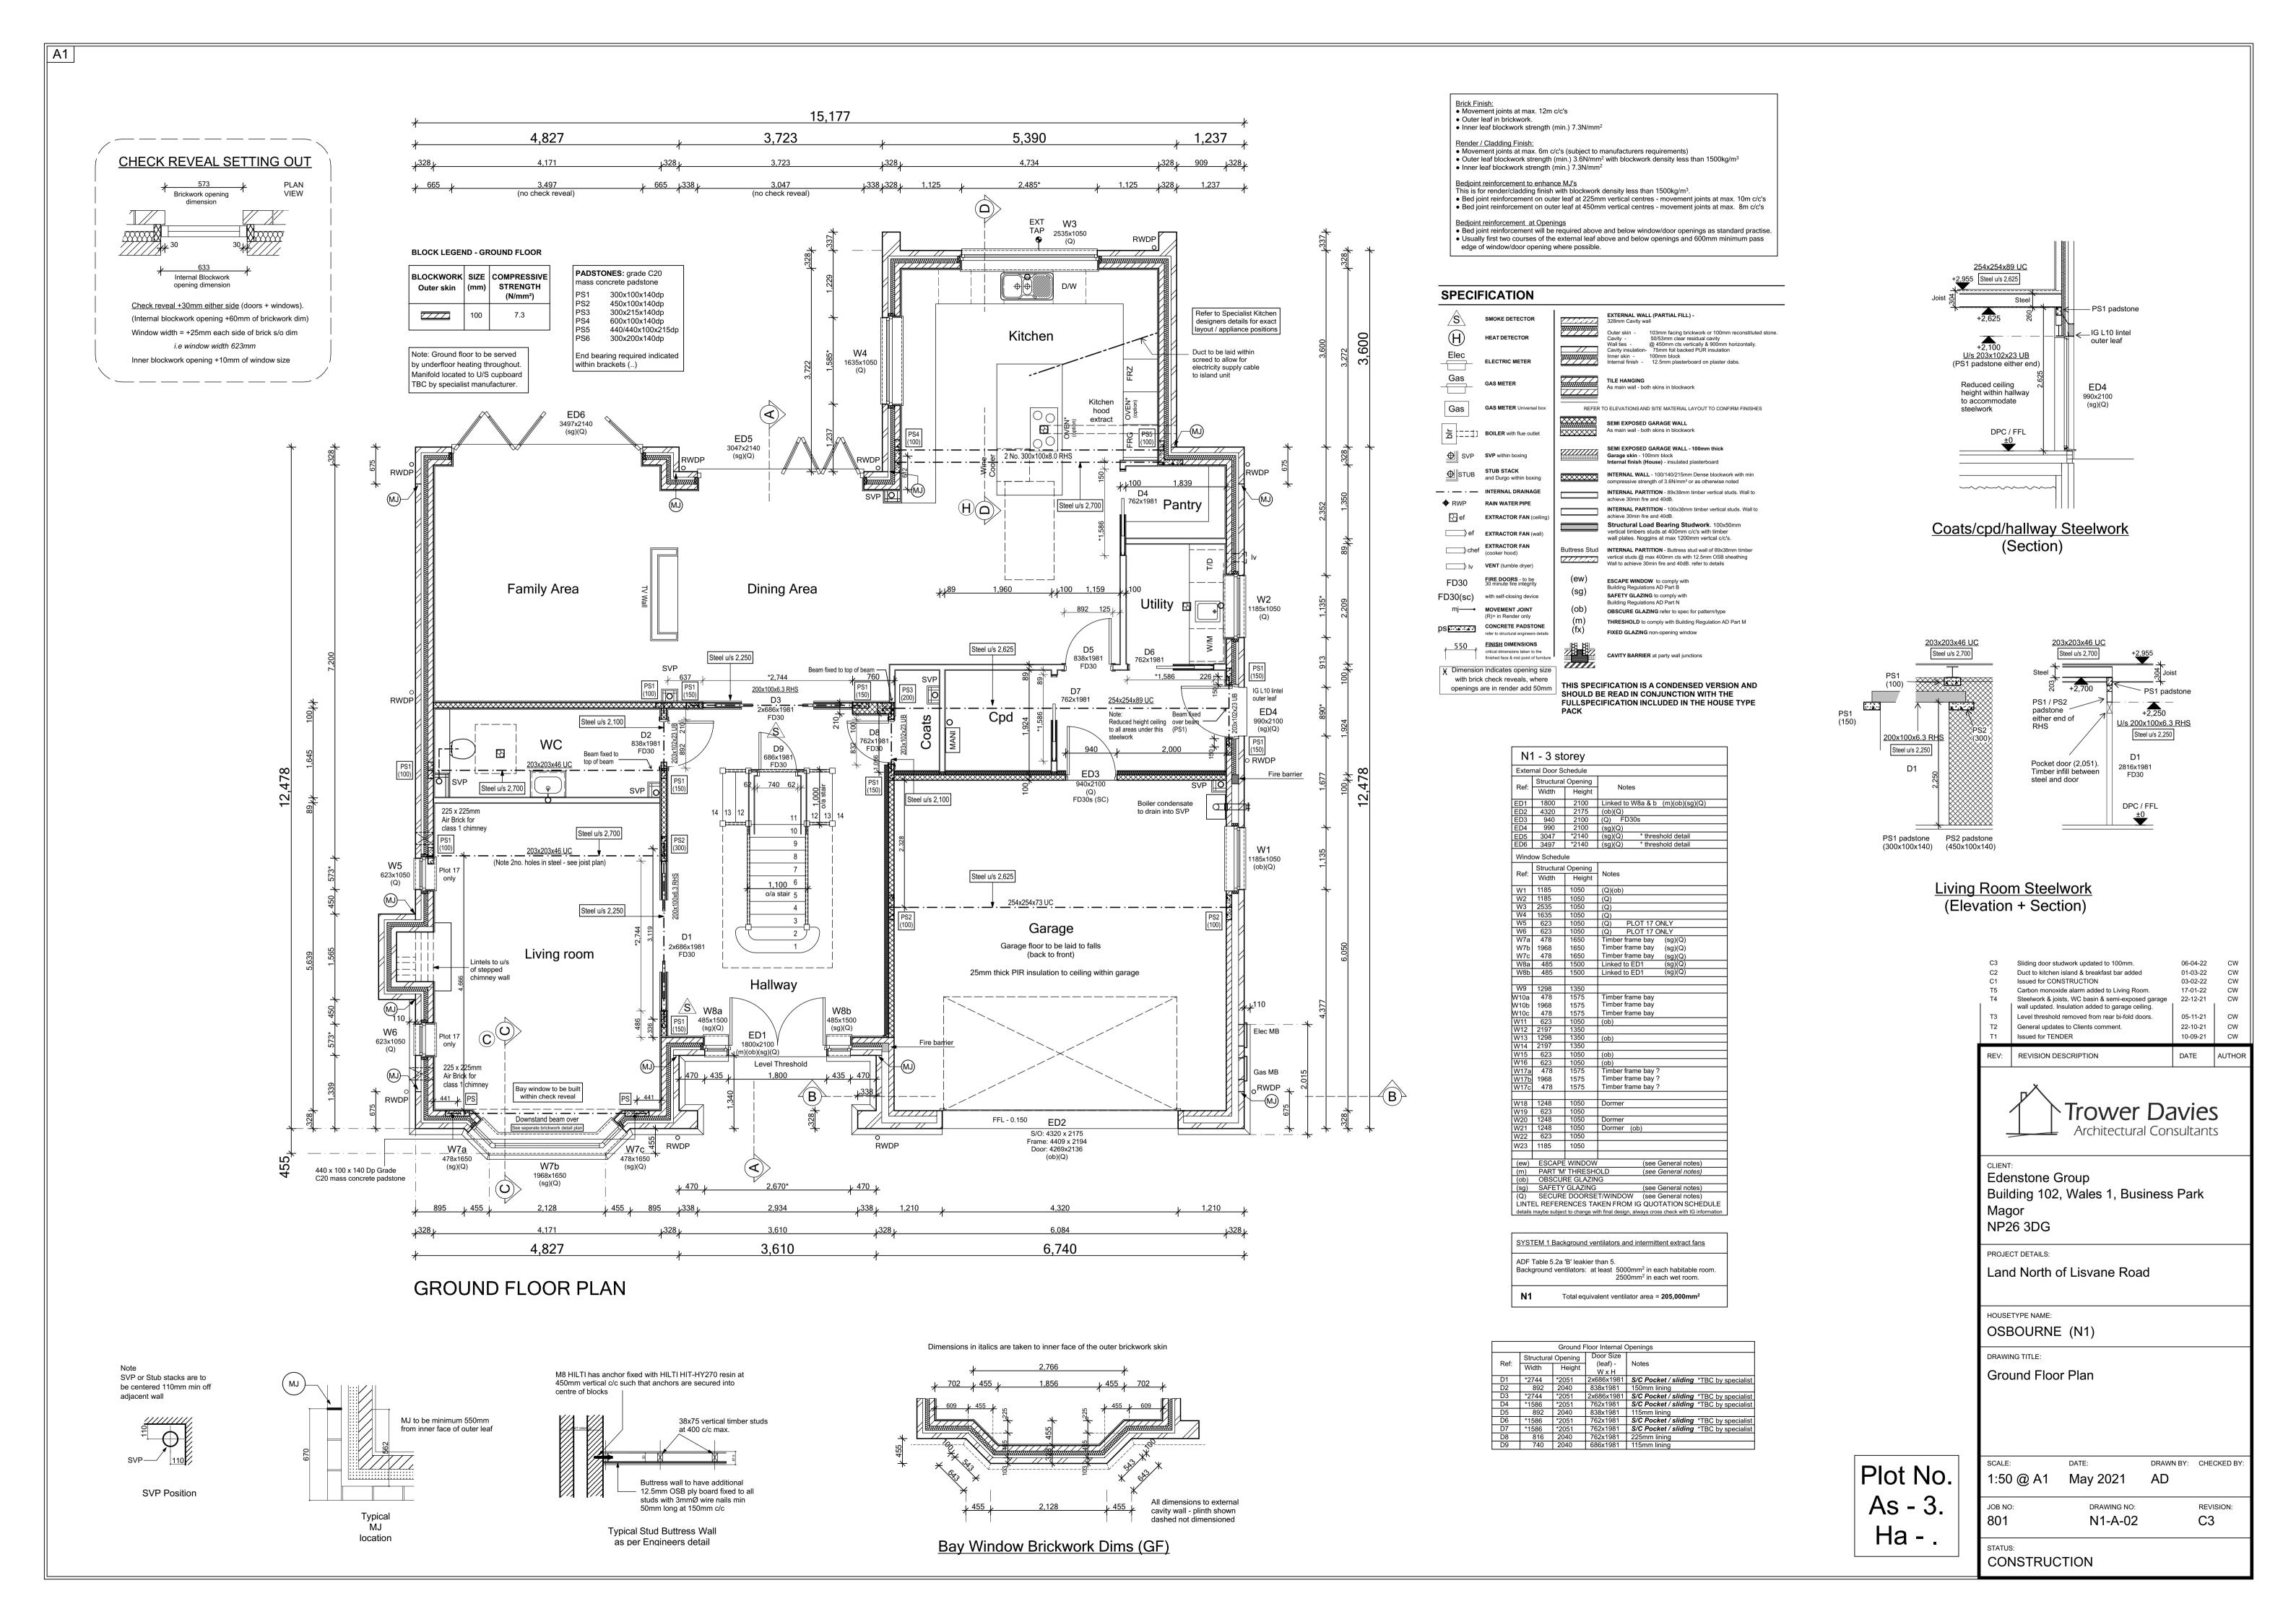


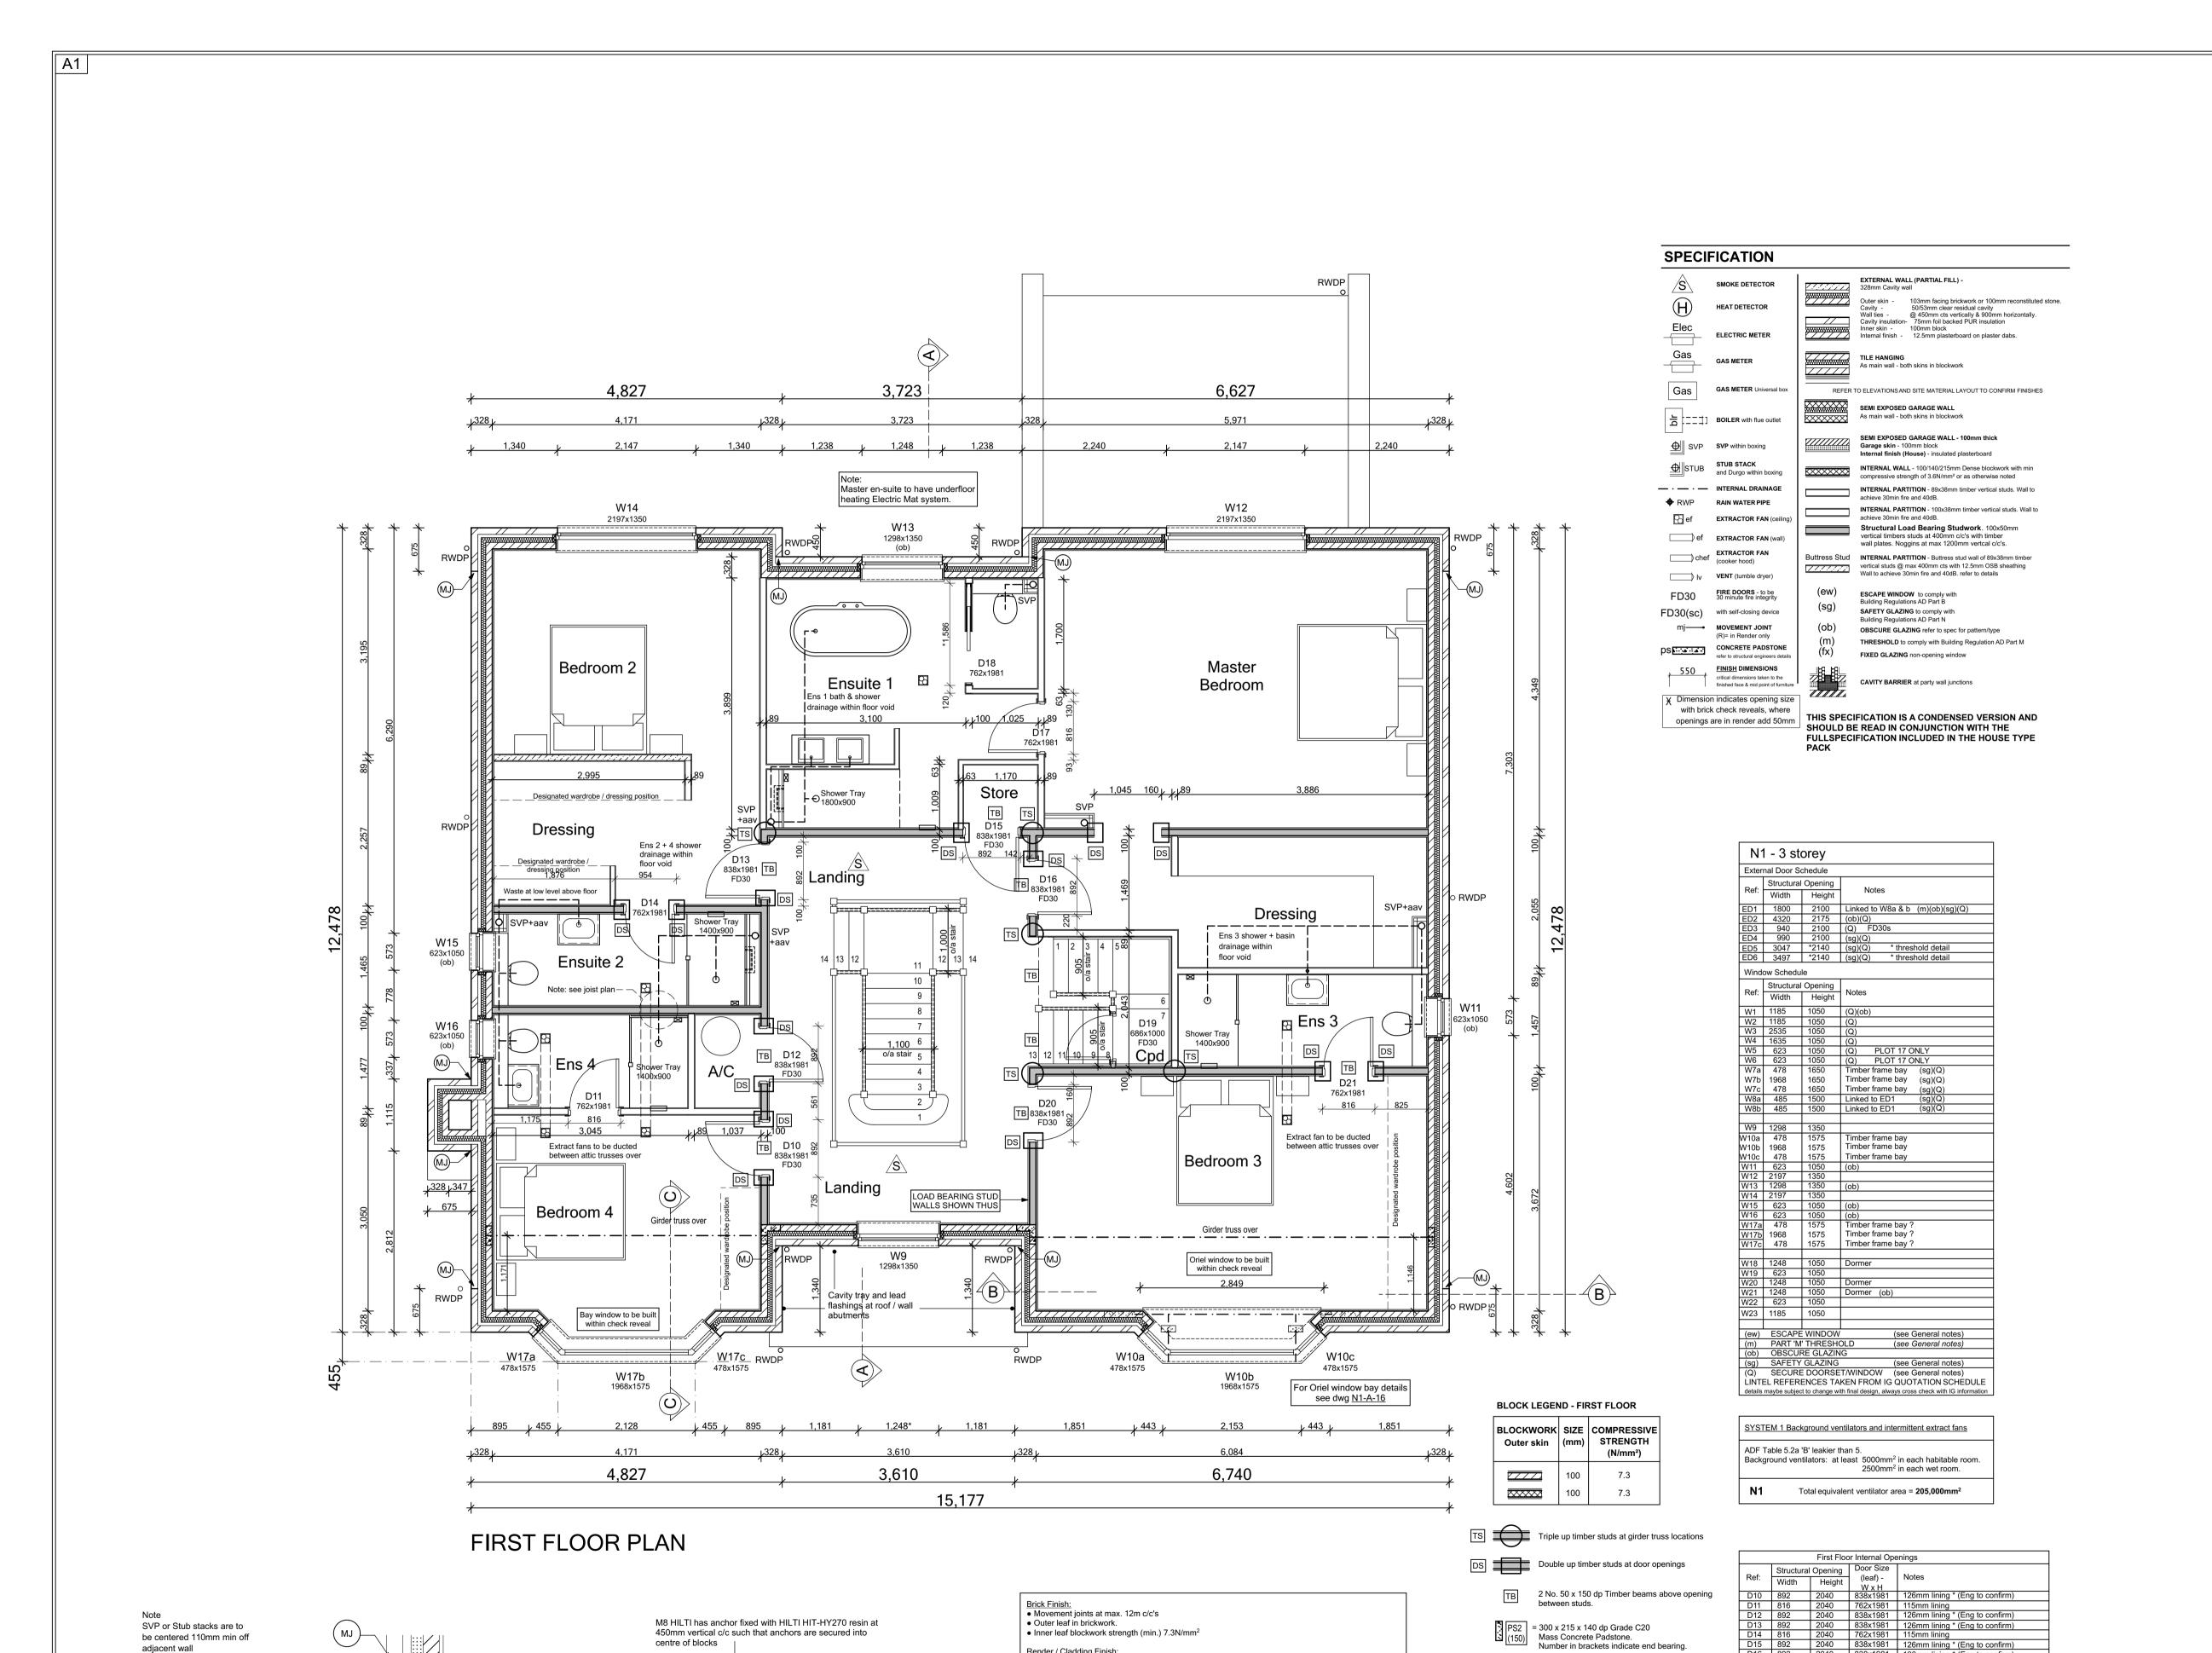

be centered 110mm min off adjacent wall

**SVP Position** 

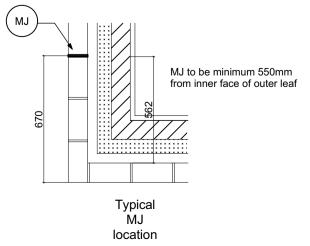

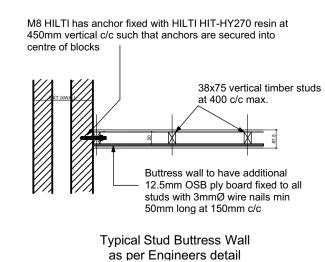

Brick Finish:  Movement joints at max. 12m c/c's  Outer leaf in brickwork.  Inner leaf blockwork strength (min.) 7.3N/mm²
Render / Cladding Finish:  • Movement joints at max. 6m c/c's (subject to manufacturers requirements)  • Outer leaf blockwork strength (min.) 3.6N/mm² with blockwork density less than 1500kg/m³  • Inner leaf blockwork strength (min.) 7.3N/mm²
Bedjoint reinforcement to enhance MJ's  This is for render/cladding finish with blockwork density less than 1500kg/m³.  • Bed joint reinforcement on outer leaf at 225mm vertical centres - movement joints at max. 10m c/c's  • Bed joint reinforcement on outer leaf at 450mm vertical centres - movement joints at max. 8m c/c's
Bedjoint reinforcement at Openings     Bed joint reinforcement will be required above and below window/door openings as standard practise.     Usually first two courses of the external leaf above and below openings and 600mm minimum pass edge of window/door opening where possible.

iluei tiuss locations					
4	First Floor Internal Openings				
door openings		Structura	Structural Opening		
	Ref:	Width	Height	(leaf) - W x H	Notes
beams above opening	D10	892	2040	838x1981	126mm lining * (Eng to confirm)
	D11	816	2040	762x1981	115mm lining
	D12	892	2040	838x1981	126mm lining * (Eng to confirm)
C20	D13	892	2040	838x1981	126mm lining * (Eng to confirm)
020	D14	816	2040	762x1981	115mm lining
te end bearing.	D15	892	2040	838x1981	126mm lining * (Eng to confirm)
<b>3</b>	D16	892	2040	838x1981	126mm lining * (Eng to confirm)
	D17	816	2040	762x1981	115mm lining
	D18	*1586	*2051	762x1981	S/C Pocket / sliding *TBC by specialist
	D19	740	1060	686x1000	126mm lining * (Eng to confirm)
	D20	892	2040	838x1981	126mm lining * (Eng to confirm)
	D21	816	2040	762x1981	126mm lining * (Eng to confirm)

VVOA	405	1500	LIIREG TO ED 1	(09)(0)
W8b	485	1500	Linked to ED1	(sg)(Q)
W9	1200	1250		
	1298 478	1350 1575	Timbor from - L	201
W10a W10b	478 1968	1575	Timber frame by Timber frame by	
W10b	478	1575	Timber frame b	,
W11	623	1050	(ob)	oay
W12	2197	1350	(00)	
W13	1298	1350	(ah)	
W14	2197	1350	(ob)	
W15	623	1050	(ob)	
W16	623	1050	(ob)	
W17a	478	1575	Timber frame b	201/2
W17b	1968	1575	Timber frame b	
W17c	478	1575	Timber frame b	
VVI/C	470	1575	Tillibel Italile L	oay :
W18	1248	1050	Dormer	
W19	623	1050	Dominer	
W20	1248	1050	Dormer	
W21	1248	1050	Dormer (ob)	
W22	623	1050	Donner (OD)	
W23	1185	1050		
, ,				
(ew)		WINDOW		see General notes)
(m)		THRESHO		see General notes)
(ob)		RE GLAZINO		0
(sg)		GLAZING		see General notes)
(Q)		DOORSET		see General notes)
				QUOTATION SCHEDULE
details	maybe subjec	t to change with	n final design, alway	s cross check with IG information
evet	EM 1 Dool	around von	tilators and into	rmittent extract fans
3131	EIVI I Daci	tground ven	ulators and inte	millent extract lans
		'B' leakier th		
Back	ground ven	tilators: at l	east 5000mm <sup>2</sup>	in each habitable room.
			2500mm²	in each wet room.
N1	Т	otal equival	ent ventilator ar	ea = <b>205,000mm</b> ²
		First Flo	or Internal Ope	enings
	Structur		Door Size	<u>-</u>
Ref:		ral Opening	(loof)	Notes
	Width	Height	W x H	<del>-</del>
D10	892	2040	838x1981	126mm lining * (Eng to confirm)
D11	816	2040	762x1981	115mm lining
D12	1 0 10			
				126mm lining * (Eng to confirm)
D13	892	2040	838x1981	126mm lining * (Eng to confirm)
D13	892 892	2040 2040	838x1981 838x1981	126mm lining * (Eng to confirm)
D14	892 892 816	2040 2040 2040	838x1981 838x1981 762x1981	126mm lining * (Eng to confirm) 115mm lining
	892 892	2040 2040	838x1981 838x1981	126mm lining * (Eng to confirm)

T5 T4 T3 T2 T1	sliding door studwork updated to 100mm. Wardrobes & sanitary items, ens 3 basin drainage & landing window updated. En-suite 4 shower tray updated to 1400mm Oriel window information & wardrobe note added. General updates to Clients comment. Issued for TENDER	03-02-22 22-12-21 11-11-21 03-11-21 22-10-21 10-09-21	CW CW CW CW CW						
REV:	REVISION DESCRIPTION	DATE	AUTHOR						
-	Trower Da Architectural Con								
Ede Build Mag	CLIENT: Edenstone Group Building 102, Wales 1, Business Park Magor NP26 3DG								
PROJE	CT DETAILS:								
Land	d North of Lisvane Road								
HOUSE	TYPE NAME:								
OSE	BOURNE (N1)								
DRAWI	NG TITLE:								
First Floor Plan									

C2 Under stairs cupboard to SF staircase updated.

C1 Issued for CONSTRUCTION

03-10-22 CW


Plot No. As - 3. Ha - .

STATUS:

CONSTRUCTION

SCALE:	DATE:	DRAWN BY:	CHECKED BY:
1:50 @ A1	May 2021	AD	
JOB NO:	DRAWING NO:		REVISION:
801	N1-A-03		C2



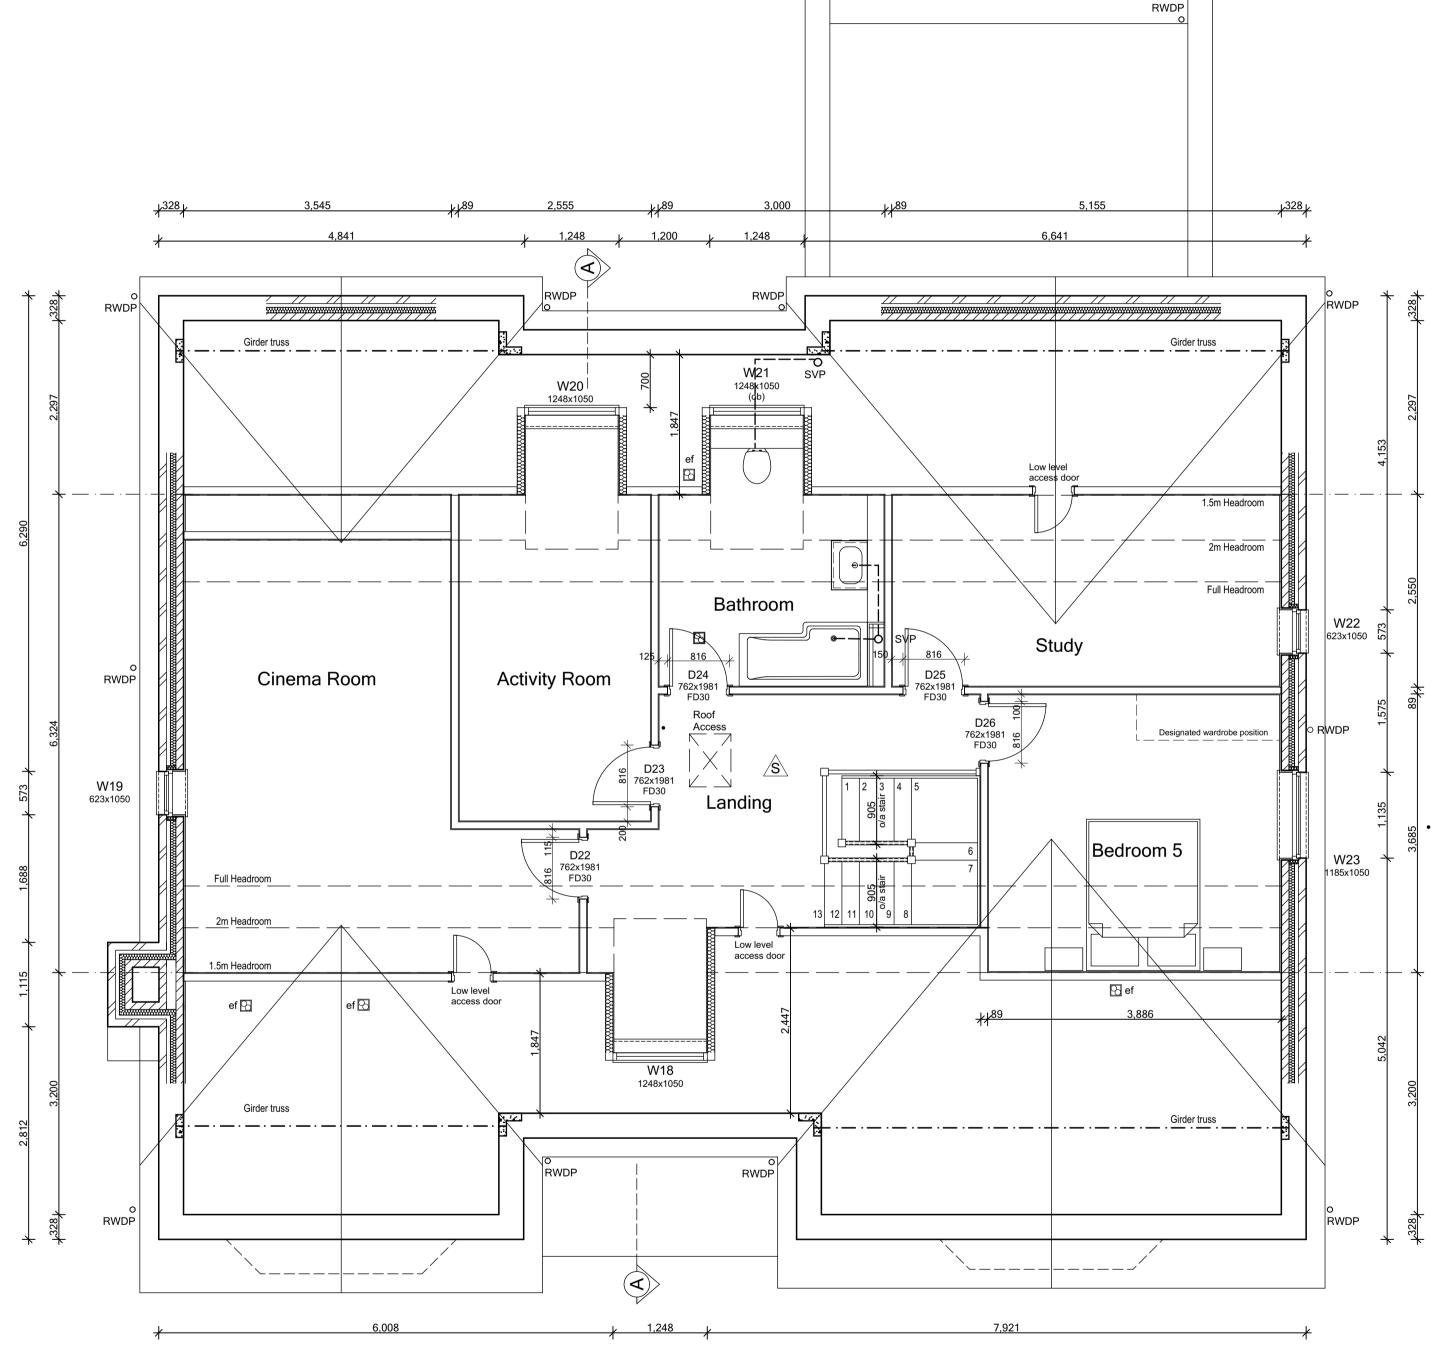

SECOND FLOOR PLAN



	Second Floor Internal Openings					
Ref:	Structural Opening Door Size	Notes				
Ref:	Width	Height	(leaf) - W x H	Notes		
D22	816	2040	762x1981	115mm lining		
D23	816	2040	762x1981	115mm lining		
D24	816	2040	762x1981	115mm lining		
D25	816	2040	762x1981	115mm lining		
D26	816	2040	762x1981	115mm lining		

Brick Finish:

• Movement joints at max. 12m c/c's Outer leaf in brickwork. • Inner leaf blockwork strength (min.) 7.3N/mm<sup>2</sup>

Render / Cladding Finish:

• Movement joints at max. 6m c/c's (subject to manufacturers requirements)

• Outer leaf blockwork strength (min.) 3.6N/mm² with blockwork density less than 1500kg/m³

• Inner leaf blockwork strength (min.) 7.3N/mm²

Bedjoint reinforcement to enhance MJ's

This is for render/cladding finish with blockwork density less than 1500kg/m³.

Bed joint reinforcement on outer leaf at 225mm vertical centres - movement joints at max. 10m c/c's

Bed joint reinforcement on outer leaf at 450mm vertical centres - movement joints at max. 8m c/c's

Bedjoint reinforcement at Openings
 Bed joint reinforcement will be required above and below window/door openings as standard practise.
 Usually first two courses of the external leaf above and below openings and 600mm minimum pass edge of window/door opening where possible.

C1	Issued for CONSTRUCTION	03-02-22	CW
T4	Wardrobes & sanitary items updated, roof access		
	doors adjusted in line with truss design.	22-12-21	CW
T3	Wardrobe note added.	05-11-21	CW
T2	General updates to Clients comment.	22-10-21	CW
T1	Tender Issue	10-09-21	CW
REV:	REVISION DESCRIPTION	DATE	AUTHOR



Edenstone Group Building 102, Wales 1, Business Park Magor NP26 3DG

PROJECT DETAILS:

Land North of Lisvane Road

HOUSETYPE NAME: OSBOURNE (N1)

DRAWING TITLE: Second Floor Plan

DRAWN BY: CHECKED BY: 1:50 @ A1 May 2021 AD DRAWING NO:


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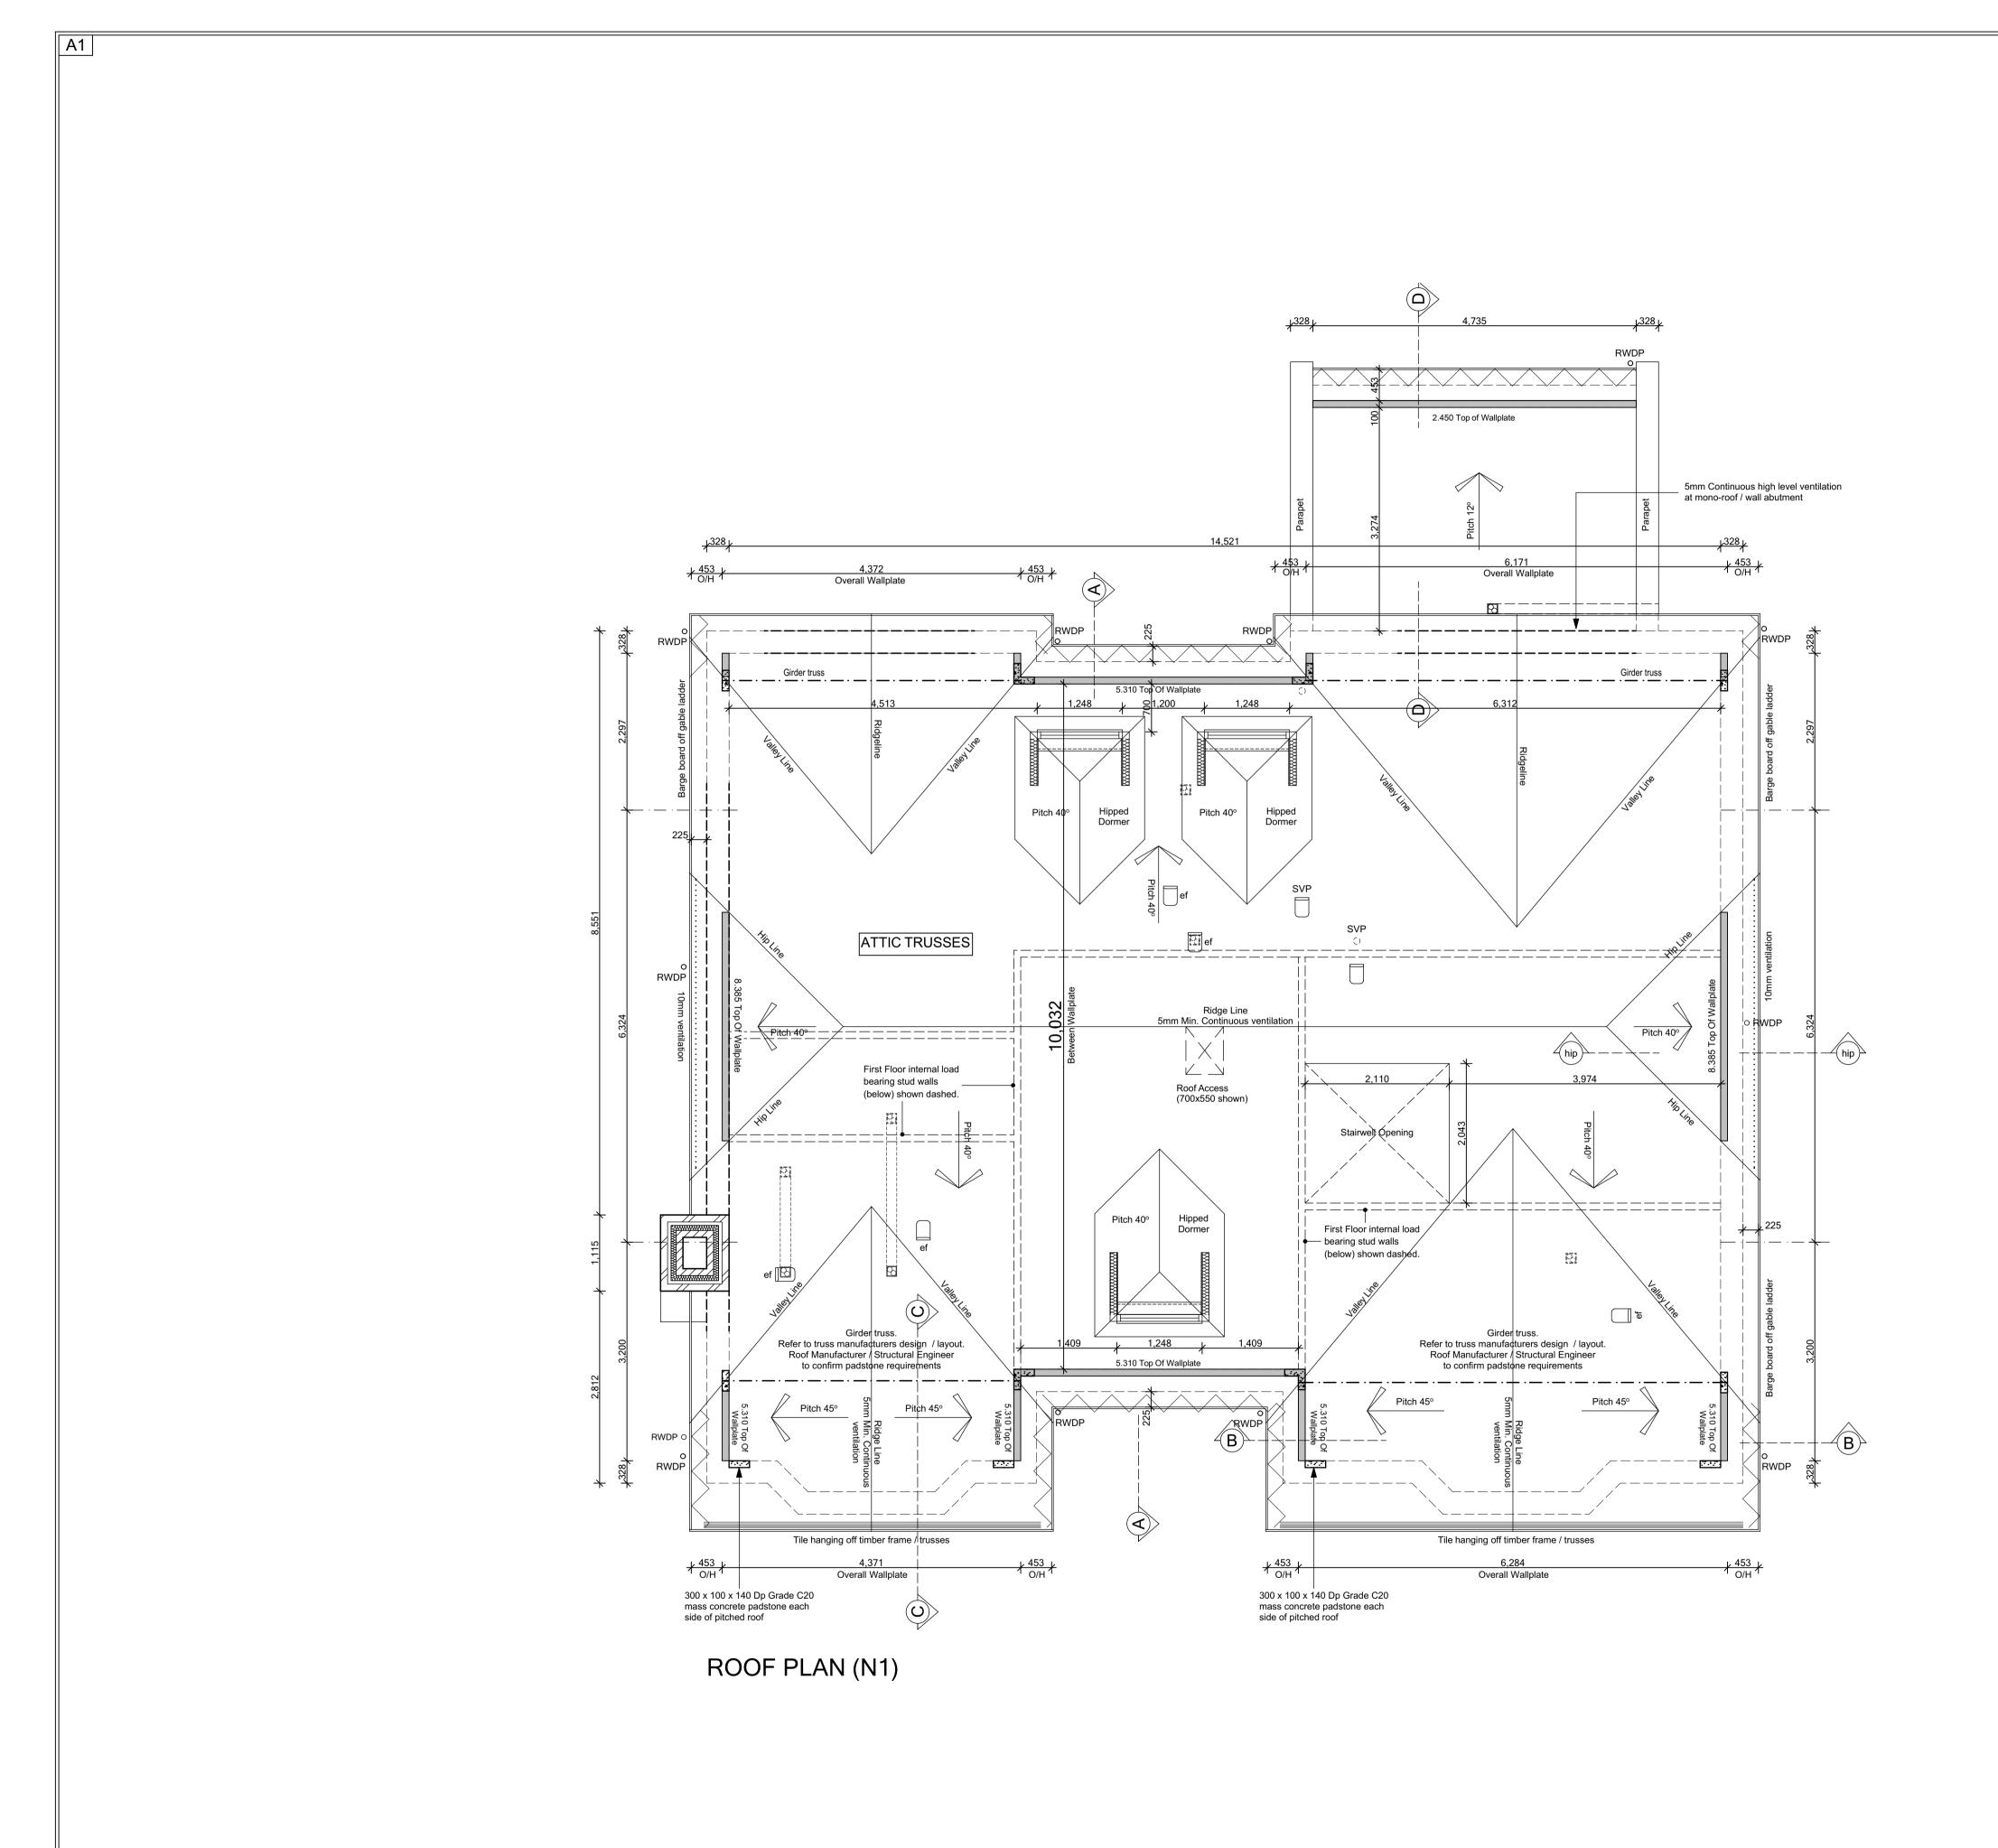
REVISION:

C1

CONSTRUCTION

Plot No. As - 3. Ha - .



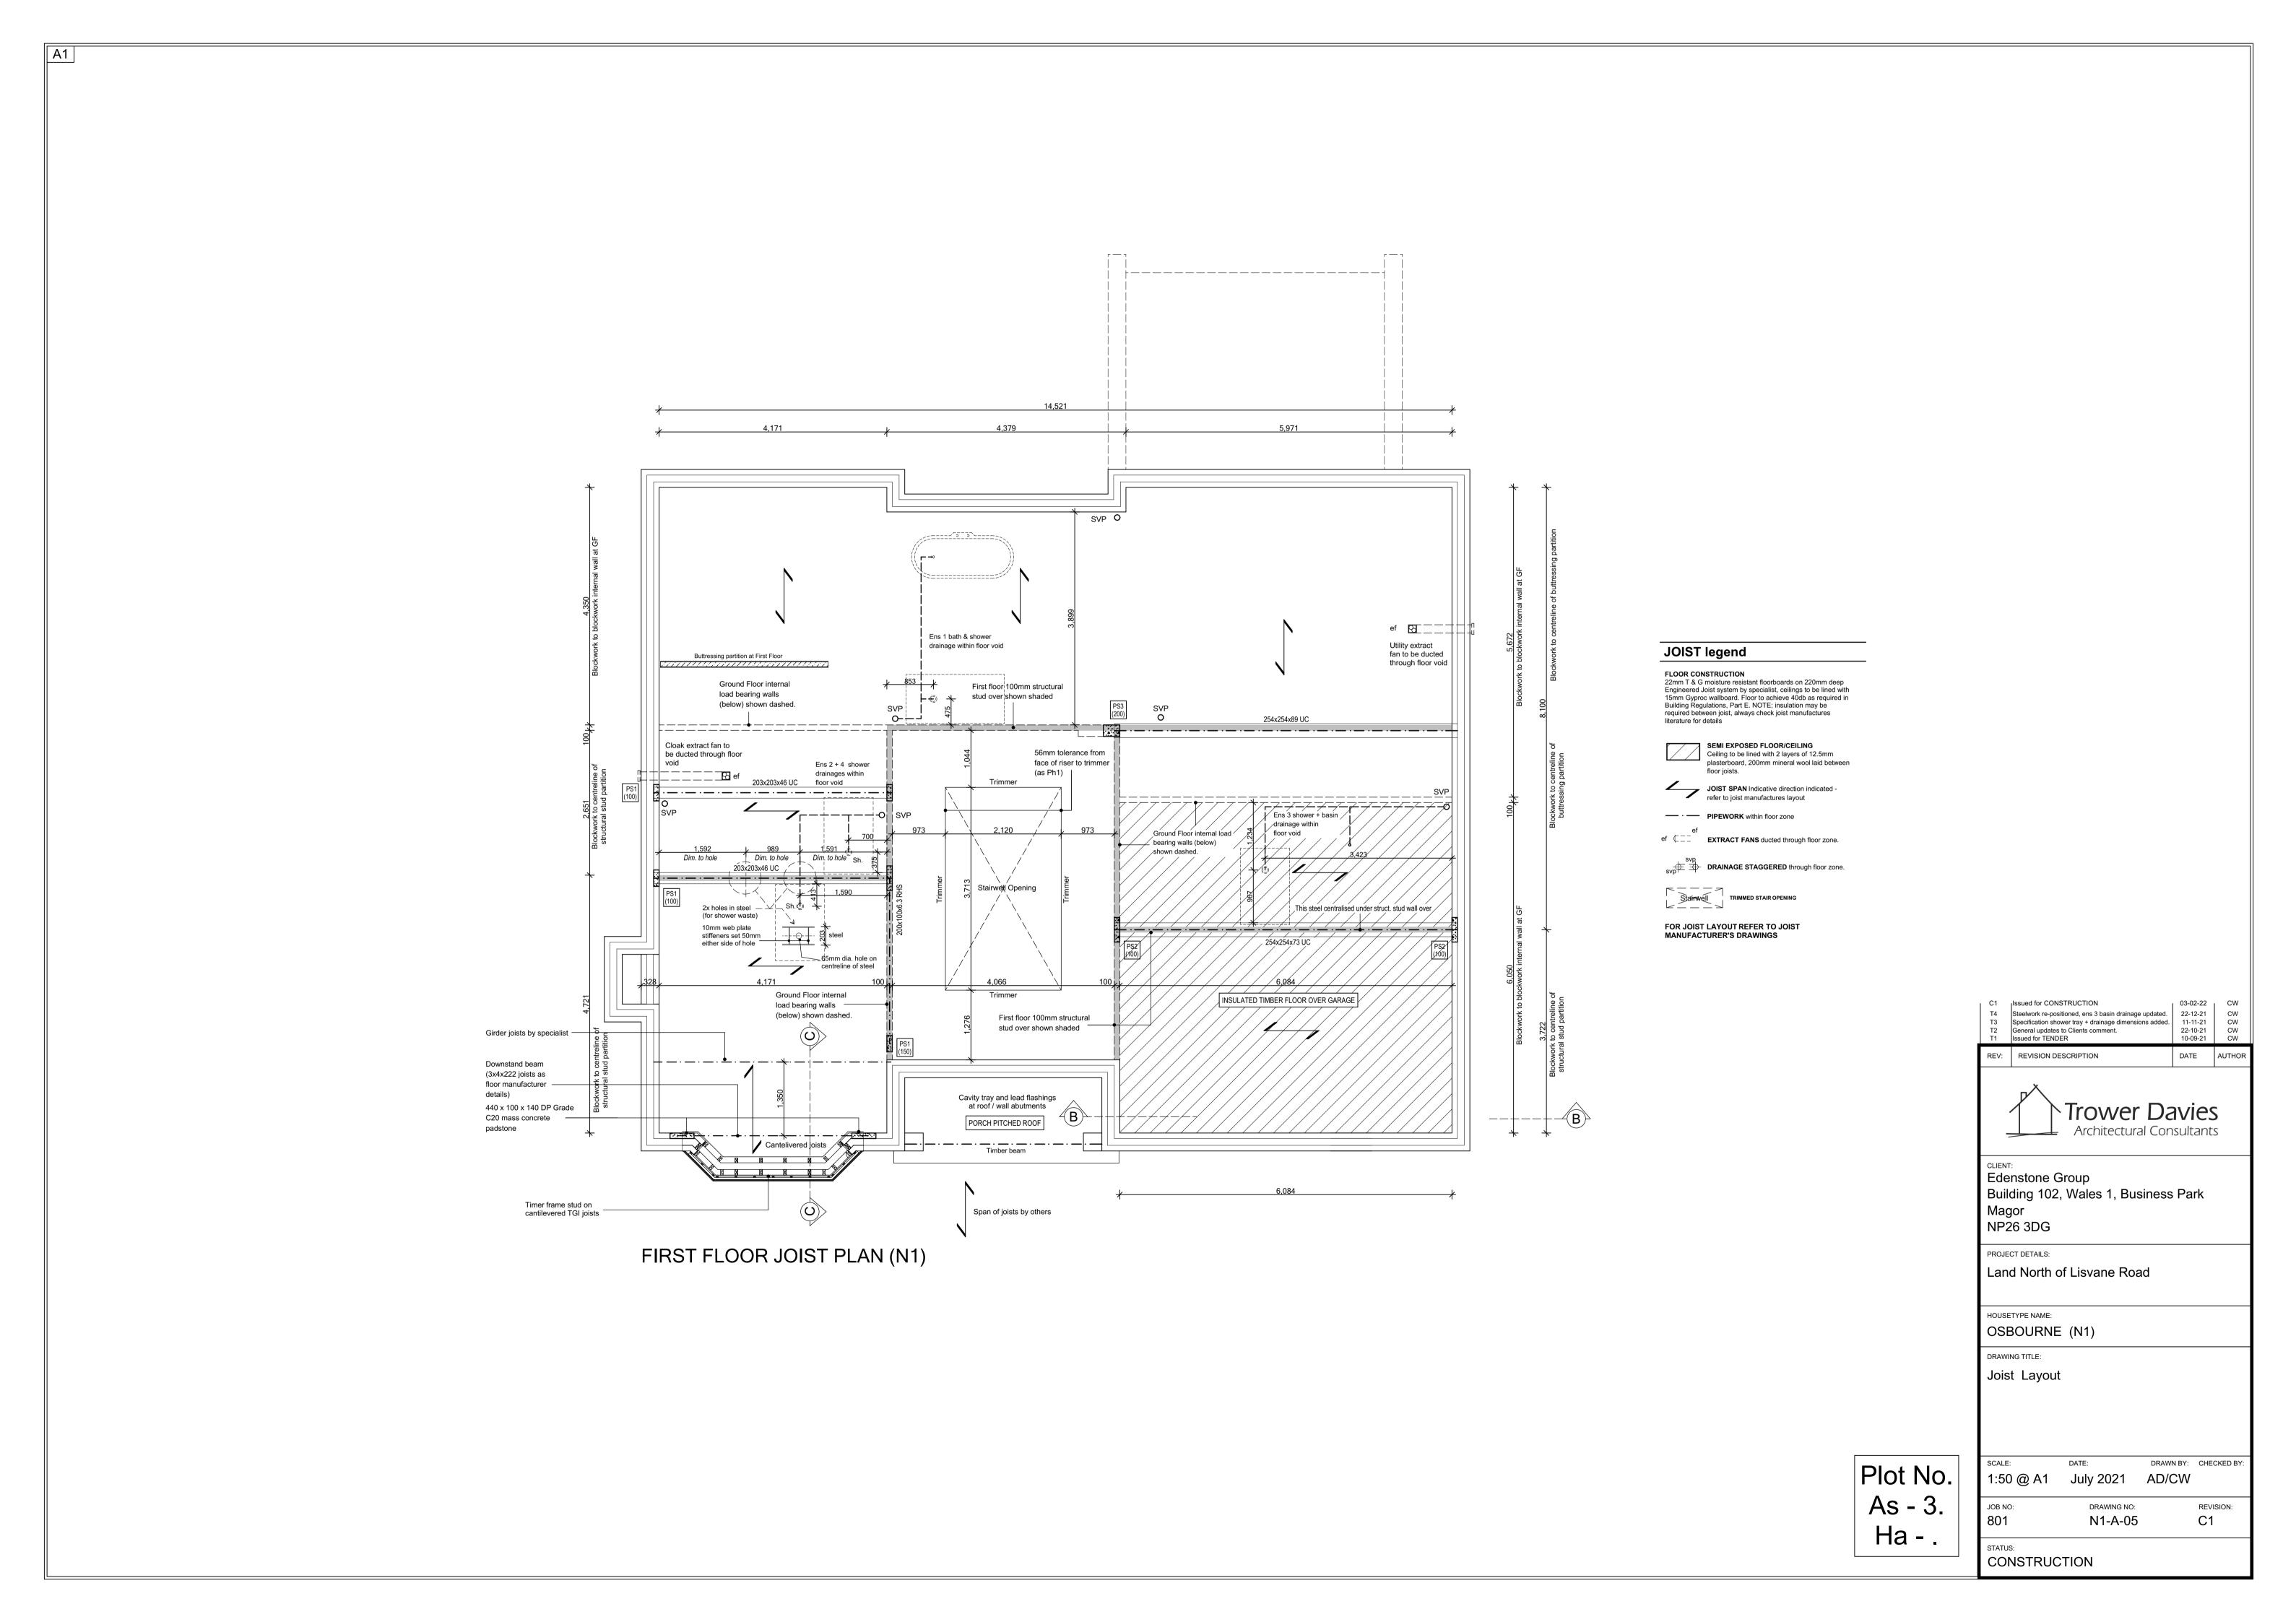

#### **ROOF legend**

Prefabricated trussed rafters (to BS 5268 Part 11 1985) to be designed by specialist supplier. Main roof finish secured in accordance with manufacturer's recommendation regarding pitch

#### Pitch ?° ROOF PIT

VENTILATION 5mm continuous
VENTILATION 10mm continuous
VENTILATION 25mm continuous

EXTRACTOR FAN ducted to tile vent

SVP terminating at approved tile vent

BOILER OUTLET terminating at roof


CODE 4 LEAD FLASHING
with proprietary cavity tray system

PARTY WALL

built up to u/s of roof covering and fire stopped

WALL PLATE 100x50mm to be bedded on mortar and strapped to masonry. Whenever practicable wall plates to be in lengths not less than 3m and jointed with half-lapped joints

THIS SPECIFICATION IS A CONDENSED VERSION AND SHOULD BE READ IN CONJUNCTION WITH THE FULLSPECIFICATION INCLUDED IN THE HOUSE TYPE PACK

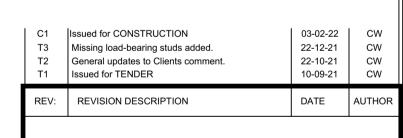

Architectural Consultants

Edenstone Group
Building 102, Wales 1, Business Park
Magor

NP26 3DG

PROJECT DETAILS:

Land North of Lisvane Road

HOUSETYPE NAME:
OSBOURNE (N1)


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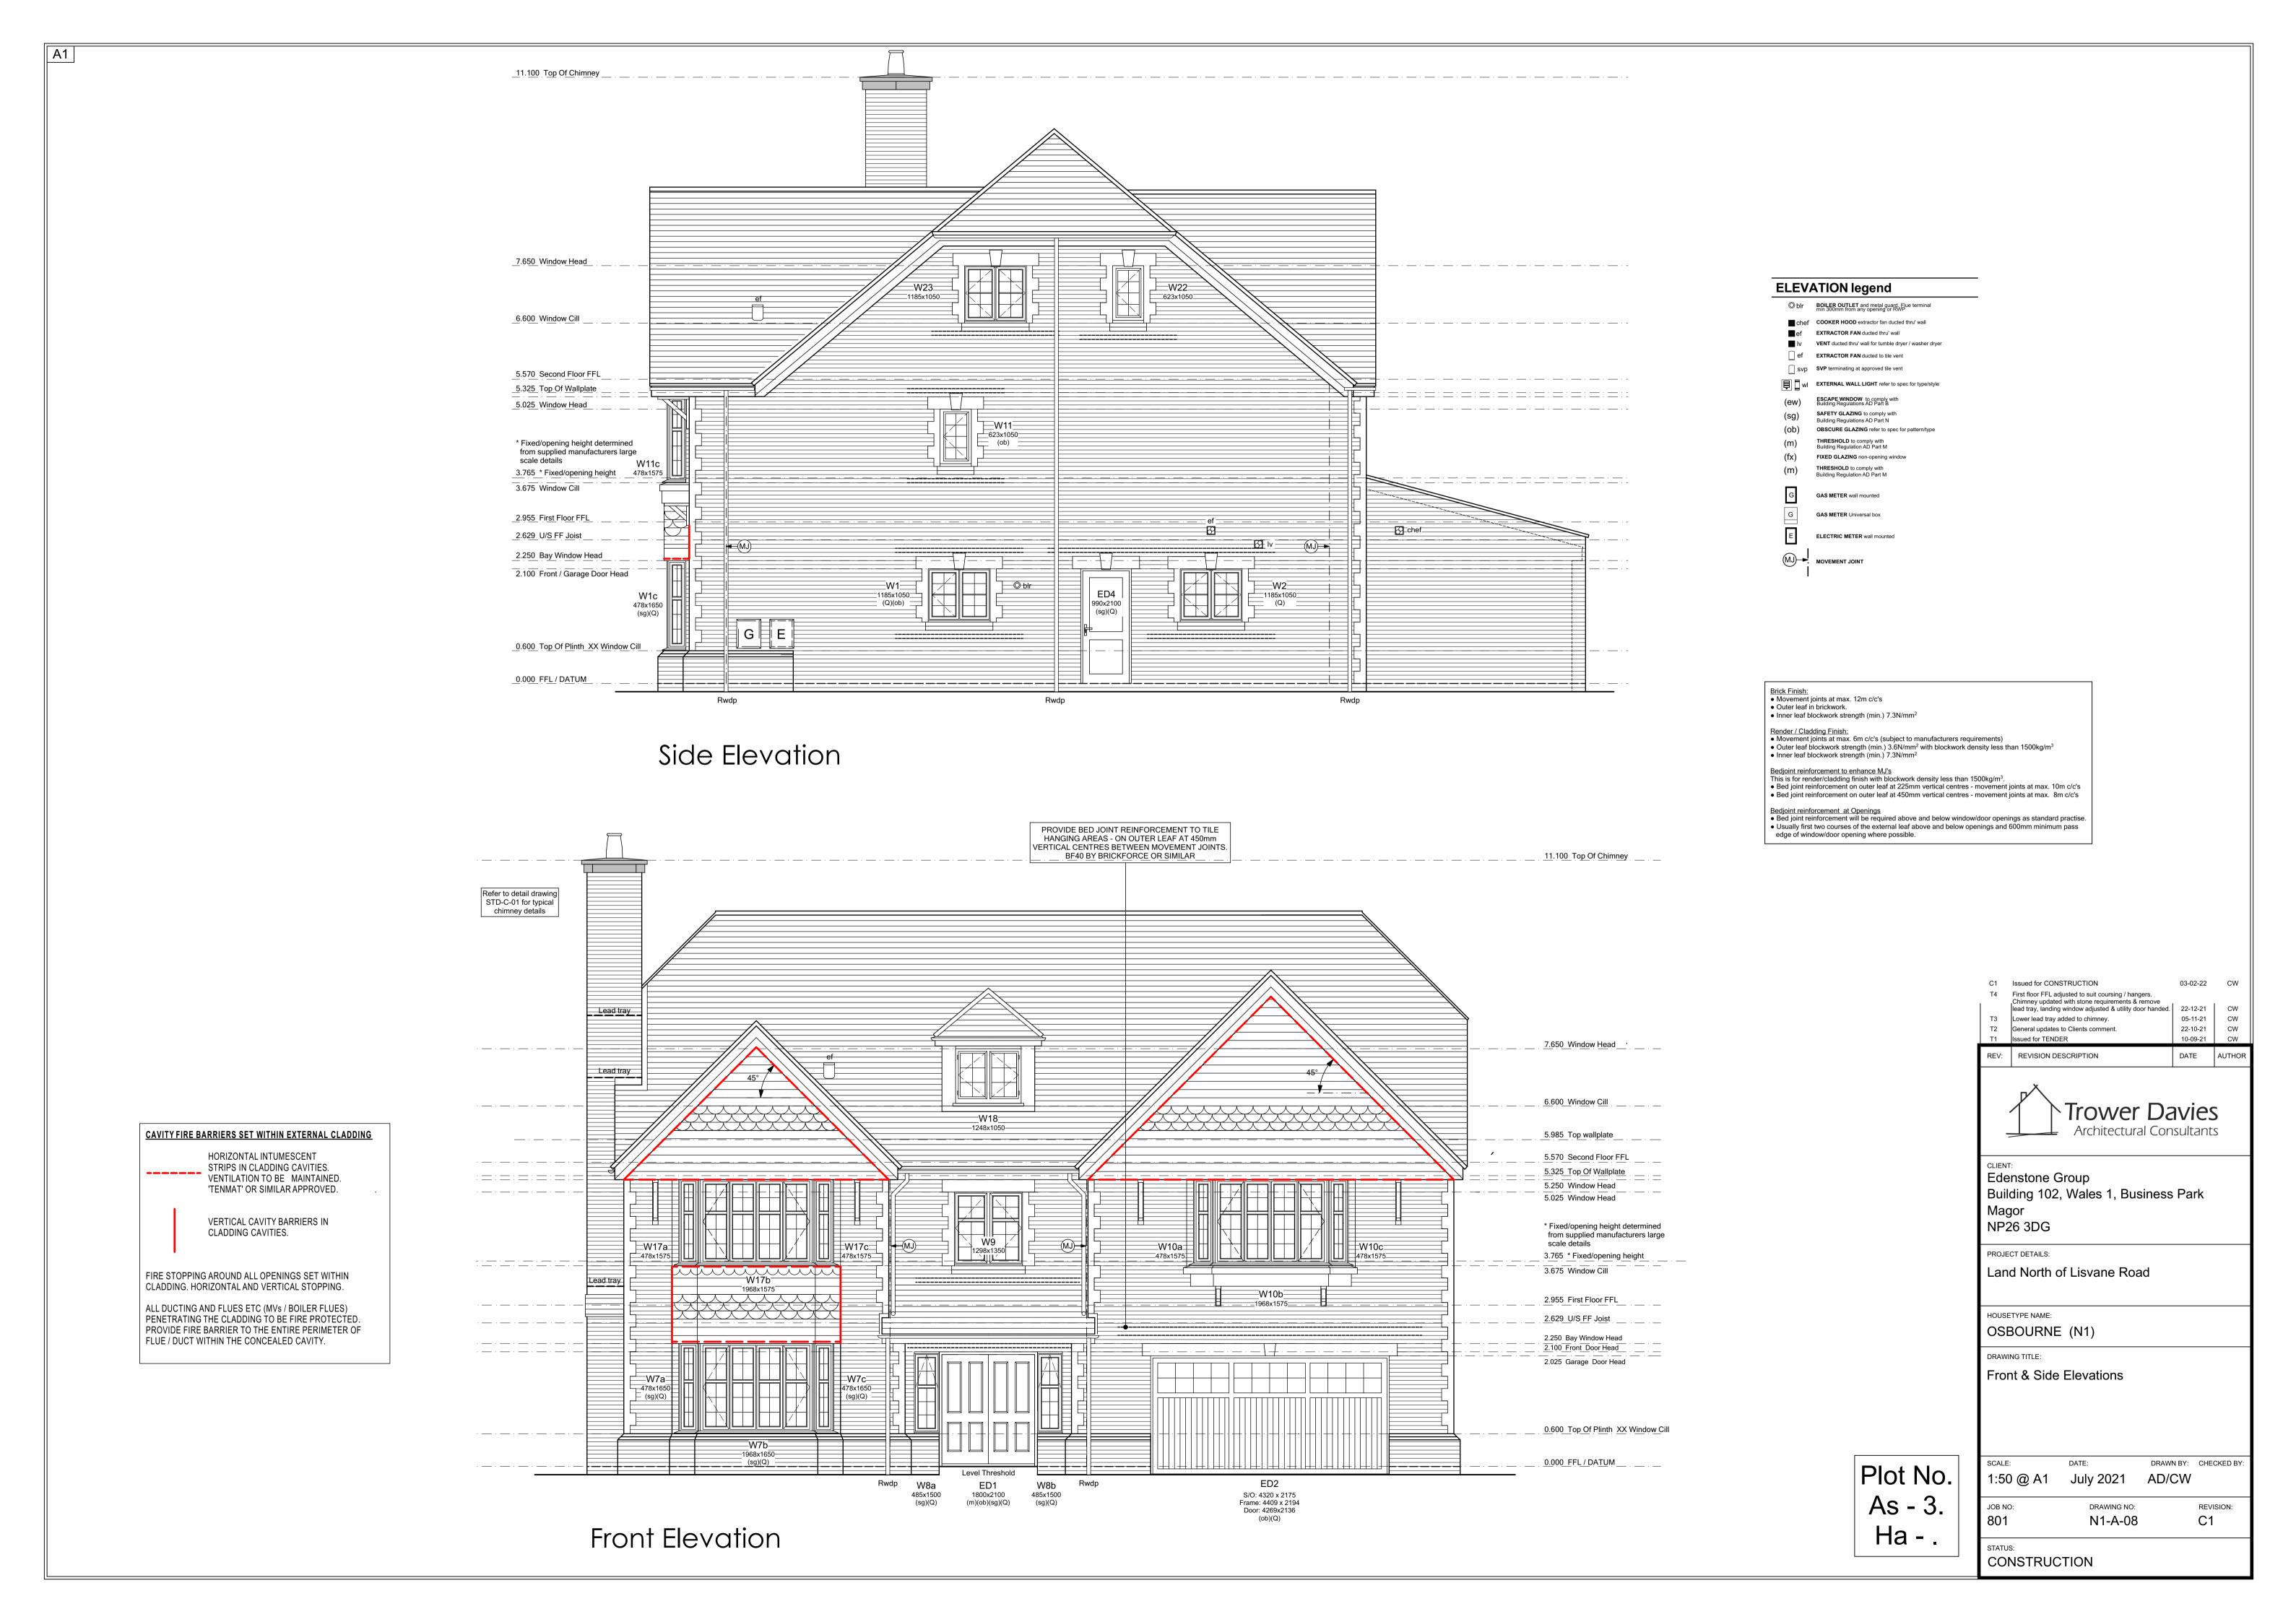
Roof Layout

Plot No. As - 3.


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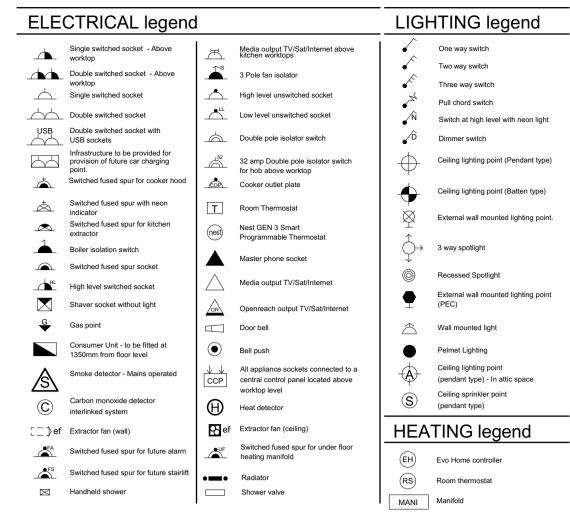
> STATUS: CONSTRUCTION






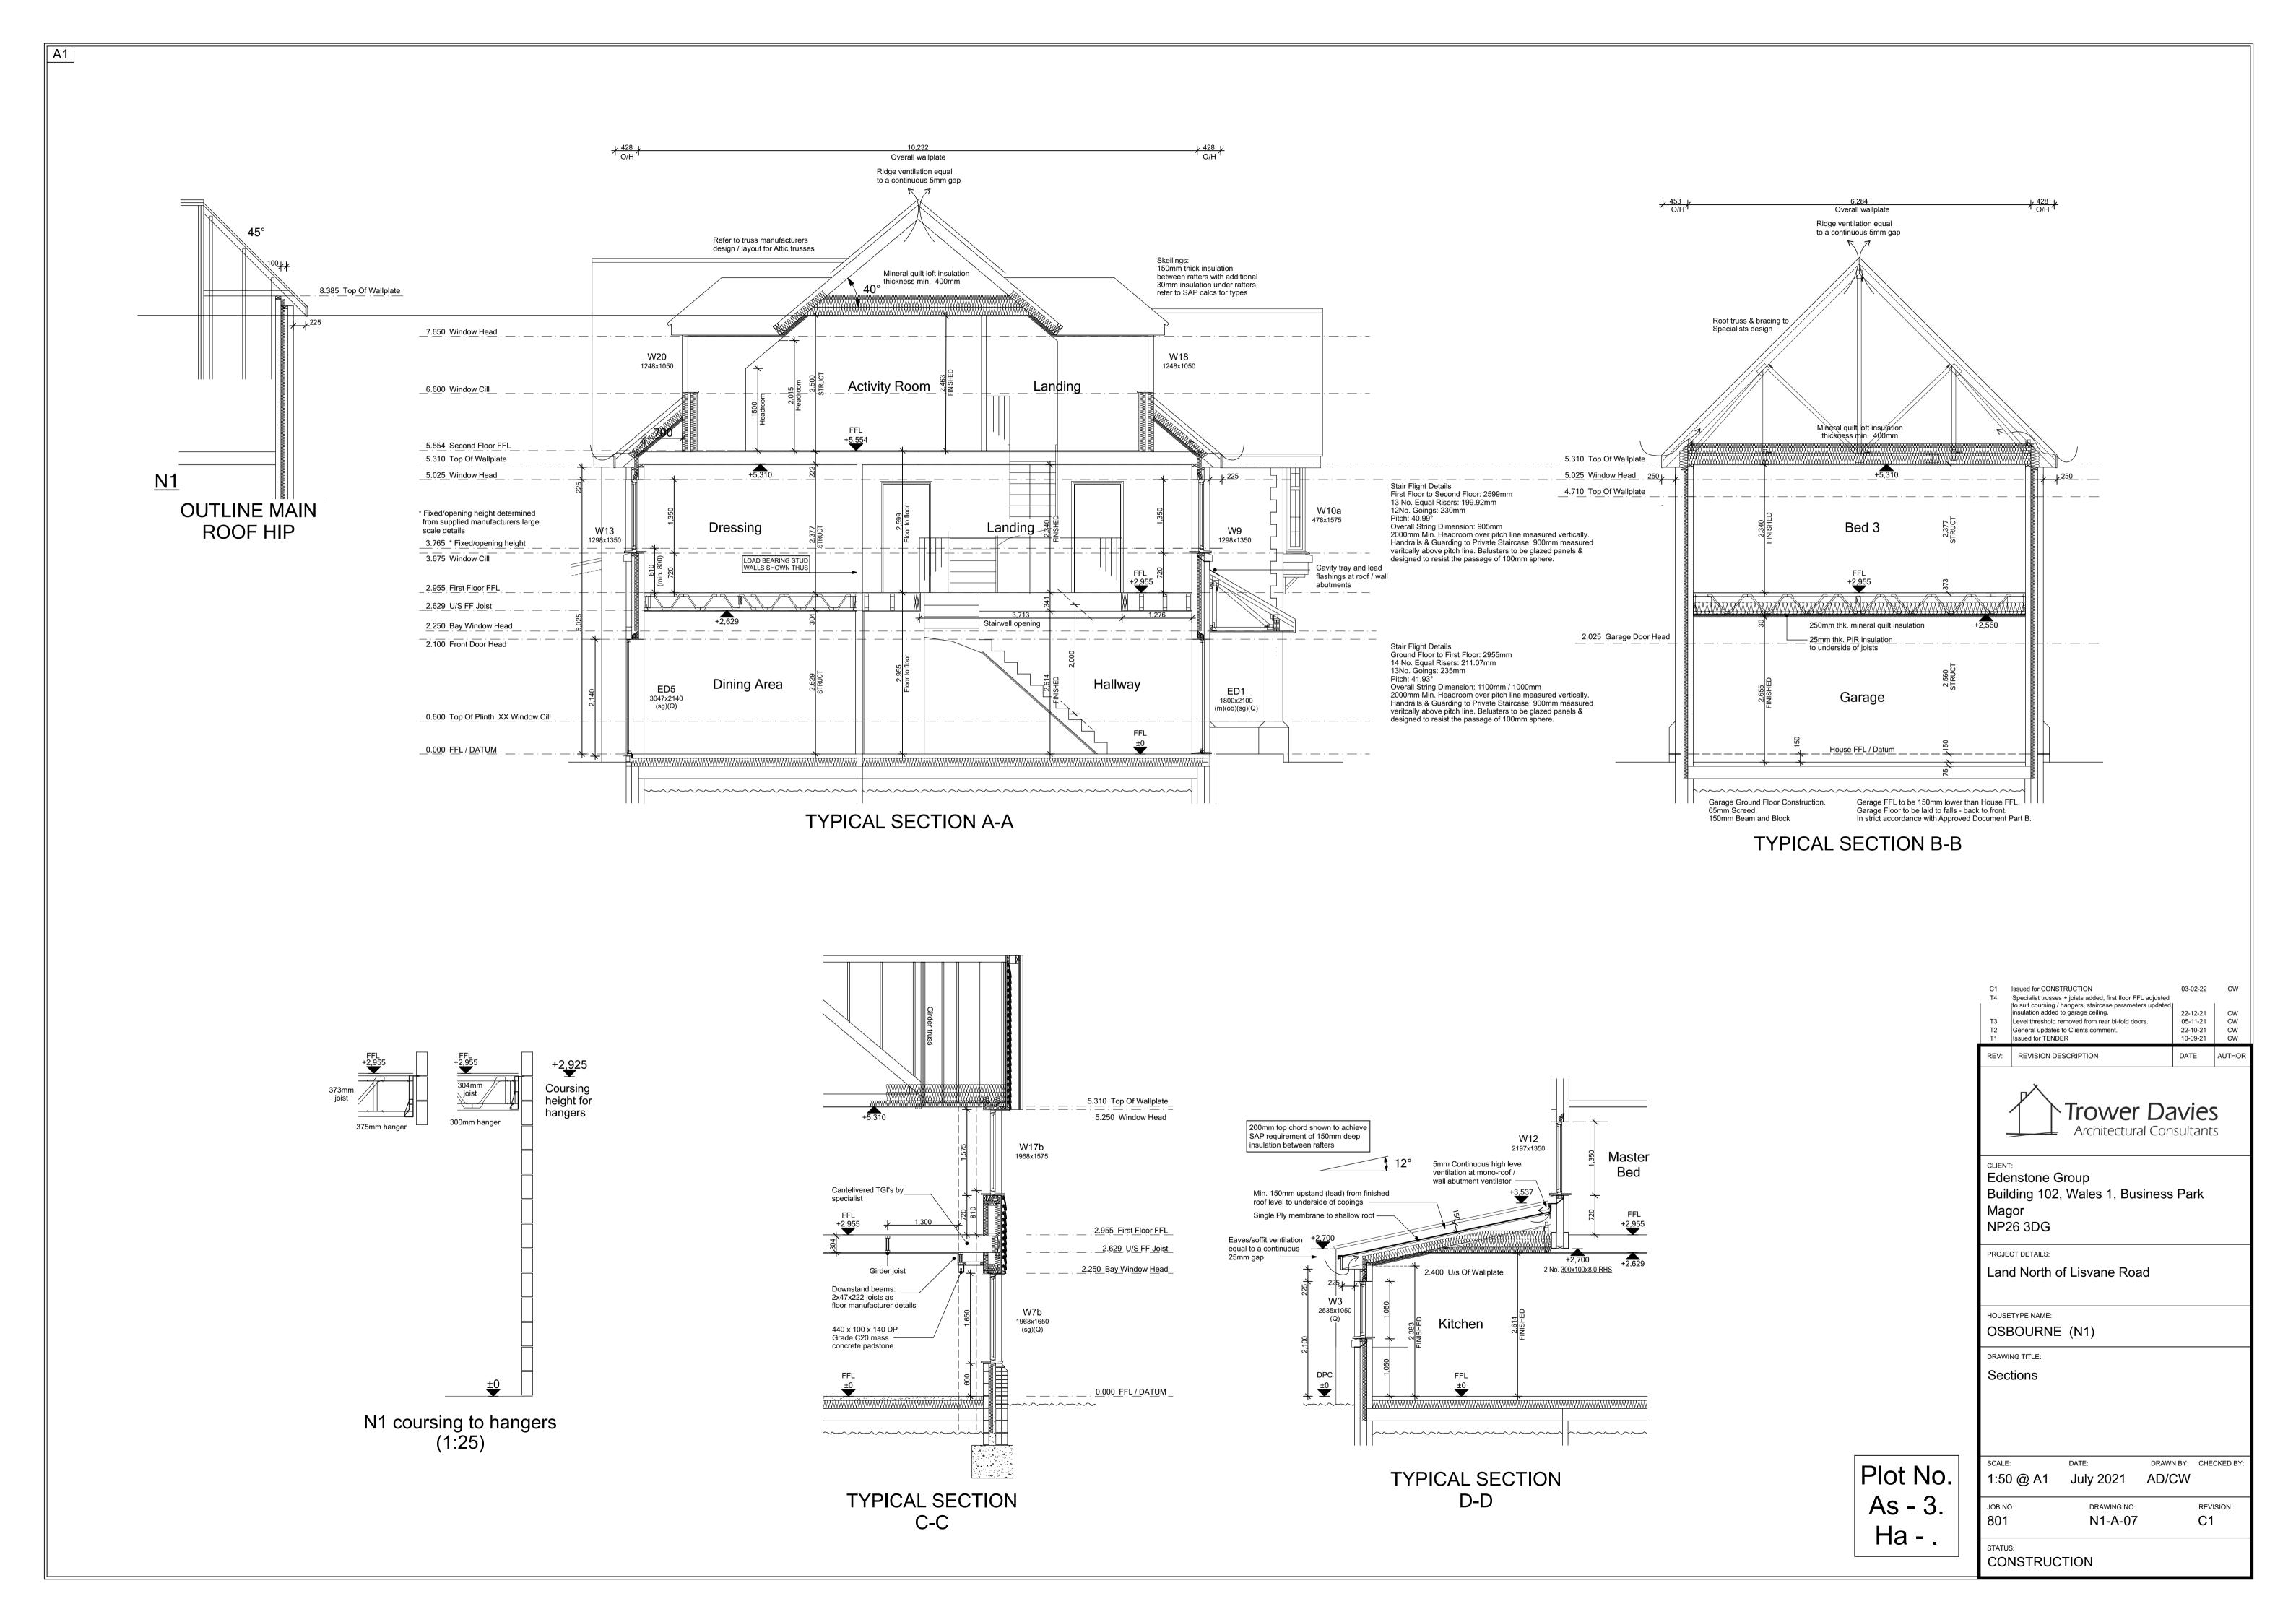




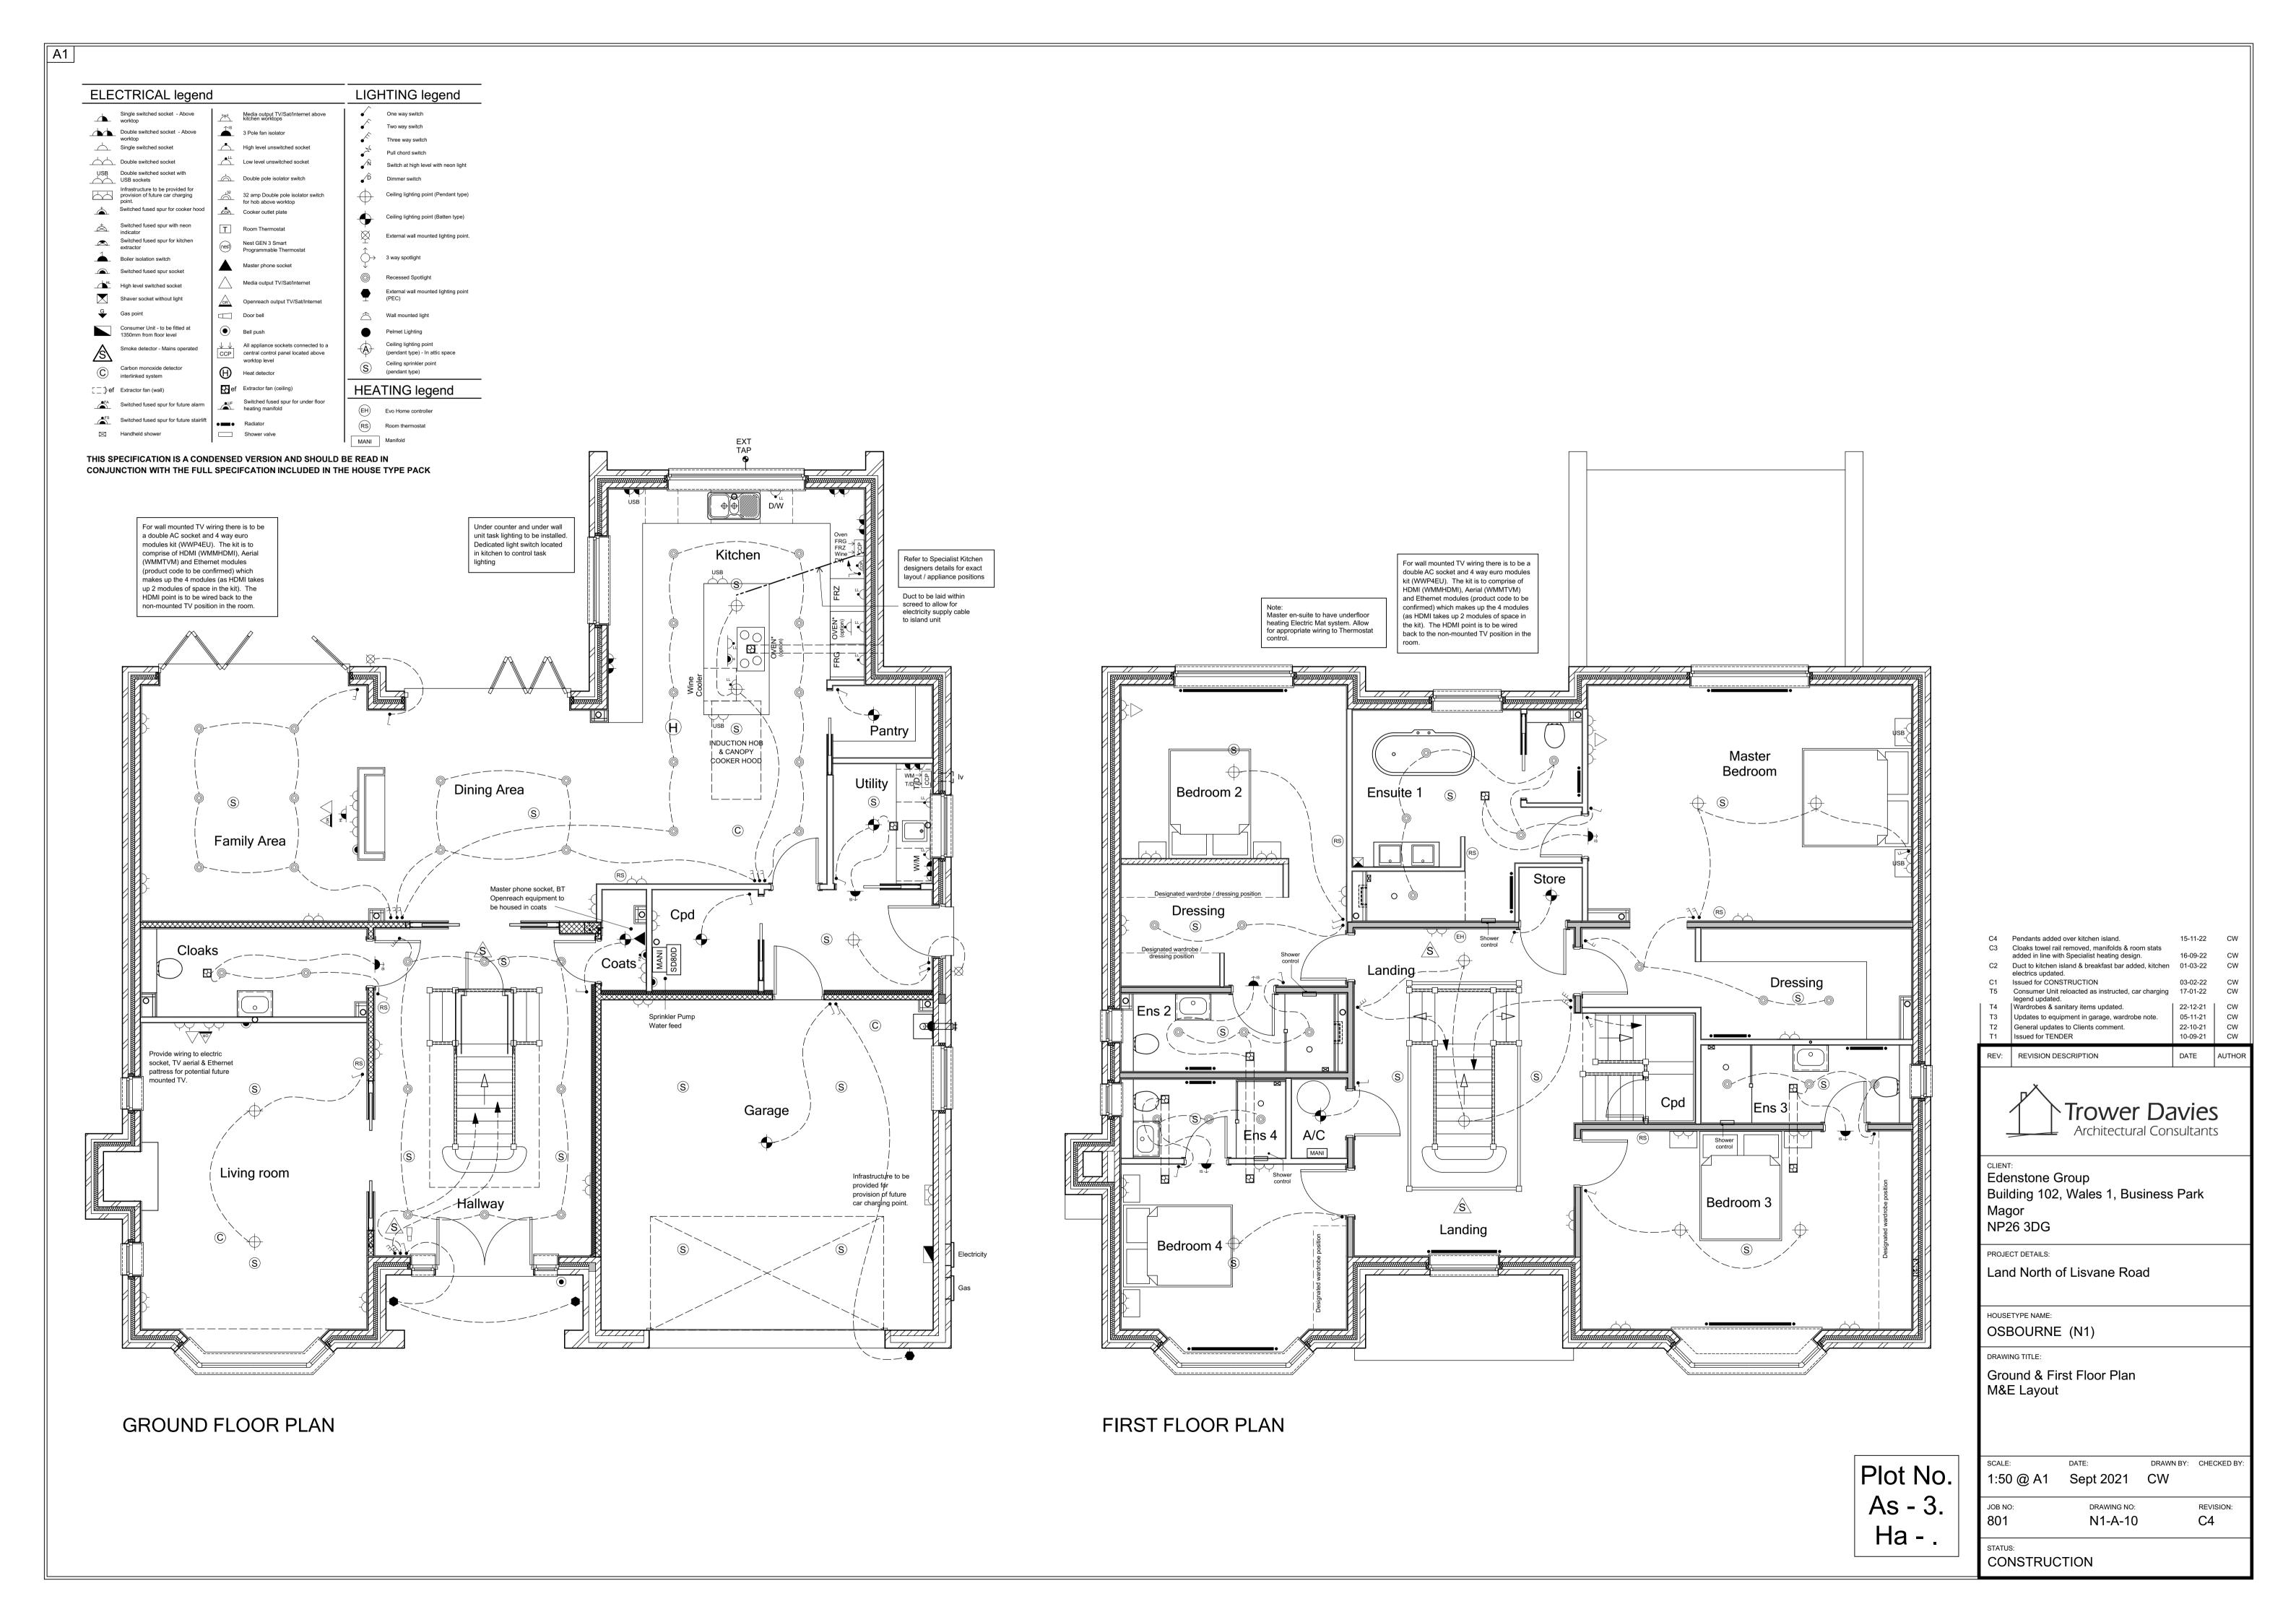


THIS SPECIFICATION IS A CONDENSED VERSION AND SHOULD BE READ IN CONJUNCTION WITH THE FULL SPECIFCATION INCLUDED IN THE HOUSE TYPE PACK

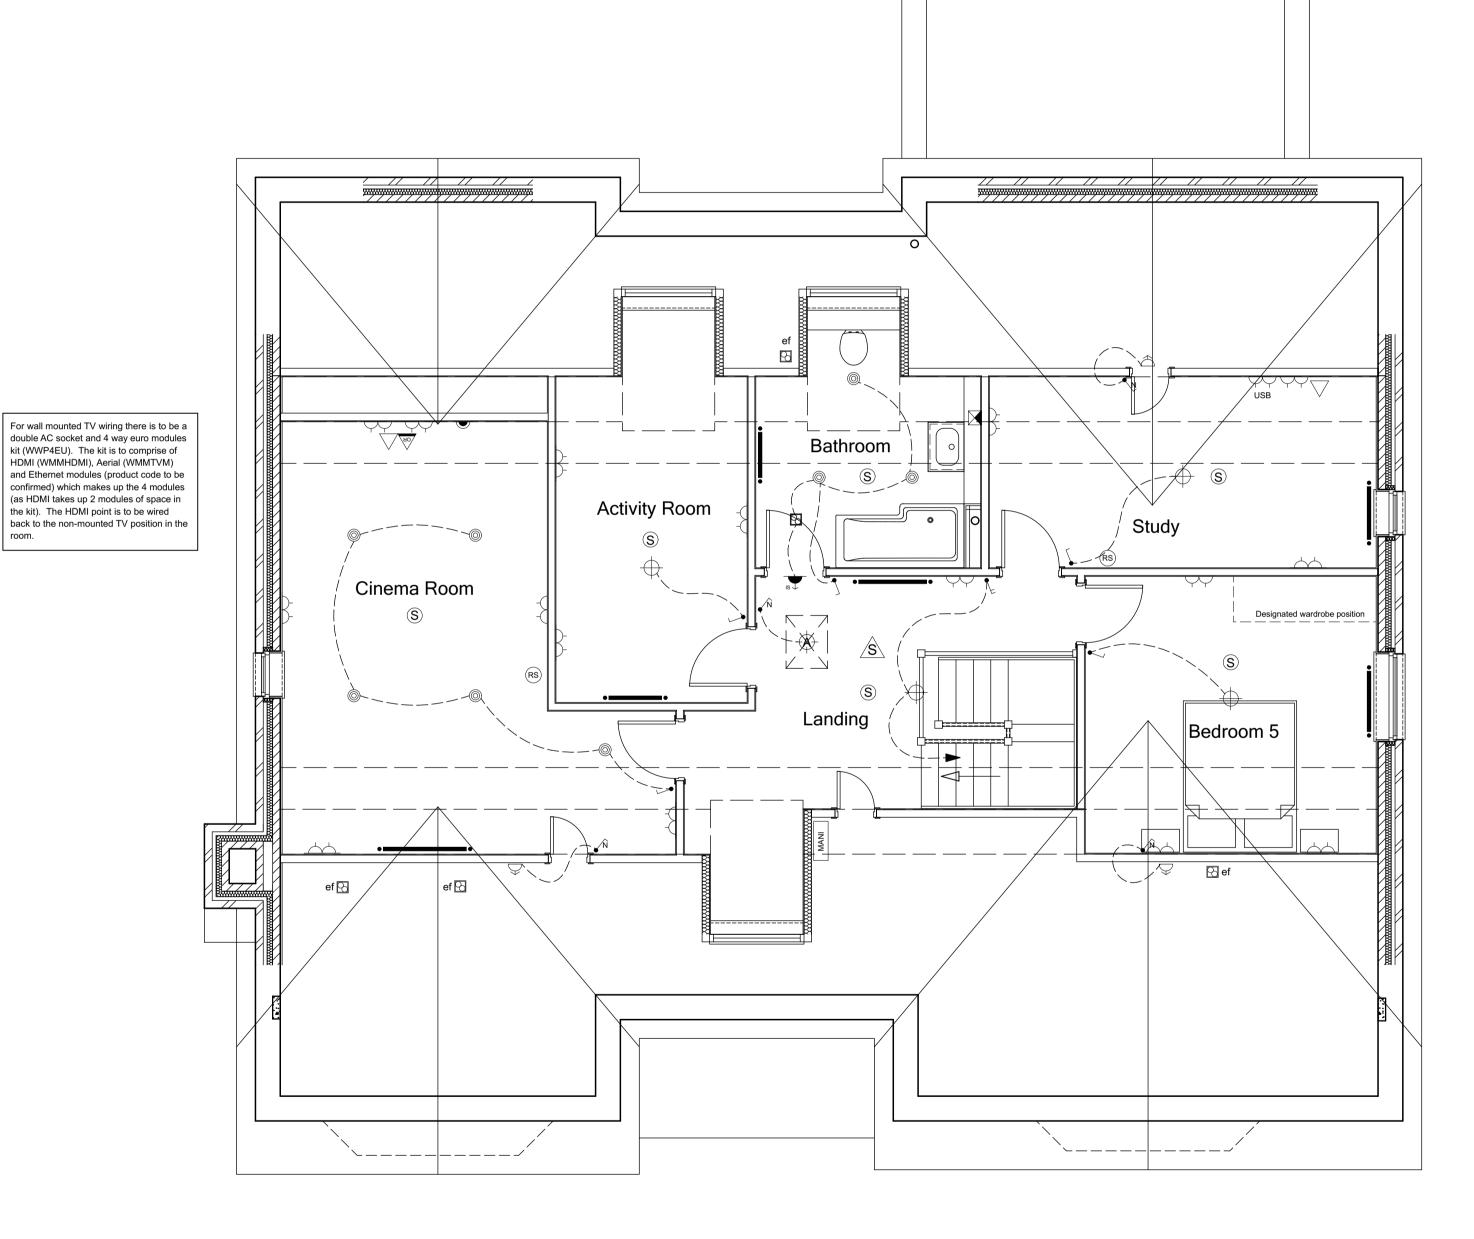



SECOND FLOOR PLAN

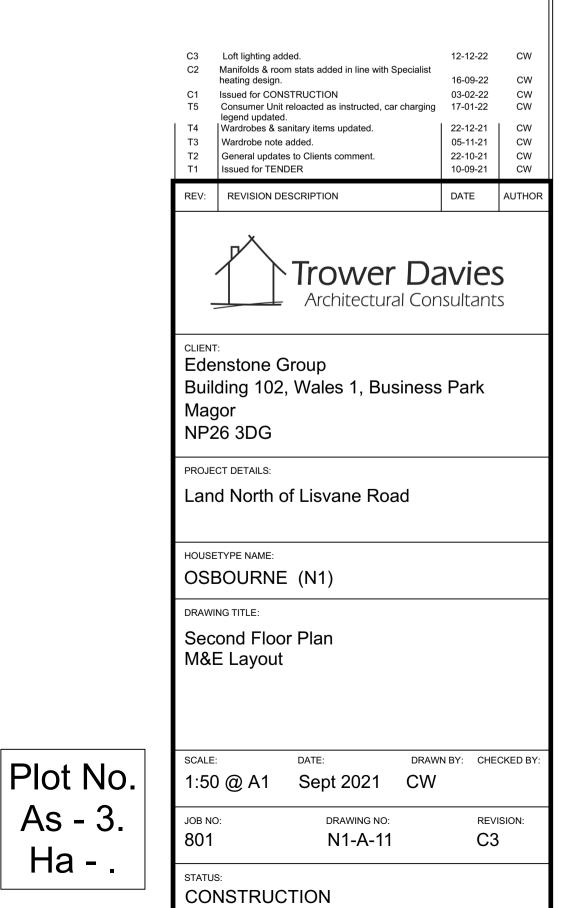




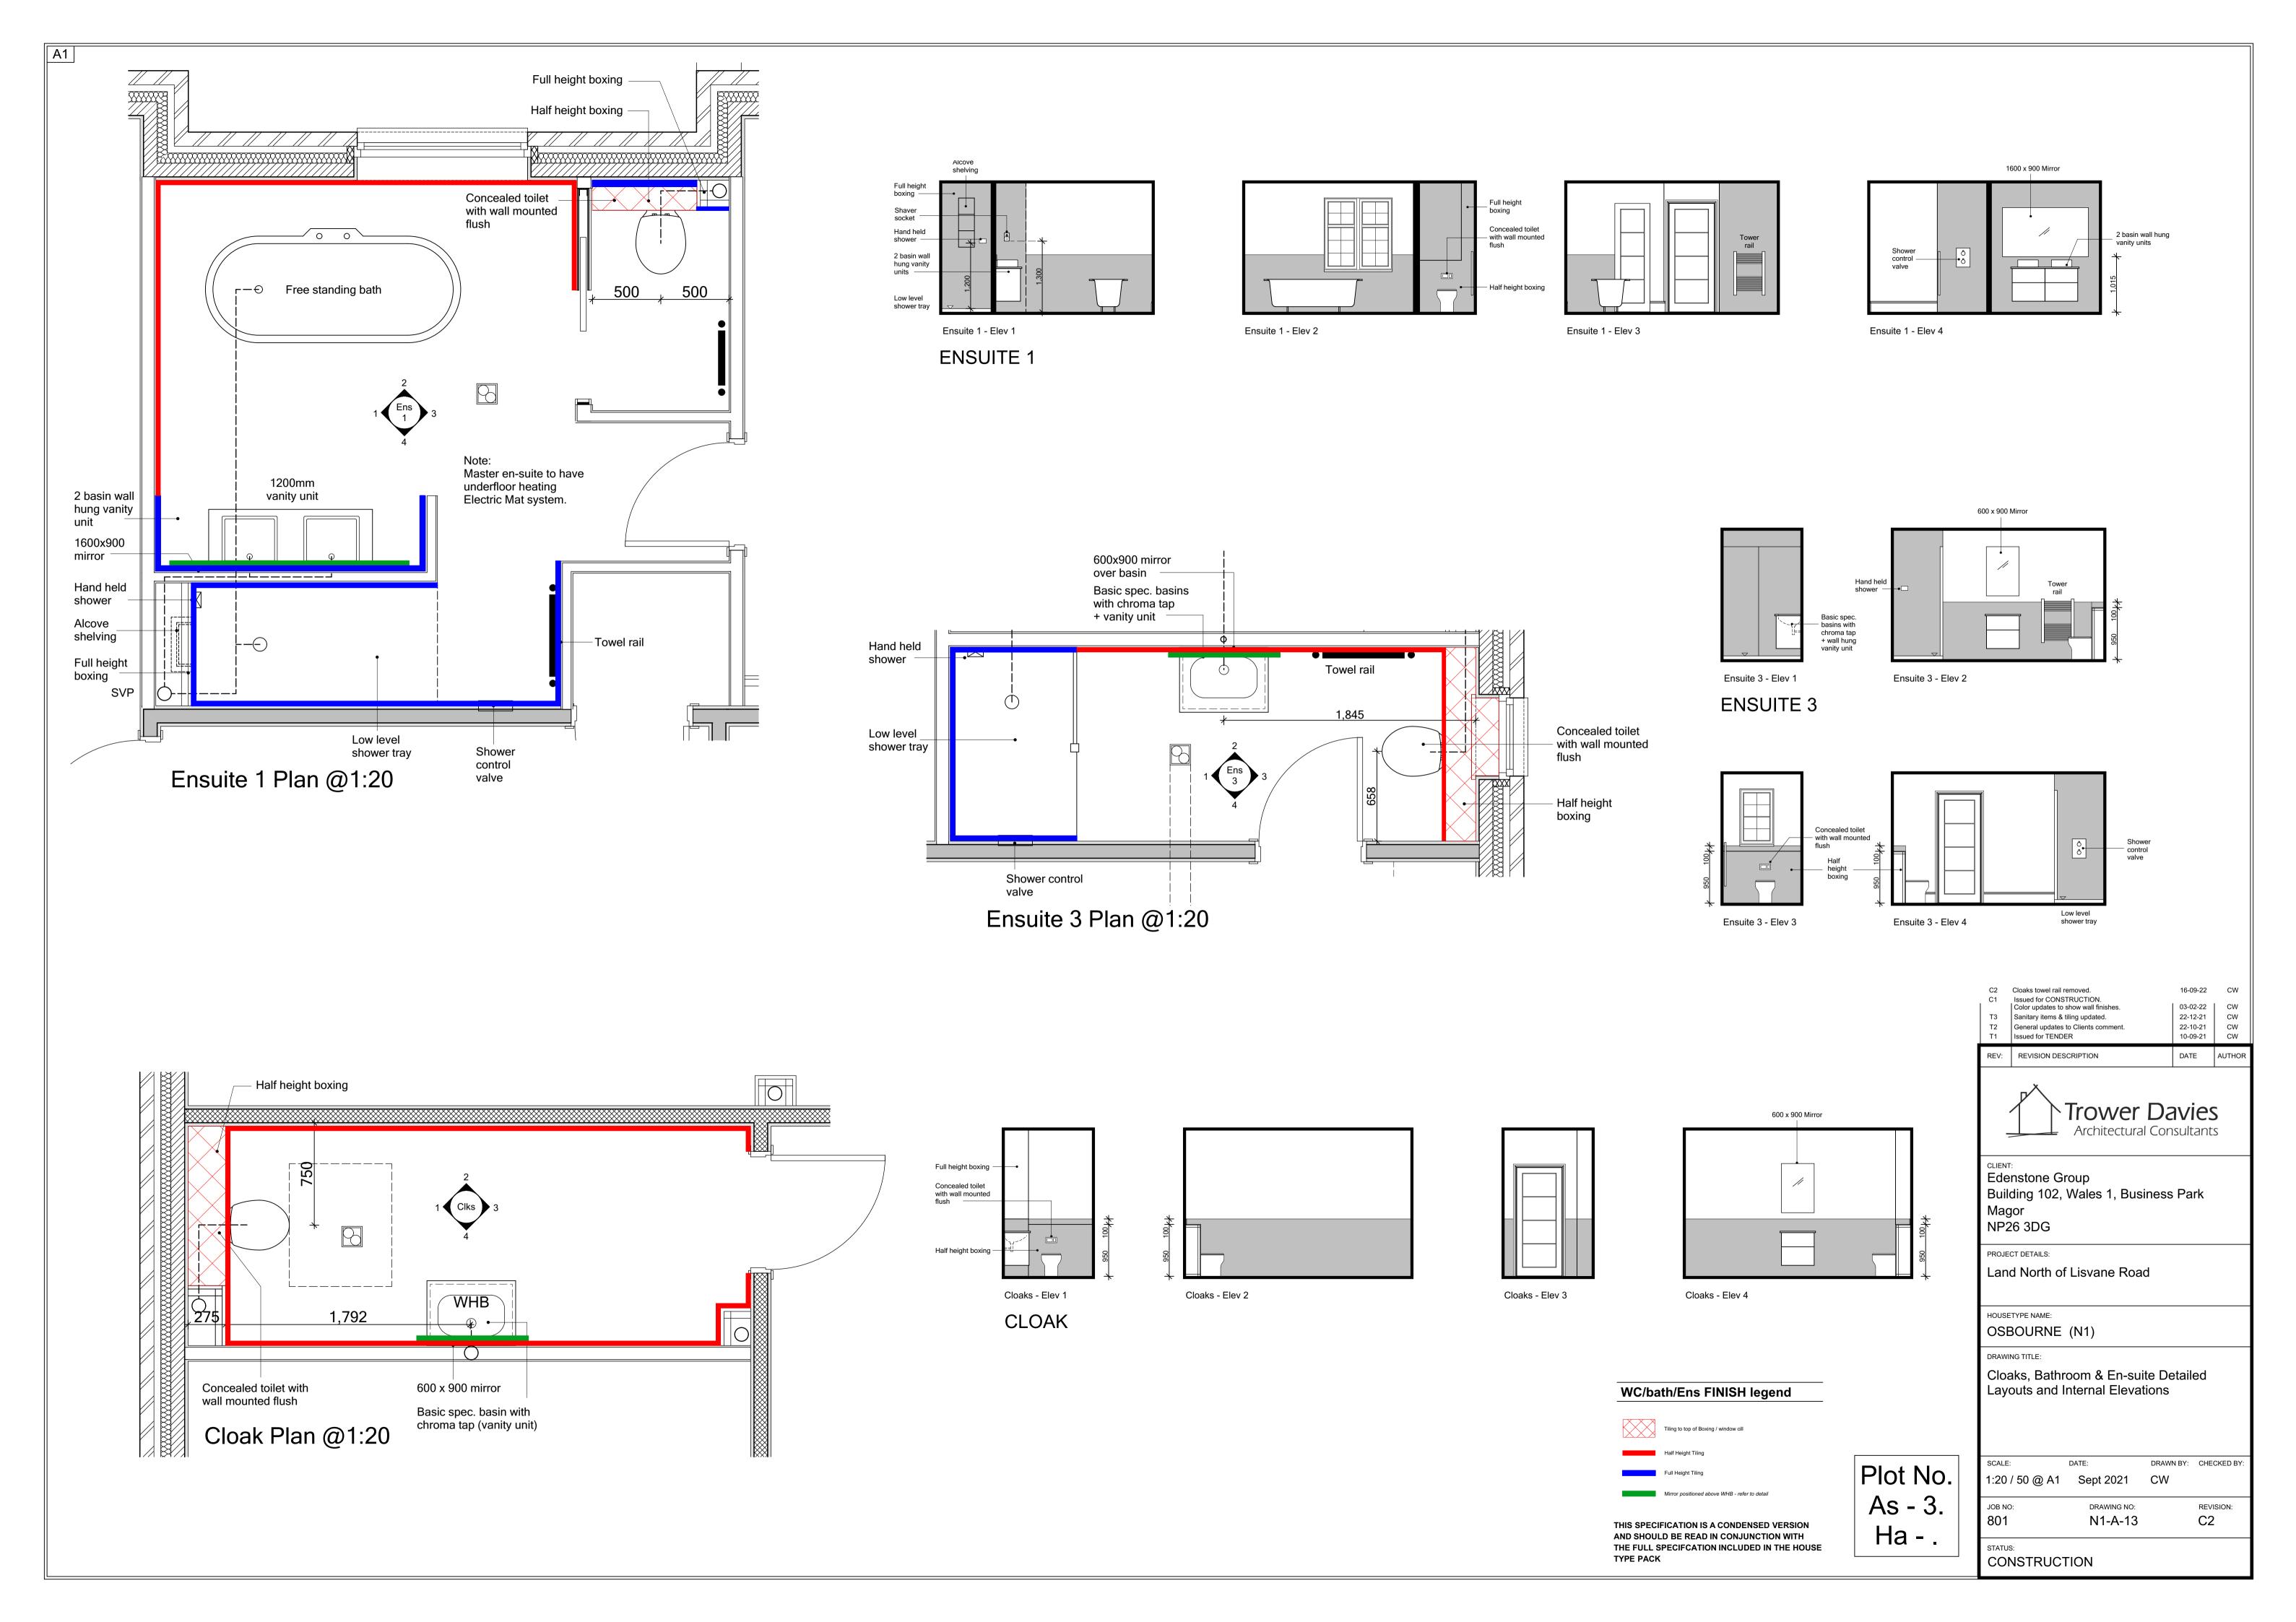

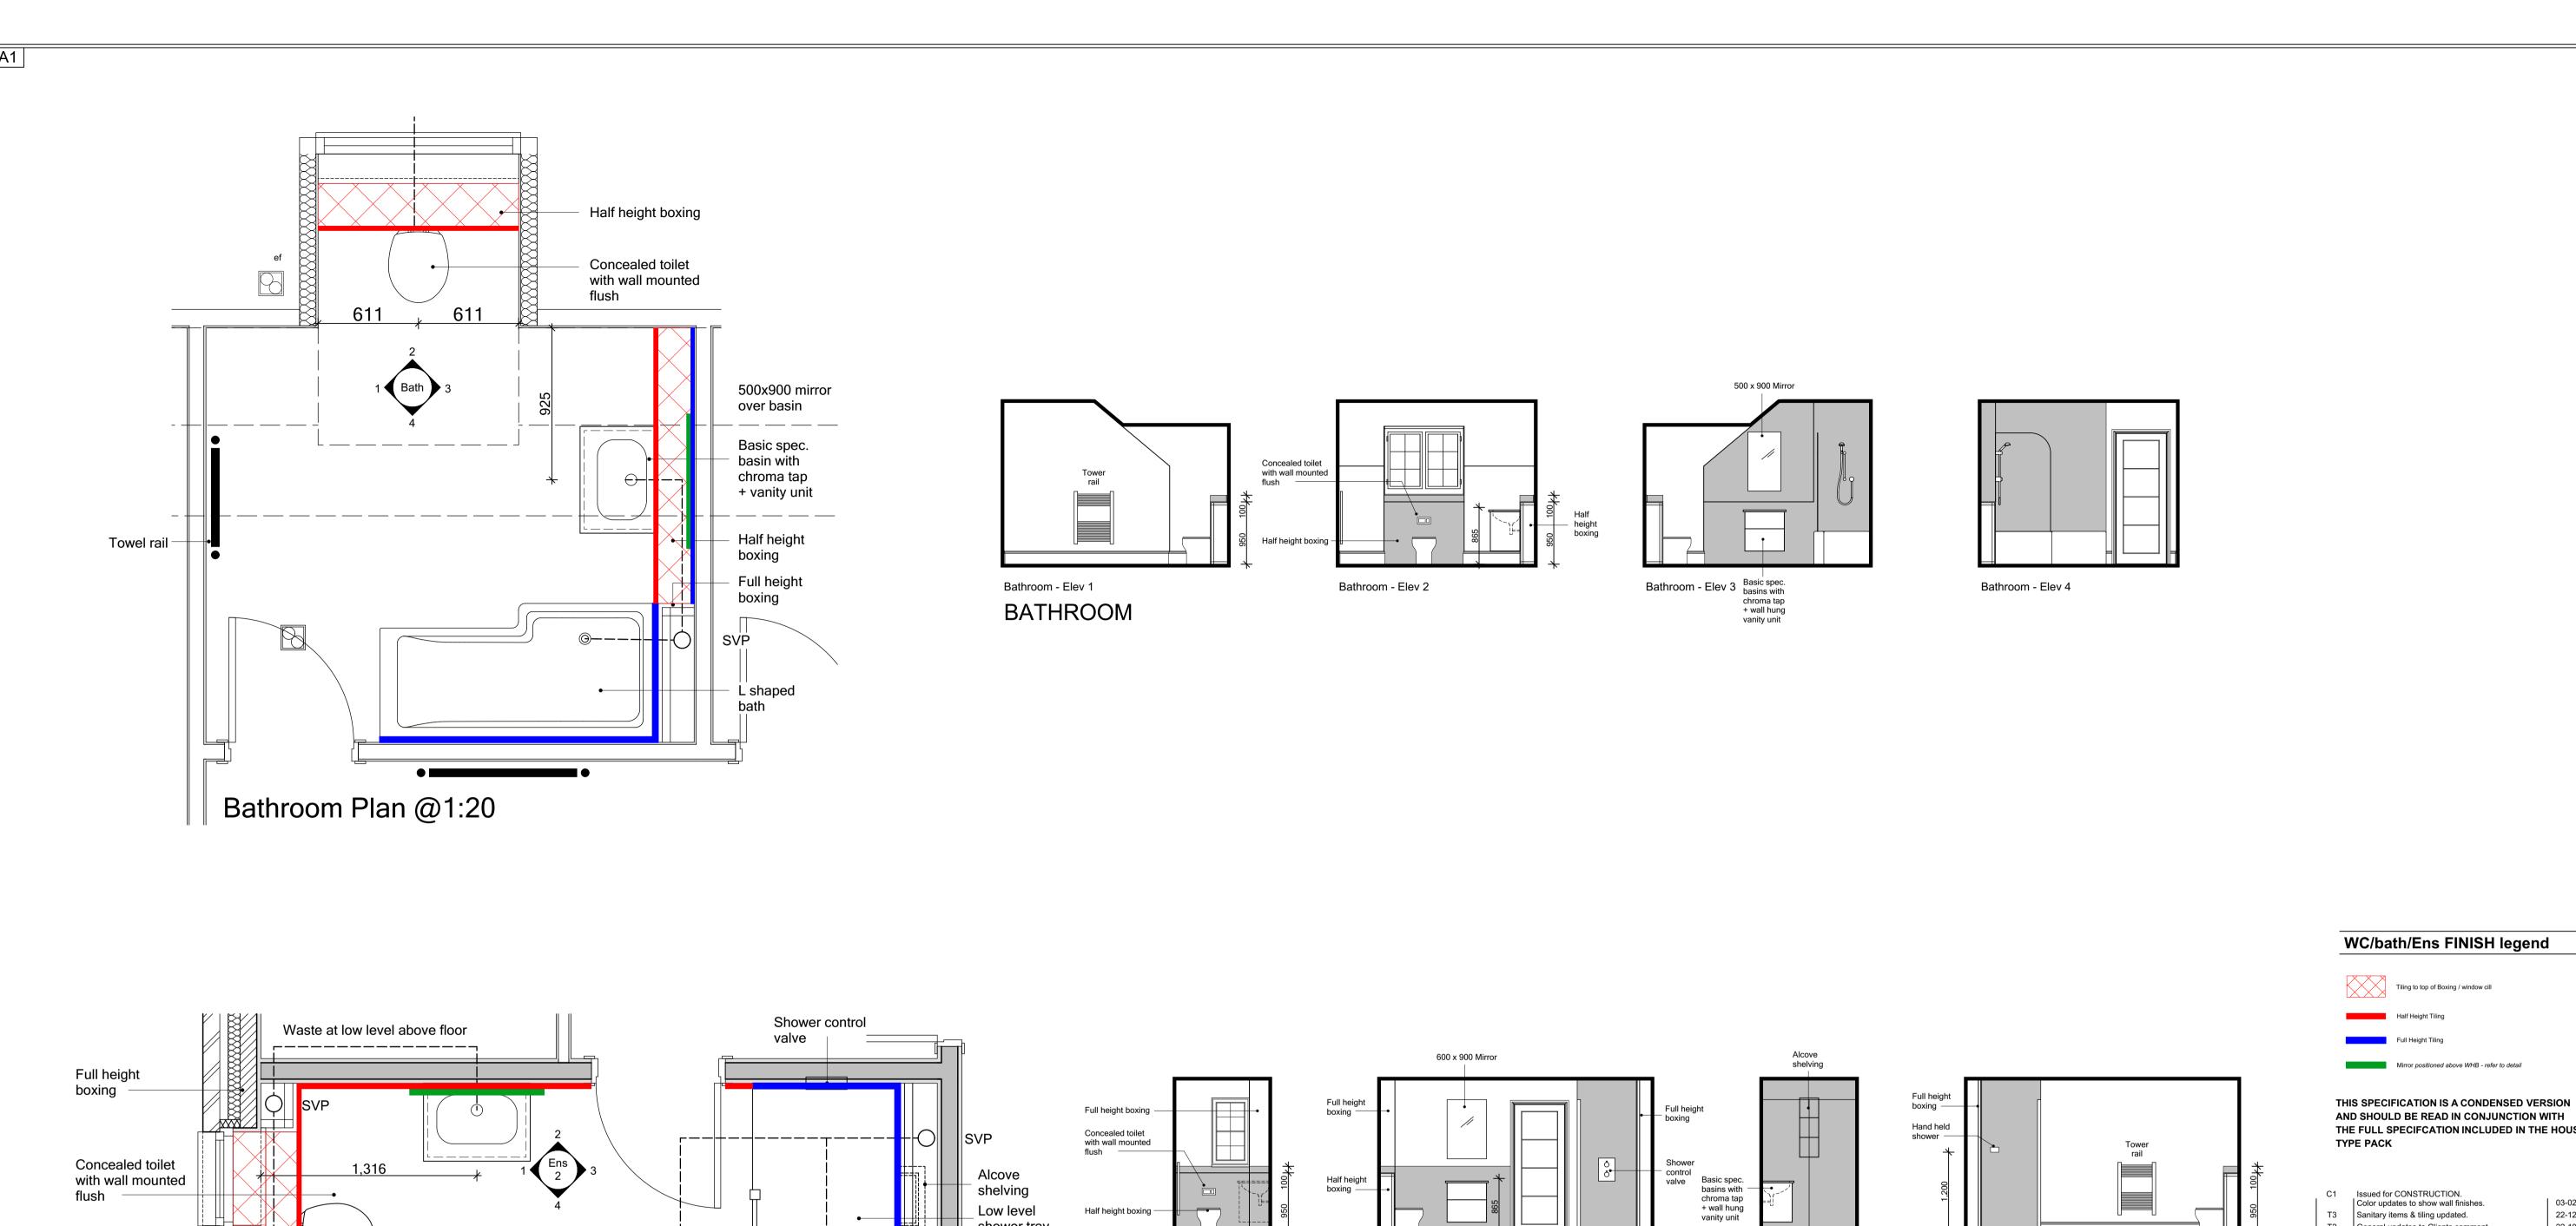


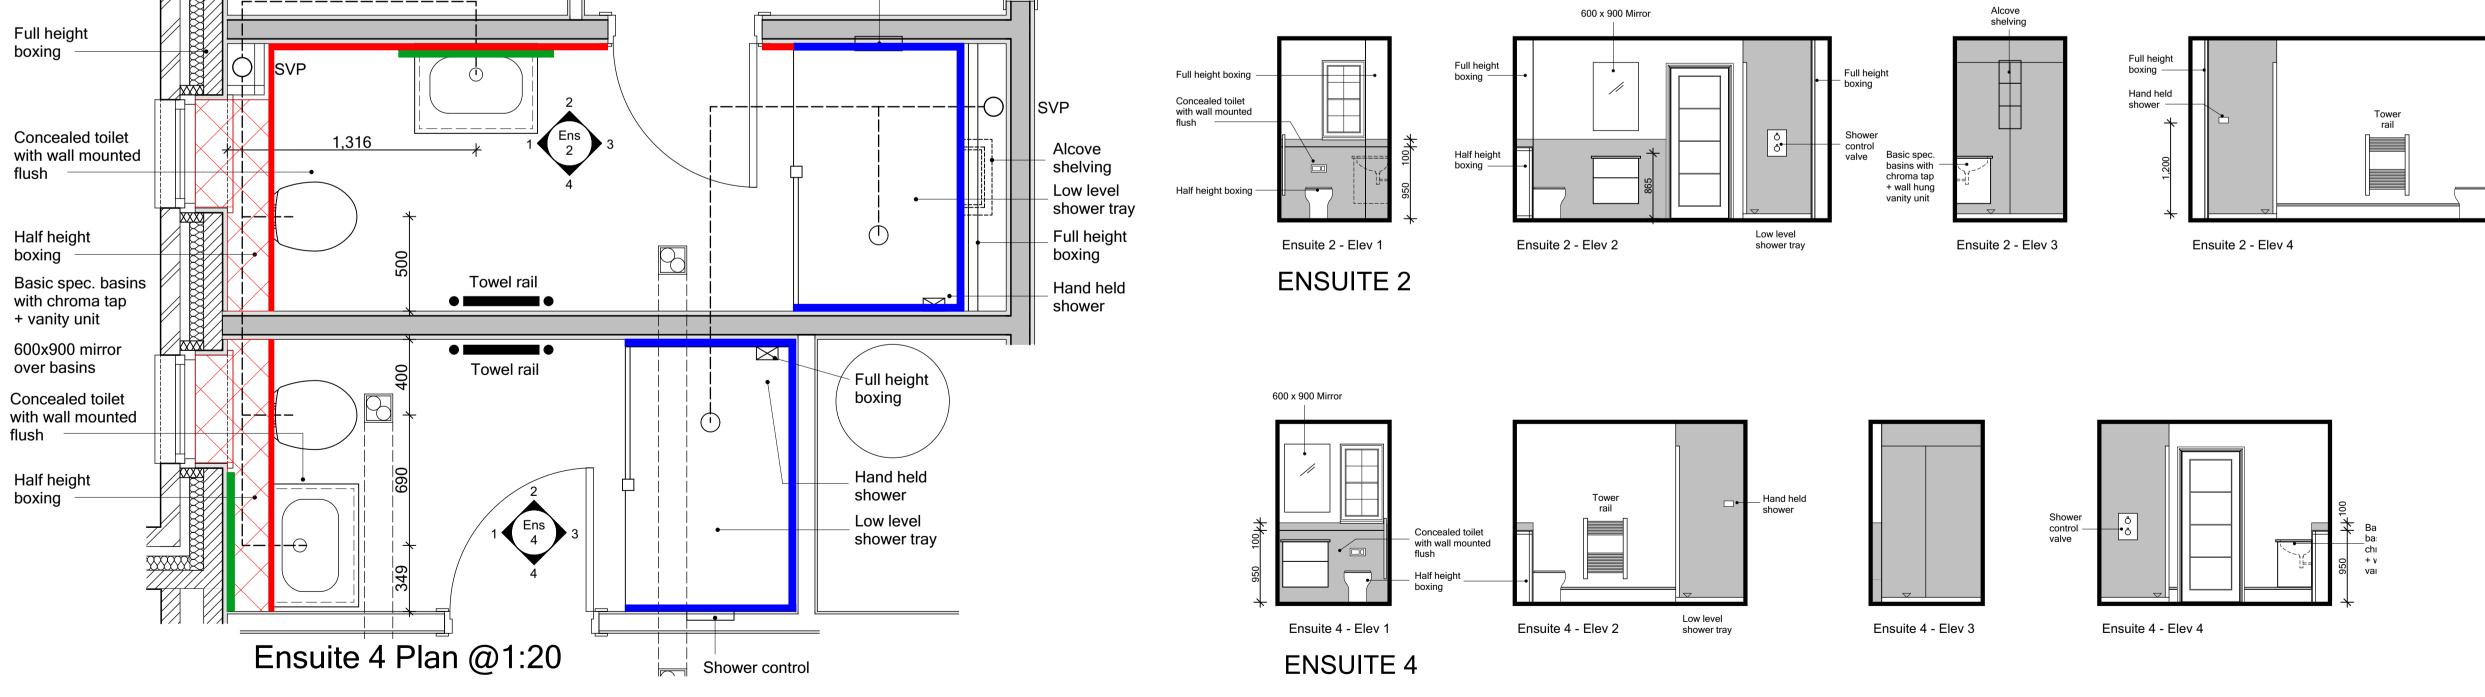



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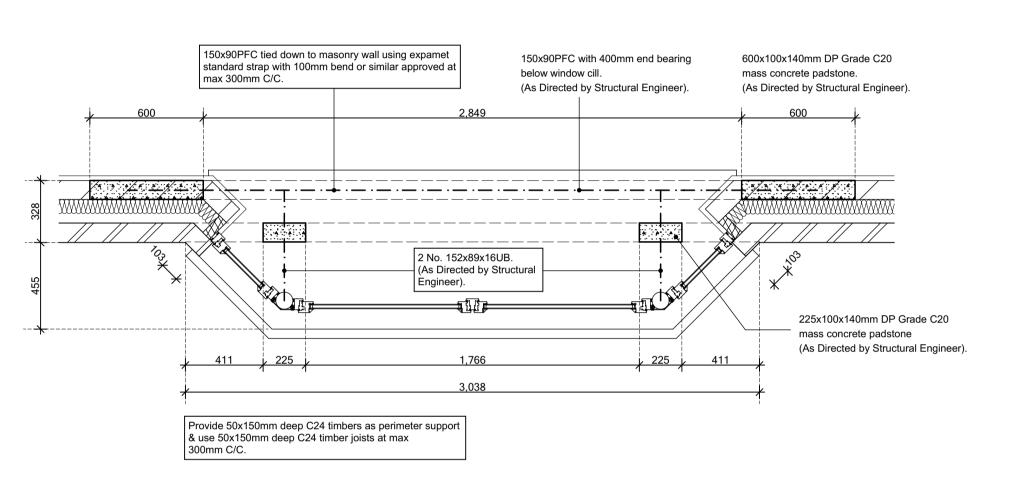
CONSTRUCTION

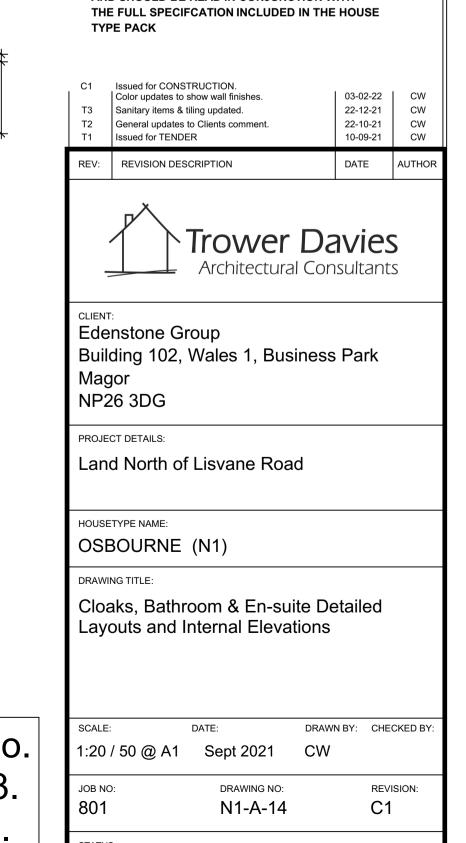



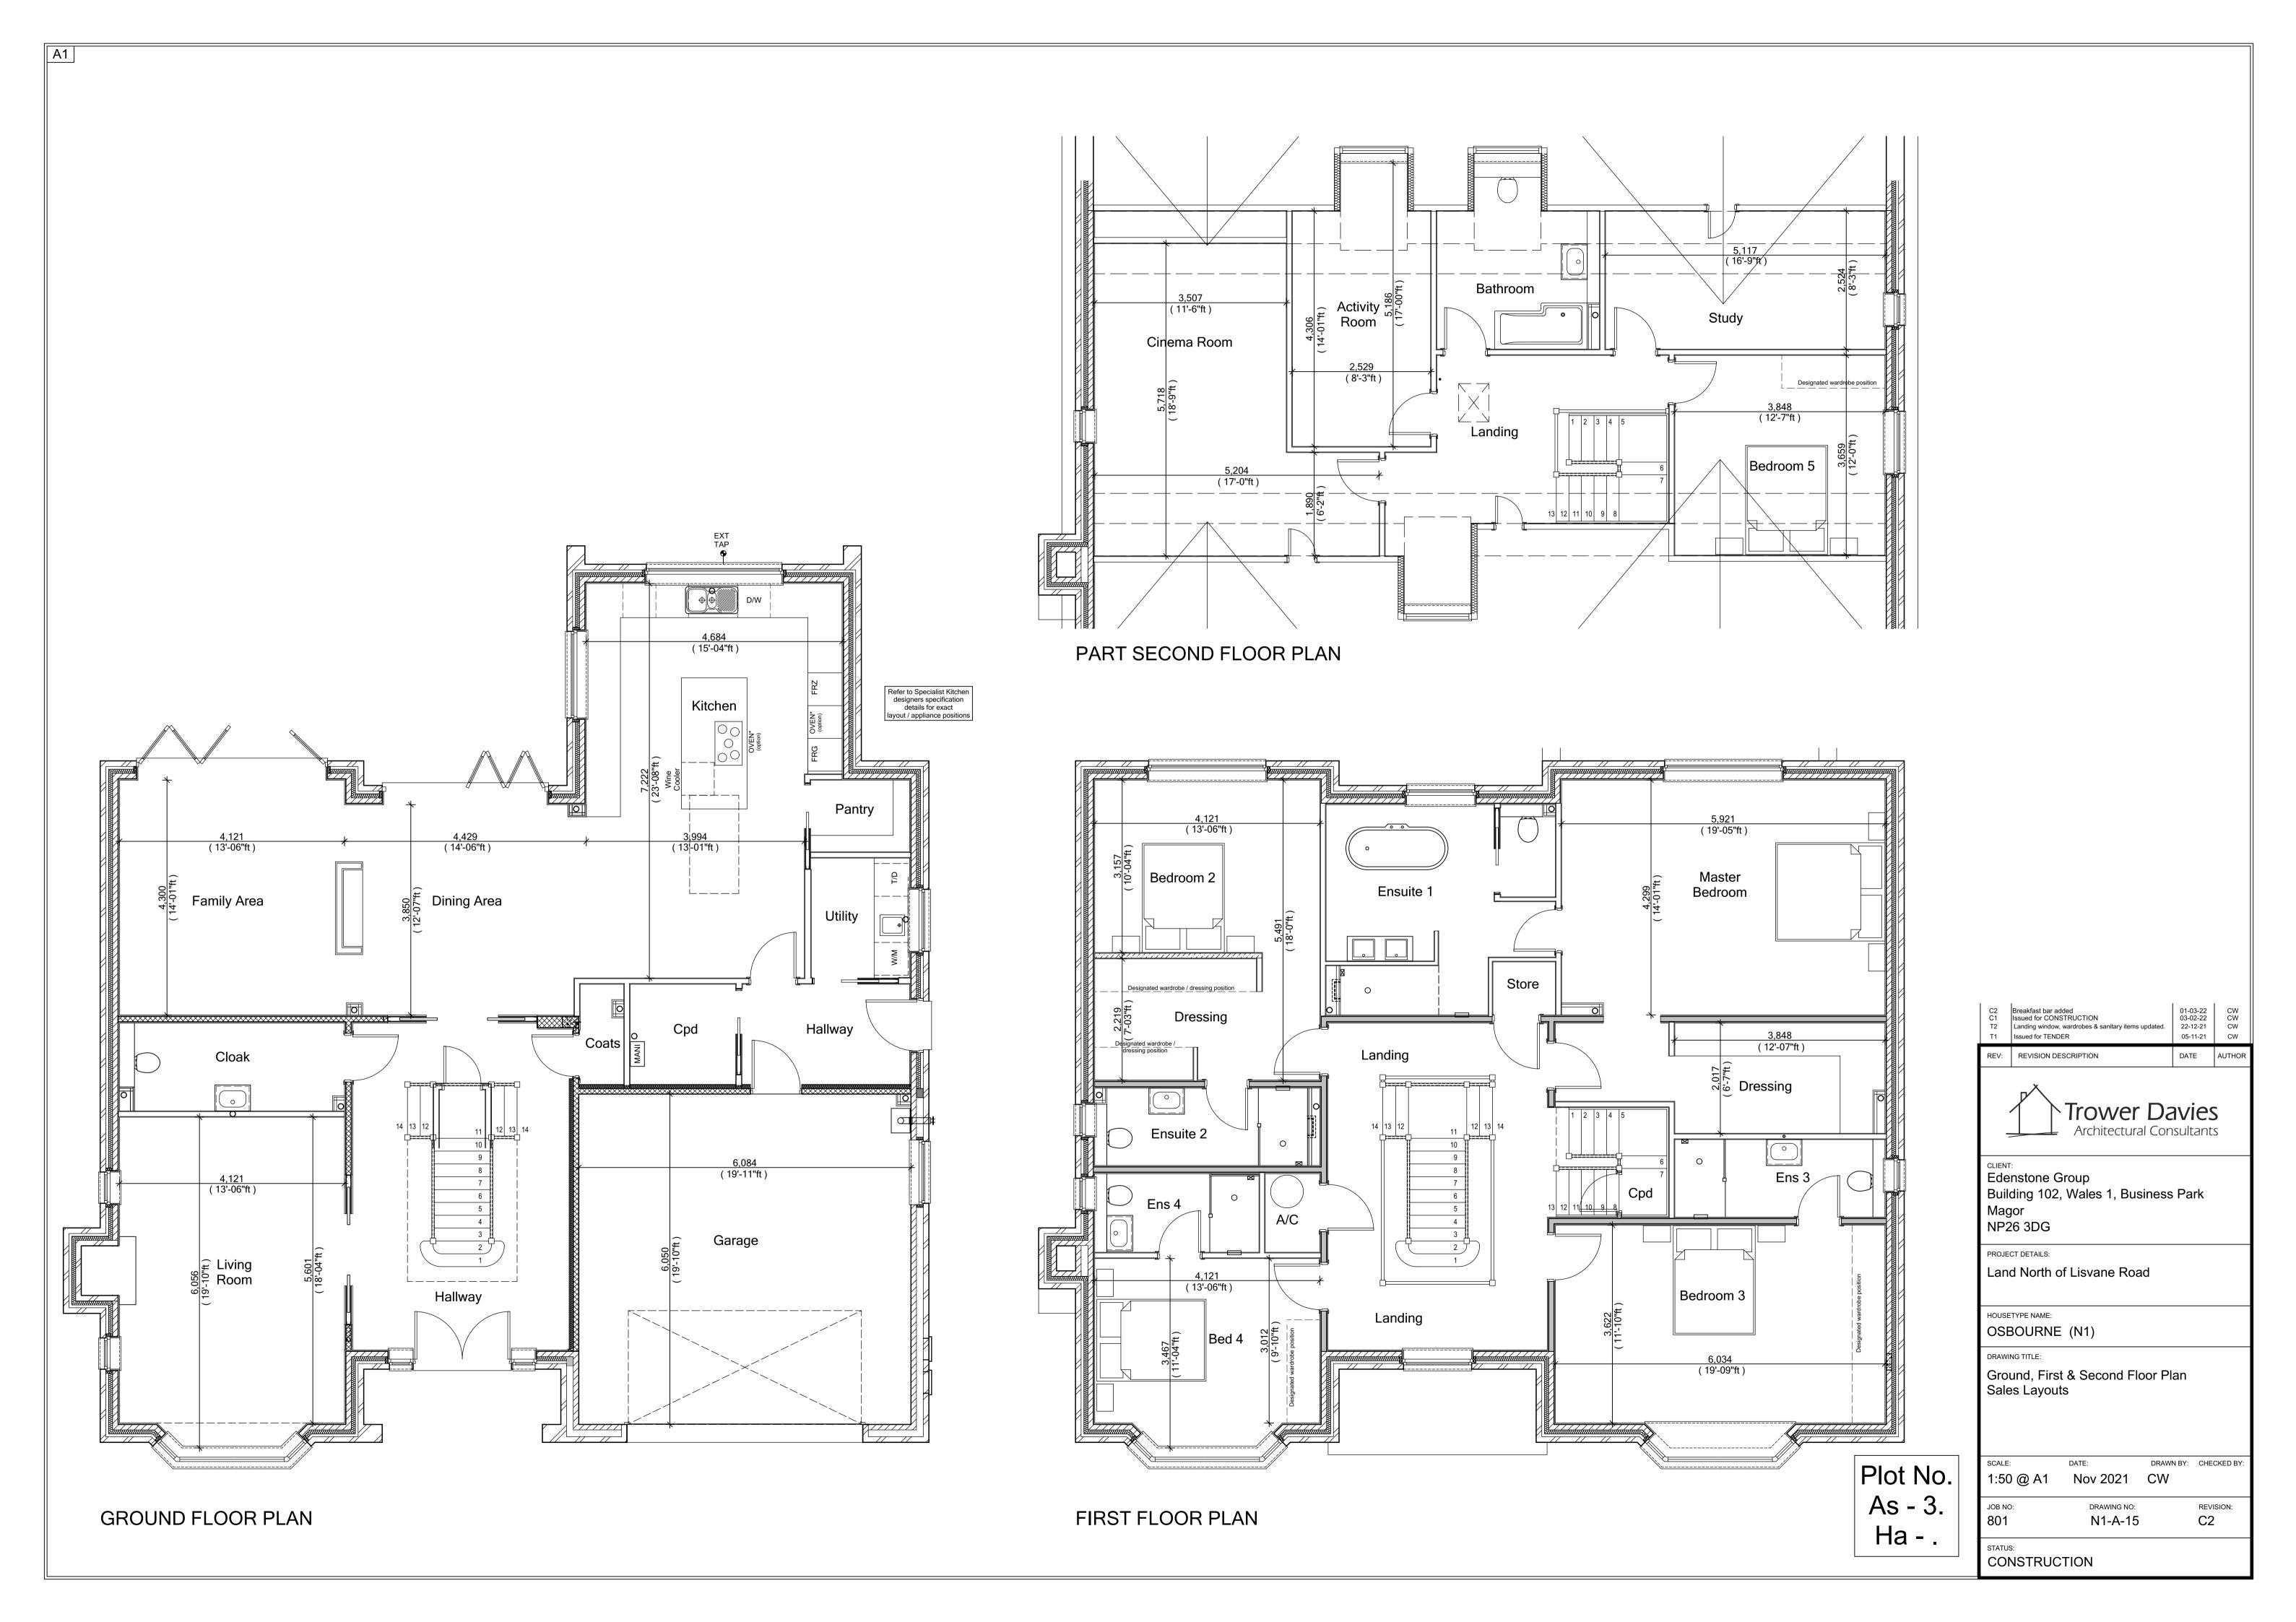


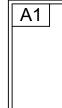Oriel Window Generic Section Detail

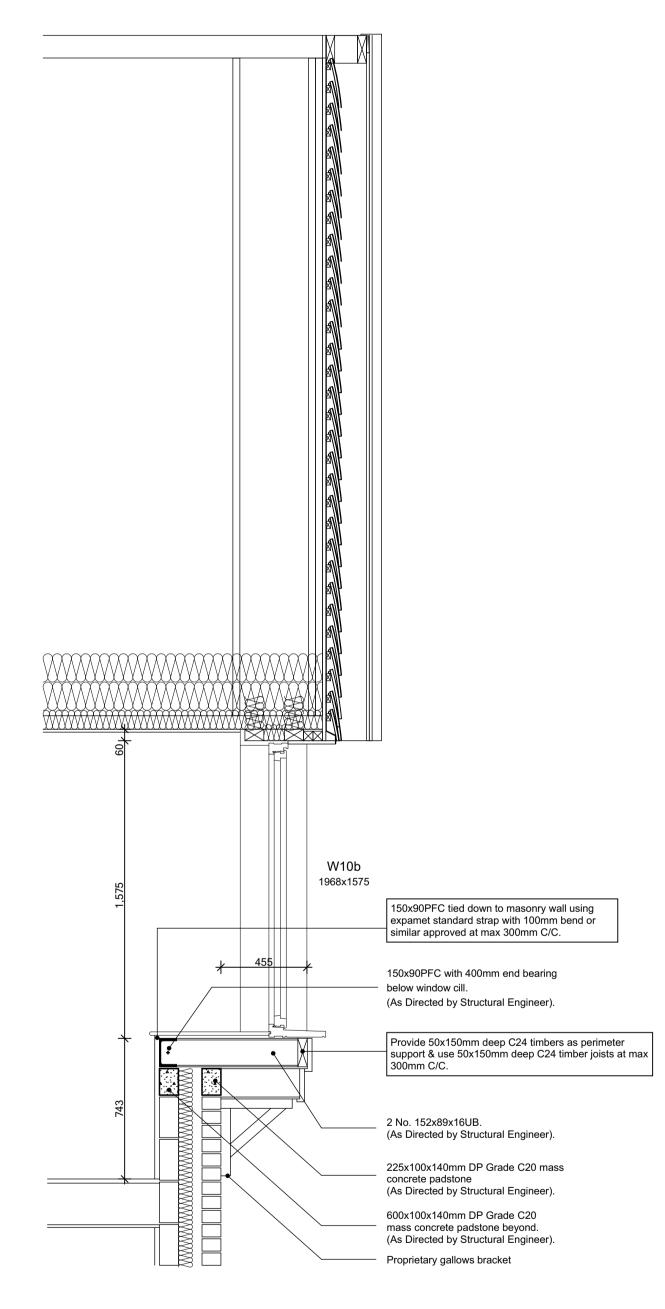

W10a - W10c Oriel Window Detail

# Detail subject to Structural Engineers Review

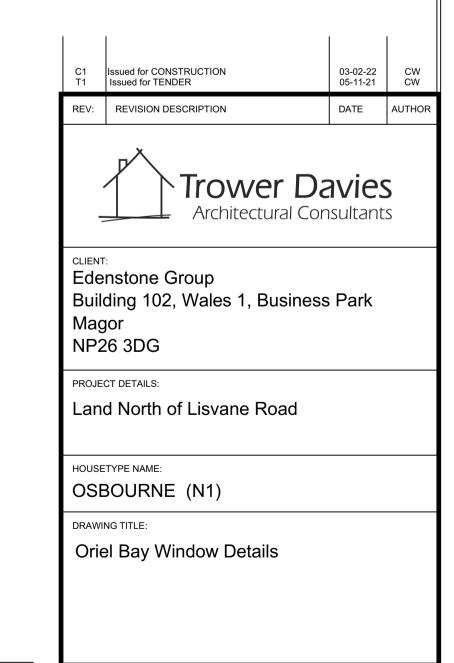

Plot No. As - 3. Ha - .

SCALE:	DATE:	DRAWN BY:	CHECKED BY:
1:20 @ A1	Nov 2021	CW	
JOB NO: <b>801</b>	DRAWING NO: N1-A-16		REVISION:
STATUS: CONSTRUC	TION		