


## DRAWING INDEX

- 1 SITE PLAN
  - 2 BUILDING ELEVATIONS
  - 3 FLOOR PLANS
  - 4 REFLECTED CEILING PLANS
  - 5 BUILDING SECTIONS
  - 6 ROOM/DOOR SCHEDULES/DETAILS
  - 7 INTERIOR ELEVATIONS/MISC. DETAILS
- 
- S-1 FOUNDATION PLAN
  - S-2 STRUCTURAL DETAILS
  - P-1 SITE/RISER DIAGRAM
  - P-2 PLUMBING PLAN
  - P-3 SCHEDULES/DETAILS
  - H-1 HVAC PLAN
  - H-2 HVAC DETAILS
  - H-3 HVAC ALT. #1/ DET.
  - E-1 SYMBOLS & SCHEDULES
  - E-2 POWER PLAN
  - E-3 LIGHTING PLAN

## BUILDING DATA

|                   |                                |
|-------------------|--------------------------------|
| ZONING            | R-0                            |
| OCCUPANCY         | ILHR 59 HAZARDOUS              |
| CONSTRUCTION TYPE | METAL FRAME UNPROTECTED (NO.G) |
| AREA              |                                |
| MAIN LEVEL        | 1,767 SQ. FT.                  |
| UPPER LEVEL       | 2,590 SQ. FT.                  |
| OCCUPANT LOAD     | 67                             |

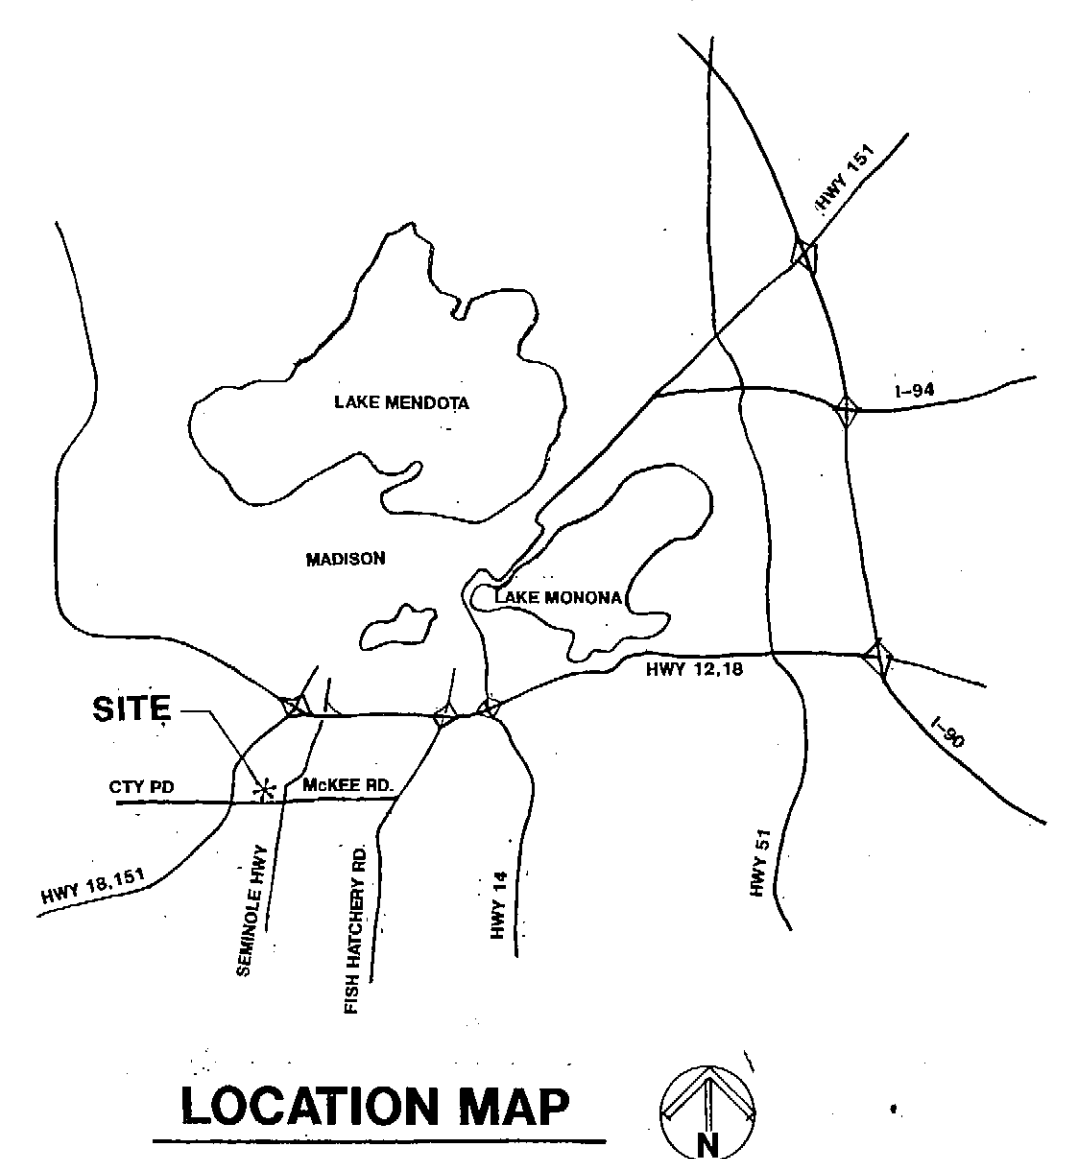

NEW CONTOURS ————— 170 —————  
SPOT ELEVATION 170.00  
DRAINAGE SWALE —————> —————>

- 1) MAXIMUM SLOPE FOR FINISHED GRADE SHALL NOT EXCEED 1" IN 4'.
- 2) SEED, SOO, PLANTING N.I.C.
- 3) PROVIDE 6" TOP SOIL ON ALL DISTURBED GROUND.

SIGN "VISITOR PARKING"

PROVIDE 4" CROWN —  
ON ENTRANCE DRIVE.

16"  $\phi$   $\times$  85' CORRUGATED —  
STEEL CULVERT. FLARED ENDS  
EAST INVERT = 166.8  
WEST INVERT = 166.2

EXIST'G  
14" WATER -  
-----  
EXIST'G  
4" GAS

## AND VENTILATING DING PLANS ditionally

**20'ED**  
BY LABOR AND HUMAN RELATIONS

ll V Baldwin  
CORRESPONDENCE  
-2264 B

**1** SITE GRADING PLAN

BUILDING & SITE PLANS CONDITIONALLY  
**APPROVED**  
CITY OF FITCHBURG  
ZONING DEPARTMENT  
\_\_\_\_\_  
Signature Date 4-6-89

BUILDING PLANS CONDITIONALLY  
**APPROVED**  
CITY OF FITCHBURG  
BUILDING INSPECTION DEPARTMENT

SIGNATURE JAMES KORETEV DATE 4/6/89

**Conditionally Approved**  
Fire Prevention Bureau  
Fitchburg Fire Department.

*[Signature]*  
NAME TITLE  
04-03-89  
DATE

WISCONSIN  
DAVID O. NOELCK  
A-1893  
FOND DU LAC  
WIS  
2/8/89  
ARCHITECT

*[Circular stamp: DA - 100-447896]*

## PLUMBING

**H.V.A.C.**

**ELECTRICAL**

## PROJECT REVIEW

**Foth & Van Dyke**  
Engineers / Architects


# FITCHBURG UTILITY BUILDING

6060 McKee Road


Fitchburg, WI

SHEET NO.

1

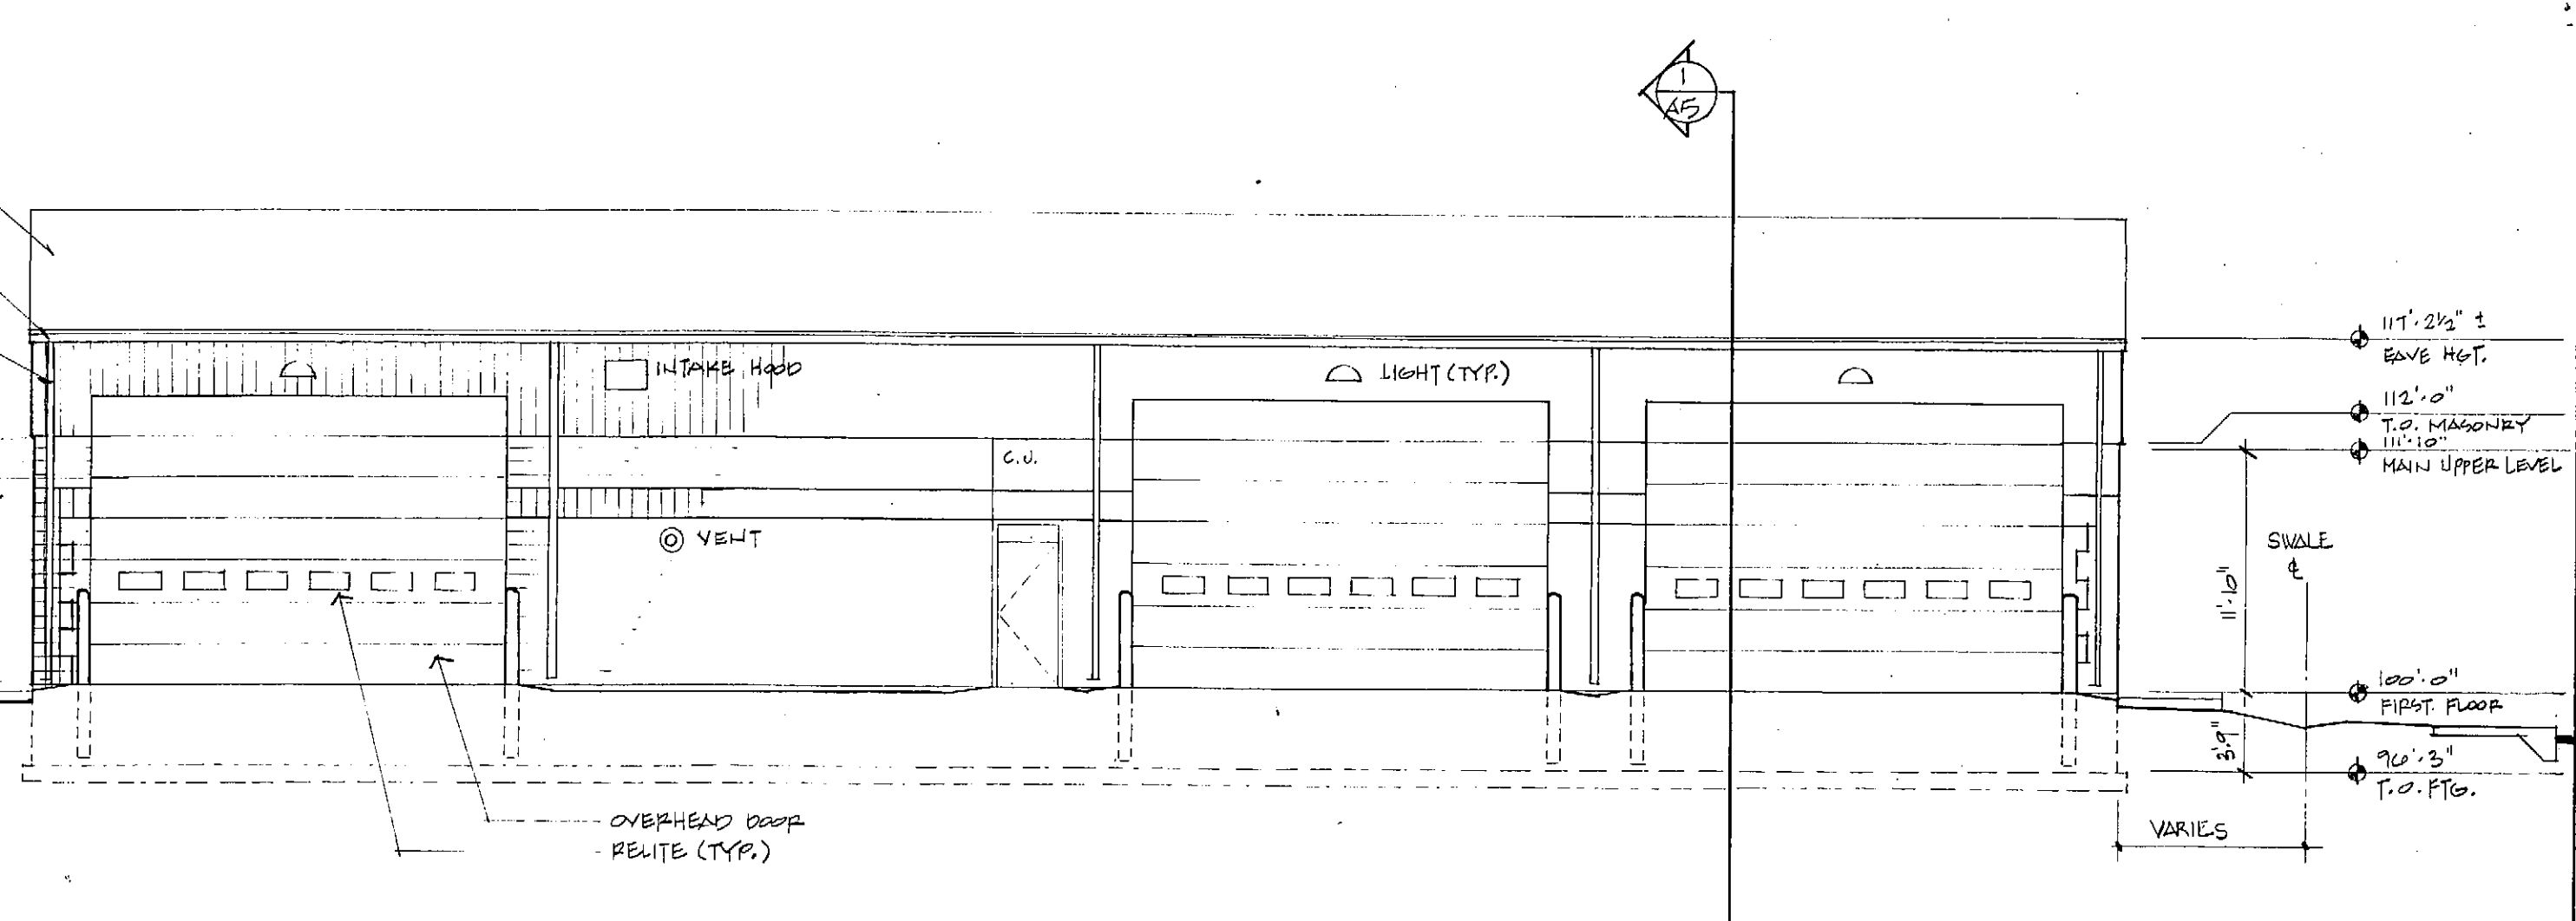



**2 WEST ELEVATION**

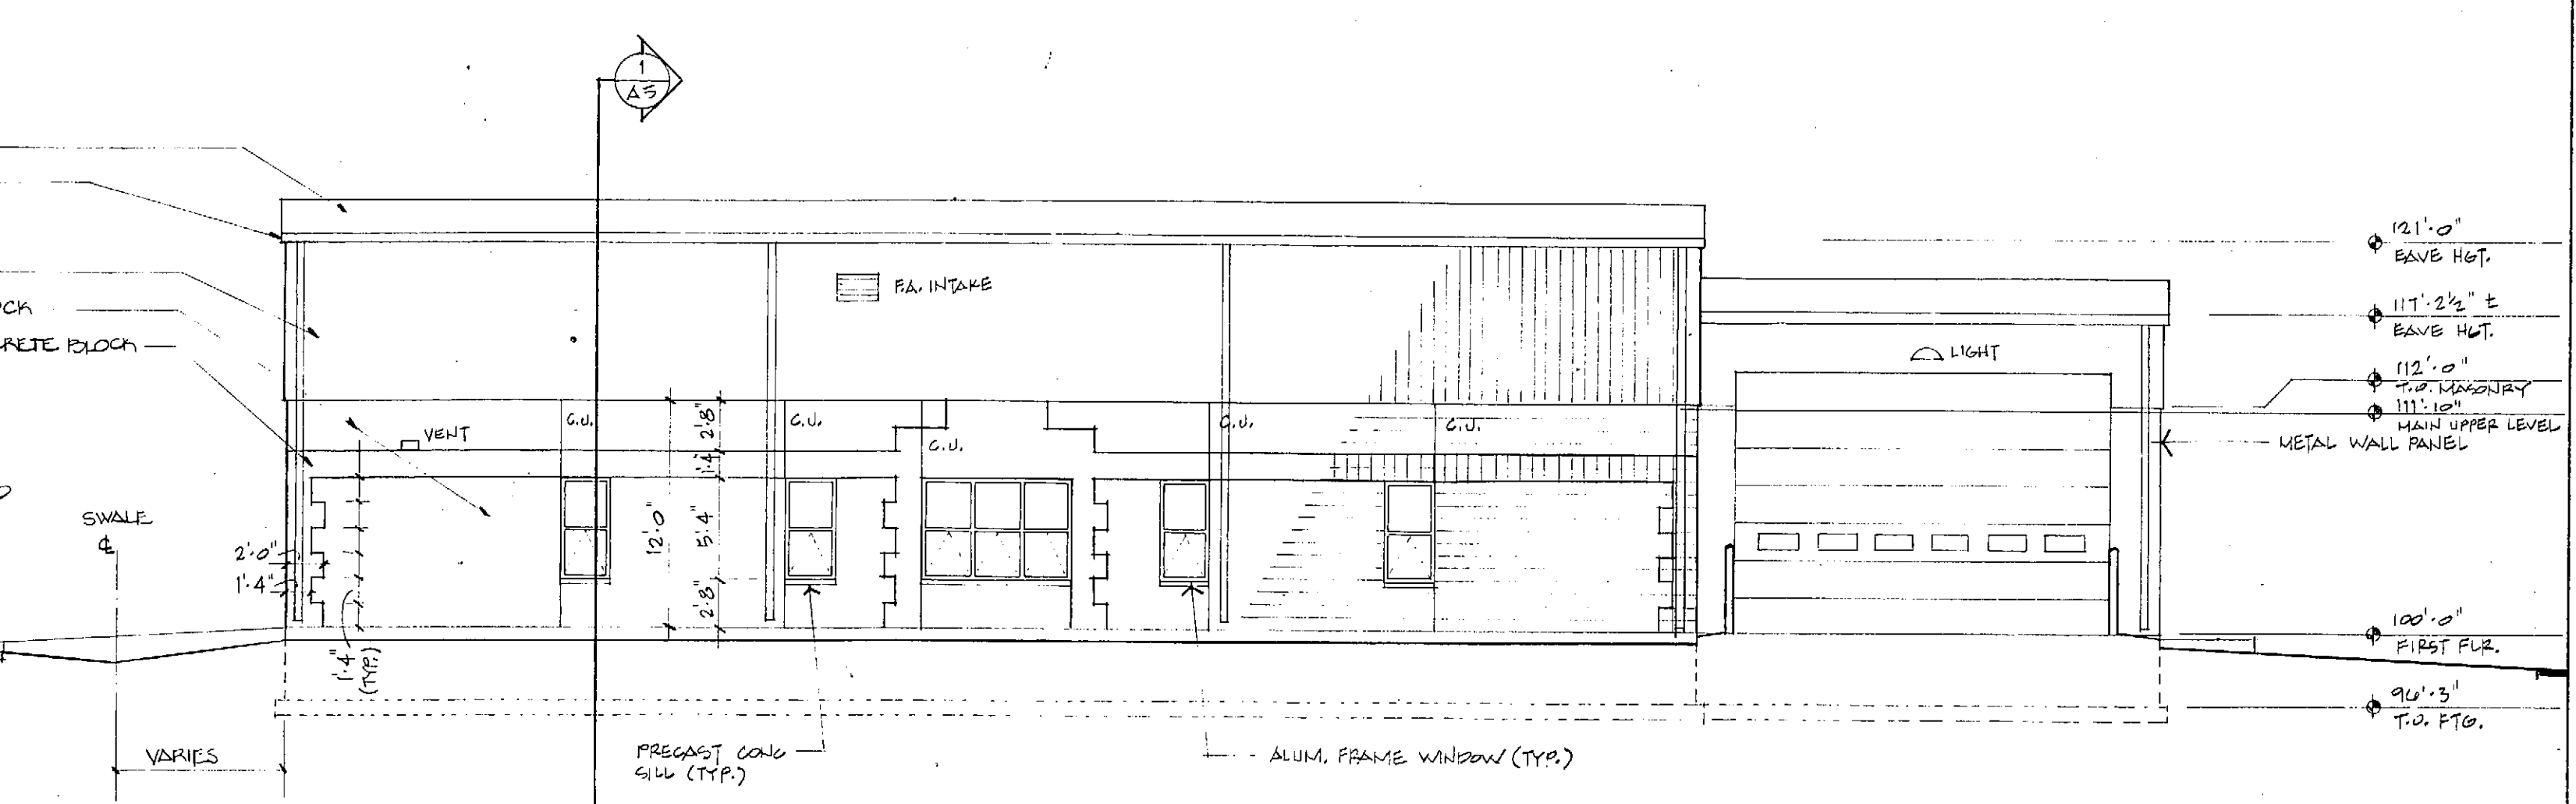

#### 4 EAST ELEVATION



|           |             |-----------|-------------|------|----|-----|-------------|------|----|-------------|-------|----------|--------|----------------|--------|--------|--|---|--|----------------------------|--|----------------------------------|--|------------------|--|
| REVISIONS |             |      |    |     |             |      |    |             |       | FILE NO. | 2414   | PROJECT REVIEW |        |        |  | Foth & Van Dyke<br>Engineers / Architects |  | FITCHBURG UTILITY BUILDING |  | 6060 McKee Road<br>Fitchburg, WI |  | SHEET NO.<br>A-2 |  |
| NO.       | DESCRIPTION | DATE | BY | NO. | DESCRIPTION | DATE | BY | SURVEYED BY |       |          |        |                |        |        |  |   |  |                            |  |                                  |  |                  |  |
| △         |             |      |    | △   |             |      |    | DRAWN BY    | RQH   | DATE     | 2-1-89 | DESIGN         | D.O.H. | DATE   |  | DESIGN                                    |  | DATE                       |  |                                  |  |                  |  |
| △         |             |      |    | △   |             |      |    | SCOPE LG.   | BBFAO | REVIEW   | J.A.J. | DATE           | 2-3-89 | REVIEW |  | DATE                                      |  |                            |  |                                  |  |                  |  |
| △         |             |      |    | △   |             |      |    | SCALE       |       |          |        |                |        |        |  |   |  |                            |  |                                  |  |                  |  |

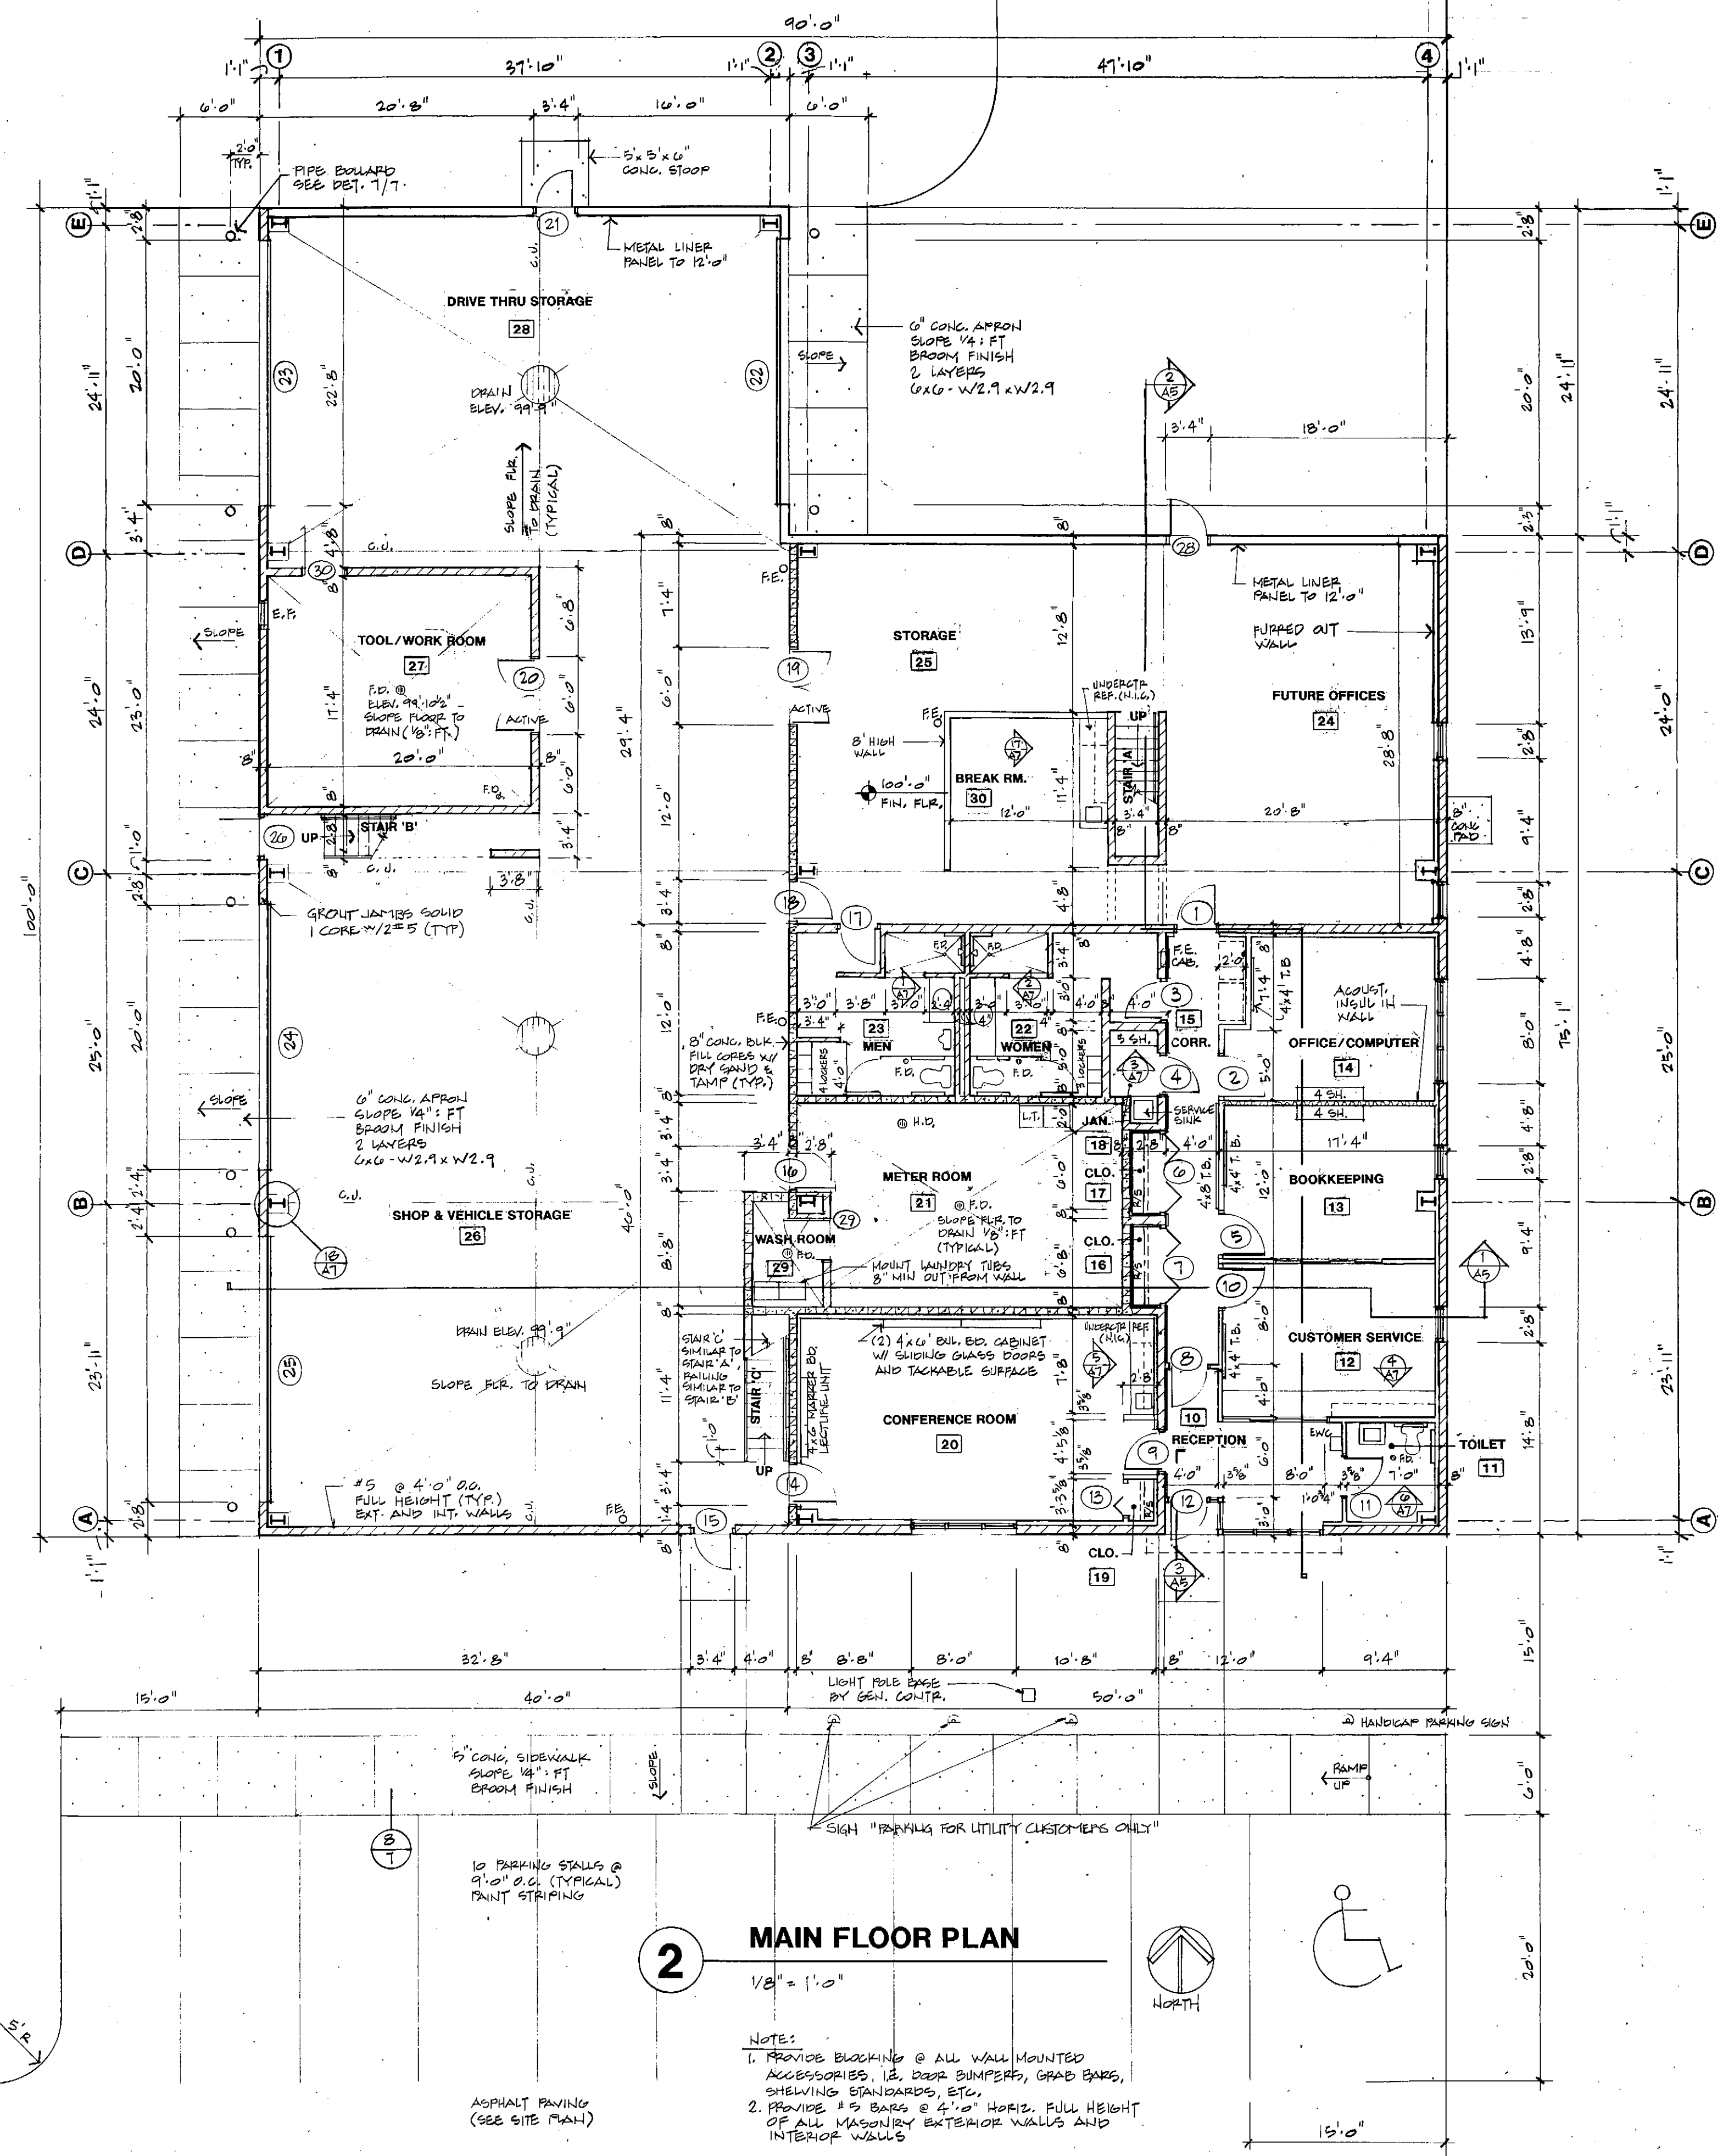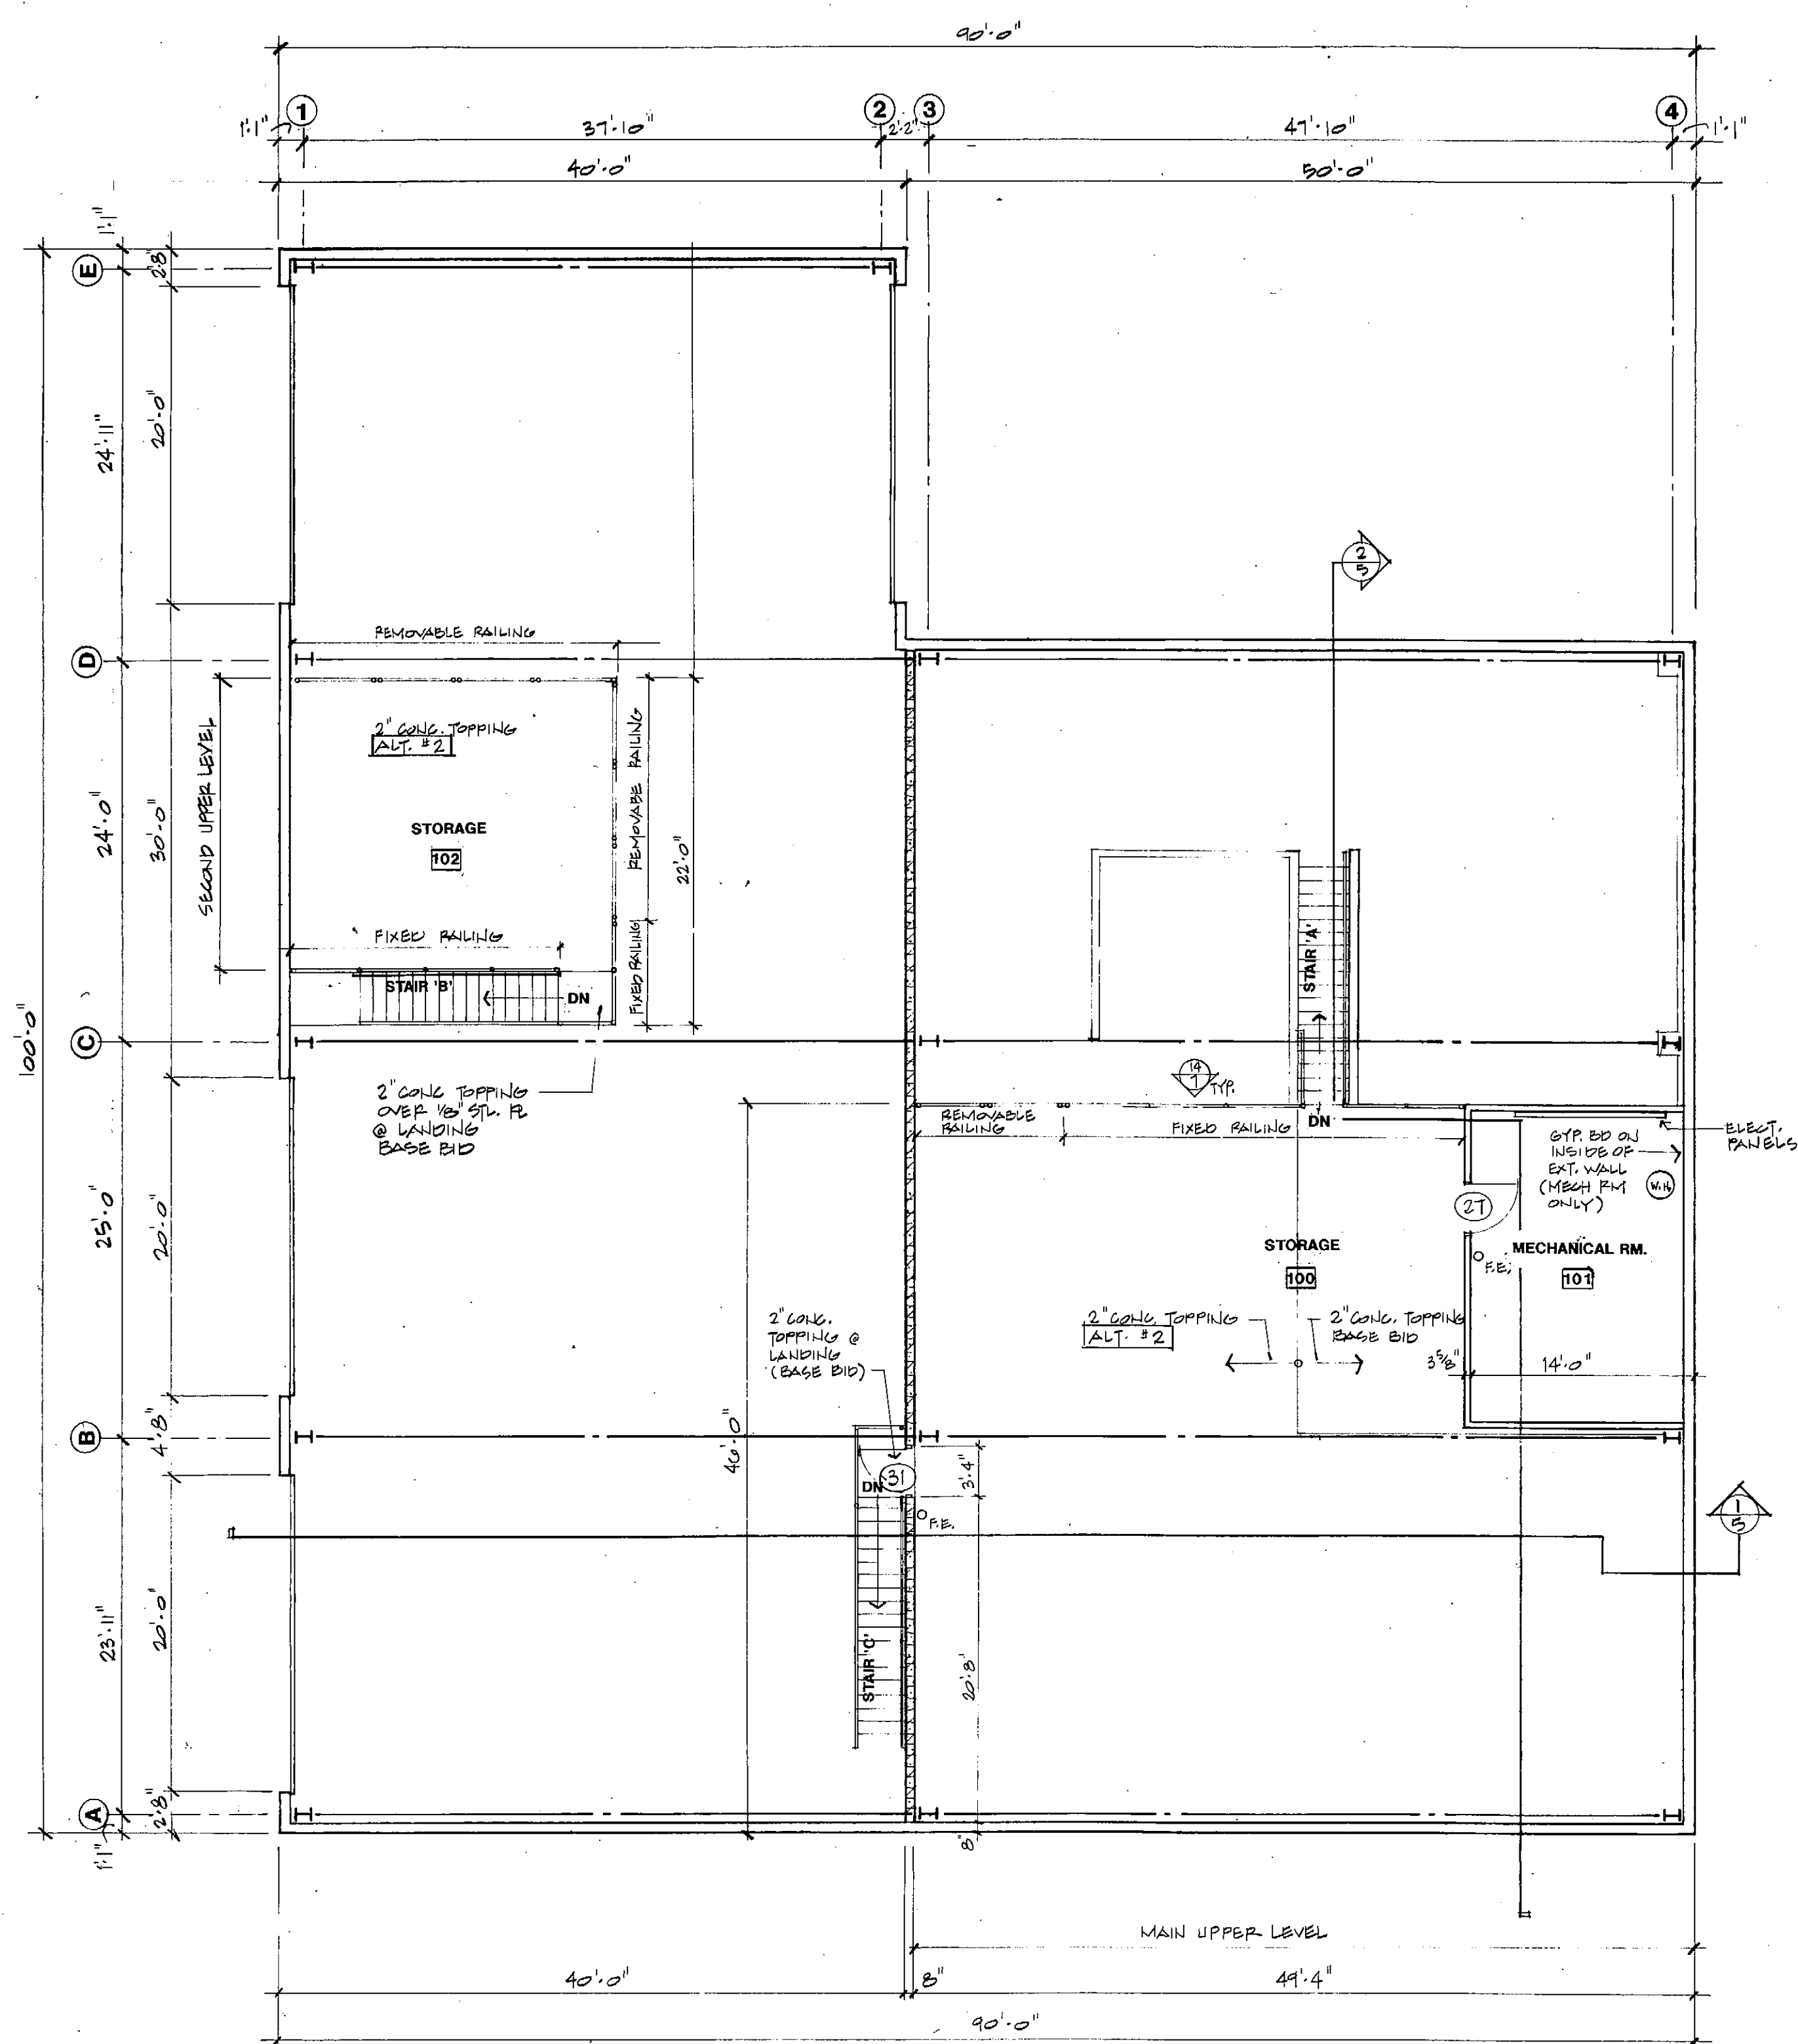

| REVISIONS                |             |      |    |                          |             |      |    | FILE NO.    | 2414   | PROJECT REVIEW |  |        |        |        |        |
|--------------------------|-------------|------|----|--------------------------|-------------|------|----|-------------|--------|----------------|--|--------|--------|--------|--------|
| NO.                      | DESCRIPTION | DATE | BY | NO.                      | DESCRIPTION | DATE | BY | SURVEYED BY |        |                |  | DESIGN | DATE   | DESIGN | DATE   |
| <input type="checkbox"/> |             |      |    | <input type="checkbox"/> |             |      |    | DRAWN BY    | JABJ   |                |  |        |        |        |        |
| <input type="checkbox"/> |             |      |    | <input type="checkbox"/> |             |      |    | DATE        | 2-7-89 |                |  | DESIGN | P.O.N. | DATE   |        |
| <input type="checkbox"/> |             |      |    | <input type="checkbox"/> |             |      |    | SCOPE I.D.  | BDF40  |                |  | REVIEW | J.A.J. | DATE   |        |
| <input type="checkbox"/> |             |      |    | <input type="checkbox"/> |             |      |    | SCALE       |        |                |  |        |        | REVIEW | 2-3-89 |

| PROJECT REVIEW |        |      |        |      |
|----------------|--------|------|--------|------|
| DESIGN         | D.O.N. | DATE | DESIGN | DATE |
| REVIEW         | J.A.D. | DATE | REVIEW | DATE |

**Foth & Van Dyke**  
Engineers / Architects


## FITCHBURG UTILITY BUILDING

6060 McKee Road


Fitchburg, WI

SHEET NO.  
**A-3**



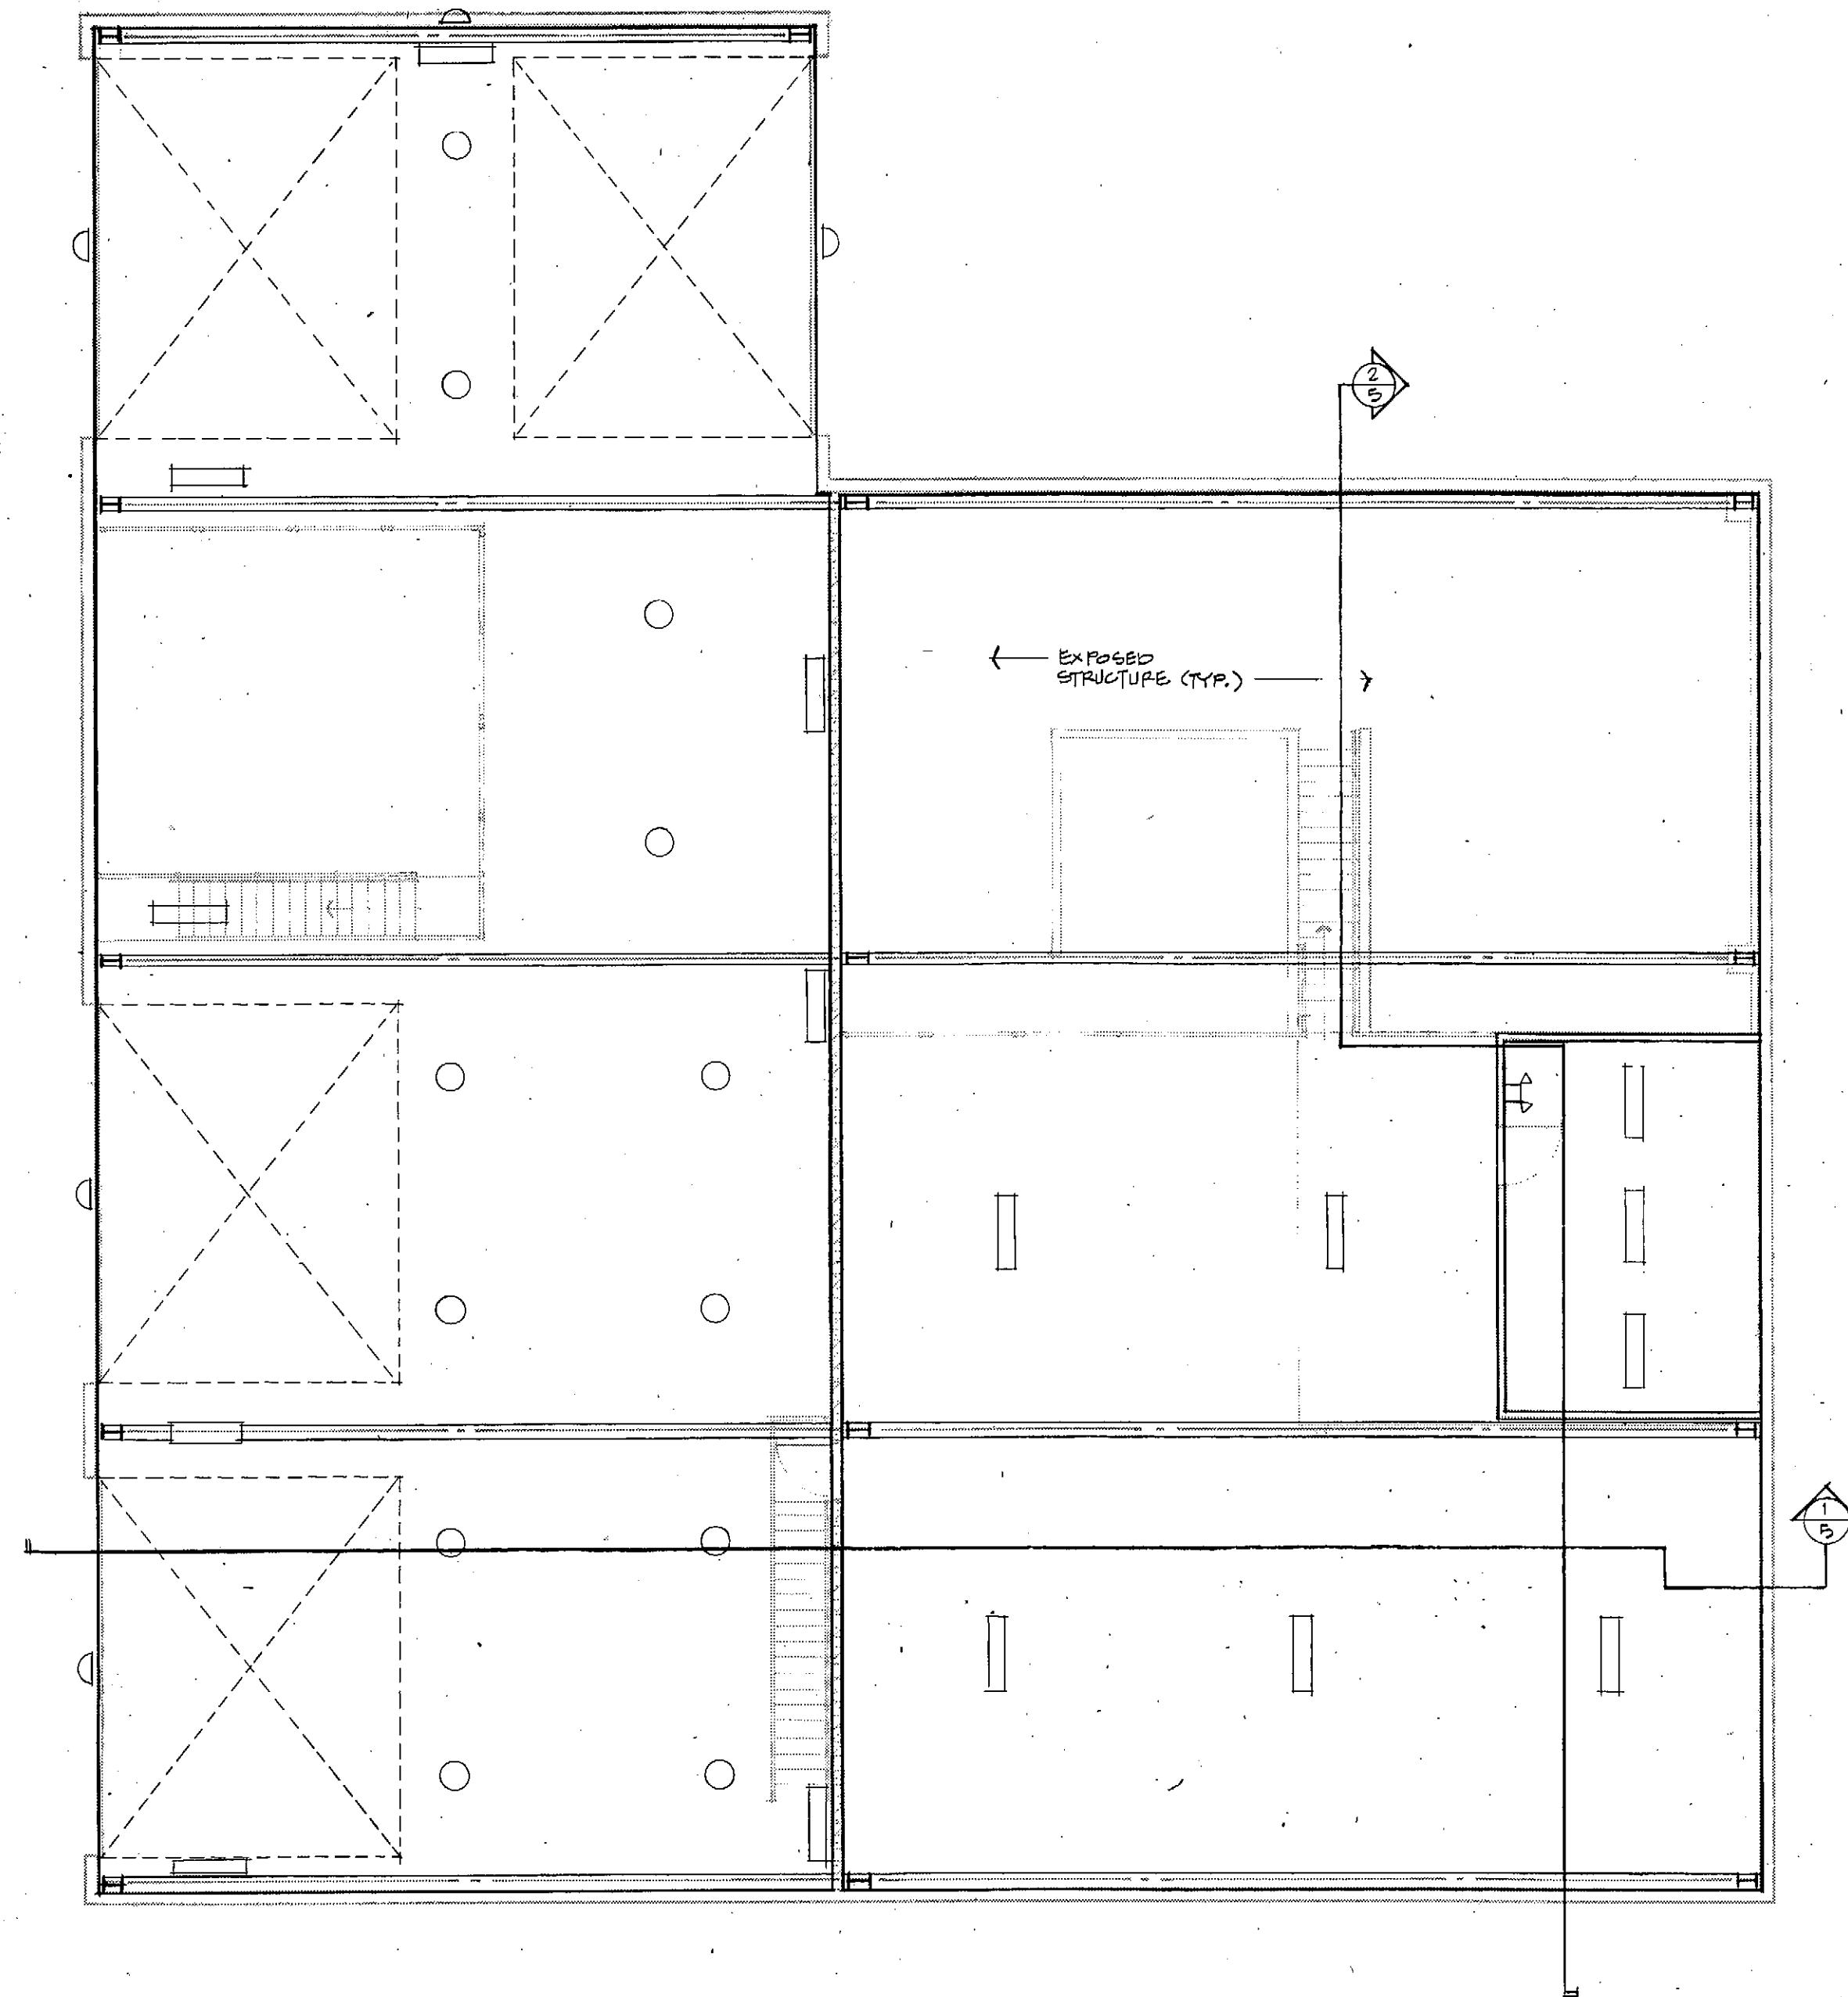

**1 UPPER LEVEL REFLECTED CEILING PLAN**  
1/8" = 1'-0"

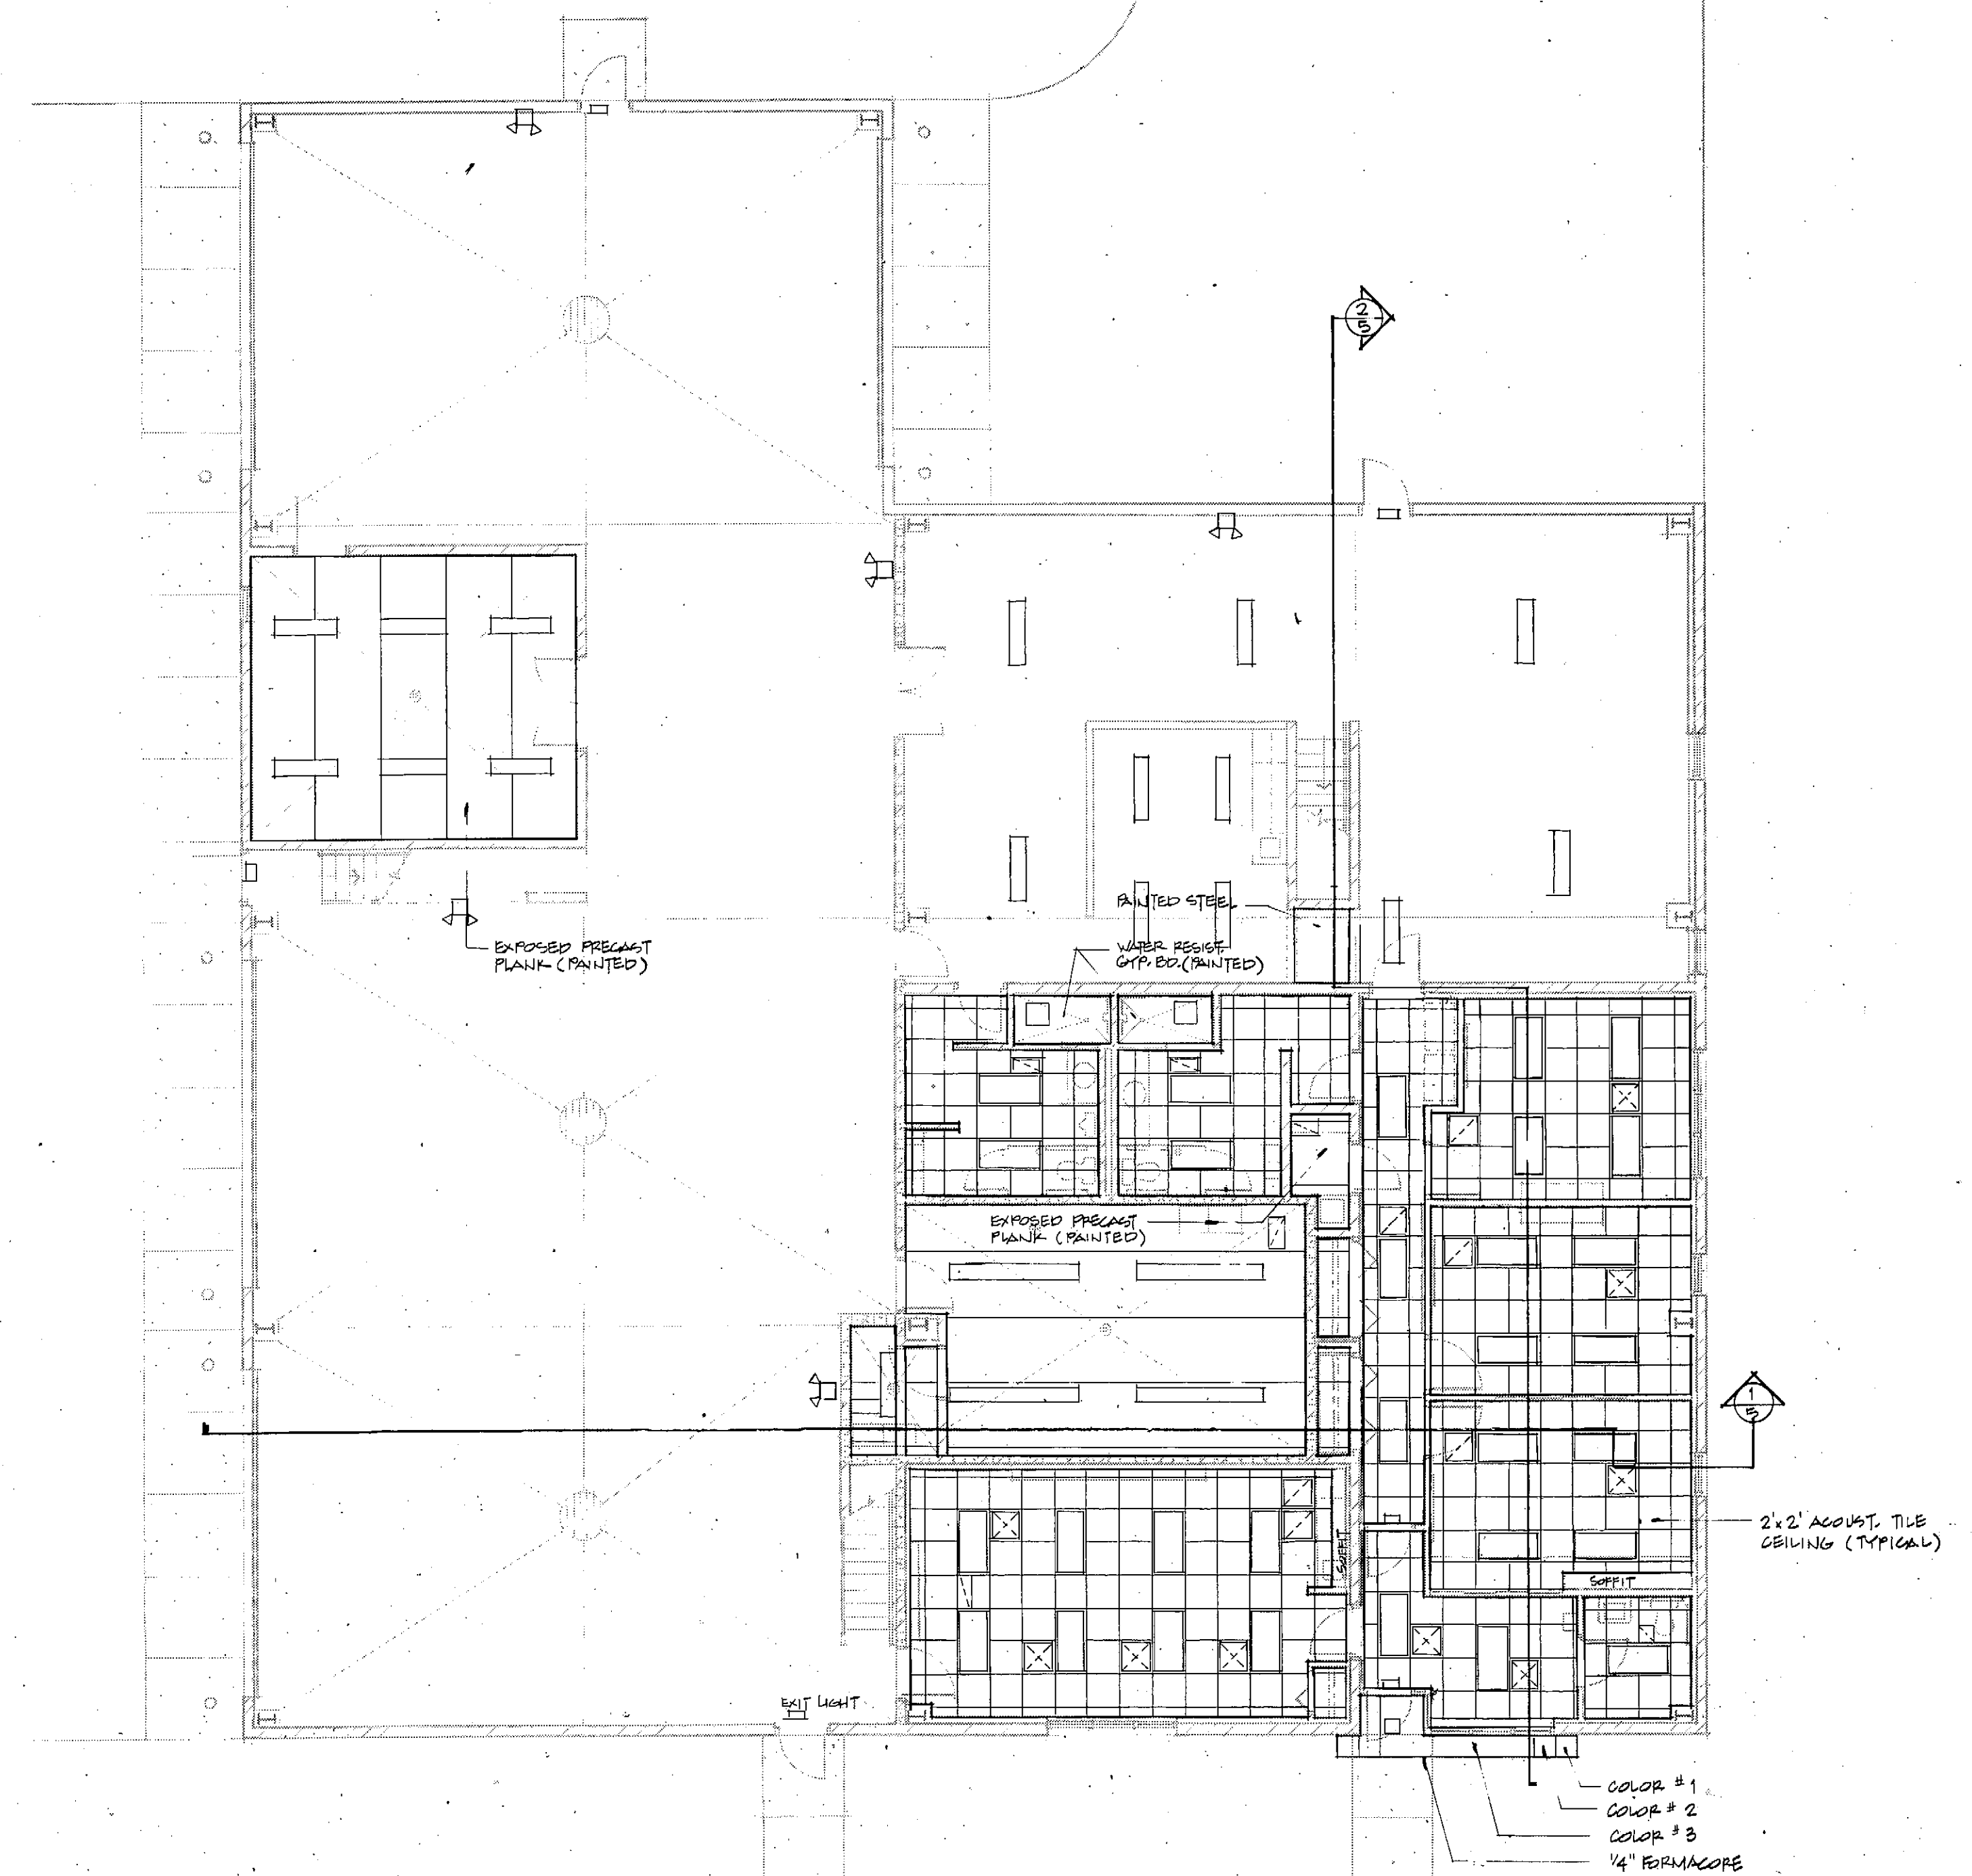

**2 MAIN FLOOR REFLECTED CEILING PLAN**  
1/8" = 1'-0"

TELETYPE DOT 11/2/83

| REVISIONS |             |      |    |     |             |
|-----------|-------------|------|----|-----|-------------|
| NO.       | DESCRIPTION | DATE | BY | NO. | DESCRIPTION |
| 1         |             |      |    | 1   |             |
| 2         |             |      |    | 2   |             |
| 3         |             |      |    | 3   |             |

|             |        |
|-------------|--------|
| FILE NO.    | 2414   |
| SURVEYED BY | DOH    |
| DATE        | 2.1.89 |
| SCOPE I.D.  | BB740  |
| SCALE       |        |




| PROJECT REVIEW |        |      |        |      |  |
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| DESIGN         | DOH    | DATE | DESIGN | DATE |  |
| REVIEW         | J.A.D. | DATE | REVIEW | DATE |  |

**Foth & Van Dyke**  
Engineers / Architects

**FITCHBURG UTILITY BUILDING**  
6060 McKee Road  
Fitchburg, WI

SHEET NO.  
**A-4**

NOTE: METAL BUILDING SUPPLIER TO PROVIDE ALL ROOF CURBS, WATERPROOF FLASHINGS AND ADEQUATE SUPPORT REQUIRED FOR ALL ROOF PENETRATIONS AND ROOF MOUNTED ACCESSORIES. REVIEW ALL PLANS INCLUDING ELECTRICAL, MECHANICAL, AND PLUMBING.

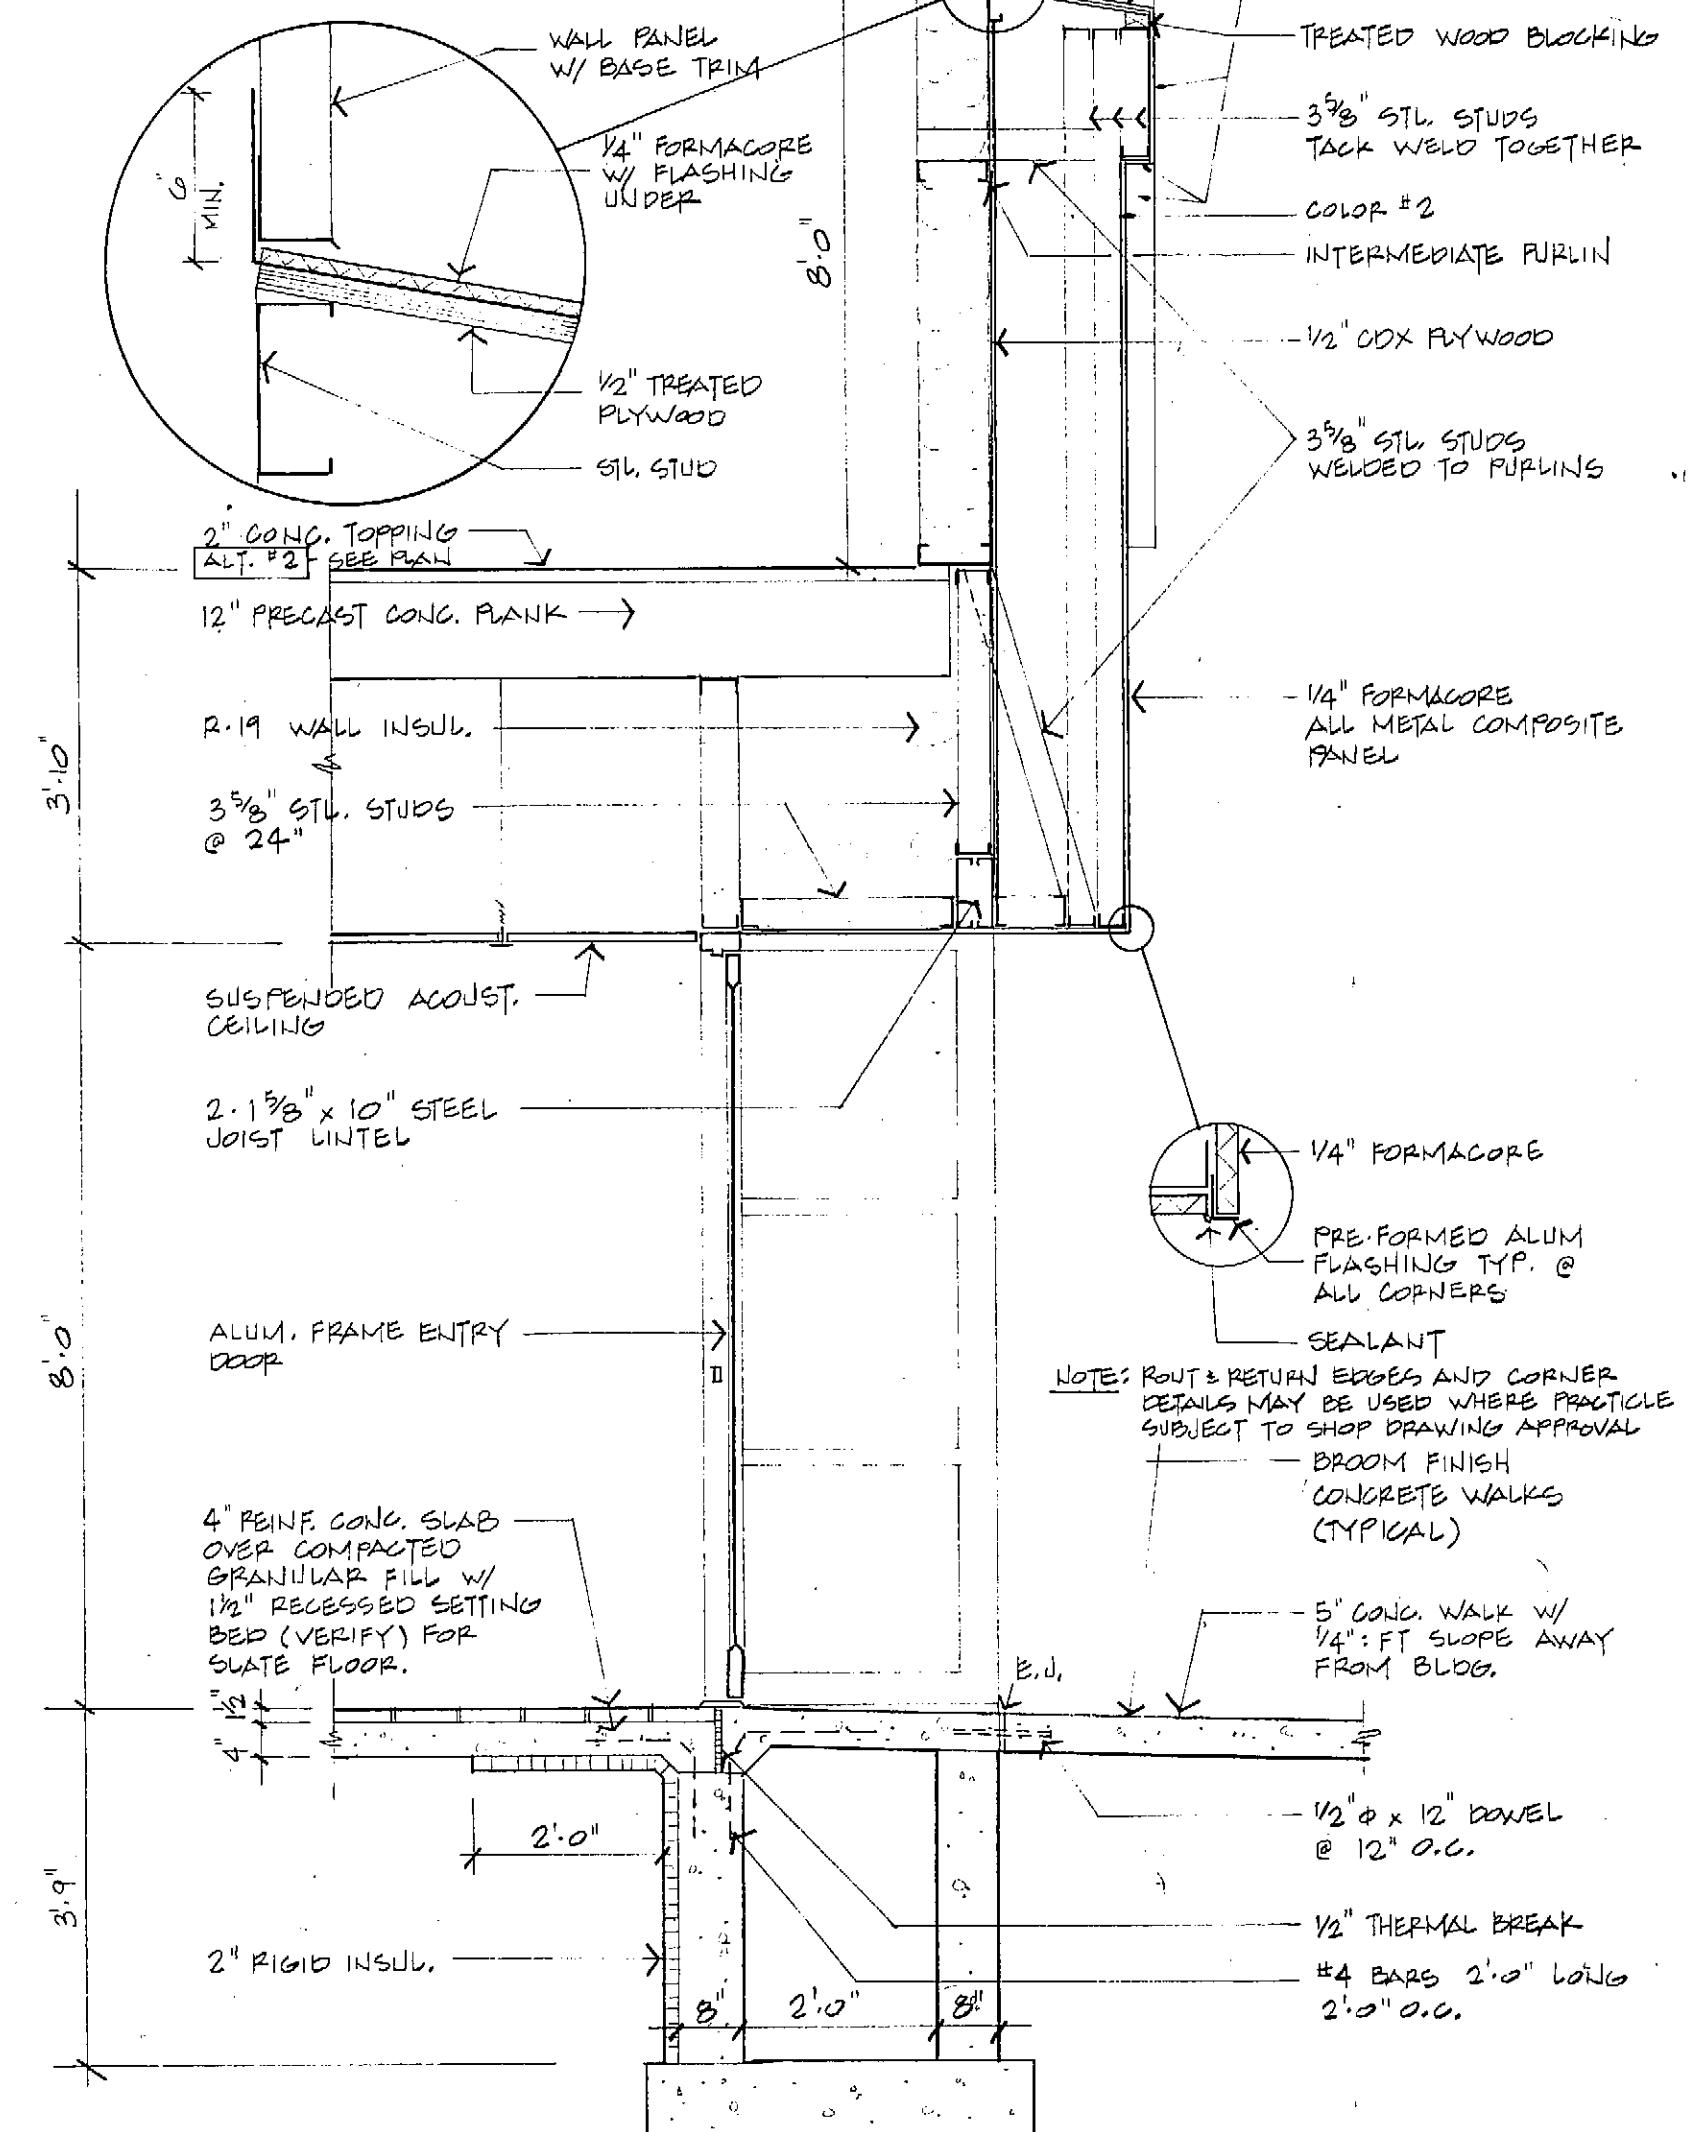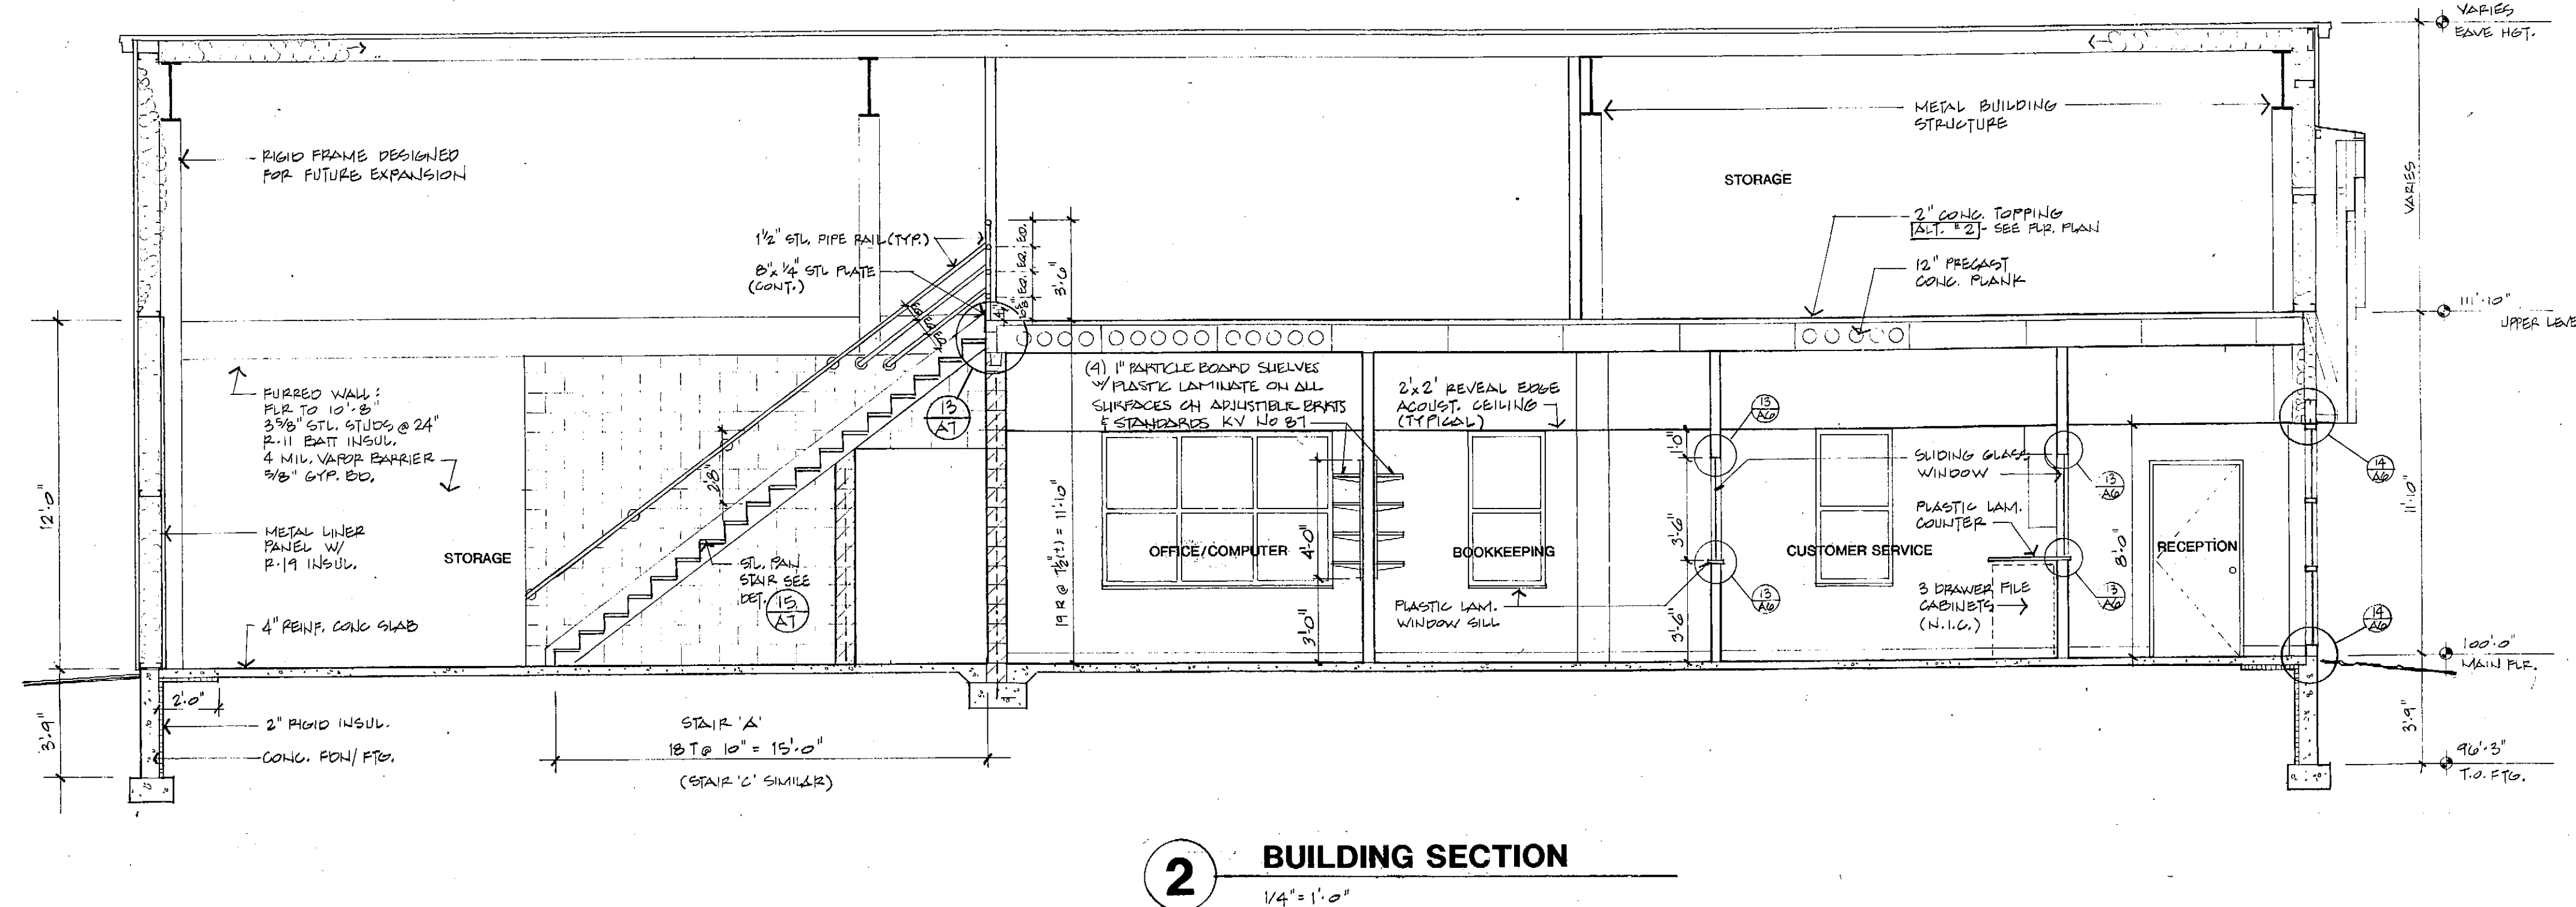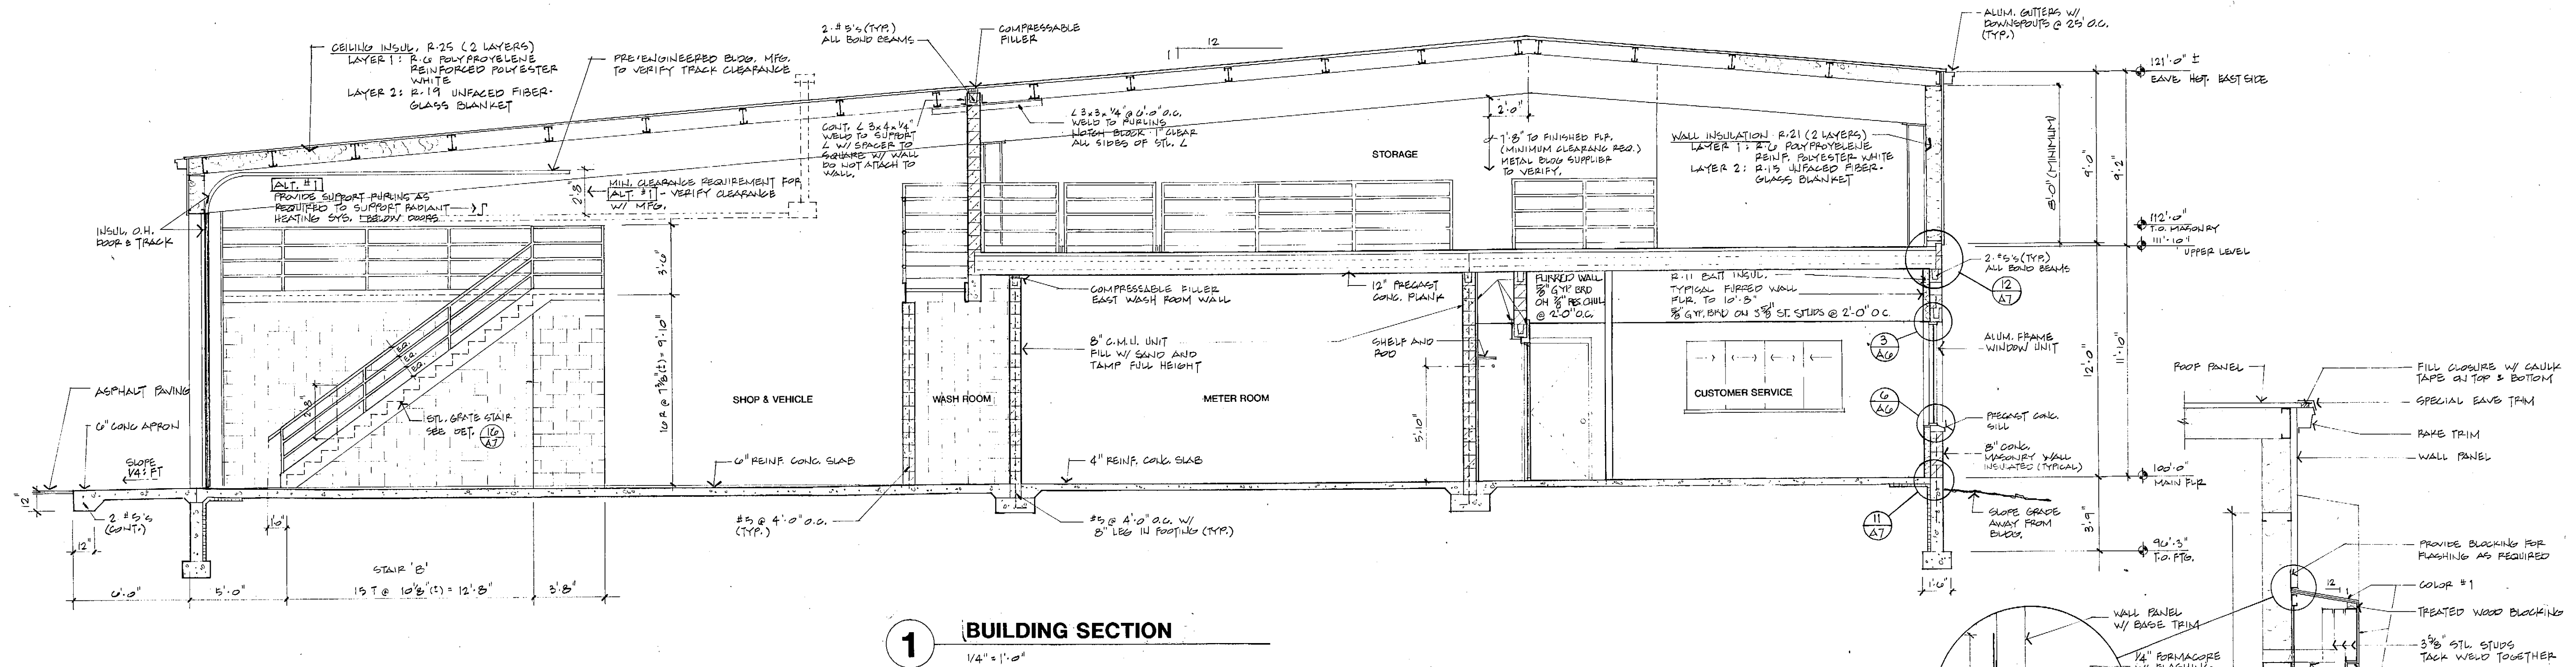

| REVISIONS |             |      |    |     |             |      |    |          |        | PROJECT REVIEW |      |          |      | FITCHBURG UTILITY BUILDING |               | SHEET NO. |  |
|-----------|-------------|------|----|-----|-------------|------|----|----------|--------|----------------|------|----------|------|----------------------------|---------------|-----------|--|
| NO.       | DESCRIPTION | DATE | BY | NO. | DESCRIPTION | DATE | BY | FILE NO. | 2414   | DESIGNED       | DATE | DESIGNED | DATE | 6060 McKee Road            | Fitchburg, WI | A-5       |  |
| 1         |             |      |    | 1   |             |      |    | FILE NO. | 2414   | DESIGNED       | DATE | DESIGNED | DATE | 6060 McKee Road            | Fitchburg, WI |           |  |
| 2         |             |      |    | 2   |             |      |    | DATE     | JAB:1  | REVIEW         | DATE | REVIEW   | DATE |                            |               |           |  |
| 3         |             |      |    | 3   |             |      |    | SCALE    | 2.1.89 |                |      |          |      |                            |               |           |  |
| 4         |             |      |    | 4   |             |      |    |          | BBP:40 |                |      |          |      |                            |               |           |  |
| 5         |             |      |    | 5   |             |      |    |          |        |                |      |          |      |                            |               |           |  |

| ROOM FINISH SCHEDULE |                      |                |                 |                                  |                    |                    |             |                      |        |   |
|----------------------|----------------------|----------------|-----------------|----------------------------------|--------------------|--------------------|-------------|----------------------|--------|---|
| NO.                  | ROOM NAME            | FLOOR MATERIAL | BASE MATERIAL   | WALL MATERIAL/FINISH             |                    |                    |             | CEILING              |        | REMARKS                                 |
|                      |                      |                |                 | NORTH                            | EAST               | SOUTH              | WEST        | MATERIAL             | HEIGHT |   |
| 10                   | RECEPTION            | SLATE          | SLATE           | G.B./VINYL                       | G.B./VINYL         | G.B./VINYL         | G.B./VINYL  | A.C.P.               | 8'-0"  | PAINT GYP BD C.O                        |
| 11                   | TOILET               | CERAMIC TILE   | 4" CERAMIC TILE |                                  |                    |                    |             | C.A.C.T.             |        |   |
| 12                   | CUSTOMER SERVICE     | CARPET - 1     | 4" VINYL        |                                  |                    |                    |             | A.C.P.               |        |   |
| 13                   | BOOKKEEPING          |                |                 |                                  |                    |                    |             |                      |        |   |
| 14                   | OFFICE/COMPUTER      |                |                 |                                  |                    |                    |             |                      |        |   |
| 15                   | CORRIDOR             |                |                 |                                  |                    |                    |             |                      |        |   |
| 16                   | CLOSET               |                |                 | G.B./P.C-5                       | G.B./P.C-5         | G.B./P.C-5         | G.B./P.C-5  |                      |        |   |
| 17                   | CLOSET               |                |                 |                                  |                    |                    |             |                      |        |   |
| 18                   | JANITOR              | CONC. (C-2)    |                 | G.B./P.C-4                       | G.B./P.C-4         | G.B./P.C-4         | G.B./P.C-4  | CONC. PLANK / P.C-4  | 10'-8" |   |
| 19                   | CLOSET               | CARPET - 2     | 4" VINYL        | G.B./P.C-5                       | G.B./P.C-5         | G.B./P.C-5         | G.B./P.C-5  | A.C.P.               | 8'-0"  |   |
| 20                   | CONFERENCE RM        | CARPET - 2     | 4" VINYL        | G.B./VINYL                       | G.B./VINYL         | G.B./VINYL         | G.B./VINYL  | A.C.P.               | 8'-0"  | PAINT GYP BD C.O                        |
| 21                   | METER RM.            | CONC. (C-1)    |                 | G.B./P.C-3*                      | G.B./P.C-3*        | G.B./P.C-3*        | G.B./P.C-3* | CONC. PLANK / P.C-3* | 10'-8" | * ALT. #3                               |
| 22                   | WOMEN                | CONC (C-1)     |                 | G.B./P.C-3                       | G.B./P.C-3         | G.B./P.C-3         | G.B./P.C-3  | C.A.C.T.             | 8'-0"  | WATER RESIST. G.B. C.W. IN SHOWER P.C-5 |
| 23                   | MEN                  |                |                 |                                  |                    |                    |             | C.A.C.T.             | 8'-0"  | WATER RESIST. G.B. C.W. IN SHOWER P.C-5 |
| 24                   | FUTURE OFFICES       | CONC. (C-2)    |                 | MTL. PANEL                       | G.B./P.C-5         | G.B./P.C-4         | G.B./P.C-4* |                      |        | * ALT. #3                               |
| 25                   | STORAGE              |                |                 |                                  | G.B./P.C-4*        | G.B./P.C-4*        |             |                      |        | * ALT. #3                               |
| 26                   | SHOP & VEHICLE STOR. |                |                 | G.B./P.C-4*                      |                    |                    |             |                      |        | * ALT. #3                               |
| 27                   | TOOL/ WORK RM.       |                |                 |                                  |                    |                    |             | CONC. PLANK / P.C-4  | 8'-8"  | * ALT. #3                               |
| 28                   | DRIVE THRU STOR.     |                |                 | MTL. PANEL                       | MTL. PANEL         |                    |             |                      |        | * ALT. #3                               |
| 29                   | WASH ROOM            |                |                 | G.B./P.C-3                       | G.B./P.C-3         | G.B./P.C-3         | G.B./P.C-3  | CONC. PLANK / P.C-3  | 10'-8" |   |
| 30                   | BREAK ROOM           |                | 4 VINYL         | G.B./P.C-5                       | G.B./P.C-4         | G.B./P.C-4         | G.B./P.C-5  |                      |        |   |
| 100                  | STORAGE              | CONC. (C-2)    |                 | MTL. PANEL / P.M-1<br>G.B./P.C-5 | G.B./P.C-5*        |                    | G.B./P.C-4* |                      |        | * ALT. #3                               |
| 101                  | MECHANICAL EQUIP     |                |                 |                                  |                    | G.B./P.C-5         | G.B./P.C-5  |                      |        |   |
| 102                  | STORAGE              |                |                 | MTL. PANEL / P.M-1               | MTL. PANEL / P.M-1 | MTL. PANEL / P.M-1 | MTL. PANEL  |                      |        |   |
|                      |                      |                |                 |                                  |                    |                    |             |                      |        |   |
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| DOOR & FRAME SCHEDULE |          |                           |      |                     |                 |       |              |               |        |      |             |         |         |              |   |                        |
|-----------------------|----------|---------------------------|------|---------------------|-----------------|-------|--------------|---------------|--------|------|-------------|---------|---------|--------------|---|------------------------|
| DOOR NO.              | ROOM NO. | SIZE                      | DOOR |                     |                 | FRAME |              |               | DETAIL |      | FIRE RATING | LOUVER  | GLAZING | HARDWARE SET | REMARKS                                       |                        |
|                       |          |                           | TYPE | MATERIAL            | FINISH          | TYPE  | MATERIAL     | FINISH        | JAMB   | HEAD |             |         |         |              |   |                        |
| 1                     | 15       | 3' x 7' x 1 3/4"          | B    | SOLID CORE WOOD     | STAIN & VARNISH | A     | HOLLOW METAL | ENAMEL        | 7/6    | 9/6  |             |         |         | S            | B   | 12" x 30" VISION PANEL |
| 2                     | 14       | ↓                         | B    |                     |                 | B     |              |               | 5/6    | 2/6  |             | U.G. 1" | S       | B            | 12" x 30" VISION PANEL                        |                        |
| 3                     | 15       |                           | B    |                     |                 | A     |              |               | 12/6   | 9/6  |             | L 30x10 |         | D            |   |                        |
| 4                     | 16       |                           | B    |                     |                 | A     |              |               | 12/6   | 9/6  |             | L 14x6  |         | E            |   |                        |
| 5                     | 14       | ↓                         | B    |                     |                 | B     |              |               | 5/6    | 2/6  |             | U.G. 1" | S       | B            | 12" x 30" VISION PANEL                        |                        |
| 6                     | 13       | 2' x 7' (1 PAIR)          | C    |                     |                 | A     |              |               | 12/6   | 9/6  |             |         |         | I            |   |                        |
| 7                     | 12       | 2' x 7' (1 PAIR)          | C    |                     |                 | A     |              |               | 12/6   | 9/6  |             |         |         | I            |   |                        |
| 8                     | 12       | 3' x 7' x 1 3/4"          | B    |                     |                 | B     |              |               | 5/6    | 2/6  |             |         | S       | B            | 12" x 30" VISION PANEL                        |                        |
| 9                     | 20       | 3' x 7' x 1 3/4"          | B    |                     |                 | A     |              |               | 12/6   | 9/6  |             | U.G. 1" |         | B            |   |                        |
| 10                    | 10       | 3' x 7' x 1 3/4"          | B    |                     |                 | B     |              |               | 5/6    | 2/6  |             | U.G. 1" | S       | B            | 12" x 30" VISION PANEL                        |                        |
| 11                    | 11       | 3' x 7' x 1 3/4"          | B    | ↓                   | ↓               | B     | ↓            | ↓             | 5/6    | 2/6  |             | L 14x6  |         | C            |   |                        |
| 12                    | 10       | 3' x 7' x 1 3/4"          | A    | ALUM.               | BRS. ANODIZED   | C     | ALUM.        | BRS. ANODIZED | —      | —    |             |         | IS      | A            |   |                        |
| 13                    | 20       | 2' x 7'                   | C    | SOLID CORE WOOD     | STAIN & VARNISH | A     | HOLLOW METAL | ENAMEL        | 5/6    | 2/6  |             |         |         | I            |   |                        |
| 14                    | 20       | 3' x 7' x 1 3/4"          | B    | INSUL. HOLLOW METAL | ENAMEL          | A     | HOLLOW METAL | ENAMEL        | 7/6    | 4/6  |             |         |         | B            |   |                        |
| 15                    | 20       |                           | B    |                     |                 | C     |              |               |        | 1/6  | 10/10       |         | IS      | H            | FIXED PANEL ABOVE DOOR 12" x 30" VISION PANEL |                        |
| 16                    | 21       |                           | B    | ↓                   | ↓               | A     |              |               |        | 4/6  |             | L 30x24 | S       | F            | 12" x 30" VISION PANEL                        |                        |
| 17                    | 23       |                           | B    | SOLID CORE WOOD     | STAIN & VARNISH | A     |              |               |        |      |             | L 30x10 |         | D            |   |                        |
| 18                    | 25       | ↓                         | B    | INSUL. HOLLOW METAL | ENAMEL          | A     |              |               |        |      |             |         | S       | F (W.S.)     | 12" x 30" VISION PANEL                        |                        |
| 19                    | 25       | 2' x 7' x 1 3/4" (1 PAIR) | B    | INSUL. HOLLOW METAL |                 | C     |              |               |        | 1/6  |             |         | S       | G (W.S.)     | 12" x 30" VISION PANEL (ACTIVE LEAF)          |                        |
| 20                    | 27       | 2' x 7' x 1 3/4" (1 PAIR) | B    | HOLLOW METAL        |                 | C     |              |               |        | ↓    |             |         |         | G            |   |                        |
| 21                    | 28       | 3' x 7' x 1 3/4"          | B    | INSUL. HOLLOW METAL | ↓               | C     | ↓            | ↓             | ↓      | 1/6  | 10/10       |         | IS      | H            | FIXED PANEL ABOVE DOOR 12" x 30" VISION PANEL |                        |
| 22                    | 28       | 2' x 14"                  | D    | INSUL. METAL        | —               | —     | —            | —             | 5/6    | 11/6 |             |         |         |              |   |                        |
| 23                    | 28       |                           | D    |                     | —               | —     | —            | —             |        |      |             |         |         |              |   |                        |
| 24                    | 26       |                           | D    | ↓                   | —               | —     | —            | —             |        |      |             |         |         |              |   |                        |
| 25                    | 26       | ↓                         | D    | ↓                   | —               | —     | —            | —             | ↓      |      |             |         |         |              |   |                        |
| 26                    | 26       | 3' x 7' x 1 3/4"          | B    | INSUL. HOLLOW METAL | ENAMEL          | C     | HOLLOW METAL | ENAMEL        | 7/6    | 1/6  | 10/10       |         | IS      | H            | FIXED PANEL ABOVE DOOR 12" x 30" VISION PANEL |                        |
| 27                    | 101      | 3' x 7' x 1 3/4"          | B    | HOLLOW METAL        |                 | B     |              |               | 5/6    | 2/6  |             |         |         | B            |   |                        |
| 28                    | 24       | 3' x 7' x 1 3/4"          | B    | INSUL. HOLLOW METAL |                 | C     |              |               |        |      |             |         | IS      | F            | FIXED PANEL ABOVE DOOR 12" x 30" VISION PANEL |                        |
| 29                    | 29       | 3' x 7' x 1 3/4"          | B    | HOLLOW METAL        |                 | A     |              |               | 7/6    | 4/6  |             | L 30x24 |         | B            |   |                        |
| 30                    | 27       | 3' x 7' x 1 3/4"          | B    | ↓                   |                 | A     |              |               |        |      |             |         |         | H            | MOUNT BUMPER ON STU. COL.                     |                        |
| 31                    | 100      | 3' x 7' x 1 3/4"          | B    | INSUL. HOLLOW METAL | ↓               | A     | ↓            | ↓             | ↓      | ↓    |             |         |         | B (W.S.)     | MOUNT BUMPER ON DOOR                          |                        |

**LEGEND:**  
 ALUM. - ALUMINUM  
 BRZ. - BRONZE  
 CONC. - CONCRETE  
 A.C.P. - ACOUSTICAL PANEL  
 C.A.C.T. - CERAMIC ACOUSTICAL TILE  
 G.B. - GYPSUM BOARD  
 MTL. - METAL  
 P - PAINT  
 C - COATING (SEE SPEC.)  
 M - METAL COATING (SEE SPEC.)  
 S - SAFETY GLASS  
 IS - INSULATED SAFETY GLASS

**DOOR TYPES**  
 A STOREFRONT  
 B FLUSH  
 C BI-FOLD (1 PAIR SHOWN)  
 D OVERHEAD

**DOOR FRAME TYPES**  
 A  
 B  
 C

**BY-PASS GLASS DET.**  
 N.T.S.

**STOREFRONT HEAD/SILL**  
 1/2" = 1'-0"

**1 HEAD DETAIL**  
 1/2" = 1'-0"  
 C.M.U. LINTEL (SEE STRUCTURAL)  
 SEALANT BOTH SIDES  
 HOLLOW METAL FRAME GROUT SOLID

**2 HEAD DETAIL**  
 1/2" = 1'-0"  
 3/8" STL. STUD WALL W/ 5/8" GYP. BD. EX. SIDE  
 HOLLOW METAL FRAME

**3 HEAD DETAIL**  
 1/2" = 1'-0"  
 4" CONC. BLOCK  
 VINYL FLASHING  
 WEAP HOLES 32" O.C. (2 MIN.)  
 C.M.U. LINTEL (SEE STRUCTURAL)  
 SEALANT  
 ALUM. FRAME WINDOW

**4 HEAD DETAIL**  
 1/2" = 1'-0"  
 C.M.U. LINTEL (SEE STRUCTURAL)  
 SEALANT BOTH SIDES  
 HOLLOW METAL FRAME GROUT SOLID

**5 JAMB DETAIL**  
 1/2" = 1'-0"  
 3/8" STL. STUD WALL W/ 5/8" GYP. BD. EX. SIDE  
 DOUBLE STUD @ JAMB  
 HOLLOW METAL FRAME W/ JAMB ANCHOR CLIPS

**6 SILL DETAIL**  
 1/2" = 1'-0"  
 PLASTIC LAM. ON 3/4" PARTICLE BOARD SILL  
 ALUM. FRAME WINDOW  
 SEALANT  
 PRECAST CONC. SILL W/ DRAIN  
 FLURRED WALL: 3/8" STL. STUDS R-11 EXST INSUL 4 MIL V.B. 5/8" GYP. BD  
 C.M.U. WALL

**7 JAMB DETAIL**  
 1/2" = 1'-0"  
 C.M.U. WALL  
 FRAME ANCHOR (3 PER JAMB)  
 SEALANT BOTH SIDES  
 HOLLOW METAL FRAME GROUT SOLID

**8 JAMB DETAIL**  
 1/2" = 1'-0"  
 GROUT JAMB SOLID (1 CORE) W/ 2" x 5"  
 CONC. BLOCK WALL (FLR TO 12'-0")  
 4" x 4" x 1/4" STL. ANGLE W/ 6" MASONRY ANCHORS @ 24" O.C. VERT. PAINT TO MATCH BLOCK  
 OVERHEAD DOOR 3 TRACK INSTALL PER MFG. INSTRUCT. VERIFY LOCATION & ANCHORAGE OF O.H. DOOR HARDWARE  
 FLR TO 12'-0" A.F.F.


**9 HEAD DETAIL**  
 1/2" = 1'-0"  
 C.M.U. LINTEL (SEE STRUCTURAL)  
 7/8" REG. CHANNELS @ 24" O.C. W/ 5/8" GYP. BD.  
 HOLLOW METAL FRAME

**10 SILL DETAIL**  
 1/2" = 1'-0"  
 H.M. DOOR W/ SWEEP  
 ALUM. SILL  
 CONC. FLR. SLAB  
 1/2" x 12" SMOOTH ROD, GREASE ONE END 12" O.C.  
 PERIMETER INSUL.

**11 JAMB DETAIL**  
 1/2" = 1'-0"  
 WALL PANEL AND TRIM (PREFINISHED)  
 STEEL CHANNEL W/ PREPARED MTL. TRIM.  
 NOTE: PAINT ALL EXPOSED METAL  
 4" x 4" x 1/4" STL. ANGLE WELD TO CHANNEL  
 OVERHEAD DOOR 3 TRACK INSTALL PER MFG. INSTRUCT. VERIFY LOCATION AND ANCHORAGE OF O.H. DOOR HARDWARE.

**12 JAMB DETAIL**  
 1/2" = 1'-0"  
 C.M.U. WALL  
 7/8" REG. CHANNELS @ 24" O.C. W/ 5/8" GYP. BD.  
 HOLLOW METAL FRAME W/ 3 ANCHORS PER JAMB  
 FLURRED WALL WHEN SHOWN ON PLAN  
 GLOBE GYP. BD TO C.M.U. WHEN SHOWN ON PLAN



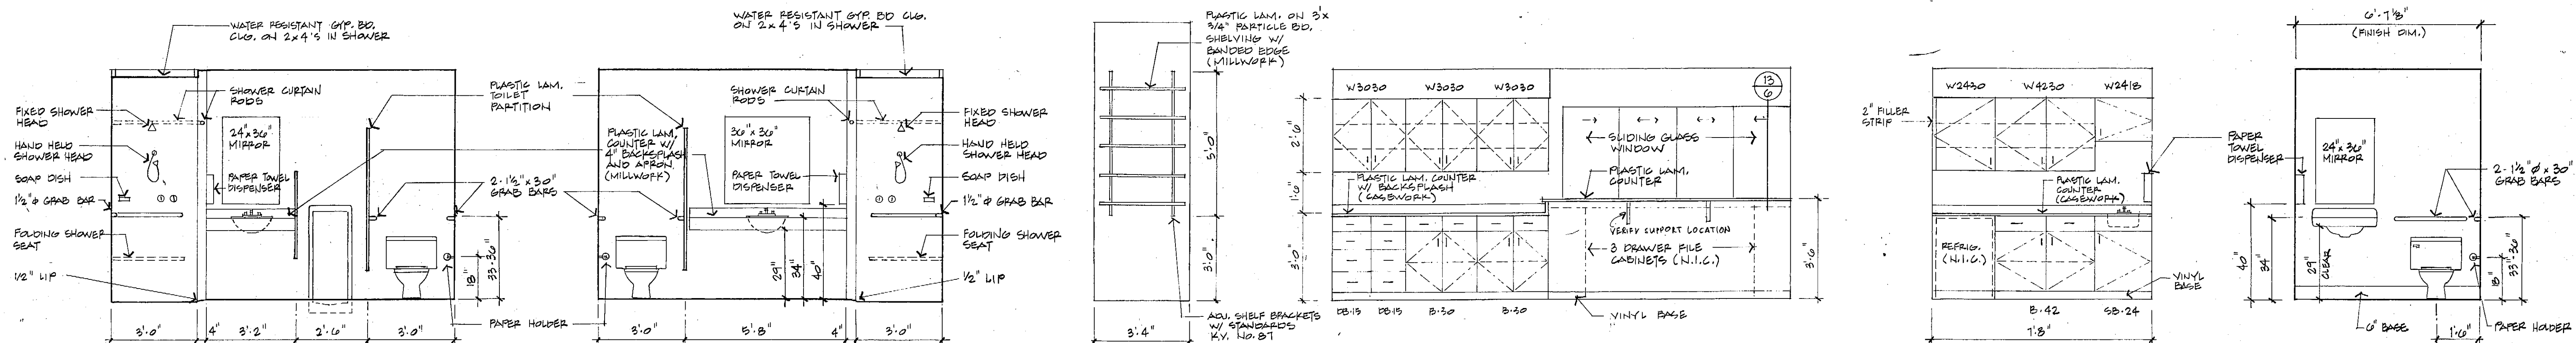

**1 MENS ROOM ELEV.**  
3/8" = 1'-0"


**2 WOMENS ROOM ELEV.**  
3/8" = 1'-0"

**3 JAN. RM.**  
3/8" = 1'-0"


**4 CUSTOMER SERVICE ELEV.**  
3/8" = 1'-0"

**5 CONF. RM. ELEV.**  
3/8" = 1'-0"


**6 TOILET RM. ELEV.**  
3/8" = 1'-0"

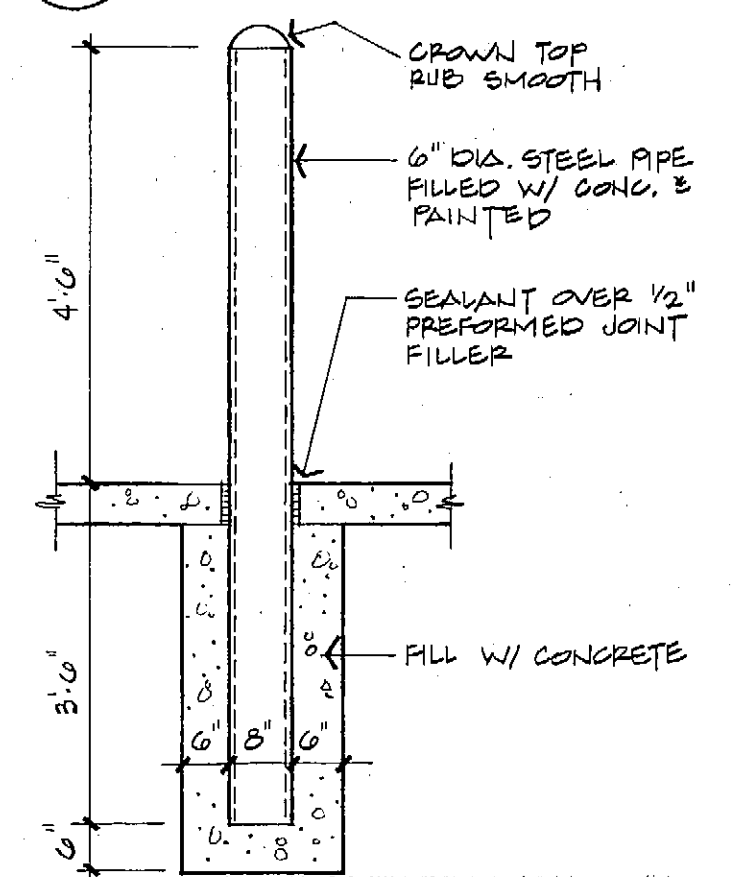


**7 PIPE BOLLARD DET.**  
1/2" = 1'-0"

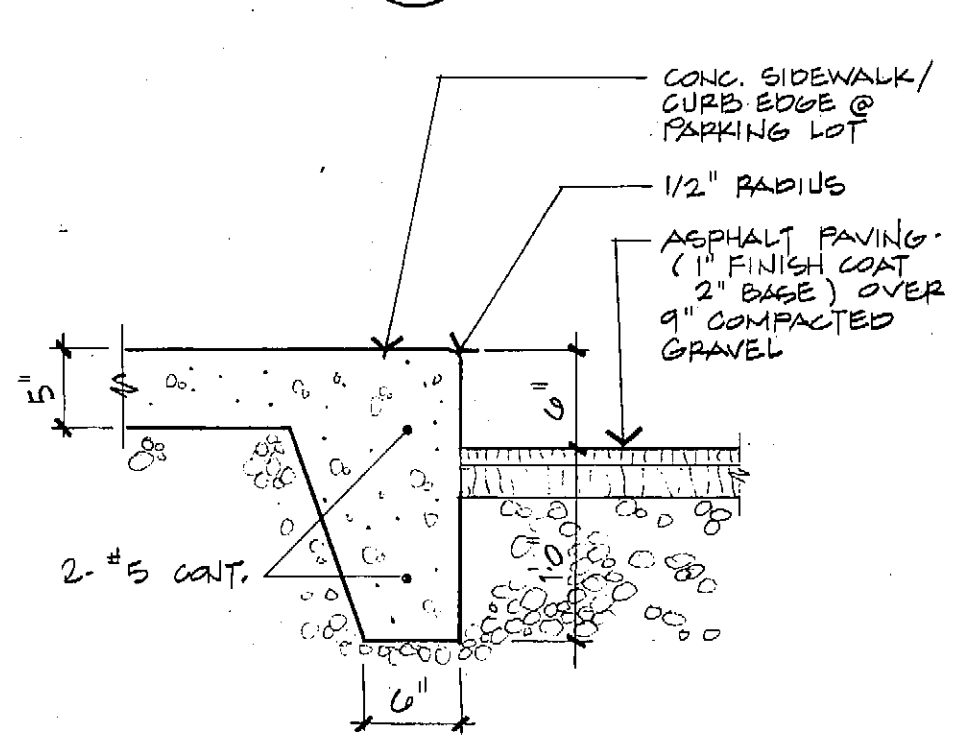


**8 SIDEWALK/CURB DET.**  
1" = 1'-0"

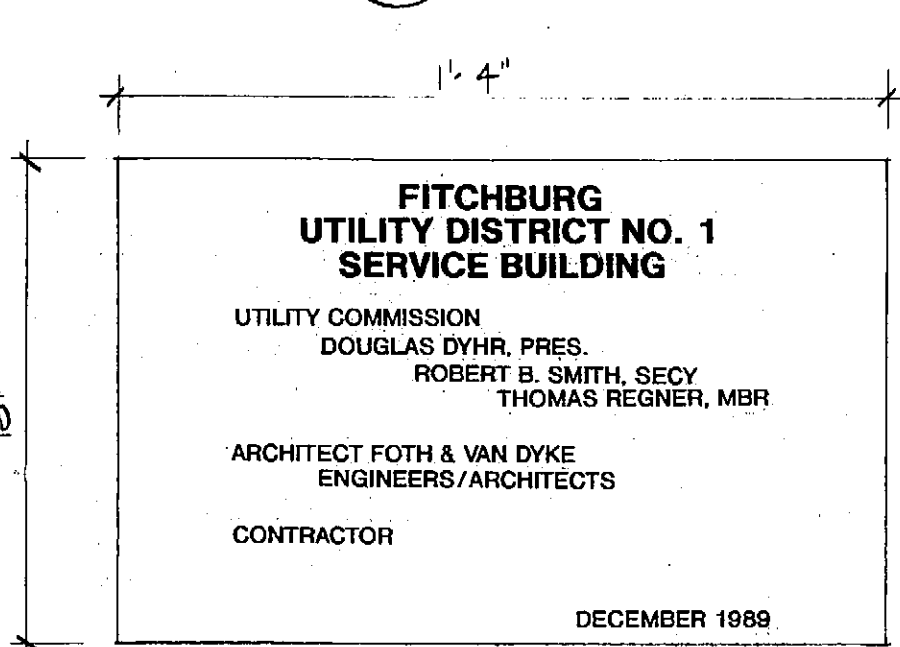


**9 BRONZE PLAQUE**  
3" = 1'-0"

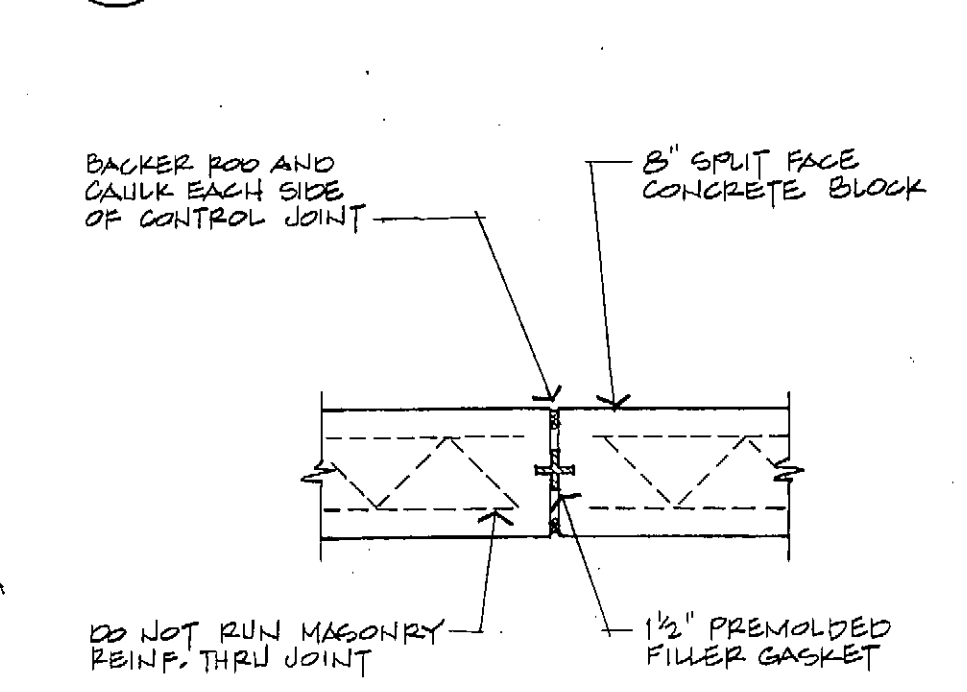


**10 EXPAN. JOINT DET.**  
1/2" = 1'-0"

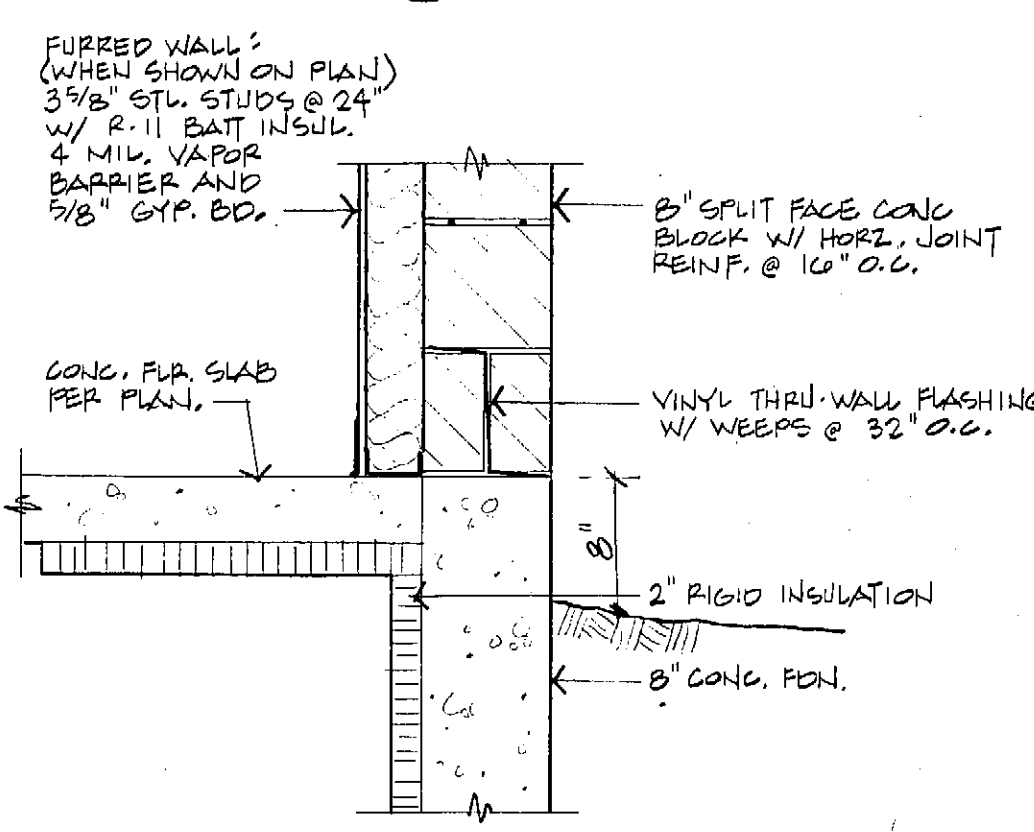


**11 EXT. WALL/FDN. DET.**  
1" = 1'-0"

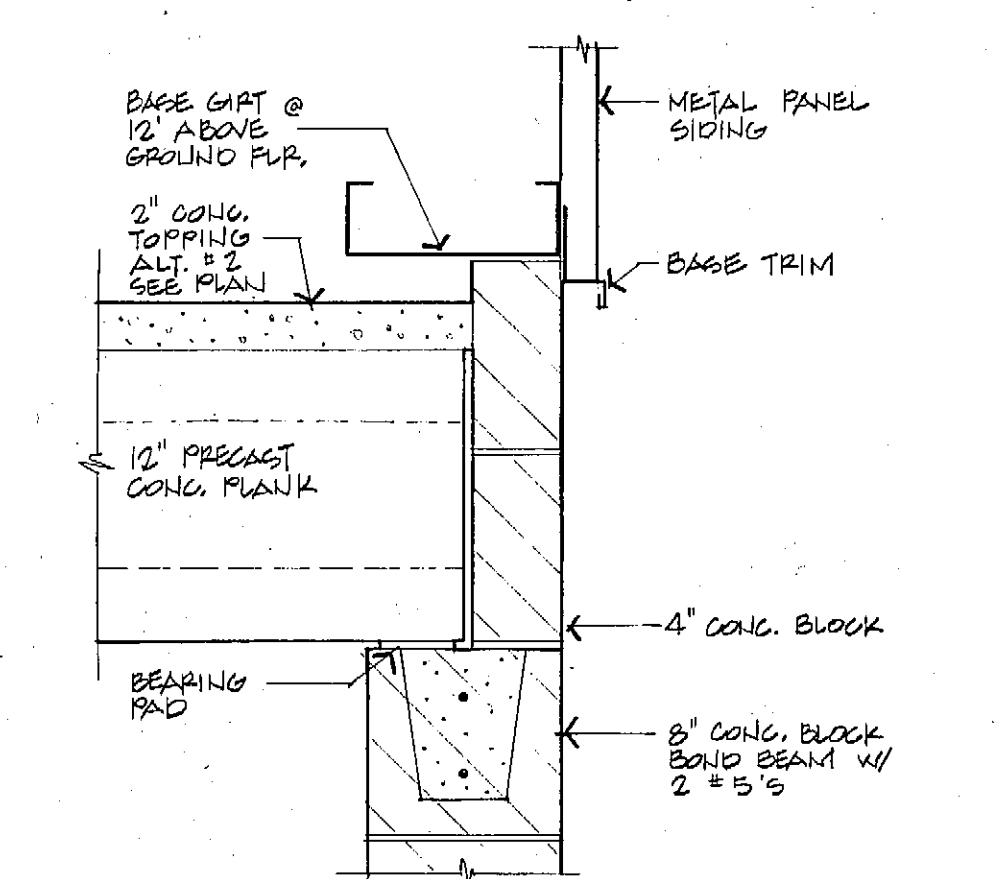


**12 PRECAST @ EXT. WALL**  
1/2" = 1'-0"

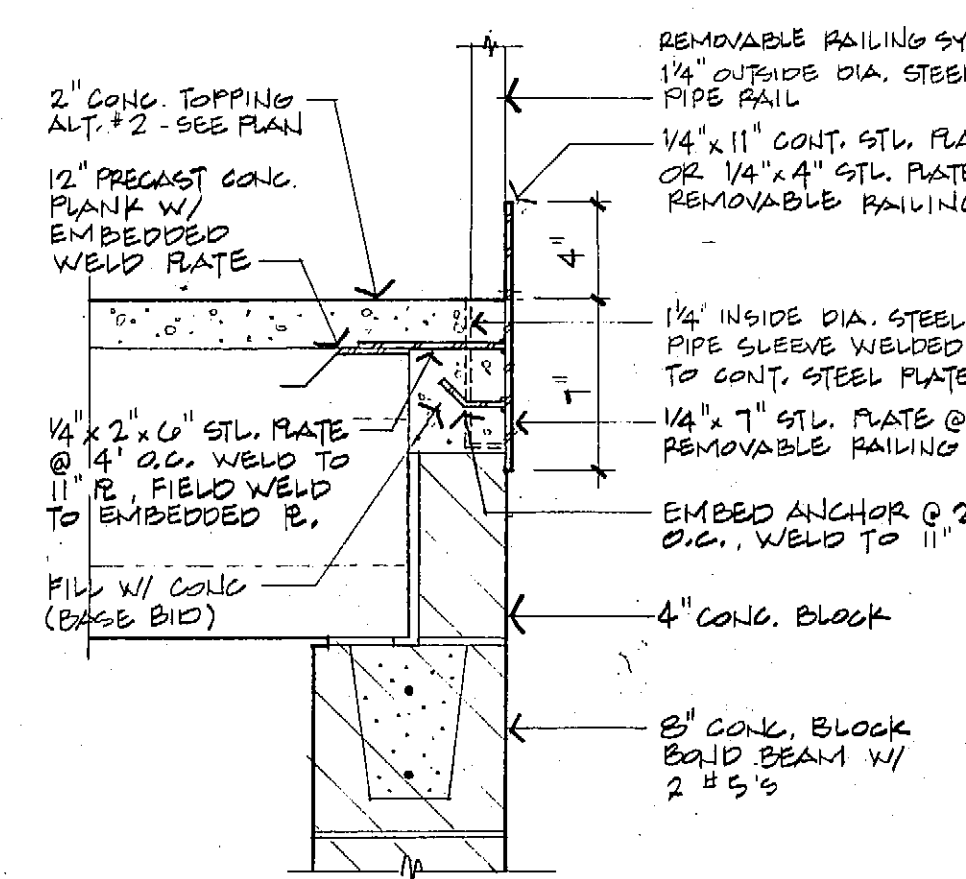


**13 GUARDRAIL @ PRECAST**  
1/2" = 1'-0"

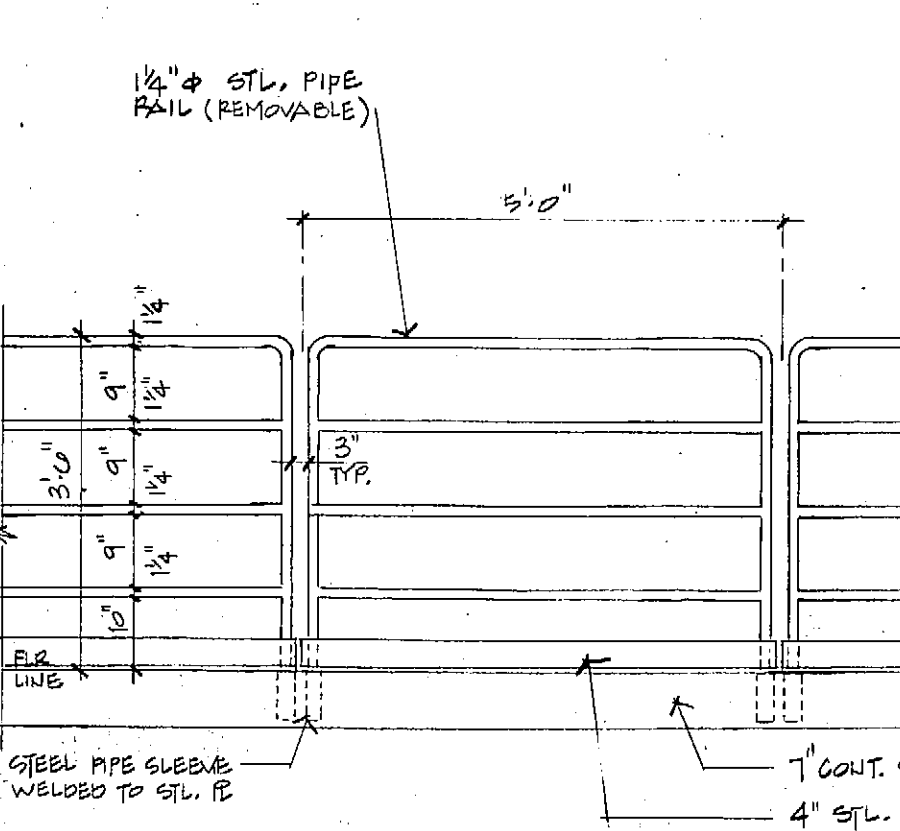


**14 REMOVABLE GUARDRAIL**  
1/2" = 1'-0"

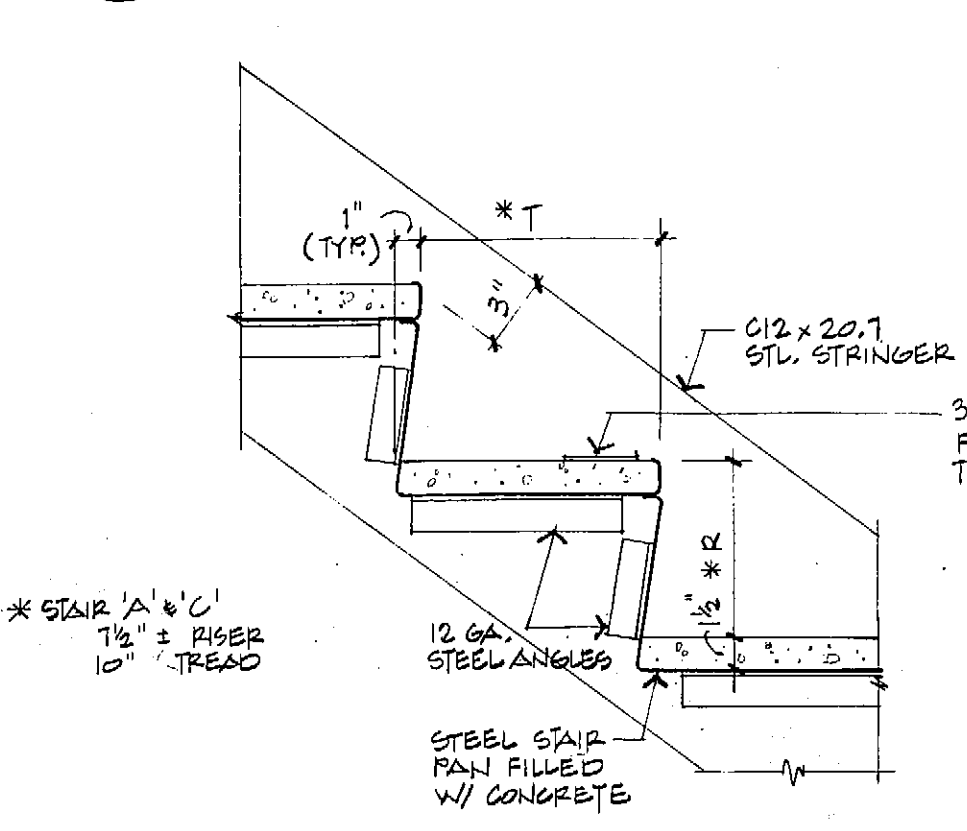


**15 STAIR TREAD/RISER DET.**  
1/2" = 1'-0"

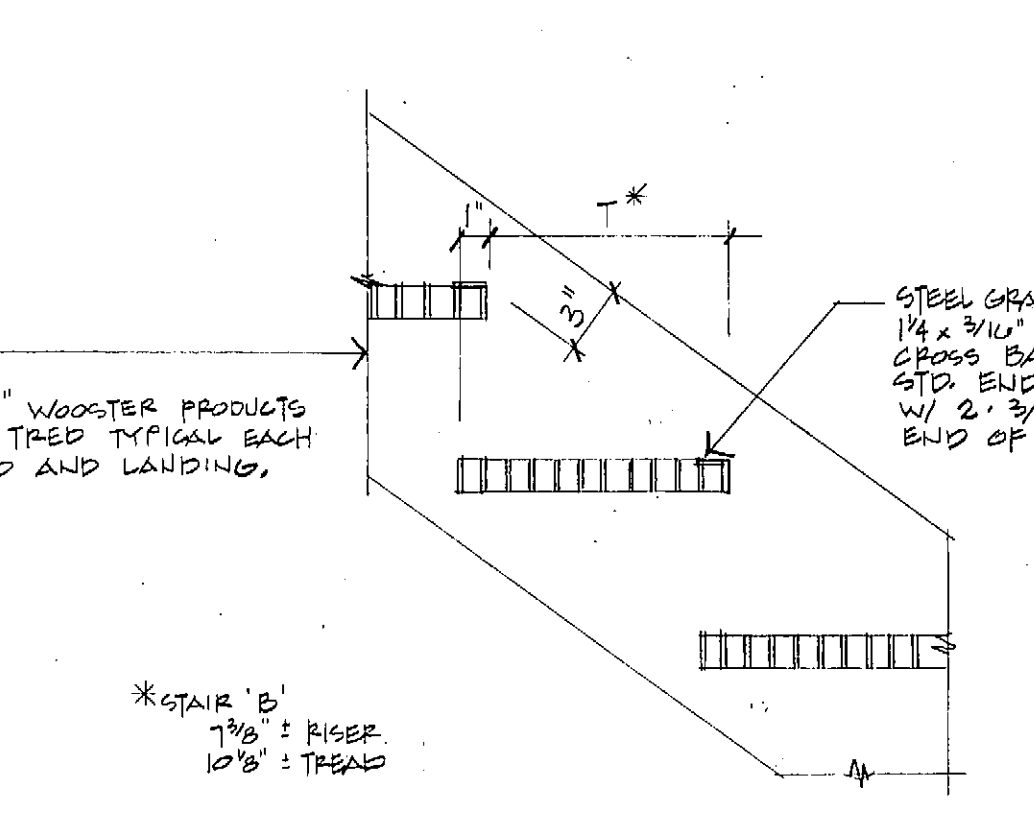

**16 TREAD DETAIL**  
1/2" = 1'-0"

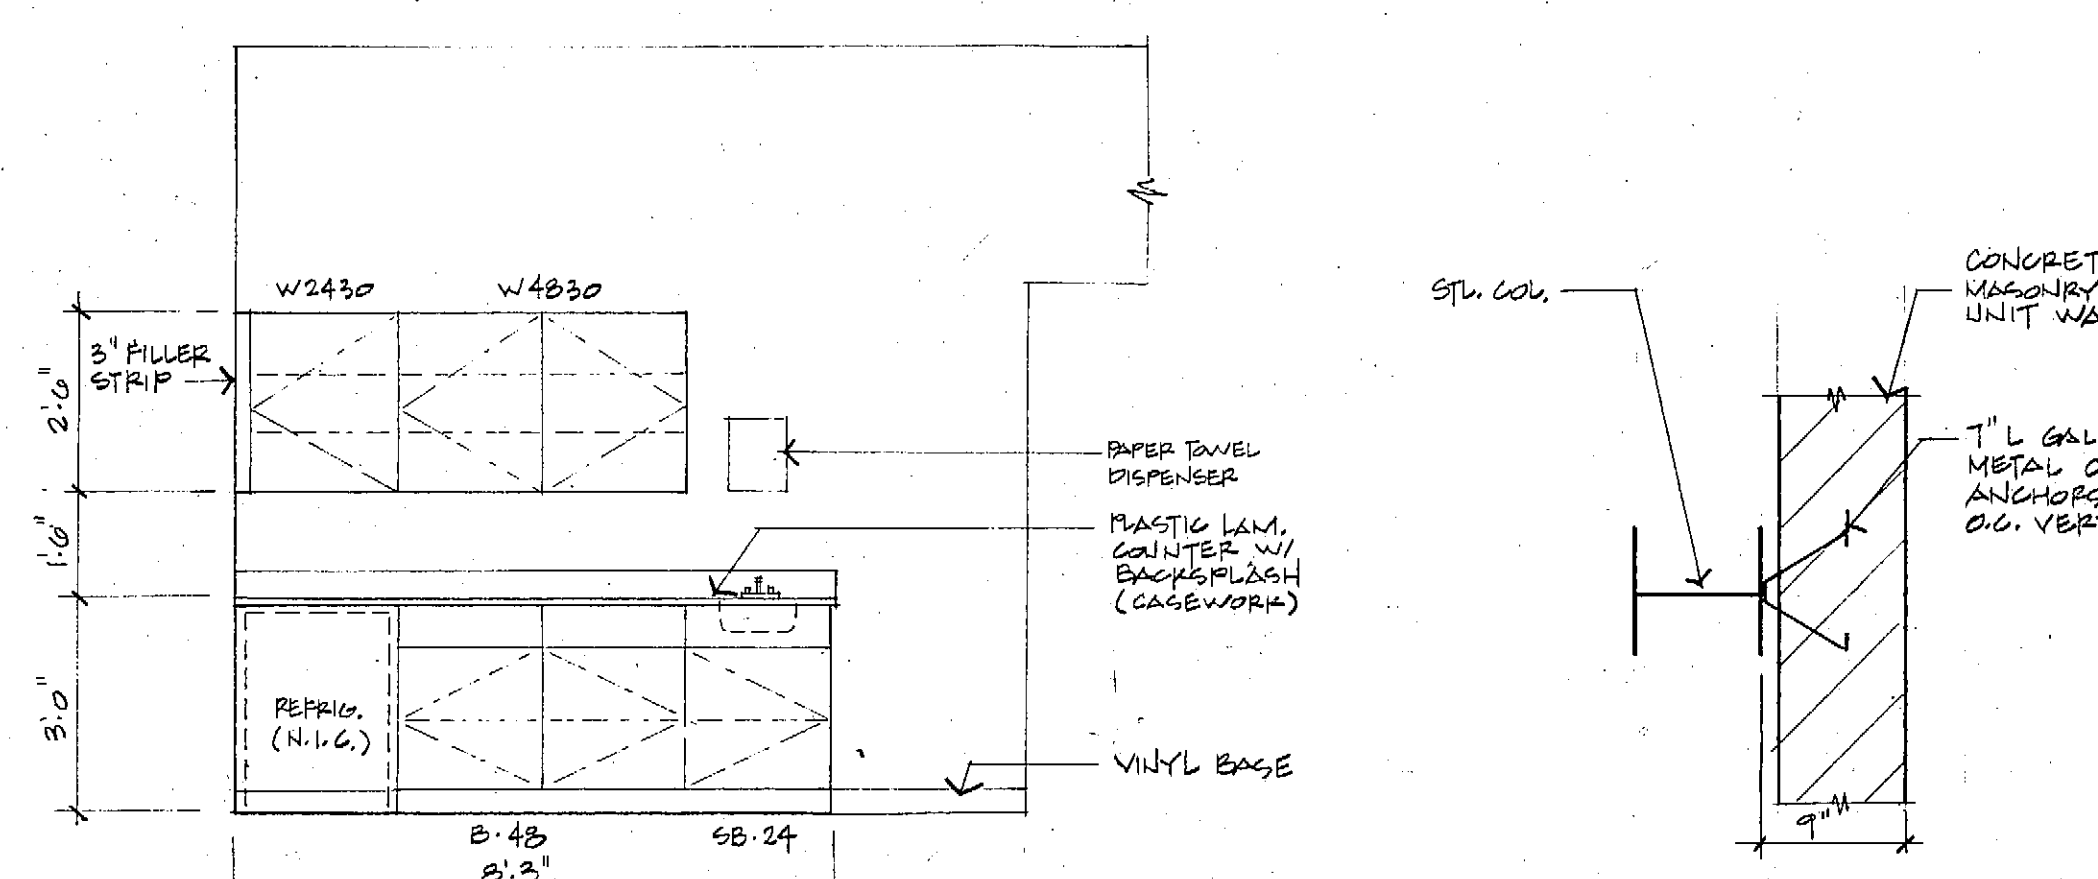



**17 BREAK RM. ELEV.**  
3/8" = 1'-0"

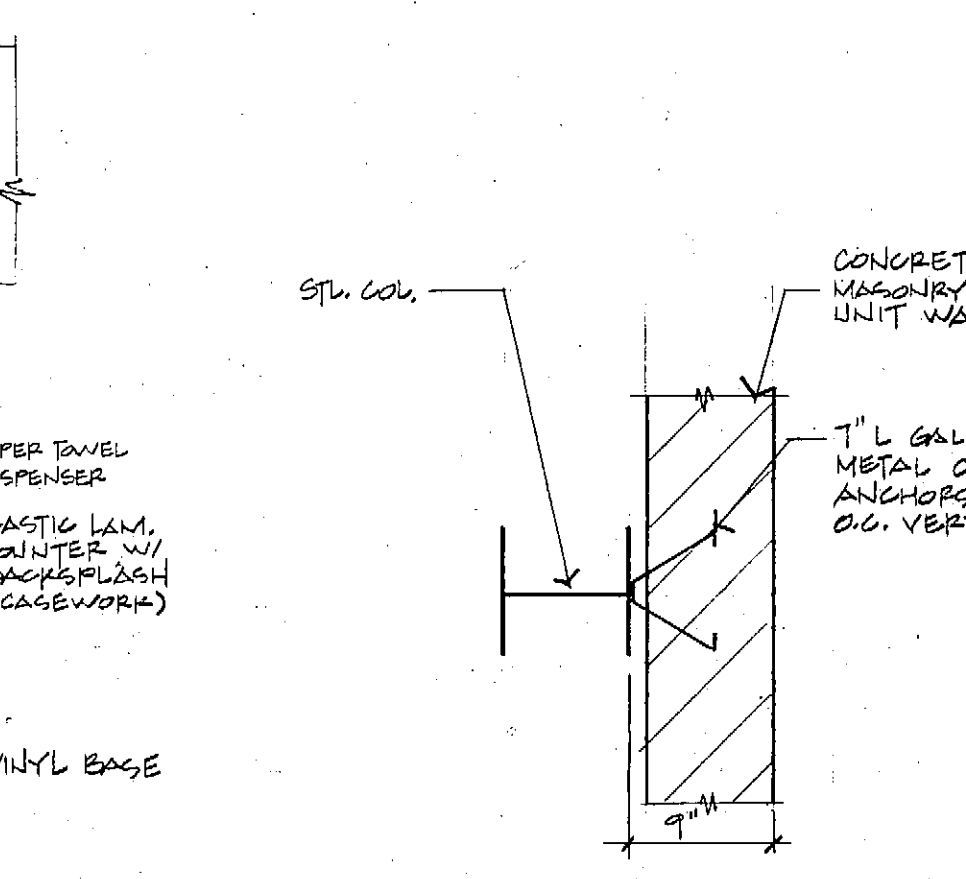

**18 COL/CMU WALL SUPPORT**  
1" = 1'-0"

| REVISIONS |             |      |    |     |             | PROJECT REVIEW |    |          |        | Foth & Van Dyke |        | FITCHBURG UTILITY BUILDING |               | SHEET NO.<br><b>A-7</b> |
|-----------|-------------|------|----|-----|-------------|----------------|----|----------|--------|-----------------|--------|----------------------------|---------------|-------------------------|
| NO.       | DESCRIPTION | DATE | BY | NO. | DESCRIPTION | DATE           | BY | FILE NO. | 24-14  | DESIGNED BY     | JAB-1  | 6060 McKee Road            | Fitchburg, WI |                         |
| 1         |             |      |    | 1   |             |                |    | DATE     | 2-1-89 | DESIGN          | D.O.N. |                            |               |                         |
| 2         |             |      |    | 2   |             |                |    | SCOPE    | 88F40  | REVIEW          | J.A.U. |                            |               |                         |
| 3         |             |      |    | 3   |             |                |    | SCALE    |        | DATE            | 2-3-89 |                            |               |                         |

- 
- Architectural floor plan showing structural details and room layouts. Key annotations include:
- Top Left:** 48" x 12" PRECAST PLANK W/2" CONC. TOPPING - SUPERIMPOSED LIVE LOAD = 125 psf. BEARING BLOCK WALL BELOW. 12" PRECAST CONC. PLANK (TYP.).
  - Top Center:** 3'-8" CONC. BLOCK WALL TO STAIR LANDING. 1/8" STEEL PLATE W/2" CONC. FILL AT STAIR LANDING (TYP.).
  - Center:** 12" PRECAST CONC. PLANK (TYP.). 8" W x 14" D CONC. BEAM W/ 3 #6 BOT., 2 #6 TOP & #3 STIRRUPS @ 1' O.C. PROVIDE SOLID MASONRY BENEATH BEAM BEARING (TYP.) SEE SHEET 3.
  - Bottom Left:** 1/8" STEEL PLATE W/2" CONC. FILL AT STAIR LANDING (TYP.). PROVIDE OPENING FOR 14" Ø DUCT - SEE SHEET H-1 FOR LOCATION.
  - Right Side:** BEARING BLOCK WALL BELOW. 48" x 12" PRECAST PLANK W/2" CONC. TOPPING. SUPERIMPOSED LIVE LOAD = 140 psf. PROVIDE OPENINGS FOR COLUMNS (TYP.).
  - Top Right:** PROVIDE OPENING W/ HEADER FOR 18/24", 14/24" & 18/24" DUCTS - SEE SHEET H-1 FOR LOCATIONS.
  - Dimensions:** 8' 0", 5' 0", 41' 10", 1' 1".
  - Room Numbers:** 12/7, 13/7, 2/5-2, 1/5-2, 12/7.


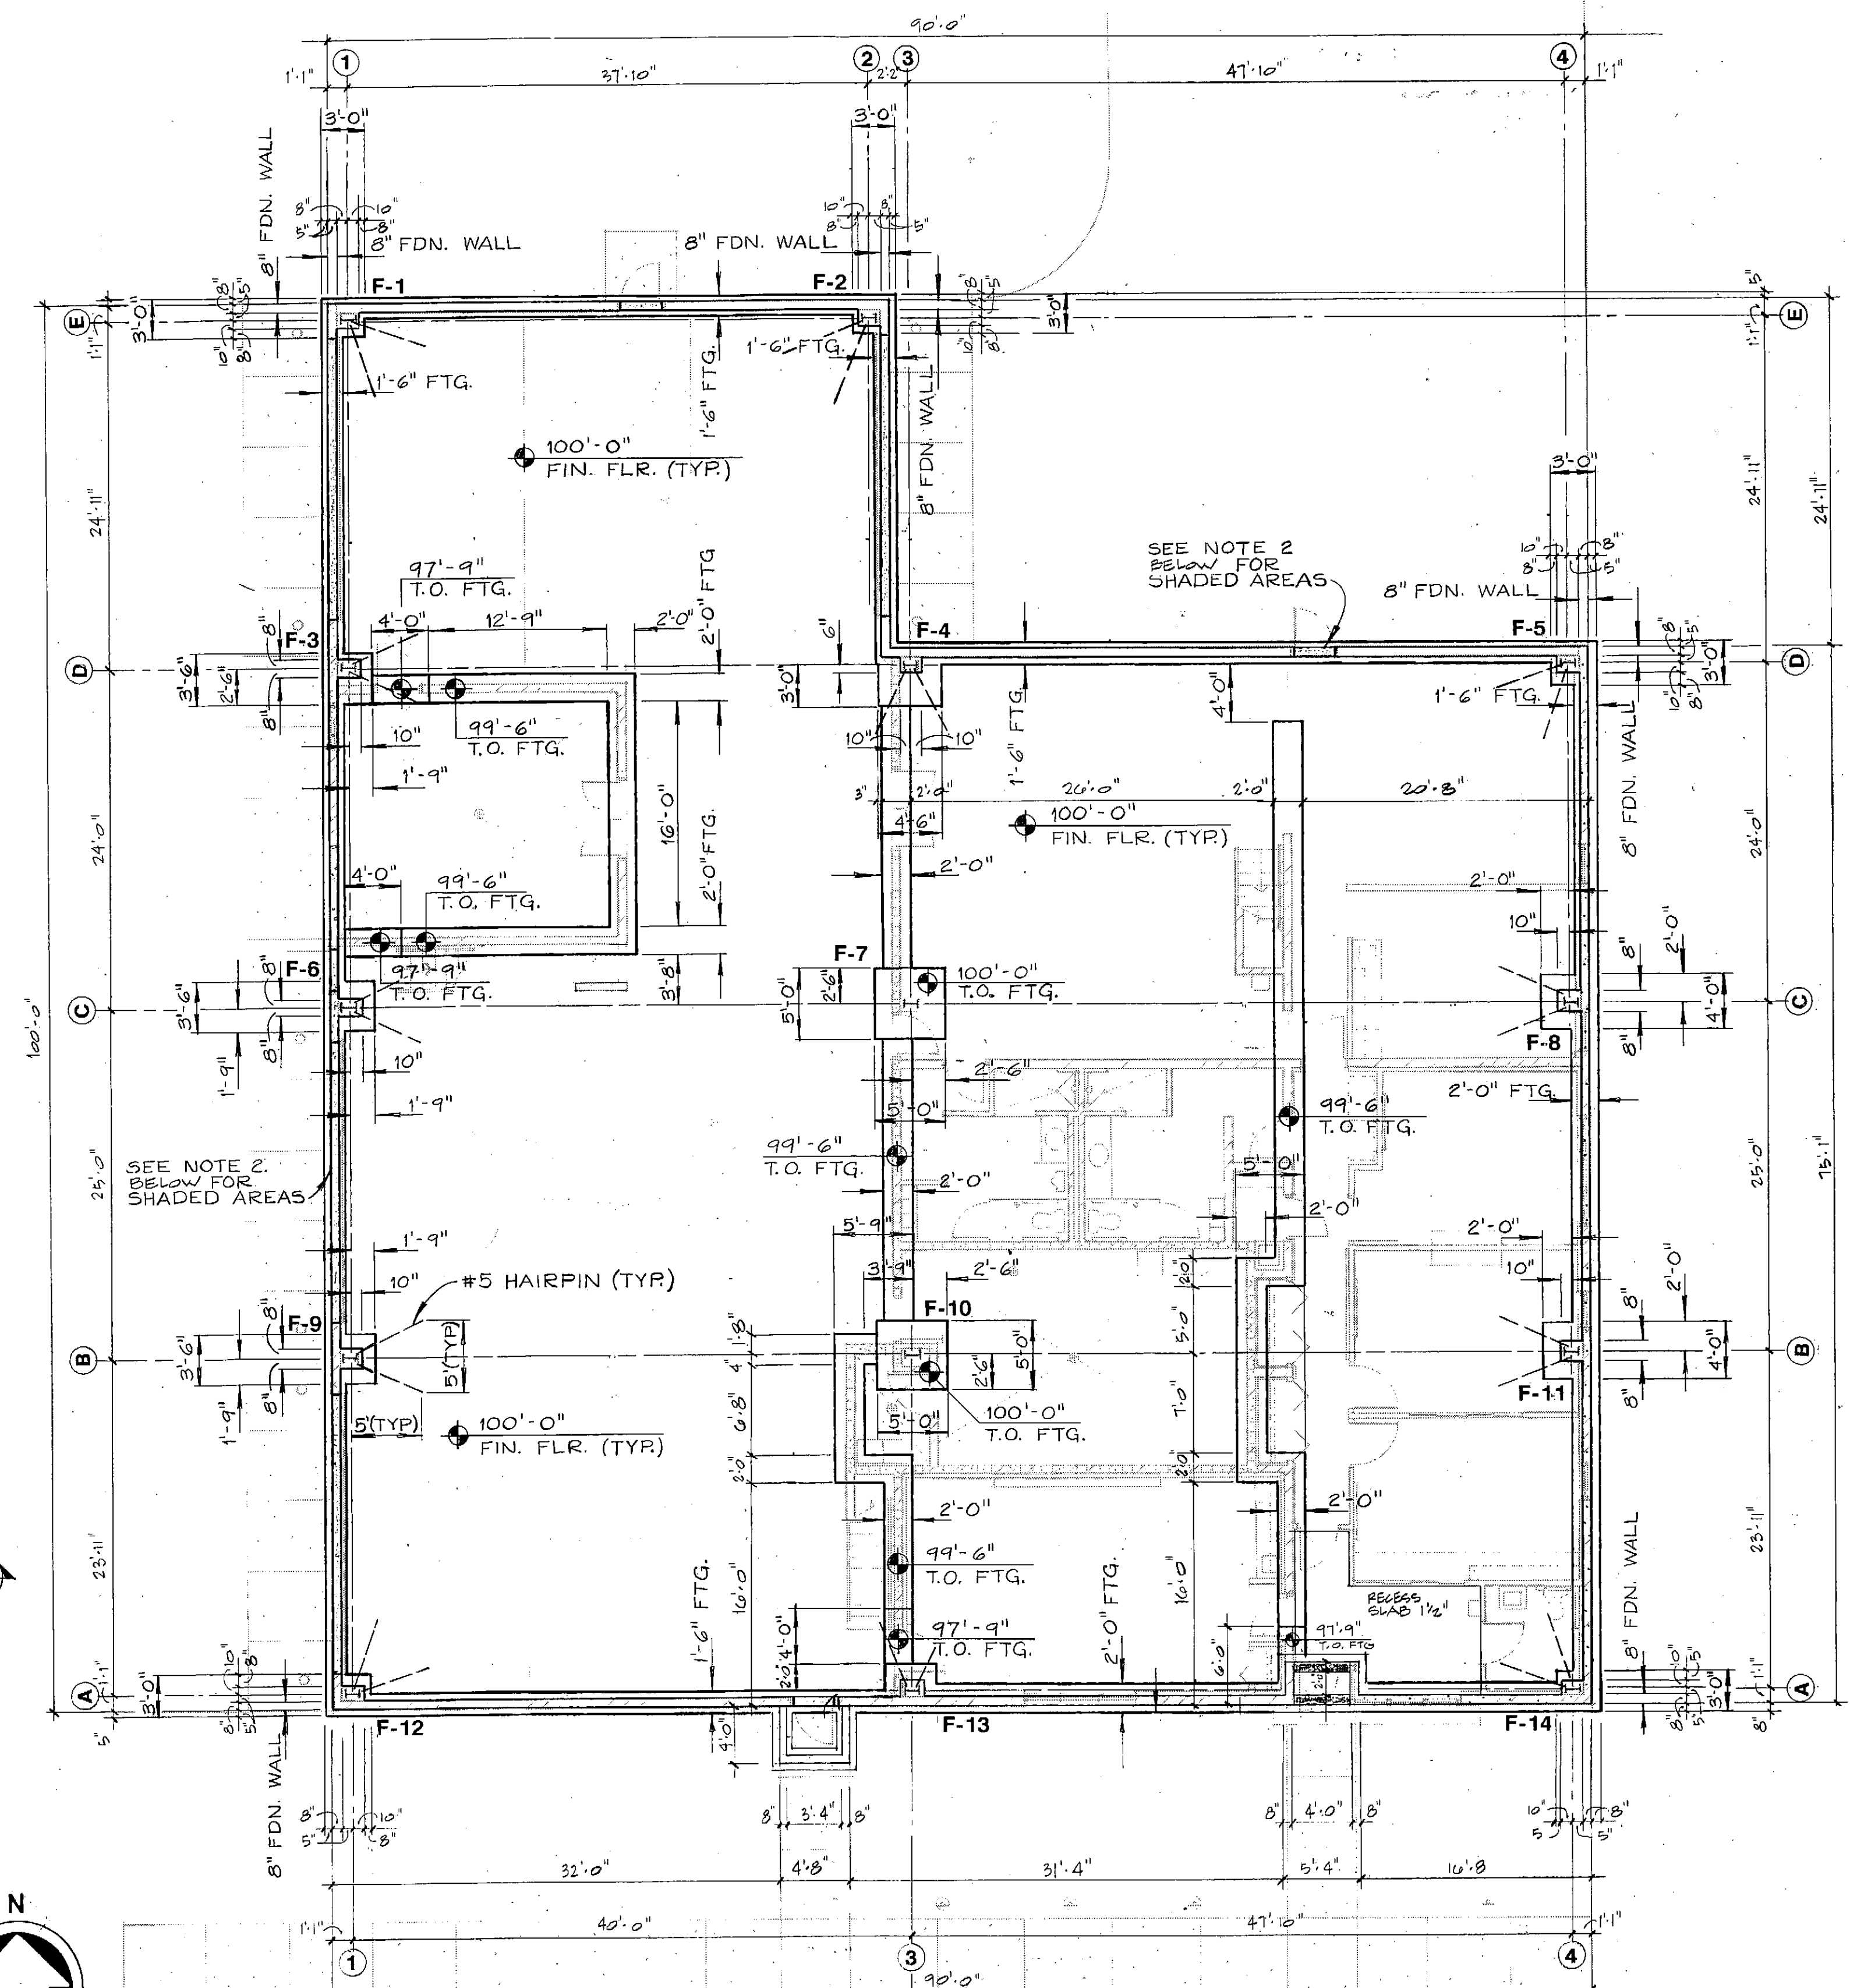
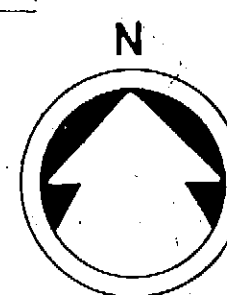
$$1/8'' = 1' - 0''$$

$$1/8'' = 1' - 0''$$

- |           |             |      |    |     |             |      |    |             |        |                |      |        |      |
|-----------|-------------|------|----|-----|-------------|------|----|-------------|--------|----------------|------|--------|------|
| REVISIONS |             |      |    |     |             |      |    | FILE NO.    | 2414   | PROJECT REVIEW |      |        |      |
| NO.       | DESCRIPTION | DATE | BY | NO. | DESCRIPTION | DATE | BY | SURVEYED BY |        |                |      |        |      |
| △         |             |      |    | △   |             |      |    | DRAWN BY    |        |                |      |        |      |
| △         |             |      |    | △   |             |      |    | DATE        | 2-7-89 | DESIGN         | DATE | DESIGN | DATE |
| △         |             |      |    | △   |             |      |    | SCOPE I.D.  | BBF40  | REVIEW         | DATE | REVIEW | DATE |
| △         |             |      |    | △   |             |      |    | SCALE       |        |                |      |        |      |





3-1



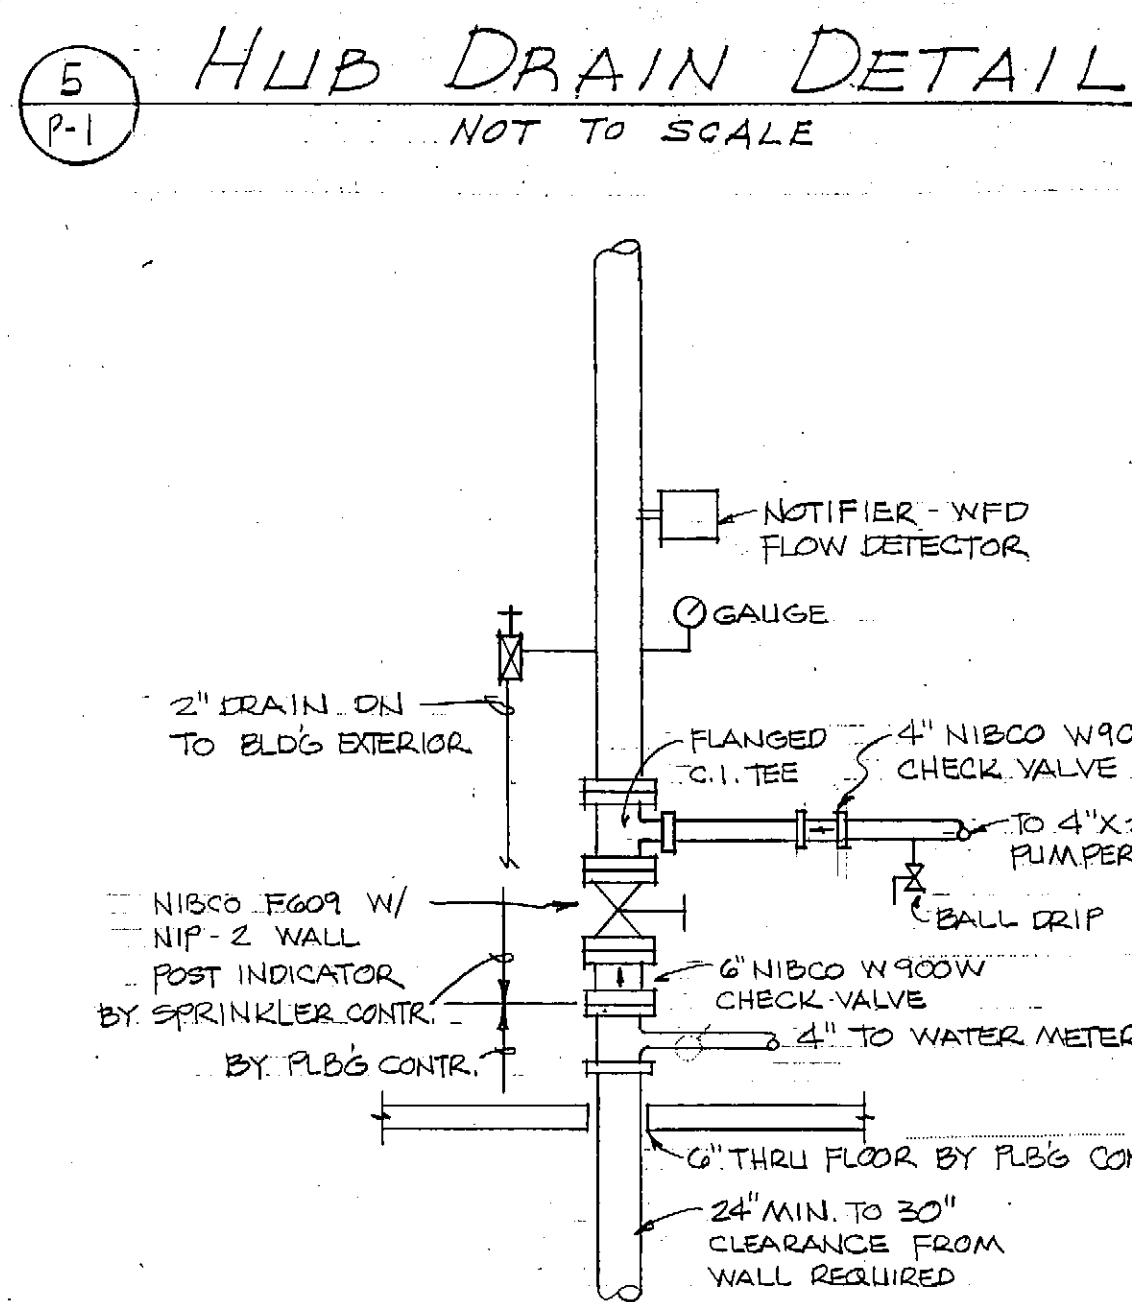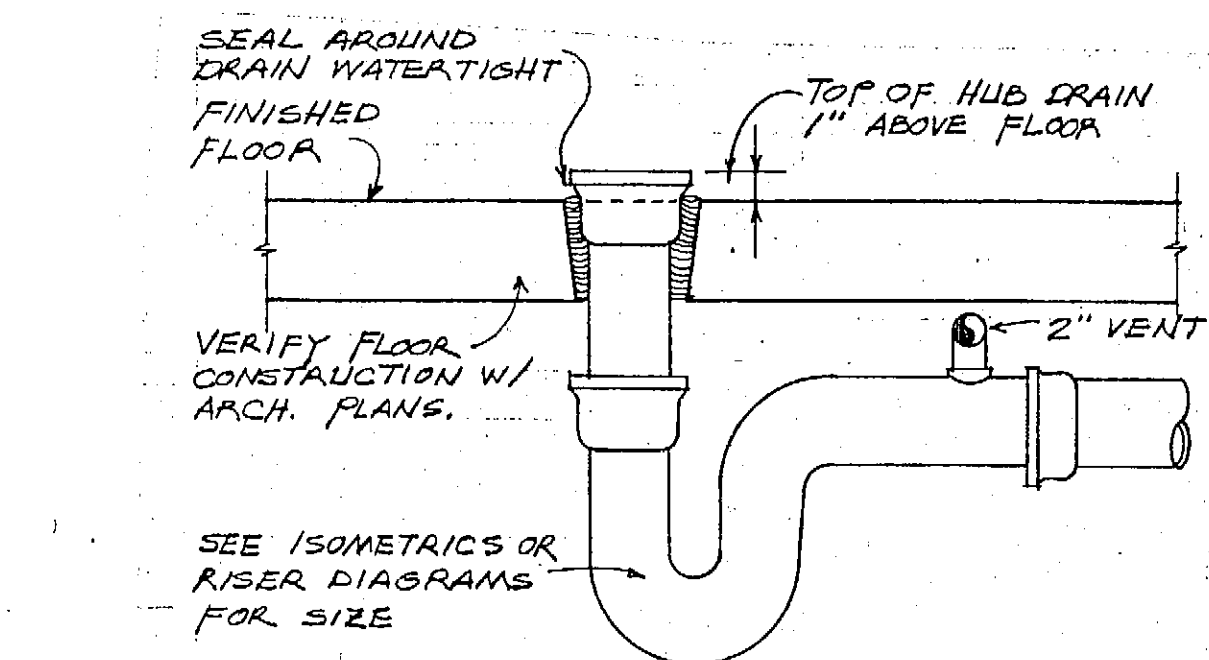
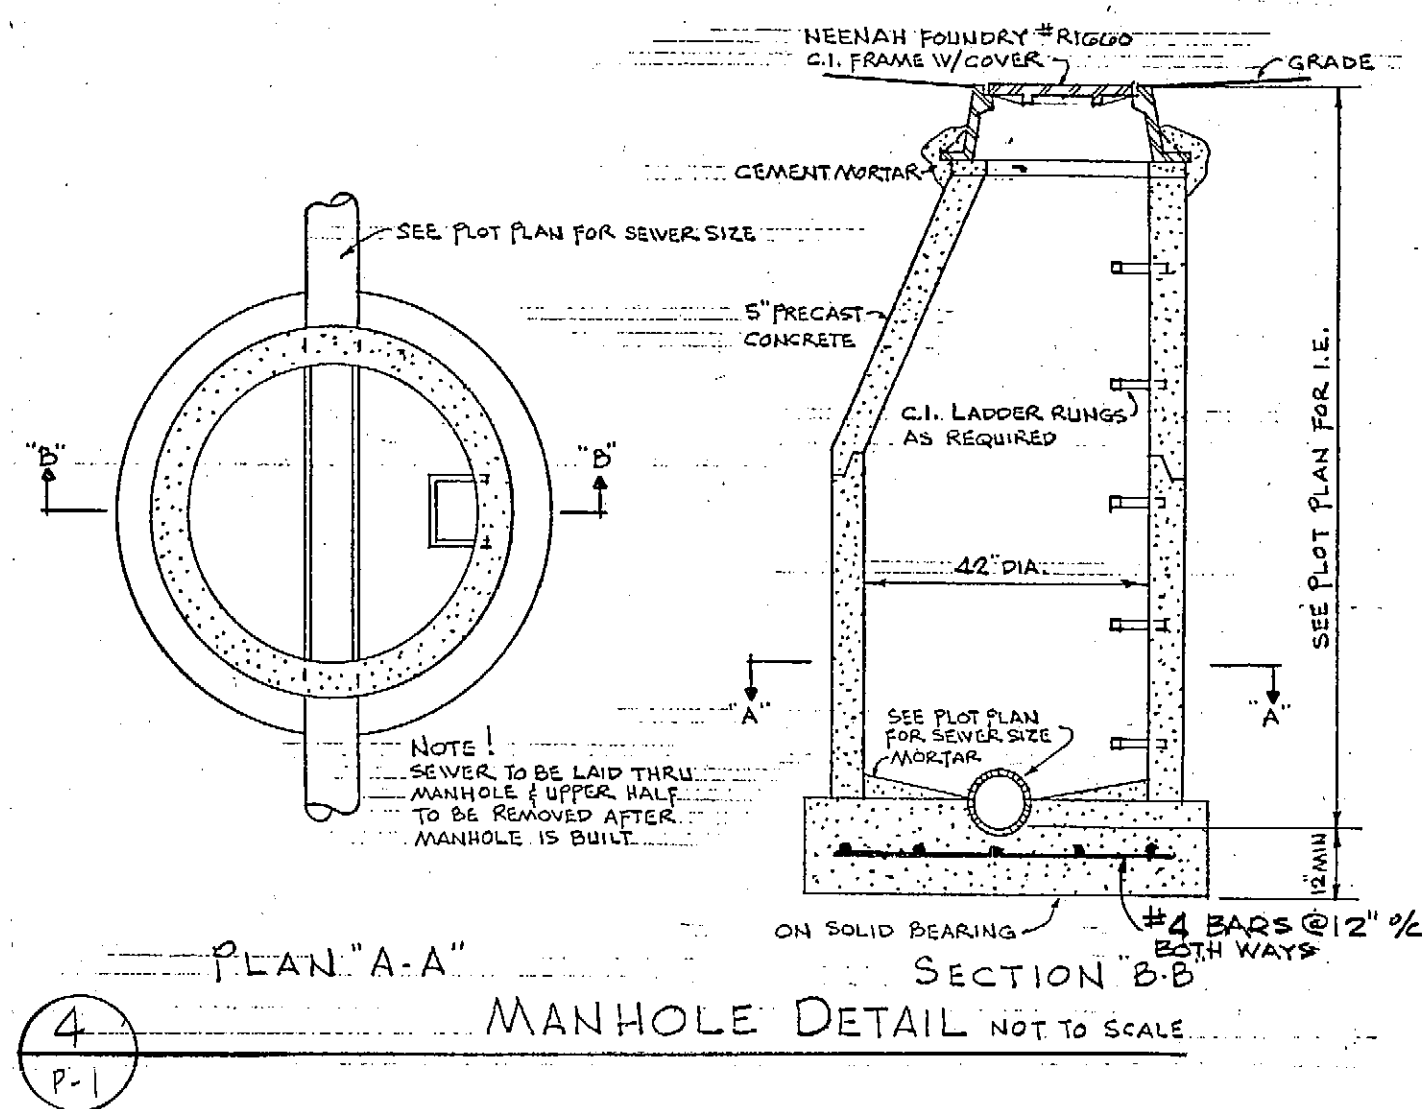




**WATER FLOW DATA**  
 STATIC PRESSURE 63 PSI  
 RESIDUAL PRESSURE 54 PSI @ 1980 GPM  
 20 PSI @ 4600 GPM

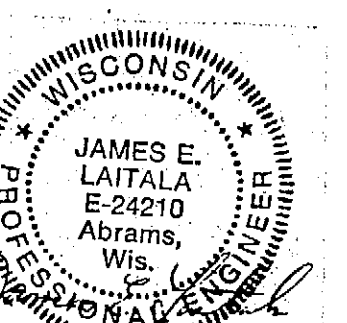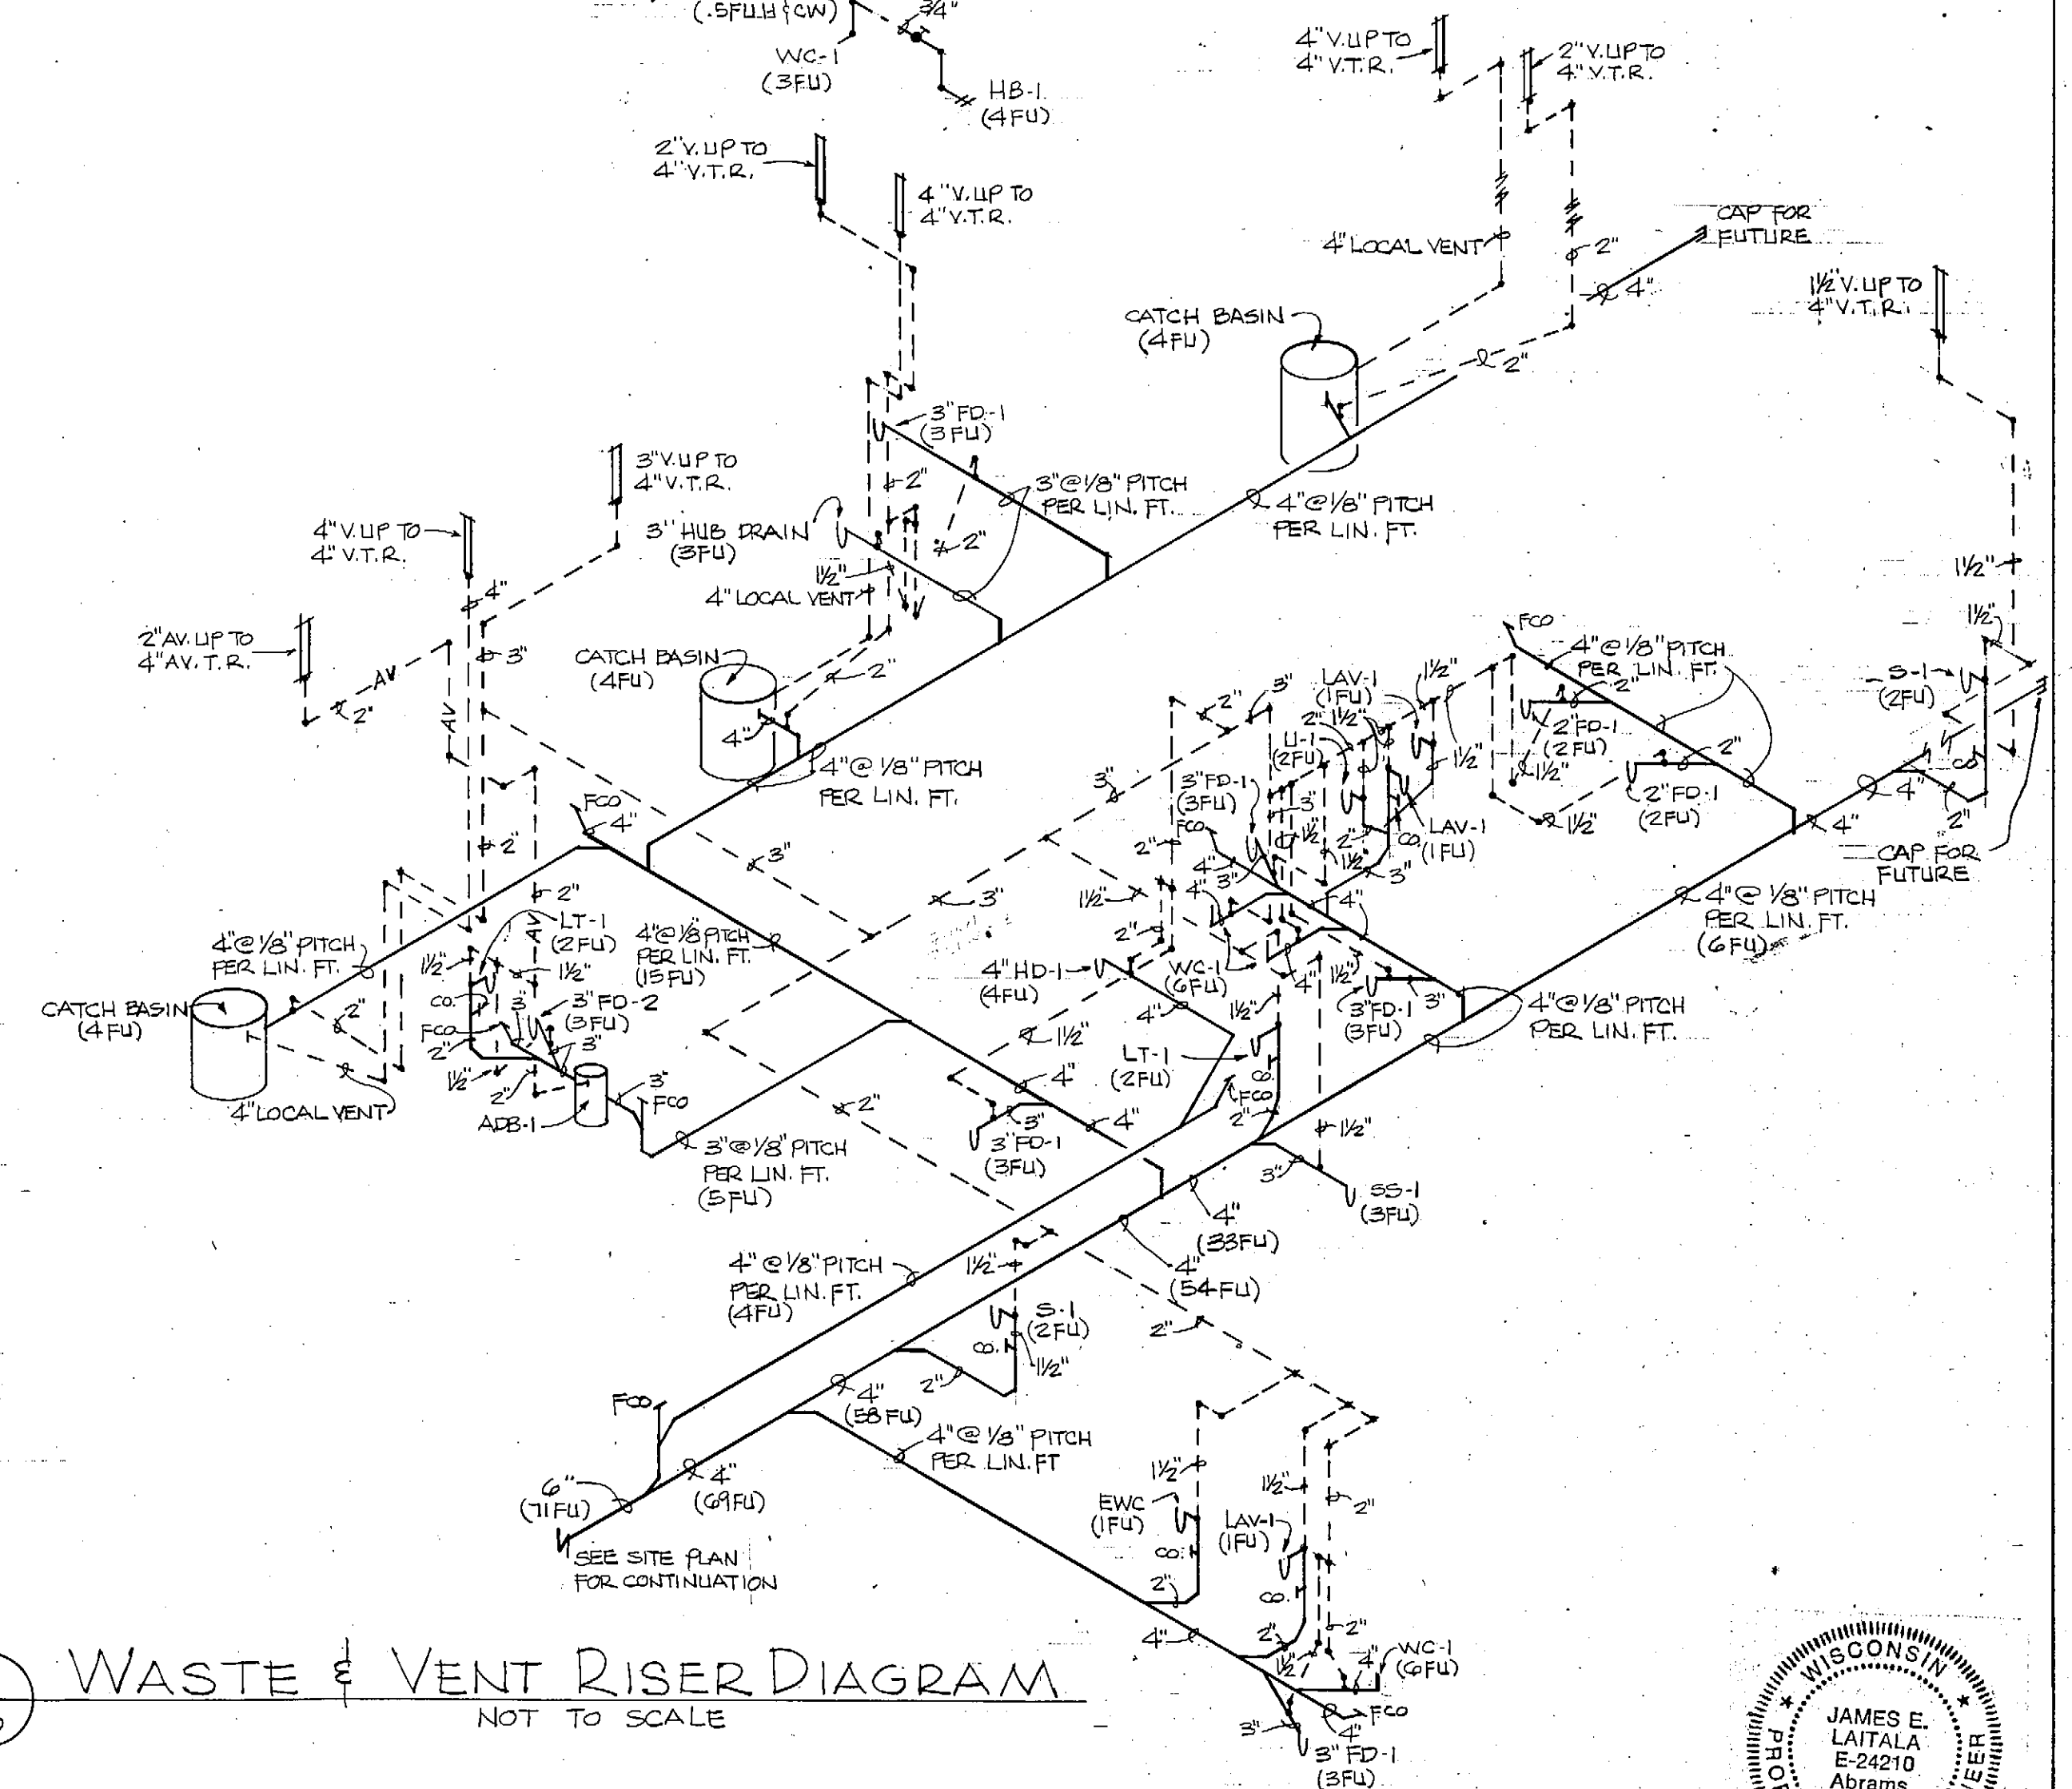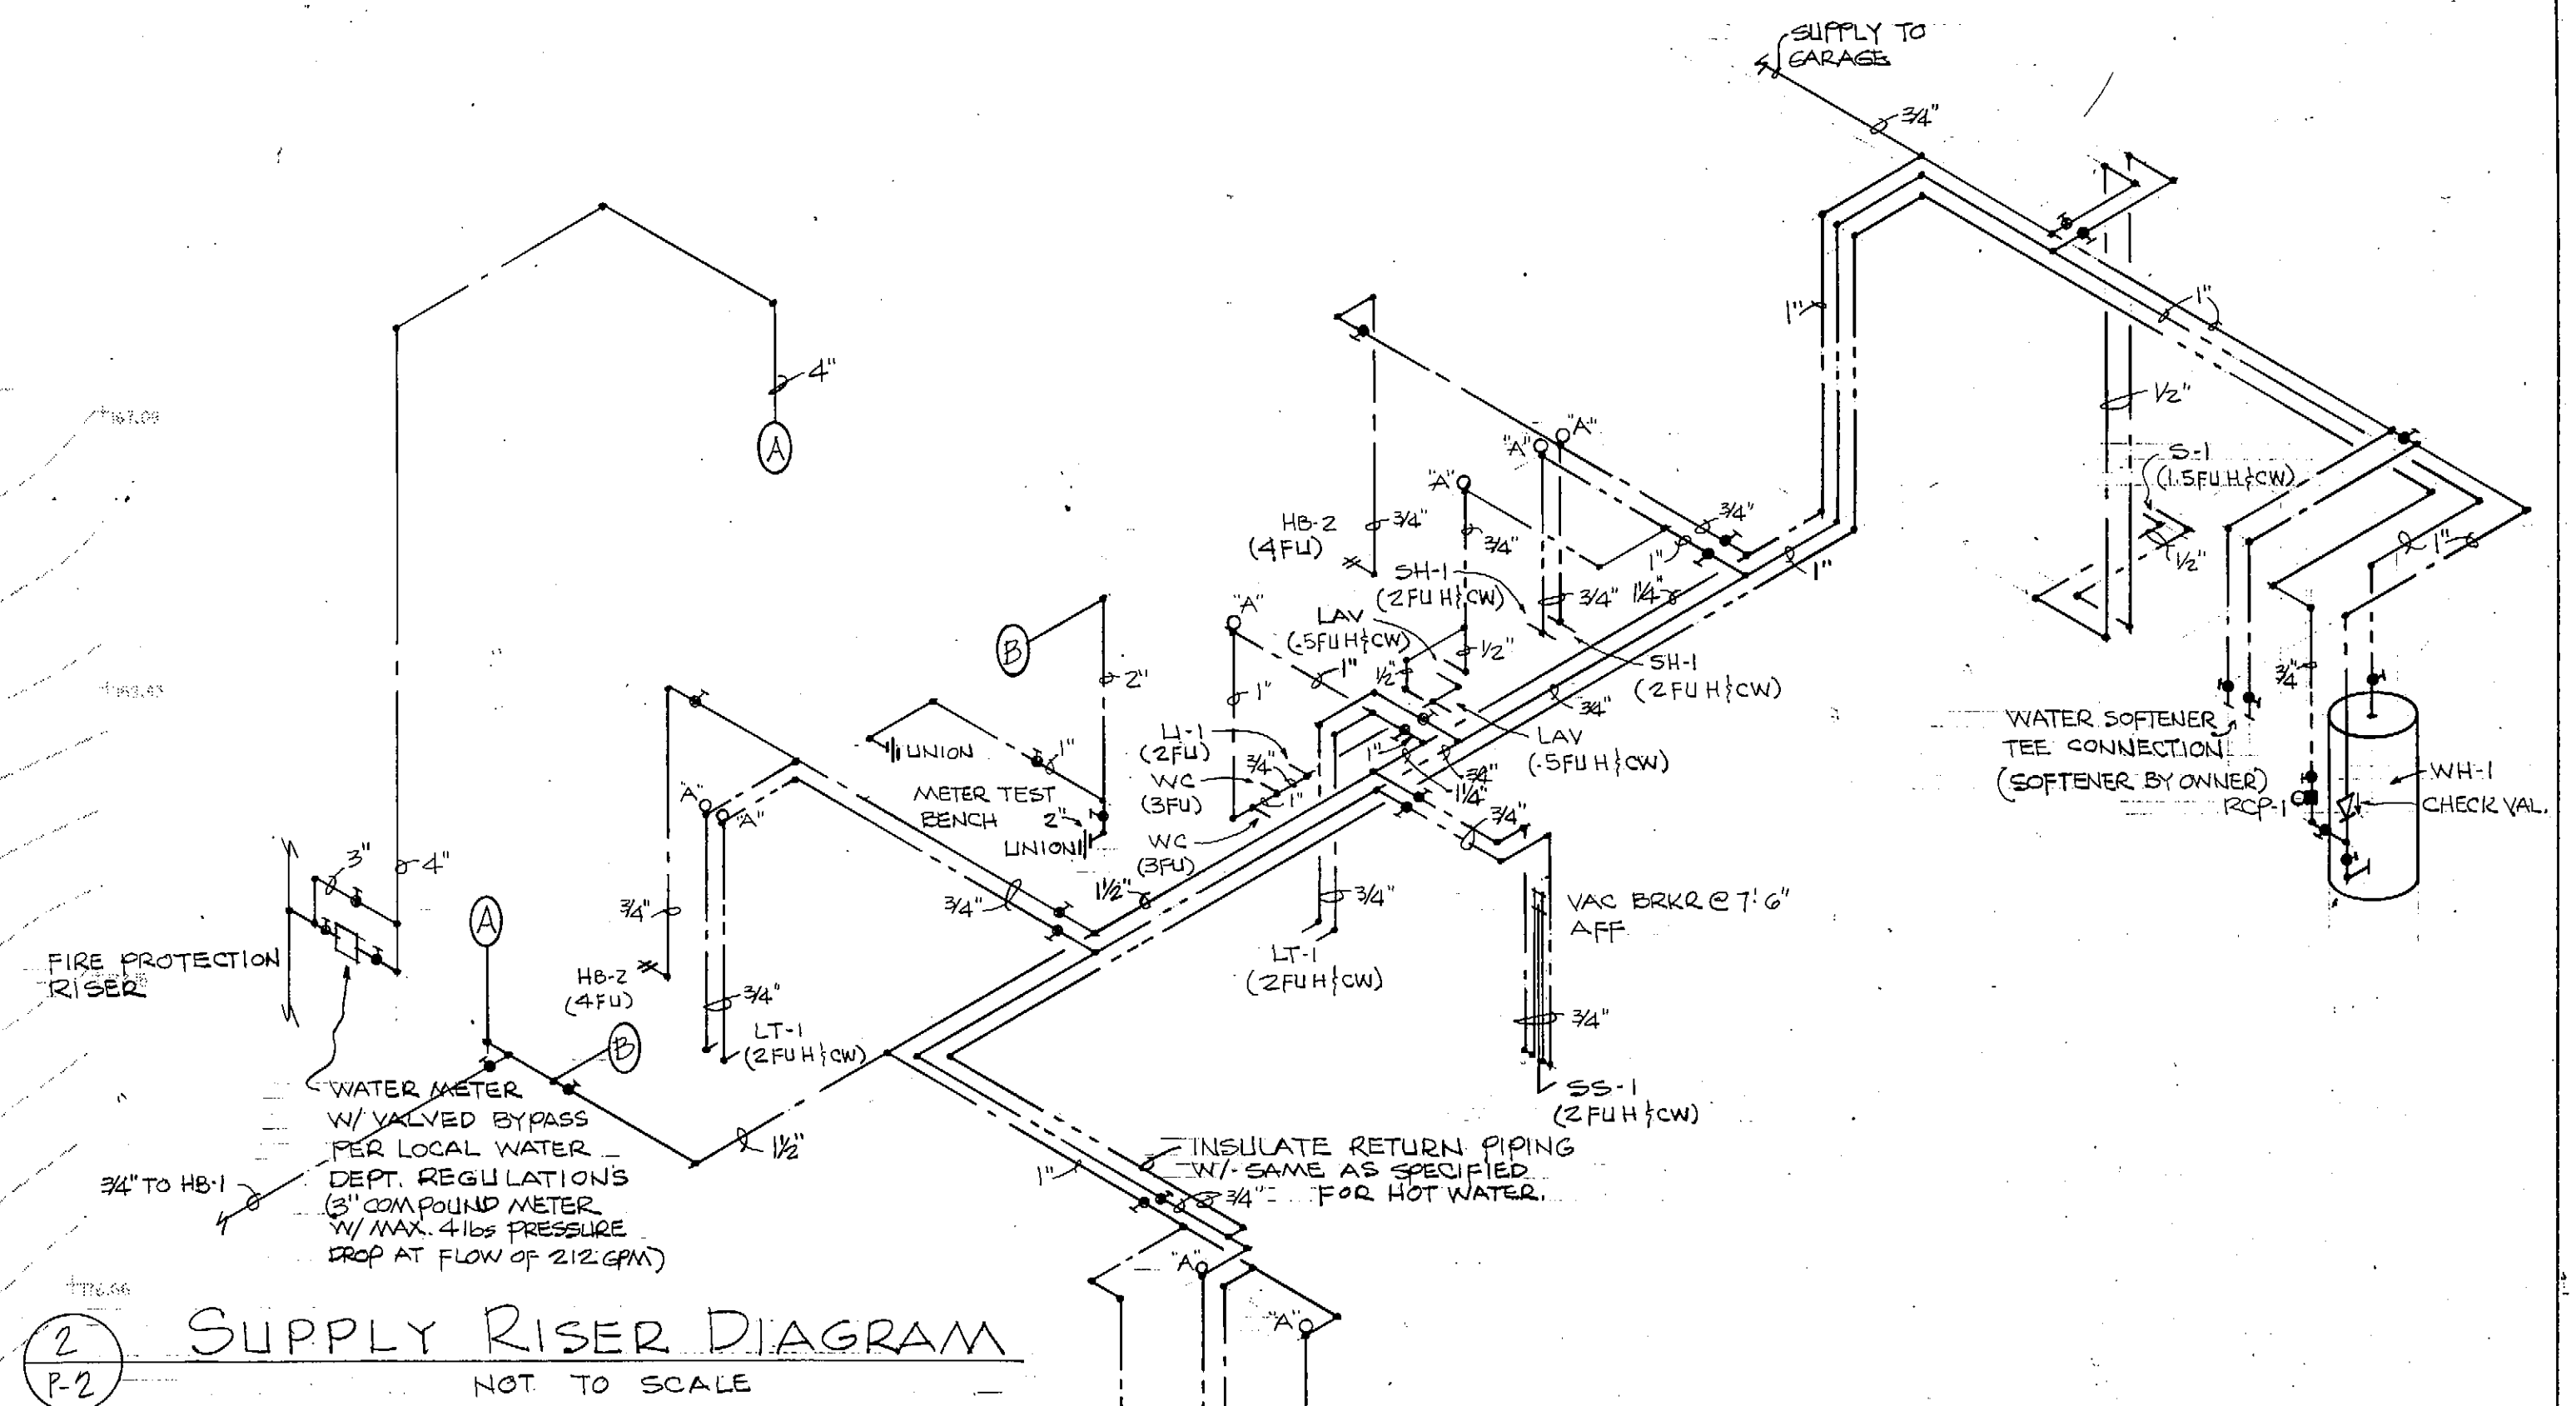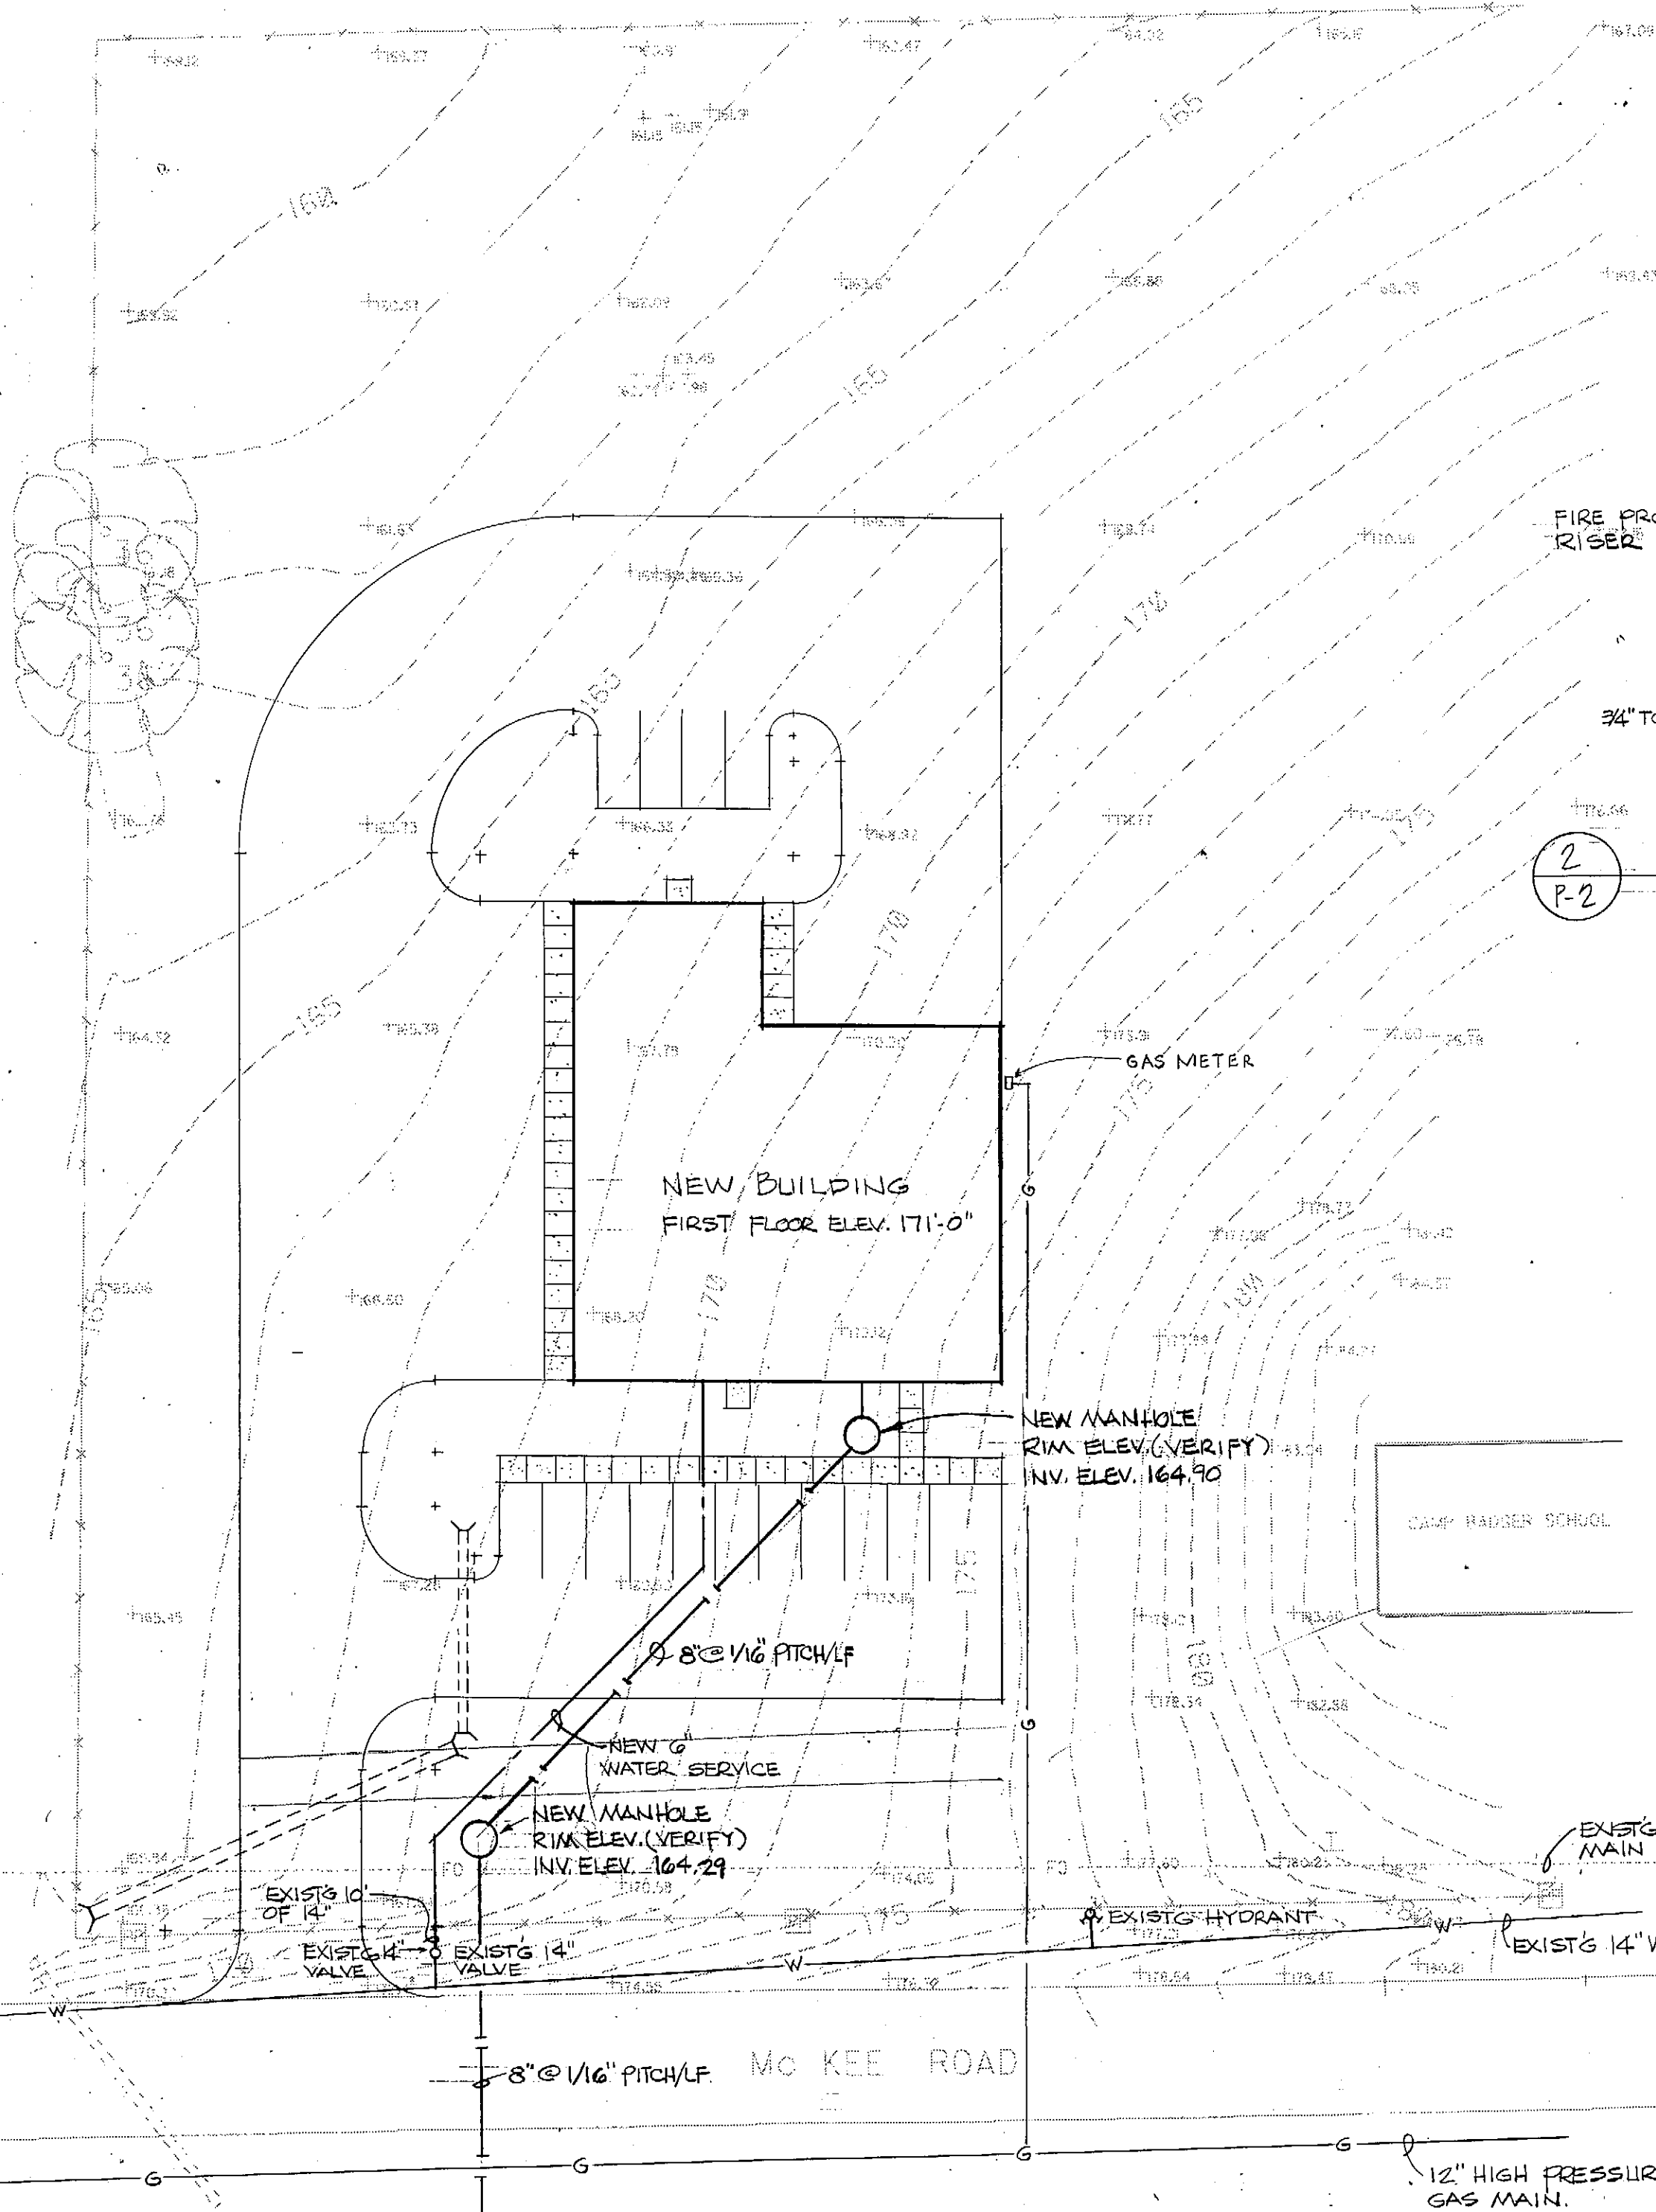

| REVISIONS |             |      | PROJECT REVIEW |     |             | FITCHBURG UTILITY BUILDING |    | SHEET NO.<br><b>P-1</b> |
|-----------|-------------|------|----------------|-----|-------------|----------------------------|----|-------------------------|
| NO.       | DESCRIPTION | DATE | BY             | NO. | DESCRIPTION | DATE                       | BY |                         |
| 1         |             |      |                | 1   |             |                            |    |                         |
| 2         |             |      |                | 2   |             |                            |    |                         |
| 3         |             |      |                | 3   |             |                            |    |                         |
| 4         |             |      |                | 4   |             |                            |    |                         |
| 5         |             |      |                | 5   |             |                            |    |                         |
| 6         |             |      |                | 6   |             |                            |    |                         |
| 7         |             |      |                | 7   |             |                            |    |                         |
| 8         |             |      |                | 8   |             |                            |    |                         |
| 9         |             |      |                | 9   |             |                            |    |                         |
| 10        |             |      |                | 10  |             |                            |    |                         |
| 11        |             |      |                | 11  |             |                            |    |                         |
| 12        |             |      |                | 12  |             |                            |    |                         |
| 99        |             |      |                | 99  |             |                            |    |                         |
| 100       |             |      |                | 100 |             |                            |    |                         |

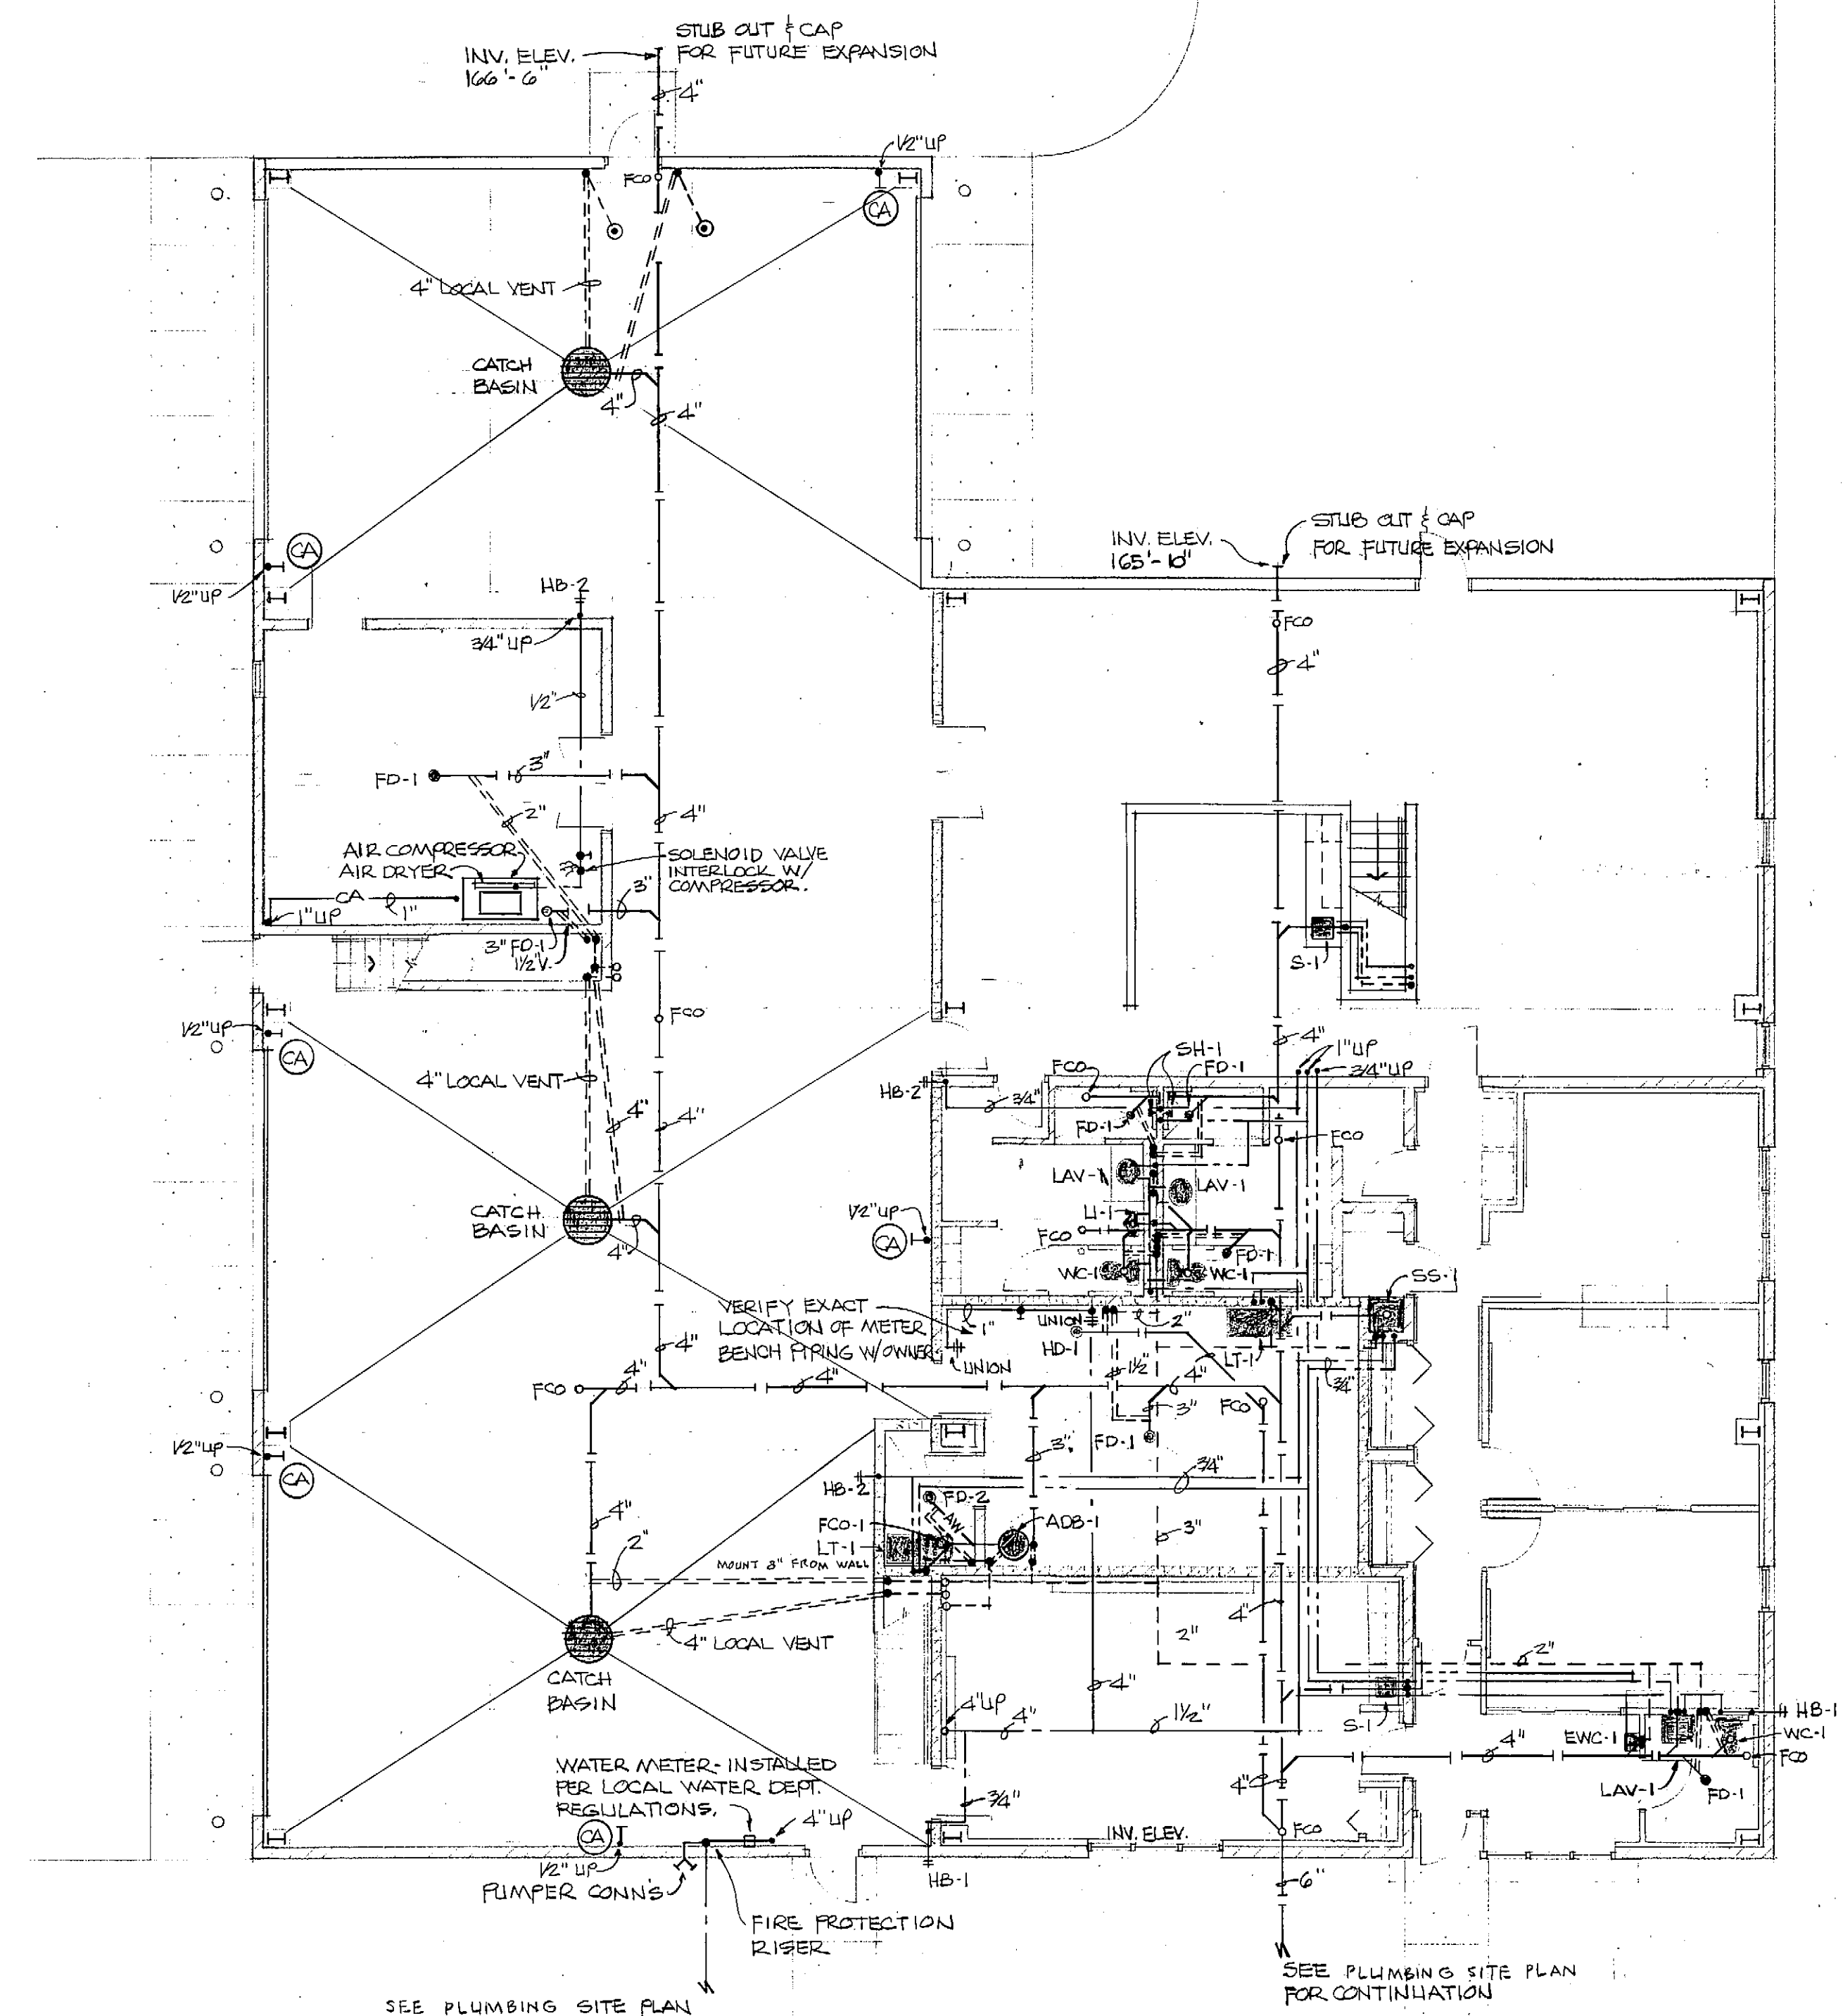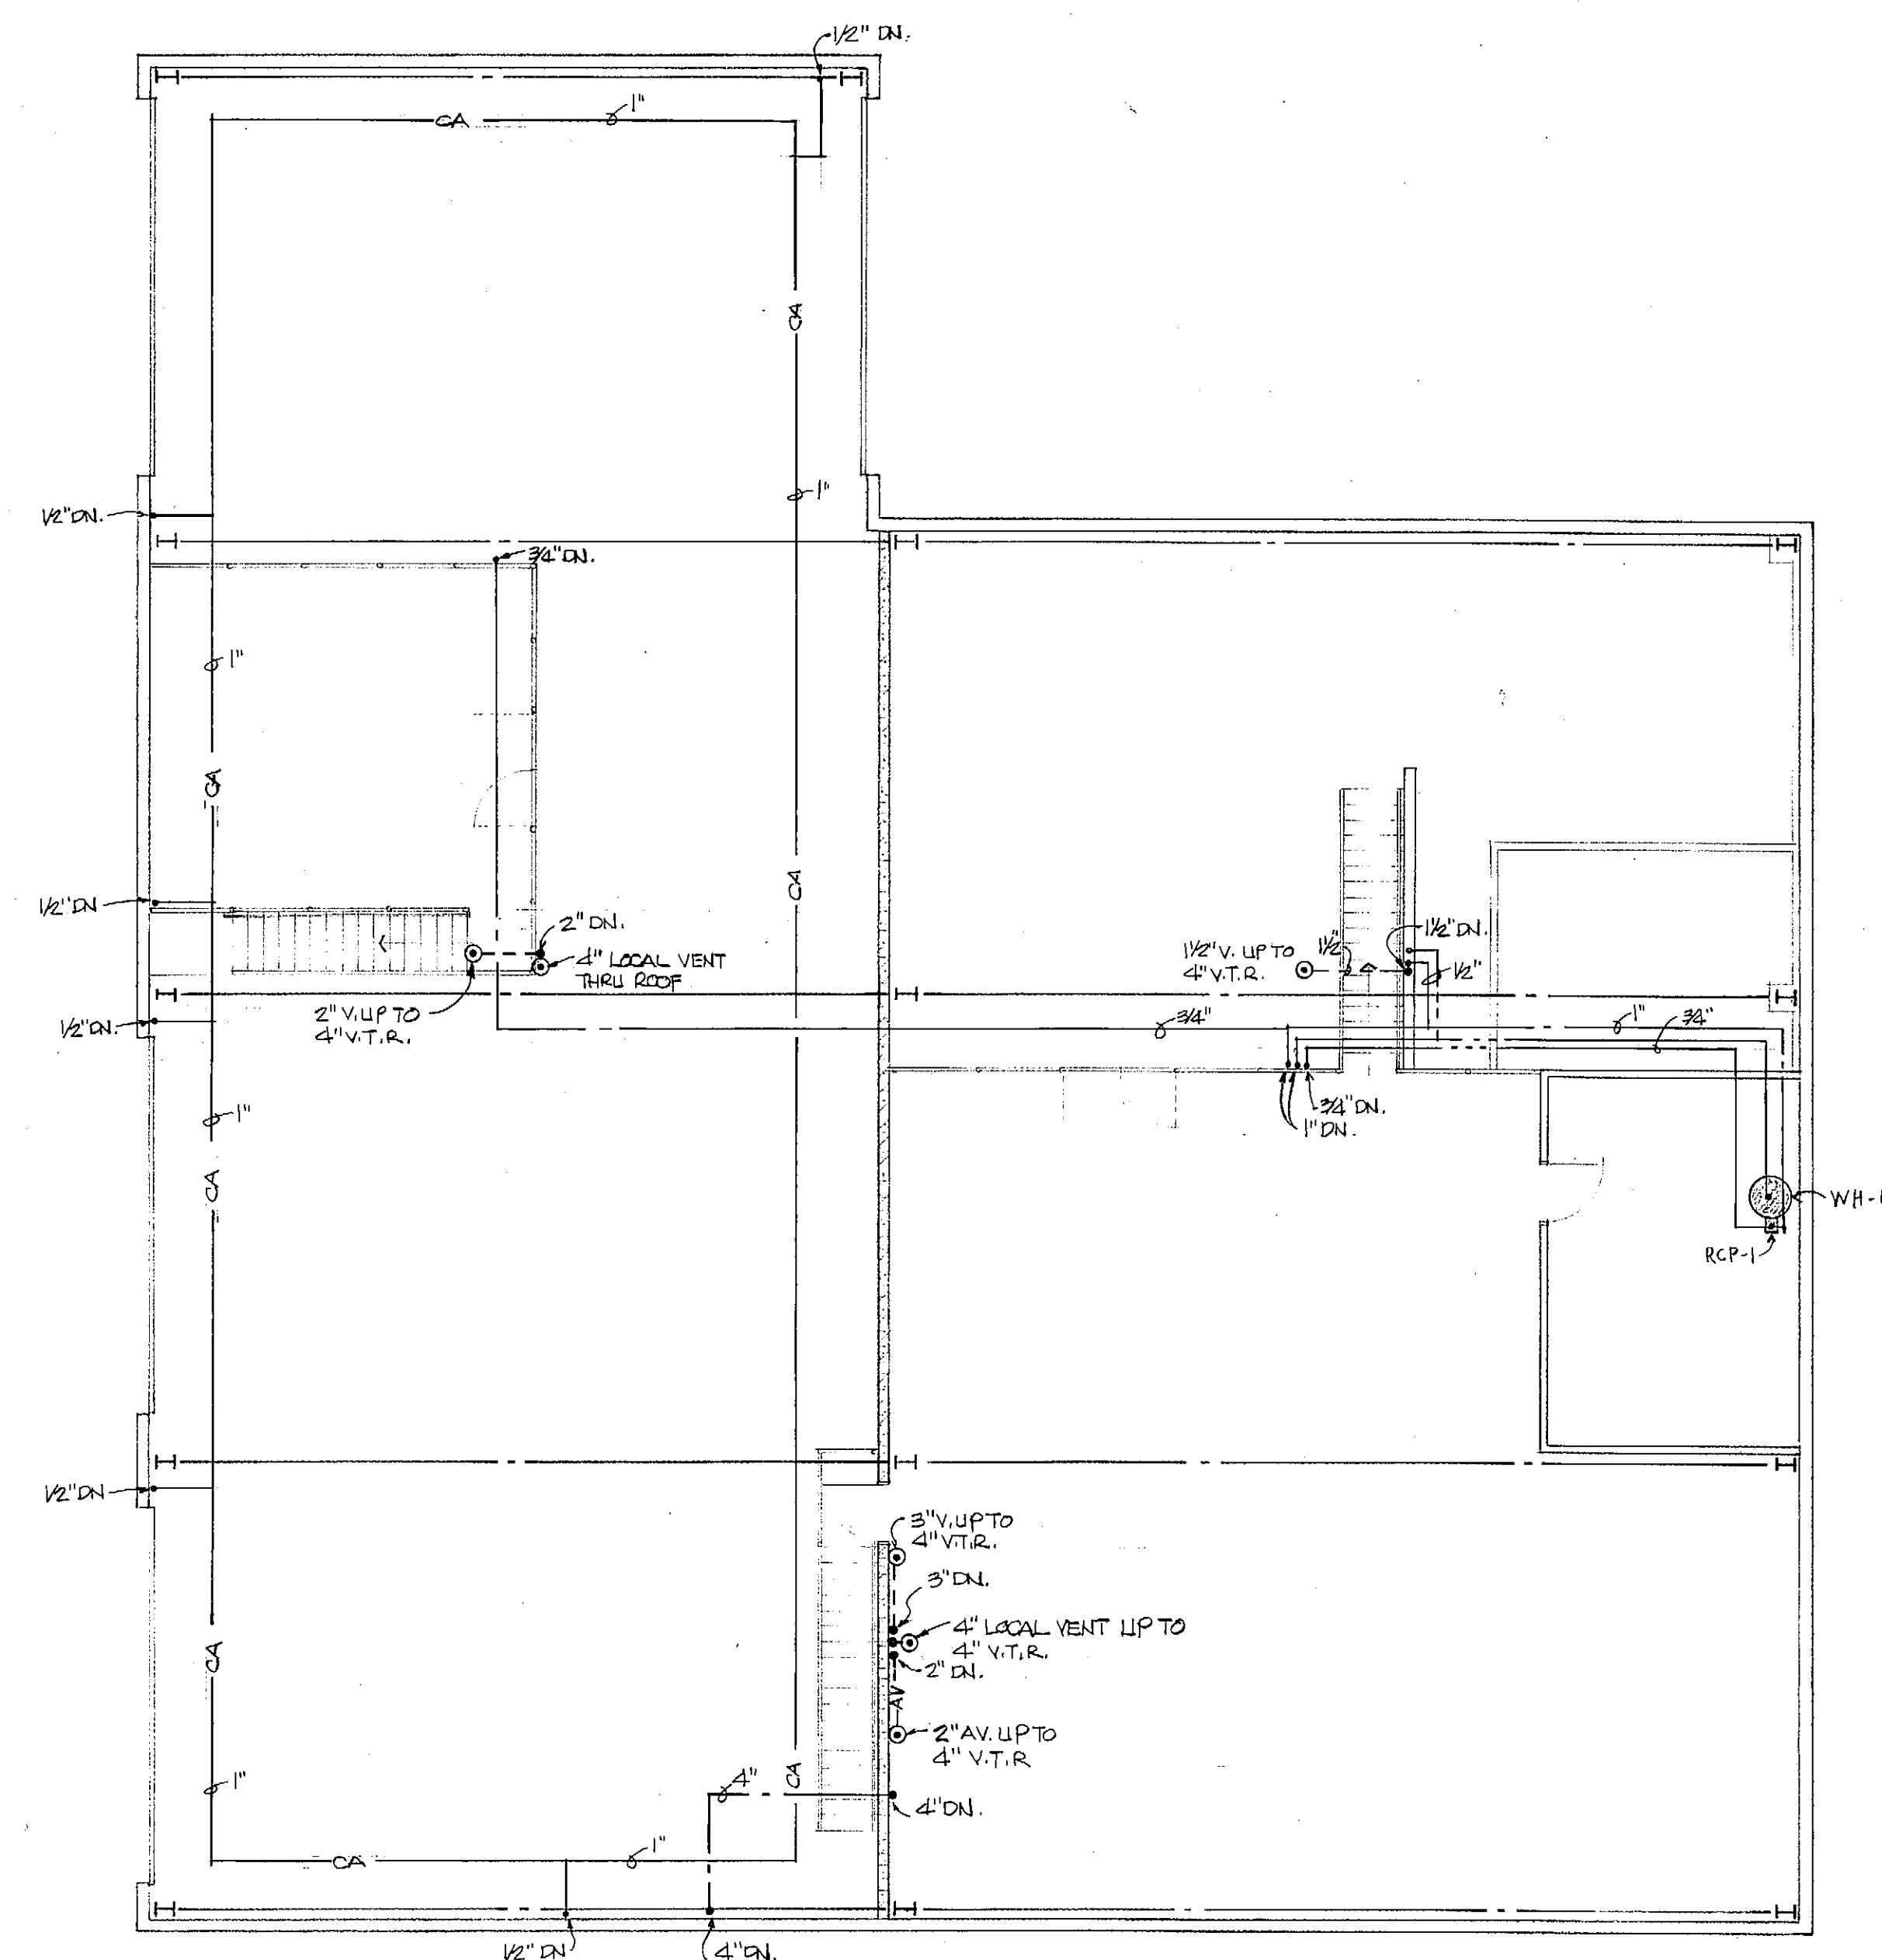

|                          |           |             |      |    |     |             |      |    |             |        |                |      |        |      |
|--------------------------|-----------|-------------|------|----|-----|-------------|------|----|-------------|--------|----------------|------|--------|------|
| A 1527<br>TELEPHONE POST | REVISIONS |             |      |    |     |             |      |    | FILE NO.    | 2414   | PROJECT REVIEW |      |        |      |
|                          | NO.       | DESCRIPTION | DATE | BY | NO. | DESCRIPTION | DATE | BY | SURVEYED BY | DESIGN | J.E.L.         | DATE | DESIGN | DATE |
|                          |           |             |      |    |     |             |      |    | DRAWN BY    |        |                |      |        |      |
|                          | △         |             |      |    | △   |             |      |    | DATE        | 2-7-89 |                |      |        |      |
|                          | △         |             |      |    | △   |             |      |    | SCOPE I.D.  | 88F40  |                |      |        |      |
|                          | △         |             |      |    | △   |             |      |    | SCALE       |        | REVIEW         |      | REVIEW |      |

|                |        |      |         |
|----------------|--------|------|---------|
| PROJECT REVIEW |        |      |         |
| DESIGN         | J.E.L. | DATE | 11/1/89 |
| REVIEW         |        | DATE |         |

**Foth & Van Dyke**  
Engineers / Architects


## FITCHBURG UTILITY BUILDING

6060 McKee Road


Fitchburg, WI

SHEET NO.

**P-2**

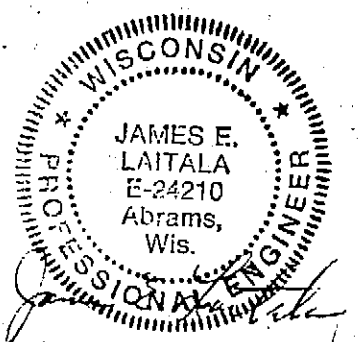




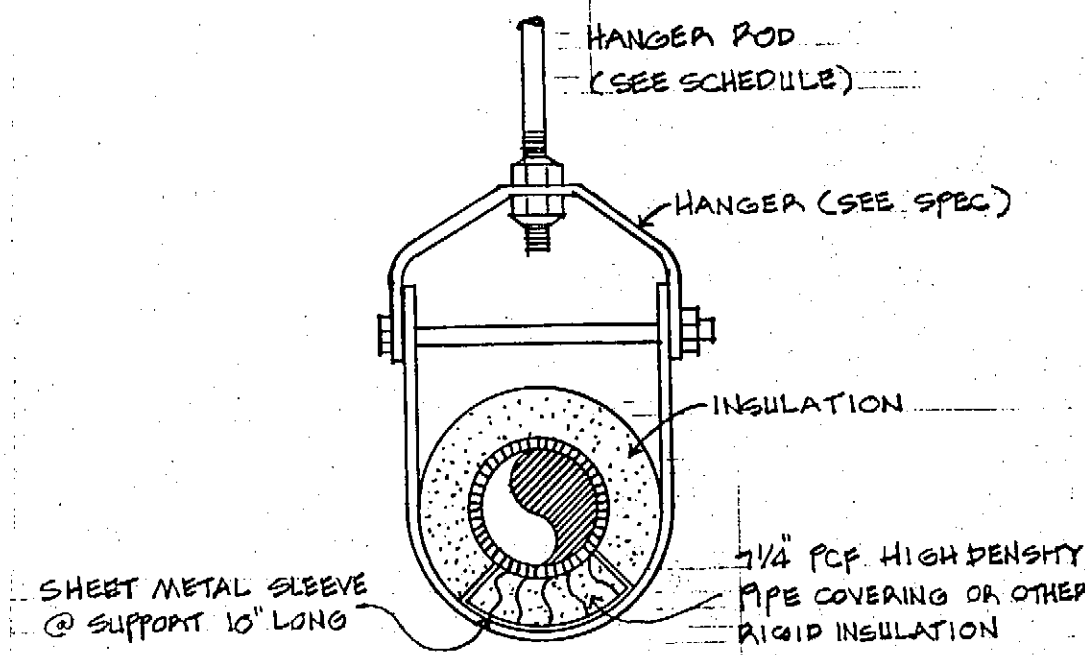


1  
P-3  
TYPICAL PIPING SUPPORT FOR ALL INSULATED PIPING

NOTE:  
AT PIPE SUPPORT OR HANGERS  
FOR COPPER TUBE SIZES 2 AND LARGER  
A HIGH DENSITY RIGID INSULATION SHALL BE USED

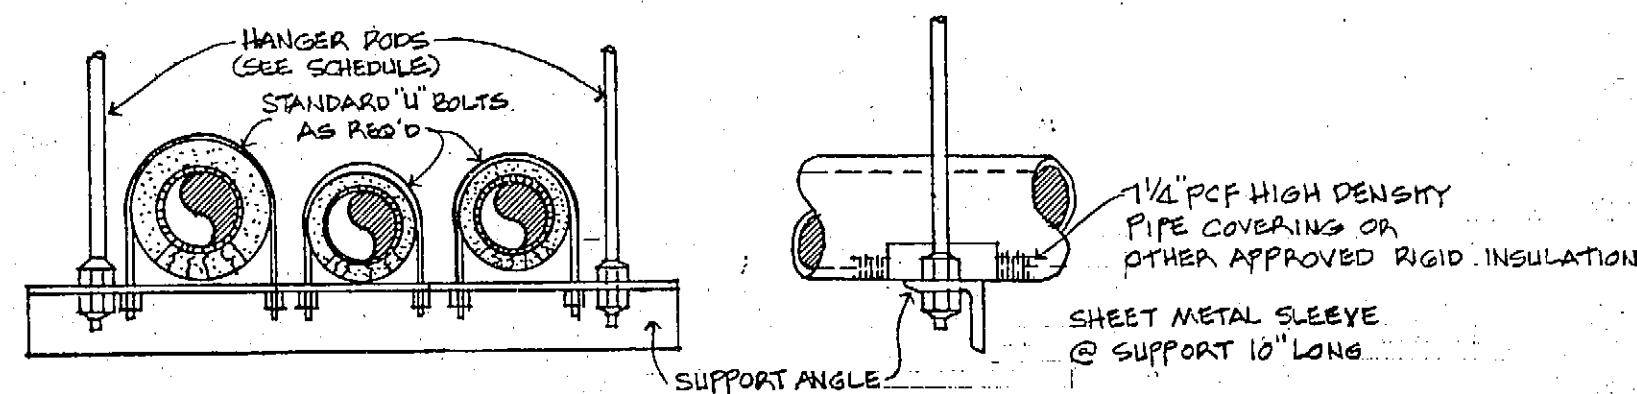

5  
P-3  
TRAPEZE HANGER DETAIL

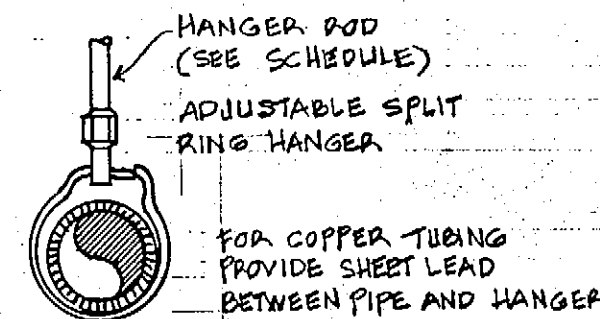

6  
P-3  
PIPING SUPPORT


| PIPE SUPPORT SCHEDULE |                 |        |                        |
|-----------------------|-----------------|--------|------------------------|
| PIPE SIZE INCHES      | SPACING IN FEET |        | HANGER ROD SIZE INCHES |
|                       | STEEL           | COPPER |                        |
| 1/2                   | 5               | 6      | 3/8                    |
| 3/4                   | 6               | 6      | 3/8                    |
| 1                     | 7               | 6      | 3/8                    |
| 1 1/4                 | 8               | 6      | 3/8                    |
| 1 1/2                 | 9               | 10     | 3/8                    |
| 2                     | 10              | 10     | 3/8                    |
| 2 1/2                 | 11              | 10     | 3/8                    |
| 3                     | 12              | 10     | 3/8                    |

| SHOCK ABSORBER SCHEDULE |       |       |       |       |       |
|-------------------------|-------|-------|-------|-------|-------|
| SYMBOL                  | A     | B     | C     | D     | E     |
| MODEL NO.               | 75001 | 75002 | 75003 | 75004 | 75006 |


MODEL NUMBERS BASED ON LOSAM  
INSTALL PER MANUFACTURER'S REQUIREMENTS

| KEY OF PLUMBING SYMBOLS |                     |                                      |
|-------------------------|---------------------|--------------------------------------|
| SYMBOLS                 | ABBR.               | DESCRIPTION                          |
| ---                     | STW . S.            | STORM SEWER                          |
| ---                     | SAN . S.            | SANITARY SEWER OR DRAIN BELOW GRADE  |
| ---                     | SAN . S.            | SANITARY SEWER OR DRAIN ABOVE GRADE  |
| ---                     | V .                 | VENT PIPE ABOVE GRADE                |
| ---                     | V .                 | VENT PIPE BELOW GRADE                |
| ---                     | CW .                | COLD WATER                           |
| ---                     | HW .                | HOT WATER                            |
| ---                     | HW .                | HOT WATER WITH HEAT TAPE 120 DEGREES |
| ---                     | HW .                | HOT WATER WITH HEAT TAPE 140 DEGREES |
| ---                     | H . W . R .         | HOT WATER RECIRCULATING              |
| ---                     | B . V .             | BALL VALVE                           |
| ---                     | SA .                | SHOCK ABSORBER                       |
| ---                     | CO . OR F . C . O . | CLEANOUT OR FLUSH CLEANOUT (NOTED)   |
| ---                     | CA .                | COMPRESSED AIR OUTLET                |
| ---                     | CA .                | COMPRESSED AIR PIPING                |
| ---                     | AV .                | ACID VENT PIPING                     |
| ---                     | AW .                | ACID WASTE PIPING UPSTREAM OF AOB-1  |


ACID PIPING TO BE FUSEAL, ENFIELD OR EQUAL.  
THIS INCLUDES FITTINGS.

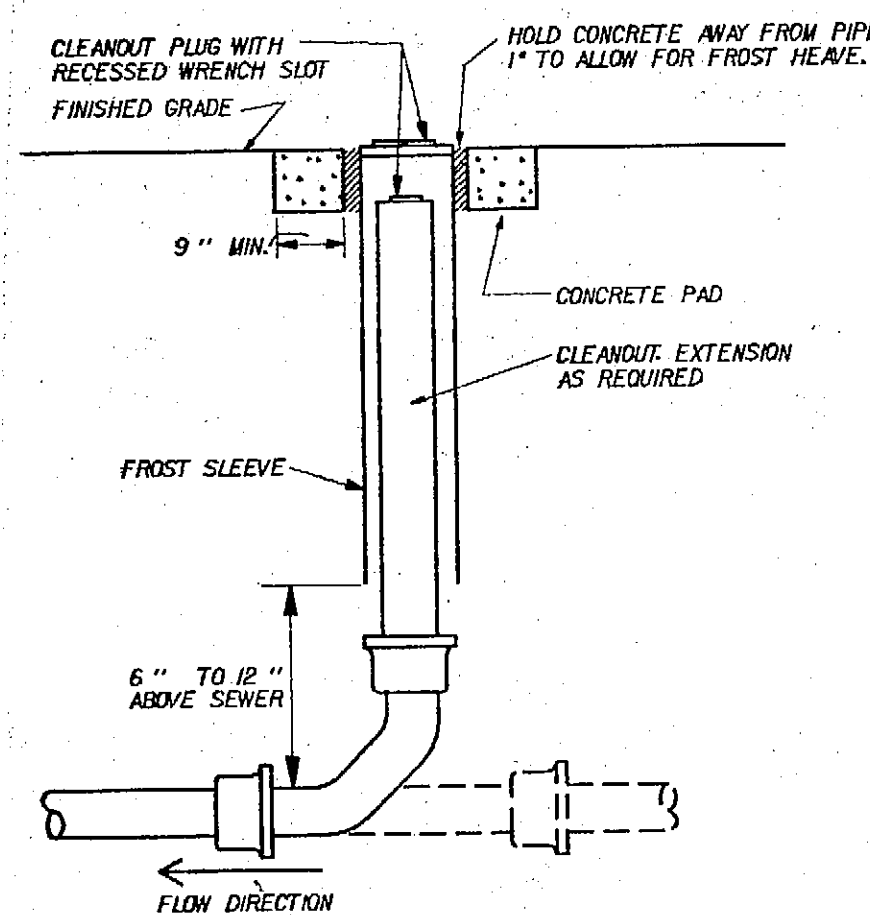


2  
P-3  
EXTERIOR CLEANOUT DETAIL  
NOT TO SCALE

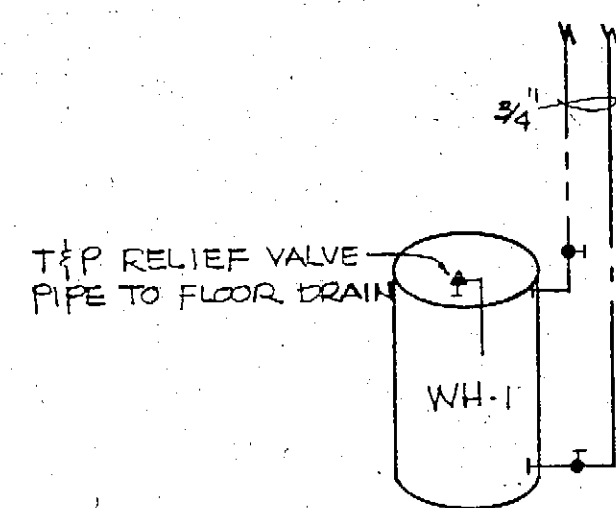

3  
P-3  
WATER HEATER DETAIL  
NOT TO SCALE

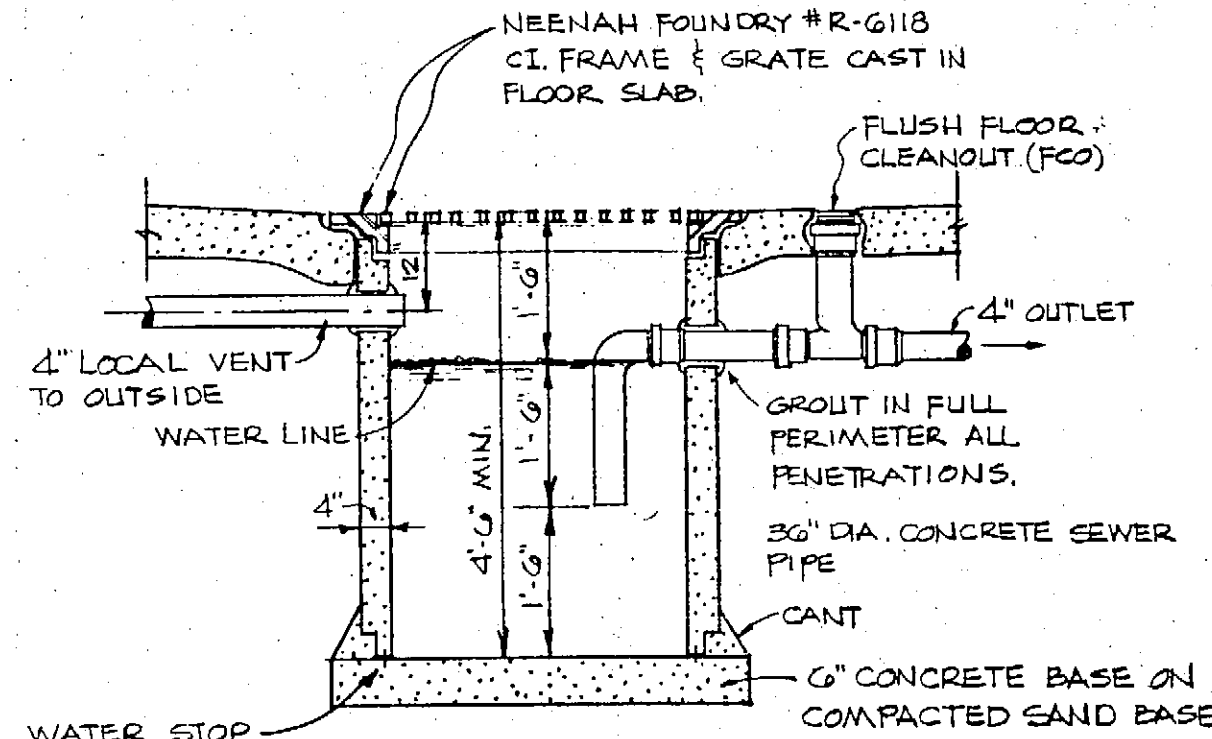


7  
P-3  
INTERIOR CATCH BASIN DETAIL  
NOT TO SCALE

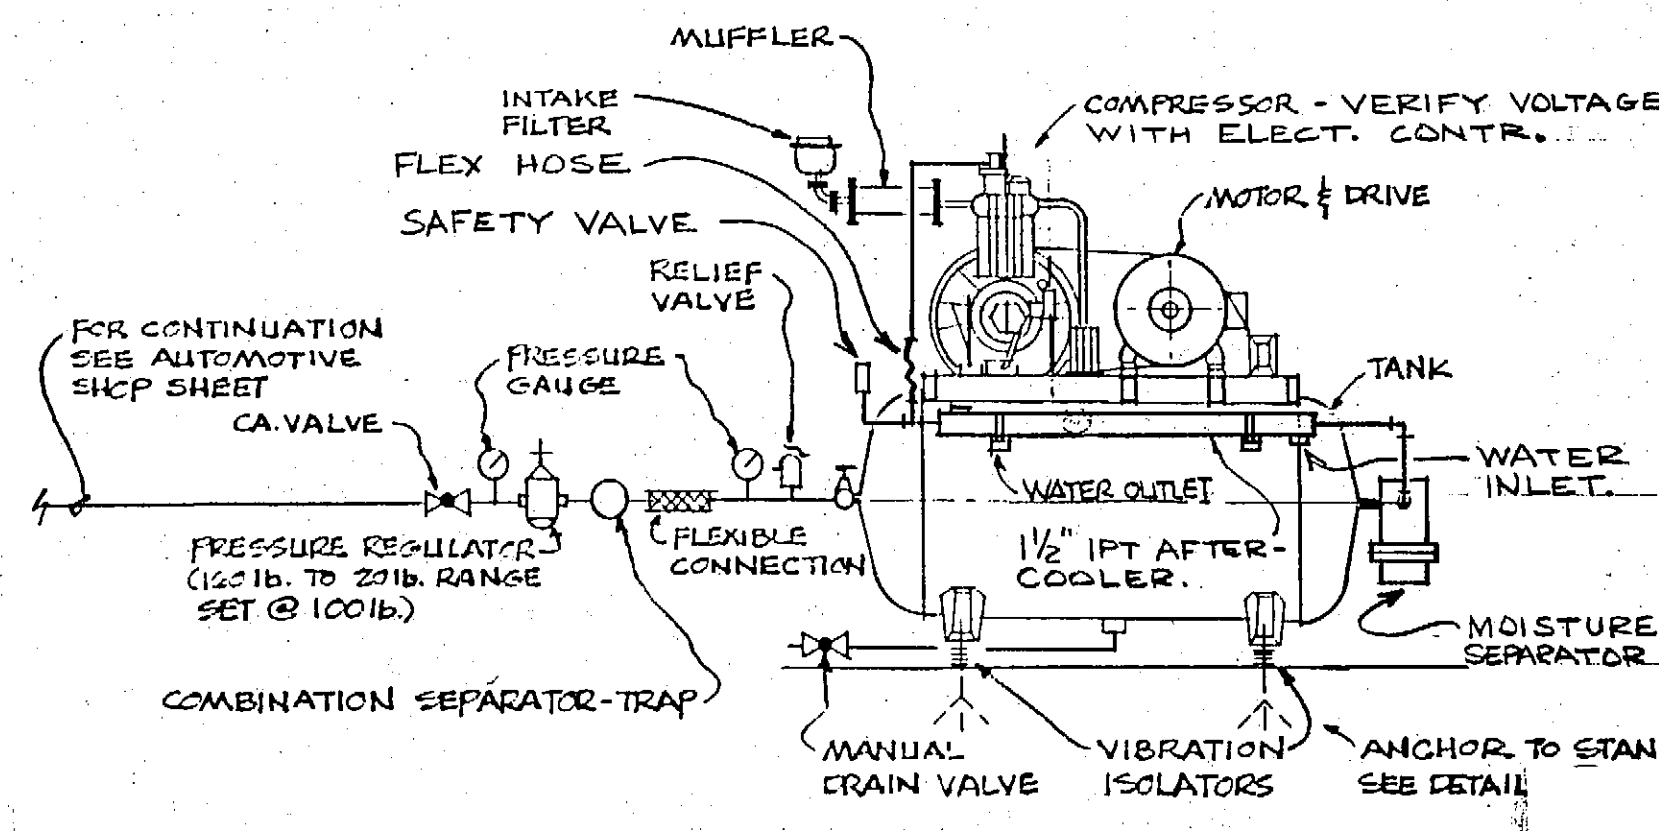

8  
P-3  
AIR COMPRESSOR DETAIL  
NOT TO SCALE

CONTRACTOR TO FURNISH ENOUGH LIMESTONE CHIPS  
TO FILL AOB-1 TWICE AFTER FIRST FILL.



| PLUMBING FIXTURE SCHEDULE |                   |                 |  |                   |                    |        |      |      |              |              |                     |
|---------------------------|-------------------|-----------------|--|-------------------|--------------------|--------|------|------|--------------|--------------|---------------------|
| SYMBOL                    | MANUFACTURER      | MODEL NO.       | DESCRIPTION  | MTG AFF           | PIPING CONNECTIONS |        |      |      | FURNISHED BY | INSTALLED BY | REMARKS             |
|                           |                   |                 |  |                   | WASTE              | VENT   | CW.  | HW.  |              |              |                     |
| WC-1                      | AMERICAN STANDARD | 2109.100        | FLUSH TANK TYPE WATER CLOSET   | FLOOR             | 4"                 | 1 1/2" | 1/2" |      | P.C.         | P.C.         | COLOR WHITE         |
|                           | BEMIS             | 1955-C          | SOLID PLASTIC OPEN FRONT SEAT  |                   |                    |        |      |      | P.C.         | P.C.         | COLOR WHITE         |
| U-1                       | AMERICAN STANDARD | 6400.014        | FLOOR TYPE URINAL  | 24" TO RIM        | 2"                 | 1 1/2" |      |      | P.C.         | P.C.         | COLOR WHITE         |
|                           | SLOAN             | 186             | FLUSH VALVE  |                   |                    |        | 3/4" |      | P.C.         | P.C.         |                     |
| SS-1                      | MUSTEE            | 65              | MOLDED STONE SERVICE SINK 24" X 24"  | FLOOR             | 3"                 | 1 1/2" |      |      | P.C.         | P.C.         |                     |
|                           | CHICAGO FAUCETS   | 911-15          | SERVICE SINK FAUCET W/ VAC. BRKR   | VAC. BRKR 17'-6"  |                    |        | 3/4" | 3/4" | P.C.         | P.C.         |                     |
|                           | MUSTEE            | 65.600 & 65.700 | MOP HANGER & HOSE HOLDER   |                   |                    |        |      |      | P.C.         | P.C.         |                     |
| FD-1                      | ZURN              | 415-ZN          | FLOOR DRAIN  | FLUSH             |                    |        |      |      | P.C.         | P.C.         | SEE PLAN FOR SIZE   |
| FCO                       | ZURN              | Z-1400-2-ZN     | FLUSH FLOOR CLEANOUT   | FLUSH             |                    |        |      |      | P.C.         | P.C.         | SEE PLAN FOR SIZE   |
| WCO                       | ZURN              | Z-1440-1        | FLUSH WALL CLEANOUT  | FLUSH             |                    |        |      |      | P.C.         | P.C.         | SEE PLAN FOR SIZE   |
| RD-1                      | ZURN              | Z-100ERC        | ROOF DRAIN   |                   |                    |        |      |      | P.C.         | P.C.         | SEE PLAN FOR SIZE   |
| EWC-1                     | OASIS             | 00PSM           | ELECTRIC WATER COOLER  | 29" TO BOTT. EDGE |                    |        |      |      | P.C.         | P.C.         |                     |
| SH-1                      | SYMMONS           | 1-801S          | SURFACE MOUNTED STAINLESS STEEL SHOWER UNIT W/ PRESSURE BALANCING SHOWER VALVE | HEAD @ 6'-0"      |                    |        | 1/2" | 1/2" | P.C.         | P.C.         |                     |
| LAV-1                     | AMERICAN STANDARD | 0076.027        | VITREOUS CHINA SELF-RIMMING LAVATORY   |                   | 1 1/2"             | 1 1/2" |      |      | P.C.         | P.C.         | COLOR WHITE         |
|                           | SYMMONS           | S-60-GH         | METERING FAUCET W/ 4" CENTERS  |                   |                    |        | 1/2" | 1/2" | P.C.         | P.C.         |                     |
| HB-1                      | WOODFORD          | 65              | FREEZEPROOF HOSE BIBB  |                   |                    |        | 3/4" |      | P.C.         | P.C.         |                     |
| WH-1                      | STATE INDUSTRIES  | SR8-60-NADS-F   | GAS FIRED WATER HEATER DIRECT VENT   |                   |                    |        |      |      |              |              | 48,000 BTU/HR INPUT |
| HD-1                      | ZURN              | 32100-Z         | HUB DRAIN (SEE PLAN FOR SIZE)  |                   |                    |        |      |      |              |              |                     |
| ADB-1                     | SCHIER            | NT30AE          | ACID DILUTION BASIN  | FLUSH             | 3"                 | 2"     |      |      |              |              | SEE PLAN FOR SIZE   |
| FD-2                      | FUSEAL            | 7751            | ACID RESISTANT FLOOR DRAIN   |                   |                    |        |      |      |              |              |                     |

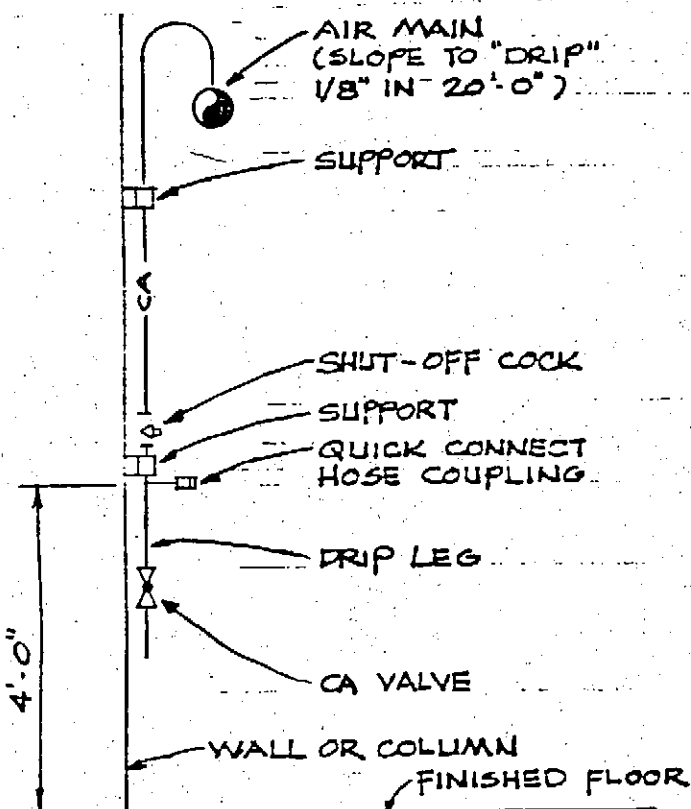

4  
P-3  
TYPICAL AIR DRIFT  
NOT TO SCALE


**SYMBOLS:**

|  |                      |  |                         |
|--|----------------------|--|-------------------------|
|  | SUPPLY AIR DUCT RISE |  | ROUND DUCT RISE         |
|  | RETURN AIR DUCT RISE |  | REFR. SUCTION PIPE      |
|  | SUPPLY AIR DUCT DROP |  | REFR. LIQUID PIPE       |
|  | RETURN AIR DUCT DROP |  | GAS PIPE                |
|  | SUPPLY GRILLE        |  | FLEXIBLE ROUND DUCT     |
|  | RETURN GRILLE        |  | FLEXIBLE CONNECTION     |
|  | BALANCING DAMPER     |  | DUCT TRANSITION         |
|  | TURNING VANES        |  | DUCT W/ SIZE (W/HT)     |
|  | SUPPLY AIR DIFFUSER  |  | DAMPER W/ ACTUATOR      |
|  | UNIT HEATER          |  | THERMOSTAT              |
|  |                      |  | STATIC PRESSURE CONTROL |
|  |                      |  | EXHAUST FAN             |
|  |                      |  | ABOVE FINISHED FLOOR    |
|  |                      |  | VENT THRU ROOF          |

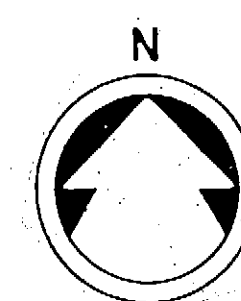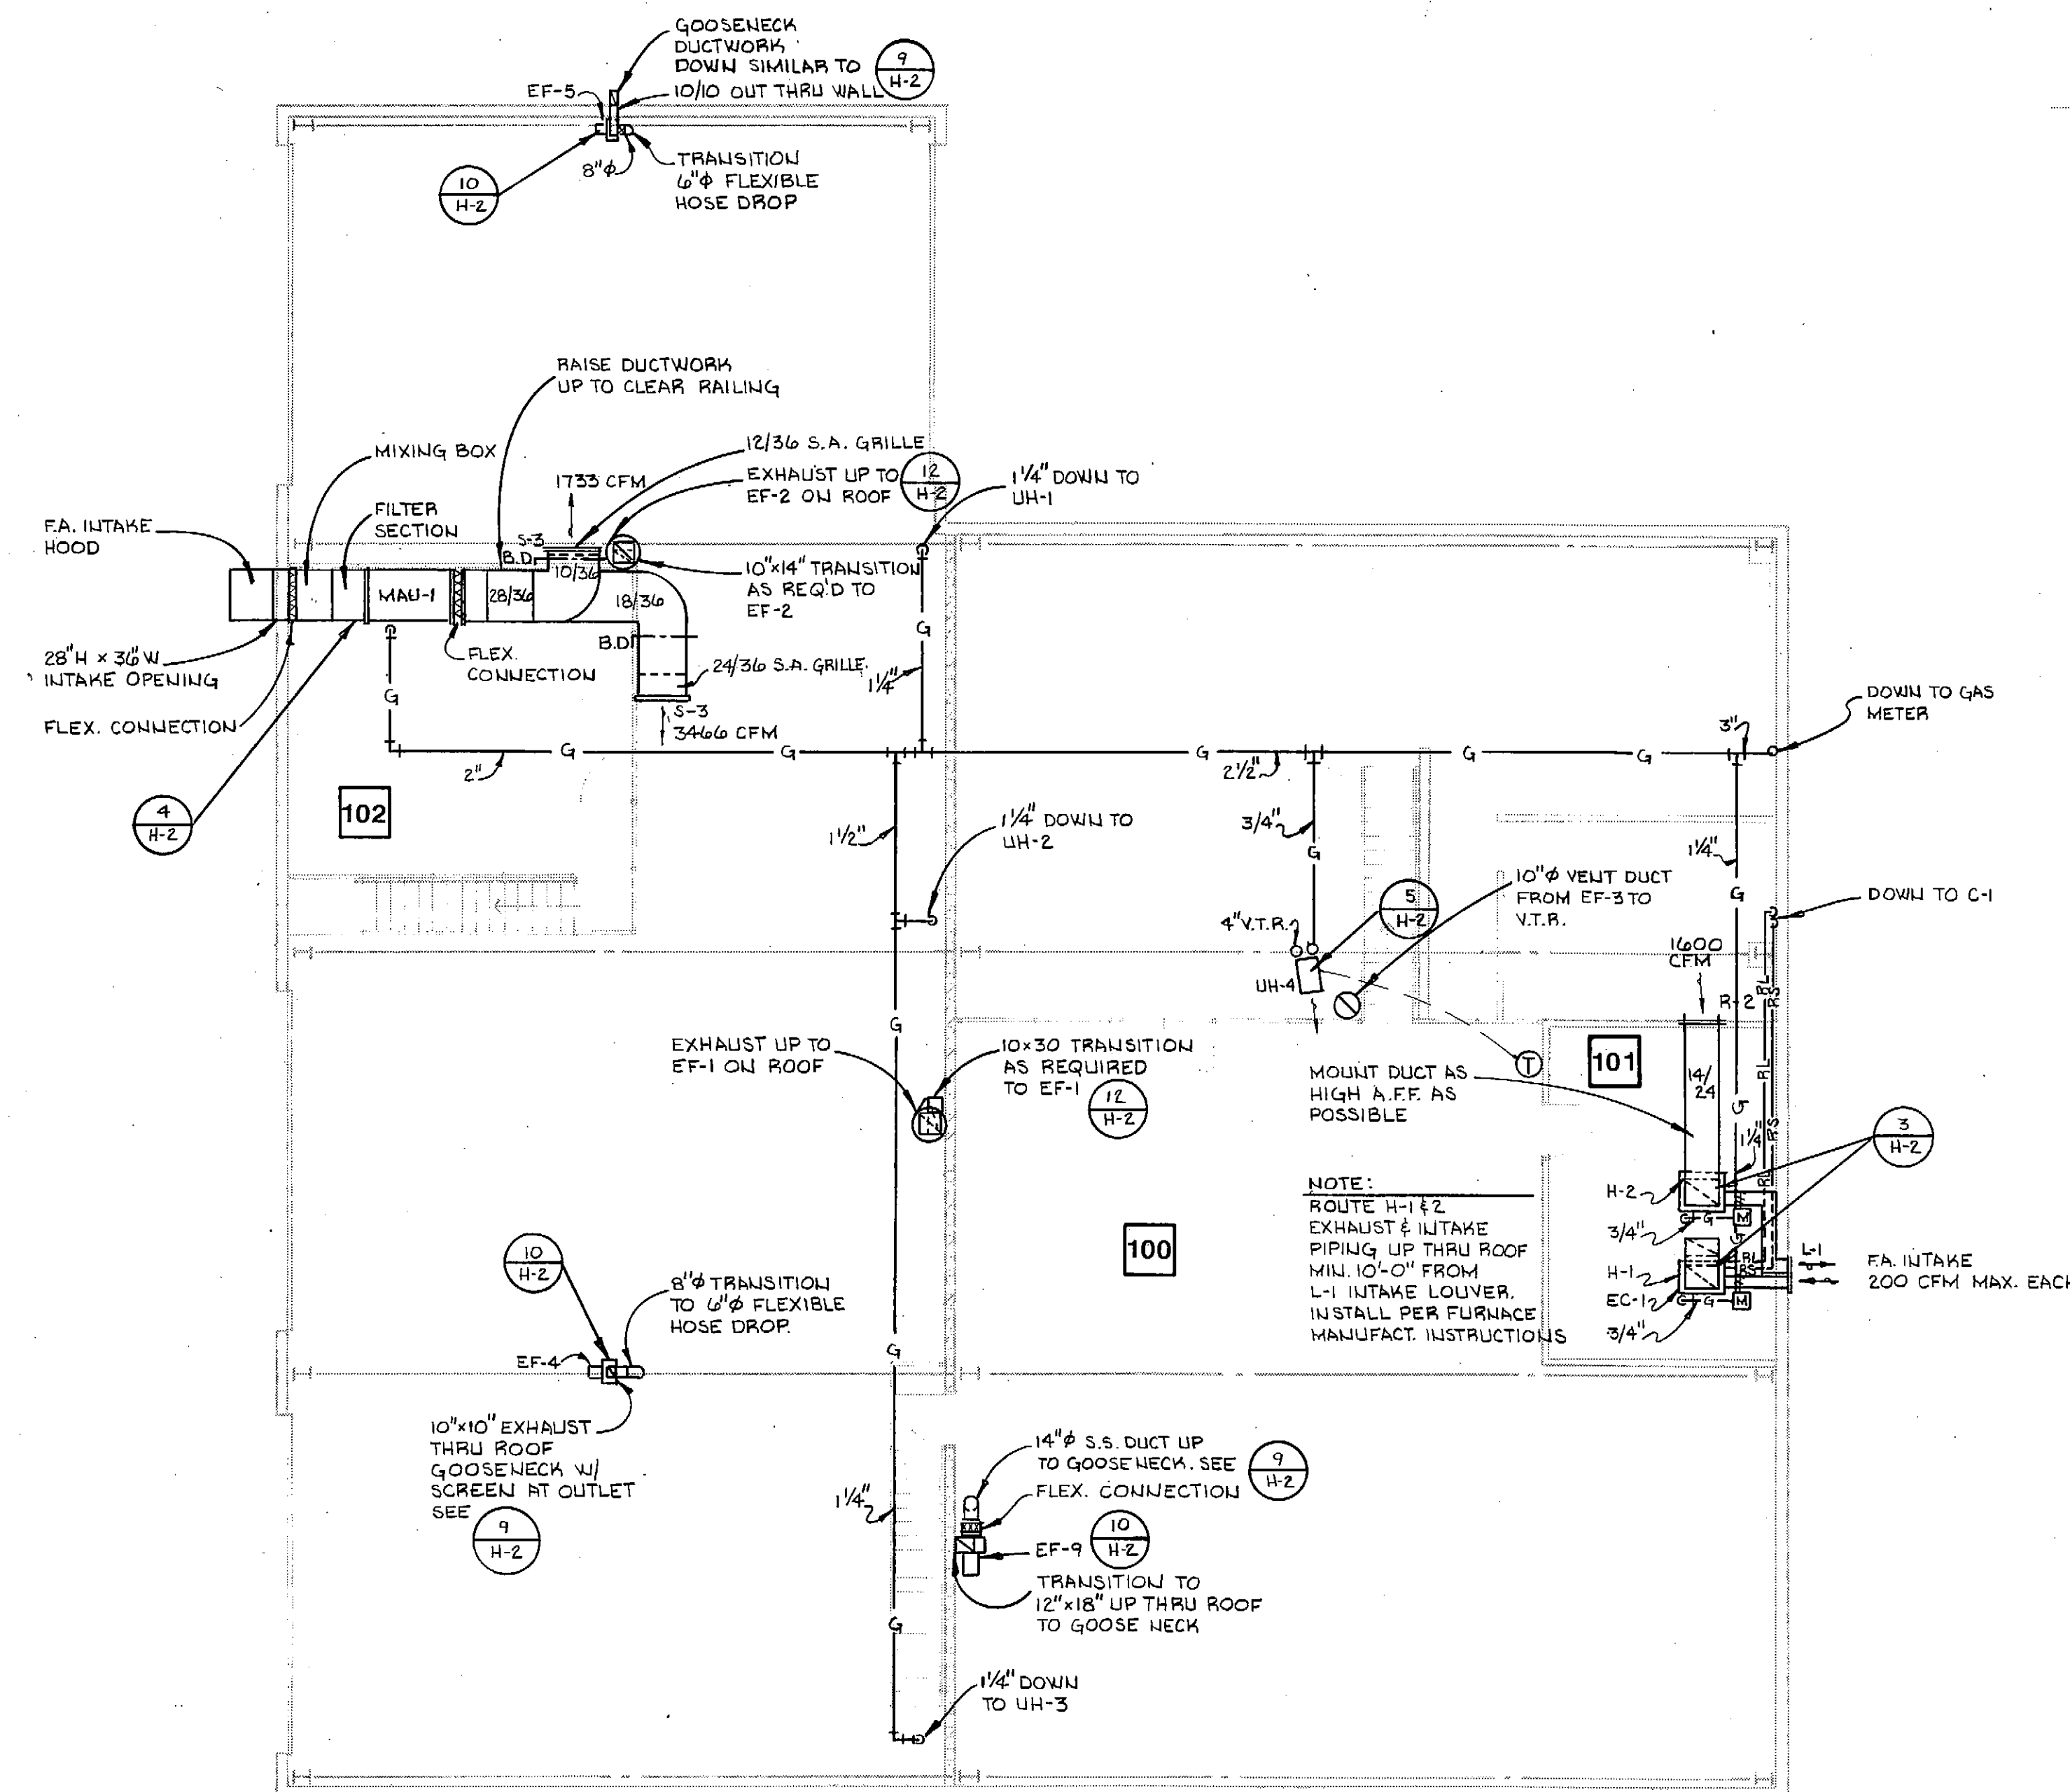


**1 UPPER LEVEL PLAN -**




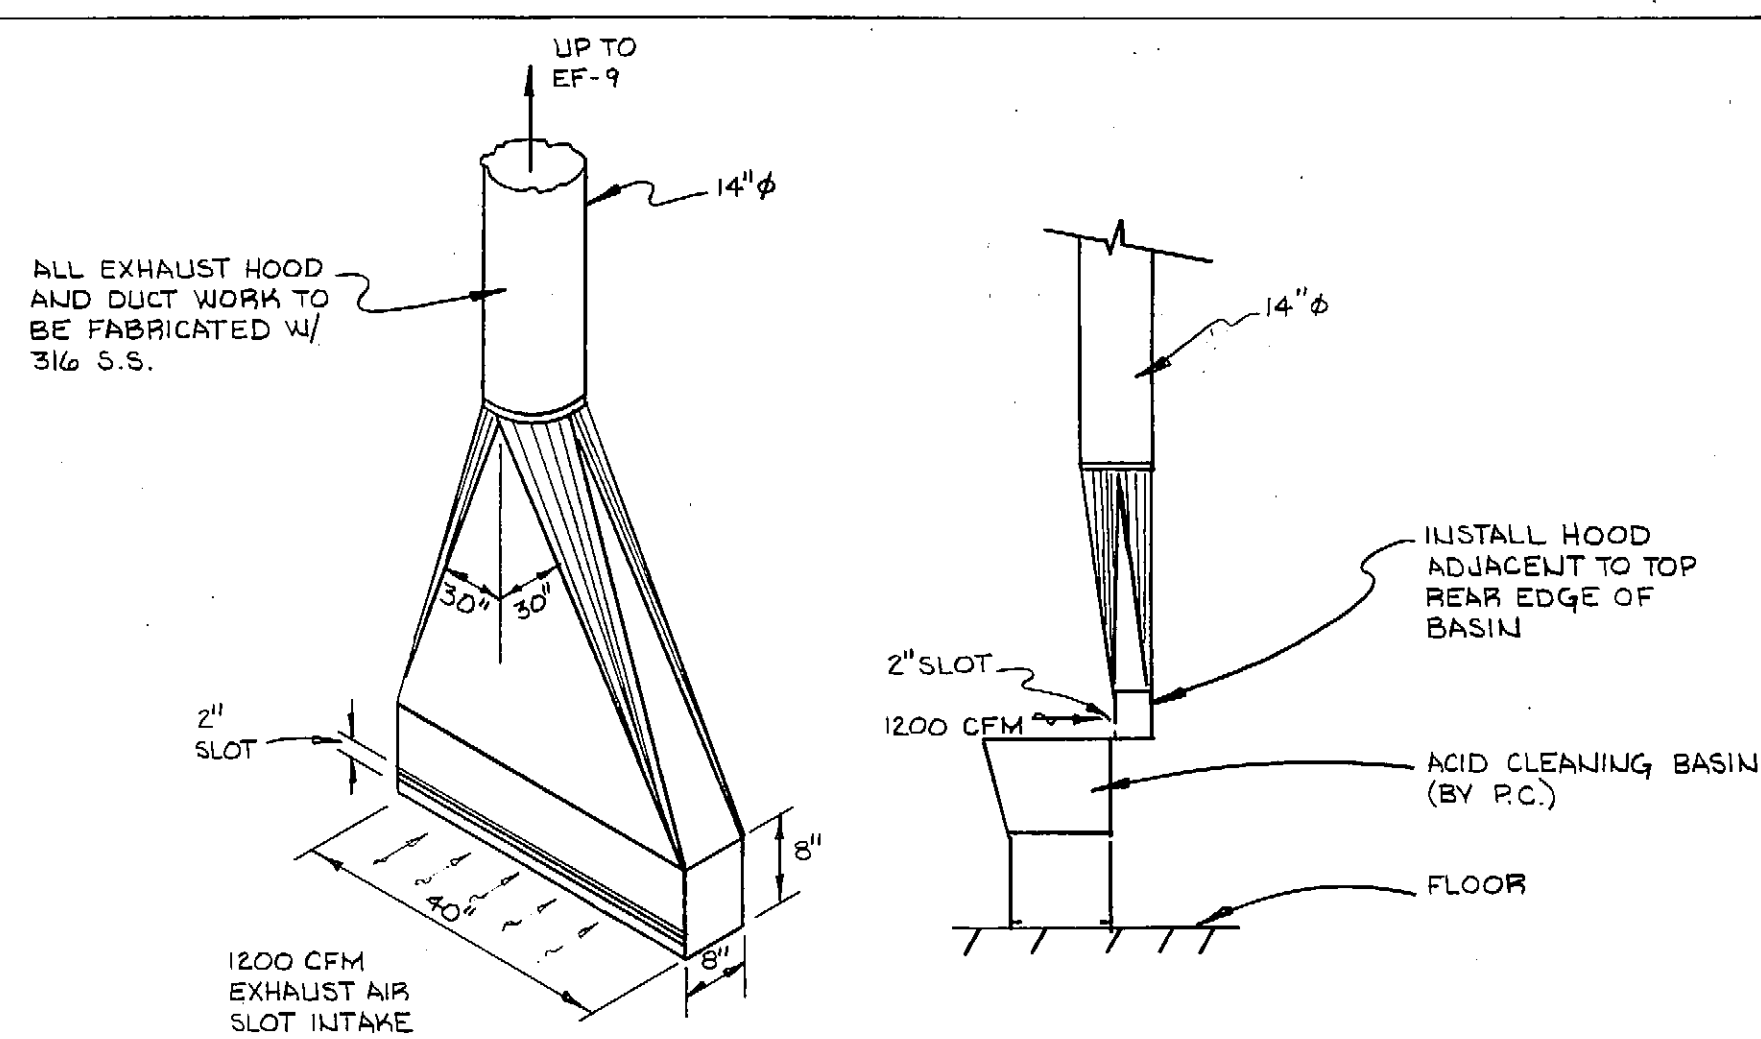


**1 H-2 ACID CLEANING EXHAUST HOOD DETAIL**  
NOT TO SCALE

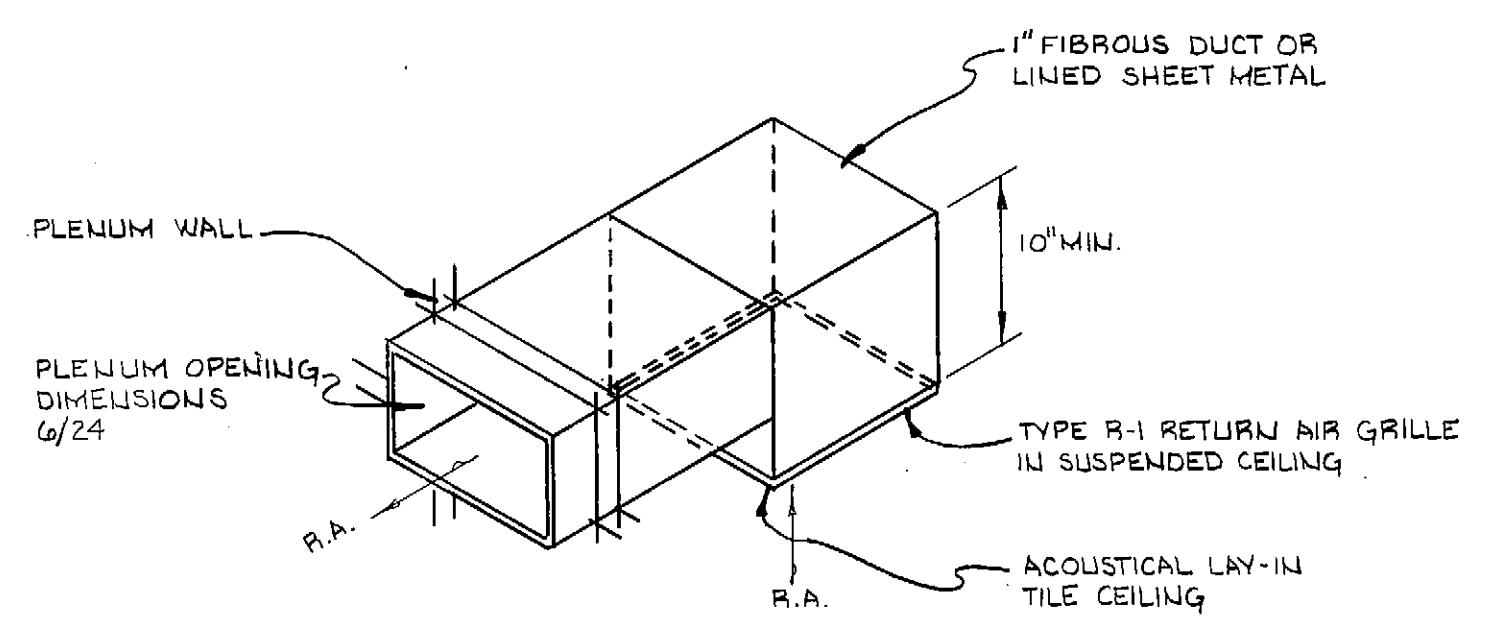


**2 H-2 FIELD FABRICATED R.A. ROOM TO PLENUM TRANSFER**  
NOT TO SCALE

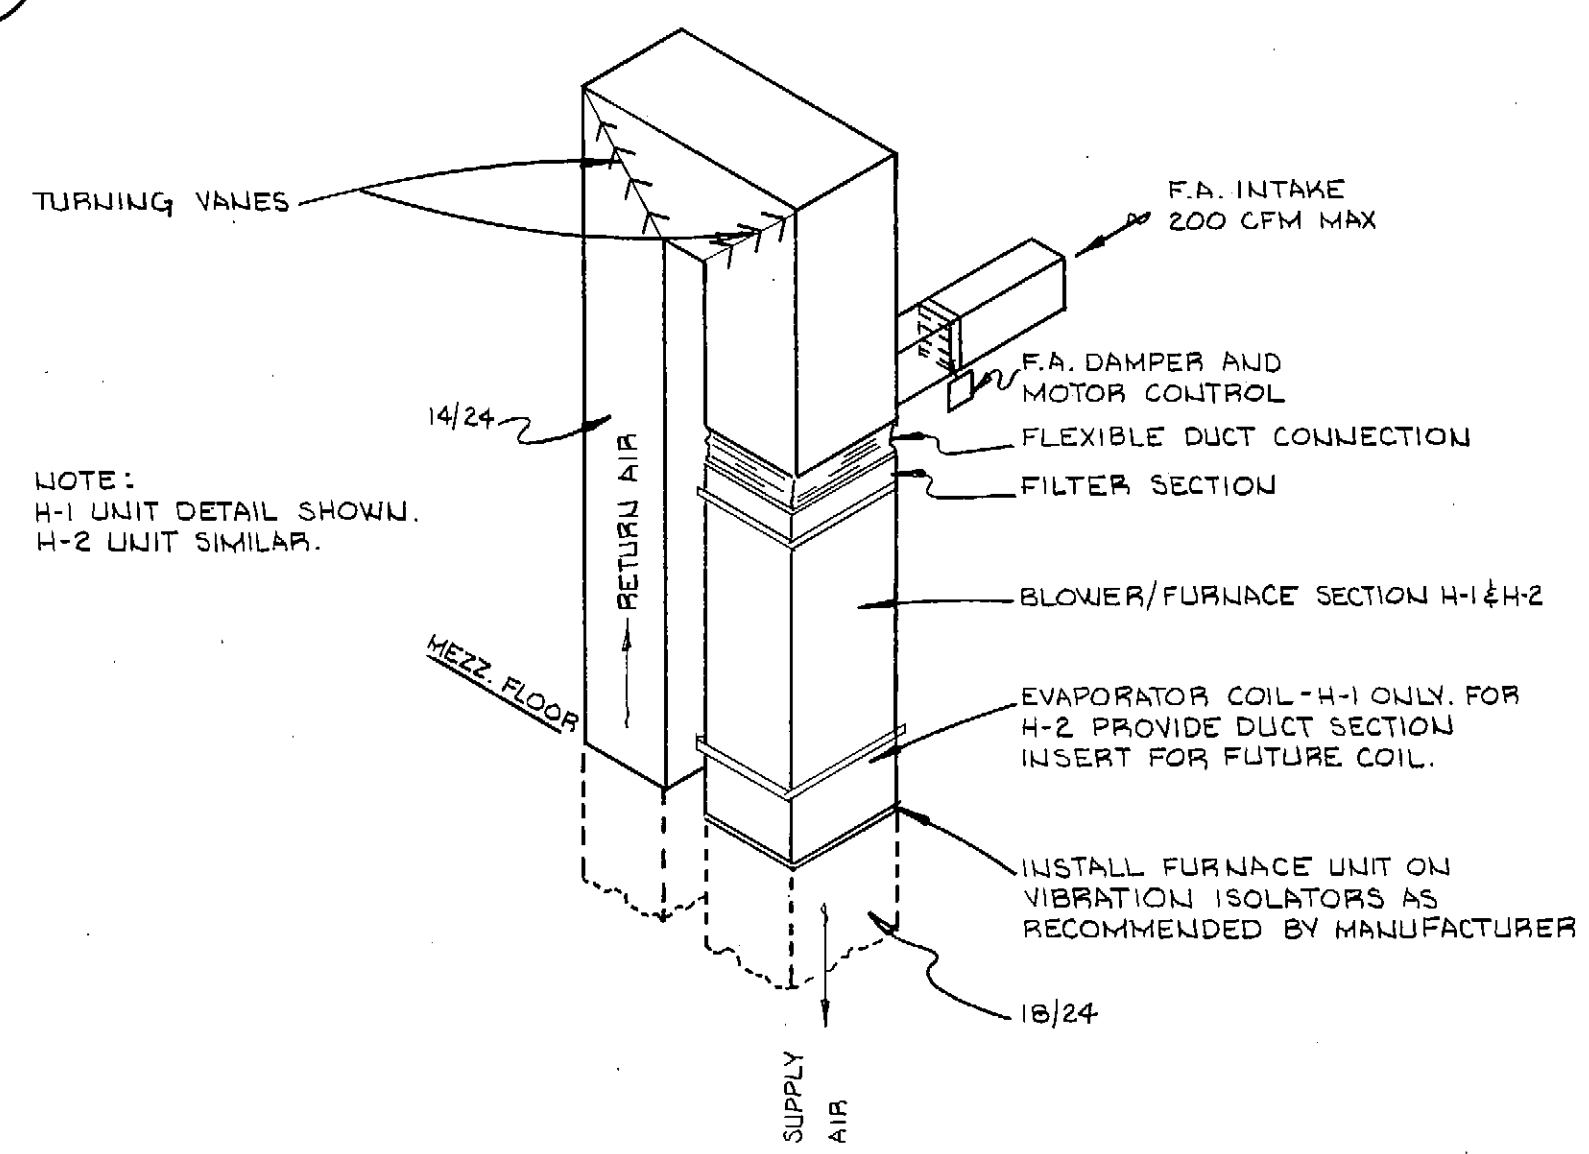


**3 H-2 FURNACE SYSTEM DETAIL**  
NOT TO SCALE

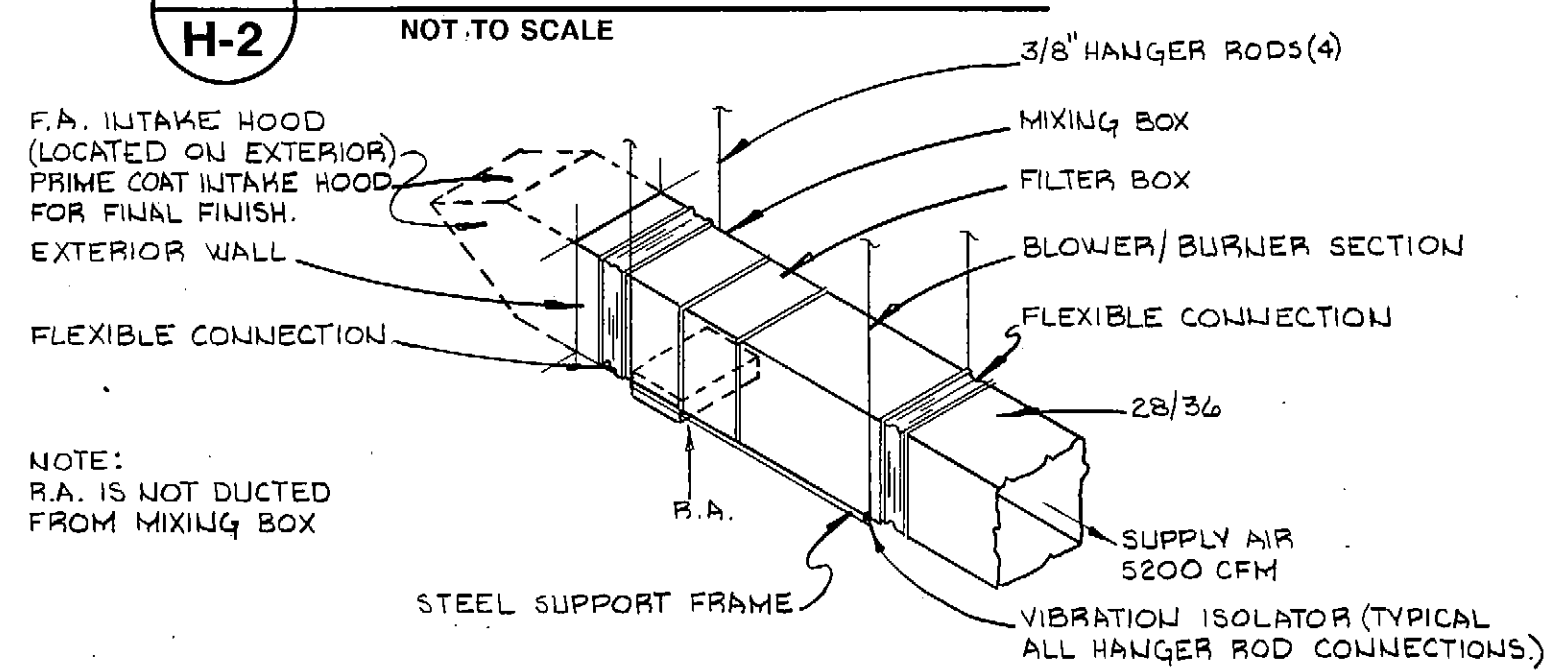


**4 H-2 MAKE-UP AIR SYSTEM DETAIL**  
NOT TO SCALE

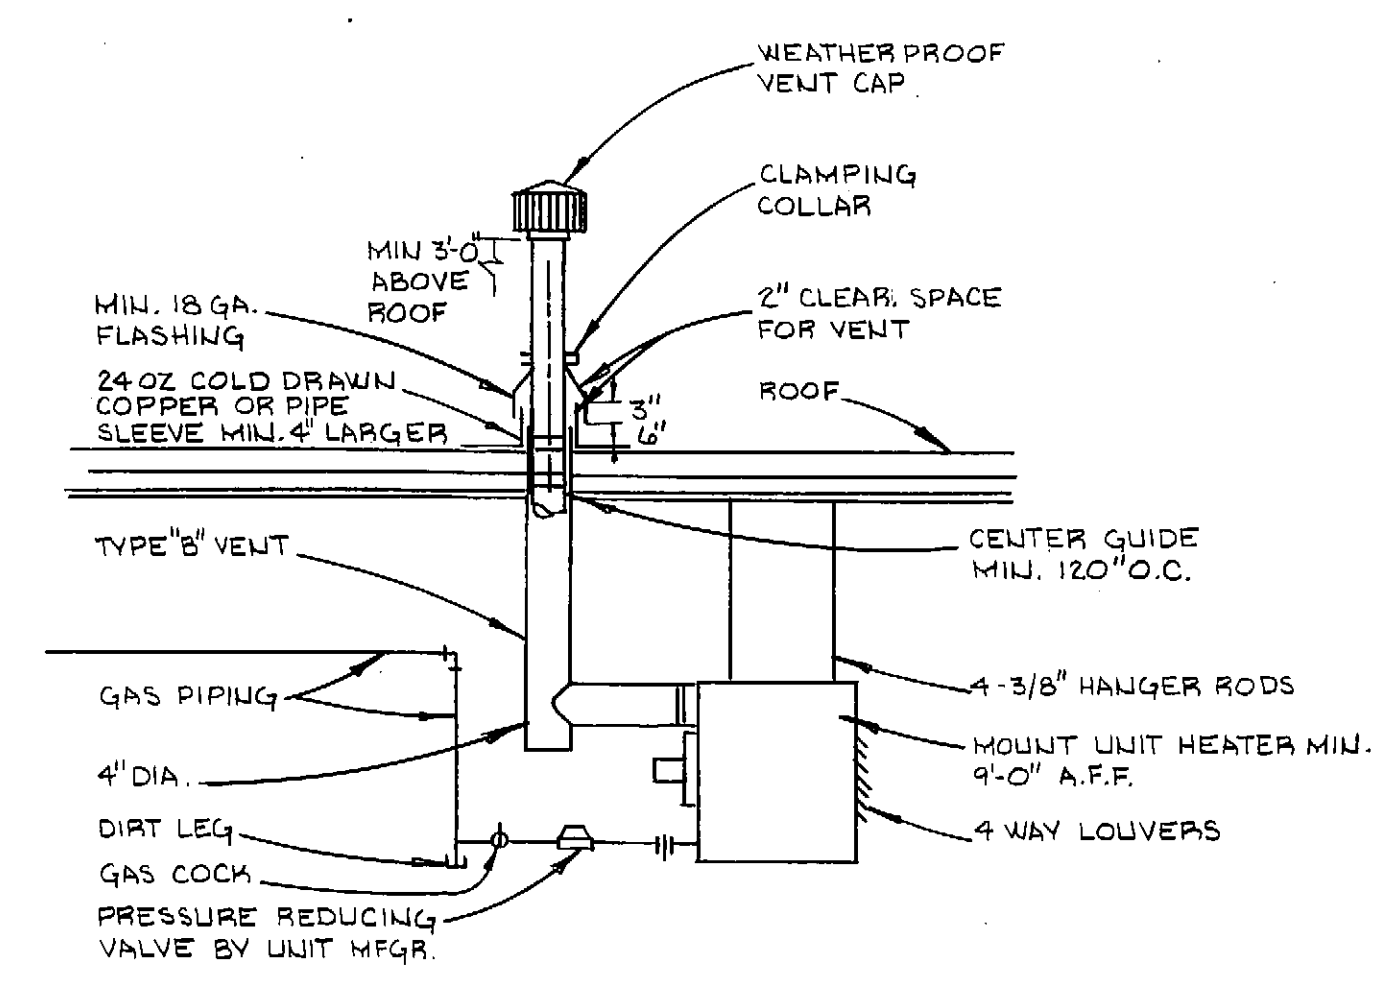


**5 H-2 UNIT HEATER DETAIL**  
NOT TO SCALE

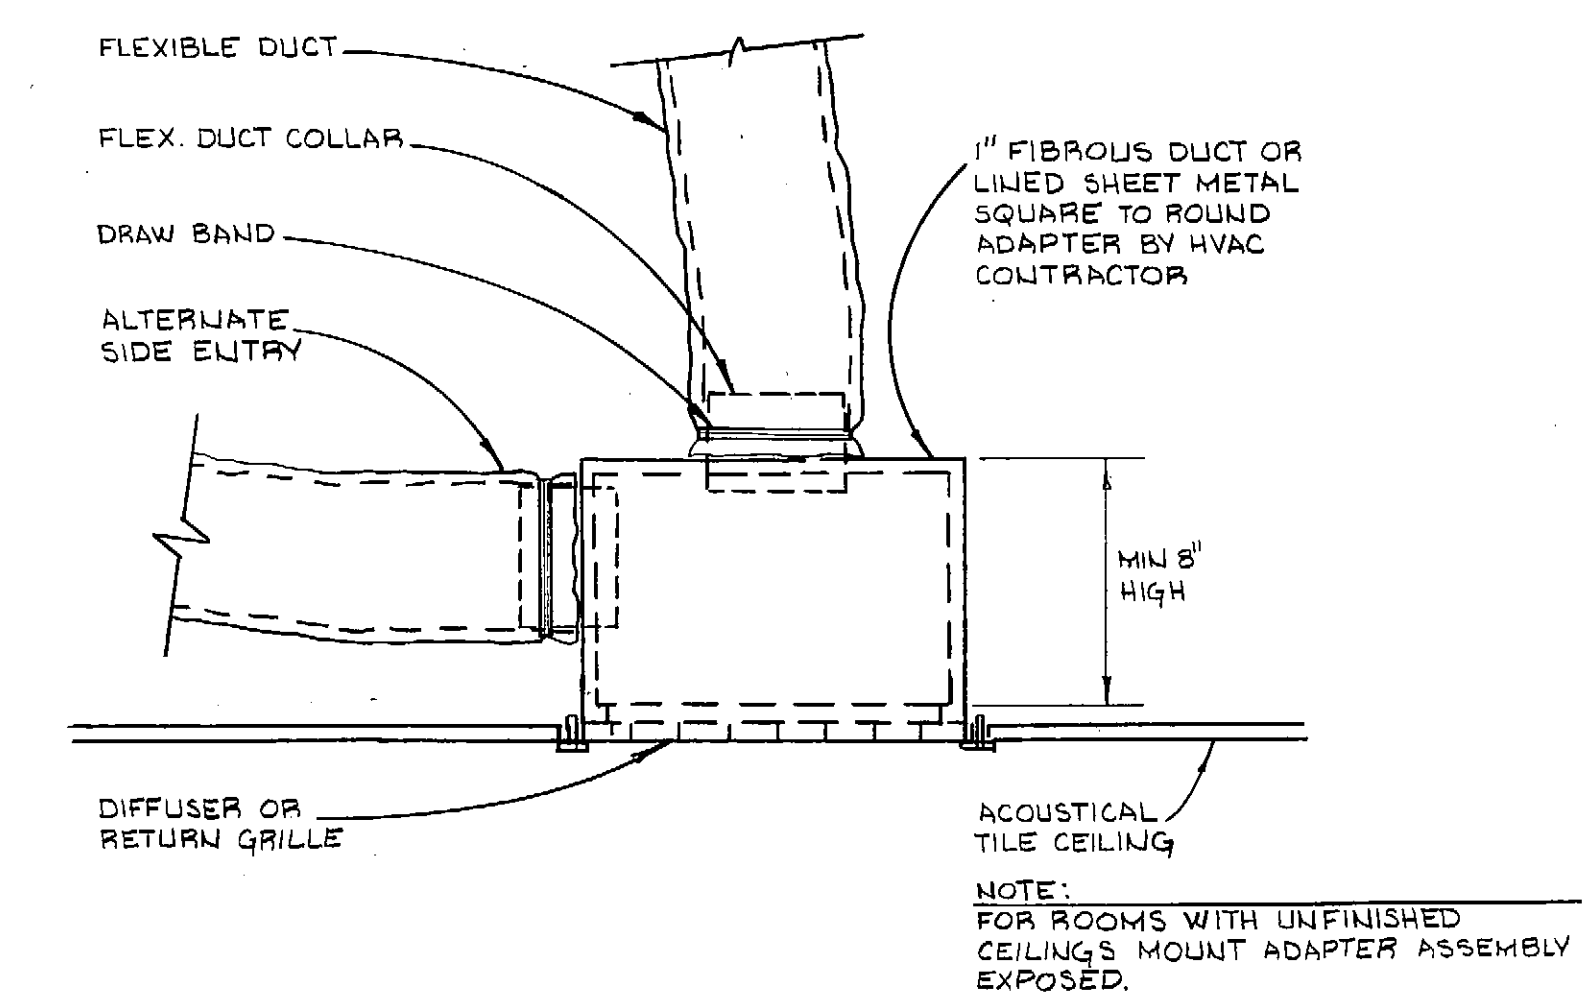


**6 H-2 FIELD FABRICATED SQUARE TO ROUND GRILLE CONNECTION DETAIL**  
NOT TO SCALE

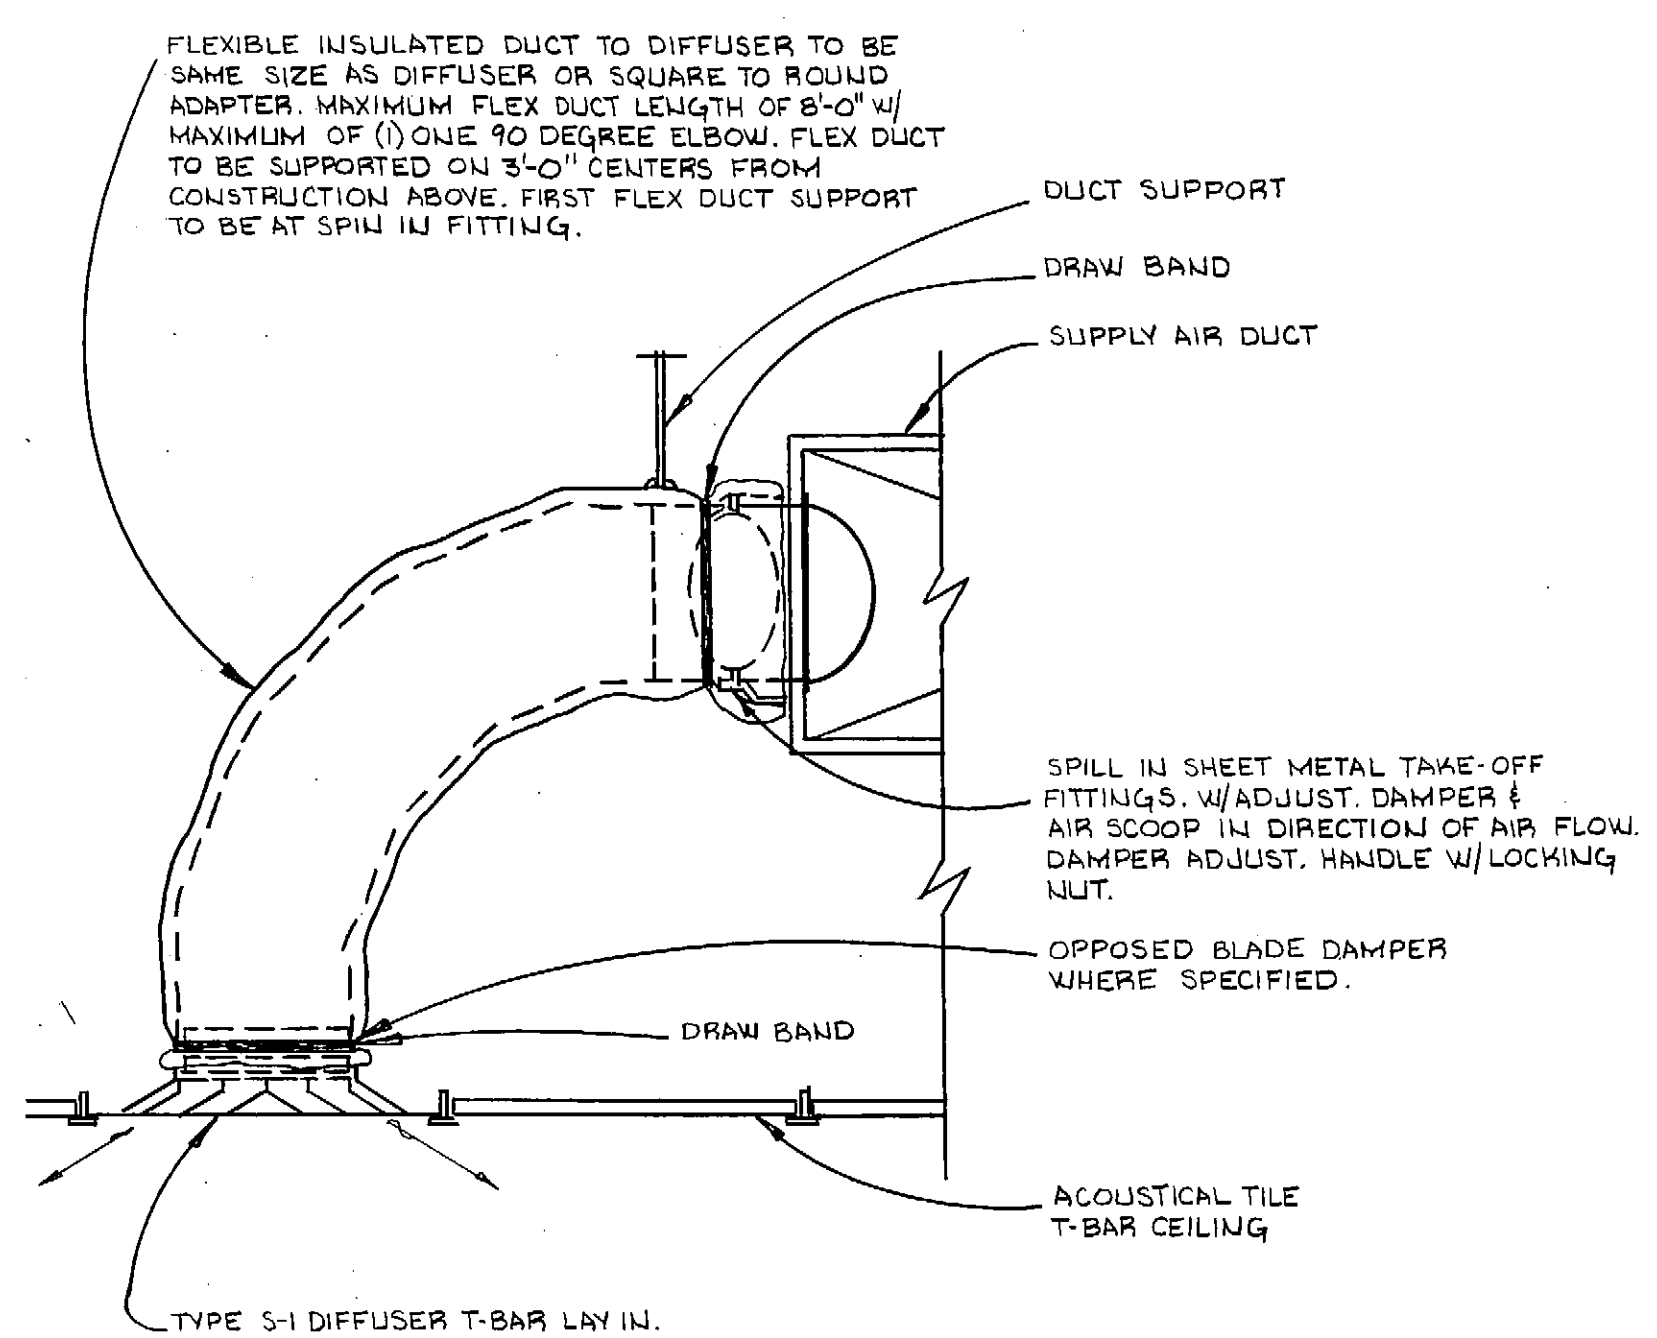


**7 H-2 BRANCH DUCT TAKE-OFF & DIFFUSER INSTALLATION DETAIL**  
NOT TO SCALE

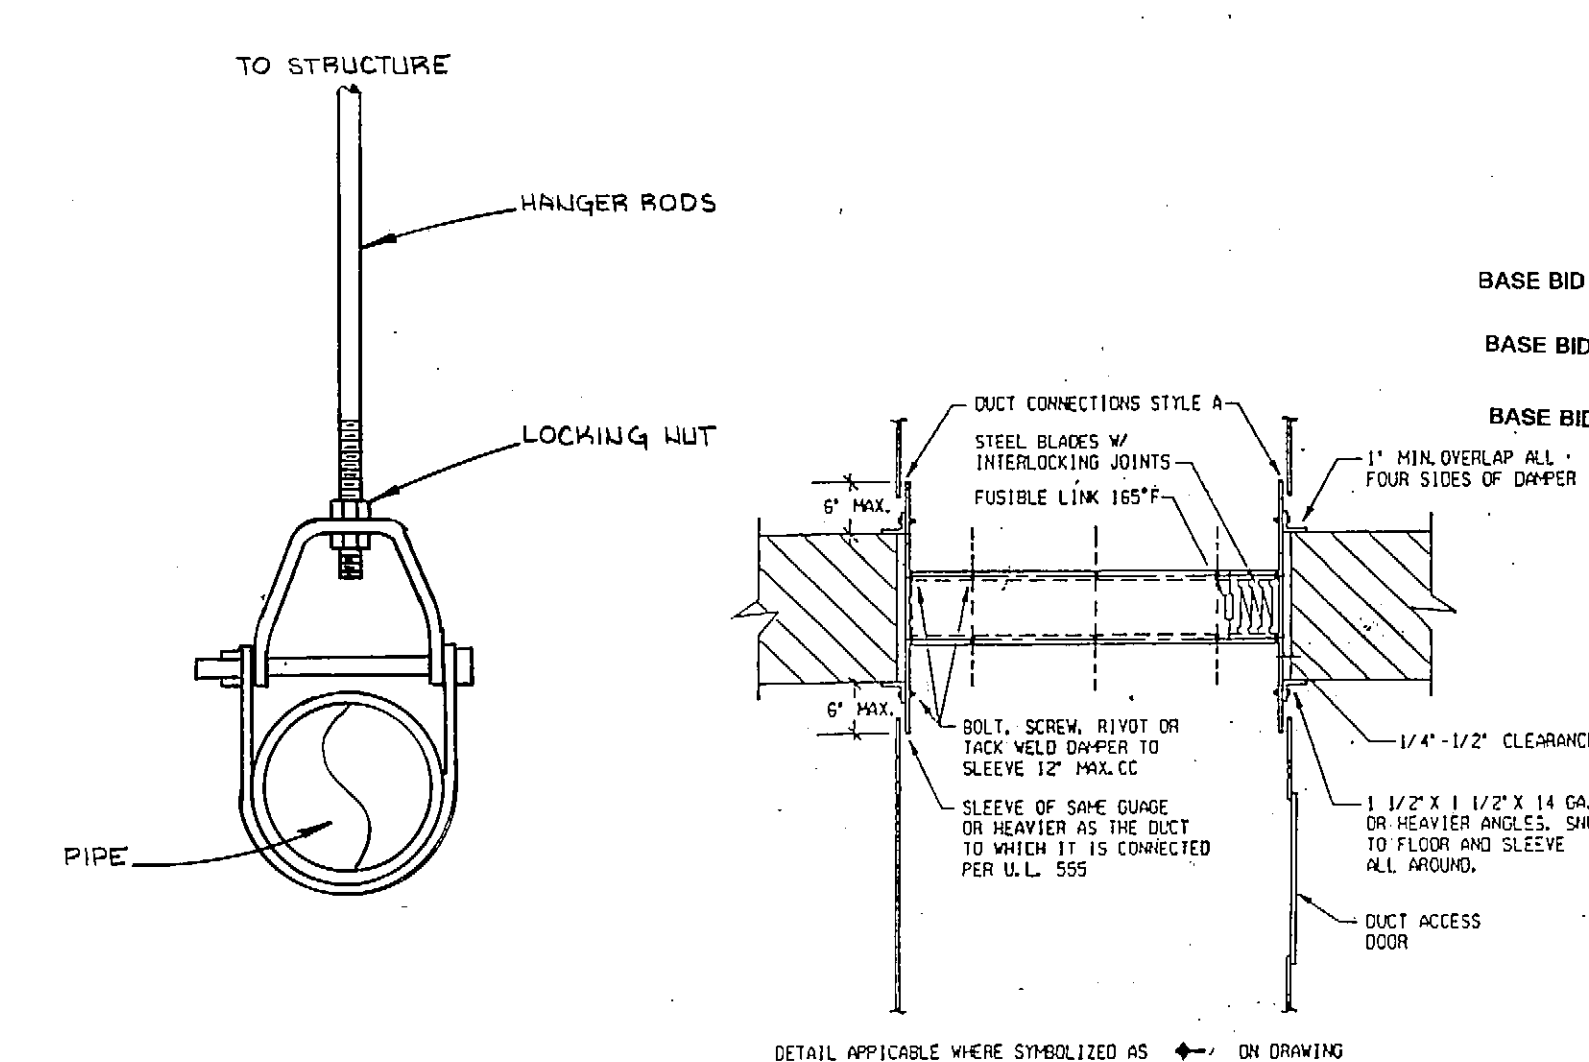

**8 H-2 CLEVIS HANGER PIPE SUPPORTS**  
NOT TO SCALE

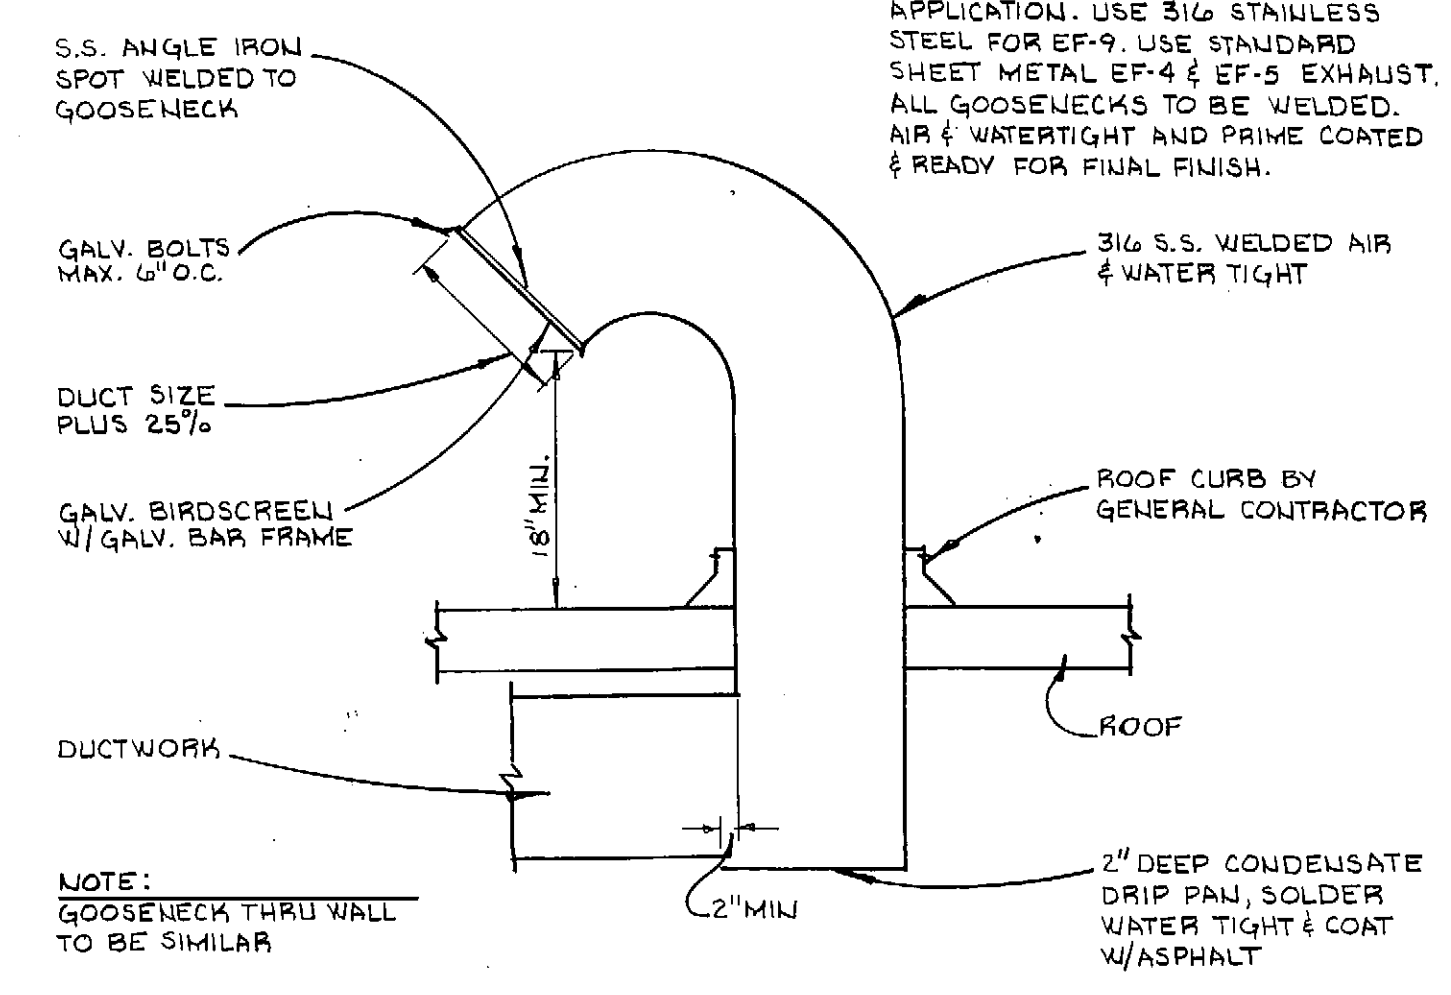


**9 H-2 RECTANGULAR GOOSENECK DETAIL**  
NOT TO SCALE

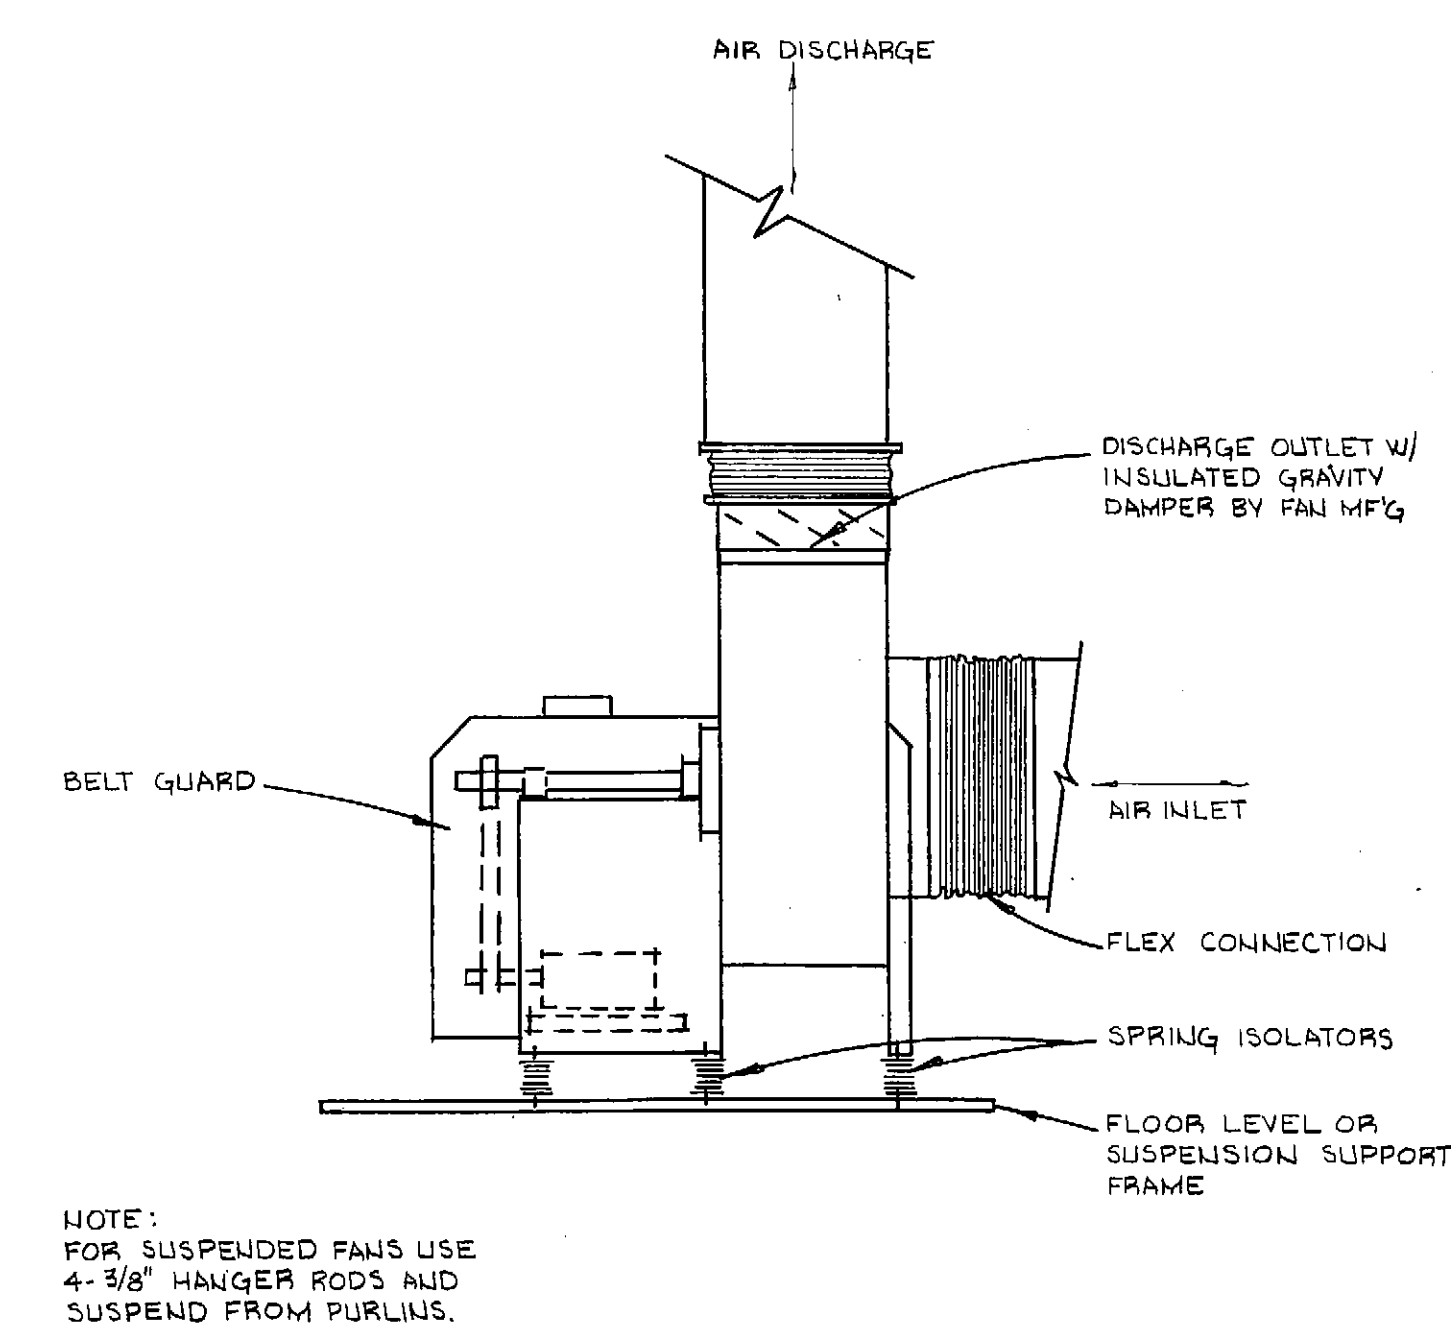


**10 H-2 UTILITY EXHAUST FAN DETAIL**  
NOT TO SCALE

| mech. equip. schedule |  |                  |                 |   |   |
|-----------------------|--|------------------|-----------------|---|---|
| i.d.                  | description  | manf.            | model           | elec. data                                    | remarks   |
| UH-1                  | Gas Fired Unit Heater<br>Input: 240 MBH<br>Output: 192 MBH                     | Reznor           | CEEEL 250       | 7-3A, 115V<br>1/4 H.P.                        | W/Thermostat &<br>4-way Louvers                 |
| UH-2                  | Gas Fired Unit Heater<br>Input: 220 MBH<br>Output: 176 MBH                     | Reznor           | CEEEL 225       | 6-4A, 115V<br>1/6 H.P.                        | W/Thermostat &<br>4-way Louvers                 |
| UH-3                  | Gas Fired Unit Heater<br>Input: 220 MBH<br>Output: 176 MBH                     | Reznor           | CEEEL 225       | 6-4A, 115V<br>1/6 H.P.                        | W/Thermostat &<br>4-way Louvers                 |
| EF-1                  | Belt Drive Centrifugal<br>Roof Mount Exhaust Fan<br>1600 CFM @ 0.375" SP       | Greenheck        | QB-14-4         | 1/3 H.P.,<br>115V                             | W/Backdraft<br>Damper                           |
| EF-2                  | Belt Drive Centrifugal<br>Roof Mount Exhaust Fan<br>800 CFM @ 0.375" SP        | Greenheck        | QB-9-4          | 1/4 H.P.,<br>115V                             | W/Backdraft<br>Damper                           |
| HAU-1                 | Direct Fired Make-up Air<br>Unit, 5200 CFM @ 0.5" S.P.<br>Heat Output: 50K MBH | Heater -<br>Rite | TOT 115         | 3 H.P.,<br>208V<br>3 phase                    | W/Intake Hood,<br>Mixing Box, Filter<br>Section |
| EF-3                  | Centrifugal Inline Fan<br>430 CFM @ 1/2" SP                                    | Greenheck        | CSP-60          | 5.0A, 115V                                    | W/Integral Backdraft<br>Damper                  |
| EF-4                  | Utility Fan<br>800 CFM @ 1-3/4" SP   | Peerless         | 10SD            | 1/2 H.P.,<br>208V, 3P                         | W/Automatic Discharge<br>Shutter & Belt Guard   |
| EF-5                  | Utility Fan<br>800 CFM @ 1-3/4" SP   | Peerless         | 10SD            | 1/2 H.P.,<br>208V, 3P                         | W/Automatic Discharge<br>Shutter & Belt Guard   |
| C-1                   | Condensing Unit<br>Cooling Capacity: 47,500<br>BTUH                            | Lennox           | HS16-S11V       | 208V, 1 phase<br>50A Cir. Bkr.<br>32A Circuit | W/Timer Off Control                             |
| EC-1                  | Evaporator Coil<br>Down Flow   | Lennox           | CR16-S1-FF      | -   | Expansion Valve Kit<br>18-53081CC               |
| H-1                   | Gas Fired Downflow Furnace<br>1600 CFM @ 0.75" SP                              | Lennox           | GSR14Q4/S-80    | 3/4 H.P.,<br>115V                             | Htg. Input: 80 MBH<br>Htg. Output: 72 MBH       |
| H-2                   | Gas Fired Downflow Furnace<br>1600 CFM @ 0.75" SP                              | Lennox           | GSR14Q4/S-80    | 3/4 H.P.,<br>115V                             | Htg. Input: 80 MBH<br>Htg. Output: 72 MBH       |
| EF-6                  | Toilet Room Exhaust Fan<br>94 CFM @ 1.0" SP                                    | Greenheck        | SP-8            | .60A,<br>115V                                 | W/Wall Cap Vent<br>MCSF                         |
| EF-7                  | Conf. Rm. Exhaust Fan<br>200 CFM @ .125" SP                                    | Greenheck        | SP-25           | 1.0A,<br>115V                                 | W/Speed Control &<br>W/SP Wall Discharge        |
| EF-8                  | Test Room Ventilation Fan<br>800 CFM @ .375" SP                                | Greenheck        | SP-60           | 5.0A,<br>115V                                 | W/Speed Control &<br>W/60 Wall Discharge        |
| EF-9                  | Hood Exhaust Fan<br>1200 CFM @ 1-1/4" SP                                       | Peerless         | 10SE            | 3/4 H.P.,<br>208V, 3P                         | W/Heresite Coating                              |
| EF-10                 | Wall Exhaust Fan<br>1000 CFM @ 3/8" SP   | Greenheck        | GWR 14-4        | 1/4 H.P.,<br>115V                             | W/14"x14" Relief, Damp                          |
| BB-1                  | Electric Baseboard Htr.  | Cadet            | 2 Ft. @ 250 Wt. | 500W @<br>208V                                | W/Integral Thermostat                           |
| UH-4                  | GAS FIRED UNIT HTR.<br>INPUT 30 MBH<br>OUTPUT 24.7 MBH                         | REZNOR           | CEEEL 30        | 2.3A, 115V<br>1/30 H.P.                       | W/THERMOSTAT<br>4-WAY LOUVERS.                  |

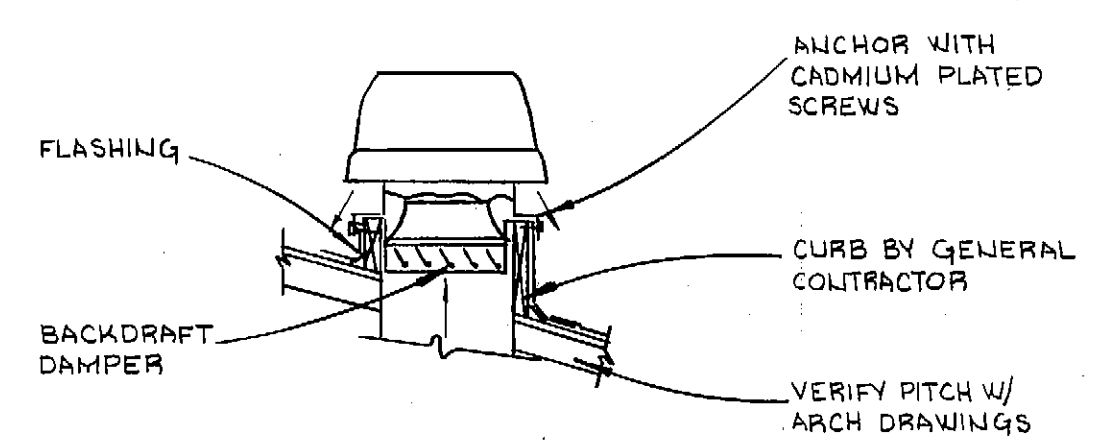


**11 H-2 FIRE DAMPER AT FLOOR DETAIL**  
NOT TO SCALE


**12 H-2 ROOF VENTILATOR DETAIL**  
NOT TO SCALE

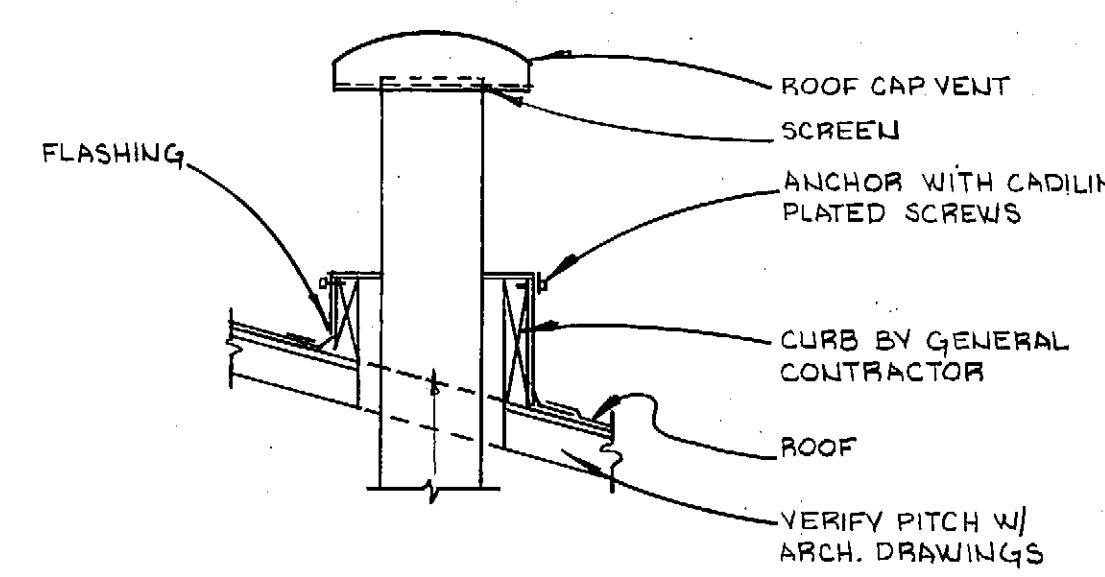

**13 H-2 ROOF CAP TYPE VENT DETAIL**  
NOT TO SCALE

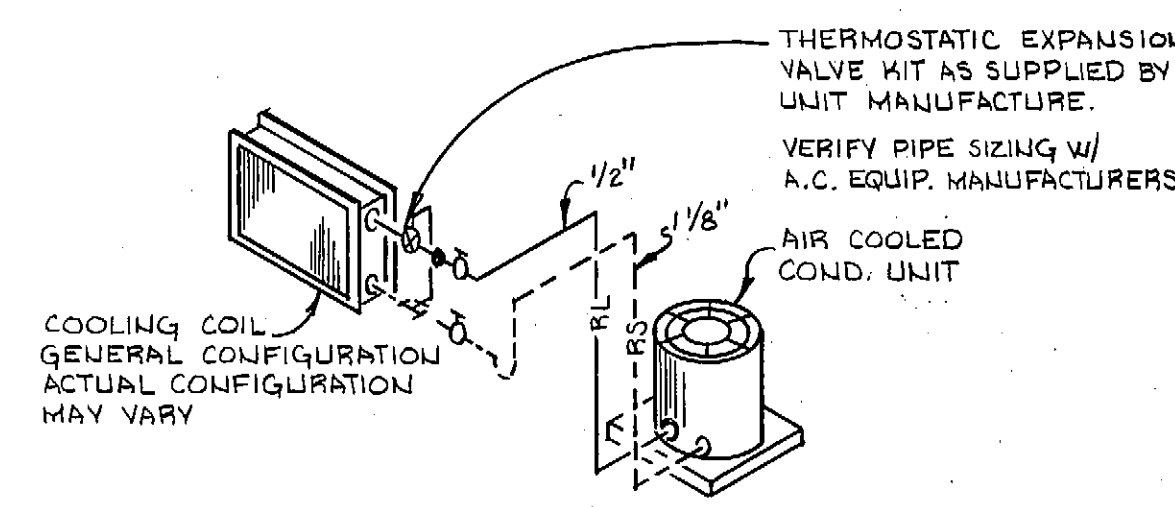

**14 H-2 AIR COOLED CONDENSING UNIT & COOLING COIL CONNECTION DETAIL**  
NOT TO SCALE

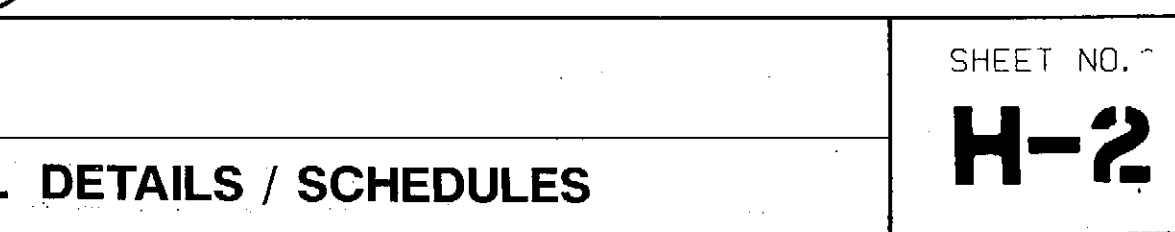

REVISIONS

| NO. | DESCRIPTION | DATE | BY | NO. | DESCRIPTION | DATE | BY |
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**Foth & Van Dyke**  
Engineers / Architects


**FITCHBURG UTILITY BUILDING**

**H.V.A.C. DETAILS / SCHEDULES**


SHEET NO. **H-2**




| mech. equip. schedule ALTERNATE #1 BID |  |                              |               |            |               |
|--|--|------------------------------|---------------|------------|---------------|
| i.d.                                   | description  | manf.                        | model         | elec. data | remarks       |
| RH-1                                   | Gas Fired Infra-Red Radiant Tube Type Heater<br>output: 75,000 BTUH ea.  | Detroit Radiant Products Co. | DTH 20 - 75N  | 4.8A, 115V | 3 Units Req'd |
| RH-2                                   | Gas Fired Infra-Red Radiant Tube Type Heater<br>output: 100,000 BTUH ea. | Detroit Radiant Products Co. | DTH 40 - 100N | 4.8A, 115V | 4 Units Req'd |
| RH-3                                   | Gas Fired Infra-Red Radiant Tube Type Heater<br>output: 40,000 BTUH ea.  | Detroit Radiant Products Co. | DTH 20 - 40N  | 4.8A, 115V | 1 Unit Req'd  |
|  |  |                              |               |            |               |
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- NOTES:**
1. ALL THERMOSTATS ARE TO BE MOUNTED AT STANDARD MOUNTING HEIGHTS ON FIRST FLOOR LEVEL.
  2. ALL VENTS TO BE TYPE "B" SUITABLE FOR NATURAL GAS.
  3. ALTERNATE #1: INSTALL GAS FIRED INFRA-RED TUBE HEATERS AS SHOWN THIS SHEET IN LIEU OF UNIT HEATERS UH-1, UH-2, UH-3. UNIT HEATERS ARE TO BE BASE BID. SEE SHEET H-1.
  4. ALL RADIANT HEATERS ARE TO BE MOUNTED AS HIGH A.F.F. AS POSSIBLE BUT STILL MAINTAIN REQUIRED CLEARANCES FROM COMBUSTIBLES.

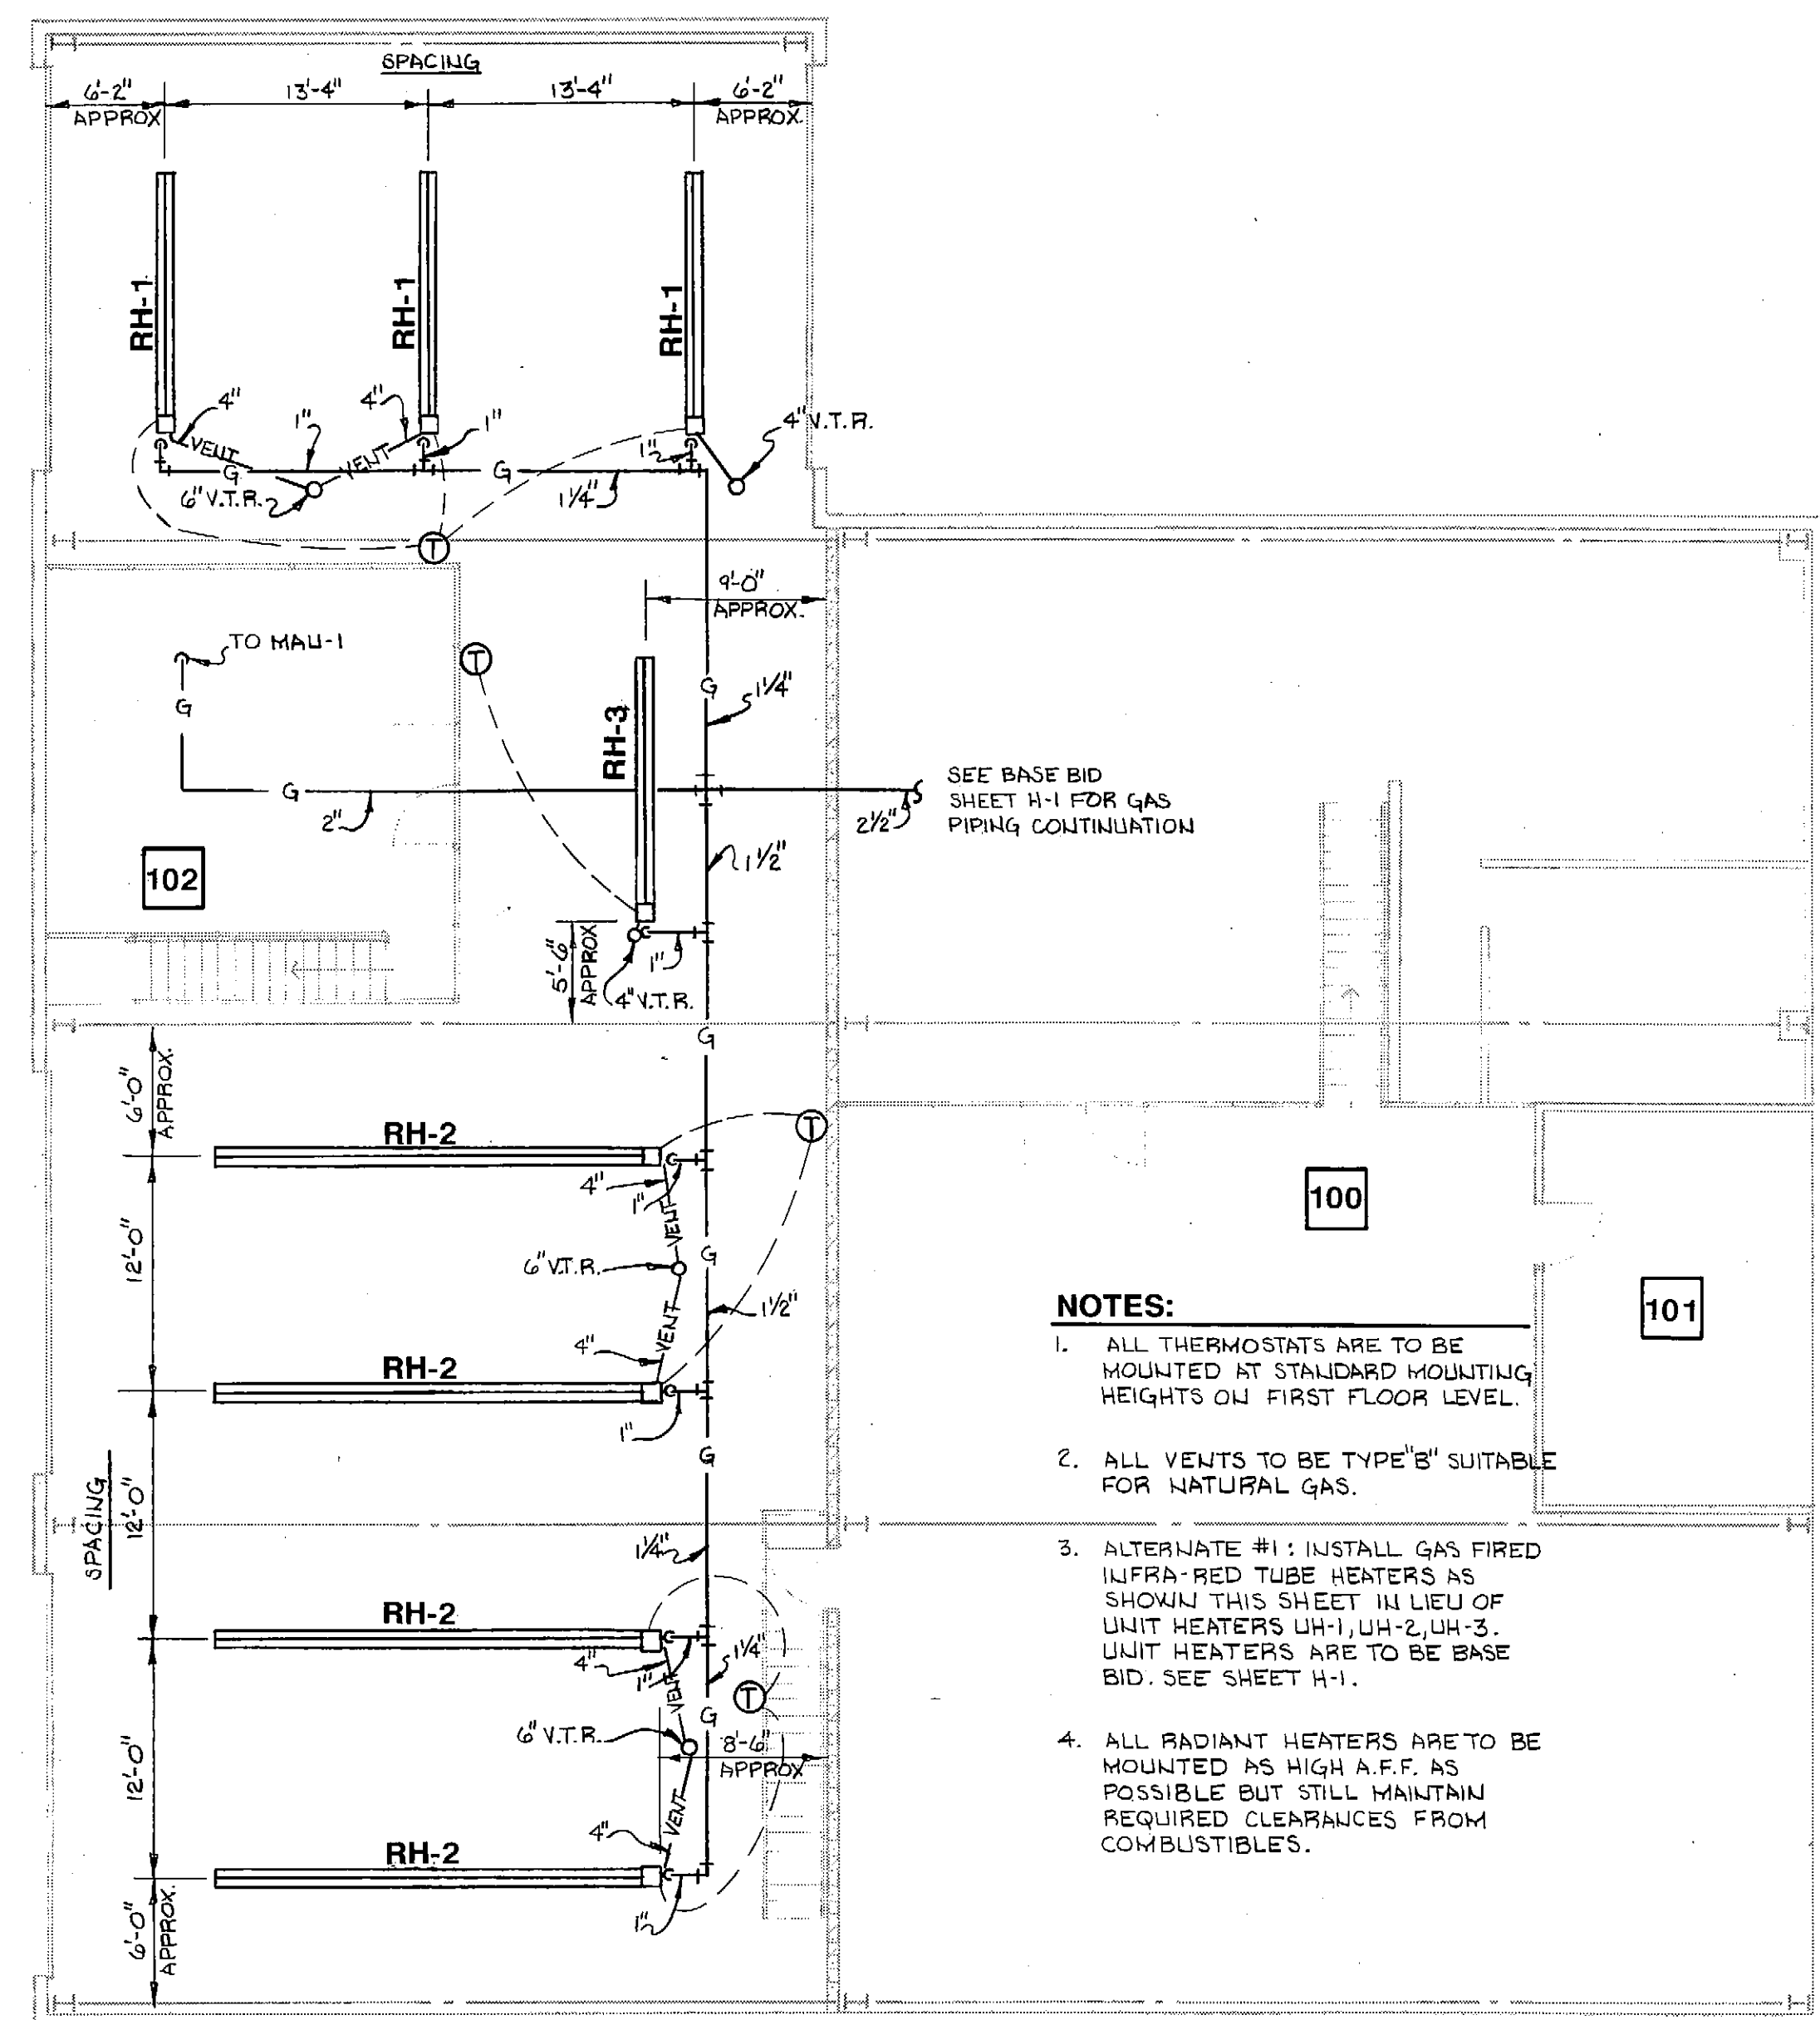

**1 RADIANT HEATER DETAIL**  
NOT TO SCALE

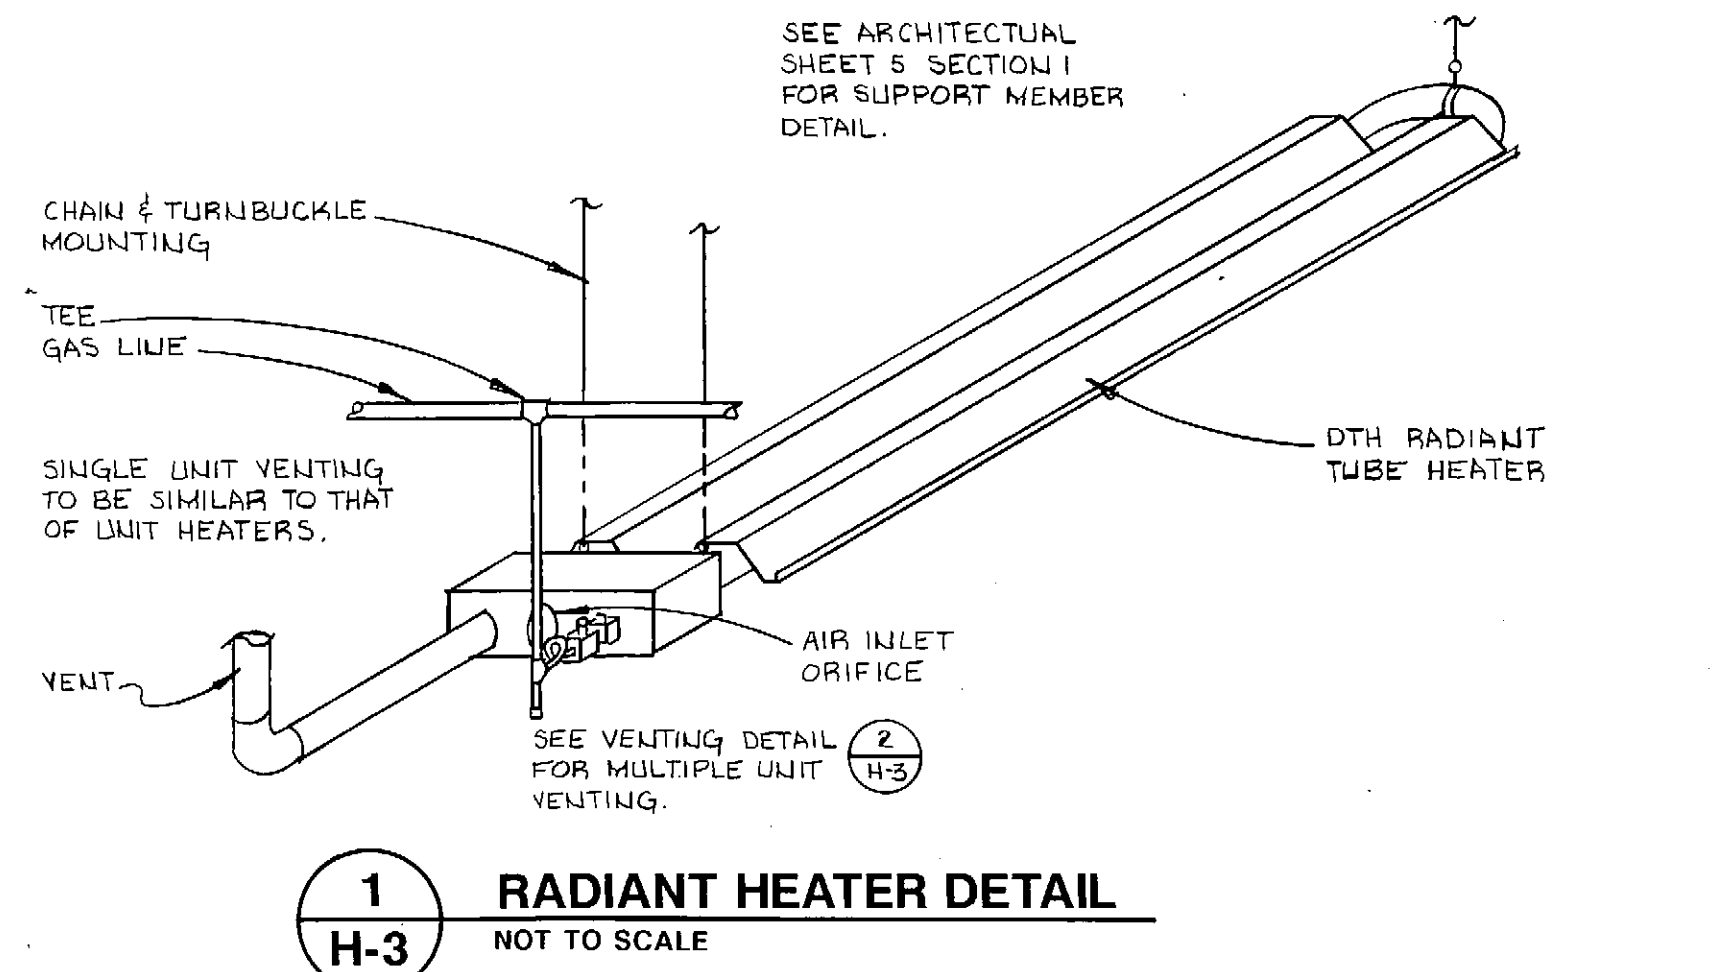


**2 GAS FIRED INFRA-RED UNIT VENTING DETAIL**  
NOT TO SCALE

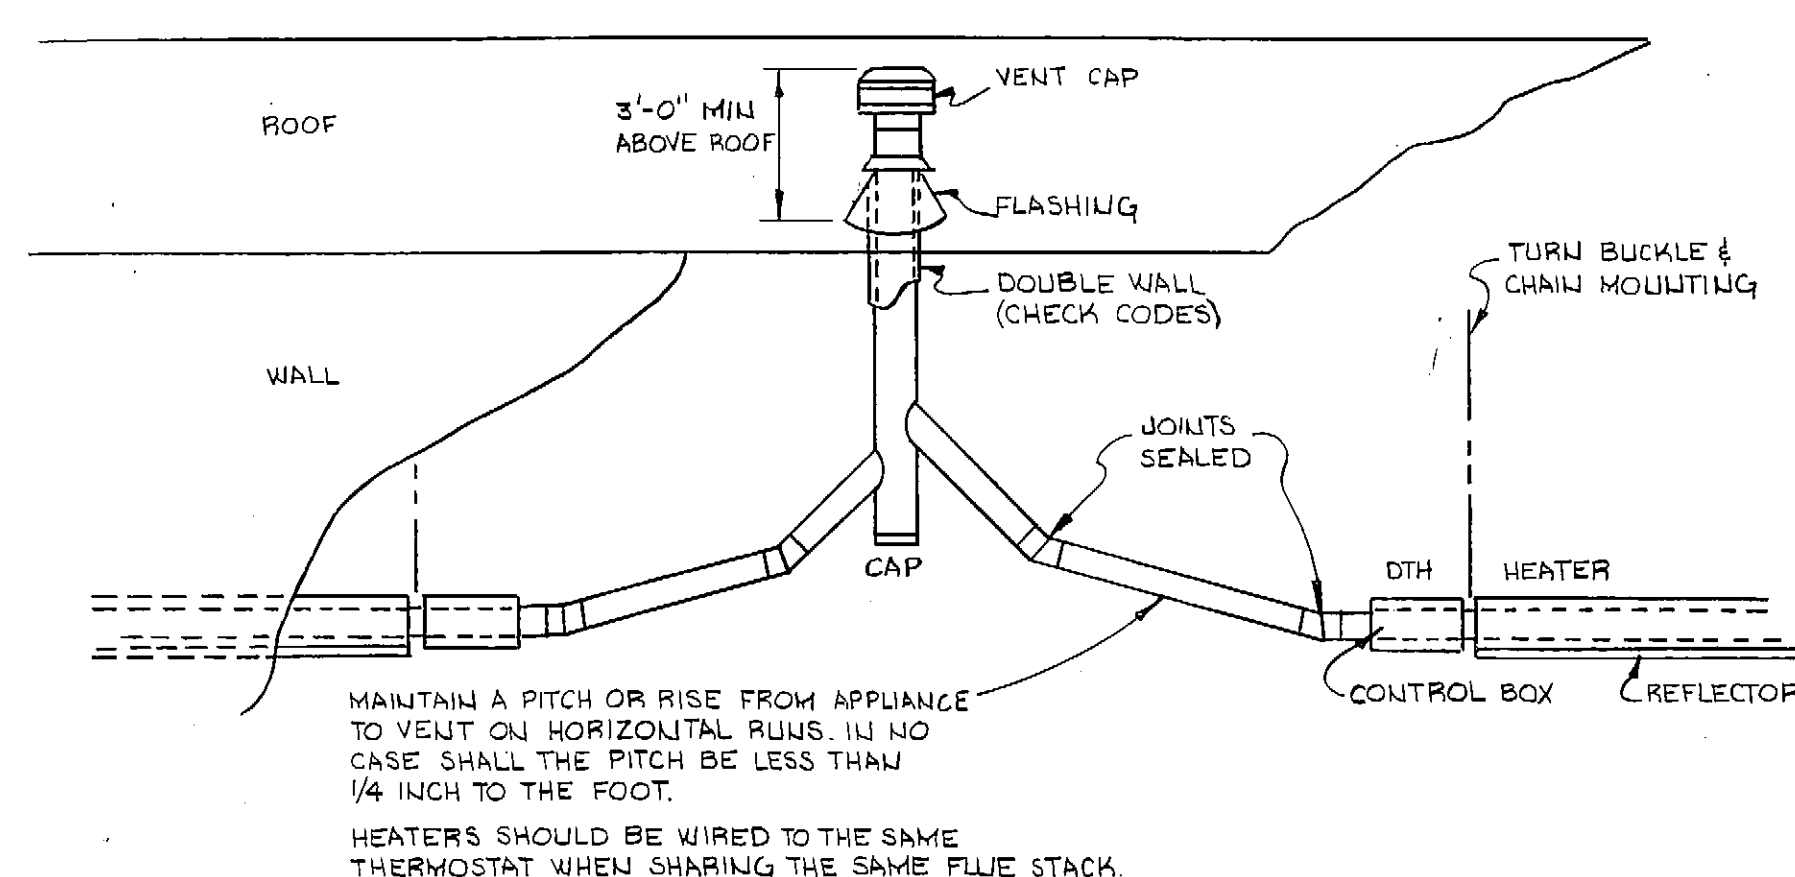**1 UPPER LEVEL PLAN ALTERNATE #1 BID - RADIANT HEAT**  
SCALE: 1/8" = 1'-0"



1. CIRCUITS TO RECEPTS NOT SHOWN, PROVIDE CIRCUITS BACK TO PANEL "A" (MAX. OF 3 RECEPT/CRKLT. IN SHOP. TOOL RM. & GARAGE; 6 RECEPT'S MAX./CRKLT. ELSEWHERE).
2. FIRE ALARM CIRCUITS NOT SHOWN, PROVIDE CIRCUITS BACK TO FA/CP PNL. RACEWAY SHALL BE 1/2".
3. TELEPHONE RACEWAY NOT SHOWN, PROVIDE 3/4" C FROM OUTLET TO SPACE ABOVE CEILING IN FINISHED AREAS, & 3/4" C FROM OUTLET TO PNL. IN UNFINISHED AREAS.
4. PROVIDE SPARE 2" C FROM TOP OF PNL. TO CEILING & STUB THRU NORTH WALL, & 2-1" C FROM BOTTOM OF PNL. & STUB THRU FLOOR TO CL. SPACE BELOW.
5. PROVIDE 2-1" C STUBBED THRU FLOOR (1 AS SPARE), & 1-2" C SERVICE ENTRANCE W/1" #10 GND. RUN IN WALL & STUB 2' BELOW GRADE. BOND GND. WIRE TO BLDG. AND WIRE.
6. CAP SPARE CONDUITS.
- 7-17. STUB 3/4" C THRU WALL ABOVE SUSPENDED CEILING FOR FUTURE ANTENNA. PROVIDE 3/4" C TO TELEPHONE OUTLET BOX.
18. RECEPT'S IN GARAGE, TOOL RM., OUTSIDE & METER TEST CELL TO BE SUPPLIED BY GFI CB'S IN PANEL "A".  
(SEE GFI CB'S IN PANEL "A")
- 19- SEE MEC. DWG'S SHEET H-3 FOR ALTERNATE BID-1 FOR RADIANT HEATERS.  
- IF ALTERNATE BID IS ACCEPTED, PROVIDE CIRCUITS TO HEATER LOCATIONS  
- IN LIEU OF UH-1, 2 & 3.
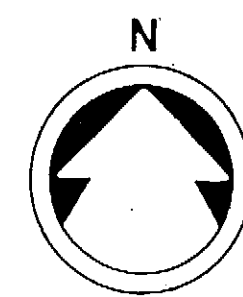
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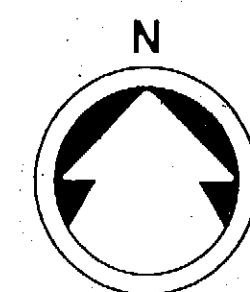
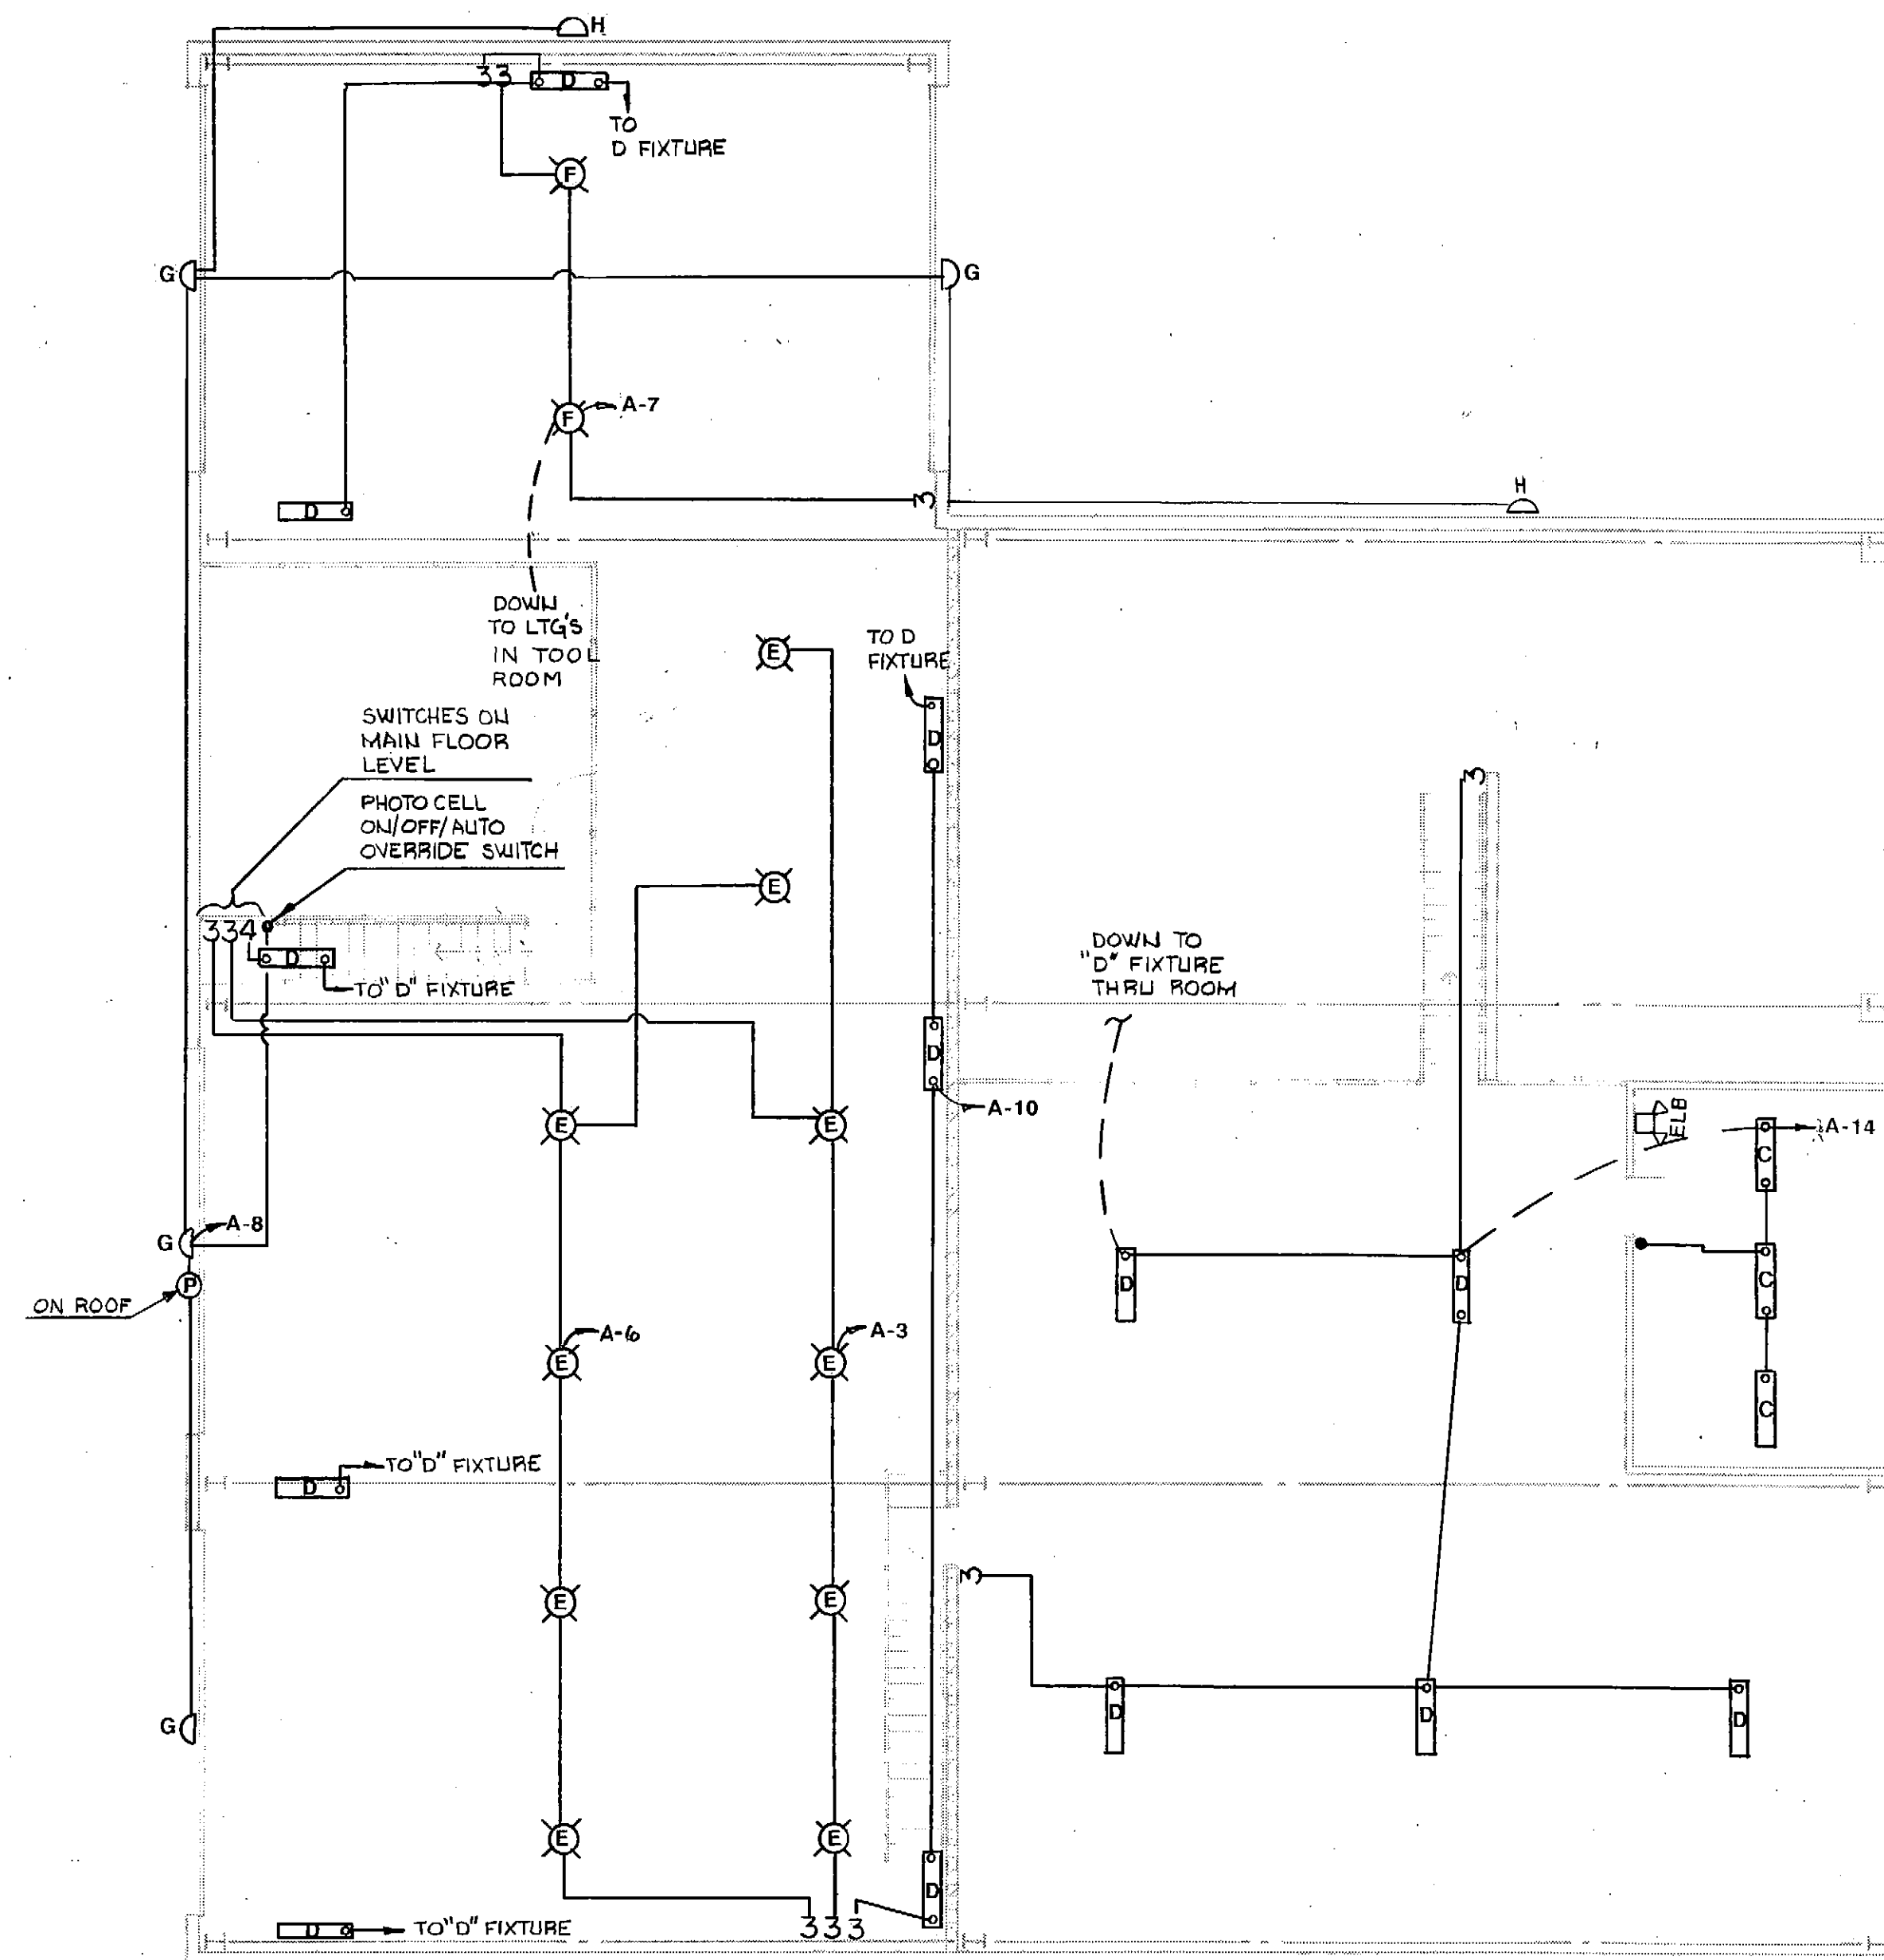
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| TELEPHONE POST<br>NAMES | REVISIONS |             |      |    |     |             |      |    | FILE NO.    | 2414     | PROJECT REVIEW |         |        |        |
|                         | NO.       | DESCRIPTION | DATE | BY | NO. | DESCRIPTION | DATE | BY | SURVEYED BY | PDP1 JSF |                |         |        |        |
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|                         | △         |             |      |    | △   |             |      |    | DATE        | BB F40   | REVIEW         | 4/30/89 | REVIEW | DATE   |
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SHEET NO.  
E-2




# NOTES:

1. CIRCUIT FOR EMERGENCY LIGHTS & EXIT LIGHTS NOT SHOWN. PROVIDE CIRCUIT FOR THESE LIGHTS BACK TO PNL."A".



**1 UPPER LEVEL PLAN - LIGHTING**  
SCALE: 1/8" = 1'-0"

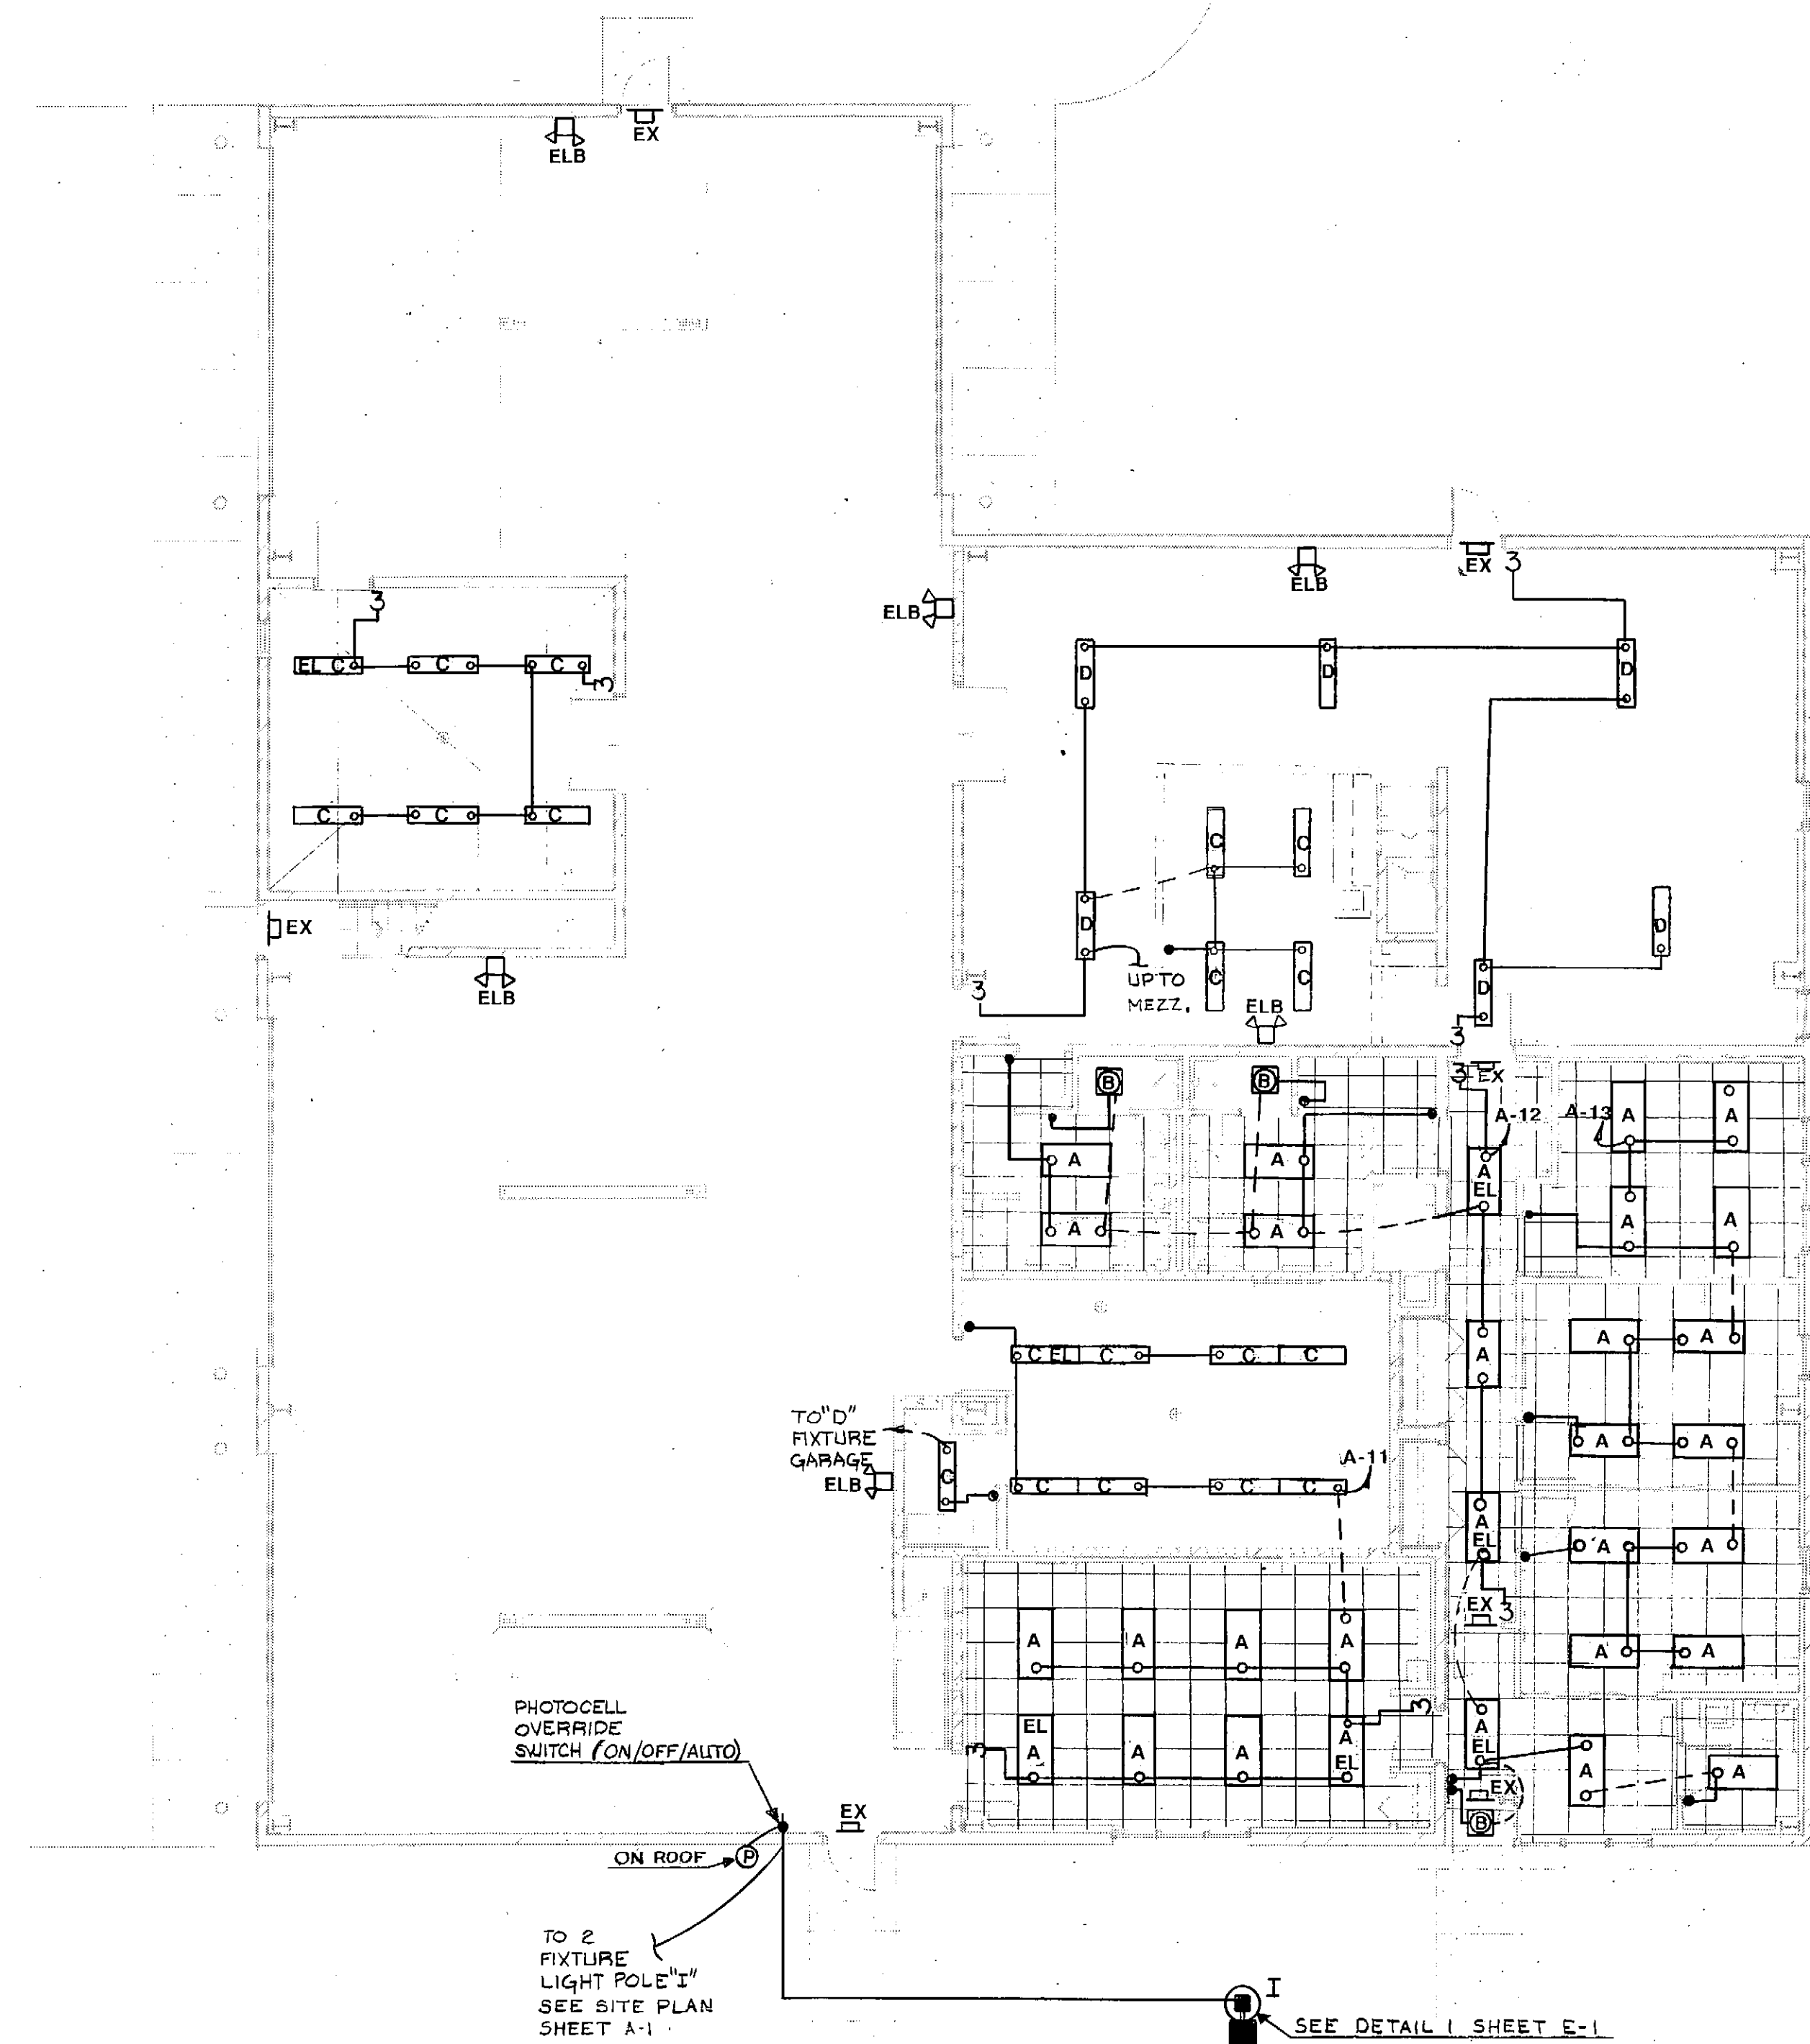

**2 MAIN FLOOR PLAN - LIGHTING**  
SCALE: 1/8" = 1'-0"

| REVISIONS |             |      |    |     |             |      | PROJECT REVIEW |      |      |      |
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**Foth & Van Dyke**  
Engineers / Architects

**FITCHBURG UTILITY BUILDING**

**LIGHTING PLAN**

SHEET NO.  
**E-3**