
FITCHBURG UTILITY BUILDING

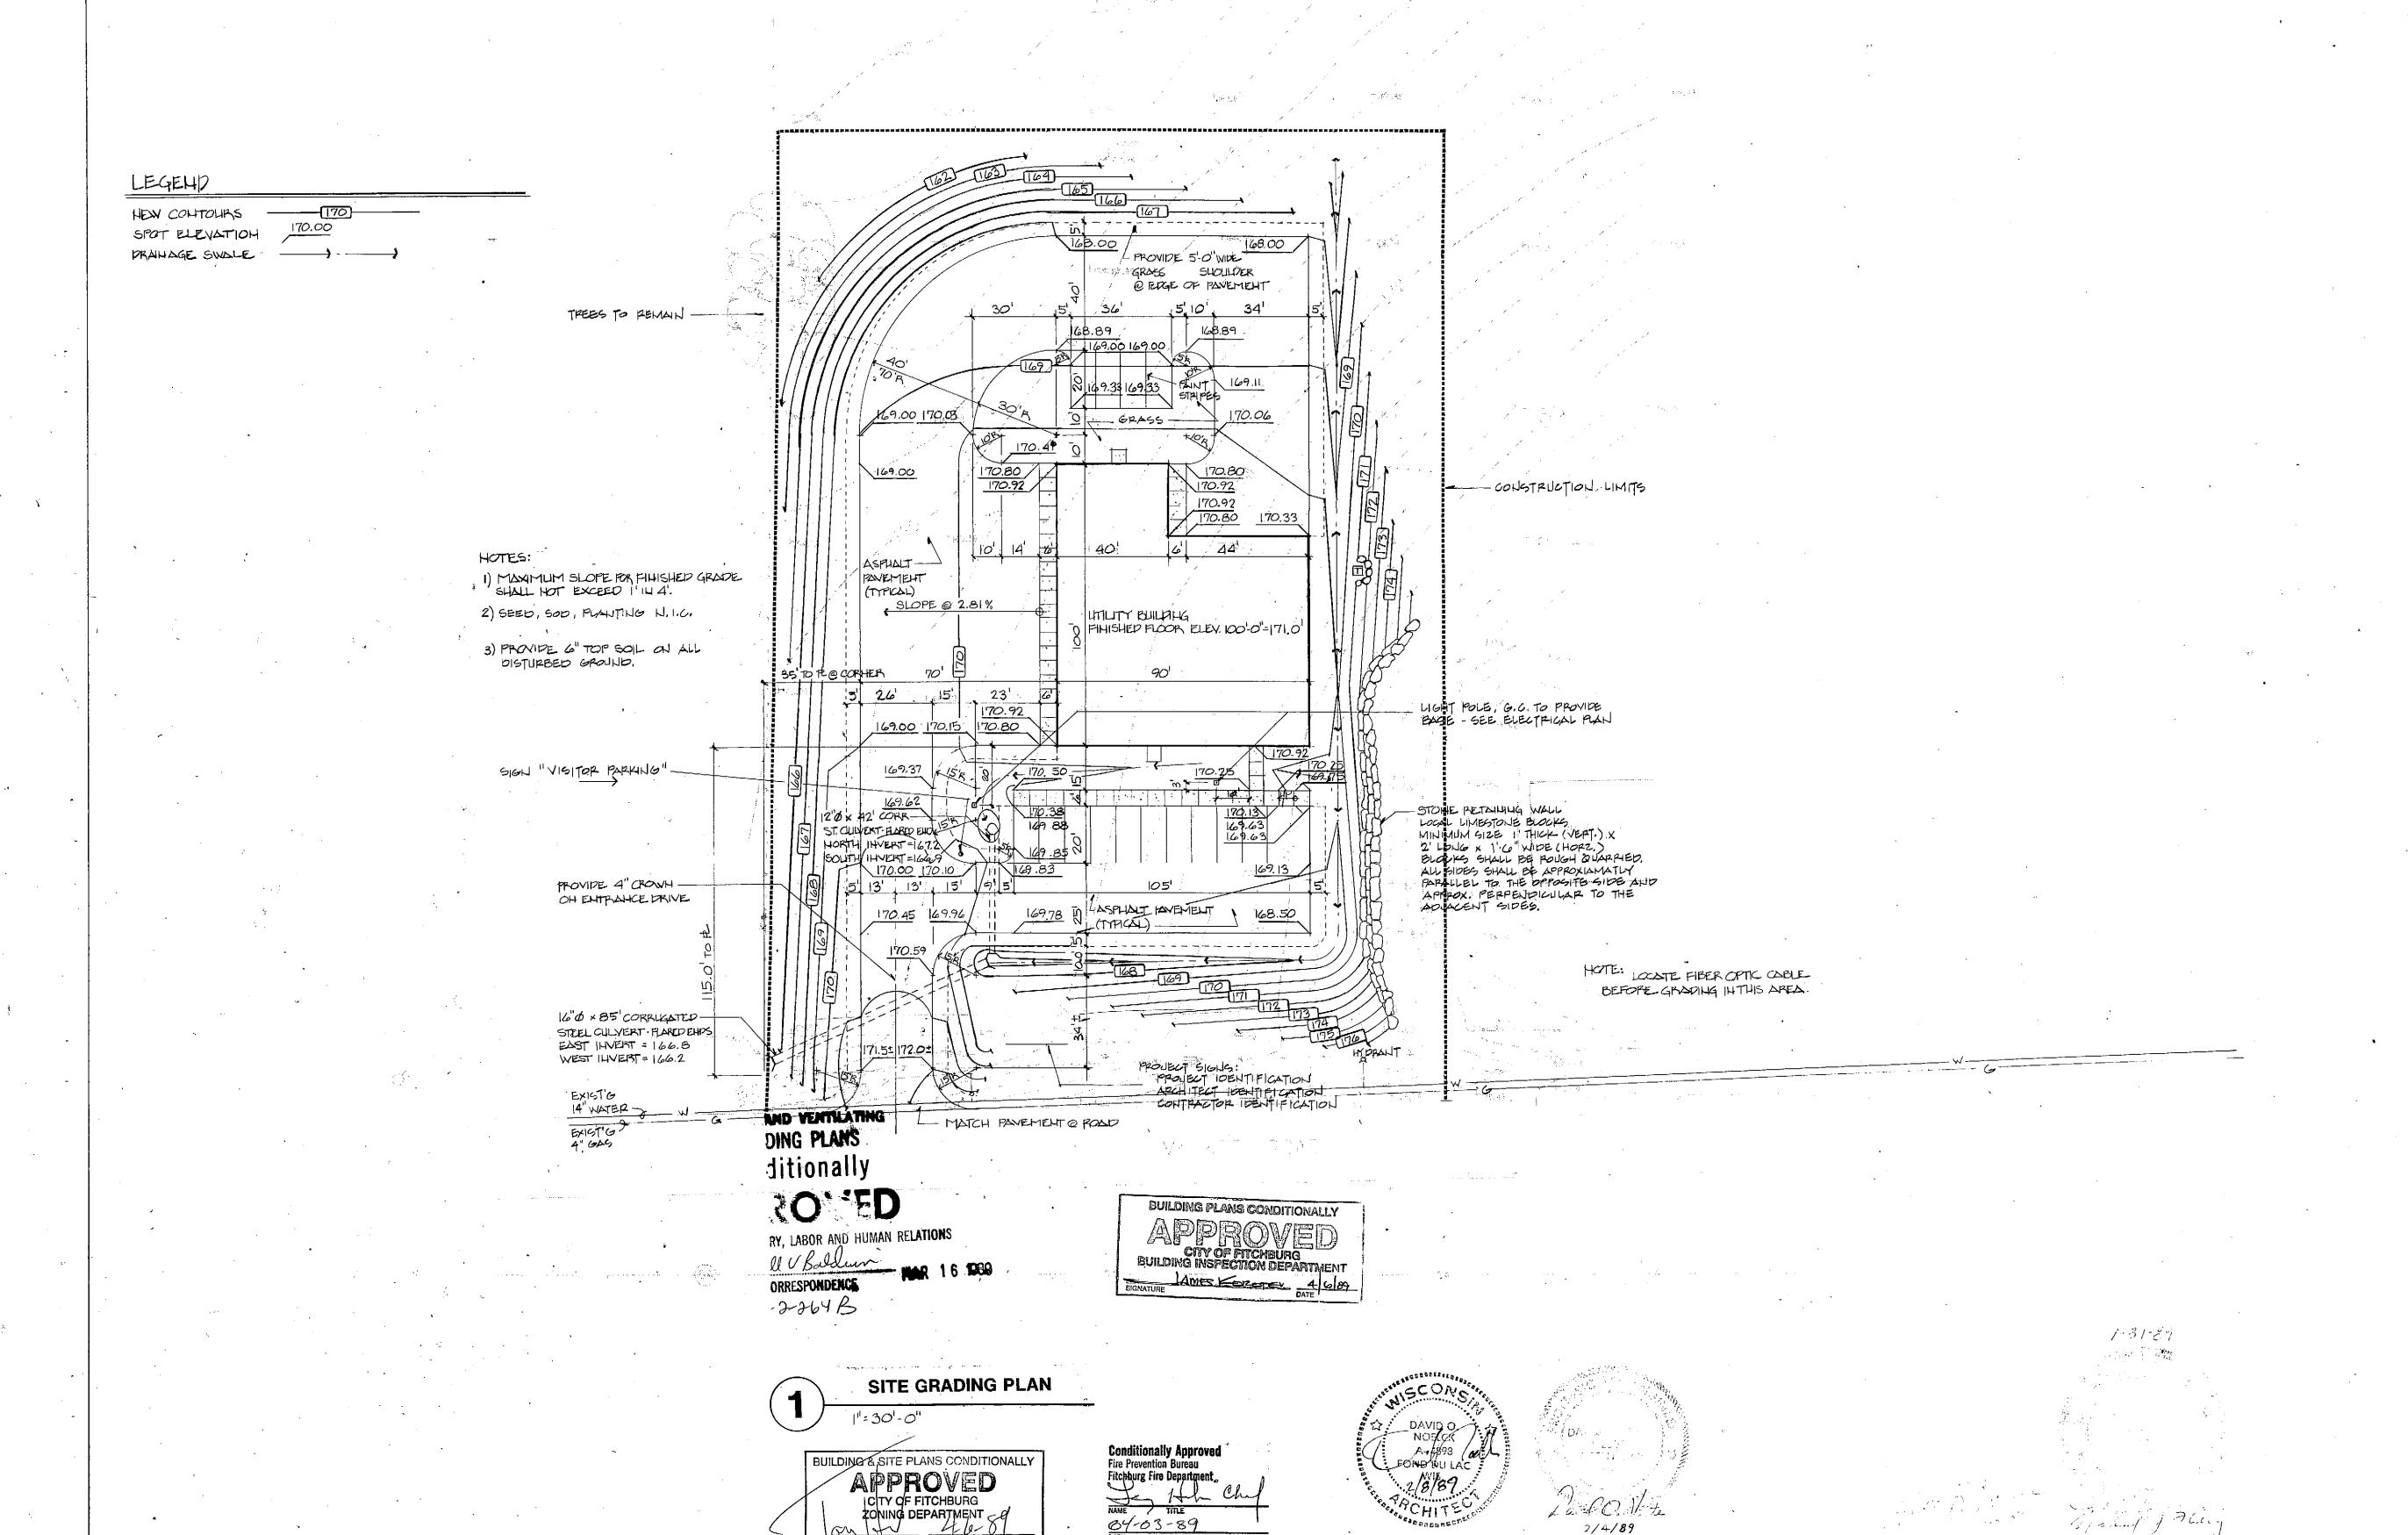

DRAWING INDEX

- 1 SITE PLAN
- 2 BUILDING ELEVATIONS
- 3 FLOOR PLANS
- 4 REFLECTED CEILING PLANS
- **5 BUILDING SECTIONS**
- 6 ROOM/DOOR SCHEDULES/DETAILS
- 7 INTERIOR ELEVATIONS/MISC. DETAILS
- S-1 FOUNDATION PLAN
- S-2 STRUCTURAL DETAILS
- P-1 SITE/RISER DIAGRAM
- P-2 PLUMBING PLAN
- P-3 SCHEDULES/DETAILS
- H-1 HVAC PLAN
- -2 HVAC DETAILS
- H-3 HVAC ALT. #1/ DET.
- 1 SYMBOLS & SCHEDULES
- E-2 POWER PLAN
- E-3 LIGHTING PLAN

BUILDING DATA

OCCUPANCY.

CONSTRUCTION

1,767 Se.FT.

ILHE 59 HAZARBOUS


JPPER LEVEL

2,590 SQ. FT.

OCCUPANT LOAD

47

P - D

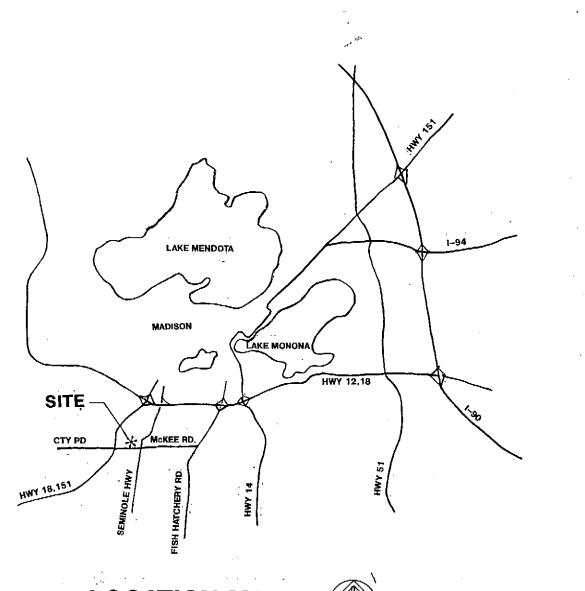

LOCATION MAP



Foth & Van Dyke
Engineers / Architects

FITCHBURG UTILITY BUILDING


STRUCTURAL


H.V.A.C.


ELECTRICAL


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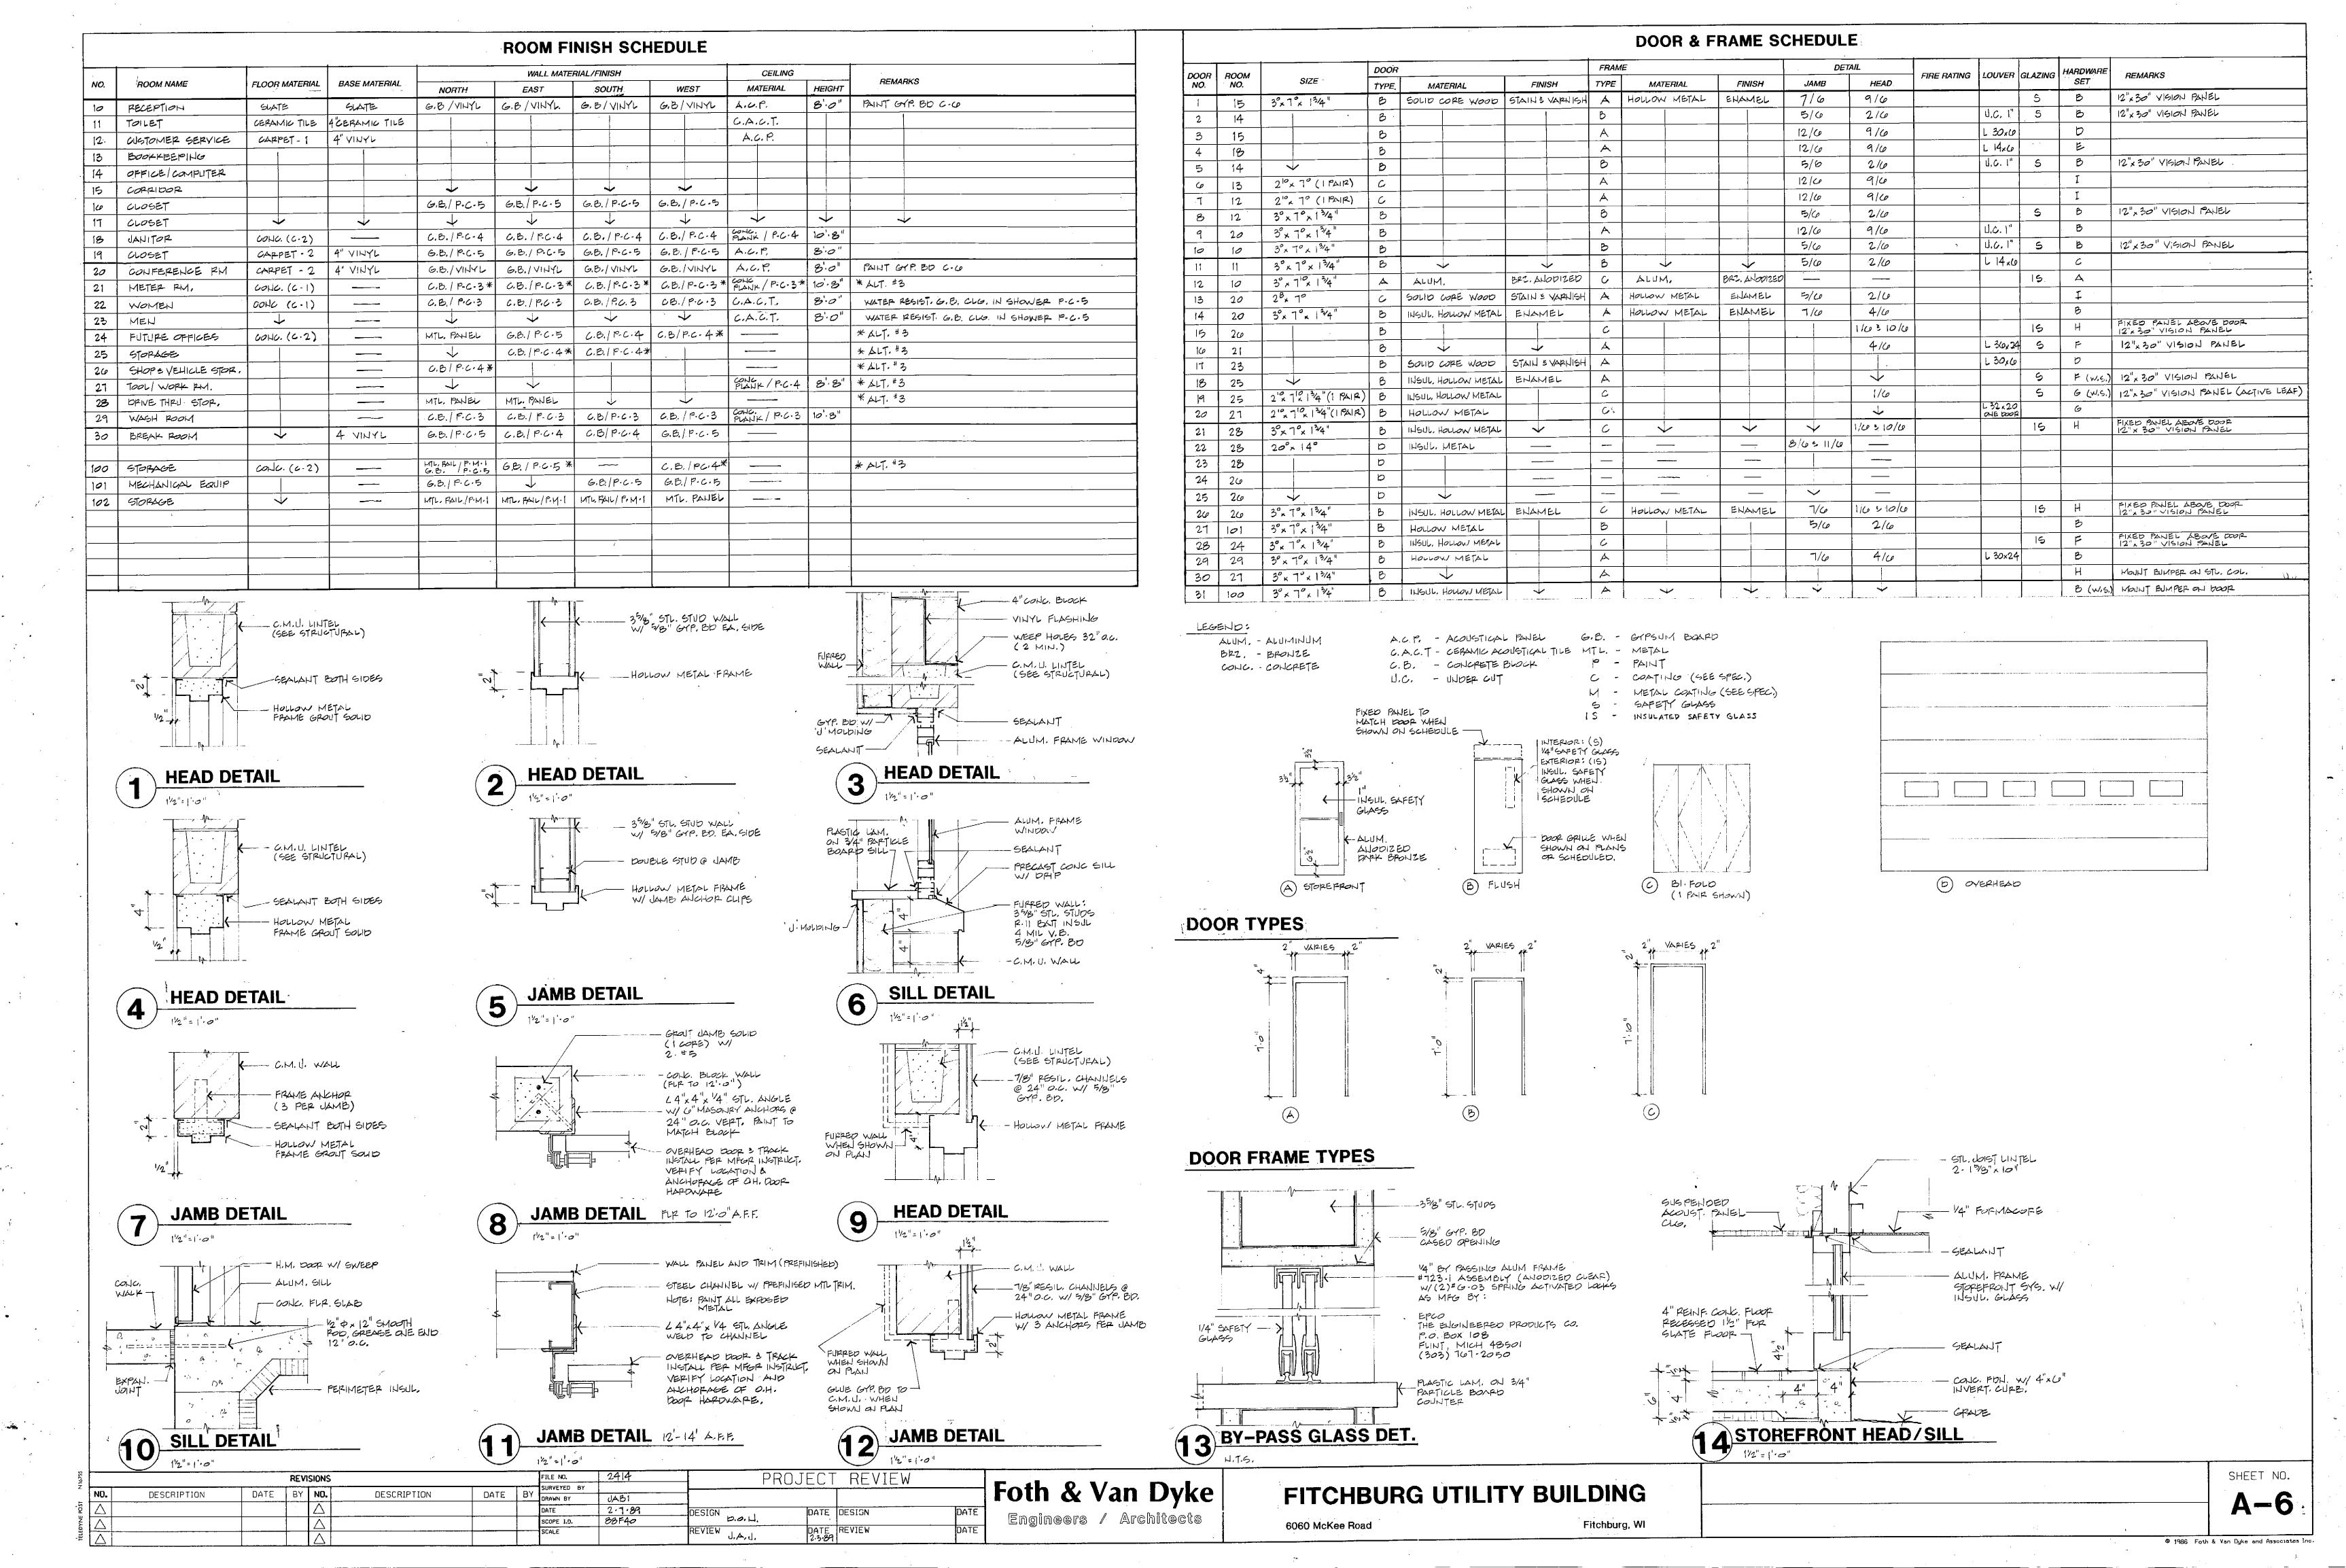



6060 McKee Road

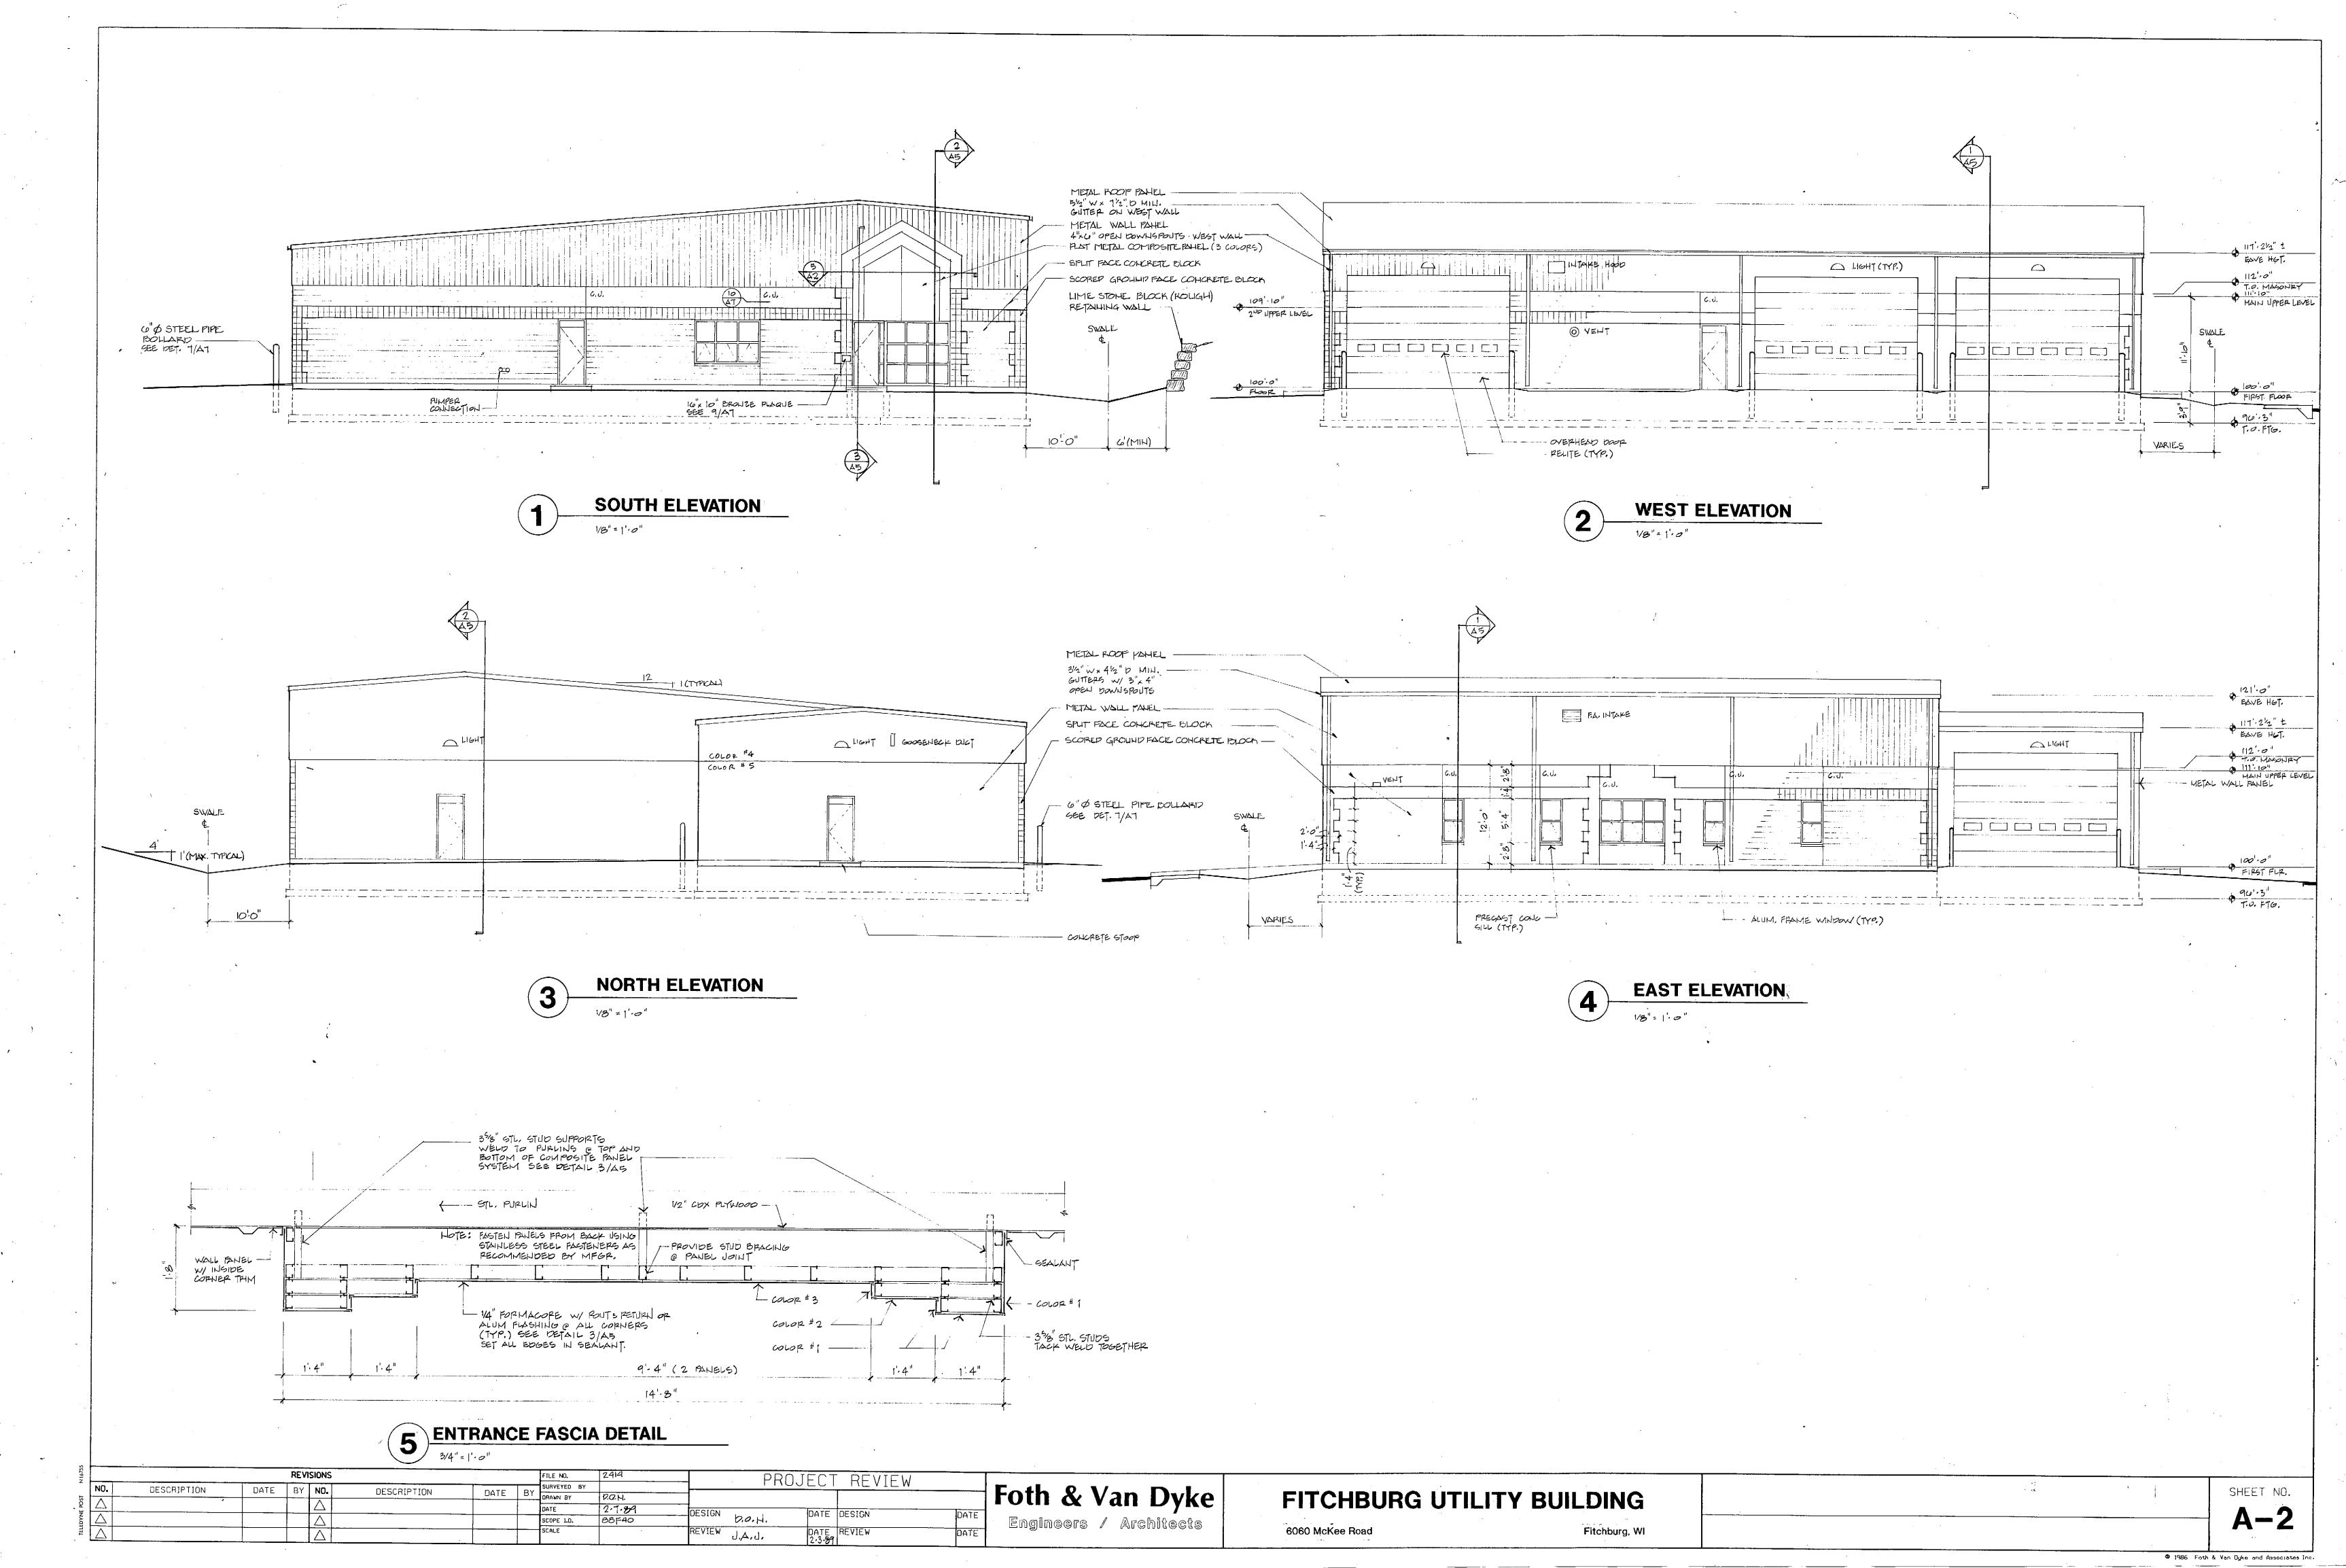
DATE REVIEW

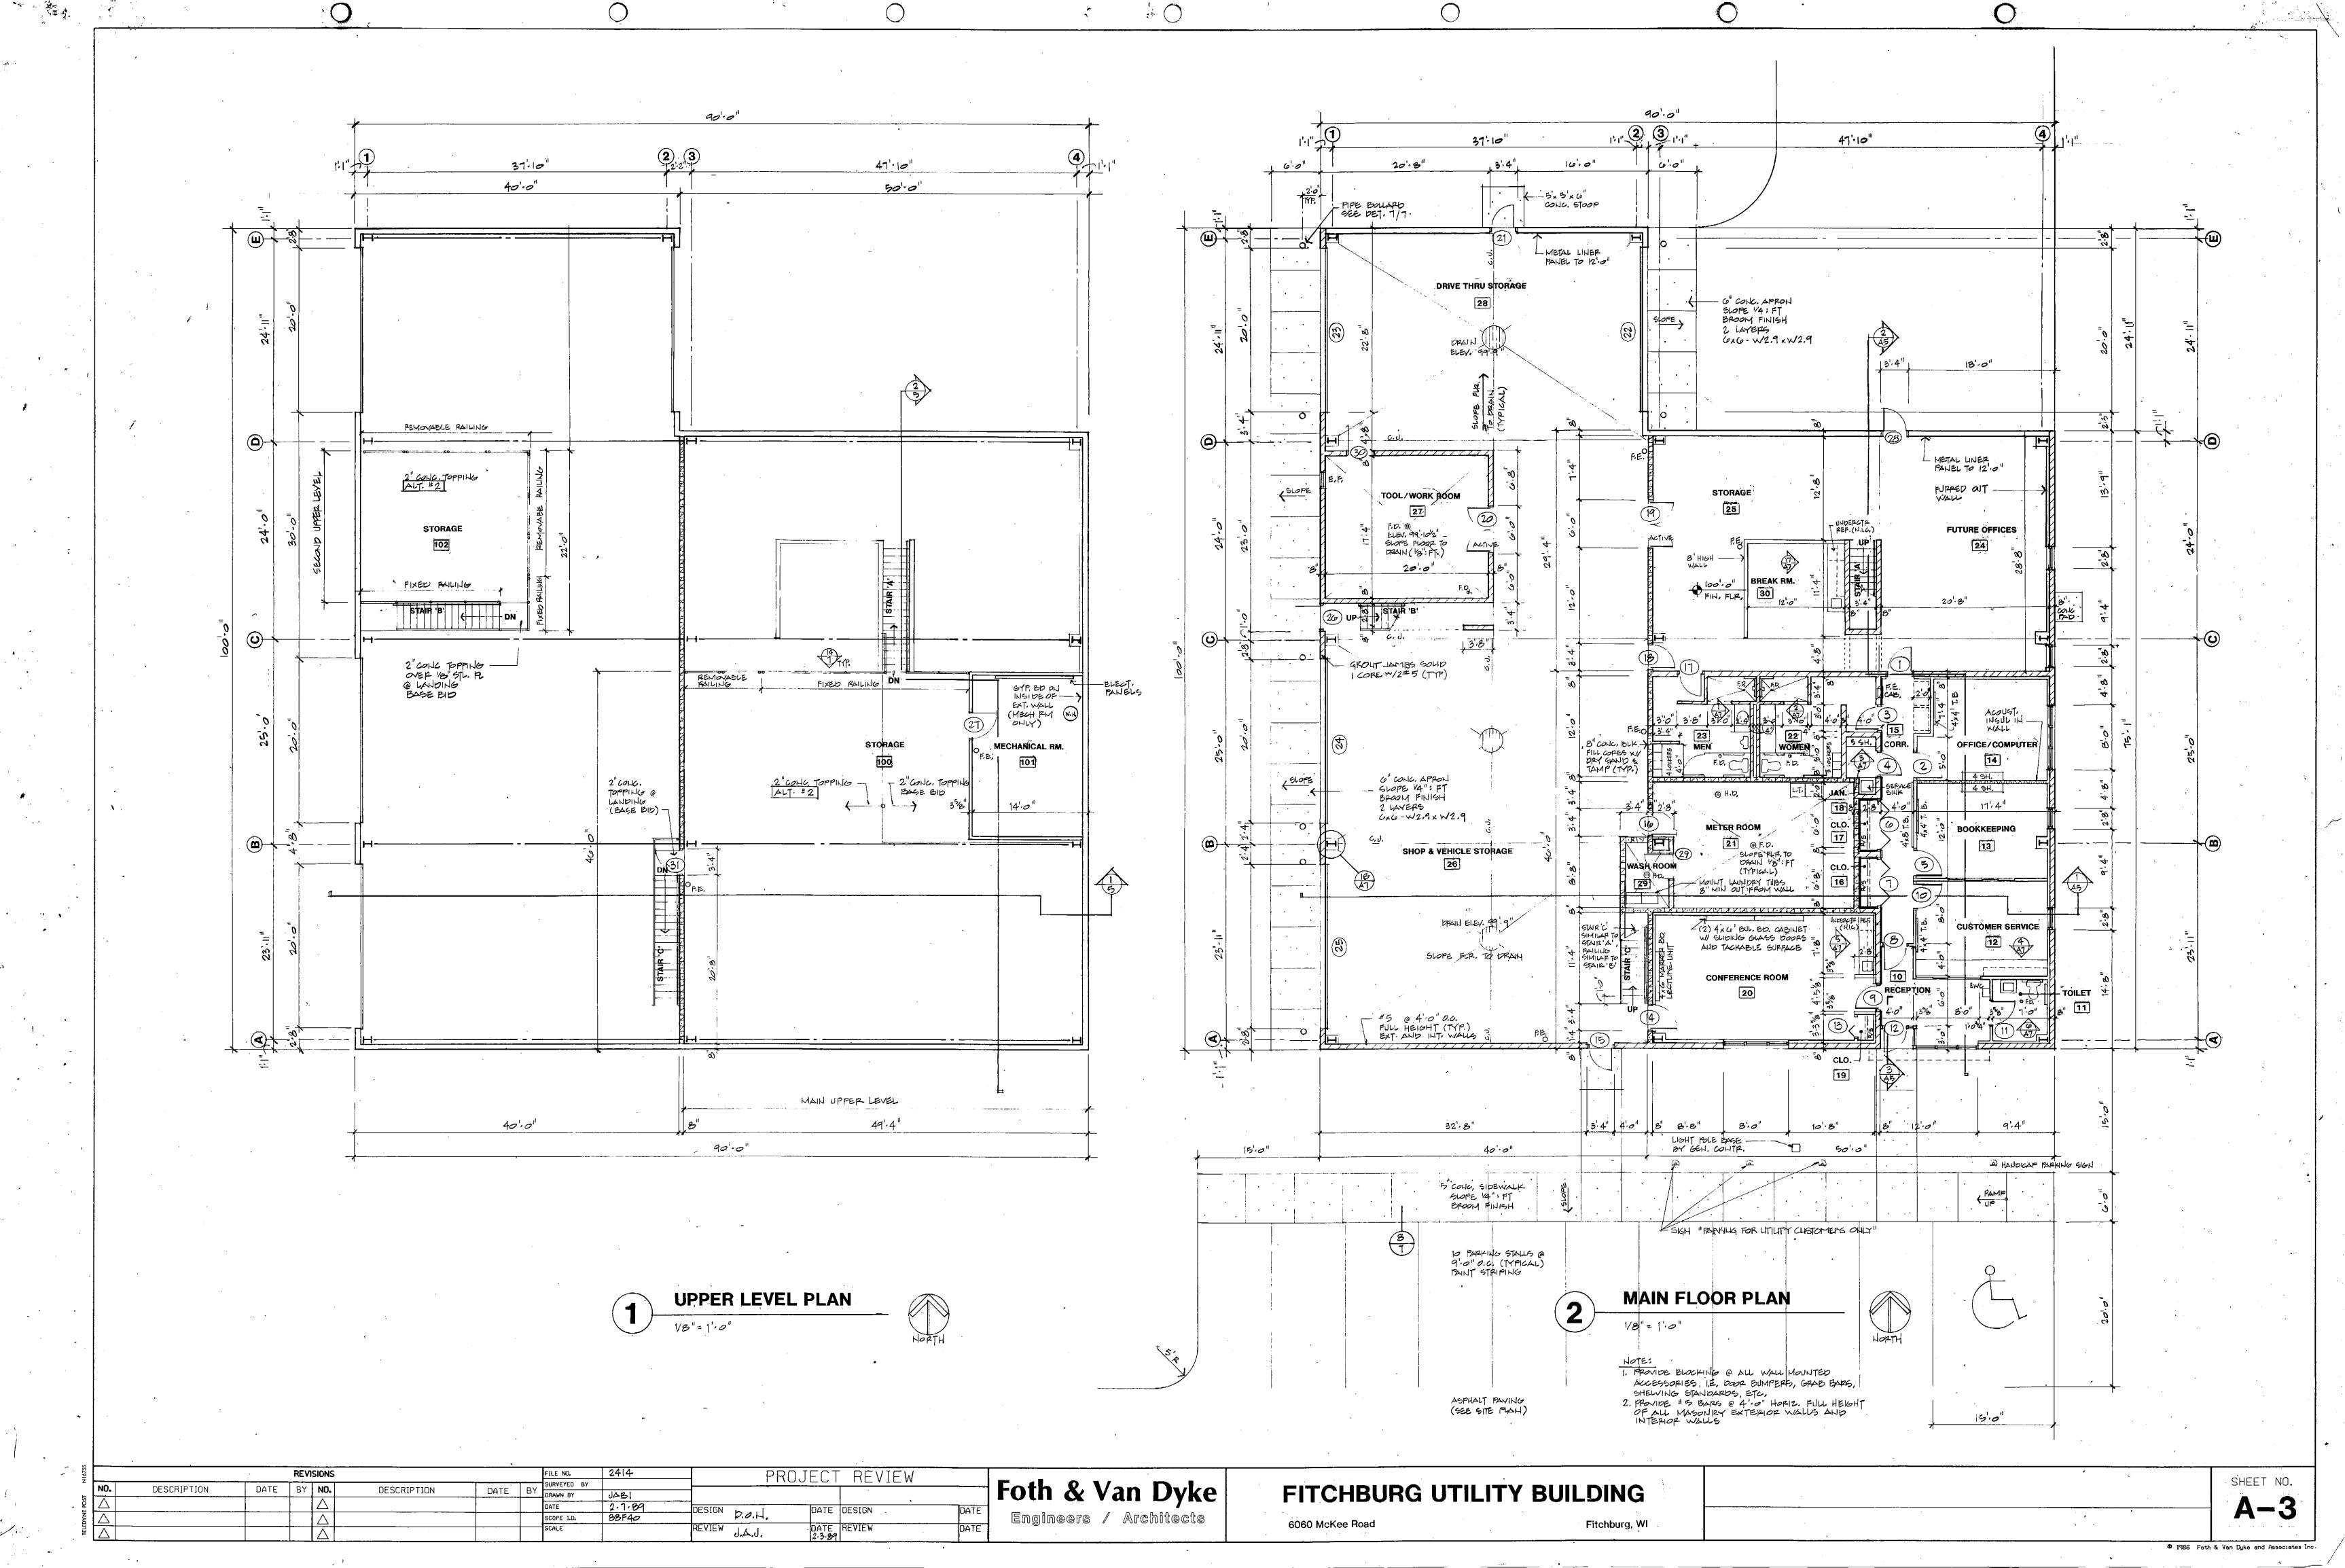REVIEW J.A.J.

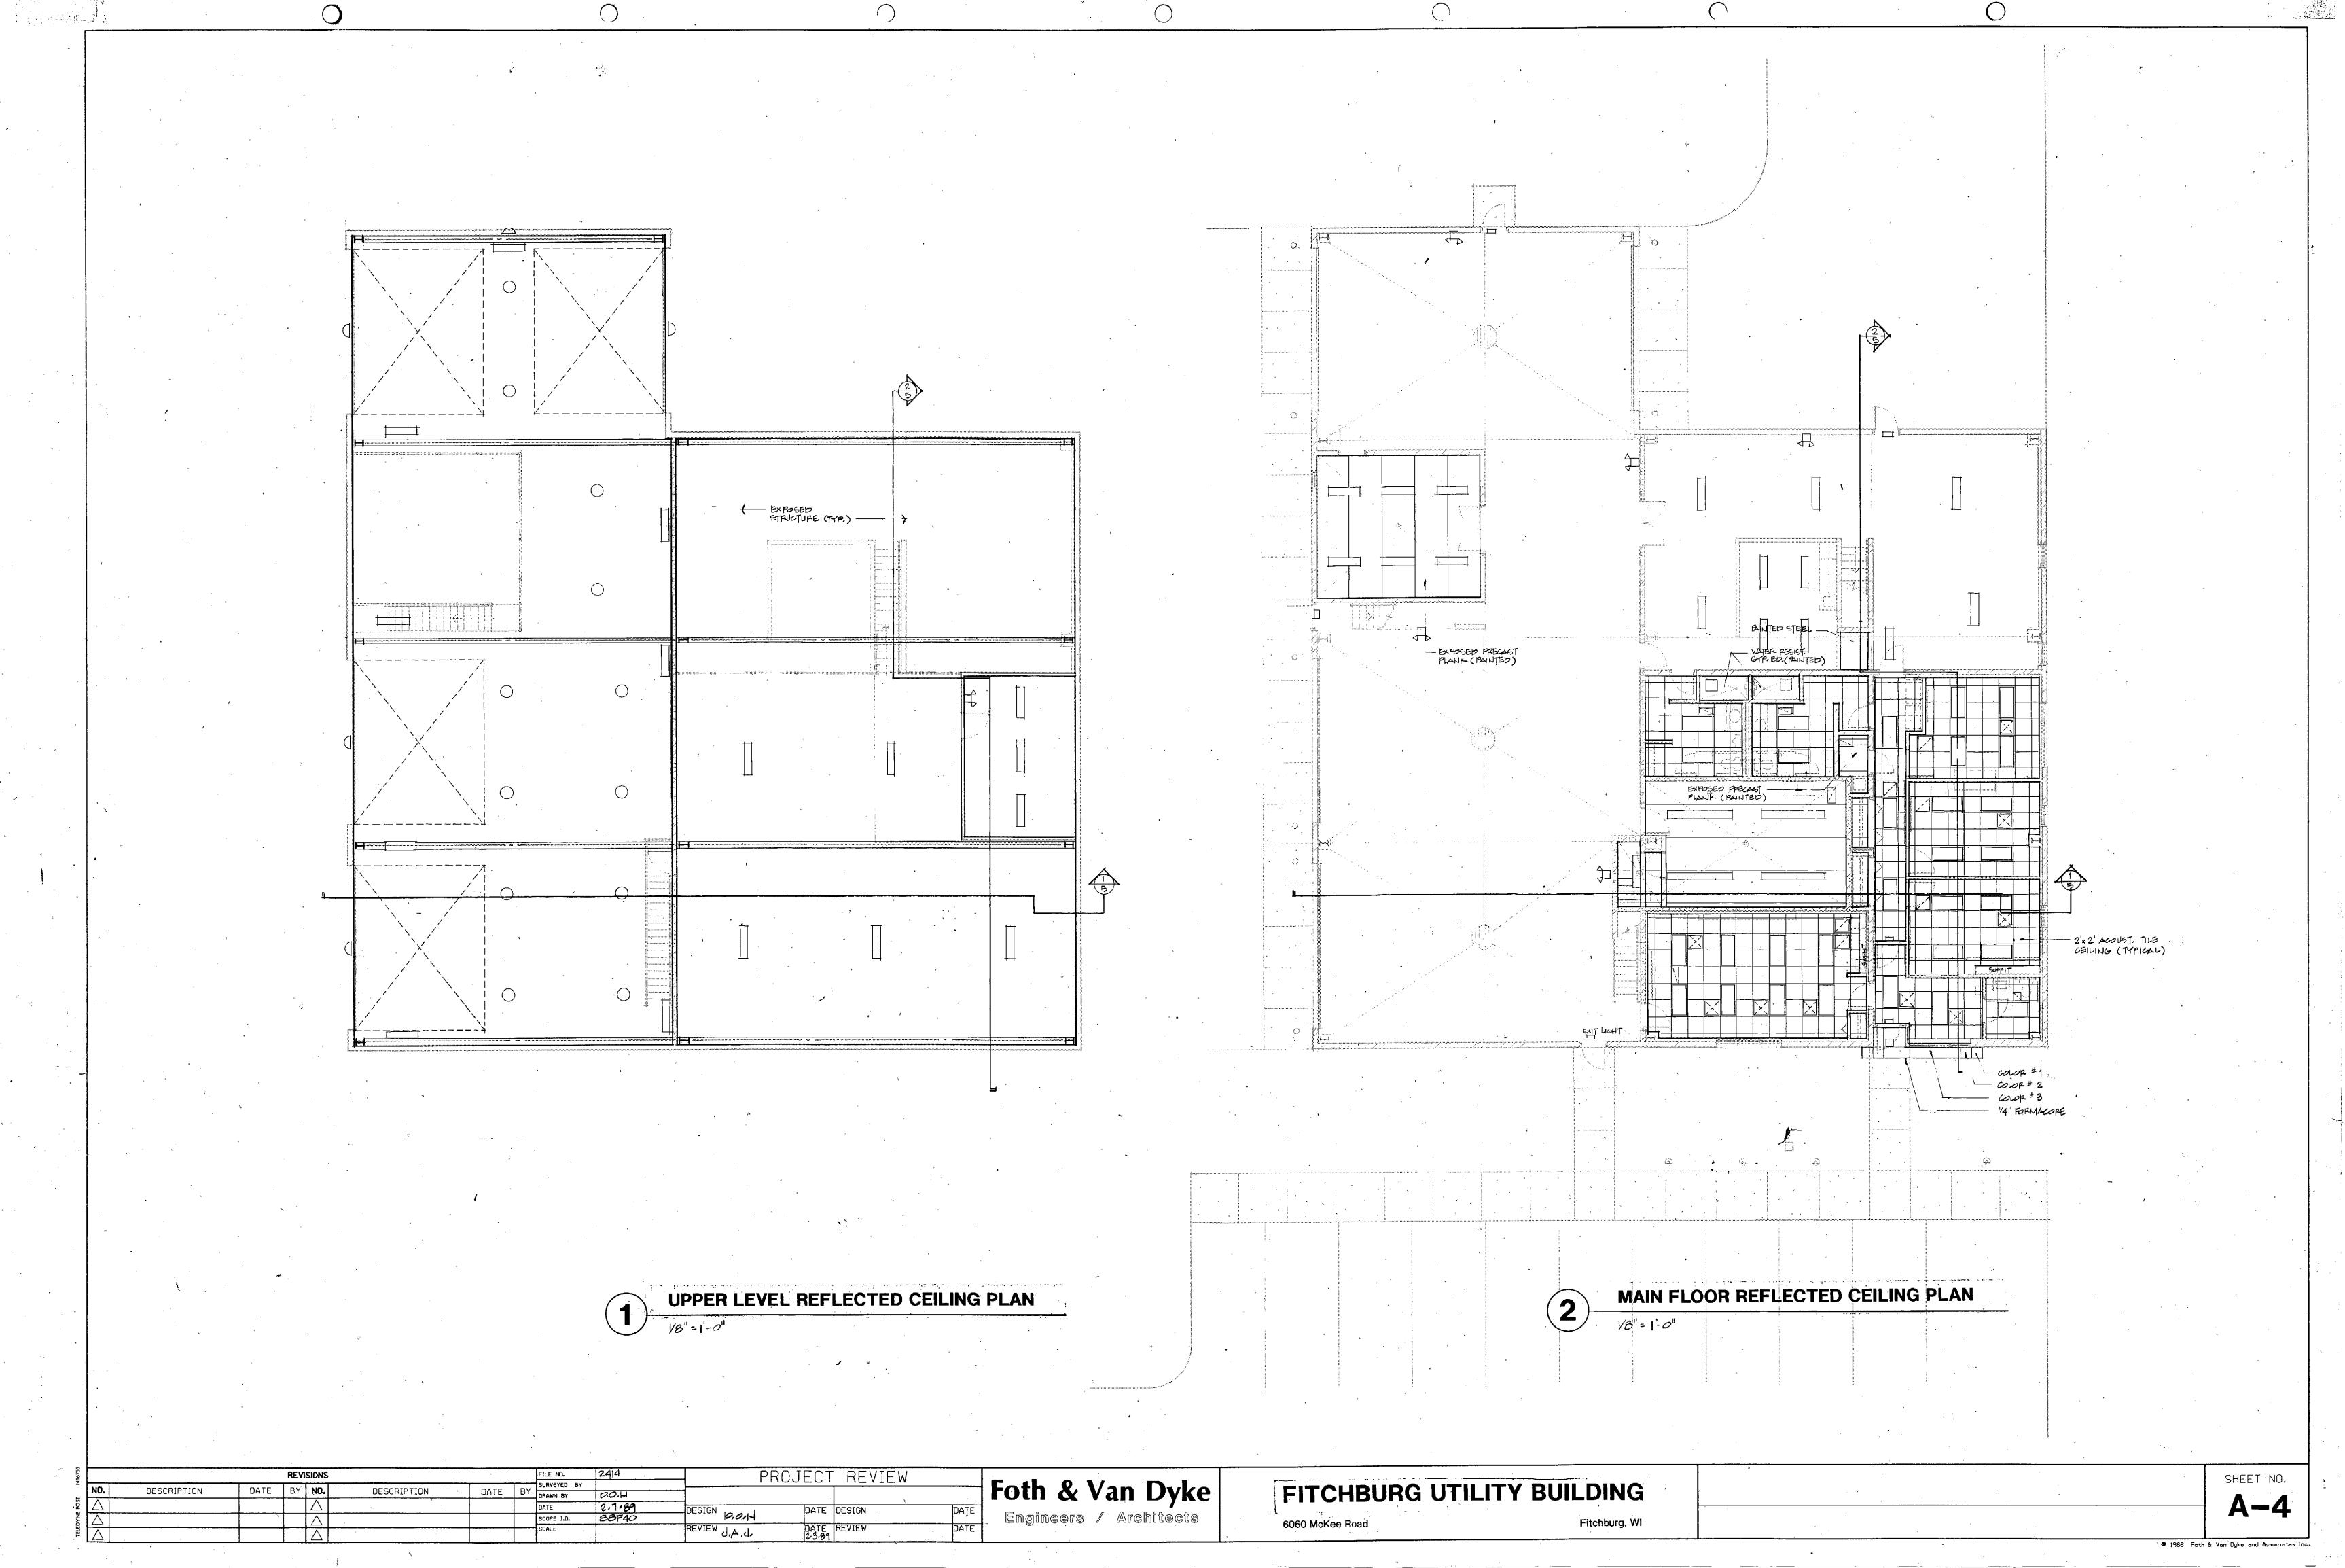Fitchburg, WI

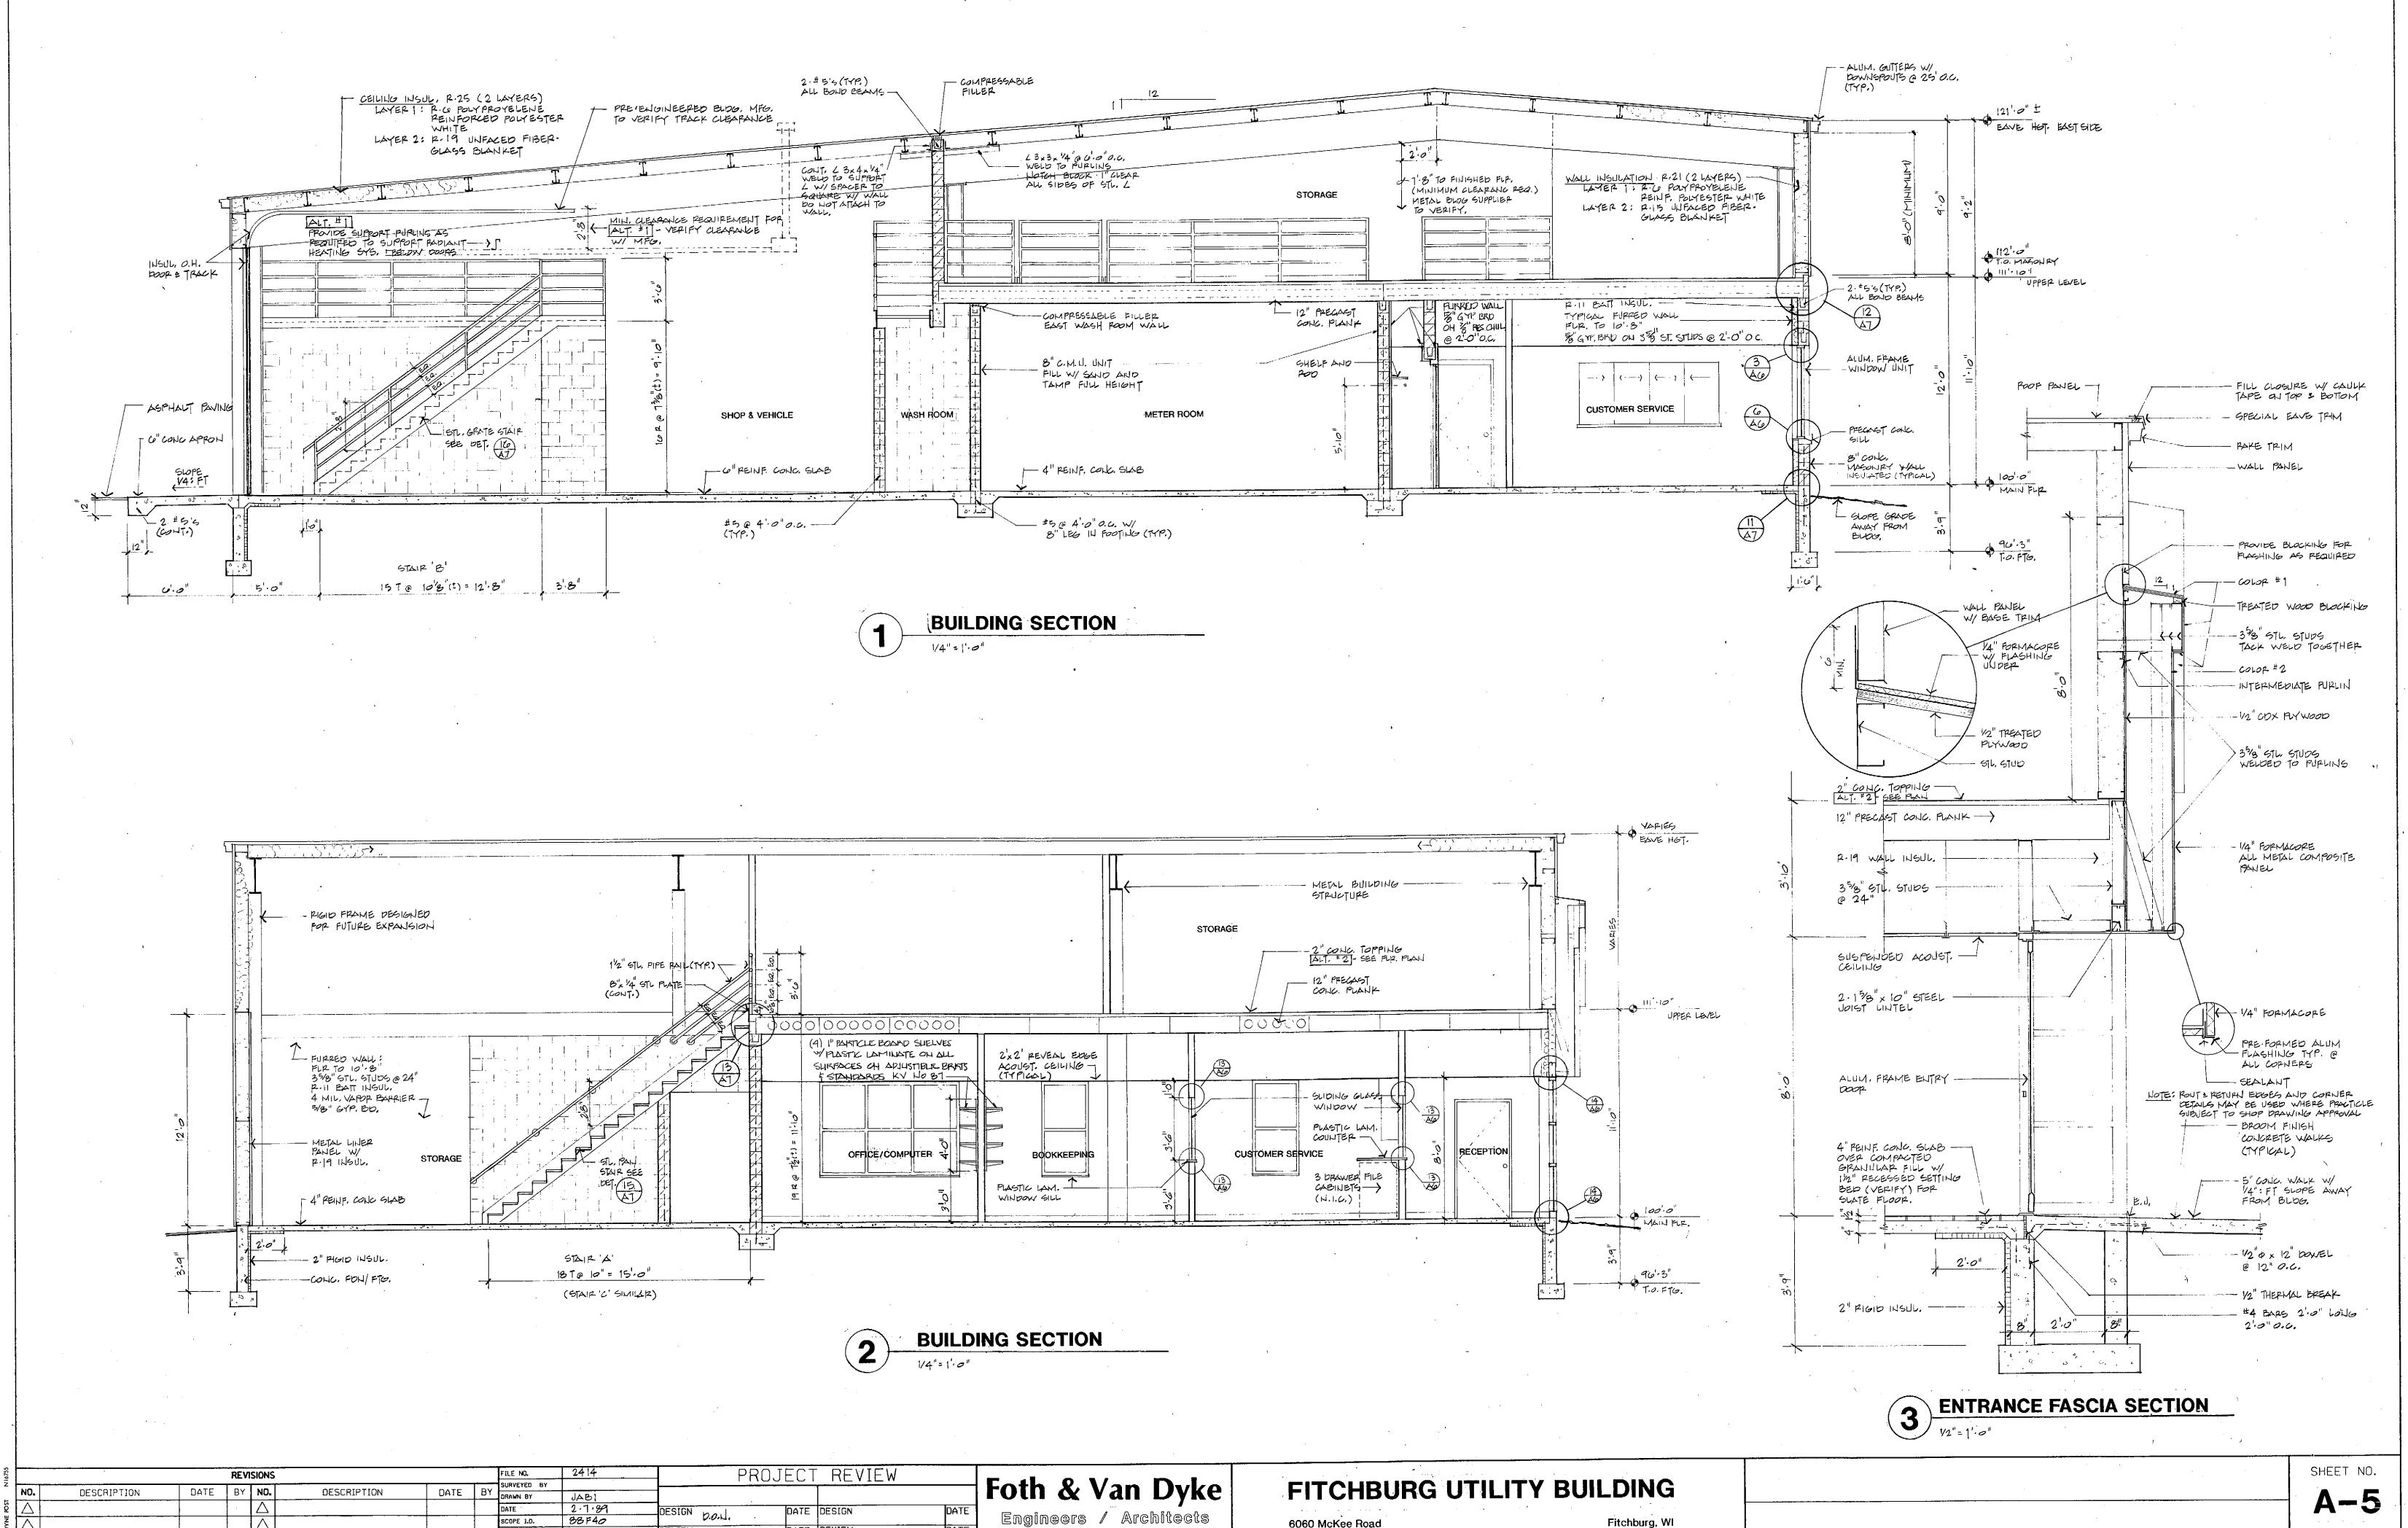

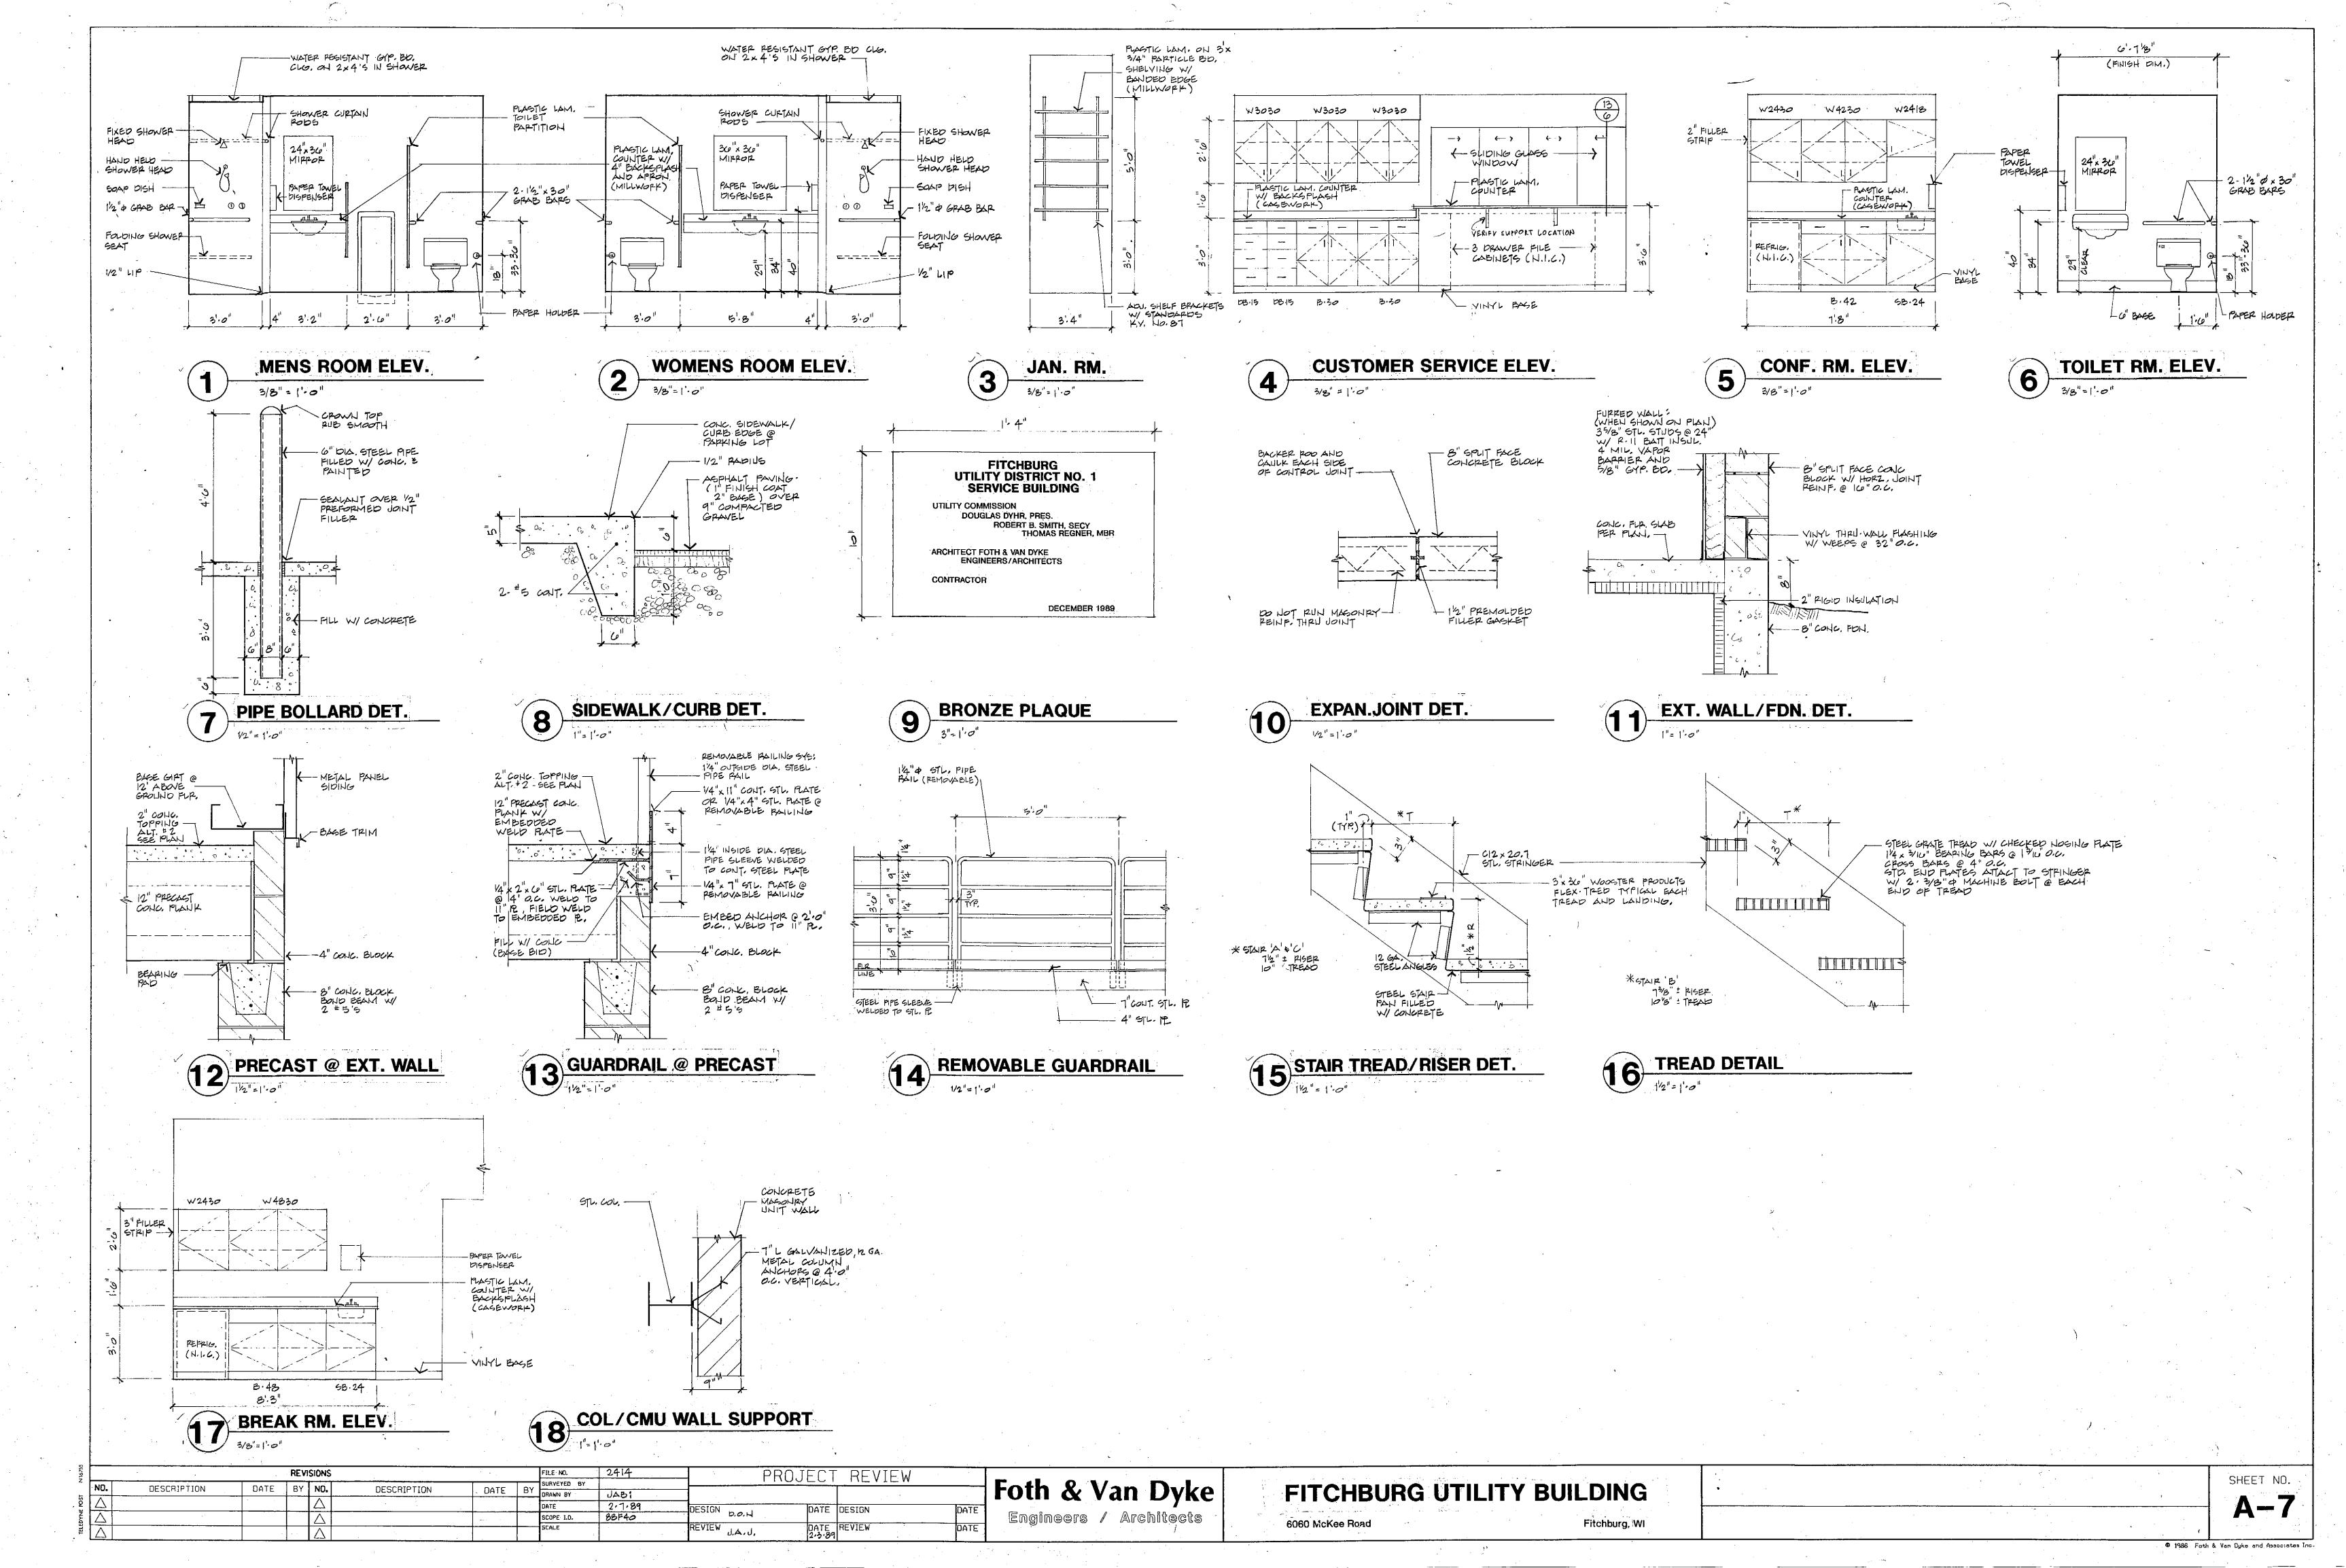

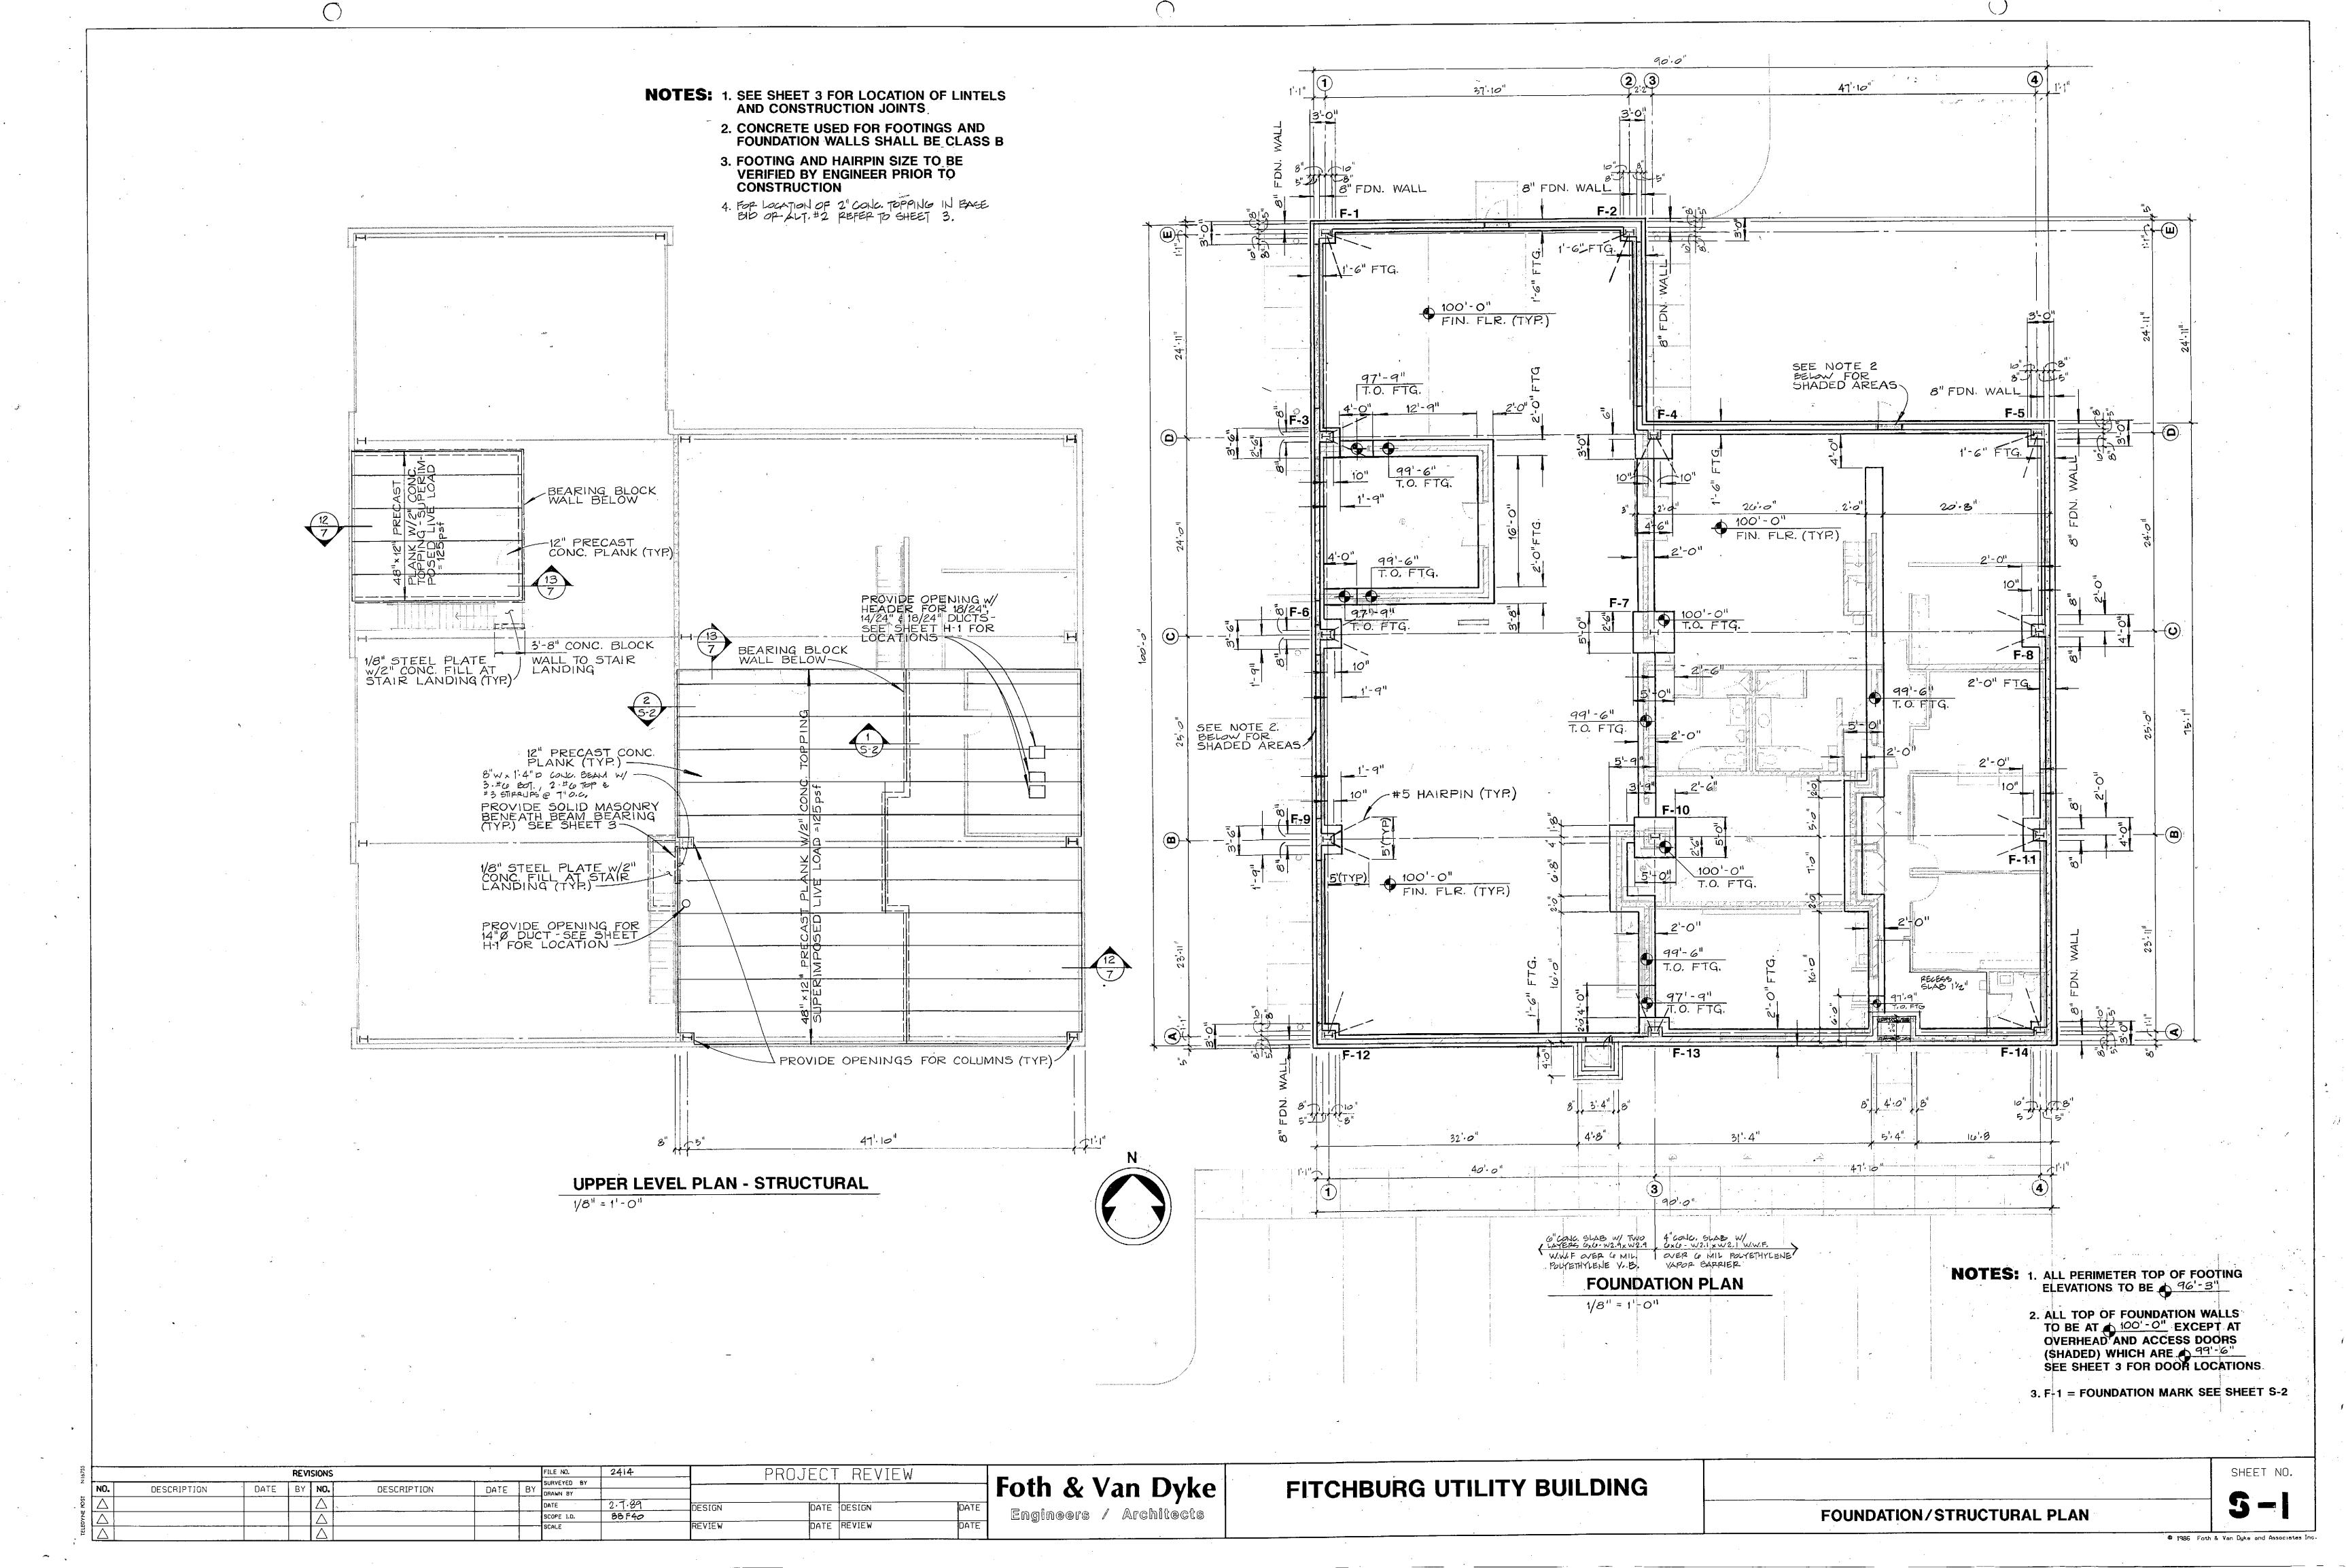

LIN	TEL SCHED	ULE
MARK	TYPE & SIZE	REINF.
L-1	8" BOND BEAM	2-#4
L-2	8" BOND BEAM	2-#7
L-3	W8 x 10	
L-4	L3 x 4 x 1/4"	_

	FOOTING & PIER SCHEDULE											
ARK		FOOTING				DEMARKS						
MA	SIZE	REINF.	TOP ELEV.	SIZE	REINF.	TOP ELEV.	REMARKS					
F-1	3'x3'x10"	3-#4 EW/T&B	96'-3"	1'-8"x 1'-0"	4-#5	100'-0"						
F-2	3'x3'x10"	3-#4 EW/T&B	96'-3"	1'-8"x 1'-0"	4-#5	100'-0"						
F-3	3.5'x3.5'x10"	3-#6 EW/T&B	96'-3"	1'-8"x 1'-4"	4-#6	100'-0"						
F-4	4.5'x4.5'x12"	5-#6 EW/T&B	96'-3"	1'-8"x 1'-4"	4-#6	100'-0"						
F-5	3'x3'x10"	3-#4 EW/T&B	96'-3"	1'-8"x 1'-4"	4-#6	100'-0"						
F-6	3.5'x3.5'x10"	3-#6 EW/T&B	96'-3"	1'-8"x 1'-4"	4-#6	100'-0"						
F-7	5'x5'x12"	7-#6 EW/T&B	- 100'-0"									
F-8	4'x4'x10"	6-#5 EW/T&B	96'-3"	1'-8"x 1'-4"	4-#6	100'-0"						
F-9	3.5'x3.5'x10"	3-#6 EW/T&B	96'-3"	1'-8"x 1'-4"	4-#6	100'-0"						
F-10	5'x5'x12"	7-#6 EW/T&B	100'-0"									
F-11	4'x4'x10"	6-#5 EW/T&B	96'-3"	1'-8"x 1'-4"	4-#6	100'-0"						
F-12	3'x3'x10"	3-#4 EW/T&B	96'-3"	1'-8"x 1'-0"	4-#5	100'-0"						
F-13	3.5'x3.5'x10"	3-#6 EW/T&B	96'-3"	1'-8"x 1'-0"	4-#5	100'-0"						
F-14	3'x3'x10"	3-#4 EW/T&B	96'-3"	1'-8"x 1'-0"	4-#5	100'-0"						


LEGEND


EW EAC


T&B TOP & BOTTO

REINF. REINFORCEMENT STEEL


ELEV. ELEVATION

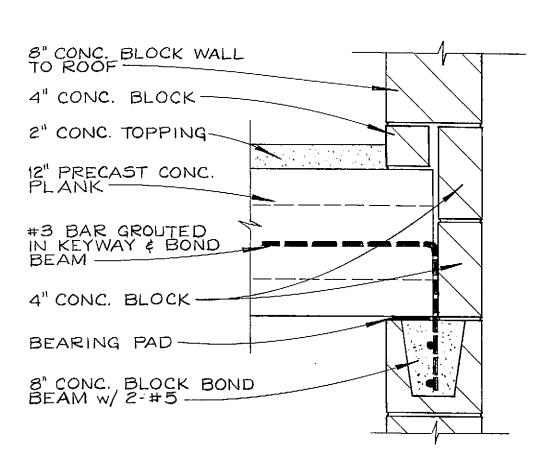

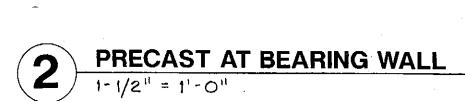

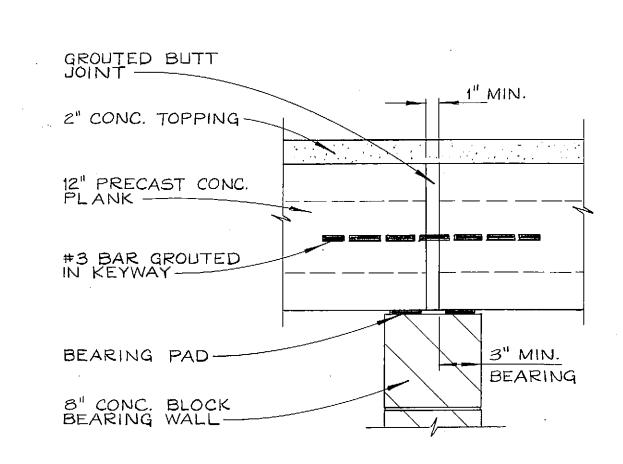



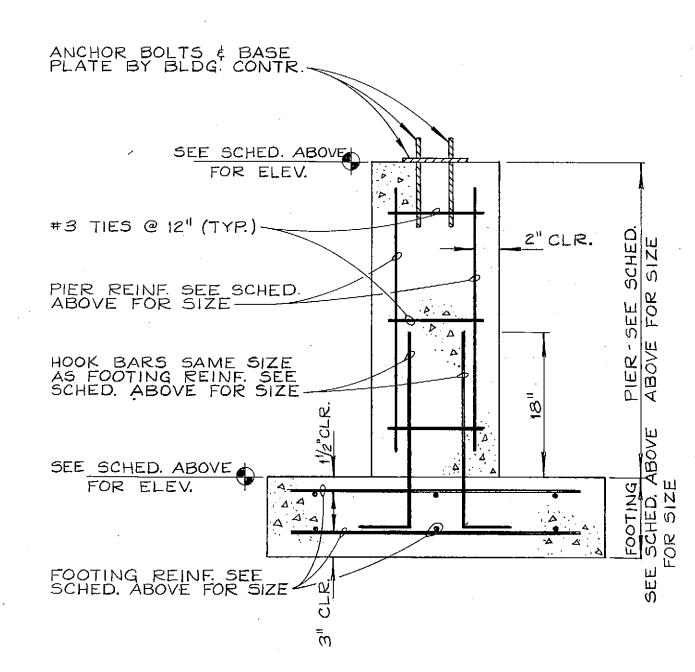



TYPICAL FOOTING & PIER DETAIL


NOT TO SCALE

• 1986 Foth & Van Dyke and Associates Inc.

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¥.		SCOPE 1.D. 88 F40	DESIGN DATE DESIGN DAT	E Transfer a serve / Arrefull a serve	·		「ワーン
EFE.		SCALE	REVIEW - DATE REVIEW - DAT	E		STRUCTURAL DETAILS	
٠ 🛱		JUNIO SURVEY	LEATER PATER PATER	<u> </u>	•	O THOU TO THE BETAIL	1

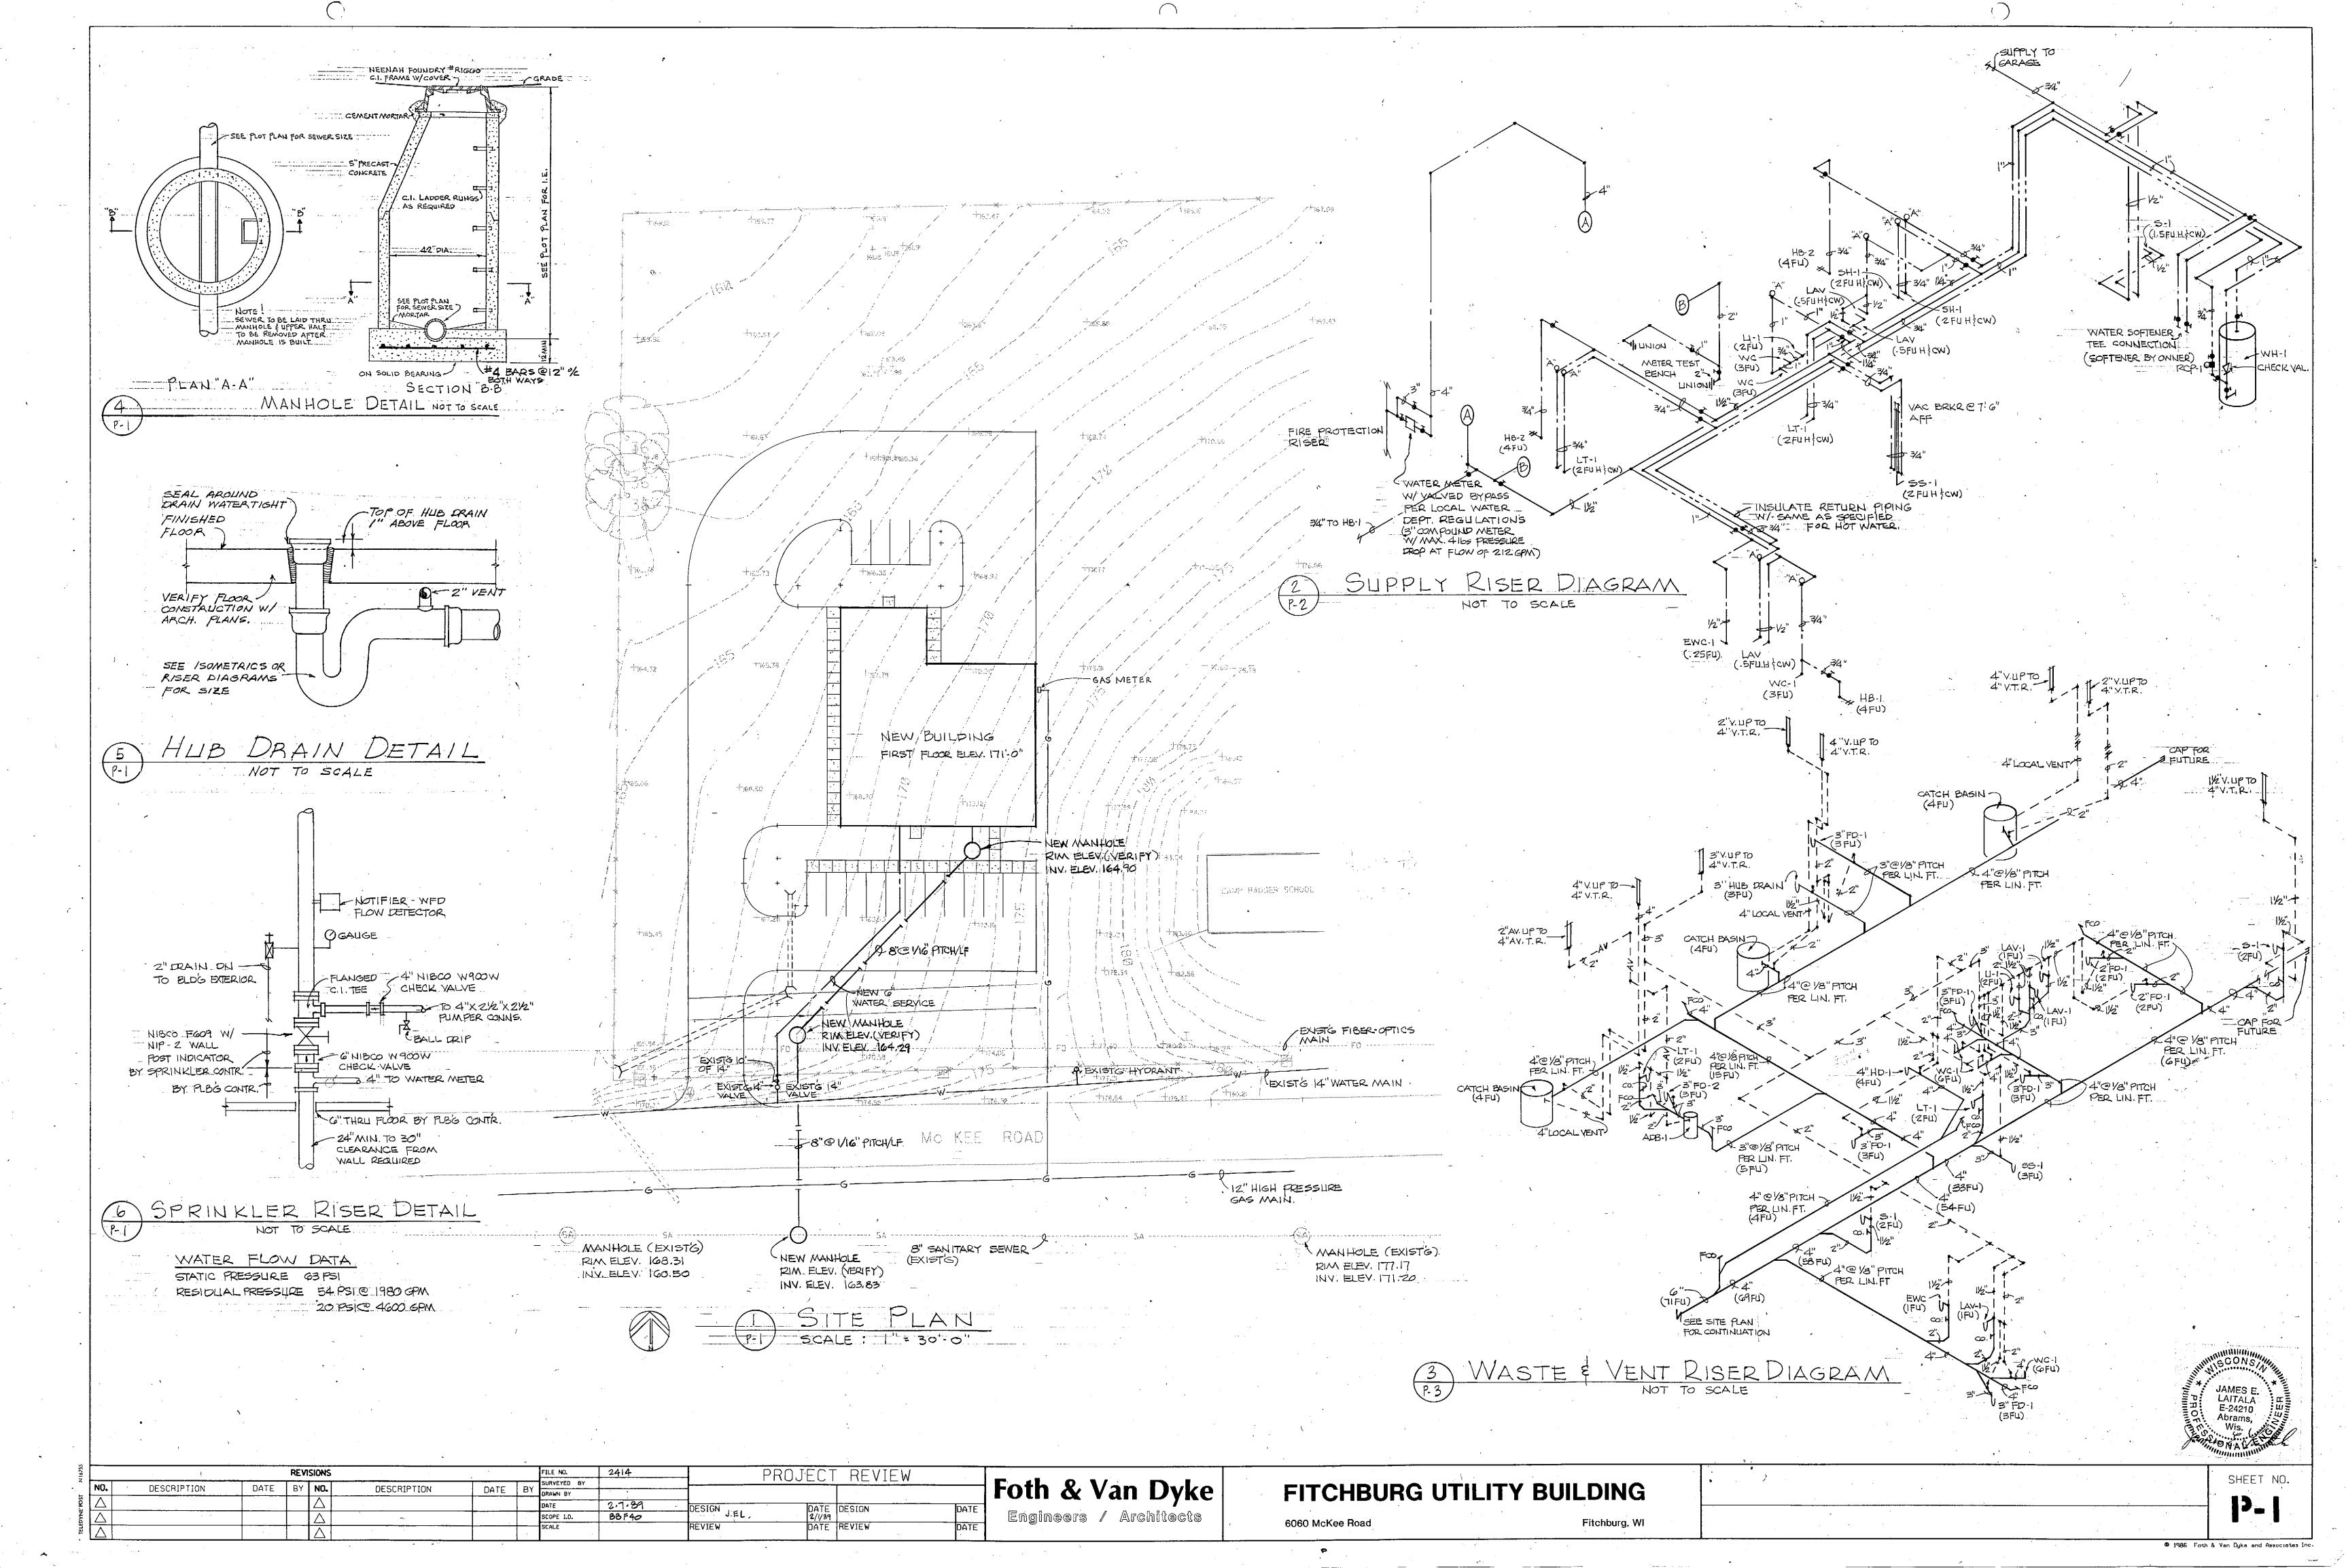

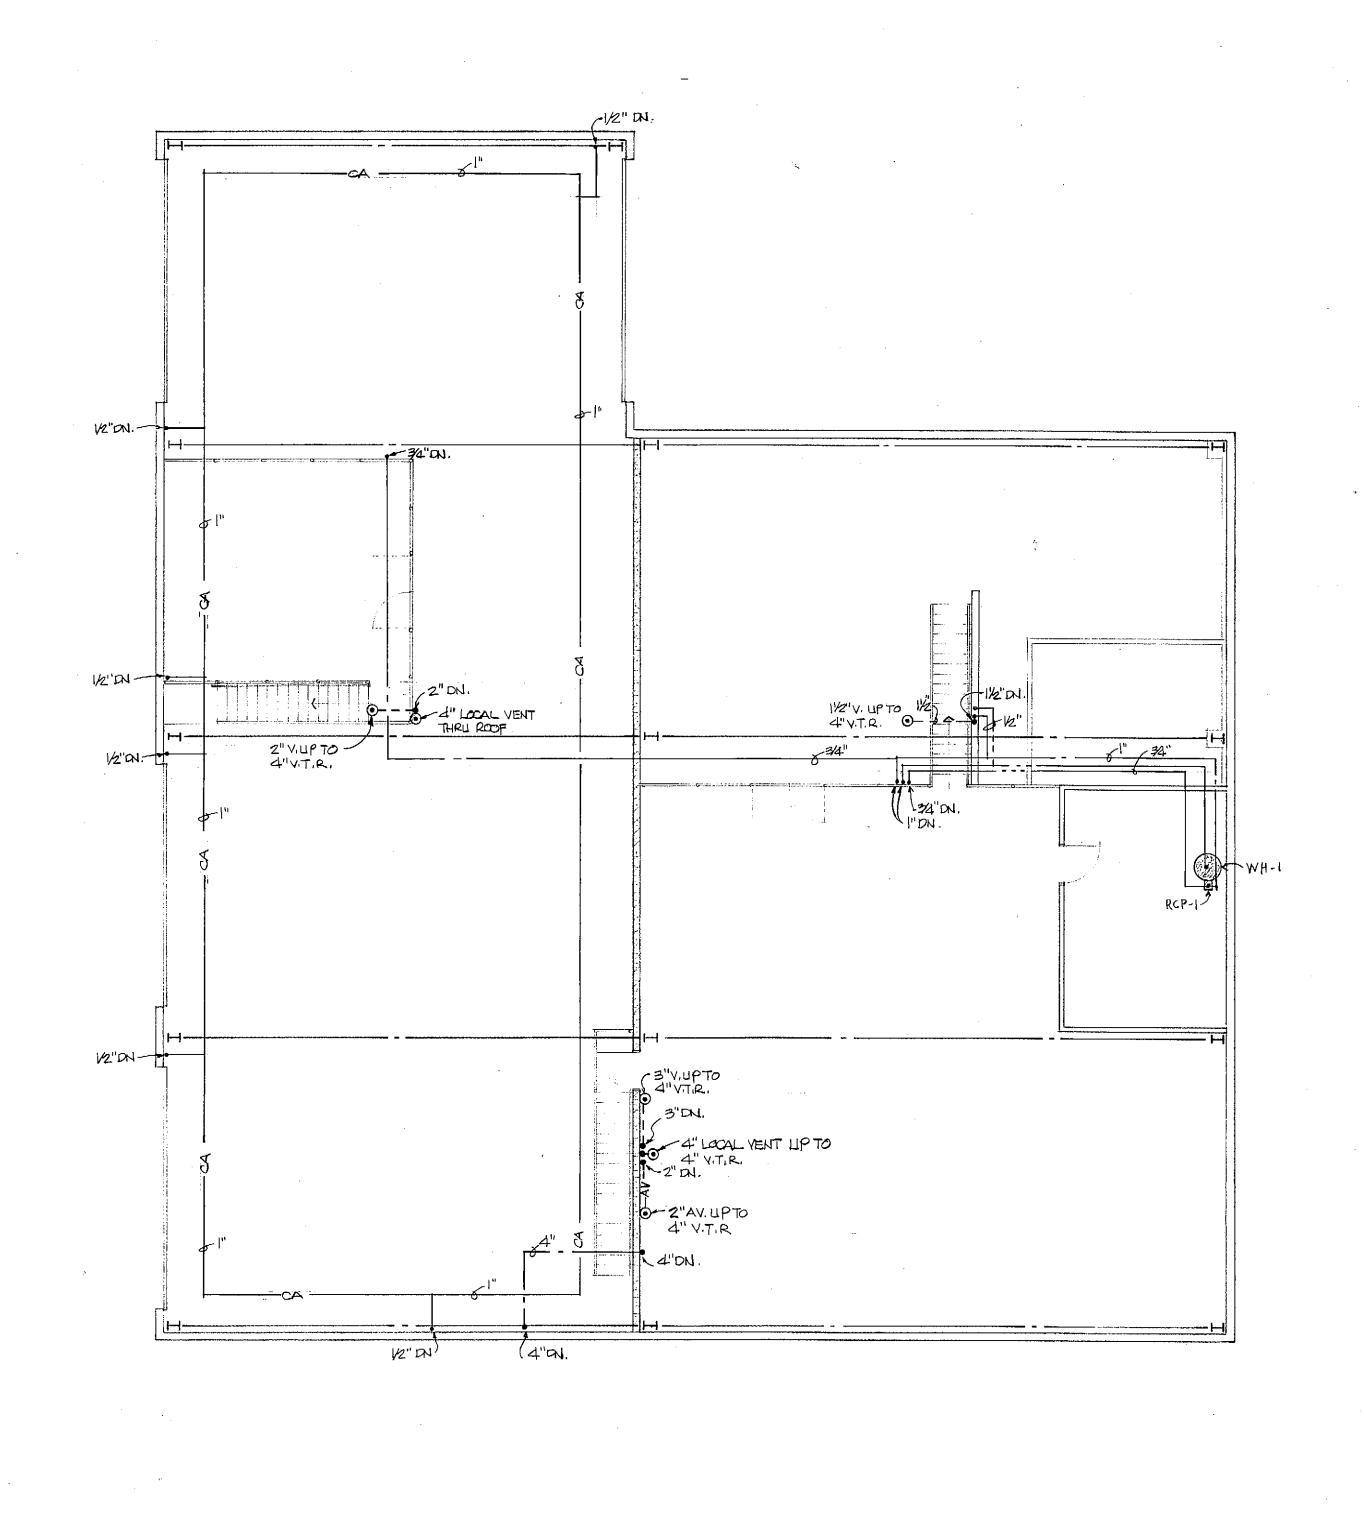

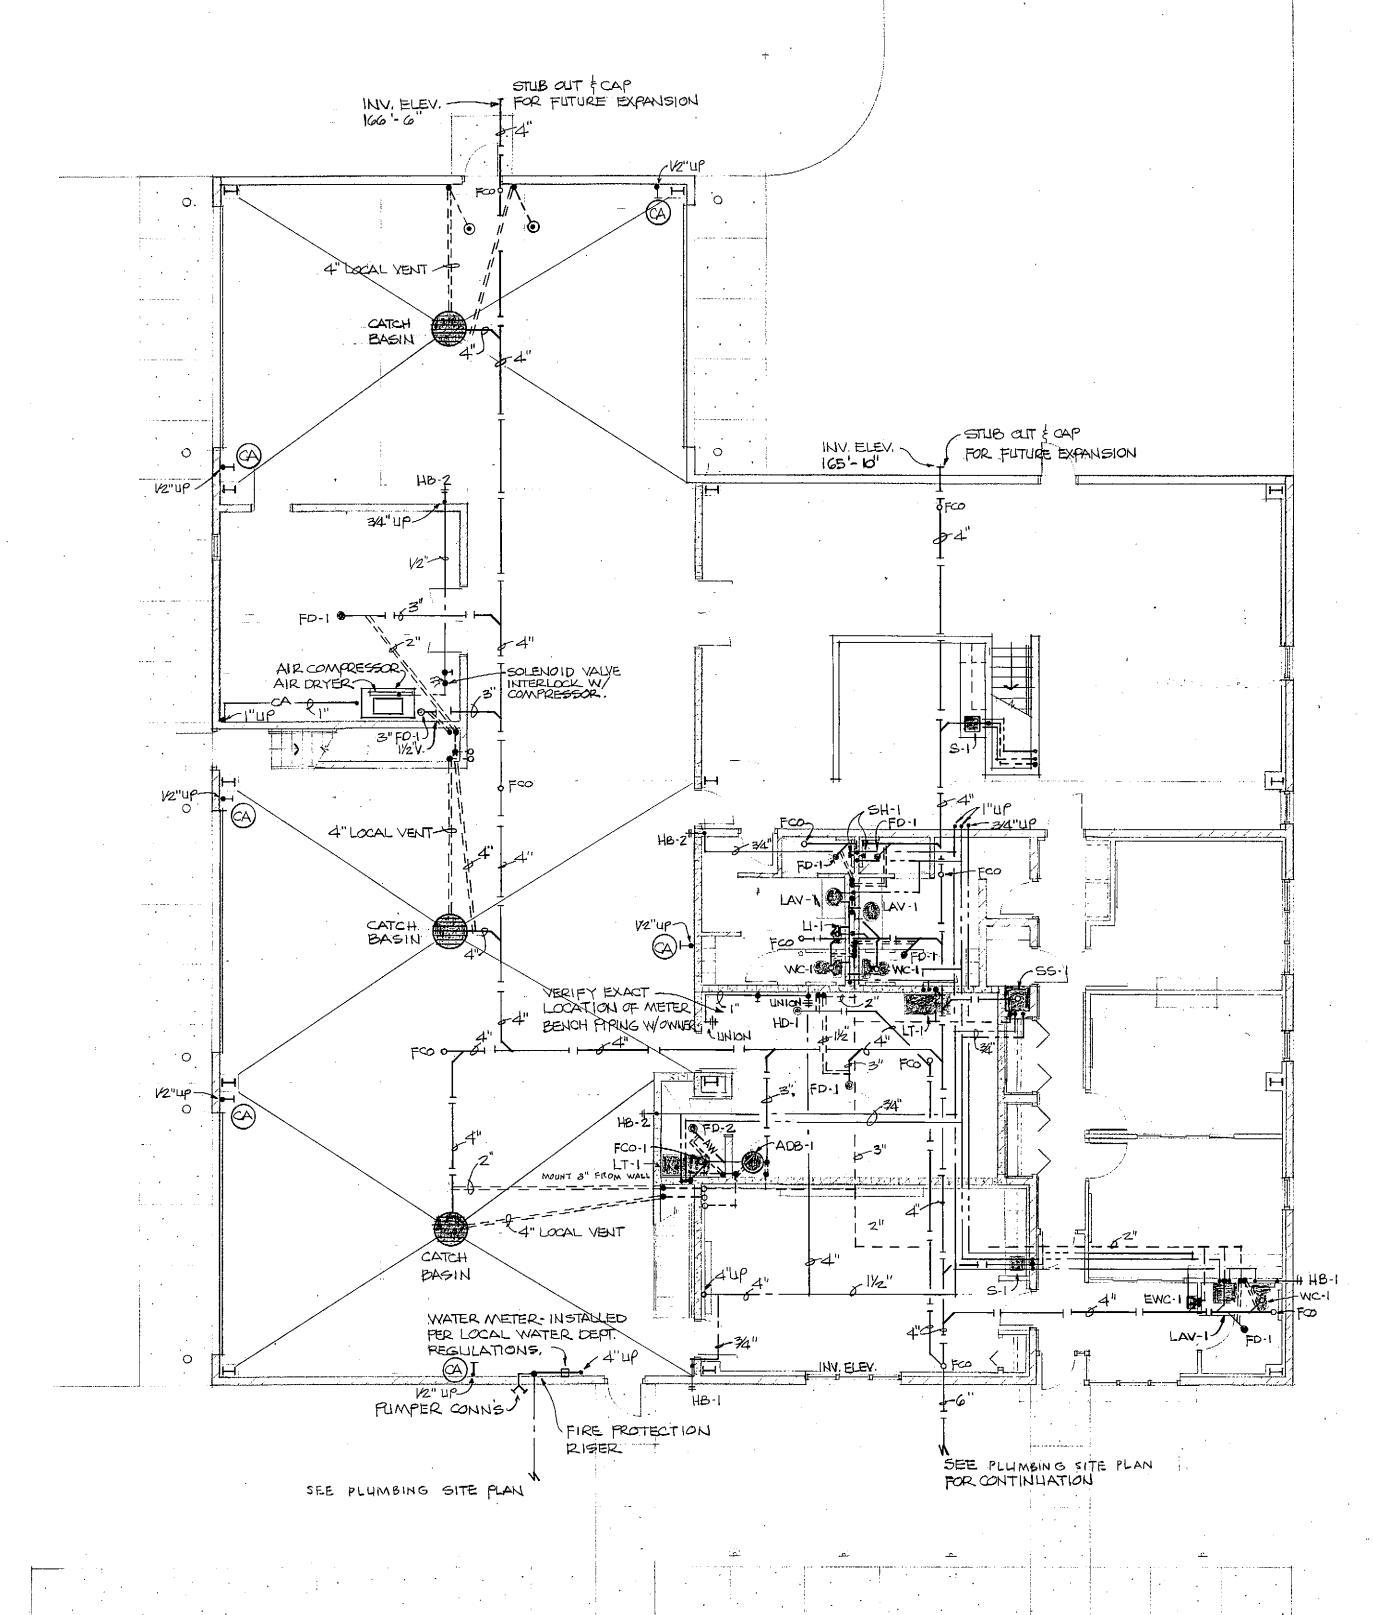




2 UPPER LEVEL PLUMBING PLAN P-2 VB" = 1-0"



FIRST FLOOR PLUMBING PLAN

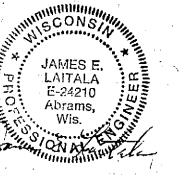

REVISIONS

FILE NO. 2414

PROJECT REVIEW

SURVEYED BY
ORAWN BY

DATE 2.1.89

DATE 2.1.89

DATE DESIGN
2/1/89

SCOPE I.D. 88F40

REVIEW


DATE REVIEW

Foth & Van Dyke
Engineers / Architects


FITCHBURG UTILITY BUILDING
6060 McKee Road Fitchburg, WI

SHEET NO.

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WALL OR COLUMN

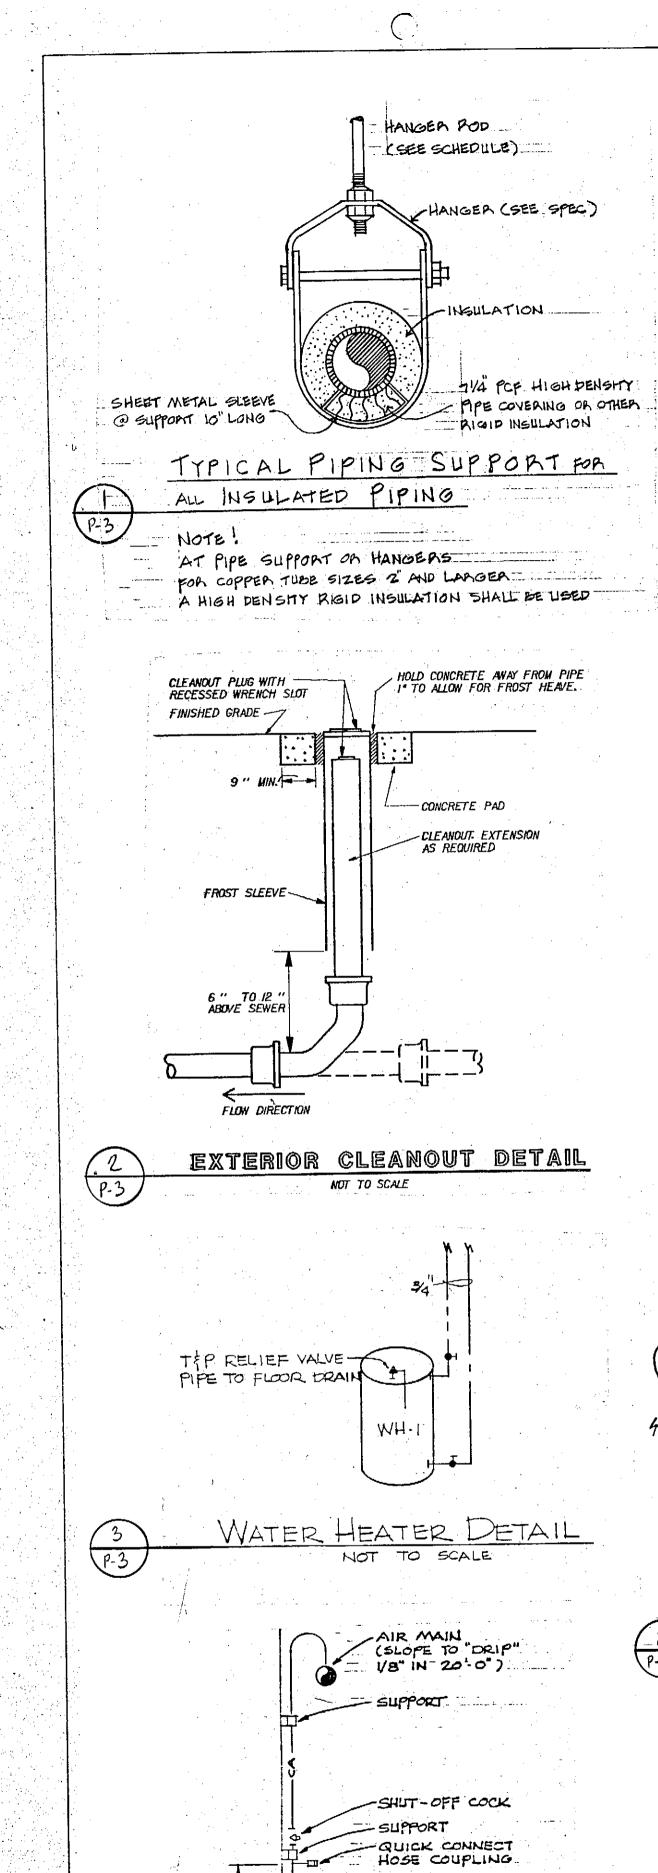

FOR COPPER THEING

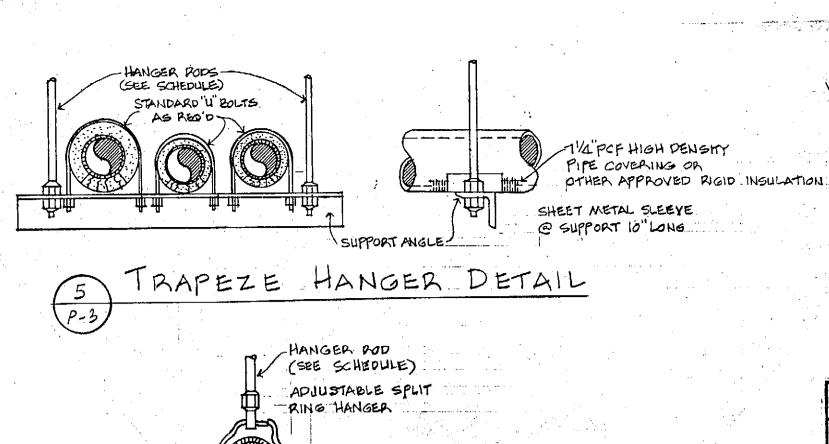PROVIDE SHEET LEAD BETWEEN PIPE AND HANGER

PIPING SUPPORT

FLOOR SLAB

NOT TO SCALE

MUFFLER

RELIEF VALVE

4" LOCAL VENT

WATER STOP -FULL PERIMETER

WATER LINE

NTERIOR

INTAKE FILTER

FLEX HOSE -

FOR CONTINUATION

CA.VALVE -

SET @ 10016.)

PRESSURE REGULATOR

SEE ALTOMOTIVE

SHOP SHEET

SAFETY VALVE

FRESSURE 7

GAUGE

NEENAH FOUNDRY #R-GIIB

CI. FRAME & GRATE CAST IN

FLUSH FLOOR : CLEANOUT (FCO)

GROUT IN FULL

PIPE

COOLER.

PERIMETER ALL PENETRATIONS.

PIPE SIZE	SPACING	HANGER PO	
TNCHES	STEEL .	COPPER	SIZE INCHES
V2	5	6	3/8
3/4	6	6	3/8
		6	3/8
. 174	8	6	3/8
1/2	• 9	10	2/8
2	0	10	3/8
2/2		10	3/8
	12	10	3/8 1. 1

INSTALL PER MANUFACTURERS REQUIREMENTS

		SHOCK	ABSON B	ER SCH	EDULE
:	SYMBOL	A	В		D E
		15001	75002	75003	75004 75006

 ACID	PIPING	TO BE	FUSEAL	ENFIELD	OR.	EQUAL.
 THIS T	NCLUDE:	FITTIN	NGS.			.,

_____ ----___

---VA---

SAN .S .

CO . OR F .

KEY OF PLUMBING SYMBOLS

STORM SEWER

COLD WATER

HOT WATER

BALL VALVE

SHOCK ABSORBER

VENT PIPE ABOVE GRADE

VENT PIPE BELOW GRADE

HOT WATER RECIRCULATING

COMPRESSED AIR OUTLET COMPRESSED AIR PIPING ACID YENT PIPING

SANITARY SEWER OR DRAIN BELOW GRADE

SANITARY SEWER OR DRAIN ABOVE GRADE

HOT WATER WITH HEAT TAPE 120 DEGREES HOT WATER WITH HEAT TAPE 140 DEGREES

CLEANOUT OR FLUSH CLEANOUT (NOTED)

ACID WASTE PIPING LIPSTREAM OF ADB-I

414 - 1 - 1 - 1 - 1 - 1 - 1 - 1 - 1 - 1	SHOCK	ABSOND	EN SCH		
SYMBOL	A	В		D	E
	15001	75002	75003	75004	75206


		PLUMBI	NG FIXTURE SCH	HEDULE					· · · · · · · · · · · · · · · · · · ·		
SYMBOL	MANUFACTURER	MODEL NO.	DESCRIPTION	MTGAFF	P WASTE	PING (ONNECTI CW.	HW.	FURNISHED BY	INSTALLED BY	REMARKS
WC-1	AMERICAN STANDARD	2109.700	FLUSH TANK TYPE WATER CLOSET	FLOOR	4"	1/2"	1/2"		P.C.	P.C.	COLOR WHITE
AAC - 1	BEMIS	1955-C	SOLID PLASTIC OFEN FRONT SEAT						PC.	PC.	COLOR WHITE
LJ-1.	AMERICAN STANDARD	6400.014	FLOOR TYPE URINAL	24" TO RIM	2"	1/2"			P.C.	P.C.	COLOR WHITE
<u> </u>		186	FLUSH VALVE				3/4"	·	P.C.	PC.	
00 1	SLOAN	43	MOLDED STONE SERVICE SINK 24"X24"	FLOOR	ਤ''	1/2"			P.C.	PC.	
SS-1		911-15	SERVICE SINK FALICET W/ VAC, BRKR	VAC. BRKR@7-6"			3/4"	3⁄4"	P.C.	P.C.	
	CHICAGO FAUCETS	65,600 \$65,700	MOPHANGER & HOSE HOLDER						P.C.	P.C.	
	MUSTEE	415-ZN	FLOOR DRAIN	FLUSH					P.C.	PC.	SEE PLAN FOR SIZE
FD-I	ZURN	Z-1400-2-ZN	FLUSH FLOOR CLEANOUT	FUISH					PC.	PC	SEE PLAN FOR SIZE
FCO	ZURH	Z-1440-1	FLLISH WALL CLEANOUT	FLUSH					P.C.	P.C.	SEE PLAN FOR SIZE
Mco	ZURN		ROOF FRAIN		<u> </u>				P.C.	PC.	SEE PLAN FOR SIZE
RD-I	ZURN	Z-100ERC	ELECTRIC WATER COOLER	29" TO BOTT, EDGE					P.C.	P.C.	
EWC-I	OASIS	∞P5M	SUBSACE MOUNTED STAINLESS STEEL SHOWER	HEAD @ 6'-0"			-1/2"	1/2"	P.C.	P.C.	
SH-I	SYMMONS	1-8018	LINIT W/ PRESSURE BALANCING SHOWER VALVE		11/2"	1/2"			PC.	P.C.	COLOR WHITE
LAV-I	AMERICAN STANDARD	0076.027	VITREOUS CHINA SELF-RIMMING LAVATORY				1/2"	1/2"	P.C.	P.C.	
	SYMMONS	.S-GO-GH	METERING FAUCET W/ 4" CENTERS			 	3/4"	,-	P.C.	P.C.	
HB-I	WOODFORD	.65	FREEZEPROOF HOSEBIBB				-74				48,000 BTU/HR INPUT
WH-I	STATE INDUSTRIES	58-50-NADS-F	GAS FIRED WATER HEATER DIRECT VENT								
HD-1	ZURN	32100-2	HUB DRAIN (SE PLAN FOR SIZE)		<u> </u>						
ADB-1	SCHIER	NT-30AE	ACID DILUTION BASIN	FLUSH	3"	211					SEE PLAN FOR SIZE
FD-2	FUSEAL	7751	ACID RESISTANT FLOOR DRAIN								JESTUAIN FOR SIZE

36" DA. CONCRETE SEWER — G" CONCRETE BASE ON COMPACTED SAND BASE CATCH BASIN DETAIL COMPRESSOR - VERIFY VOLTAGE
WITH ELECT. CONTR. / MOTOR & DRIVE MOISTURE SEPARATOR

COMBINATION SEPARATOR-TRAP CRAIN VALVE ISOLATORS SEE DETAIL -PIPE 34"CW TO INLET. PIPE 34" FROM WATER OUTLET TO DRAIN

CFLEXIBLE CONNECTION

CONTRACTOR TO FURNISH ENOUGH LIMESTONE CHIPS TO FILL ADB-1 TWICE AFTER FIRST FILL

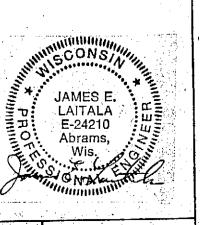



P-3 NOT TO SCALE		ing the state of t
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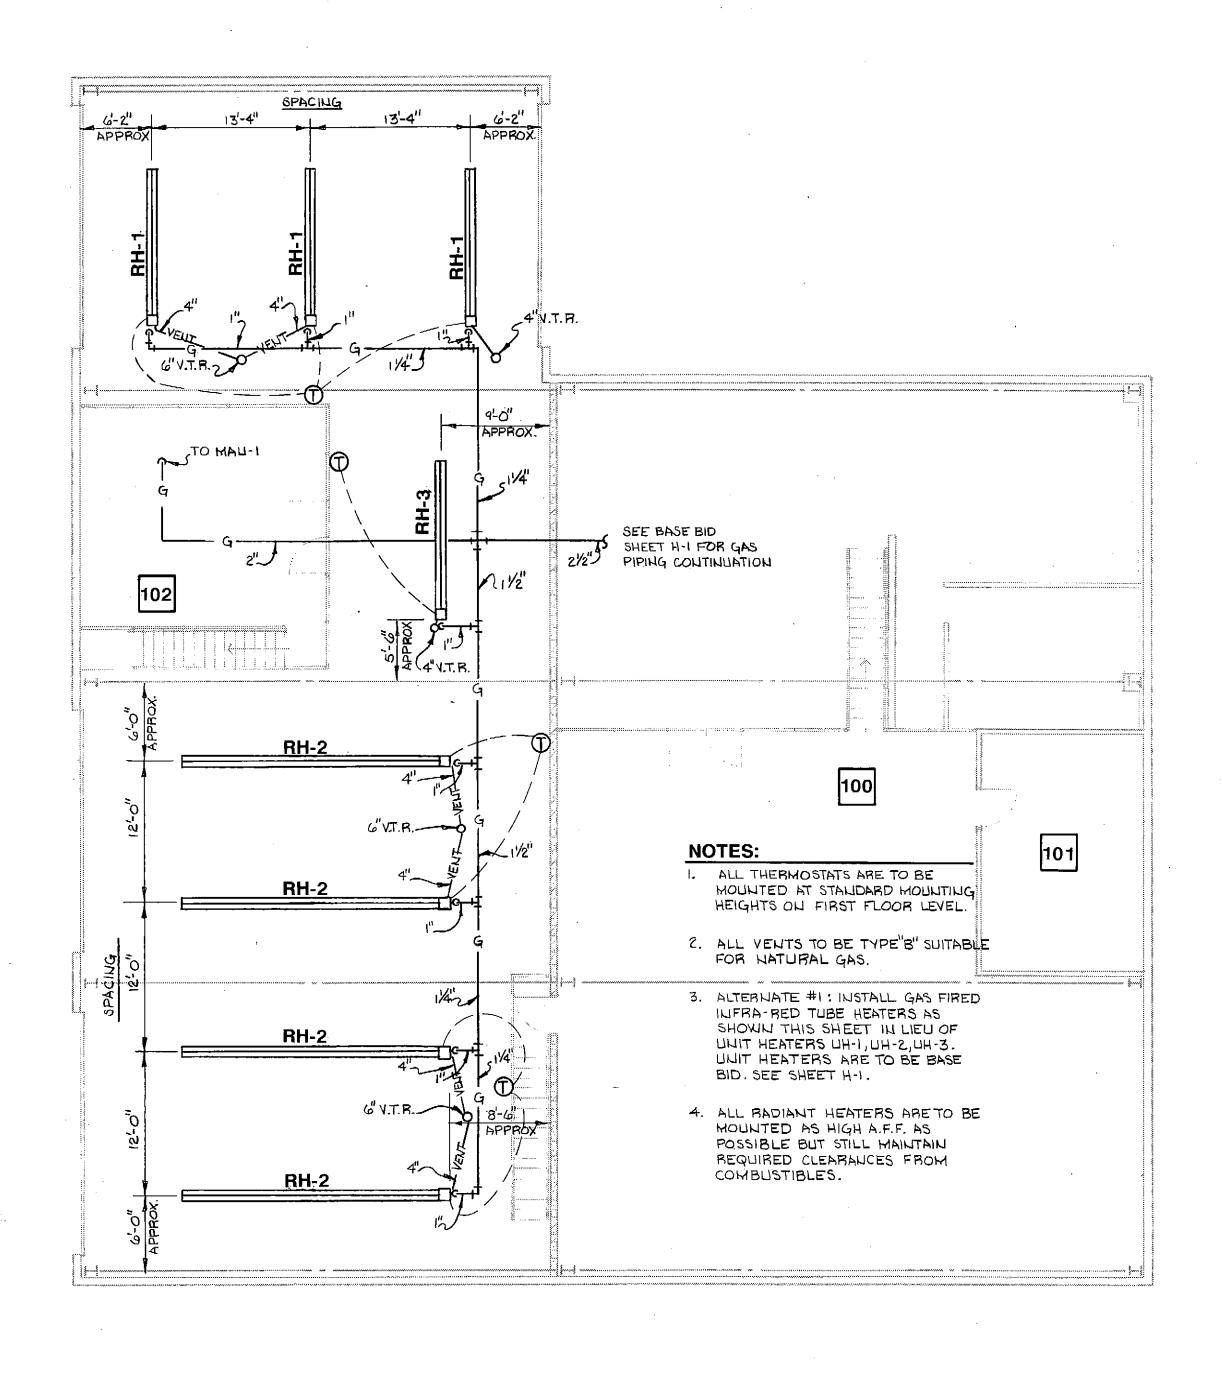
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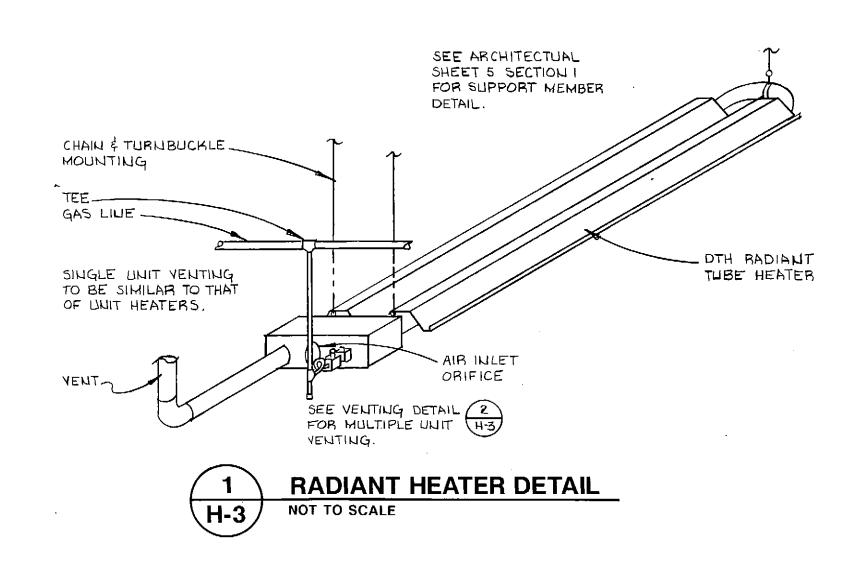





UPPER LEVEL PLAN ALTERNATE #1 BID - RADIANT HEAT

SCALE: 1/8" = 1'-0"

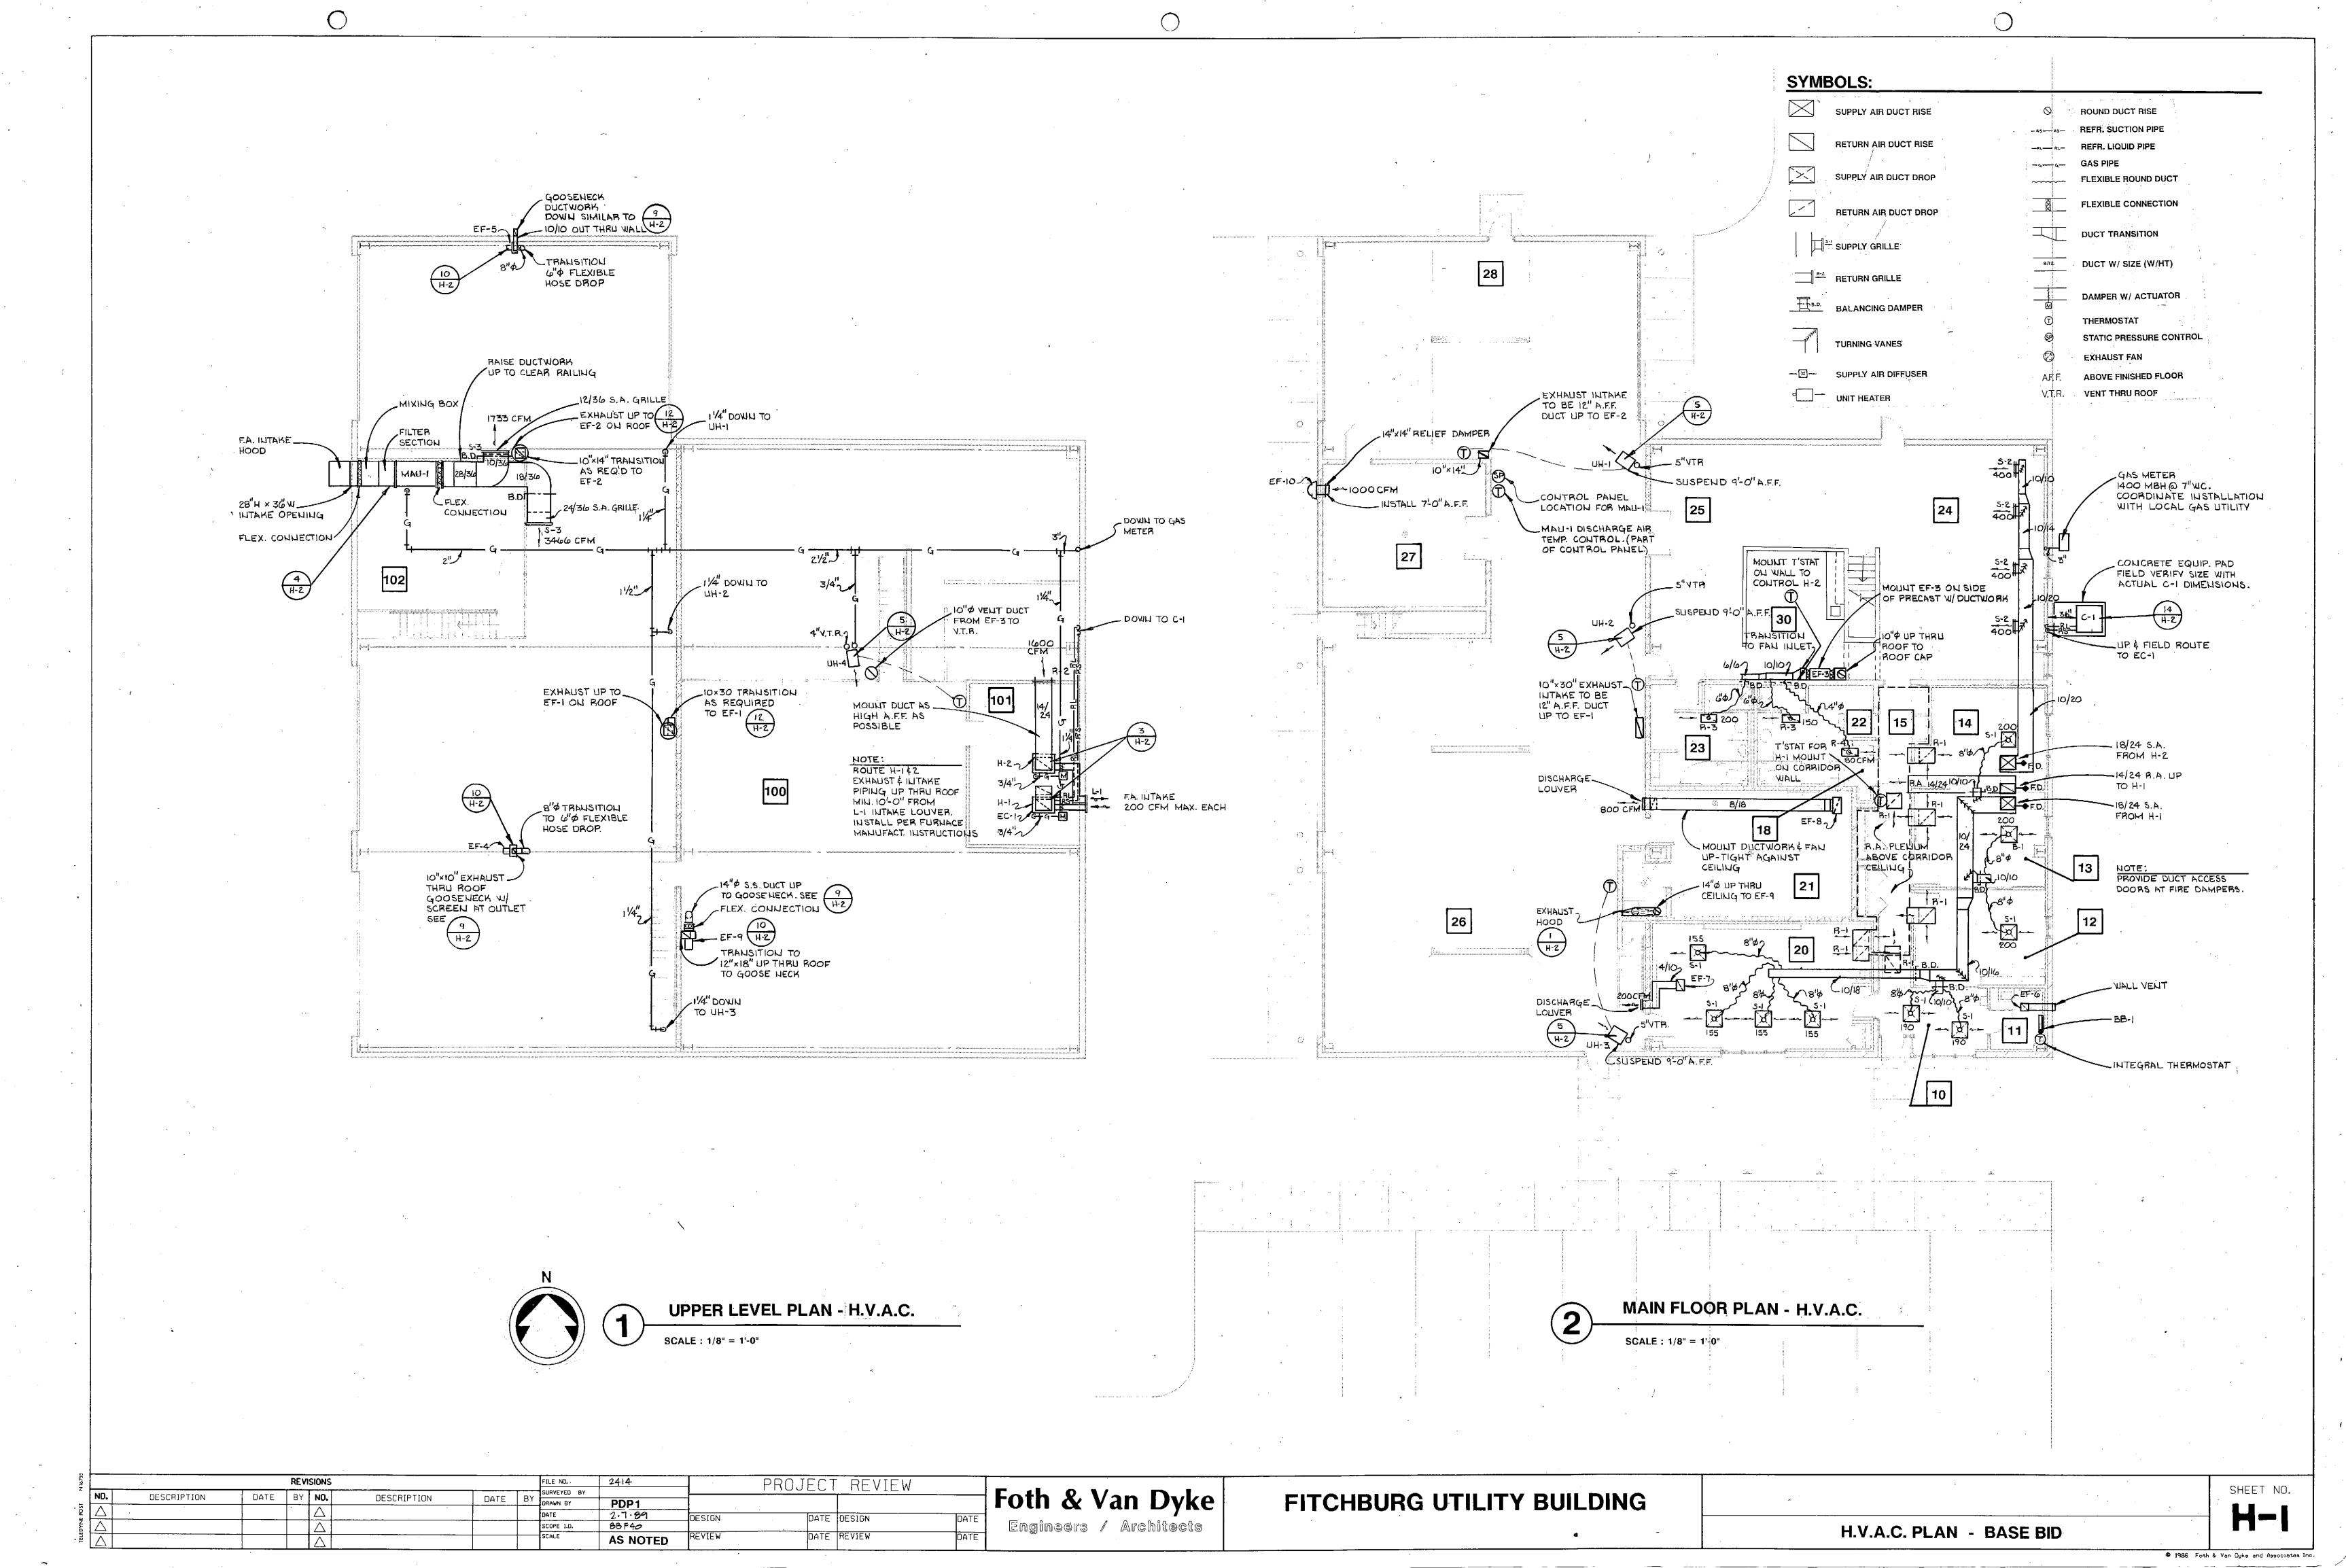i.d.	description	menf.	model	elec. data	remarks
RH-1	Gas Fired Infra-Red Radiant Tube Type Heater output: 75,000 BTUH ea.	Detroit Radiant Products Co.	DTH 20 - 75N	4.8A, 115V	3 Units Req'd
RH - 2	Gas Fired Infra-Red Radiant Tube Type Heater output: 100,000 BTUH ea.	Detroit Radiant Products Co.	DTH 40 - 100N	4.8A, 115V	4 Units Req'd
RH́-3	Gas Fired Infra-Red Radiant Tube Type Heater output: 40,000 BTUH ea.	Detroit Radiant Products Co.	DTH 20 - 40N	4.8A, 115V	l Unit Req'd

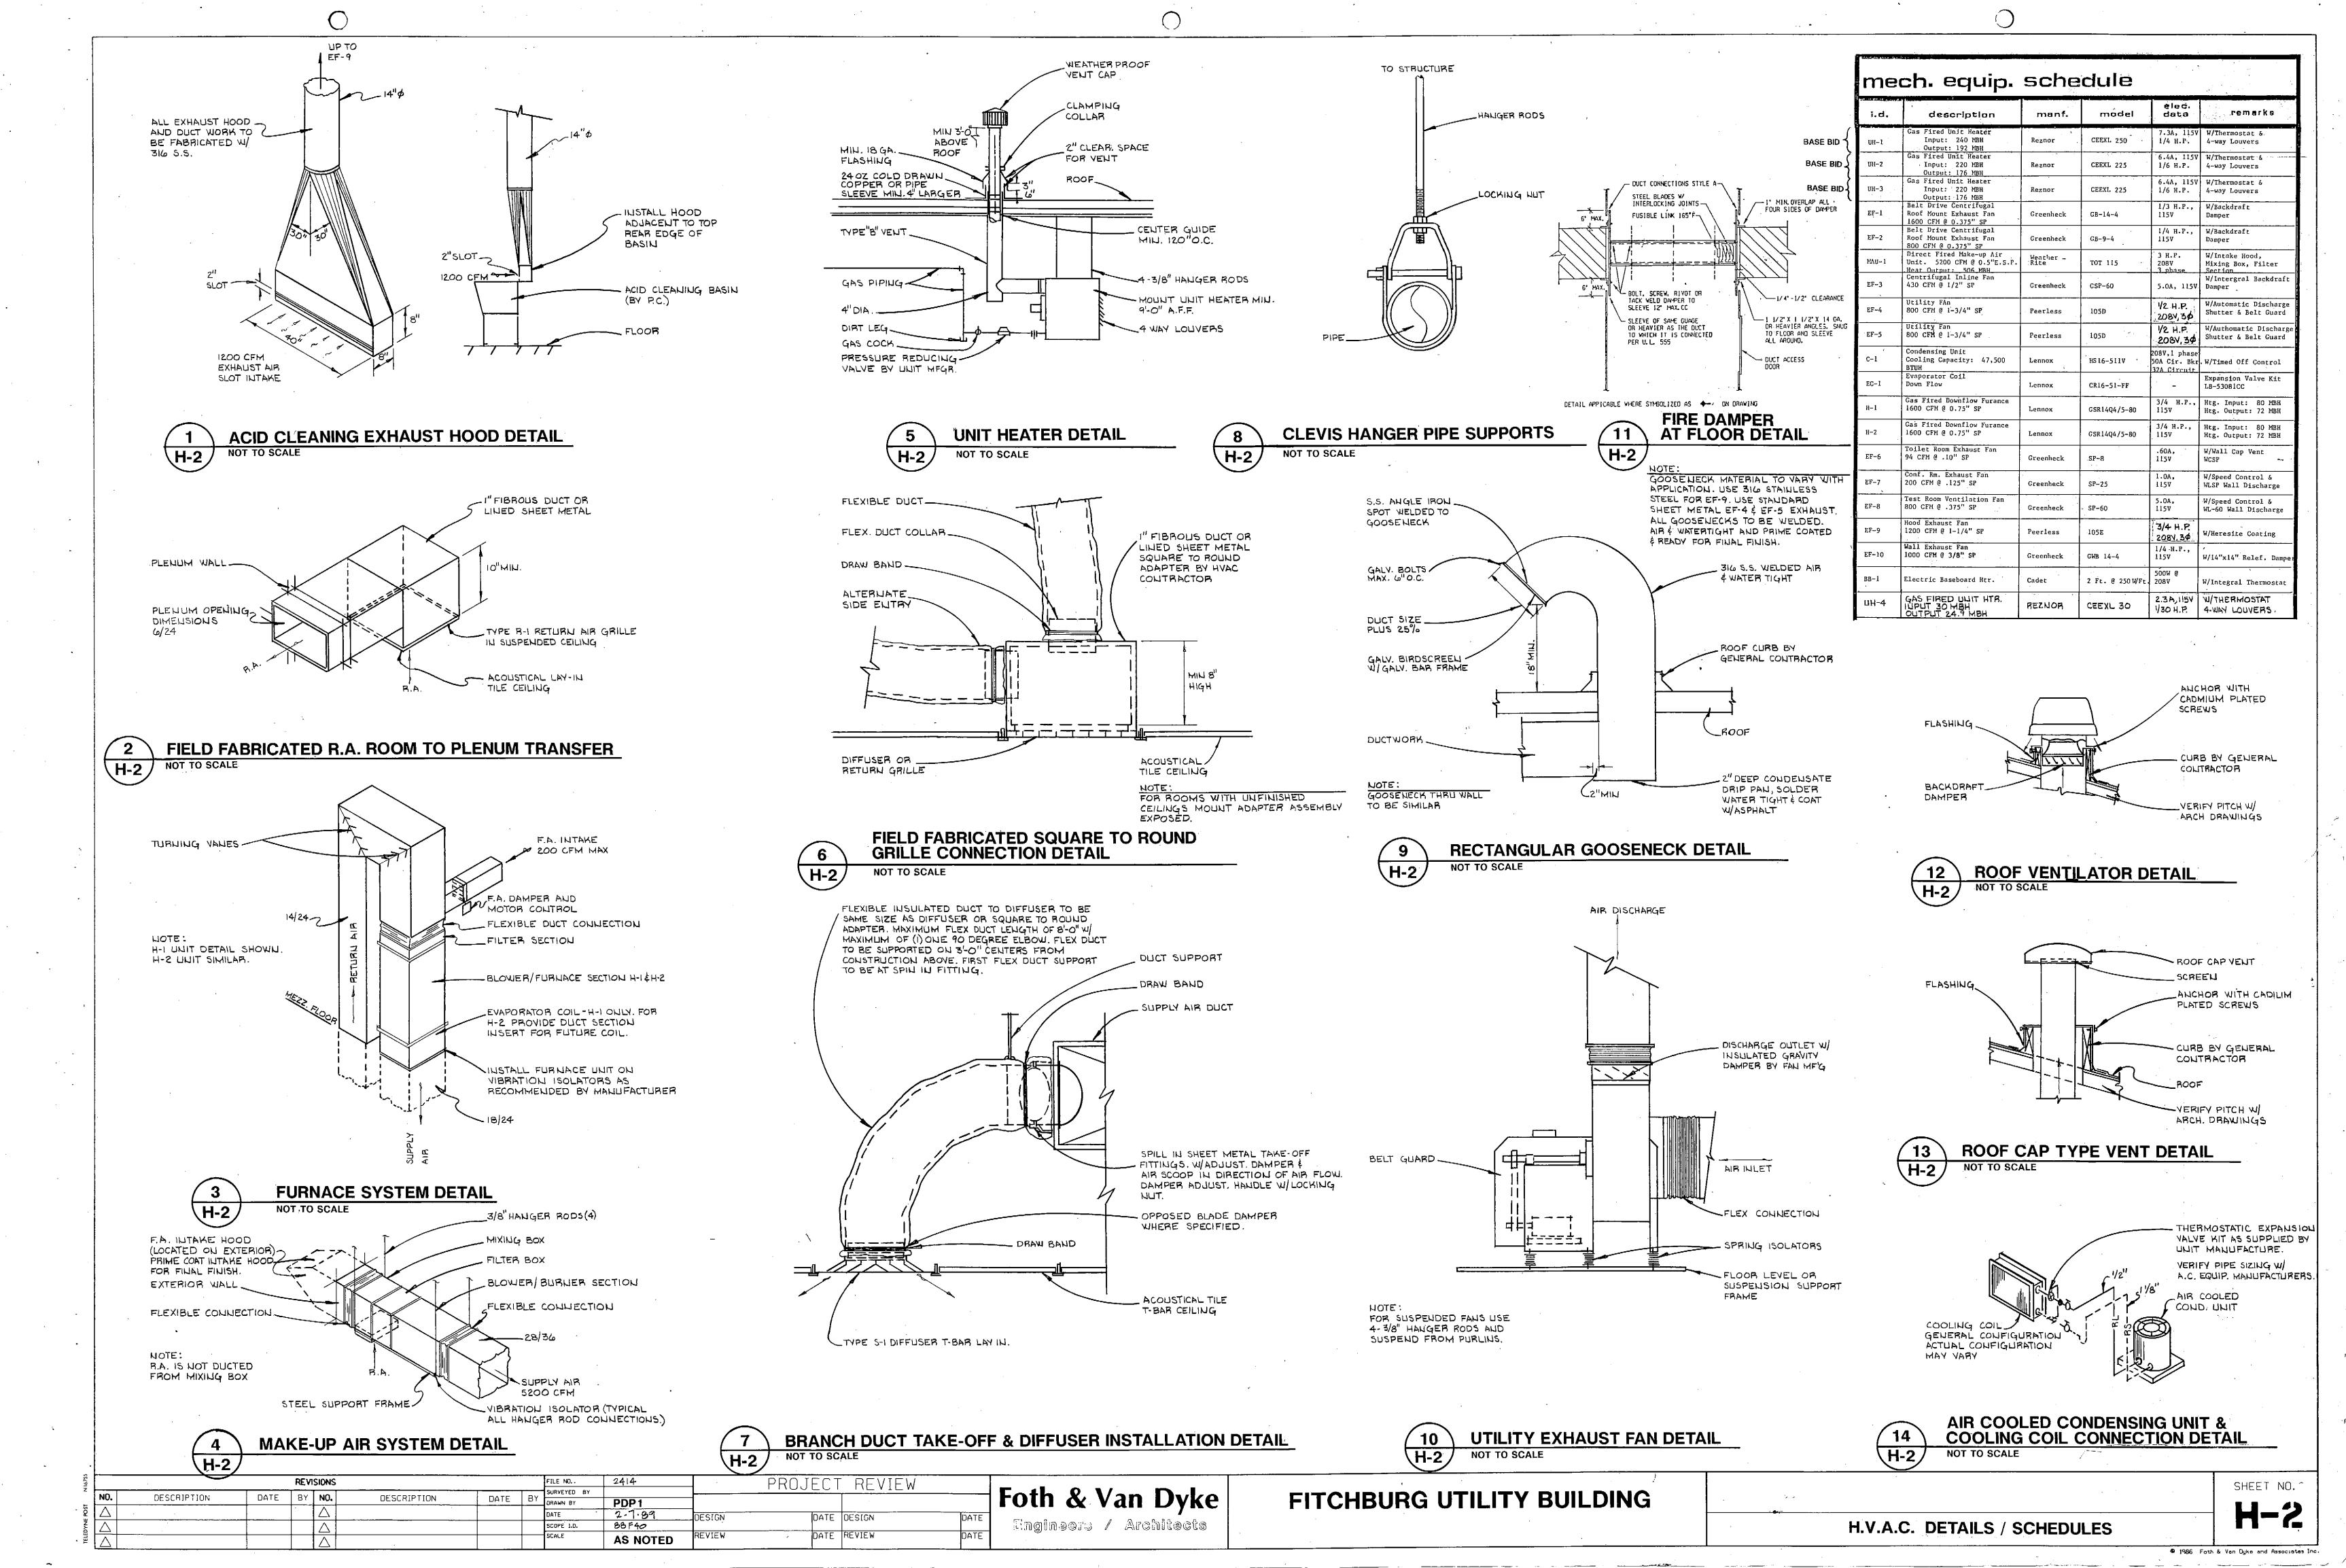

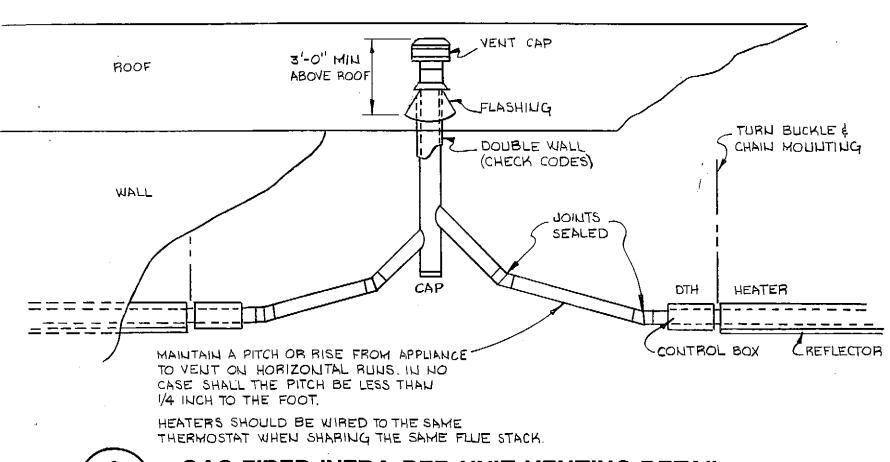

GAS FIRED INFRA-RED UNIT VENTING DETAIL

NOT TO SCALE

			REV	ISIONS				FILE NO.	2414		PROJECT	REVIEW		
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\triangle				Δ				DATE	2.7.89	DESIGN	DATE	DESIGN	DATE	1
		,				e we see		SCOPE 1.D.	88 F40	REVIEW				Engineers / Architects
$1 \wedge 1$								SCALE	AS NOTED	KEATEM	DHIE	REVIEW	DATE	

n Dyke

FITCHBURG UTILITY BUILDING

H.V.A.C. - ALTERNATE #1 PLAN / SCHEDULE / DETAILS

SHEE


SYMBOLS

FLUORESCENT FIXTURE INCANDESCENT OR H.I.D. FIXTURE RECESSED INCANDESCENT OR H.I.D. FIXTURE SINGLE POLE SWITCH THREE WAY SWITCH **DUPLEX GROUNDED RECEPTACLE** DUPLEX GROUNDED RECEPTACLE - COUNTER HEIGHT OR 48" A.F.F. WHERE NO COUNTER EXISTS, SEE SPECIFICATION. SPECIAL OUTLET 250V, 50A, 2P, 3WHUBBELL #9367 W/ #9368 PLUG. MOTOR OR SPECIAL OUTLET TELEPHONE OUTLET HEAT DETECTOR FIRE ALARM STATION FIRE ALARM SIGNAL WITH STROBE **JUNCTION BOX** DISCONNECT SWITCH DATA LINE OUTLET, 3/4"C TO TELEPHONE PANEL W/#12 INSULATED GND. WIRE. SWITCHED CIRCUIT "OPEN-STOP-CLOSE" OVERHEAD DOOR SWITCH FOR MOTOR OF SAME NO., FURNISHED BY OTHERS, INSTALLED AND WIRED BY E.C. K INDICATES KEY OPERATED. ELECTRICAL CONTRACTOR W.P. WEATHERPROOF A.F. F. ABOVE FINISHED FLOOR **ABOVE FINISHED GRADE** A.F.G. FA\CP FIRE ALARM CONTROL PANEL DOUBLE THROW SAFETY SWITCH, NOT FUSIBLE,240V,2 POLE,30A: PHOTOELECTRIC CONTROL ,TORK MODEL 2001 OR EQUAL. P 8" FIRE ALARM BELL START/STOP PUSHBUTTON, MAINTAINED CONTACT FOR MOTOR OF SAME NUMBER. MECHANICAL CONTRACTOR MC. MANUAL STARTER MAN MAGNETIC STARTER MAG ON UNIT QU **NEAR UNIT** NU **PREWIRED** PW CIRCUIT BREAKER CB CRKT CIRCUIT

SPEED

SWITCH

SPD

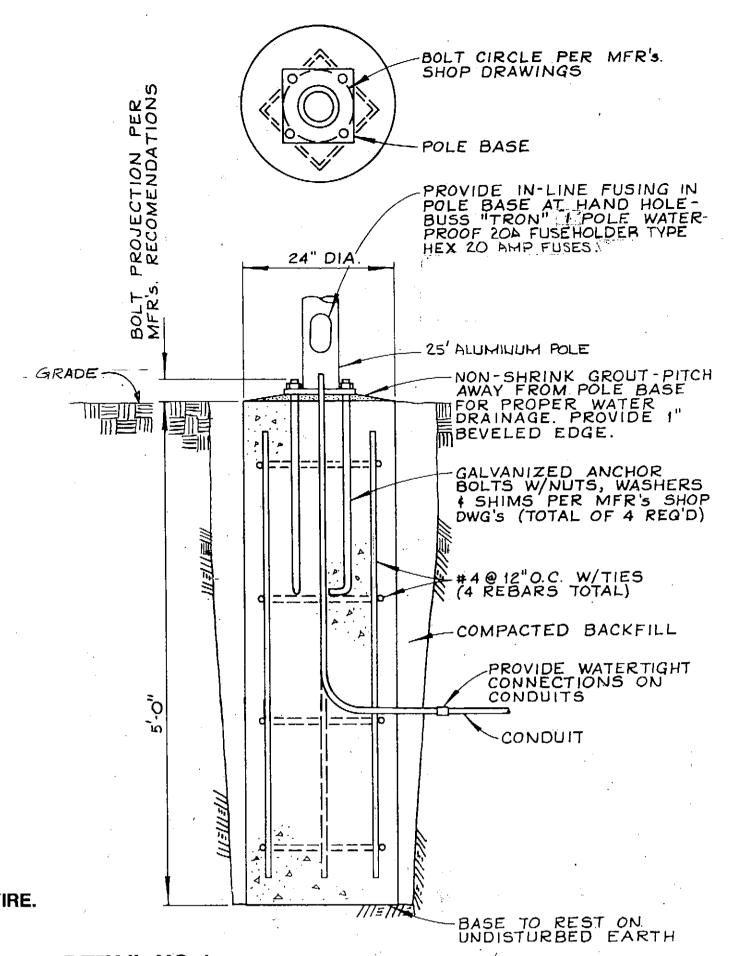

CONCRETE BASE DETAIL FOR POLE LIGHTS NOT TO SCALE

PANEL"A" CIRCUIT BREAKERS: 1-3P 80A (FOR PANELB) 1-2P 50A (FOR WELDER) 25-1P 20A (MISC. CIRCUITS) MECH. ROOM 8-IP 20A (GFI CB'S FOR MISC, CIRCUITS) MAIN PANEL "A" 120/2084, 3 \$,4W PANEL"B" CIRCUIT BREAKERS: MECH. PAHEL"B" 1-3P, 20A (FOR MA-1) 1-2P, 50A (FOR C-1) 1-2P, 20A (FOR BB-1) 3-1P, 25A (MISC. CIRCUITS) 30,4W 3-IP ISA (MISC. CIRCUITS) 1-3P GOA (FOR AIR COMPRESSOR) BATTERY BACK UP 5/N 8-IP 20'A (FOR MISC, CIRCUITS) 3-3P 15A (FOR EF-4,5 & 9) AOOI M.L.O. 225A M.L.O. 42 CRKT. DOUBLE 30 CRCT. CONCRETE ENCASED PANELS 4-#3/0, 1-#2 GND, 21/2"C TRANSFORMER & METER SOCKET AS PER MADISON

MAIN DISCONNECT:

200A, 120/208V, 34, 4W

HEAVY DUTY SWITCH W/ 200A CLASS RKI FUSES

BUILDING GUD, SYSTEM

POWER SINGLE LINE NOT TO SCALE

GAS & ELECTRIC

FIXTURE SCHEDULE LAMPS DIFFUSER OR SHEILDING MOUNTING FINISH DESCRIPTION ORD. ABBR. FLUSH WITH 25P-G-240-FLUORESCENT TROFFER ACRYLIC PRISMATIC AILIOHTIL CEILILIG ENAMEL A12-120-ES RS/WHII PG-TG WITH PG624 RECESSED SHOWER RECESSED WHITE ACRYLIC PROGRESS FLUORESCENT INDUSTRIAL WITH 10% UPLIGHT AF10-240 CHAIN HUNG 8'A.F.F. HOHE AILIOHTIL 120-ES (4 W/8T PREFIX ENAMEL RS/WMI CHAIN HUNG, 10! AFF IN WHITE BAKED GENERAL PURPOSE EJ-2-40 F40TI2/LW AILIOHTIL GARAGE, B'AFF ELSEWHERE 120 - ES ENAMEL FLUORESCENT INDUSTRIAL RS/WMII HOOK-CORD-PLUG TE 250M -HIGH BAY ENCLOSED MVR 250 SPUH ALUMINUM TEMPERED GLASS AILIOHTIJ & RECEPTACLE IGA F.F. E17W-120 -SF-LCP3 METAL HALIDE HOOK . CORD - PLUG HIGH BAY ENCLOSED TE400-E17W MVR 400 SPUN ALUMINUM LITHONIA TEMPERED GLASS & RECEPTACLE IG A.F.F. 120-SF-LCP3 METAL HALIDE WALL ABOVE DOORS, 15' AFG WE-14-1-FM METAL HALIDE MVR 175 DARK BRONZE POLYCARBONATE GARDCO 120-175 MH BRA- POLY WALL MOUNT WALL ABOVE WE-19-1-FM METAL HALIDE MVR 250 POLYCARBONATE GARDCO DARK BRONZE DOORS, 15' AFG 120-250MH WALL MOUNT BRA-PC-POLY POLE MOUNT H-19-2-3 METAL HALIDE POLE DARK BRONZE POLYCARBONATE GARDCO 25' AFG 120-400 MH BBP-POLY MOUNTED AREA LIGHT IN FIXTURE ADD"EL" EMERGENCY LIGHTING LITHOUIA BY MANUFACTURER PACKAGE IN LITHONIA FLUORESCENT FIXTURES FIXTURE CAT. N. WALL 8' A.F.F. SELF CONTAINED STEEL HOUSING SEALED BEAM ELU-2C AILIOHTIL ELB EMERGENCY LIGHT PAR-36 WALL 7' A.F.F. RED LETTERS ON SINGLE FACE EXIT STENCIL FACE MARCO F4/T5 £Χ

PROVIDE: 2-25' GARDCO ALUMINUM POLES, CAT # CA5-25H DARK BRONZE.

MOTOR & SPECIAL OUTLET SCHEDUL													LE	E		
MTR. NO.	DESCRIPTION	LOCATION	KW.	"Н.Р.	VOLT	ϕ	CKT.	BKR./FUSE		STARTER		CONTROL			REMARKS	
								POLE	AMP.	TYPE	WIRING BY	LOC.	ТҮРЕ	WIRING BY	LOC.	
UH-I	UNIT HEATER	GARAGE		· 1/4	115	1	B-1	_	20	MAG.	EC	72	THERMOSTAT	Y.	GARAGE	BASE BID
UH-2	UNIT HEATER	GARAGE		1/6	115	١	B-19	-	20	MAG.	EC	הא	THERMOSTAT	МС	GARAGE	BASE BID
UH-3	UNIT HEATER	GARAGE		1/6	115	1	B-19	١	20	MAG.	EC	ИП	THERMOSTAT	MC	GARAGE	BASE BID
EF-I	ROOF EXHAUST	ROOF		1/3	115	1	B-2		20	MAN.	EC	gee Plan	_	_		SEE NOTE 2
EF-2	ROOF EXHAUST	GARAGE		1/4	15	١	B-3	1	15	MAN.	EC	SEE PLAN		_	_	SEE NOTE 2
I-AM	MAKE-UP AIR UNIT	TOOL RM. MEZZ.		3	208	3	B-7	3	20	MAG.	PW	o O	INTERLOCK W/ EF-1 & EF-2			SEE NOTE 1
EF-3	CENTRIFUGAL FAN	ABOVE BREAK RM.		FRAC.	115	1	B-4	ì	15	-	_	-	TIME CLOCK	MC	MECH. RM.	SEE NOTE 2
EF-4	UTILITY FAU	GARAGE		1/2	208	3	B-5	3	- 15	MAH.	EC	SEE PLAN		_	_	
EF-5	UTILITY FAN	GARAGE		1/2	208	3	B-6	3	15	ман.	EC	SEE			_	
C-1	CONDENSING UNIT	PAD MOUNT	6.0		208	1	B-13	2	50	MAG.	PW	OU	THERMOSTAT	MC	OFFICE	
H-1	DOWN FLOW FURNACE	MECH, RM.		3/4	115	١.	B-10	1	25	MAG.		ΟU	THERMOSTAT	MC	OFFICE	
H-2	DOWN FURNACE	MECH, RM.		3/4	115	1,	B-8	١	25	MAG.		OU	THERMOSTAT	МС	BREAK RM.	
EF-6	TOILET FAN	TOILET RM,		FRAC.	115		OFF				_		LIGHT SWITCH	EC	TOILET RM.	
EF-7	CONF. EXHAUST FAN	CONF. RM.		FRAC.	115	. 1	B-12	1	20		 -		SPD. SWITCH	EC	CONF. RM.	SPD, SW, BY MC. SEE NOTE 2
EF-8	TEST ROOM VENTILATO	RITEST RM.		FRAC.	115	1	B-12		20		_		SPD, SWITCH	EC	TEST RM.	SPD. SW, BY MC, SEE NOTE 2
EF-9	HOOD EXHAUST	MEZZ.		3/4	208	3	B-15	3	15	MAN.	EC	SEE PLAN			-	
EF10	WALL EXHAUST	TOOL RM.		1/4	115	1	B-16		15	MAN.	EC	SEE PLAN	TAUK VALVE	_	-	SEE NOTE 2
	AIR COMPRESSOR	TOOL RM.		10	208	3	B-18	3	60	MAG.	EC	TOOL RM.		EC	· ON	NEMA SIZE 2 STARTE
BB-1	BASEBOARD HEATER	TOILET RM.	0.5		208	1	B-14	2	20	_	 	_	INTEGRAL		OU	,
RH UH-4	RADIANT HEATERS 1,2\$3 (ALTERNATE BID)	GARAGE	O,1 EA	,	115	1	3 CRKT	5 1	20	MAG.	EC	οu	THERMOSTAT		GARAGE	ALTERNATE BID-1 SEE MECH, SHT, H-3
	WELDER RECEPTACLE	TOOL BOOM	10.4		208	1	A-24	2	50	-						250V, 50A, 2P, 3W HUBBELL#9367
	UNIT HEATER	ABOVE BREAK RM.		1/20	115	1	B-1	1	20	MAG.	E.C.	N.U.	THERMOSTAT	MC	MEZZ.	

NOTE # | - MA. I DISCONNECT AND STARTER FURNISHED ON UNIT BY MC. MA-1 TO OPERATE WHEN EF-1 AND/OR EF-2 ARE OPERATING

NOTE #2-DISCONNECT ON UNIT BY MC.

FITCHBURG UTILITY BUILDING

SHEET NO. E

PROJECT REVIEW REVISIONS Foth & Van Dyke URVEYED BY DATE BY DATE BY NO. DESCRIPTION DESCRIPTION DATE DESIGN 1/30/69 DATE REVIEW Engineers / Architects PRD 88 F40

AS NOTED

SYMBOLS AND SCHEDULES

