

SCHEDULE OF FINISHES


KEY	
	FLOOR FINISHES
	WALL FINISHES
	SKIRTING FINISHES
	CEILING FINISHES

- FLOOR FINISHES**
- 1 50mm THK. FLOOR CEMENT RENDERING IN 1:3 CEMENT, SAND FINISHED SMOOTH WITH COLOUR CEMENT FLOAT.
 - 2 300 x 600 HEAVY DUTY POLISHED OR SATIN FINISH HOMOGENEOUS TILES LAID TO A PATTERN.
 - 3 300 x 600 NON - SKID TILES LAID TO GIVEN PATTERN
 - 4 CONCRETE POWER TROWEL FINISHED WITH HEAVY-DUTY EPOXY PAINT. (GRAY COLOUR) (PARKING & RAMPS)
 - 5 INTER - LOCK PAVING STONE FINISHED
 - 6 LOOP PILE CARPET
 - 8 NON TOXIC WATER PROOFING OF REPUTED MANUFACTURER
 - 9 450 x 900 HEAVY DUTY POLISHED OR SATIN FINISH HOMOGENEOUS TILES LAID TO GIVEN PATTERN.
 - 10 400 x 600 HEAVY DUTY POLISHED OR SATIN FINISH HOMOGENEOUS TILES LAID TO GIVEN PATTERN.
 - 11 50mm THK. FLOOR CEMENT RENDERING IN 1:3 CEMENT, SAND FINISHED.

- WALL FINISHES**
- A 1:5 CEMENT, SAND SMOOTH PLASTER FINISHED AND PAINTED WITH APPROVED COLOUR.
 - B 600 x 300 GLAZED CERAMIC WALL TILES UP TO CEILING LEVEL
 - C 300 x 300 GLAZED CERAMIC WALL TILES UPTO 1200 HEIGHT & 1:5 CEMENT, SAND SMOOTH PLASTER FINISHED PAINTED WITH APPROVED COLOUR.
 - D CALCIUM SILICATE BOARD & GLASS PARTITION WALL UP TO SLAB LEVEL
 - E TEMPERED GLASS PARTITION UP TO SLAB LEVEL
 - F EXTERNAL WALLS SEMI ROUGH FINISHED PLASTERED & PAINTED

- CEILING FINISHES**
- ▲ CEILING HEIGHT SHOULD BE 2.7 m. FROM FINISHED FL. LEVEL (150 mm. BELOW FROM BEAM- BOTTOM)
 - 1 SOFIT OF THE SLAB SMOOTH PLASTERED & PAINTED WITH APPROVED COLOUR.
 - 2 FAIR FACE CONCRETE SOFIT WITH PAINT OF APPROVED COLOUR.
 - 3 MINERAL FIBRE PANEL CEILING
 - 4 GYPSUM BOARD CEILING
 - 5 SUPPERFLEX BOARD CEILING
 - 6 ALUMINIUM STRIP CEILING
 - 7 MOISTURE RESISTANT CEILING

- SKIRTING FINISHES**
- a 100mm HIGH CEMENT, SAND SMOOTH FINISHED SKIRTING.
 - b HOMOGENEOUS TILES SKIRTING.
 - c TIMBER SKIRTING.

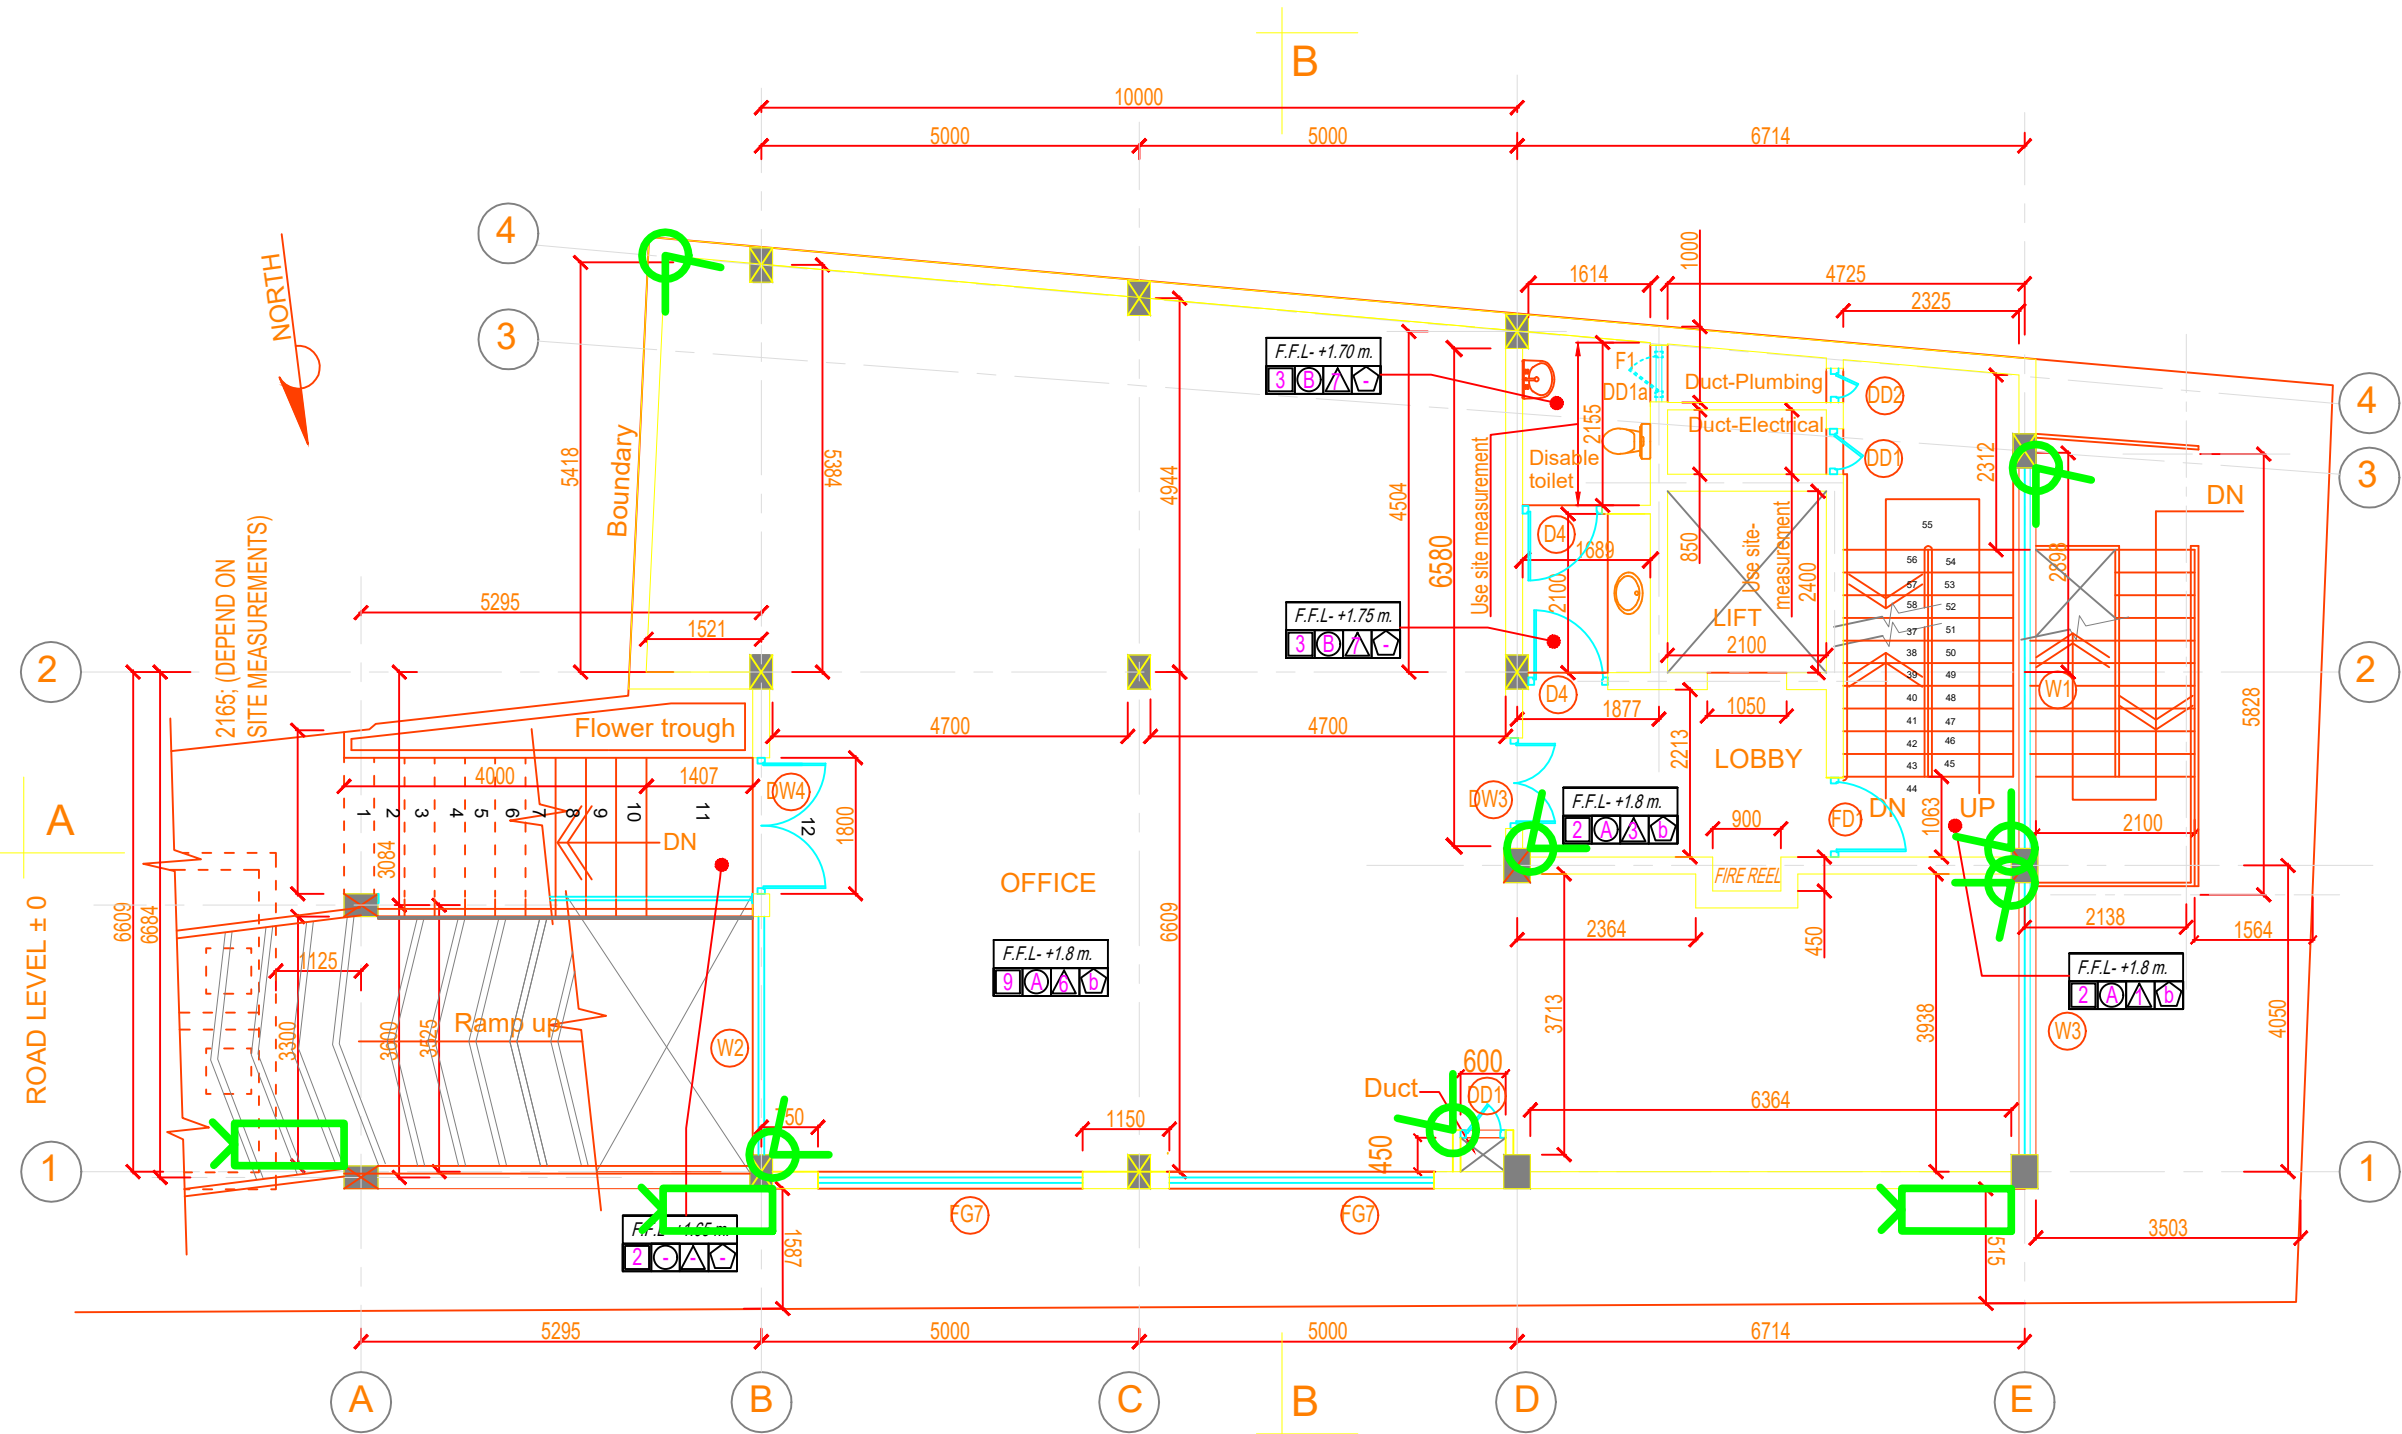


GROUND FLOOR PLAN

SCALE: 1 : 100

DOME CAMERA
BULLET CAMERA

NOTE :
1. ENTIRE AREA TO BE MECHANICALLY AIR CONDITIONED
2. CEILING HEIGHT SHOULD BE 2.7 m. FROM FINISHED FL. LEVEL (150 mm. BELOW FROM BEAM- BOTTOM)
REFER DETAIL AT DR. NO: KST/ARCH/DE/A-11

CONSULTANT

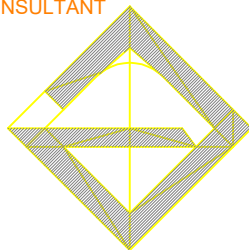

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PROJECT

PROPOSED BUILDING FOR
KS TRADING (Pvt) LTD,
AT No. 494 / 1,
NAWALA ROAD, RAJAGIRIYA.

REVISION	DESCRIPTION	DATE	CLIENT : KS TRADING (Pvt) LTD,		DRG. TITLE : GROUND FLOOR PLAN		
			PROJECT ARCHITECT : SUNIL ARIYARATNA	PROJECT ENGINEER :	DRG. No KST/ARCH/DE/A-03		
			ARCHITECT CHANAKA ARIYARATNA	APPROVED BY :-			
			DRAWN BY : NISHANTHA	CHECKED BY :-	DATE : 12 - 11 - 2014	SCALE A3 - 1 : 100	SHEET No. 3
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