


REVISED: 2017 -08-17

CONSTRUCTION ISSUE

SCHEDULE OF FINISHES

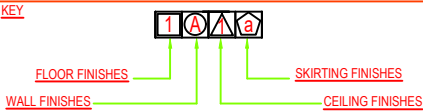

- FLOOR FINISHES**
- 1 50mm THK. FLOOR CEMENT RENDERING IN 1 : 3 CEMENT, SAND FINISHED SMOOTH WITH COLOUR CEMENT FLOAT.
  - 2 300 x 600 HEAVY DUTY POLISHED OR SATIN FINISH HOMOGENEOUS TILES LAID TO A PATTERN.
  - 3 300 x 600 NON - SKID TILES LAID TO GIVEN PATTERN
  - 4 CONCRETE POWER TROWEL FINISHED WITH HEAVY-DUTY EPOXY PAINT. ( GRAY COLOUR ) ( PARKING & RAMPS )
  - 5 INTER - LOCK PAVING STONE FINISHED
  - 6 LOOP PILE CARPET
  - 8 NON TOXIC WATER PROOFING OF REPUTED MANUFACTURER
  - 9 450 x 900 HEAVY DUTY POLISHED OR SATIN FINISH HOMOGENEOUS TILES LAID TO GIVEN PATTERN.
  - 10 400 x 600 HEAVY DUTY POLISHED OR SATIN FINISH HOMOGENEOUS TILES LAID TO GIVEN PATTERN.
  - 11 50mm THK. FLOOR CEMENT RENDERING IN 1 : 3 CEMENT, SAND FINISHED.


- WALL FINISHES**
- A 1 : 5 CEMENT, SAND SMOOTH PLASTER FINISHED AND PAINTED WITH APPROVED COLOUR.
  - B 600 x 300 GLAZED CERAMIC WALL TILES UP TO CEILING LEVEL
  - C 300 x 300 GLAZED CERAMIC WALL TILES UPTO 1200 HEIGHT & 1 : 5 CEMENT, SAND SMOOTH PLASTER FINISHED PAINTED WITH APPROVED COLOUR.
  - D CALCIUM SILICATE BOARD & GLASS PARTITION WALL UP TO SLAB LEVEL
  - E TEMPERED GLASS PARTITION UP TO SLAB LEVEL
  - F EXTERNAL WALLS SEMI ROUGH FINISHED PLASTERED & PAINTED

- CEILING FINISHES**
- ▲ CEILING HEIGHT SHOULD BE 2.7 m. FROM FINISHED FL. LEVEL (150 mm. BELOW FROM BEAM- BOTTOM )
  - 1 SOFIT OF THE SLAB SMOOTH PLASTERED & PAINTED WITH APPROVED COLOUR.
  - 2 FAIR FACE CONCRETE SOFIT WITH PAINT OF APPROVED COLOUR.
  - 3 MINERAL FIBRE PANEL CEILING
  - 4 GYPSUM BOARD CEILING
  - 5 SUPPERFLEX BOARD CEILING
  - 6 ALUMINIUM STRIP CEILING
  - 7 MOISTURE RESISTANT CEILING

- SKIRTING FINISHES**
- a 100mm HIGH CEMENT, SAND SMOOTH FINISHED SKIRTING.
  - b HOMOGENEOUS TILES SKIRTING.
  - c TIMBER SKIRTING.

NOTE :

- 1. ENTIRE AREA TO BE MECHANICALLY AIR CONDITIONED
- 2. CEILING HEIGHT SHOULD BE 2.7 m. FROM FINISHED FL. LEVEL (150 mm. BELOW FROM BEAM- BOTTOM ) REFER DETAIL AT DR. NO: KST/ARCH/DE/A-11

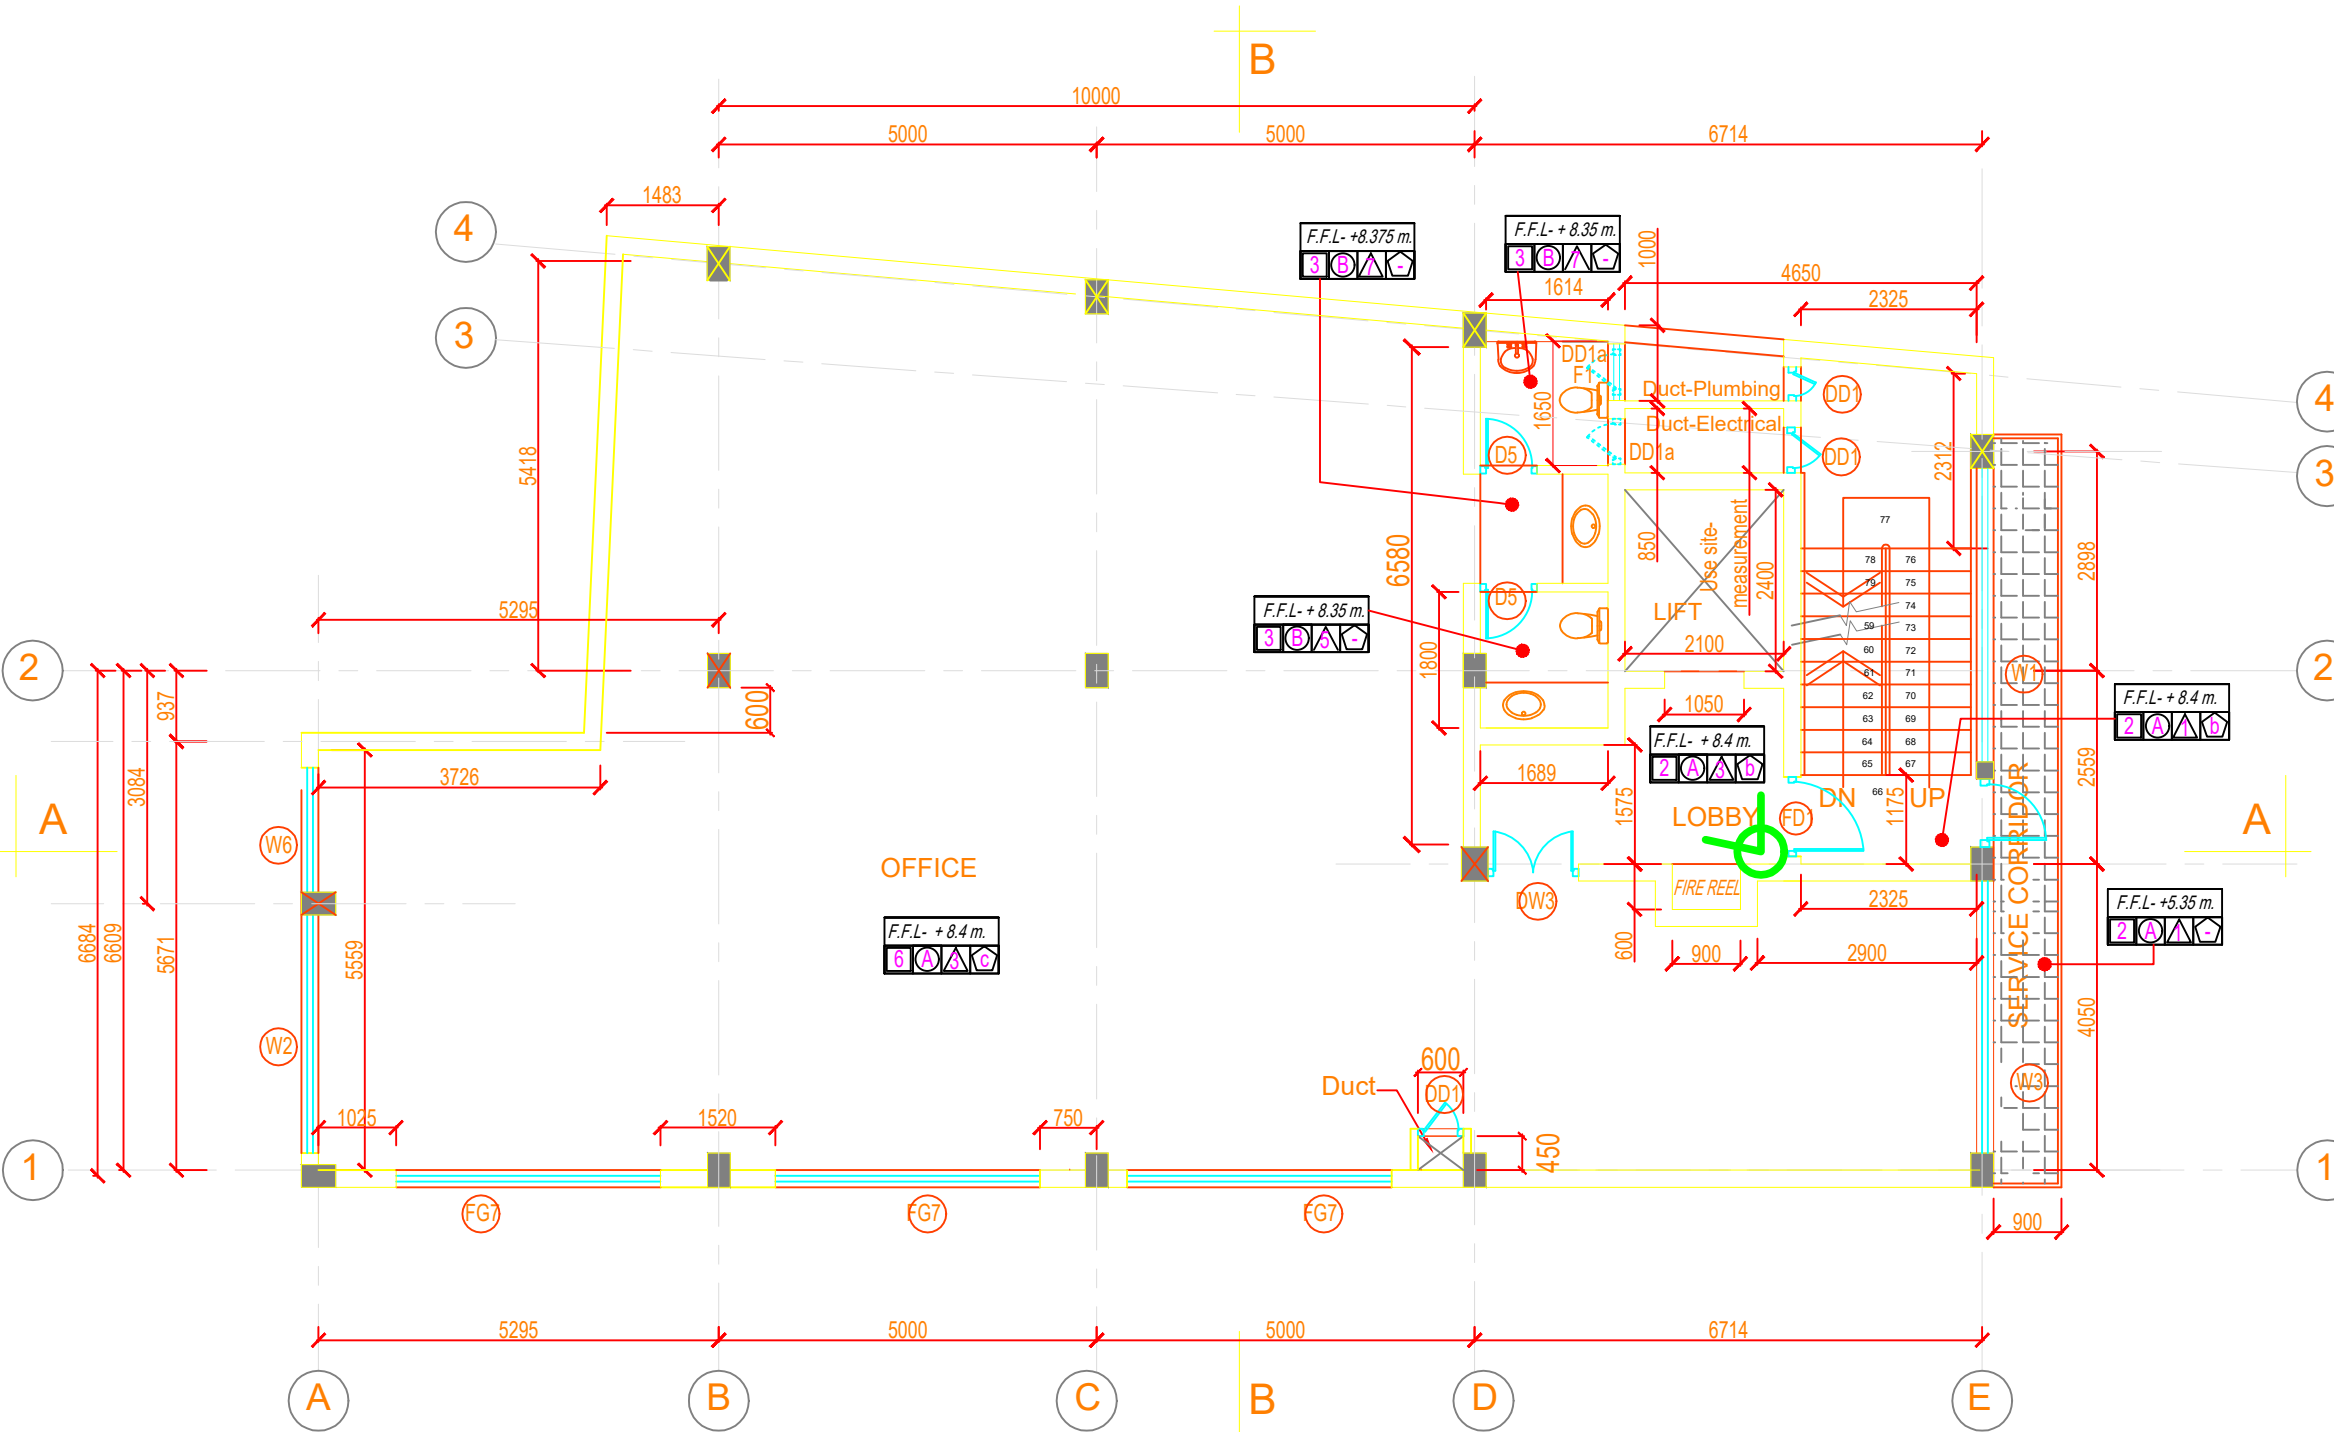


DOME CAMERA  
BULLET CAMERA

TYPICAL 2ND, 3RD FLOOR PLANS

SCALE: 1 : 100

CONSULTANT

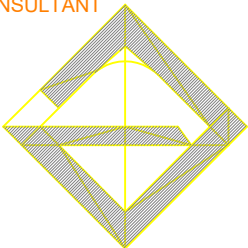

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PROJECT

**PROPOSED BUILDING FOR  
KS TRADING (Pvt) LTD,  
AT No. 494 / 1,  
NAWALA ROAD, RAJAGIRIYA.**

REVISION	DESCRIPTION	DATE	CLIENT : KS TRADING (Pvt) LTD,		DRG. TITLE : TYPICAL 1ST, 2ND, 3RD FLOOR PLANS		
			PROJECT ARCHITECT : SUNIL ARIYARATNA	PROJECT ENGINEER :	DRG. No KST/ARCH/DE/A-04		
			ARCHITECT CHANAKA ARIYARATNA	APPROVED BY :-	DATE : 12 - 11 - 2014		
			DRAWN BY : NISHANTHA	CHECKED BY :-	SCALE A3 -1 : 100		
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					REVISION R12		
					SHEET No. 4		