


LEVEL 2
SUPERVISORY CONTROL

LEVEL 1
PROCESS CONTROL NETWORK

B07A DRUG PRODUCT

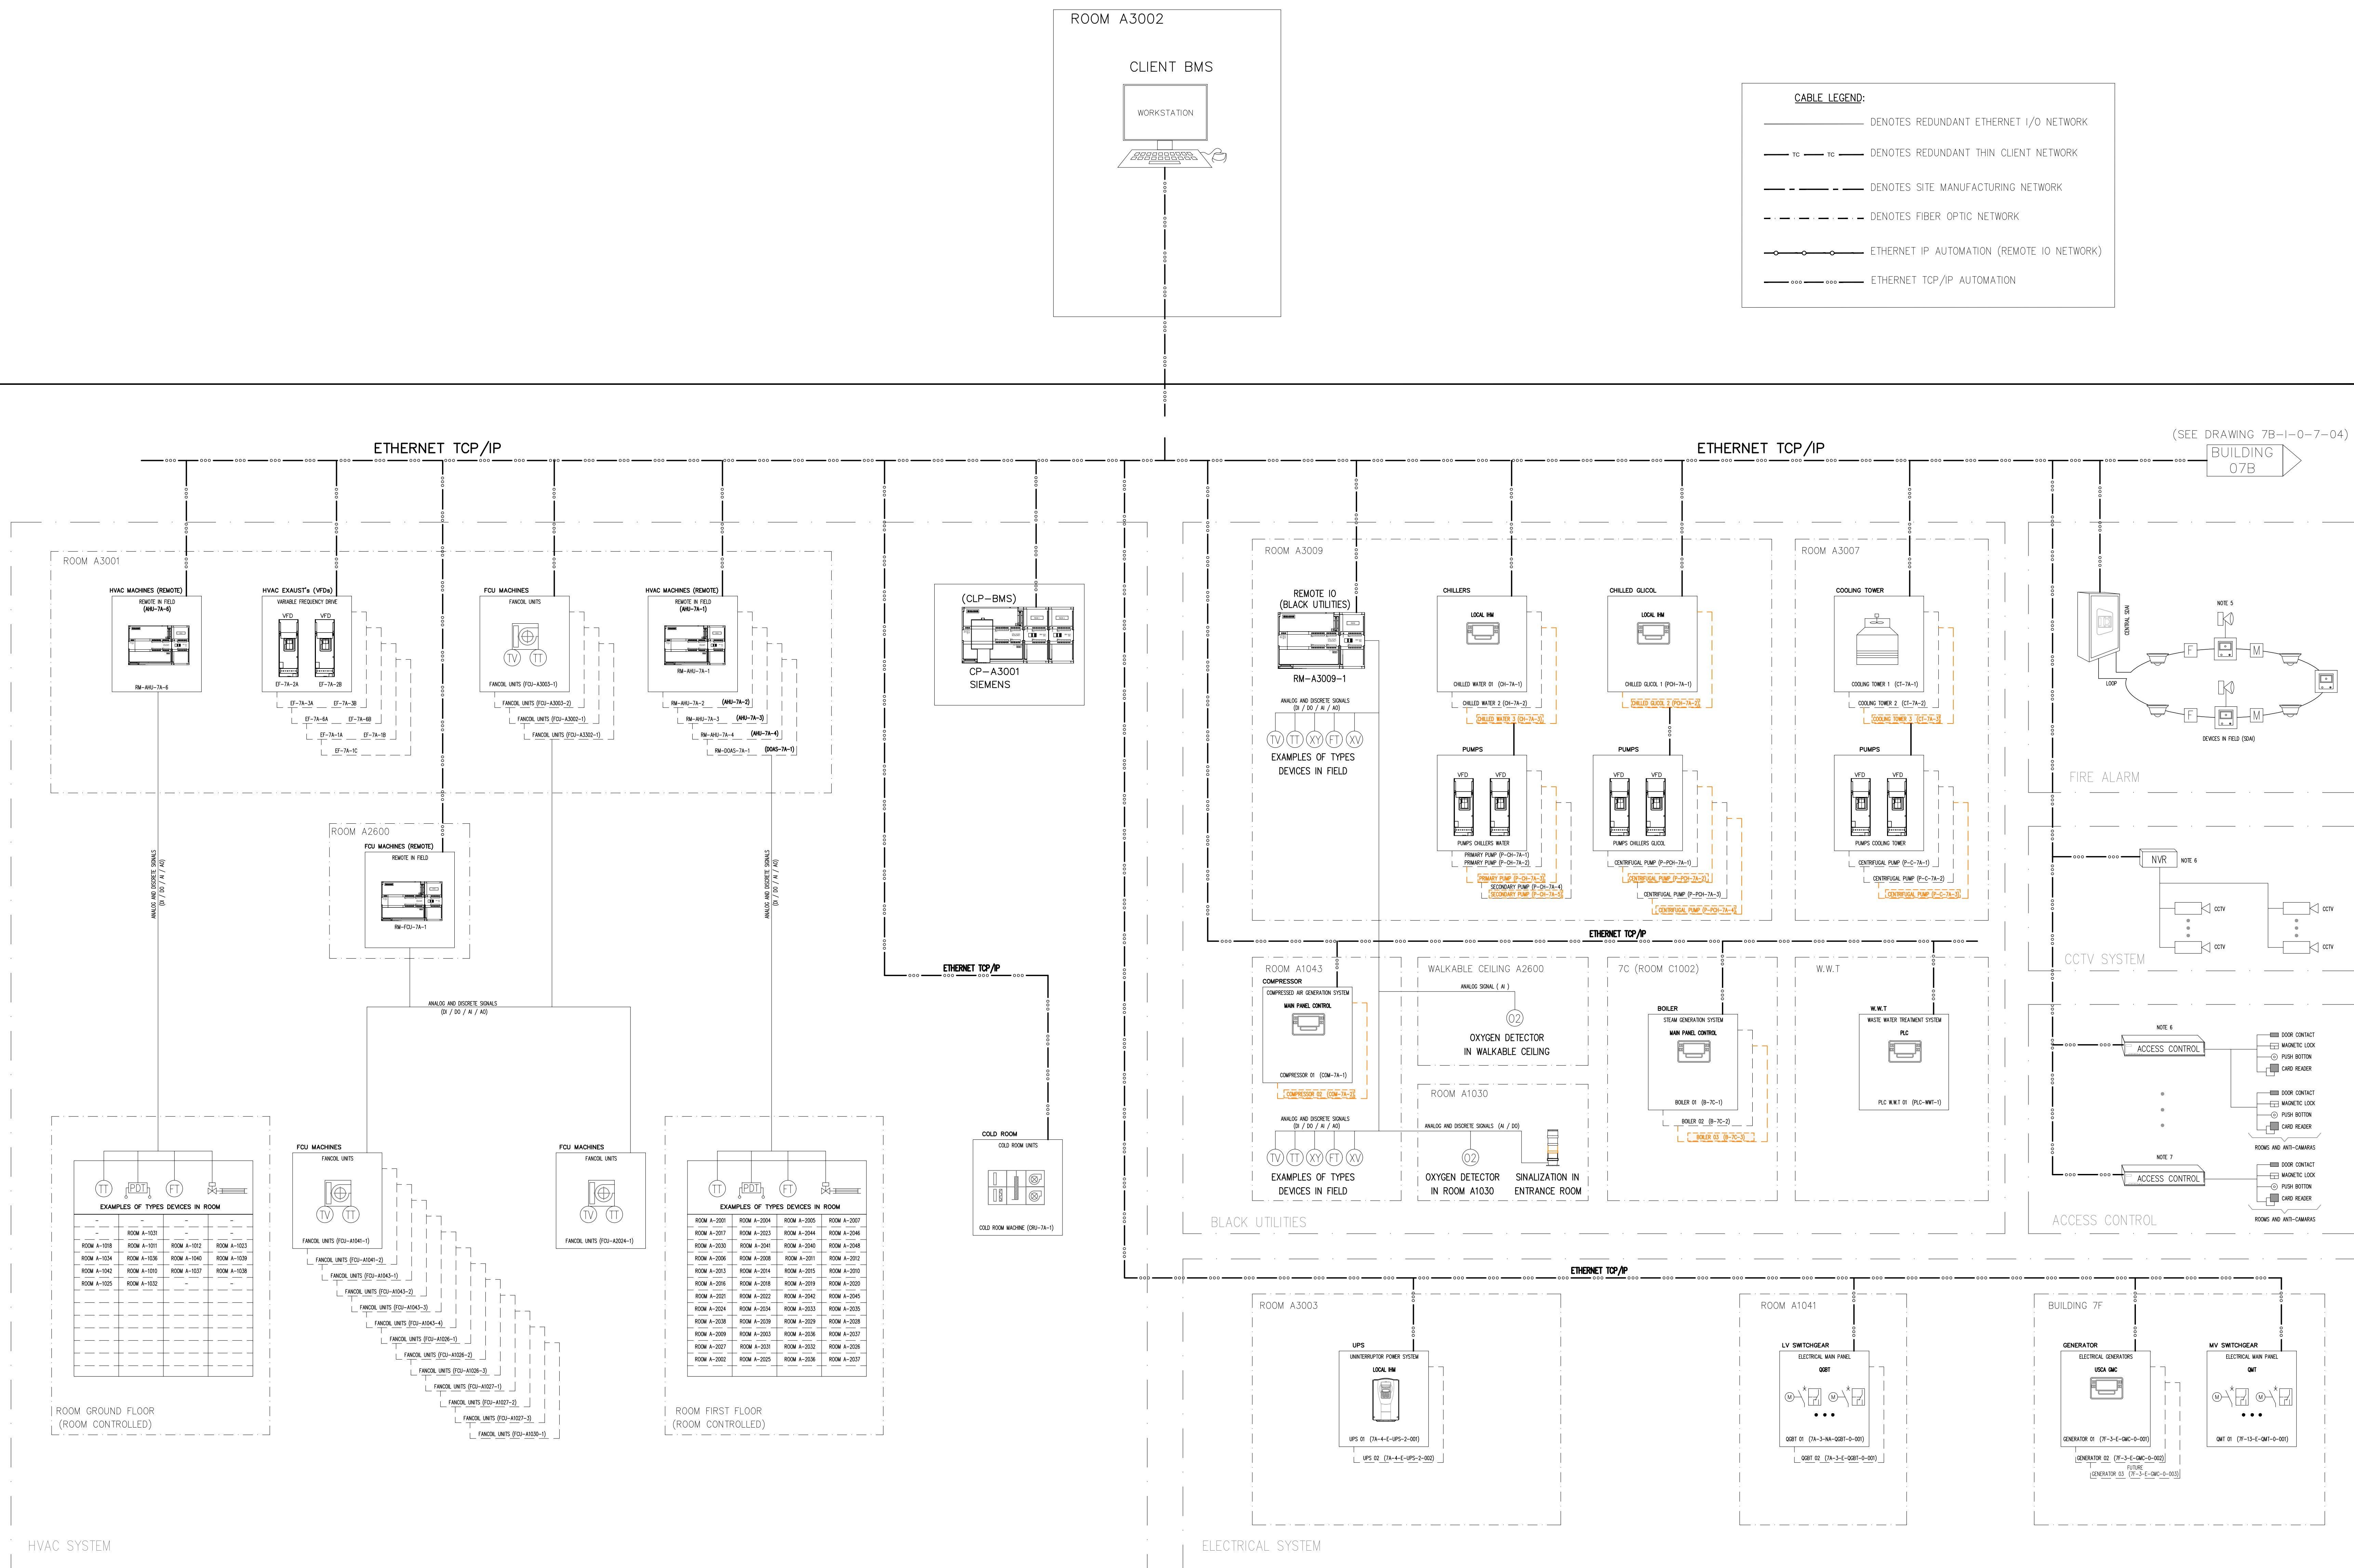

BMS ARCHITECTURE (BUILDING 7A)

REVISION	DATE	DESCRIPTION	BY
A	15JAN2021	ORIGINAL ISSUE - FOR APPROVAL	MAF
B	30JUN2021	90% DD ISSUE	MAF
0	17SEP2021	ISSUE FOR CONSTRUCTION	MAF
1	11NOV2021	ISSUE FOR CONSTRUCTION CONSIDERING COMMENTS	MAF
2	01FEB2022	ISSUE FOR CONSTRUCTION CONSIDERING COMMENTS	MAF
3	07APR2022	ISSUED FOR CONSTRUCTION (UPDATED AS PER NOTES)	ACC
4	01JUN2022	ISSUED FOR CONSTRUCTION (UPDATED AS PER NOTES)	ACC

GENERAL NOTES:

1. REFER TO GENERAL INSTRUMENTATION AND CONTROLS
2. REFER TO P&ID, PROCESS DETAILS, PIPING PLAN DRAWINGS FOR ADDITIONAL INFORMATION.
3. ALL EXPOSED CONDUITS IN LABORATORIES OR CLEAN ROOMS SHALL BE PVC COATED RIGID STEEL.
4. SEE IO LIST NUMBER PRO-AC-US-003, 0 BUILDING 7A
5. THE SDAL SYSTEM (FIRE ALARM) MUST BE CONNECTED IN BMS SYSTEM (SEE FIRE ALARM RISER DIAGRAM NUMBER 7A-I-0-7-02)
6. THE ACS SYSTEM (ACCESS CONTROL) AND CCTV SYSTEM MUST BE CONNECTED IN BMS SYSTEM (SEE TELECOM VOIP & DATA RISER DIAGRAM NUMBER 7A-I-0-7-01)
7. SEE DOCUMENT OF THE BMS SYSTEM COMPONENTS TECHNICAL SPECIFICATION (NUMBER PRO-AC-TSP-014)

REVISION 0 NOTES

- A. INSERT SUB-SYSTEM OF THE SDAL, CCTV AND ACCESS CONTROL IN DRAWING
- B. UPDATE FOR HVAC REMOTE AND VFD IN EXHAUST
- C. INSERT OF THE BUILDING 7F (GENERATORS)
- D. INSERT SUB-ARCHITECTURE IN SHEET 2 AT 7
- E. INSERT COLD ROOM IN DRAWING

REVISION 1 NOTES

- A. UPGRADED SHEET 5/7 - REMOVED AHU 7A - 7

REVISION 2 NOTES




- A. REMOVED GATEWAY MODBUS FROM PANEL QDCOM-7F-01 (SEE SHEET 07/07)

REVISION 3 NOTES

- A. HIGHLIGHTED FUTURE EQUIPMENT.

REVISION 4 NOTES

- A. CANCELED AHU-7A-5 AND YOUR COMPONENTS.
- B. RELOCATED W.W.T. FROM 7A BMS NETWORK TO 7B BMS NETWORK.
- C. UPGRADED ELECTRICAL SYSTEM NETWORK.

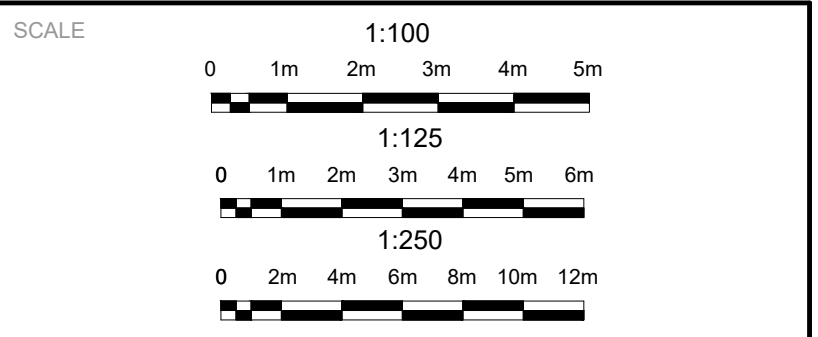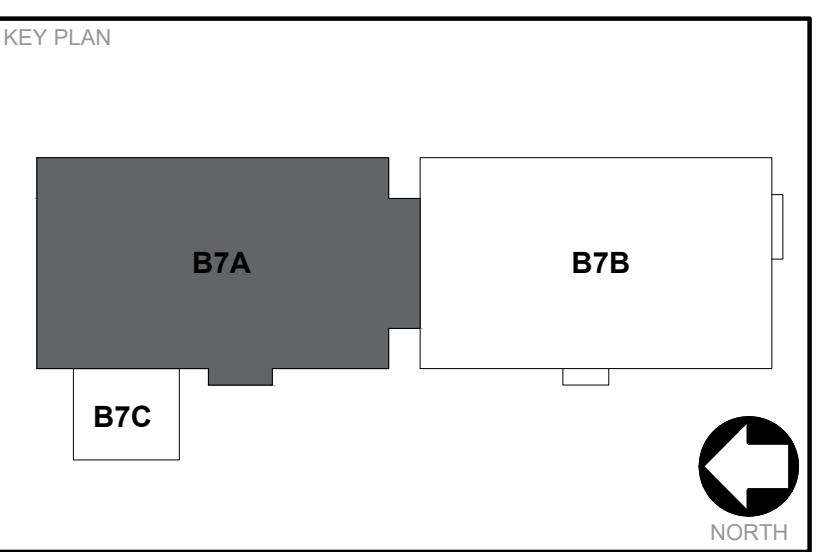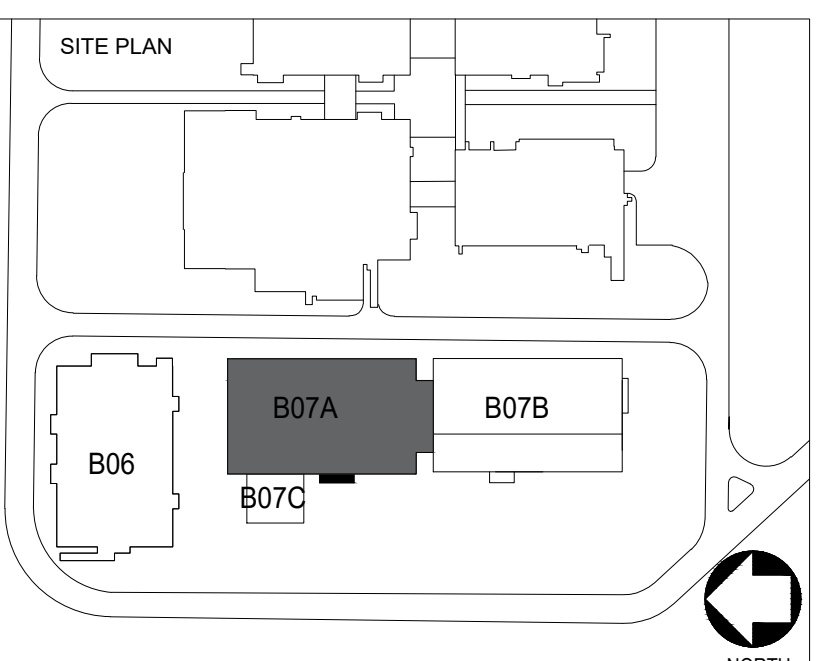





CONFIDENTIAL

THE INFORMATION CONTAINED HEREIN MAY NOT BE USED OR REPRODUCED IN ANY MANNER WITHOUT WRITTEN PERMISSION OF INTEGRATED PROJECT SERVICES.

REVISION	DATE	DESCRIPTION	BY
A	15AUG2021	ORIGINAL ISSUE - FOR APPROVAL	MAF
B	30JUN2021	90% DD ISSUE	MAF
0	17SEP2021	ISSUE FOR CONSTRUCTION	MAF
1	11NOV2021	ISSUE FOR CONSTRUCTION CONSIDERING COMMENTS	MAF
2	01FEB2022	ISSUE FOR CONSTRUCTION CONSIDERING COMMENTS	MAF
3	07APR2022	ISSUED FOR CONSTRUCTION UPDATED AS PER NOTES	ACC
4	01JUN2022	ISSUED FOR CONSTRUCTION UPDATED AS PER NOTES	ACC

GENERAL NOTES:

1. SEE DOCUMENT OF THE HVAC SYSTEM (P&ID) THE 7A BUILDING
2. SMOKE DETECTOR SUPPLY VENDOR PACKAGE (FIRE ALARM) .

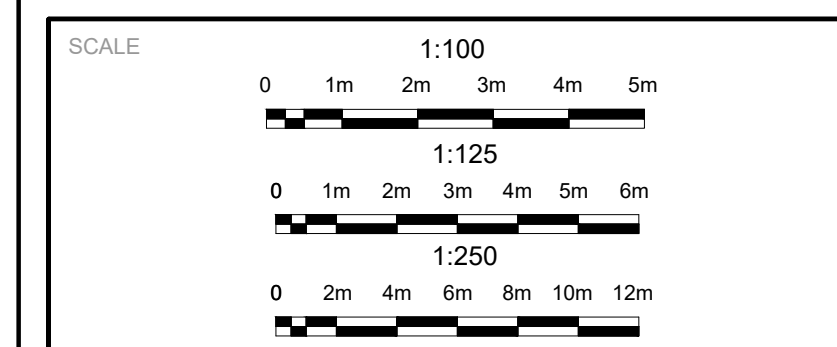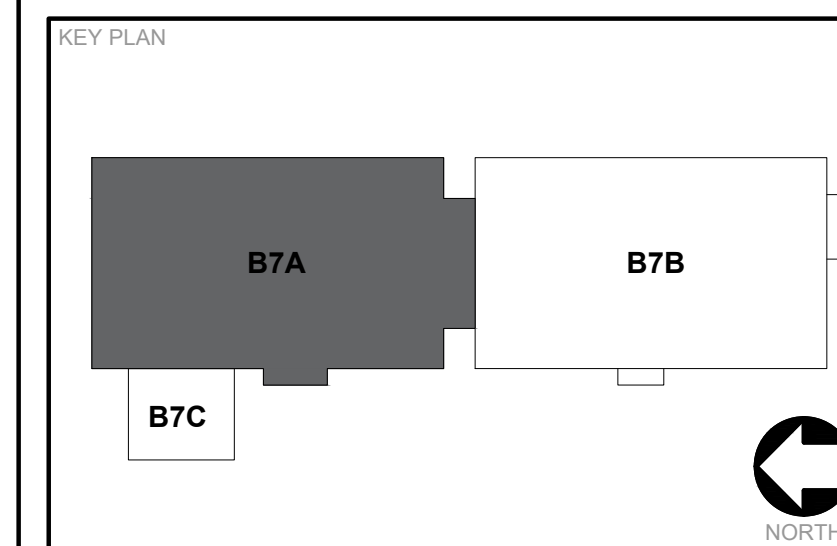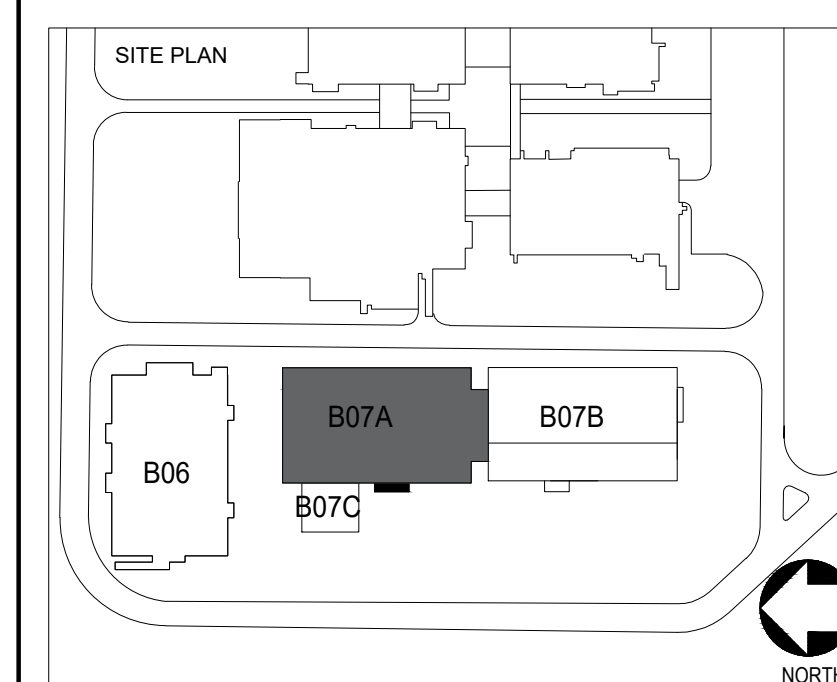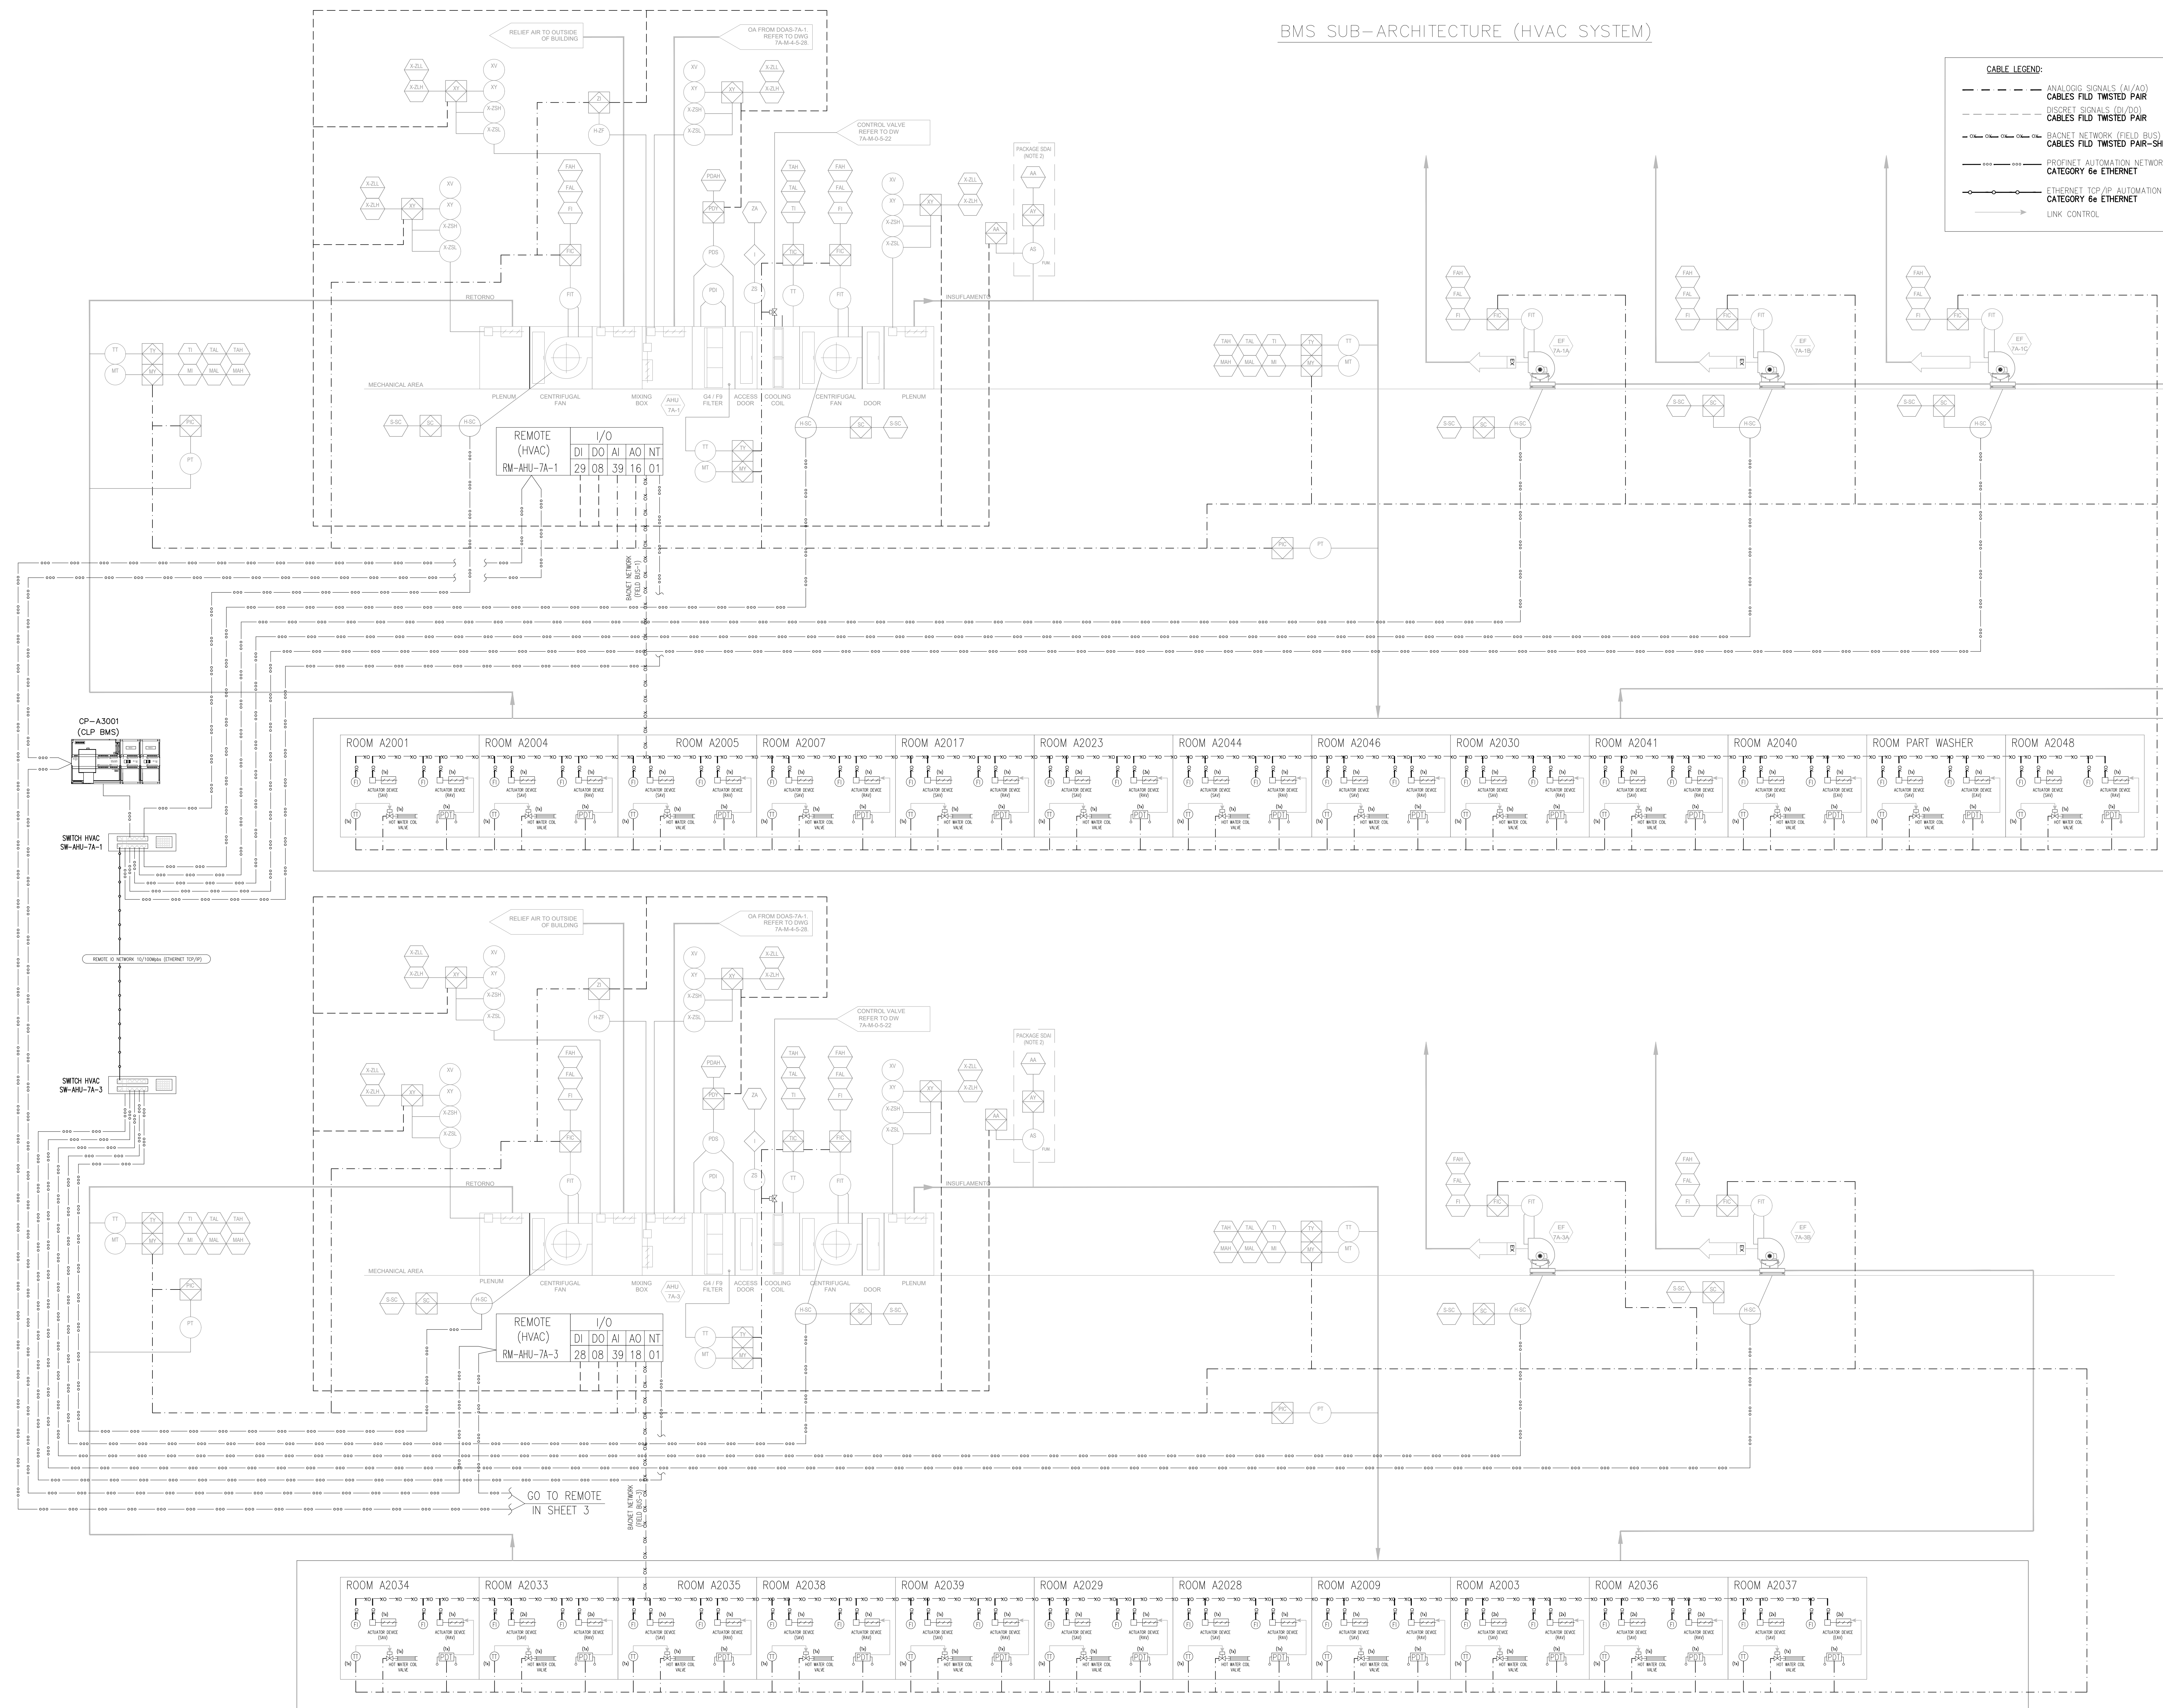

CONFIDENTIAL

THE INFORMATION CONTAINED HEREIN MAY NOT BE USED OR REPRODUCED IN ANY MANNER WITHOUT WRITTEN PERMISSION OF INTEGRATED PROJECT SERVICES.

CLIENT



DRUG PRODUCT BMS
NETWORK ARCHITECTURE
HVAC SYSTEM (SHEET 02/07)


ENGINEER	ARCHITECT	DESIGNER	IPS PROJECT #
MAF	BJE	FJT	ITD19439.01
DRAWN BY	REVIEWED BY	SCALE	CADD FILE NAME
AAS	MAJ	AS NOTED	

XREF

	DRAWING NUMBER
--	----------------

7A-1-0-7-04

BMS SUB-ARCHITECTURE (HVAC SYSTEM)

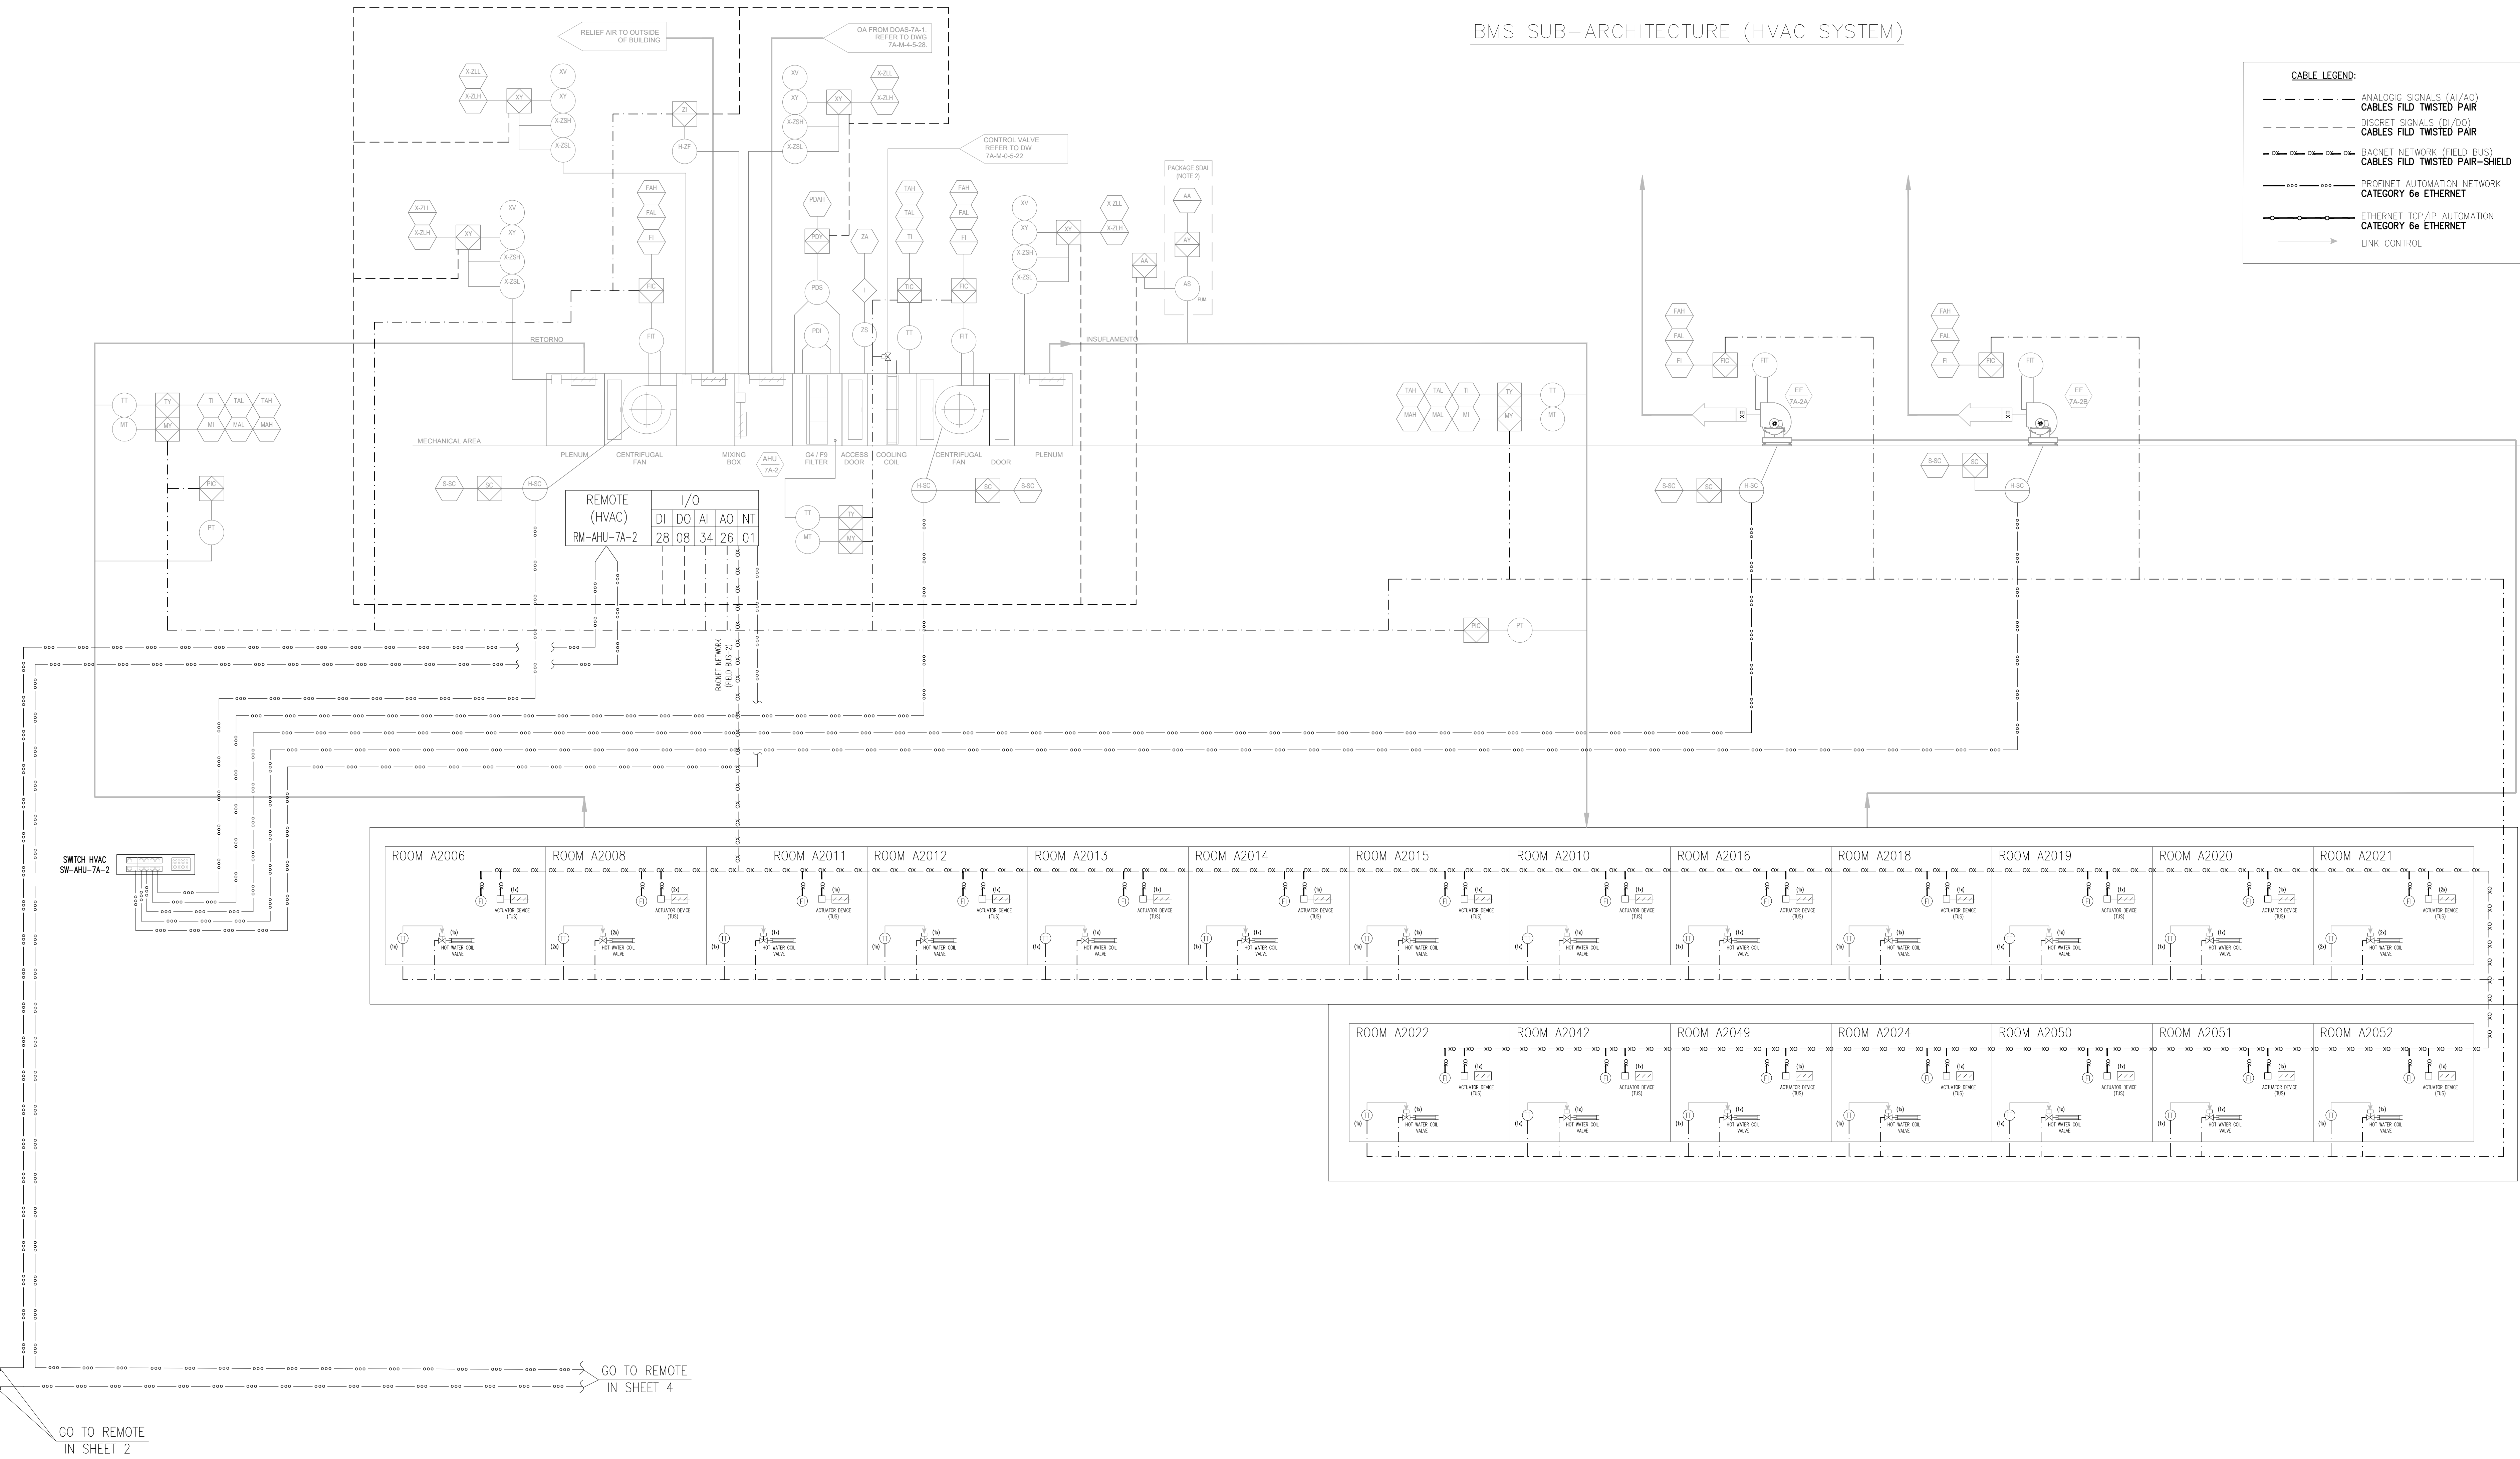




Integrated Project Services

Engineering
Design/Build
Compliance
Consulting

721 ARBOR WAY, SUITE 100
BLUE BELL
PENNSYLVANIA 19422
PHONE: 610.828.4090
FAX: 610.828.3656
www.ipsdb.com

IPS Professional Engineers and Architects, PC.




REVISION	DATE	DESCRIPTION	BY
A	15JAN2021	ORIGINAL ISSUE - FOR APPROVAL	MAF
B	30JAN2021	90% DD ISSUE	MAF
0	17SEP2021	ISSUE FOR CONSTRUCTION	MAF
1	11NOV2021	ISSUE FOR CONSTRUCTION CONSIDERING COMMENTS	MAF
2	01FEB2022	ISSUE FOR CONSTRUCTION CONSIDERING COMMENTS	MAF
3	07APR2022	ISSUED FOR CONSTRUCTION UPDATED AS PER NOTES	ACC
4	01JUN2022	ISSUED FOR CONSTRUCTION UPDATED AS PER NOTES	ACC



R. Dr. Cesarão Mota Júnior, 424 - Vila Buarque, São Paulo - SP, 01221-020

GENERAL NOTES:

- SEE DOCUMENT OF THE HVAC SYSTEM (P&ID) THE 7A BUILDING.
- SMOKE DETECTOR SUPPLY VENDOR PACKAGE (FIRE ALARM).

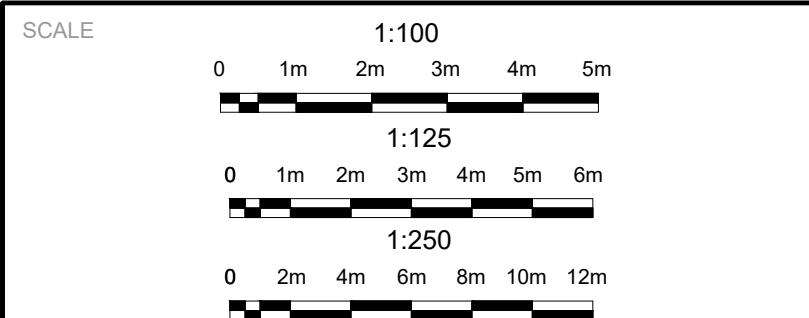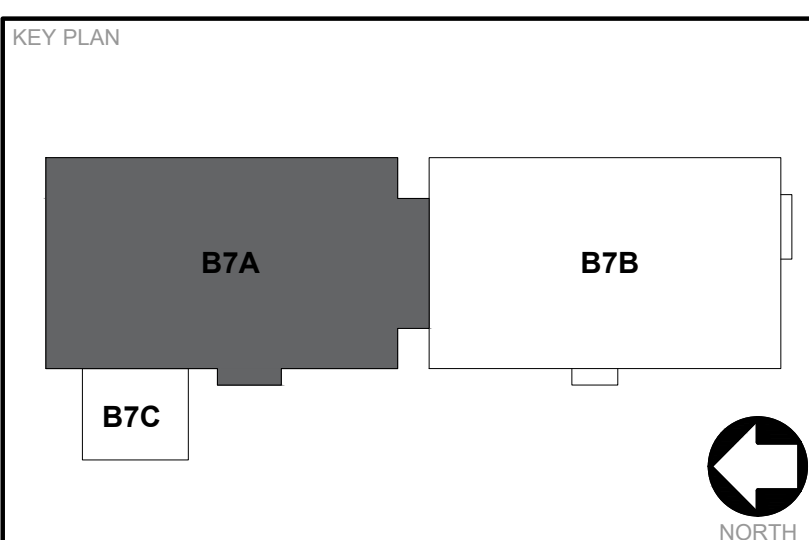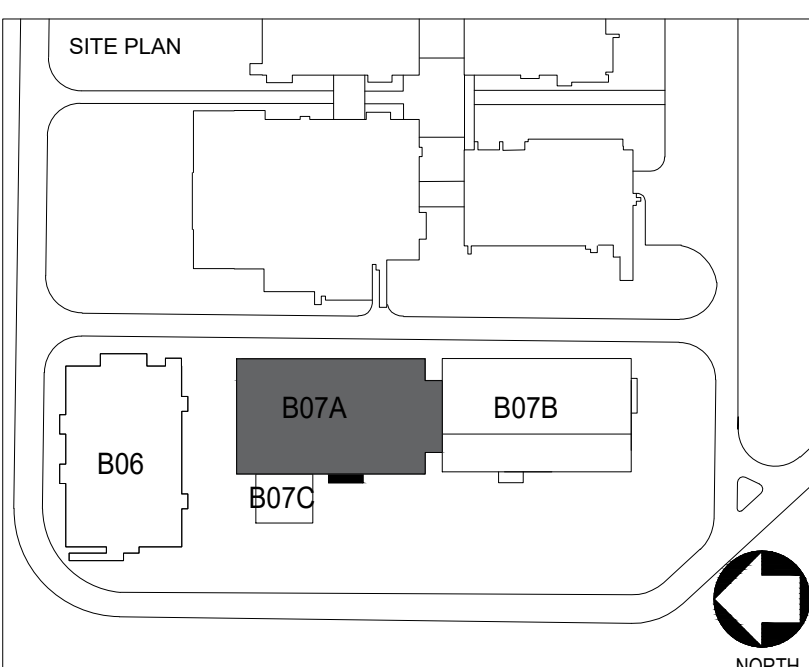

CONFIDENTIAL

THE INFORMATION CONTAINED HEREIN MAY NOT BE USED OR REPRODUCED IN ANY MANNER WITHOUT WRITTEN PERMISSION OF INTEGRATED PROJECT SERVICES.

CLIENT



BURITI EPCMV PROJECT

DRAWING TITLE:


DRUG PRODUCT BMS
NETWORK ARCHITECTURE
HVAC SYSTEM (SHEET 03/07)


ENGINEER	ARCHITECT	DESIGNER	IPS PROJECT #
MAF	BJE	FJT	ITD19439.01
DRAWN BY	REVIEWED BY	SCALE	GRID FILE NAME
AAS	MAJ	AS NOTED	

WEP FILE(S)	DRAWING NUMBER
	7A-I-0-7-04

BMS SUB-ARCHITECTURE (HVAC SYSTEM)

CABLE LEGEND:	
---	ANALOGIC SIGNALS (A/AO)
---	CABLES FLD TWISTED PAIR
---	DISCREET SIGNALS (D/DO)
---	CABLES FLD TWISTED PAIR
---	BACKET NETWORK (FIELD BUS)
---	CABLES FLD TWISTED PAIR-SHIELD
---	PROFIBET AUTOMATION NETWORK
---	CATEGORY 6e ETHERNET
---	ETHERNET TOP/IR AUTOMATION
---	CATEGORY 6e ETHERNET
---	LINK CONTROL

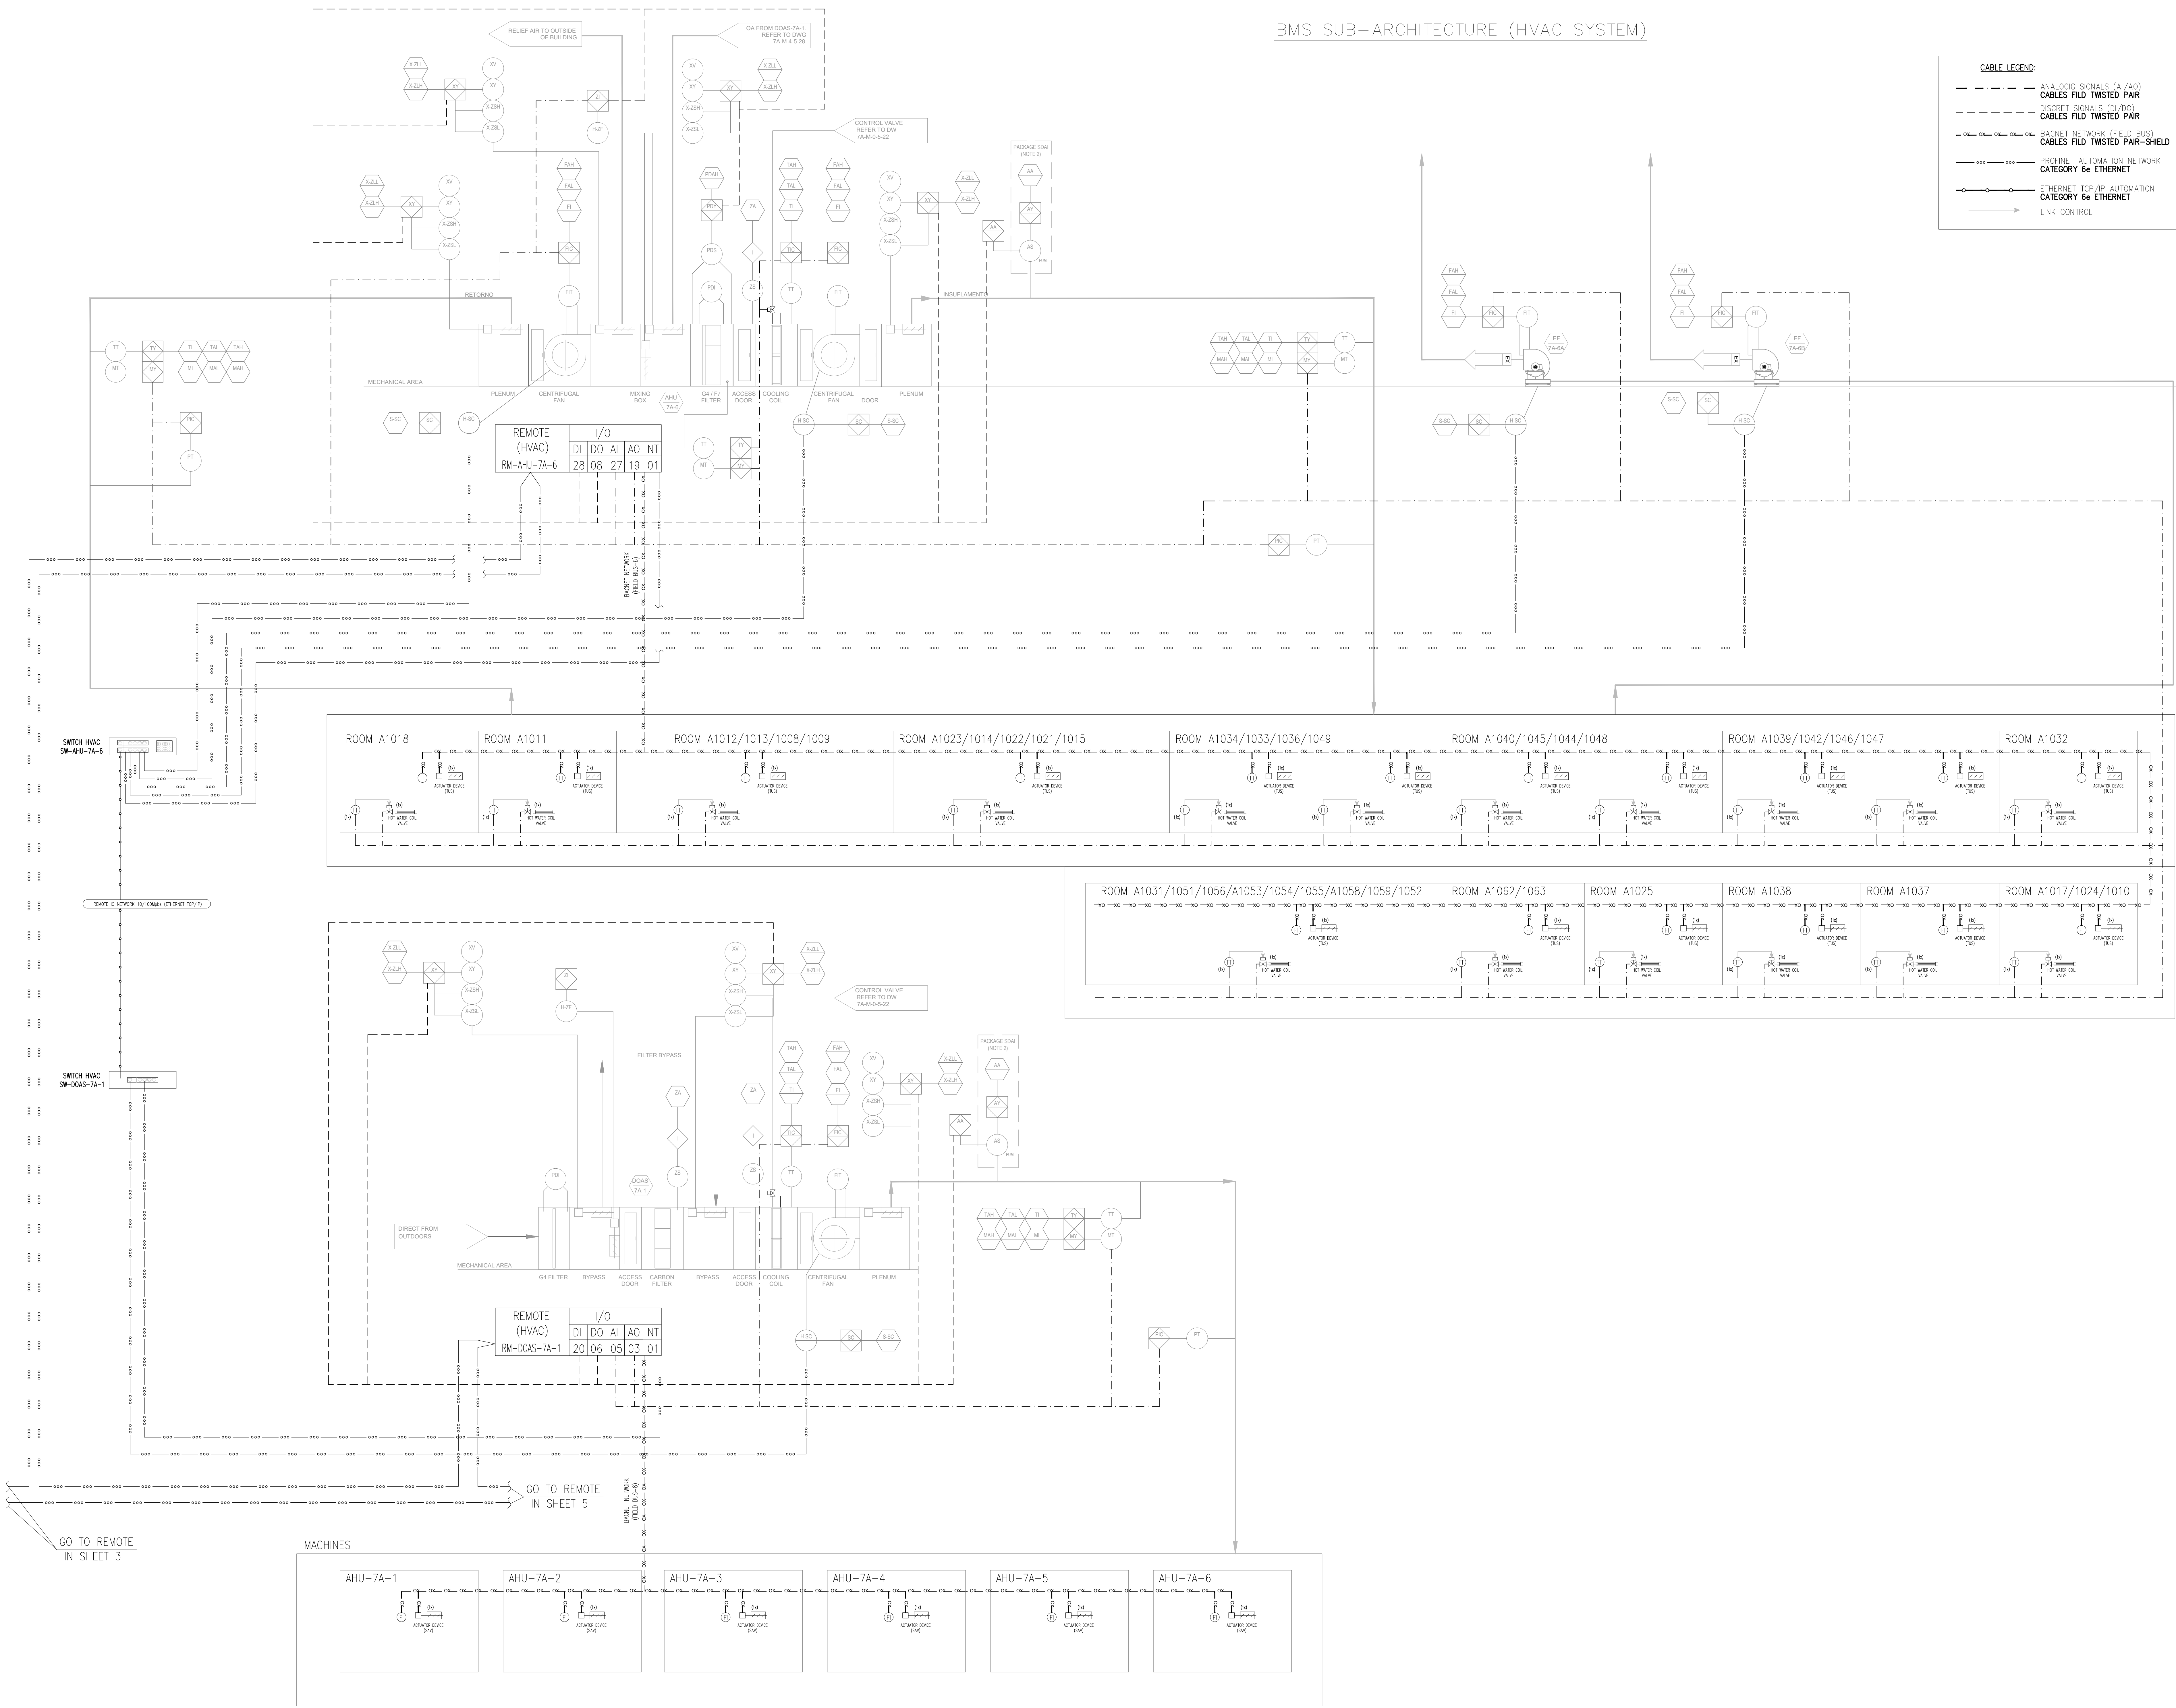



Integrated Project Services
Engineering
Design/Build
Compliance
Consulting

721 ARBOR WAY, SUITE 100
BLUE BELL,
PENNSYLVANIA 19422
PHONE: 610.828.4090
FAX: 610.828.3656
www.ipsdb.com

IPS Professional Engineers and Architects, PC.




REVISION	DATE	DESCRIPTION	BY
A	15JAN2021	ORIGINAL ISSUE - FOR APPROVAL	MAF
B	30JUN2021	90% DD ISSUE	MAF
0	17SEP2021	ISSUE FOR CONSTRUCTION	MAF
1	11NOV2021	ISSUE FOR CONSTRUCTION	MAF
2	01FEB2022	ISSUE FOR CONSTRUCTION	MAF
3	07APR2022	ISSUE FOR CONSTRUCTION	ACC
4	01JUN2022	ISSUE FOR CONSTRUCTION	ACC



R. Dr. Cesarino Mota Junior, 424 - Vila Buarque, São Paulo - SP, 01221-020

GENERAL NOTES:

- SEE DOCUMENT OF THE HVAC SYSTEM (P&ID) THE 7A BUILDING.
- SMOKE DETECTOR SUPPLY VENDOR PACKAGE (FIRE ALARM).

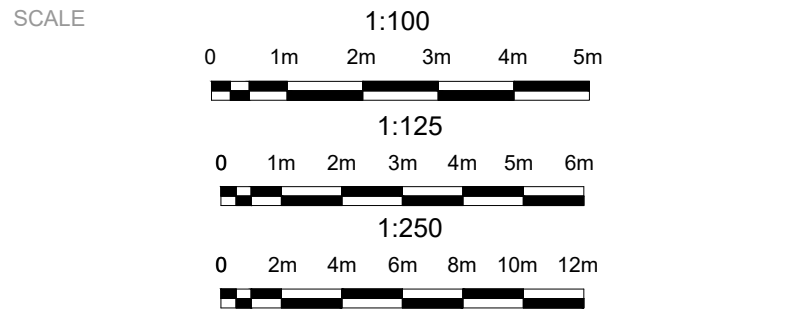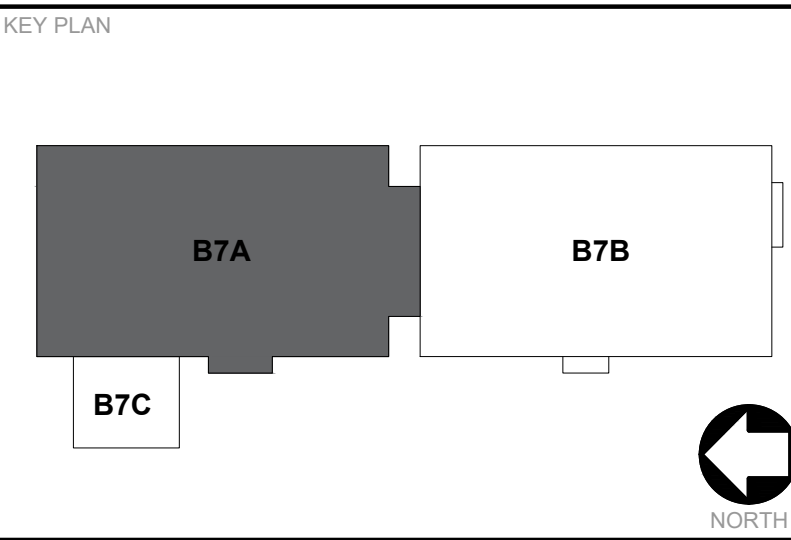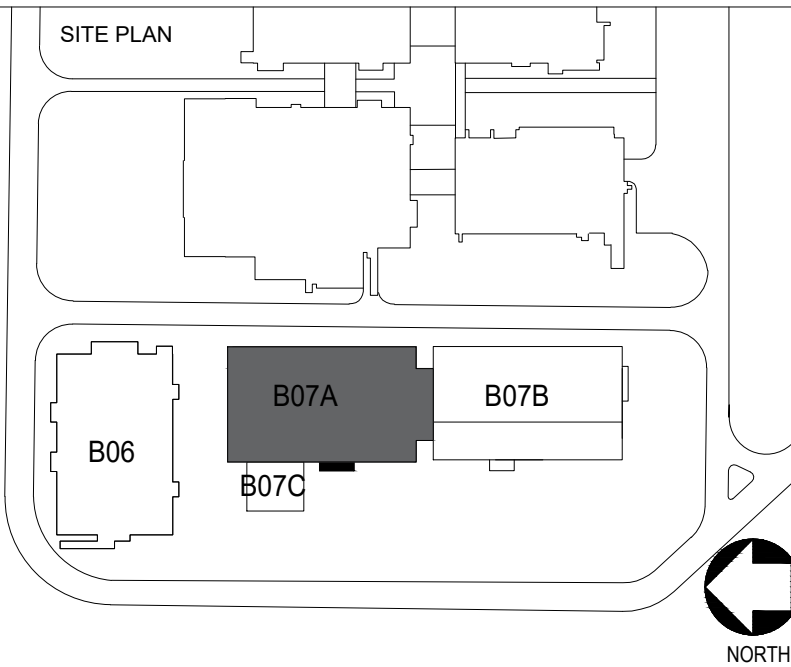

CONFIDENTIAL

CLIENT:




BURIT EPCMV PROJECT

DRAWING TITLE:

ENGINEER	ARCHITECT	DESIGNER	IPS PROJECT #
MAF	BJE	FJT	ITD19439.01
DRAWN BY	REVIEWED BY	SCALE	CADD FILE NAME
AAS	MAJ	AS NOTED	

DRP FILE(S)	DRAWING NUMBER
	7A-I-0-7-04

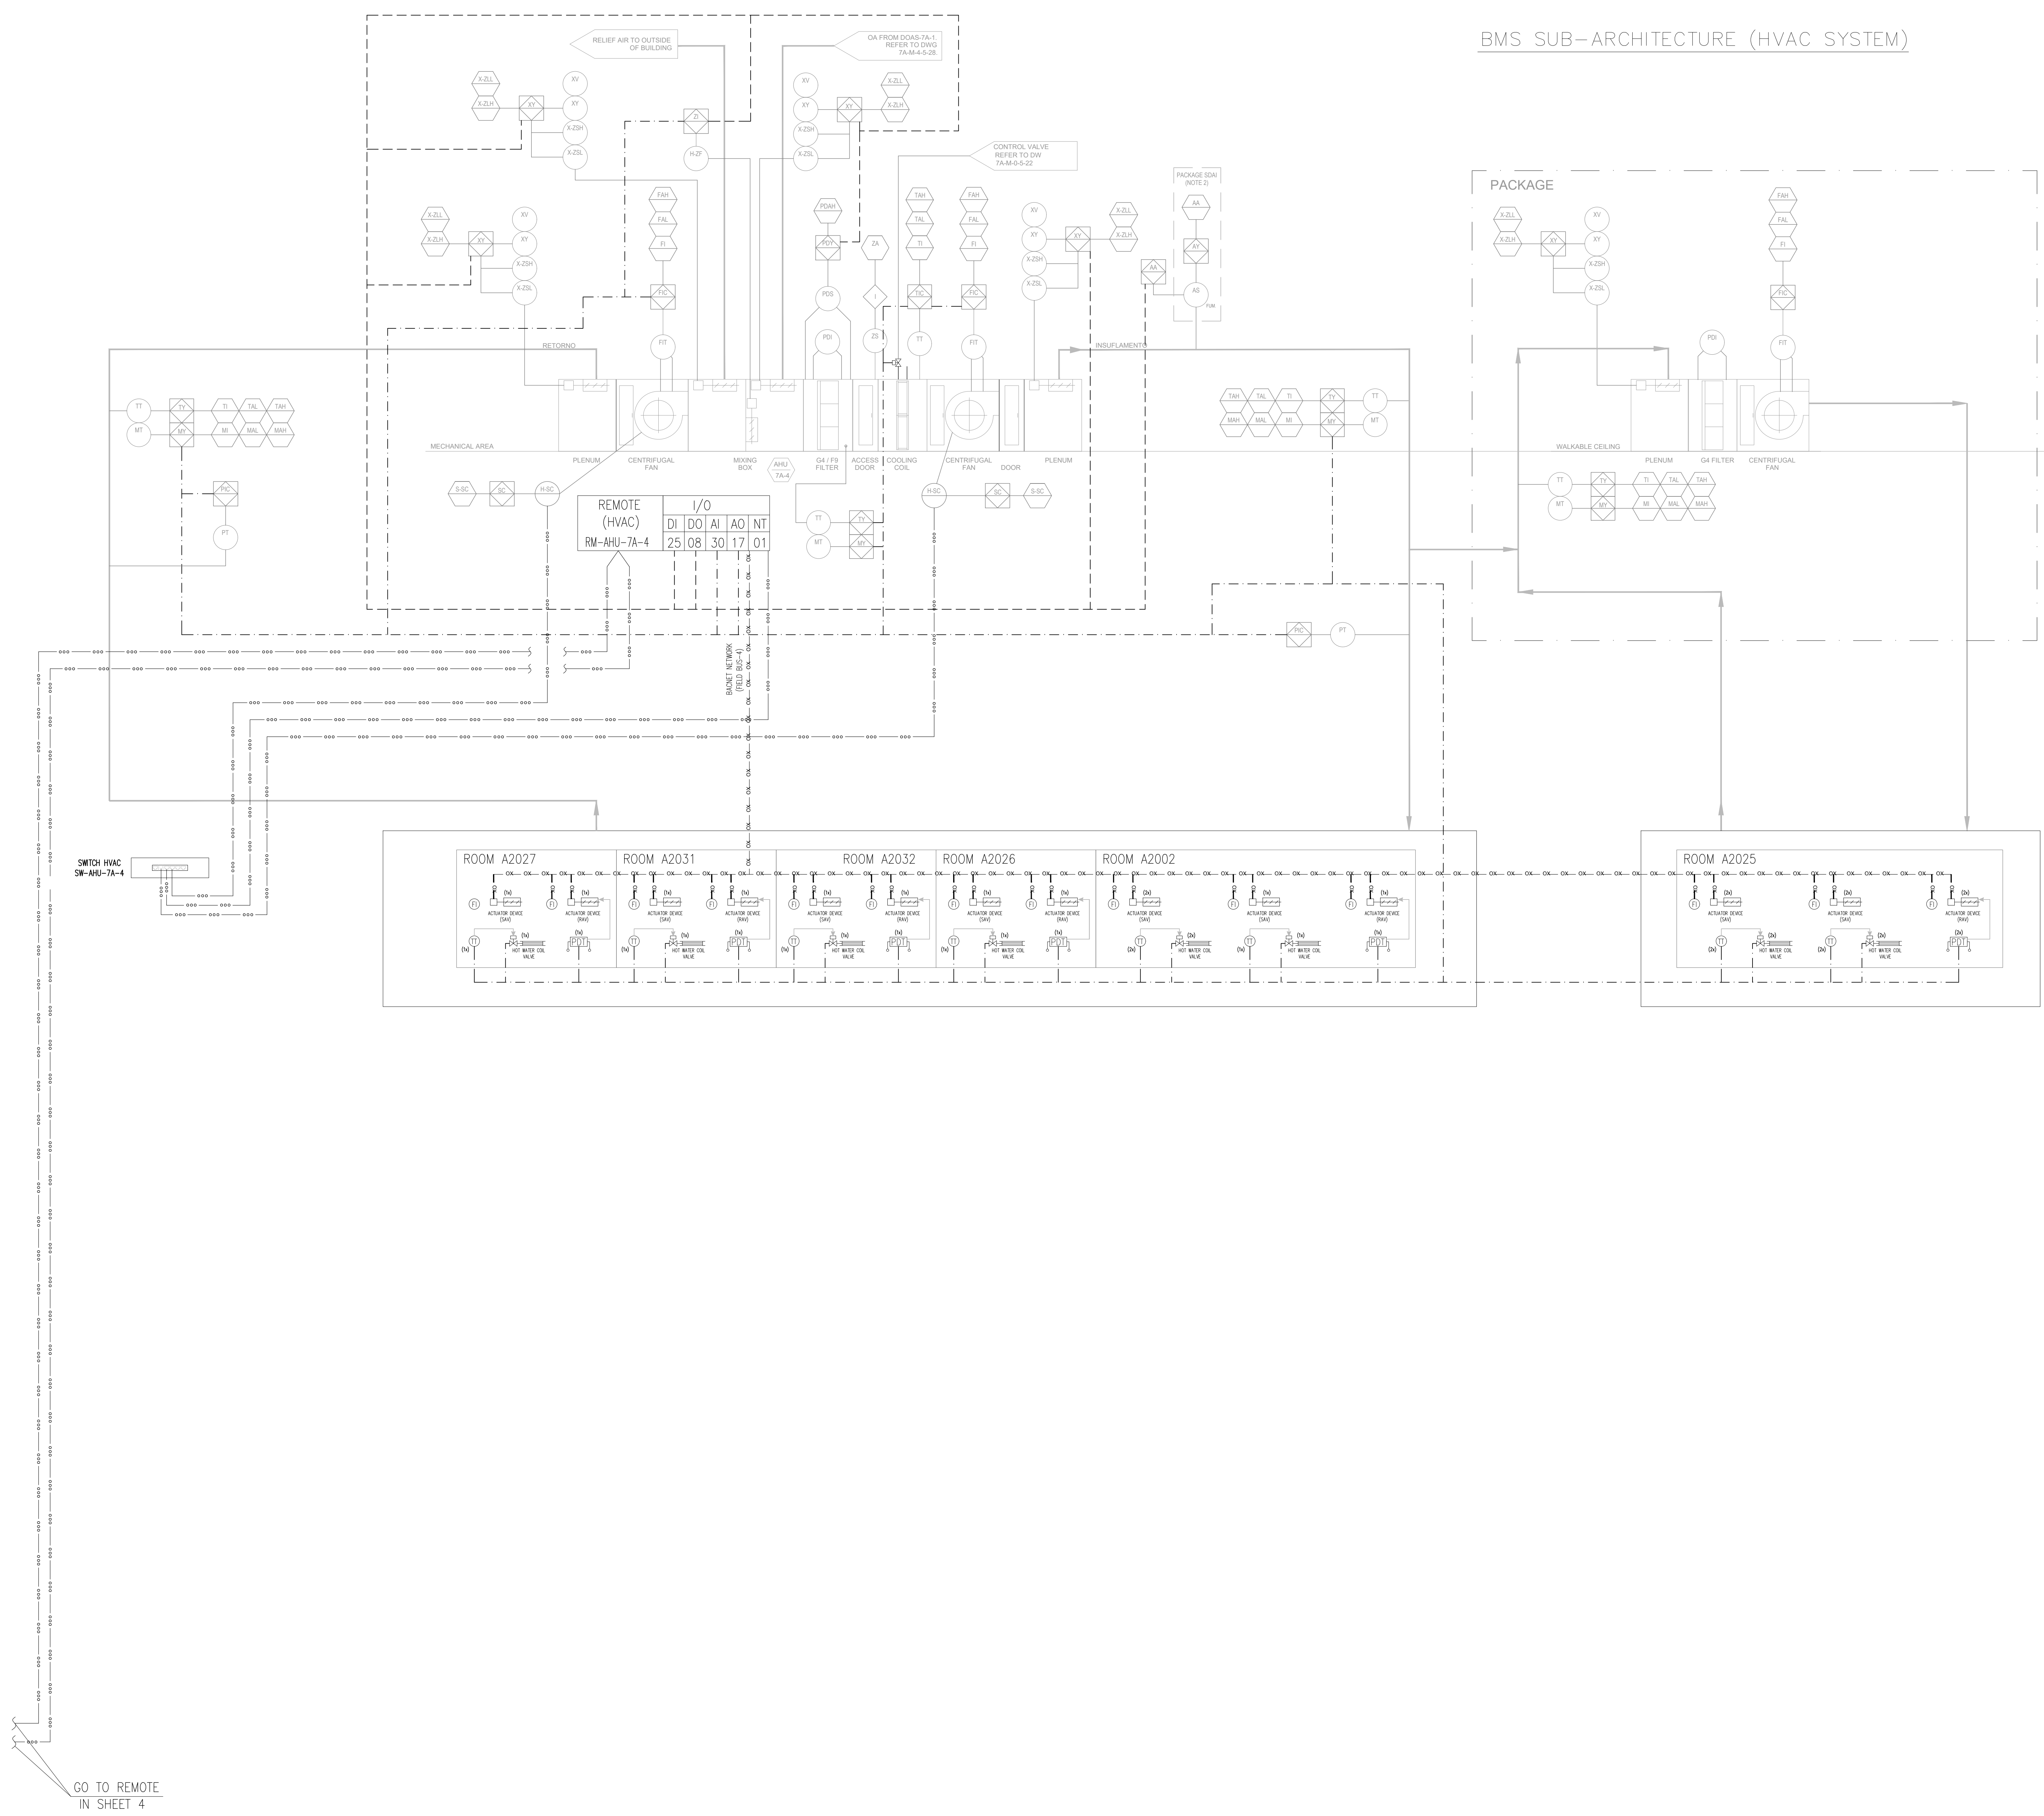

BMS SUB-ARCHITECTURE (HVAC SYSTEM)

CABLE LEGEND:

---	ANALOG SIGNALS (AI/AO)
---	CABLES FLD TWISTED PAIR
---	DISCREET SIGNALS (DI/DO)
---	CABLES FLD TWISTED PAIR-SHIELD
---	DISCREET AUTOMATION NETWORK
---	ETHERNET TSP/IP AUTOMATION CATEGORY 6e ETHERNET
---	LINK CONTROL

ips
Integrated Project Services
Engineering
Design/Build
Compliance
Consulting

721 ARBOR WAY, SUITE 100
BLUE BELL
PENNSYLVANIA 19422
PHONE: 610.828.4090
FAX: 610.828.3656
www.ipsdb.com

IPS Professional Engineers and Architects, PC.




REVISION	DATE	DESCRIPTION	BY
A	10JUN2021	ORIGINAL ISSUE - FOR APPROVAL	MAF
B	30JUN2021	90% DD ISSUE	MAF
0	17SEP2021	ISSUE FOR CONSTRUCTION	MAF
1	11NOV2021	ISSUE FOR CONSTRUCTION	MAF
2	01FEB2022	ISSUE FOR CONSTRUCTION	MAF
3	07APR2022	ISSUED FOR CONSTRUCTION	ACC
4	01JUN2022	ISSUED FOR CONSTRUCTION	ACC

TESSLER
engenharia

R. Dr. Cesarão Mota Júnior, 424 - Vila Buarque, São Paulo - SP, 01221-020

GENERAL NOTES:

- SEE DOCUMENT OF THE HVAC SYSTEM (P&ID) THE 7A BUILDING.
- SMOKE DETECTOR SUPPLY VENDOR PACKAGE (FIRE ALARM).

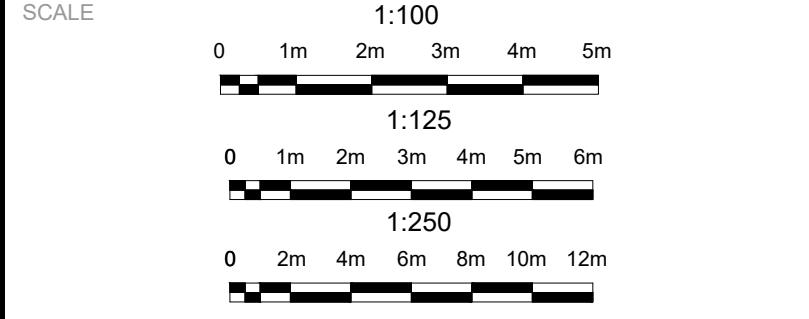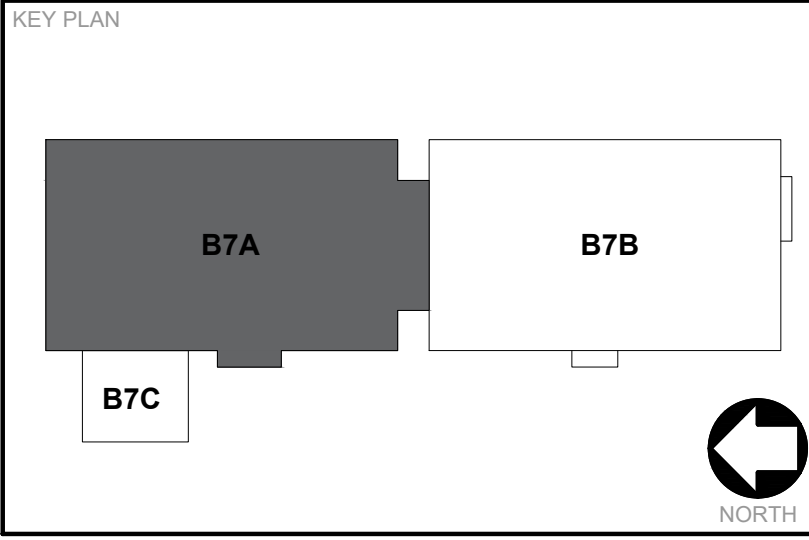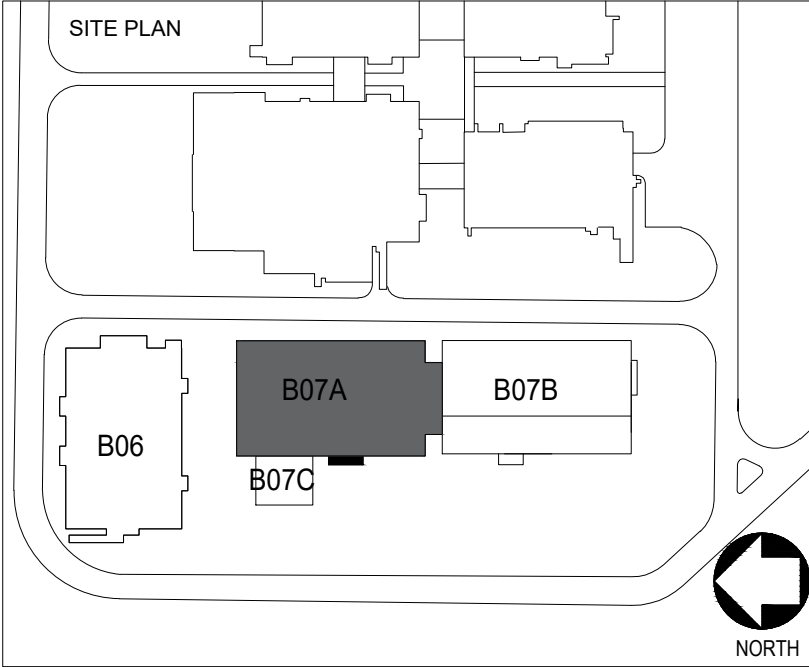

CONFIDENTIAL

THE INFORMATION CONTAINED HEREIN MAY NOT BE USED OR REPRODUCED IN ANY MANNER WITHOUT WRITTEN PERMISSION OF INTEGRATED PROJECT SERVICES.

CLIENT:

Takeda

Hemobrás
Empresa Brasileira de Hemoderivação e Biotecnologia

BURITI EPCMV PROJECT

DRAWING TITLE:

**DRUG PRODUCT BMS
NETWORK ARCHITECTURE
HVAC SYSTEM (SHEET 05/07)**


ENGINEER MAF	ARCHITECT BJE	DESIGNER FJT	IPS PROJECT # ITD19439.01
DRAWN BY AAS	REVIEWED BY MAJ	SCALE AS NOTED	CADD FILE NAME

WREP FILE(S)	DRAWING NUMBER
	7A-I-0-7-04

BMS SUB-ARCHITECTURE (HVAC SYSTEM)

CABLE LEGEND:

- ANALOG SIGNALS (4x/AD)
- CABLES FLD TWISTED PAIR
- DISCRET SIGNALS (DI/DO)
- CABLES FLD TWISTED PAIR
- BACNET NETWORK (FIELD BUS)
- CABLES FLD TWISTED PAIR-SHIELD
- PROFINET AUTOMATION NETWORK CATEGORY 6e ETHERNET
- ETHERNET TCP/IP AUTOMATION CATEGORY 6e ETHERNET
- LINK CONTROL

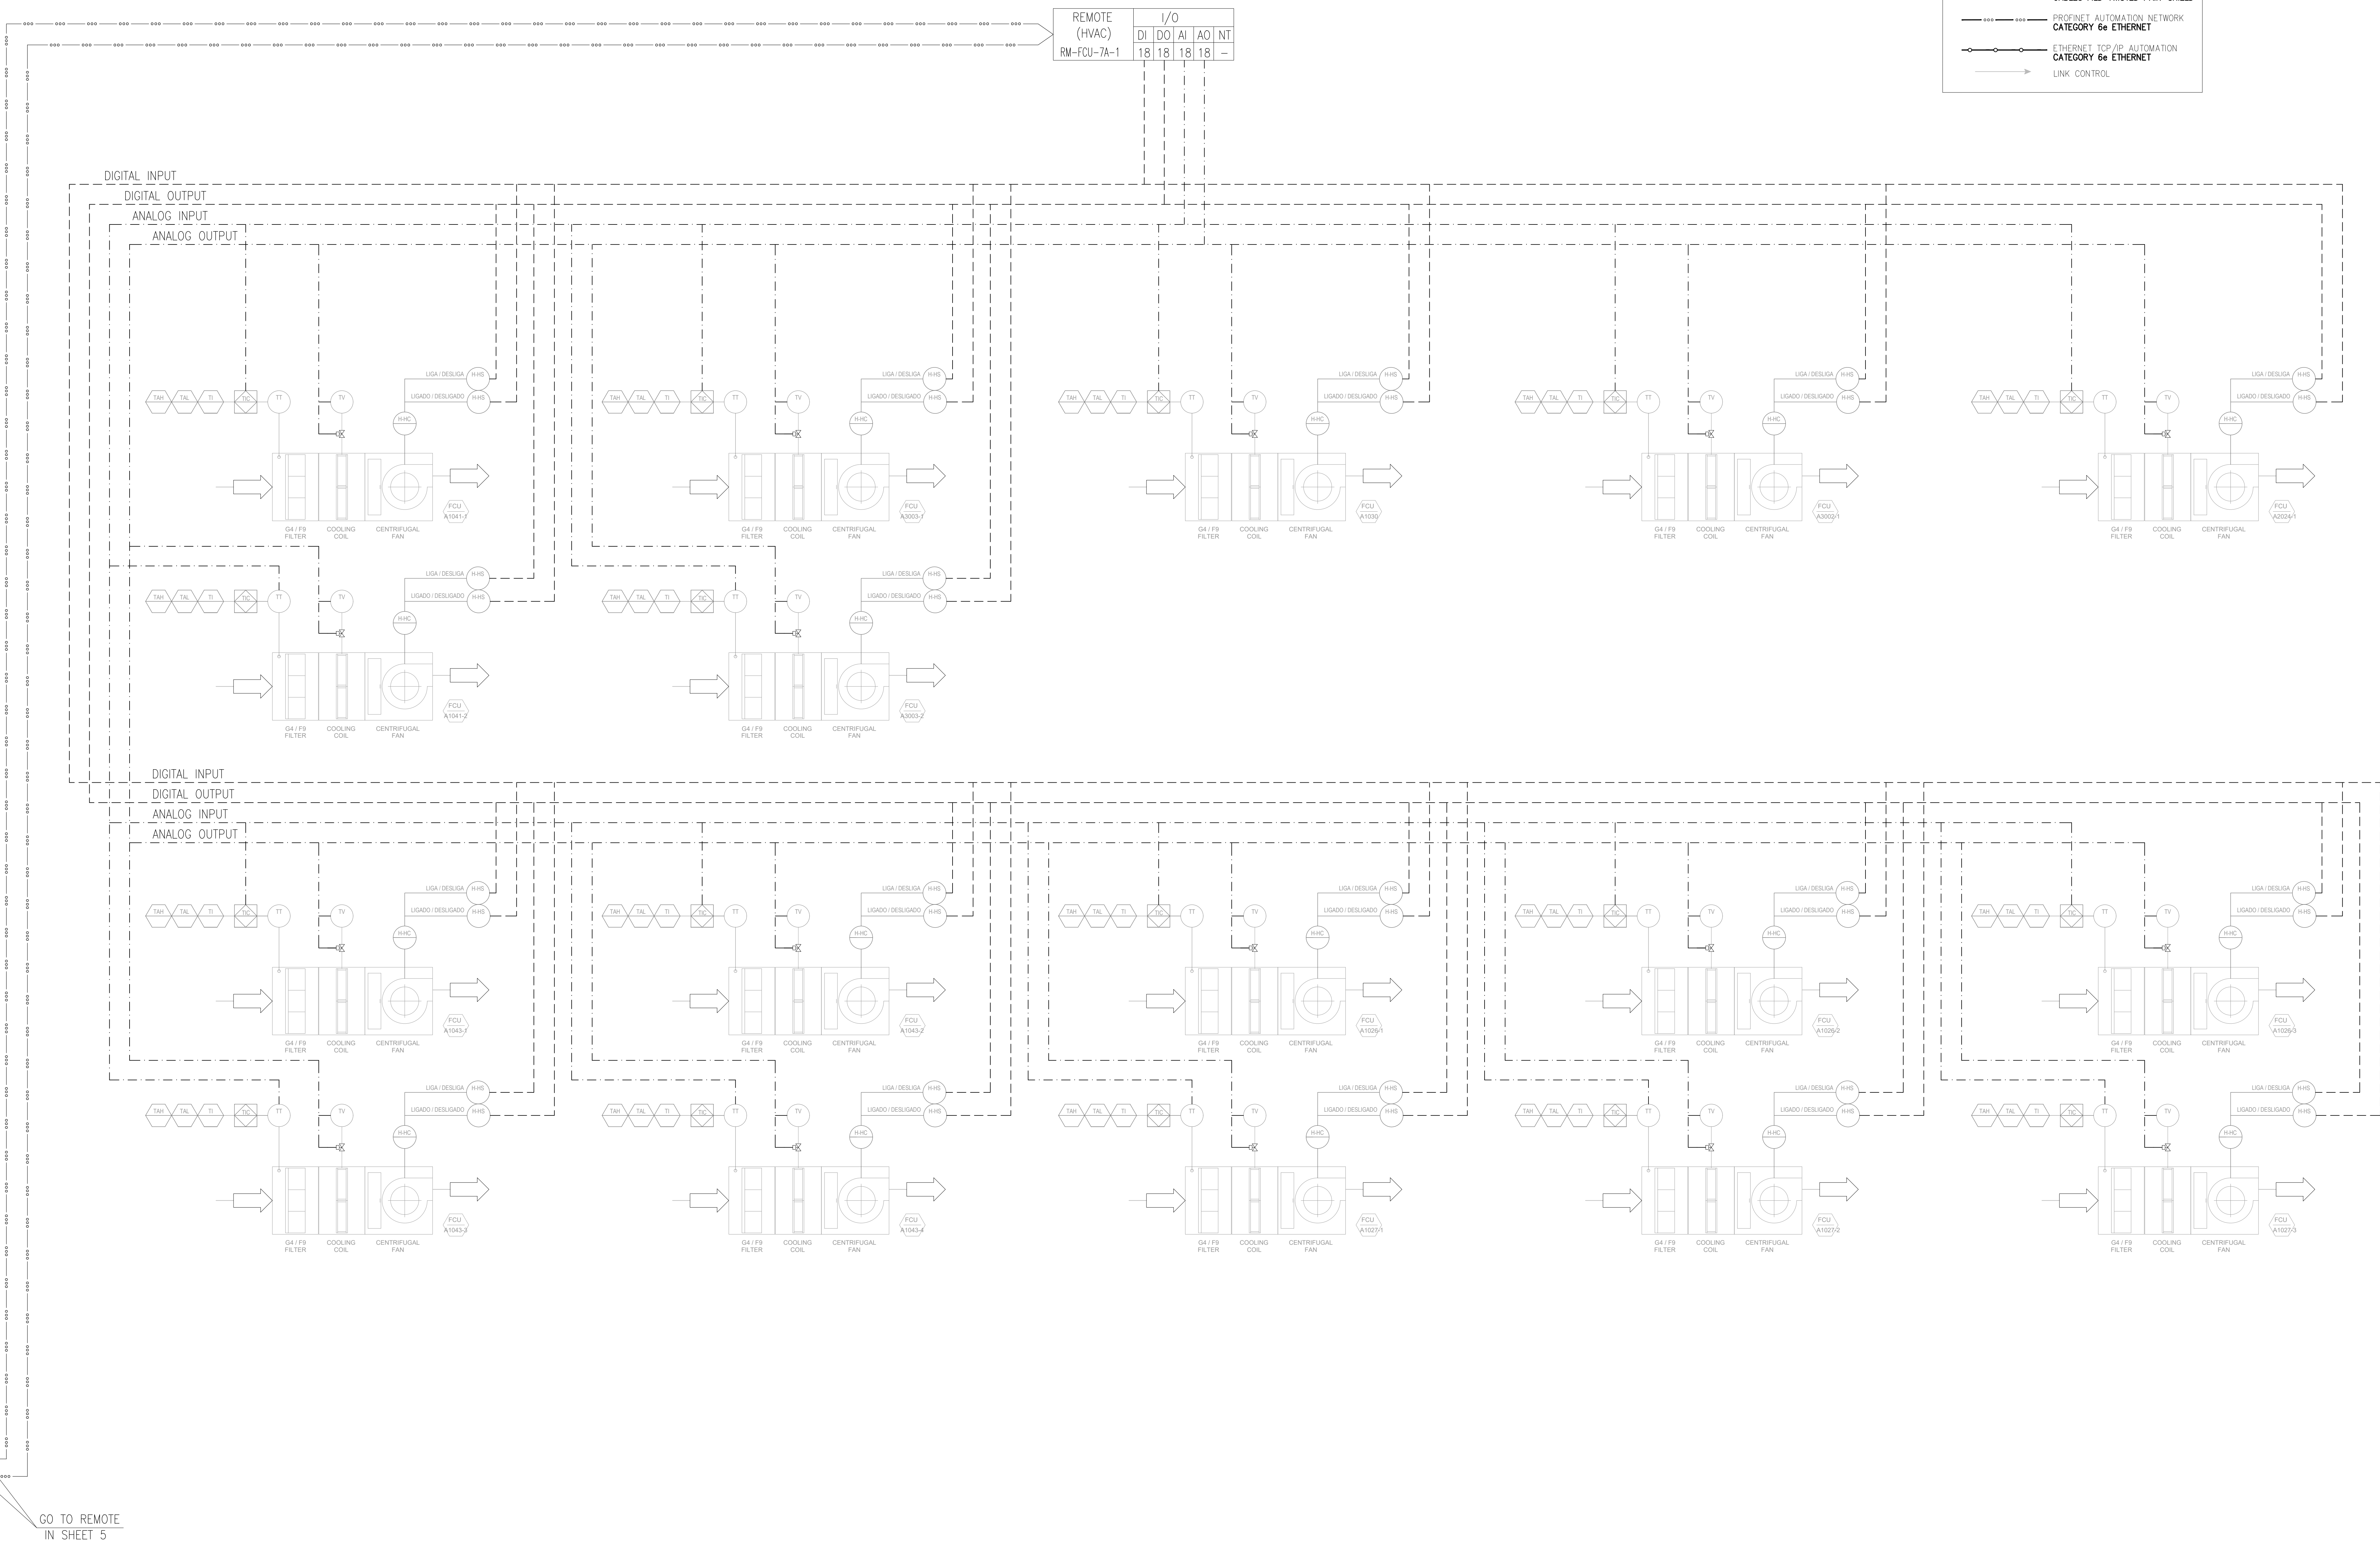




ips
Integrated Project Services
Engineering Design/Build Compliance Consulting
721 ARBOR WAY, SUITE 100
BLUE BELL, PENNSYLVANIA 19422
PHONE: 610.828.4090
FAX: 610.828.3656
www.ipsdb.com
IPS Professional Engineers and Architects, PC.

REVISION	DATE	DESCRIPTION	BY
A	10JUN2021	ORIGINAL ISSUE - FOR APPROVAL	MAF
B	30JUN2021	90% DD ISSUE	MAF
0	17SEP2021	ISSUE FOR CONSTRUCTION	MAF
1	11NOV2021	ISSUE FOR CONSTRUCTION CONSIDERING COMMENTS	MAF
2	01FEB2022	ISSUE FOR CONSTRUCTION CONSIDERING COMMENTS	MAF
3	07APR2022	ISSUED FOR CONSTRUCTION (UPDATED AS PER NOTES)	ACC
4	01JUN2022	ISSUED FOR CONSTRUCTION (UPDATED AS PER NOTES)	ACC

TESSLER
engenharia
R. Dr. Cesarino Mota Junior, 424 - Vila Buarque, São Paulo - SP, 01221-020

GENERAL NOTES:

1. SEE DOCUMENT OF THE HVAC SYSTEM (P&ID) THE 7A BUILDING.

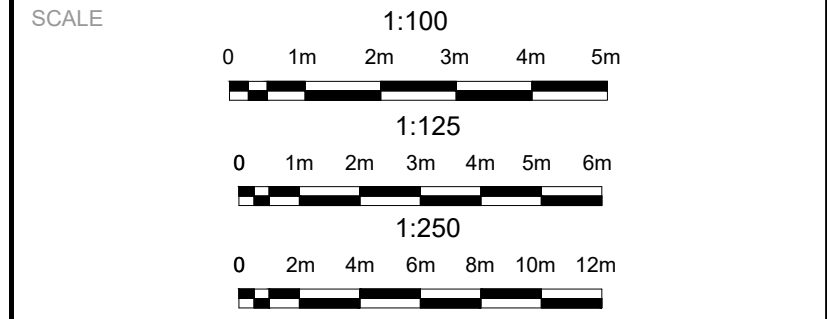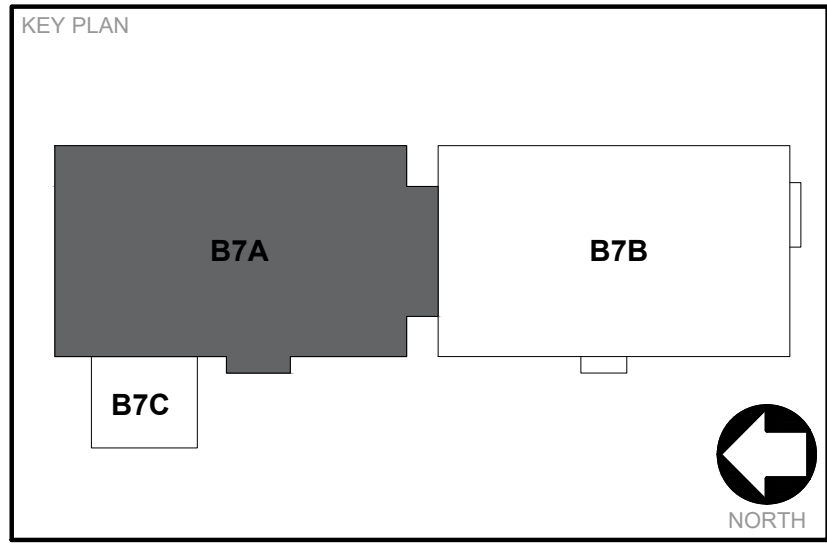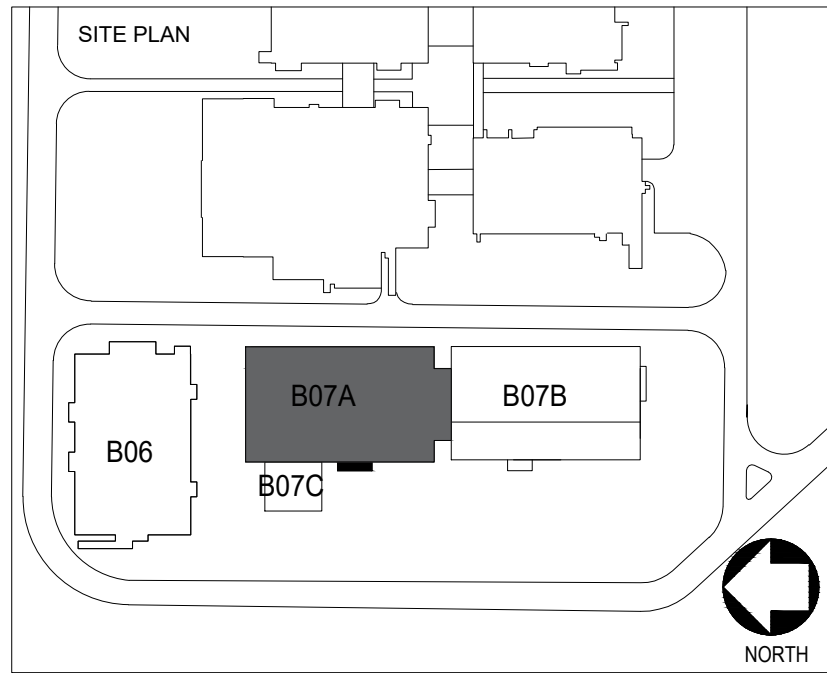

CONFIDENTIAL

THE INFORMATION CONTAINED HEREIN MAY NOT BE USED OR REPRODUCED IN ANY MANNER WITHOUT WRITTEN PERMISSION OF INTEGRATED PROJECT SERVICES.

CLIENT


Takeda
Hemobrás
Empresa Brasileira de Hemoderivação e Biotecnologia
BURITI EPCMV PROJECT

DRAWING TITLE:
DRUG PRODUCT BMS NETWORK ARCHITECTURE HVAC SYSTEM (SHEET 06/07)



ENGINEER MAF	ARCHITECT BJE	DESIGNER FJT	IPS PROJECT # ITD19439.01
DRAWN BY AAS	REVIEWED BY MAJ	SCALE AS NOTED	CADD FILE NAME

WBP FILE(S)	DRAWING NUMBER
	7A-I-0-7-04

REVISION	DATE	DESCRIPTION	BY
A	15JUN2021	ORIGINAL ISSUE - FOR APPROVAL	MAF
B	30JUN2021	90% DD ISSUE	MAF
0	17SEP2021	ISSUE FOR CONSTRUCTION	MAF
1	11NOV2021	ISSUE FOR CONSTRUCTION CONSIDERING COMMENTS	MAF
2	01FEB2022	ISSUE FOR CONSTRUCTION CONSIDERING COMMENTS	MAF
3	07APR2022	ISSUED FOR CONSTRUCTION UPDATED AS PER NOTES	ACC
4	01JUN2022	ISSUED FOR CONSTRUCTION UPDATED AS PER NOTES	ACC

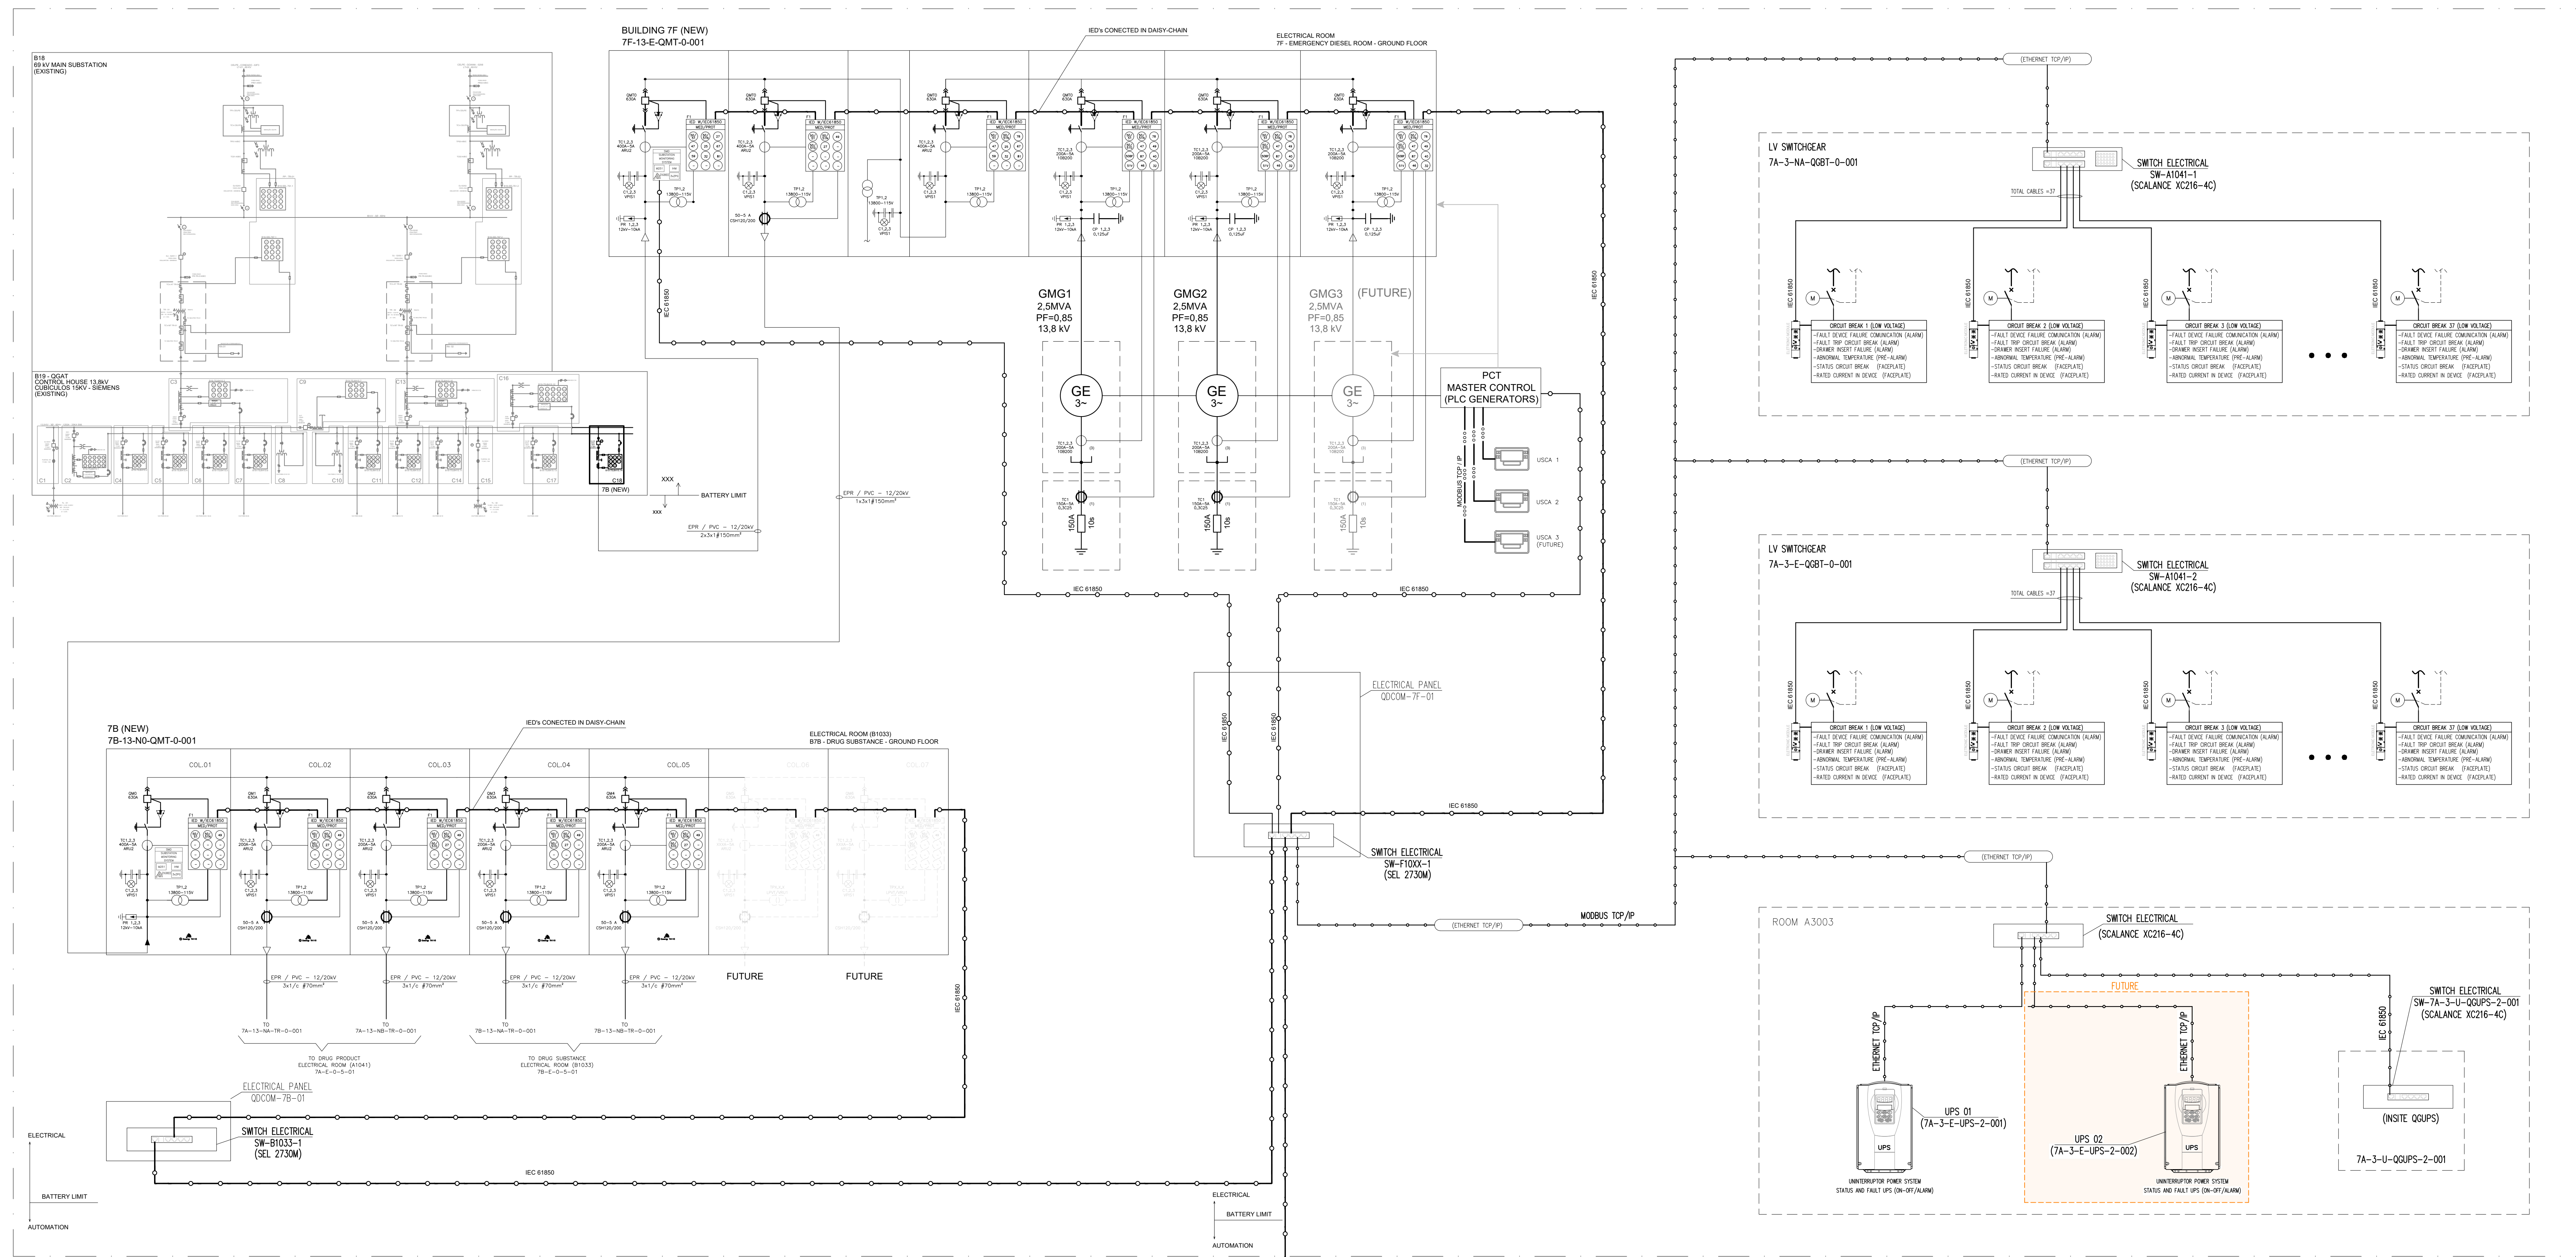

BMS ARCHITECTURE (ELECTRICAL SYSTEM)

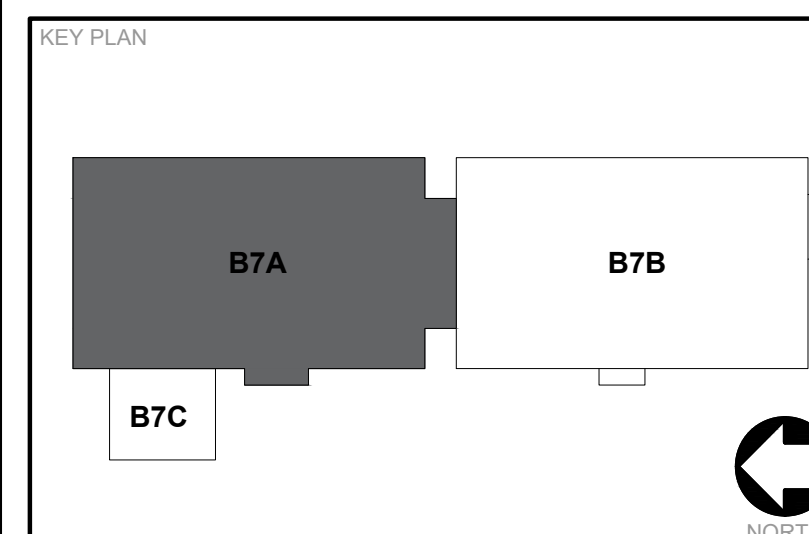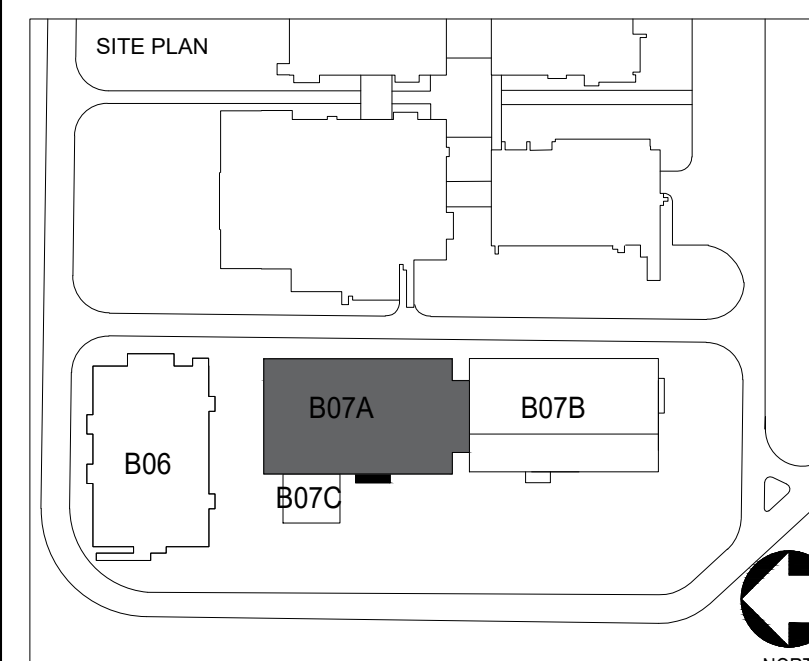

CONFIDENTIAL

THE INFORMATION CONTAINED HEREIN MAY NOT BE USED OR REPRODUCED IN ANY MANNER WITHOUT WRITTEN PERMISSION OF INTEGRATED PROJECT SERVICES.

CLIENT:

Takeda

Hemobrás
Empresa Brasileira de Hematodiagnóstico e Hemoterapia

BURITI EPCMV PROJECT

**DRUG PRODUCT BMS
NETWORK ARCHITECTURE
ELECTRICAL SYSTEM (SHEET 07/07)**

ENGINEER	ARCHITECT	DESIGNER	IPS PROJECT #
MAF	BJE	FJT	ITD19439.01
DRAWN BY	REVIEWED BY	SCALE	SAID FILE NAME
AAS	MAJ	AS NOTED	

WREP FILE(S)	DRAWING NUMBER
--------------	----------------

7A-I-0-7-04