

	B3, B-7	A6	A7	A5, A-4	A1	B6	B-4	C3, C-3	H1	H-4	H-5	H-7	H-8
		AS BELOW	AS BELOW	AS BELOW									AS BELOW
		AS BELOW		AS BELOW	AS BELOW			AS BELOW					

NOTES

- Reinforcement steel to be high yield round ribbed bars of yield strength 500Nmm-2
- All reinforcement shall be inspected by structural engineer/s before concrete casting
- Concrete cover to foundations to be 50mm, columns 40mm, beams 25mm
slabs 20mm and stairs 15mm.
- Concrete to beams, slabs and columns to be class 20 and to foundation class 25

STAIR QUANTITY TAKE-OFF					
SIZES	UNIT WEIGHT (kg)		Length (m)	T. WEIGHT (kg)	
NO			6.300	501.6	527.4
			T. WEIGHT (kg)		
BAR	SIZES	QTY	Length (mm)	TOTAL	FORM
1	8	83	1000	83.00	
2	8	30	4500	86.00	
3	8	10	3000	56.80	
4	8	10	2000	44.50	
5	8	10	1700	17.00	
6	8	10	1700	17.00	
7	8	10	2100	21.50	
8	8	10	1800	18.50	

- Reinforcement steel to be high yield round ribbed bars of yield strength 500Nmm²
- All reinforcement shall be inspected by structural engineer/s before concrete casting.
- Concrete cover to foundations to be 50mm, columns 40mm, beams 25mm
slabs 20mm and stairs 15mm.
- Concrete to beams, slabs and columns to be class 20 and to foundation class 25

BEAM ELEVATIONS QUANTITY TAKE OFF -				
SIZE	UNIT	WEIGHT (kg/m)	Length (m)	T. WEIGHT (kg)
16	1	1.38	240.0	331.2
18	1	2.07	250.0	517.5
20	1	3.05	1.000.0	3,050.0
22	1	4.40	380.0	1,672.0
25	1	8.00	100.0	800.0
28	1	12.00	100.0	1,200.0
32	1	17.80	100.0	1,780.0
36	1	25.40	100.0	2,540.0
40	1	35.00	100.0	3,500.0
45	1	47.90	100.0	4,790.0
50	1	63.70	100.0	6,370.0
56	1	82.80	100.0	8,280.0
63	1	106.00	100.0	10,600.0
70	1	137.10	100.0	13,710.0
76	1	172.40	100.0	17,240.0
80	1	192.00	100.0	19,200.0
85	1	217.00	100.0	21,700.0
90	1	242.00	100.0	24,200.0
95	1	267.00	100.0	26,700.0
100	1	292.00	100.0	29,200.0
105	1	317.00	100.0	31,700.0
110	1	342.00	100.0	34,200.0
115	1	367.00	100.0	36,700.0
120	1	392.00	100.0	39,200.0
125	1	417.00	100.0	41,700.0
130	1	442.00	100.0	44,200.0
135	1	467.00	100.0	46,700.0
140	1	492.00	100.0	49,200.0
145	1	517.00	100.0	51,700.0
150	1	542.00	100.0	54,200.0
155	1	567.00	100.0	56,700.0
160	1	592.00	100.0	59,200.0
165	1	617.00	100.0	61,700.0
170	1	642.00	100.0	64,200.0
175	1	667.00	100.0	66,700.0
180	1	692.00	100.0	69,200.0
185	1	717.00	100.0	71,700.0
190	1	742.00	100.0	74,200.0
195	1	767.00	100.0	76,700.0
200	1	792.00	100.0	79,200.0
205	1	817.00	100.0	81,700.0
210	1	842.00	100.0	84,200.0
215	1	867.00	100.0	86,700.0
220	1	892.00	100.0	89,200.0
225	1	917.00	100.0	91,700.0
230	1	942.00	100.0	94,200.0
235	1	967.00	100.0	96,700.0
240	1	992.00	100.0	99,200.0
245	1	1,017.00	100.0	1,01,700.0
250	1	1,042.00	100.0	1,04,200.0
255	1	1,067.00	100.0	1,06,700.0
260	1	1,092.00	100.0	1,09,200.0
265	1	1,117.00	100.0	1,11,700.0
270	1	1,142.00	100.0	1,14,200.0
275	1	1,167.00	100.0	1,16,700.0
280	1	1,192.00	100.0	1,19,200.0
285	1	1,217.00	100.0	1,21,700.0
290	1	1,242.00	100.0	1,24,200.0
295	1	1,267.00	100.0	1,26,700.0
300	1	1,292.00	100.0	1,29,200.0
305	1	1,317.00	100.0	1,31,700.0
310	1	1,342.00	100.0	1,34,200.0
315	1	1,367.00	100.0	1,36,700.0
320	1	1,392.00	100.0	1,39,200.0
325	1	1,417.00	100.0	1,41,700.0
330	1	1,442.00	100.0	1,44,200.0
335	1	1,467.00	100.0	1,46,700.0
340	1	1,492.00	100.0	1,49,200.0
345	1	1,517.00	100.0	1,51,700.0
350	1	1,542.00	100.0	1,54,200.0
355	1	1,567.00	100.0	1,56,700.0
360	1	1,592.00	100.0	1,59,200.0
365	1	1,617.00	100.0	1,61,700.0
370	1	1,642.00	100.0	1,64,200.0
375	1	1,667.00	100.0	1,66,700.0
380	1	1,692.00	100.0	1,69,200.0
385	1	1,717.00	100.0	1,71,700.0
390	1	1,742.00	100.0	1,74,200.0
395	1	1,767.00	100.0	1,76,700.0
400	1	1,792.00	100.0	1,79,200.0
405	1	1,817.00	100.0	1,81,700.0
410	1	1,842.00	100.0	1,84,200.0
415	1	1,867.00	100.0	1,86,700.0
420	1	1,892.00	100.0	1,89,200.0
425	1	1,917.00	100.0	1,91,700.0
430	1	1,942.00	100.0	1,94,200.0
435	1	1,967.00	100.0	1,96,700.0
440	1	1,992.00	100.0	1,99,200.0
445	1	2,017.00	100.0	2,01,700.0
450	1	2,042.00	100.0	2,04,200.0
455	1	2,067.00	100.0	2,06,700.0
460	1	2,092.00	100.0	2,09,200.0
465	1	2,117.00	100.0	2,11,700.0
470	1	2,142.00	100.0	2,14,200.0
475	1	2,167.00	100.0	2,16,700.0
480	1	2,192.00	100.0	2,19,200.0
485	1	2,217.00	100.0	2,21,700.0
490	1	2,242.00	100.0	2,24,200.0
495	1	2,267.00	100.0	2,26,700.0
500	1	2,292.00	100.0	2,29,200.0
505	1	2,317.00	100.0	2,31,700.0
510	1	2,342.00	100.0	2,34,200.0
515	1	2,367.00	100.0	2,36,700.0
520	1	2,392.00	100.0	2,39,200.0
525	1	2,417.00	100.0	2,41,700.0
530	1	2,442.00	100.0	2,44,200.0
535	1	2,467.00	100.0	2,46,700.0
540	1	2,492.00	100.0	2,49,200.0
545	1	2,517.00	100.0	2,51,700.0
550	1	2,542.00	100.0	2,54,200.0
555	1	2,567.00	100.0	2,56,700.0
560	1	2,592.00	100.0	2,59,200.0
565	1	2,617.00	100.0	2,61,700.0
570	1	2,642.00	100.0	2,64,200.0
575	1	2,667.00	100.0	2,66,700.0
580	1	2,692.00	100.0	2,69,200.0
585	1	2,717.00	100.0	2,71,700.0
590	1	2,742.00	100.0	2,74,200.0
595	1	2,767.00	100.0	2,76,700.0
600	1	2,792.00	100.0	2,79,200.0
605	1	2,817.00	100.0	2,81,700.0
610	1	2,842.00	100.0	2,84,200.0
615	1	2,867.00	100.0	2,86,700.0
620	1	2,892.00	100.0	2,89,200.0
625	1	2,917.00	100.0	2,91,700.0
630	1	2,942.00	100.0	2,94,200.0
635	1	2,967.00	100.0	2,96,700.0
640	1	2,992.00	100.0	2,99,200.0
645	1	3,017.00	100.0	3,01,700.0
650	1	3,042.00	100.0	3,04,200.0
655	1	3,067.00	100.0	3,06,700.0
660	1	3,092.00	100.0	3,09,200.0
665	1	3,117.00	100.0	3,11,700.0
670	1	3,142.00	100.0	3,14,200.0
675	1	3,167.00	100.0	3,16,700.0
680	1	3,192.00	100.0	3,19,200.0
685	1	3,217.00	100.0	3,21,700.0
690	1	3,242.00	100.0	3,24,200.0
695	1	3,267.00	100.0	3,26,700.0
700	1	3,292.00	100.0	3,29,200.0
705	1	3,317.00	100.0	3,31,700.0
710	1	3,342.00	100.0	3,34,200.0
715	1	3,367.00	100.0	3,36,700.0
720	1	3,392.00	100.0	3,39,200.0
725	1	3,417.00	100.0	3,41,700.0
730	1	3,442.00	100.0	3,44,200.0
735	1	3,467.00	100.0	3,46,700.0
740	1	3,492.00	100.0	3,49,200.0
745	1	3,517.00	100.0	3,51,700.0
750	1	3,542.00	100.0	3,54,200.0
755	1	3,567.00	100.0	3,56,700.0
760	1	3,592.00	100.0	3,59,200.0
765	1	3,617.00	100.0	3,61,700.0
770	1	3,642.00	100.0	3,64,200.0
775	1	3,667.00	100.0	3,66,700.0
780	1	3,692.00	100.0	3,69,200.0
785	1	3,717.00	100.0	3,71,700.0
790	1	3,742.00	100.0	3,74,200.0
795	1	3,767.00	100.0	3,76,700.0
800	1	3,792.00	100.0	3,79,200.0
805	1	3,817.00	100.0	3,81,700.0
810	1	3,842.00	100.0	3,84,200.0
815	1	3,867.00	100.0	3,86,700.0
820	1	3,892.00	100.0	3,89,200.0
825	1	3,917.00	100.0	3,91,700.0
830	1	3,942.00	100.0	3,94,200.0
835	1	3,967.00	100.0	3,96,700.0
840	1	3,992.00	100.0	3,99,200.0
845	1	4,017.00	100.0	4,01,700.0
850	1	4,042.00	100.0	4,04,200.0
855	1	4,067.00	100.0	4,06,700.0
860	1	4,092.00	100.0	4,09,200.0
865	1	4,117.00	100.0	4,11,700.0
870	1	4,142.00	100.0	4,14,200.0
875	1	4,167.00	100.0	4,16,700.0
880	1	4,192.00	100.0	4,19,200.0
885	1	4,217.00	100.0	4,21,700.0
890	1	4,242.00	100.0	4,24,200.0
895	1	4,267.00	100.0	4,26,700.0
900	1	4,292.00	100.0	4,29,200.0
905	1	4,317.00	100.0	4,31,700.0
910	1	4,342.00	100.0	4,34,200.0
915	1	4,367.00	100.0	4,36,700.0
920	1	4,392.00	100.0	4,39,200.0
925	1	4,417.00	100.0	4,41,700.0
930	1	4,442.00	100.0	4,44,200.0
935	1	4,467.00	100.0	4,46,700.0
940	1	4,492.00	100.0	4,49,200.0
945	1	4,517.00	100.0	4,51,700.0
950	1	4,542.00	100.0	4,54,200.0
955	1	4,567.00	100.0	4,56,700.0
960	1	4,592.00	100.0	4,59,200.0
965	1	4,617.00	100.0	4,61,700.0
970	1	4,642.00	100.0	4,64,200.0
975	1	4,667.00	100.0	4,66,700.0
980	1	4,692.00	100.0	4,69,200.0
985	1	4,717.00	100.0	4,71,700.0
990	1	4,742.00	100.0	4,74,200.0
995	1	4,767.00	100.0	4,76,700.0
1000	1	4,792.00	100.0	4,79,200.0


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91	18	2	1100	27.40	
92	18	2	1100	27.40	
93	18	2	1100	27.40	
94	20	2	2000	5.00	
95	18	2	2000	5.00	
96	16	2	2000	4.00	
97	18	2	1000	3.00	
98	16	2	2000	4.00	
99	16	2	1000	3.00	
100	16	2	1000	3.00	
101	10	47	1400	68.15	
102	16	2	1000	3.00	
103	20	2	1400	13.00	
104	20	2	1400	13.00	
105	16	2	1000	3.00	
106	16	2	1000	3.00	
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190	16	2	1000	3.00	
191	16	2	1000	3.00	
192	16	2	1000	3.00	
193	16	2	1000	3.00	
194	16	2	1000	3.00	
195	16	2	1000	3.00	
196	16	2	1000	3.00	
197	16	2	1000	3.00	
198	16	2	1000	3.00	
199	16	2	1000	3.00	
200	16	2	1000	3.00	

BEAM ELEVATIONS QUANTITY TAKE OFF				
UNIT WEIGHT (kg/m)		Length (m)		T. WEIGHT (kg)
002	0.336	2,953.1		1,002.2
V15	0.817	78.8		48.6
V16	1.586	1,556.9		2,465.4
V25	2.493	178.3		444.7
V25	3.558	166.4		592.0
		T. WEIGHT (kg)		4,659.3

BM	002	QTY	Length (m)	TOTAL	FORM
1	35	2	7300	14.60	
2	16	1	10000	61.00	
3	16	2	10000	20.00	
4	8	1046	1000	1073.80	
5	16	2	4200	17.00	
6	20	2	2500	5.00	
7	16	1	11000	44.00	
8	16	2	5000	10.00	
9	20	2	2000	5.00	
10	16	2	4200	17.00	
11	20	2	2000	5.00	
12	16	2	2500	10.00	
13	16	2	1000	2.00	
14	16	1	1000	11.00	
15	16	1	1000	7.00	
16	20	2	2000	5.00	
17	16	1	4100	32.00	
18	16	1	5000	21.00	
19	8	291	1400	407.40	
20	20	20	2000	62.00	
21	16	1	1000	7.00	
22	16	20	4300	86.00	
23	20	2	6000	27.00	
24	20	2	2000	20.00	
25	16	1	1000	20.00	
26	16	2	5000	11.00	
27	8	359	1200	430.80	
28	16	2	1100	2.00	
29	20	2	2000	5.00	
30	16	2	9100	10.00	
31	16	2	5000	10.00	
32	16	2	1000	3.00	
33	16	2	2100	4.30	
34	16	2	1100	2.30	
35	20	2	3000	5.00	
36	16	2	10000	20.00	
37	16	2	5000	31.00	
38	8	86	1000	104.80	
39	16	2	5000	11.00	
40	20	2	5000	11.70	
41	20	1	2000	11.00	
42	16	2	10000	20.00	
43	20	2	2000	5.00	
44	16	2	2000	7.00	
45	16	2	4000	12.00	
46	20	2	2000	4.00	
47	16	10	1100	11.00	
48	16	2	11000	22.00	
49	16	1	11000	40.00	
50	20	1	4100	16.00	
51	16	2	2700	5.00	

52	16	2	1000	3.00	
53	16	2	1000	2.10	
54	16	2	5000	11.00	
55	16	2	5000	11.00	
56	16	2	2100	4.30	
57	16	2	1000	3.70	
58	16	2	10000	20.00	
59	16	2	20000	40.00	
60	16	2	9000	19.00	
61	16	2	6700	13.40	
62	16	2	6700	13.40	
63	16	2	6700	13.40	
64	16	2	6700	13.40	
65	16	2	6700	13.40	
66	16	2	6700	13.40	
67	16	2	6700	13.40	
68	16	2	6700	13.40	
69	16	2	6700	13.40	
70	16	2	6700	13.40	
71	16	2	6700	13.40	
72	16	2	6700	13.40	
73	16	2	6700	13.40	
74	16	2	6700	13.40	
75	16	2	6700	13.40	
76	16	2	6700	13.40	
77	16	2	6700	13.40	
78	16	2	6700	13.40	
79	16	2	6700	13.40	
80	16	2	6700	13.40	
81	16	2	6700	13.40	
82	16	2	6700	13.40	
83	16	2	6700	13.40	
84	16	2	6700	13.40	
85	16	2	6700	13.40	
86	16	2	6700	13.40	
87	16	2	6700	13.40	
88	16	2	6700	13.40	
89	16	2	6700	13.40	
90	16	2	6700	13.40	
91	16	2	6700	13.40	
92	16	2	6700	13.40	
93	16	2	6700	13.40	
94	16	2	6700	13.40	
95	16	2	6700	13.40	
96	16	2	6700	13.40	
97	16	2	6700	13.40	
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132	16	40	1700	78.75	

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34	16	2	1800	23.30	
35	20	2	1000	8.50	
36	16	2	3300	6.60	
37	20	2	2500	5.00	
38	16	2	4200	8.40	
39	16	2	6100	12.20	
40	20	2	3700	11.70	
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42	16	2	5300	10.60	
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68	16	4	5700	23.00	
69	16	2	7500	2.10	
70	16	2	1000	2.80	
71	16	4	1600	7.20	
72	16	2	1900	20.00	
73	16	50	1600	20.00	
74	16	2	10700	51.50	

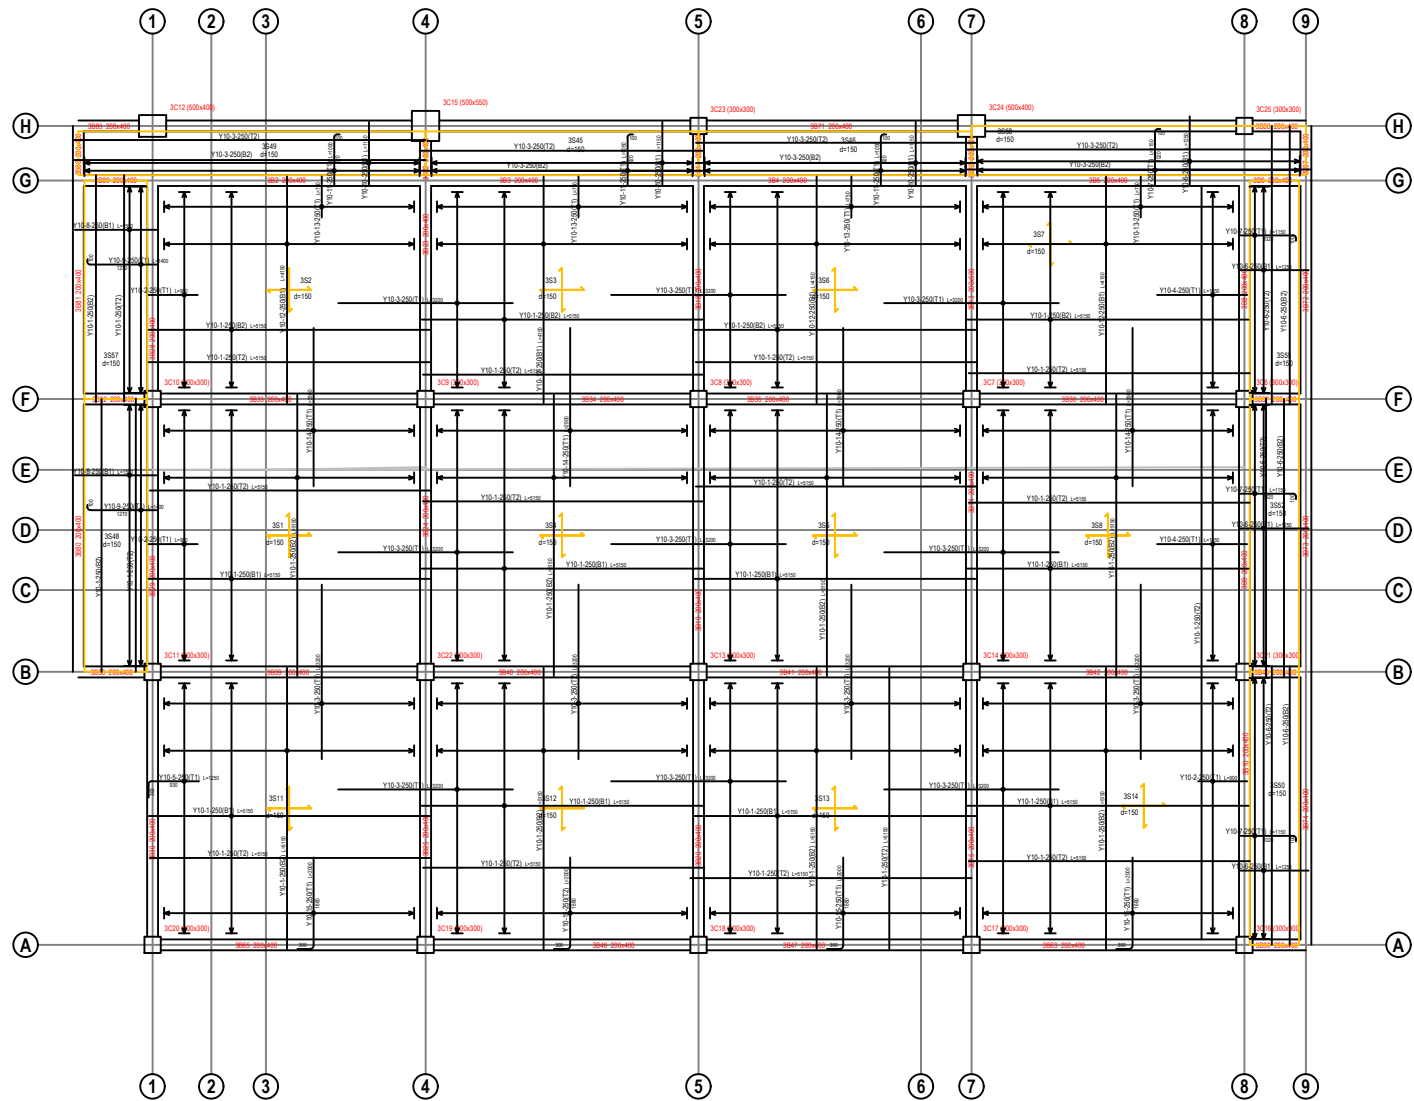

STOREY: 3 - LEVEL: +9.00m - SCALE: 1/50

CLIENT: MACHAKOS UNIVERSITY

P.O BOX 136-90100,
MACHAKOS,KENYA.

PROJECT:

PROPOSED POST GRADUATE COMPLEX

SHEET:

ROOF SLAB REBAR DETAILS

DESIGN: PATRICK MWANGI

DRAWN: PATRICK MWANGI

CHECKED:

DRAWING NO: 3S003

DATE

25-05-24

25-05-24

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.....

SIGNATRUE

p.m

p.m

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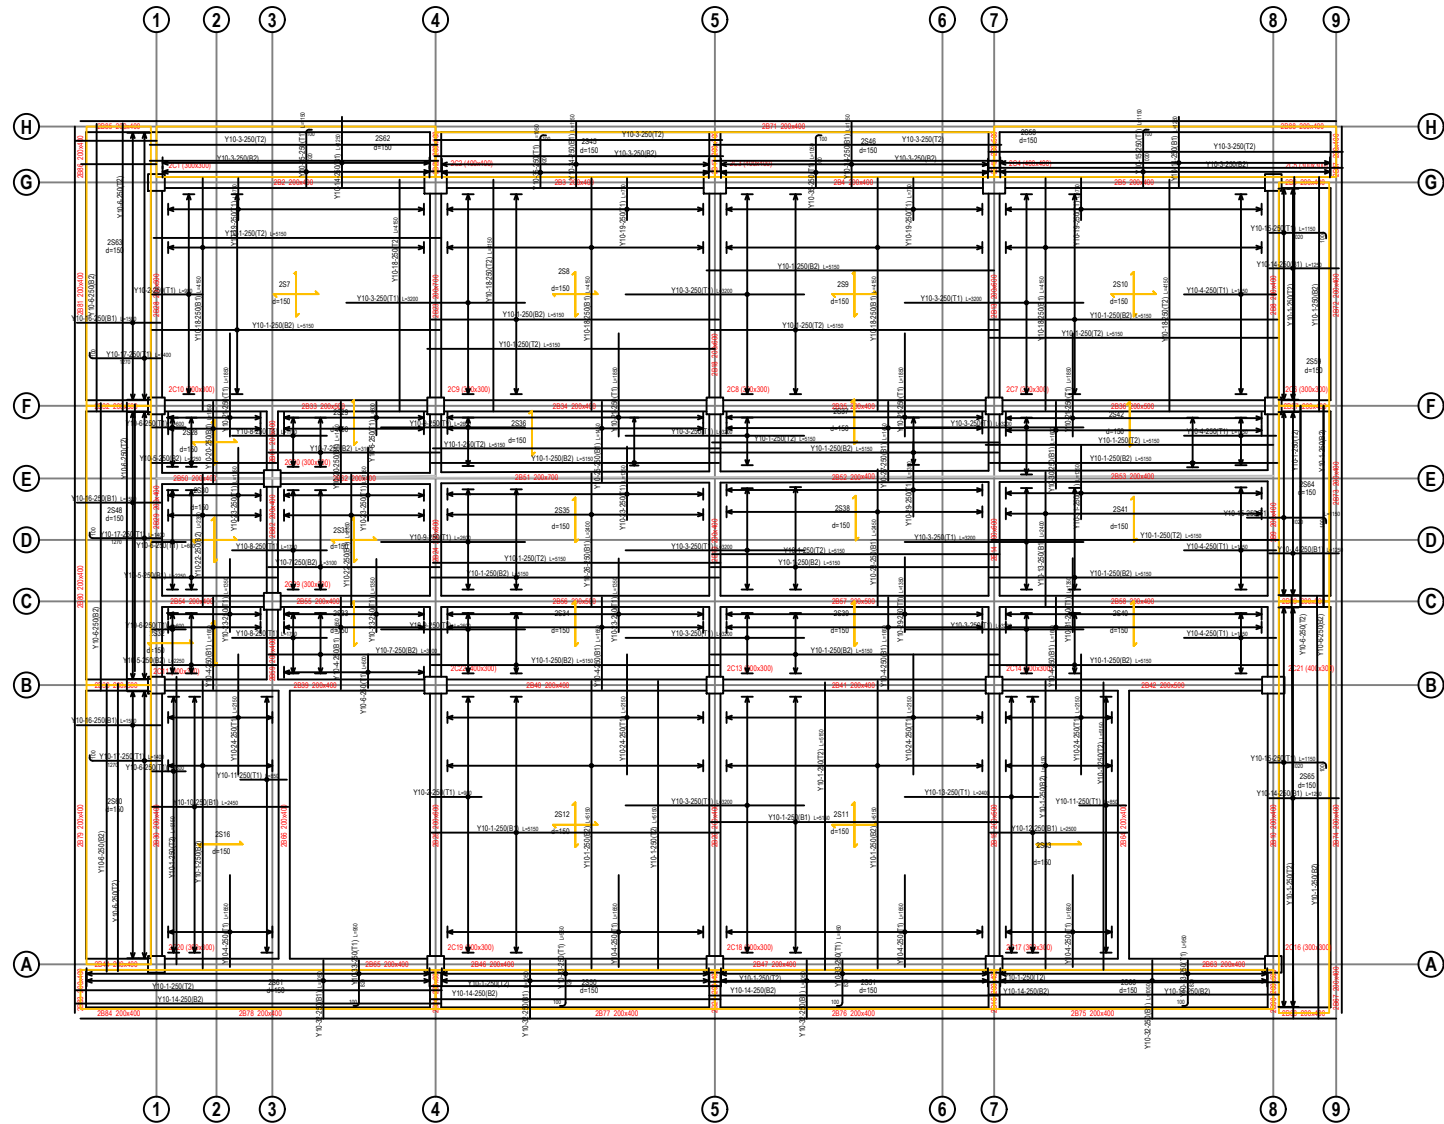
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NOTES

- Reinforcement steel to be high yield round ribbed bars of yield strength 500Nmm²
- All reinforcement shall be inspected by structural engineer/s before concrete casting.
- Concrete cover to foundations to be 50mm, columns 40mm, beams 25mm
slabs 20mm and stairs 15mm.
- Concrete to beams, slabs and columns to be class 20 and to foundation class 25

SCALE: 1 : 35



STOREY: 2 - LEVEL: +6.00m - SCALE: 1/50

CLIENT: MACHAKOS UNIVERSITY

P.O BOX 136-90100,
MACHAKOS,KENYA.

PROJECT:
PROPOSED POST GRADUATE COMPLEX

SHEET:
SLAB REBAR DETAILS

DESIGN: PATRICK MWANGI

DATE
25-05-24

SIGNATURE
p.m

DRAWN: PATRICK MWANGI

DATE
25-05-24

SIGNATURE
p.m


CHECKED:

DRAWING NO: 2S002

SCALE: 1 : 35

NOTES

- Reinforcement steel to be high yield round ribbed bars of yield strength 500Nmm²
- All reinforcement shall be inspected by structural engineer/s before concrete casting.
- Concrete cover to foundations to be 50mm, columns 40mm, beams 25mm slabs 20mm and stairs 15mm.
- Concrete to beams, slabs and columns to be class 20 and to foundation class 25

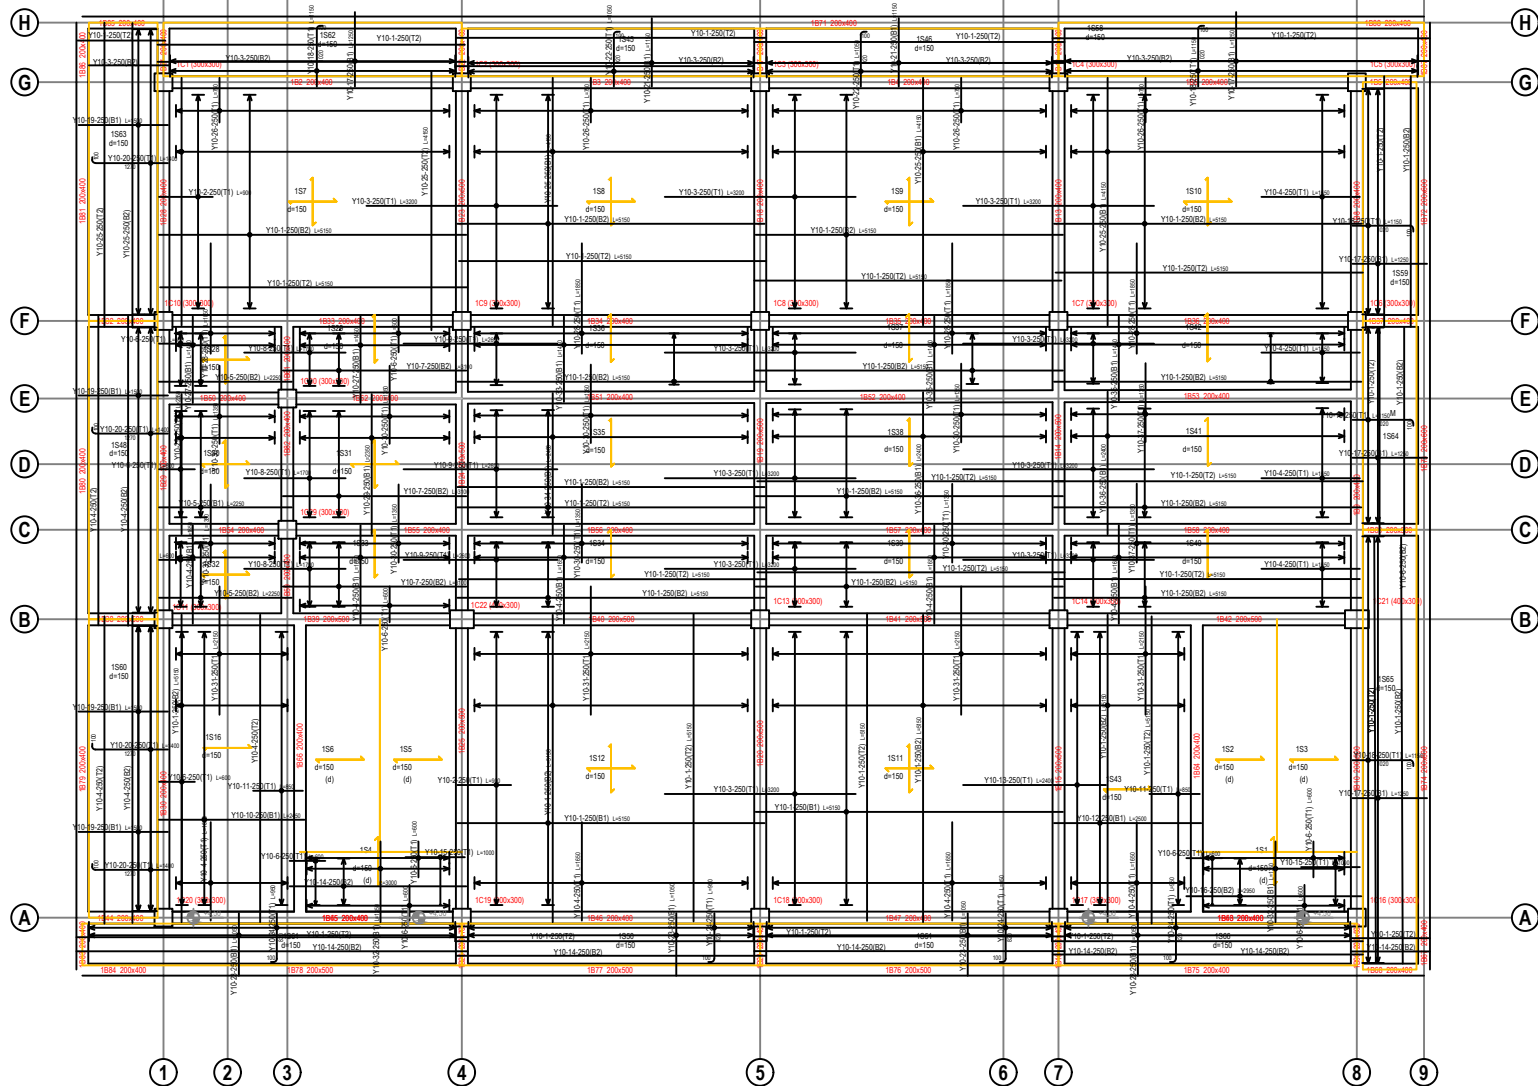

STOREY: 1 - LEVEL: +3.00m - SCALE: 1/50

CLIENT: MACHAKOS UNIVERSITY

P.O BOX 136-90100,
MACHAKOS,KENYA.

PROJECT:
PROPOSED POST GRADUATE COMPLEX

SHEET:
SLAB REBAR DETAILS

DESIGN: PATRICK MWANGI

DRAWN: PATRICK MWANGI

CHECKED:

DRAWING NO: 1S001

DATE

25-05-24

SIGNATURE

p.m


25-05-24

p.m





SCALE: 1 : 35

NOTES

- Reinforcement steel to be high yield round ribbed bars of yield strength 500Nmm²
- All reinforcement shall be inspected by structural engineer/s before concrete casting.
- Concrete cover to foundations to be 50mm, columns 40mm, beams 25mm slabs 20mm and stairs 15mm.
- Concrete to beams, slabs and columns to be class 20 and to foundation class 25

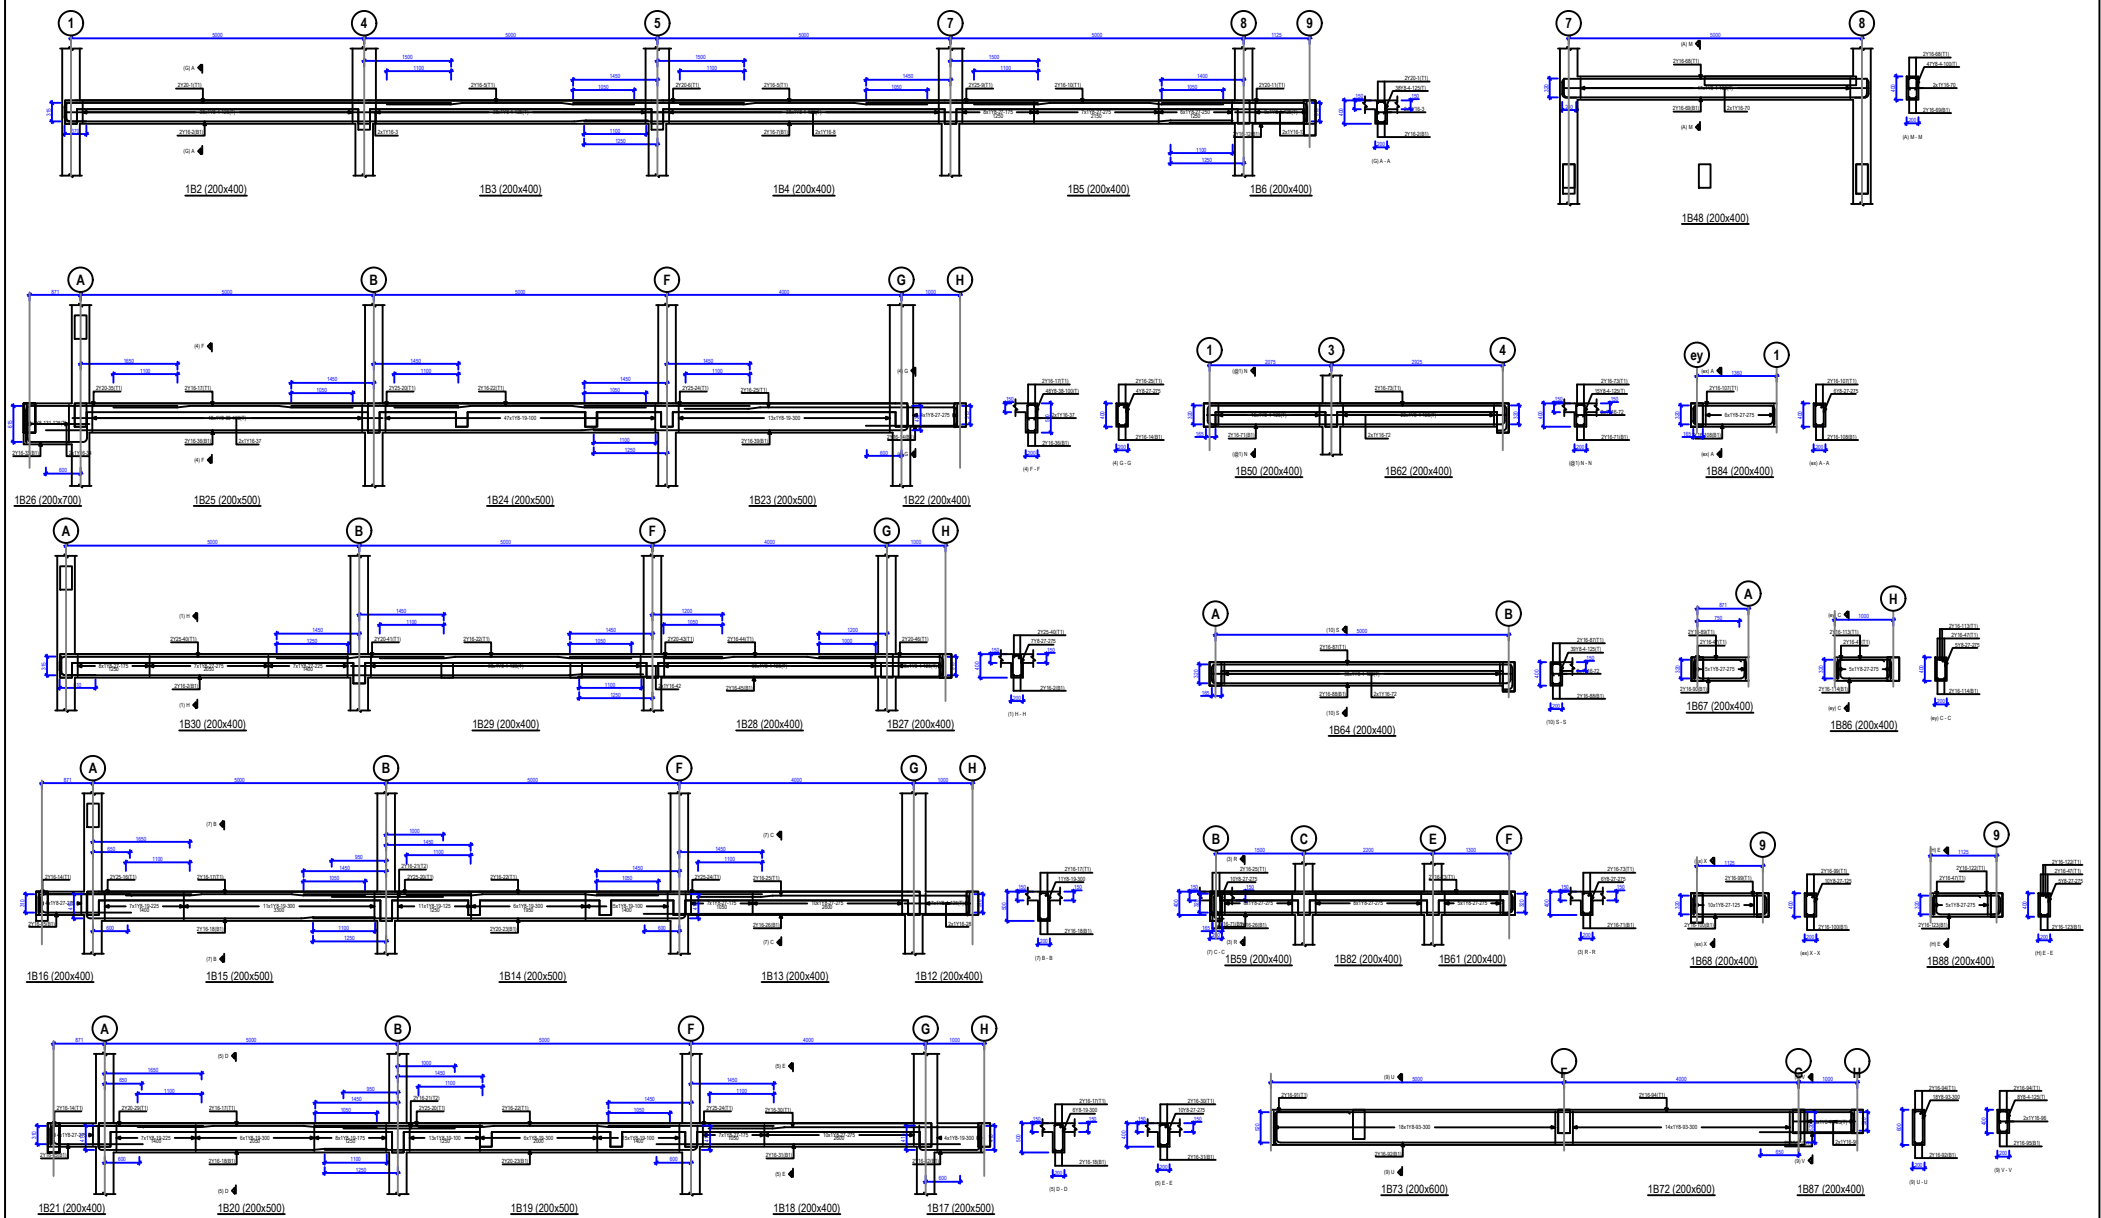

CLIENT: MACHAKOS UNIVERSITY P.O BOX 136-90100, MACHAKOS,KENYA.	PROJECT:	DESIGN: PATRICK MWANGI	DATE	SIGNATURE	<u>NOTES</u> - Reinforcement steel to be high yield round ribbed bars of yield strength 500Nmm-2 - All reinforcement shall be inspected by structural engineer/s before concrete casting. - Concrete cover to foundations to be 50mm, columns 40mm, beams 25mm slabs 20mm and stairs 15mm. - Concrete to beams, slabs and columns to be class 20 and to foundation class 25
	PROPOSED POST GRADUATE COMPLEX	DRAWN: PATRICK MWANGI	25-05-24	p.m	
		CHECKED:	25-05-24	p.m	
	SHEET:	CHECKED:			
	BEAMS REBAR DETAILS	DRAWING NO: 1S002	SCALE: 1 : 35		

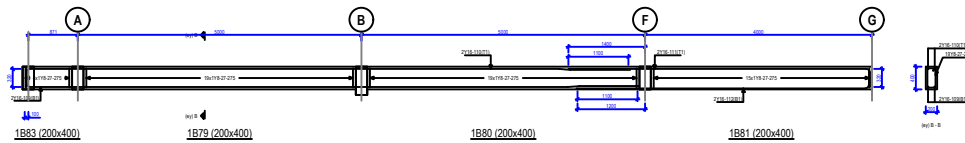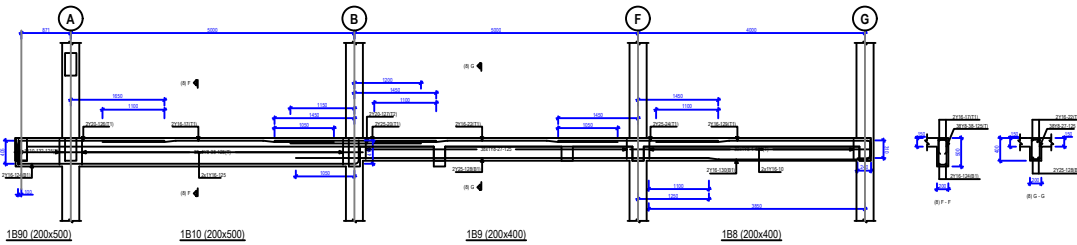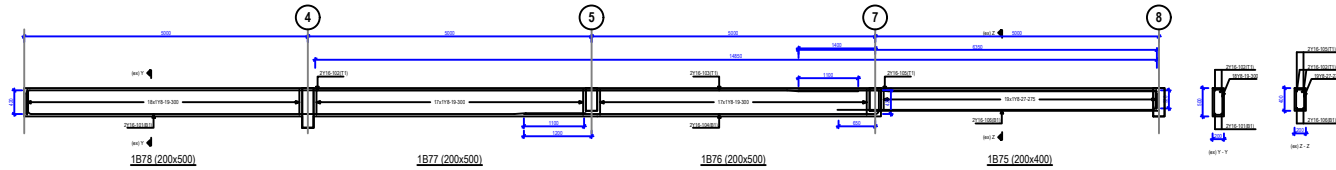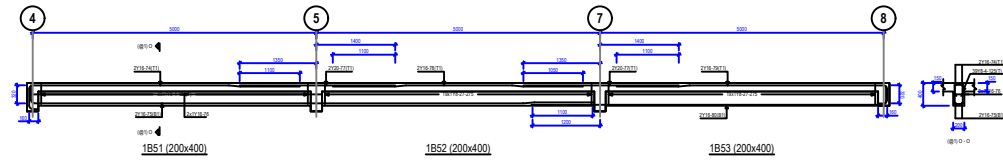

CLIENT: MACHAKOS UNIVERSITY

P.O BOX 136-90100,
MACHAKOS, KENYA.

PROJECT:
PROPOSED POST GRADUATE COMPLEX

SHEET:
BEAMS REBAR DETAILS

DESIGN: PATRICK MWANGI

DRAWN: PATRICK MWANGI

CHECKED:

DRAWING NO: 1S003

DATE

25-05-24

SIGNATURE

p.m


25-05-24

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SCALE: 1 : 35

NOTES

- Reinforcement steel to be high yield round ribbed bars of yield strength 500Nmm²
- All reinforcement shall be inspected by structural engineer/s before concrete casting.
- Concrete cover to foundations to be 50mm, columns 40mm, beams 25mm slabs 20mm and stairs 15mm.
- Concrete to beams, slabs and columns to be class 20 and to foundation class 25

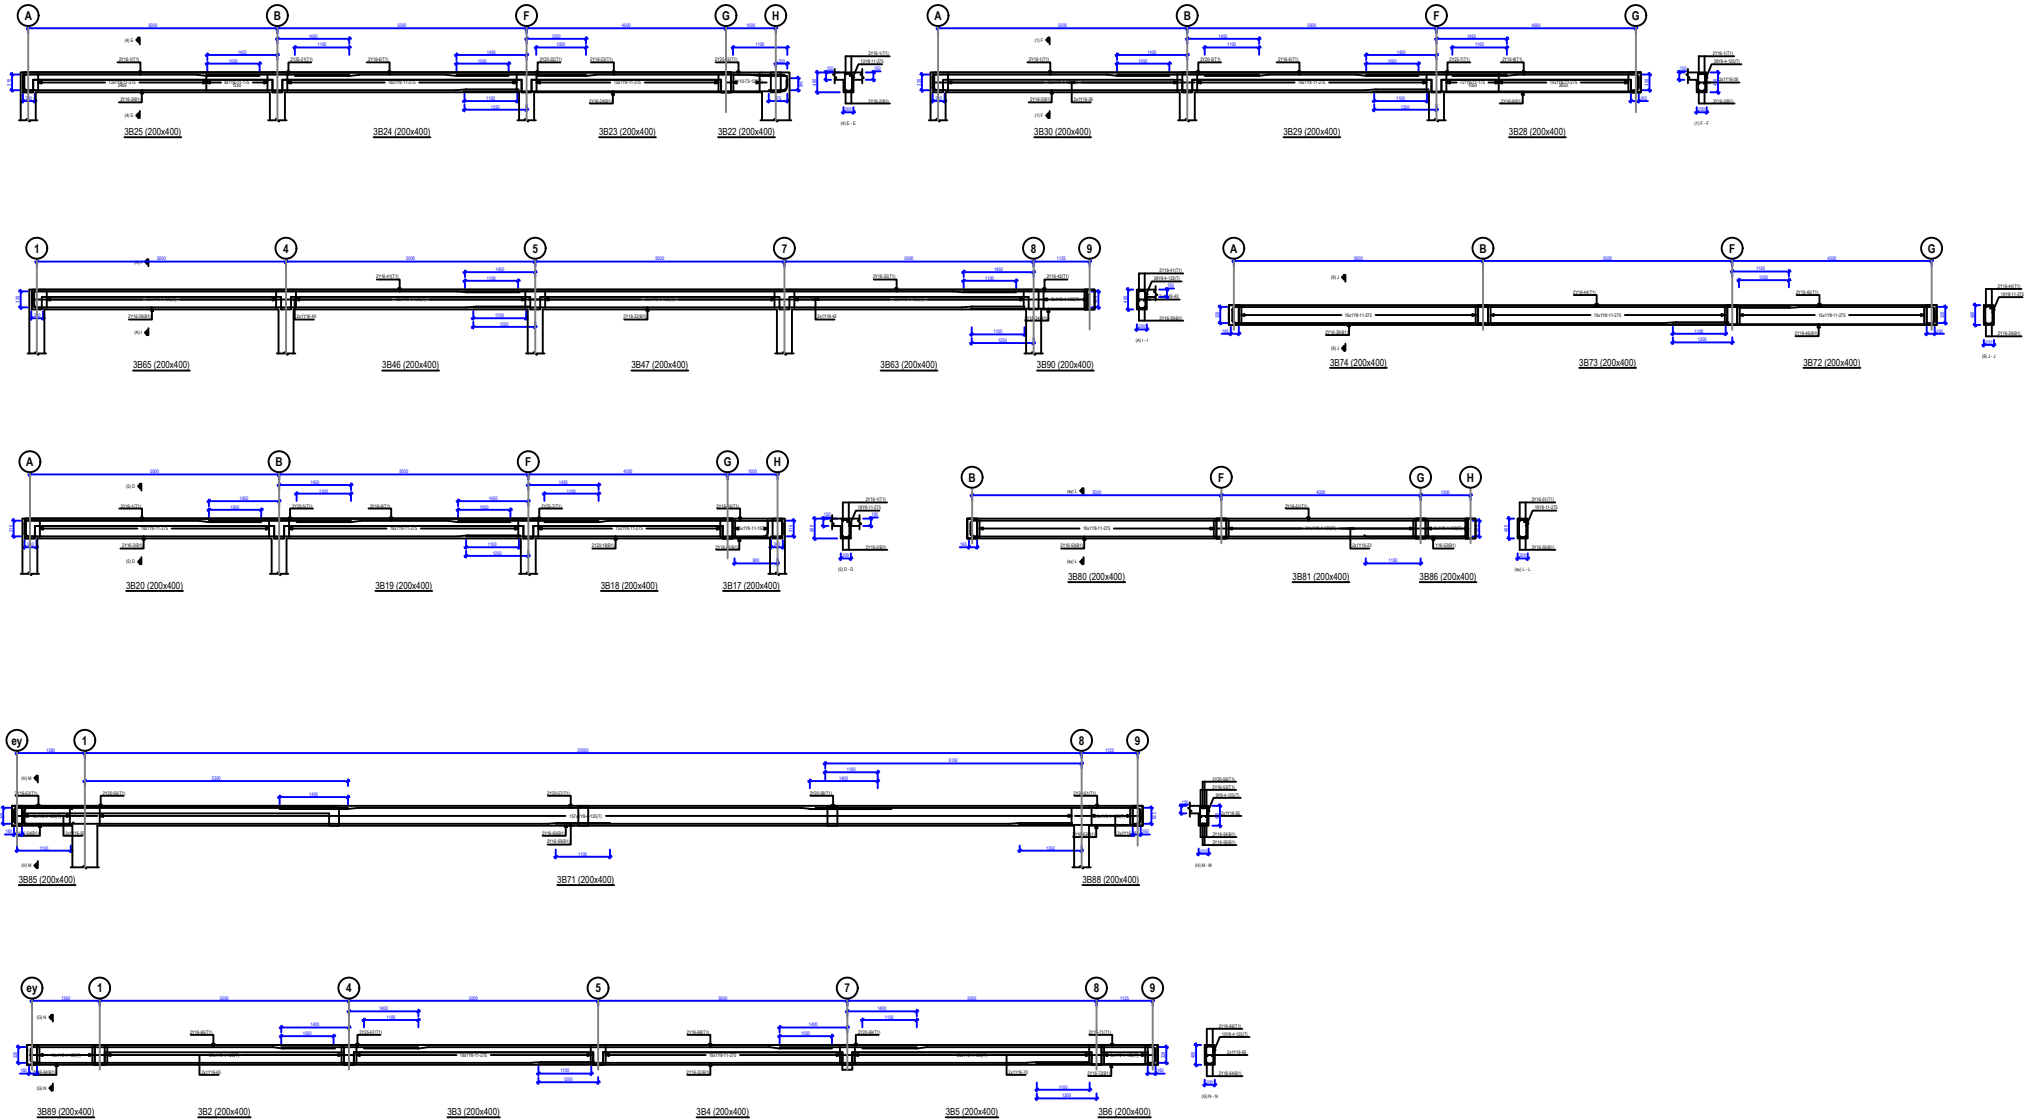

CLIENT: MACHAKOS UNIVERSITY

P.O BOX 136-90100,
MACHAKOS,KENYA.

PROJECT:
PROPOSED POST GRADUATE COMPLEX

SHEET:
BEAMS REBAR DETAILS

DESIGN: PATRICK MWANGI

DRAWN: PATRICK MWANGI

CHECKED:

DRAWING NO: 3S002

DATE

25-05-24

25-05-24

.....

SCALE: 1 : 35

SIGNATRUE





p.m

p.m

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NOTES

- Reinforcement steel to be high yield round ribbed bars of yield strength 500Nmm²
- All reinforcement shall be inspected by structural engineer/s before concrete casting.
- Concrete cover to foundations to be 50mm, columns 40mm, beams 25mm
slabs 20mm and stairs 15mm.
- Concrete to beams, slabs and columns to be class 20 and to foundation class 25

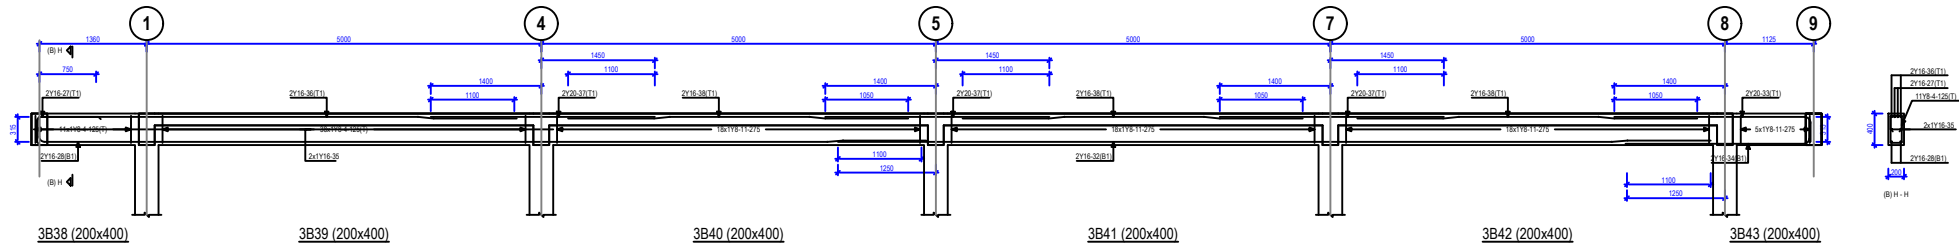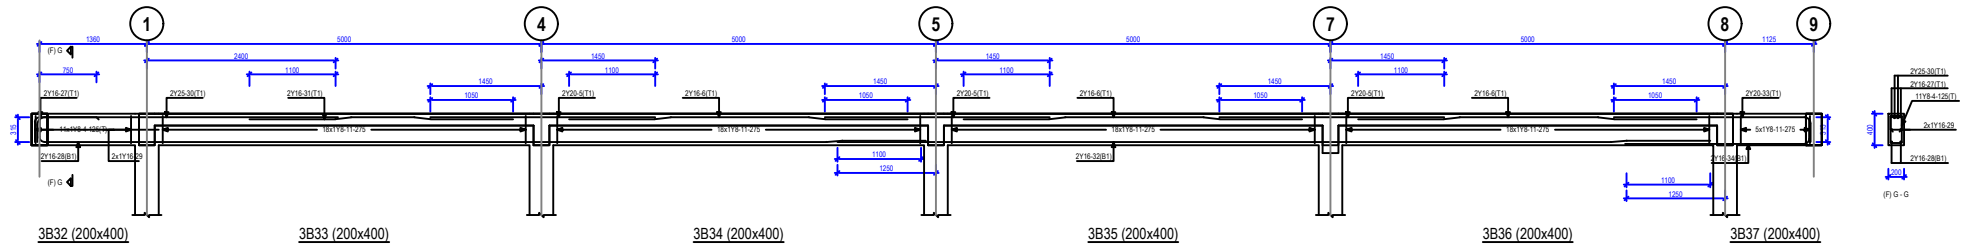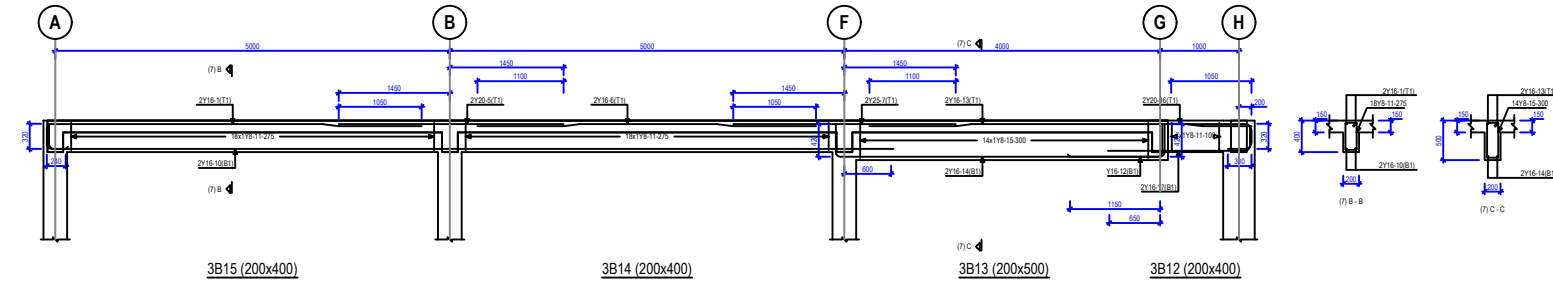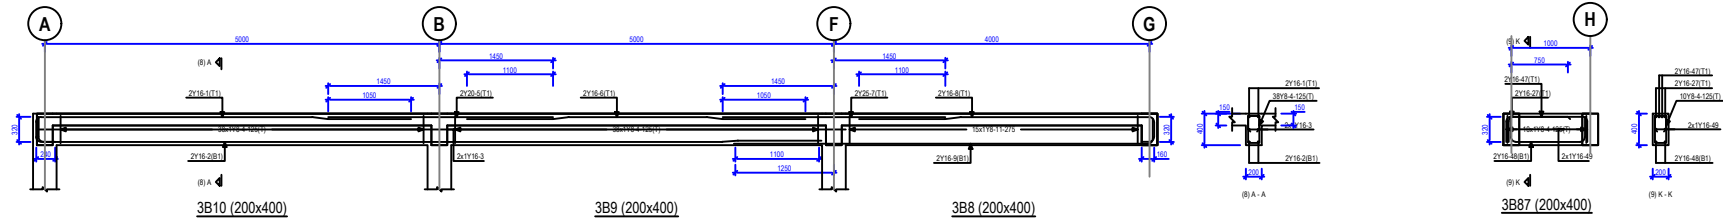

CLIENT: MACHAKOS UNIVERSITY

P.O BOX 136-90100,
MACHAKOS, KENYA.

PROJECT:
PROPOSED POST GRADUATE COMPLEX

SHEET:
BEAMS REBAR DETAILS

DESIGN: PATRICK MWANGI

DRAWN: PATRICK MWANGI

CHECKED:

DRAWING NO: 3S001

DATE

25-05-24

SIGNATURE

p.m


25-05-24

p.m

SCALE: 1 : 35

NOTES

- Reinforcement steel to be high yield round ribbed bars of yield strength 500Nmm²
- All reinforcement shall be inspected by structural engineer/s before concrete casting.
- Concrete cover to foundations to be 50mm, columns 40mm, beams 25mm slabs 20mm and stairs 15mm.
- Concrete to beams, slabs and columns to be class 20 and to foundation class 25

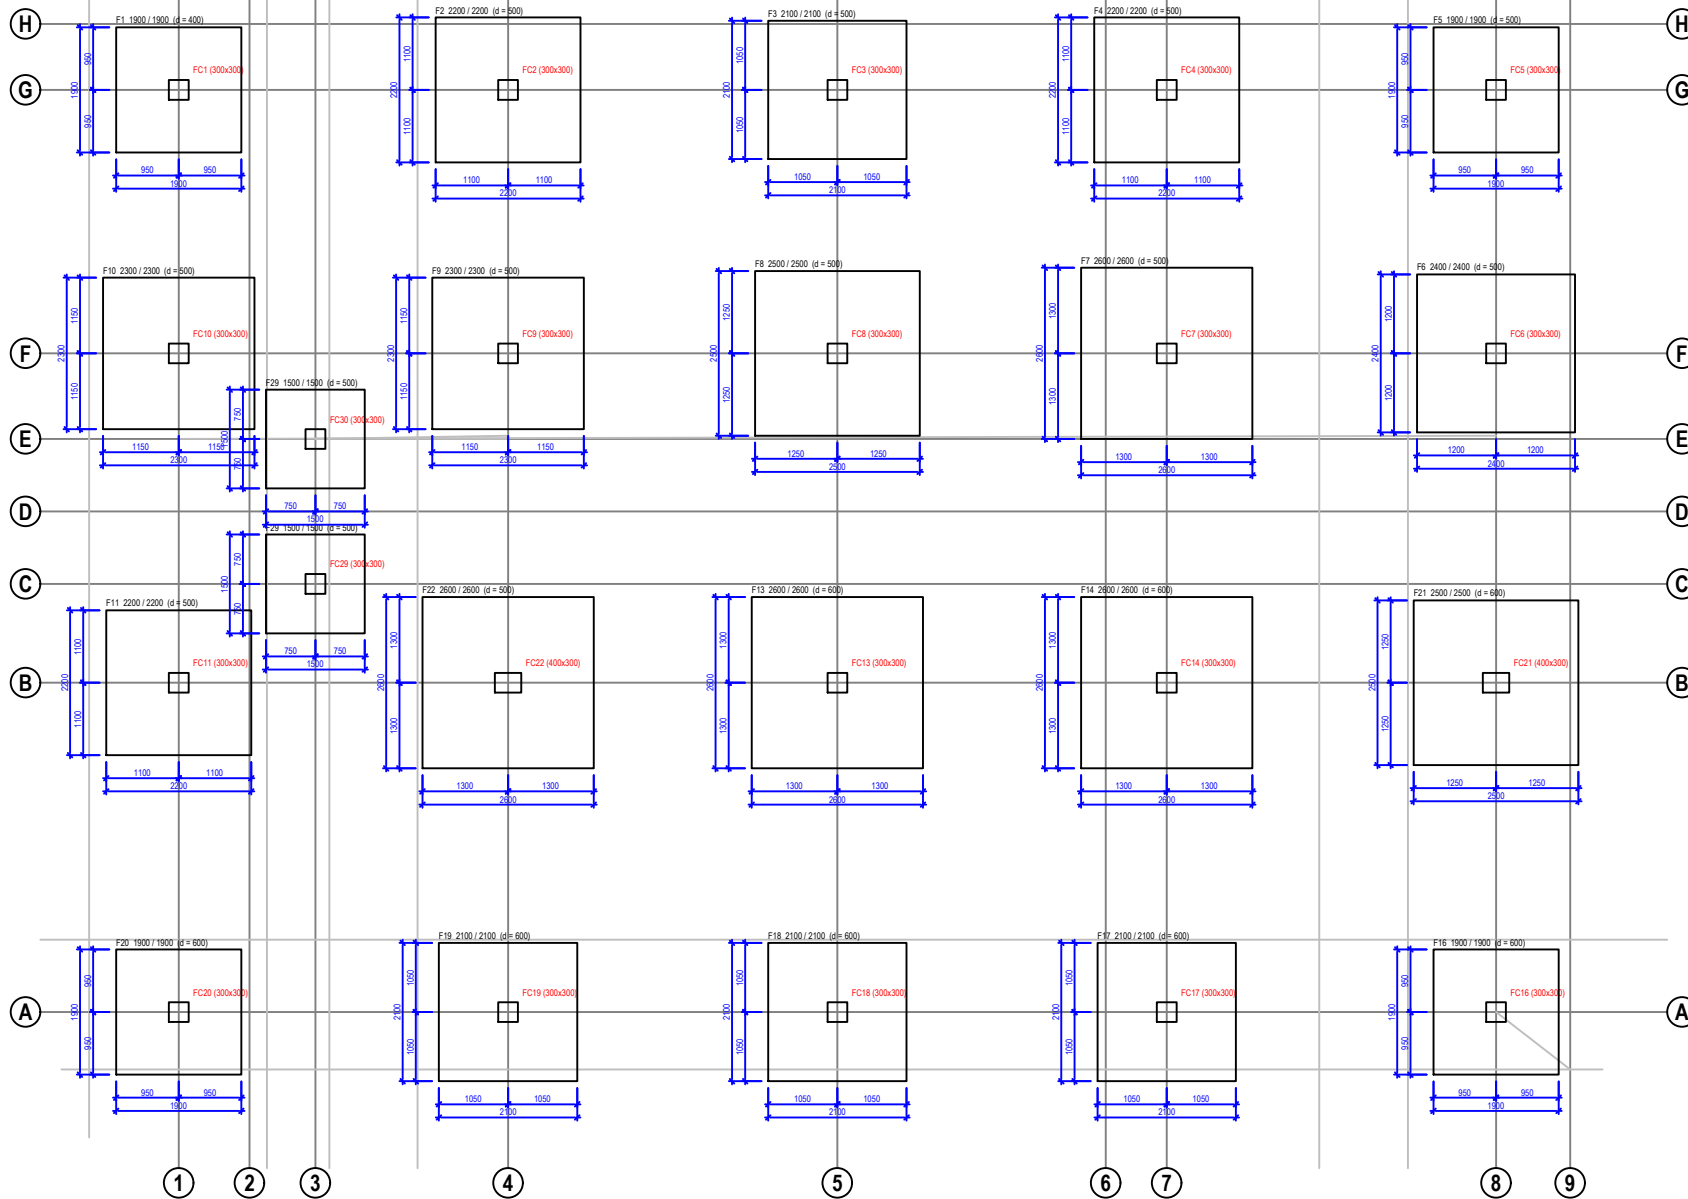

CLIENT: MACHAKOS UNIVERSITY

P.O BOX 136-90100,
MACHAKOS,KENYA.

PROJECT:
PROPOSED POST GRADUATE COMPLEX

SHEET:
PAD FOUNDATION PLAN DETAILS

DESIGN: PATRICK MWANGI

DRAWN: PATRICK MWANGI

CHECKED:

DRAWING NO: S001

DATE
25-05-24

25-05-24

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SCALE: 1 : 25


SIGNATURE
p.m

p.m

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NOTES

- Reinforcement steel to be high yield round ribbed bars of yield strength 500Nmm²
- All reinforcement shall be inspected by structural engineer/s before concrete casting.
- Concrete cover to foundations to be 50mm, columns 40mm, beams 25mm slabs 20mm and stairs 15mm.
- Concrete to beams, slabs and columns to be class 20 and to foundation class 25

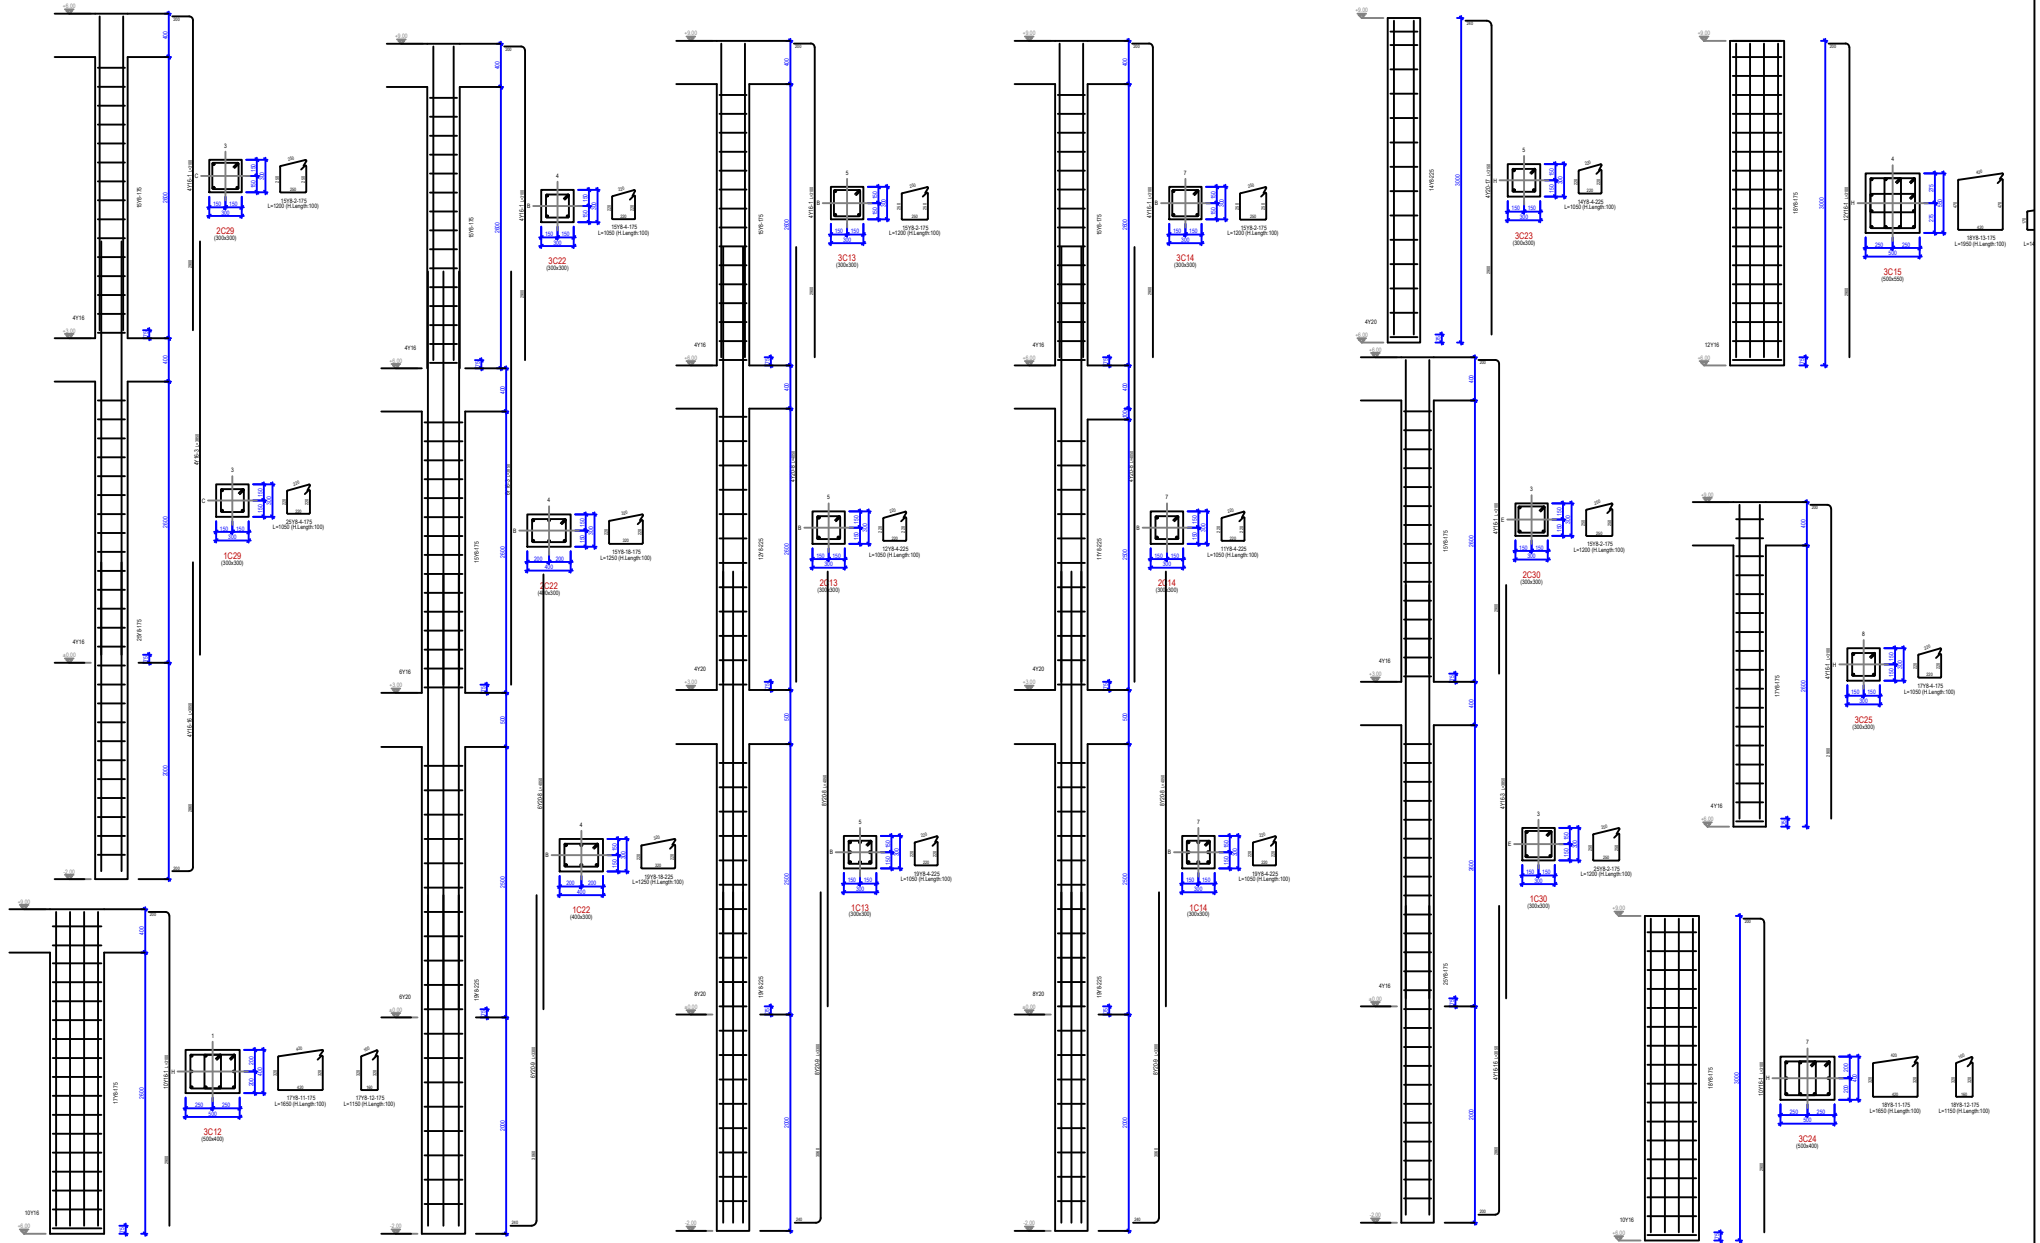

CLIENT: MACHAKOS UNIVERSITY

P.O BOX 136-90100,
MACHAKOS,KENYA.

PROJECT:
PROPOSED POST GRADUATE COMPLEX

SHEET:
COLUMNS ELEV REBAR DETAILS

DESIGN: PATRICK MWANGI

DRAWN: PATRICK MWANGI

CHECKED:

DRAWING NO: S004

DATE
25-05-24

SIGNATURE
p.m






25-05-24

p.m

SCALE: 1 : 20

NOTES

- Reinforcement steel to be high yield round ribbed bars of yield strength 500Nmm²
- All reinforcement shall be inspected by structural engineer/s before concrete casting.
- Concrete cover to foundations to be 50mm, columns 40mm, beams 25mm slabs 20mm and stairs 15mm.
- Concrete to beams, slabs and columns to be class 20 and to foundation class 25

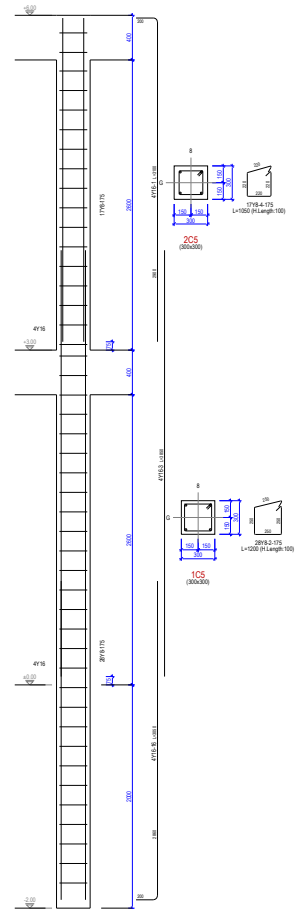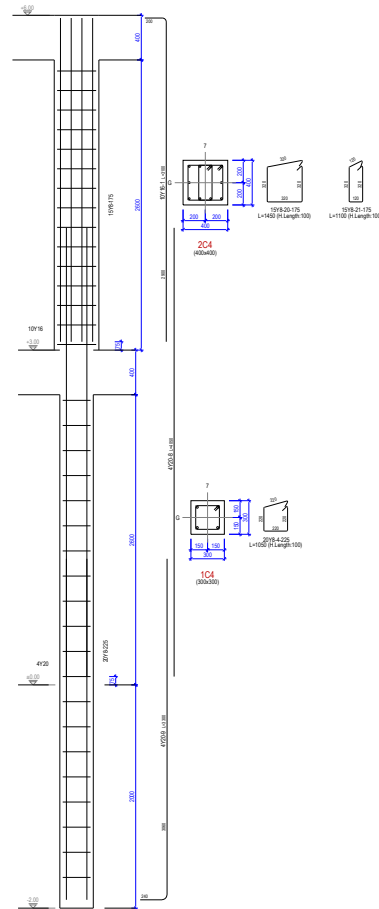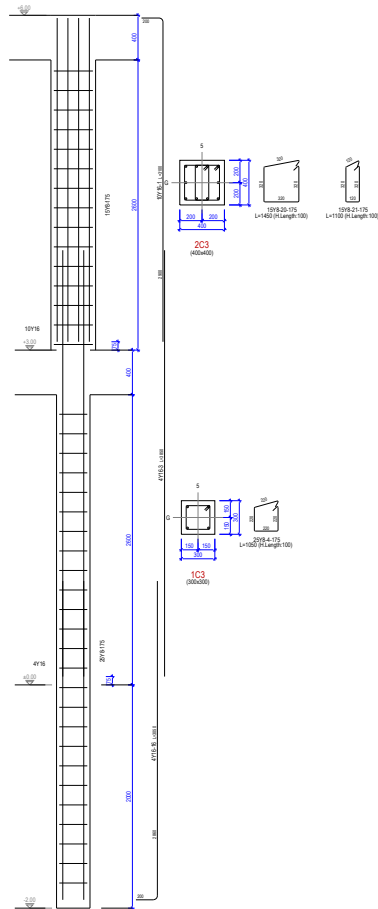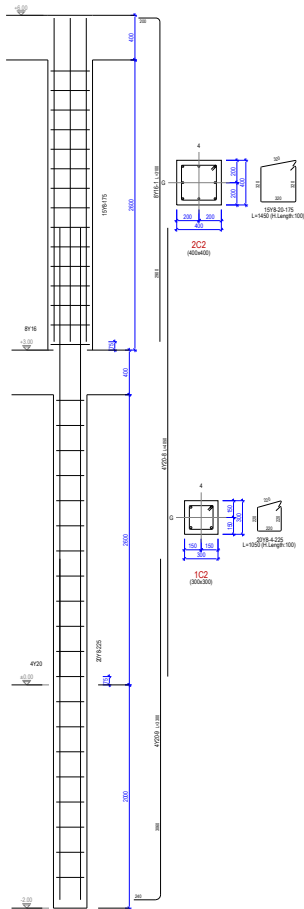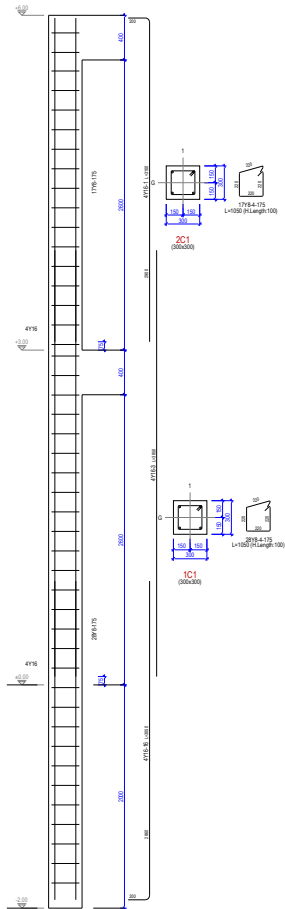

CLIENT: MACHAKOS UNIVERSITY

P.O BOX 136-90100,
MACHAKOS,KENYA.

PROJECT:
PROPOSED POST GRADUATE COMPLEX

SHEET:
COLUMNS ELEV REBAR DETAILS

DESIGN: PATRICK MWANGI

DRAWN: PATRICK MWANGI

CHECKED:

DRAWING NO: S003

DATE

25-05-24

25-05-24

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SCALE: 1 : 20

SIGNATURE


p.m

p.m

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NOTES

- Reinforcement steel to be high yield round ribbed bars of yield strength 500Nmm-2
- All reinforcement shall be inspected by structural engineer/s before concrete casting.
- Concrete cover to foundations to be 50mm, columns 40mm, beams 25mm slabs 20mm and stairs 15mm.
- Concrete to beams, slabs and columns to be class 20 and to foundation class 25

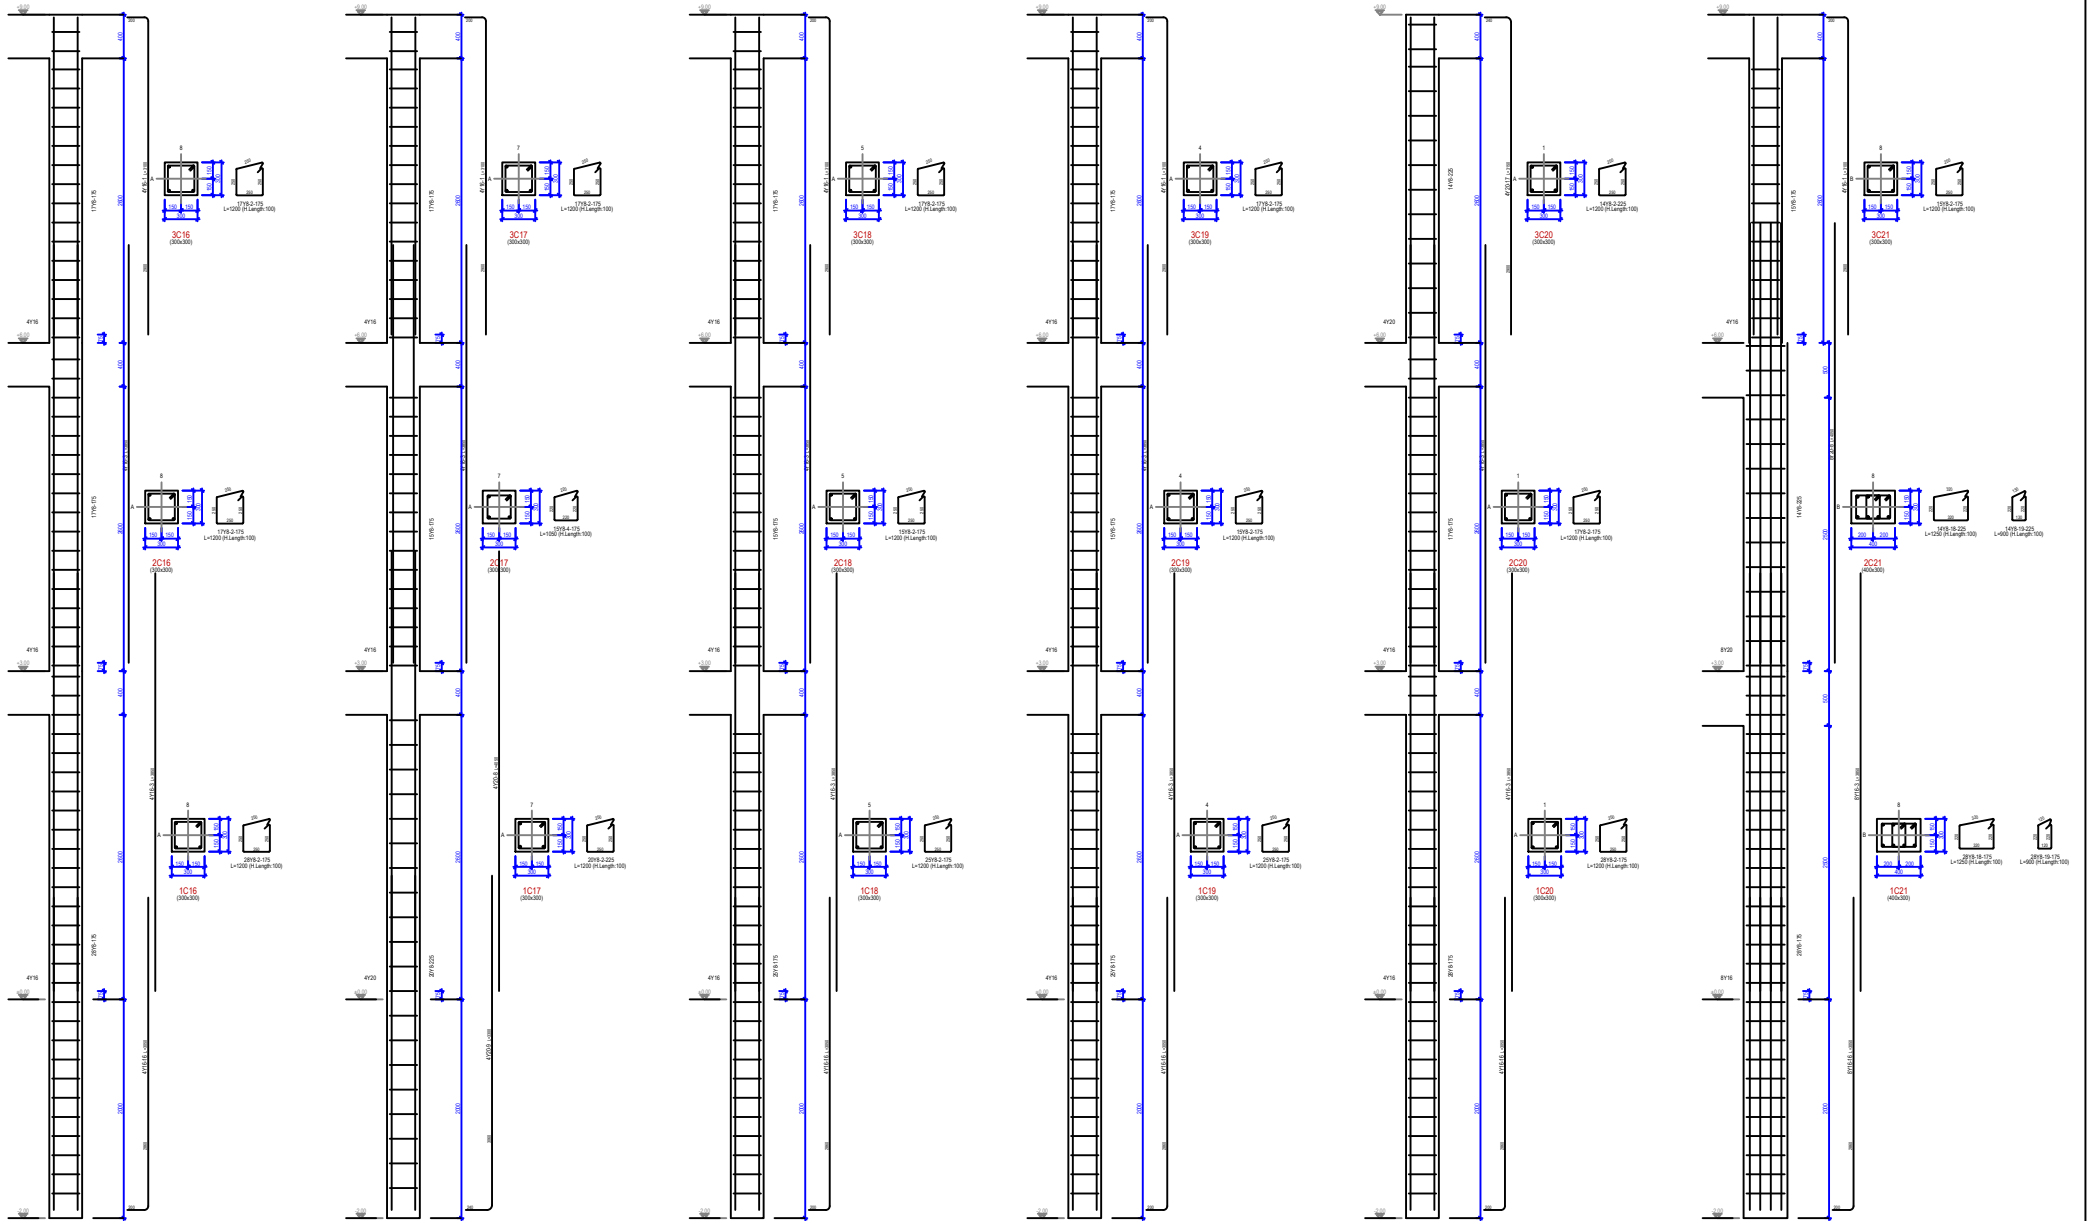

CLIENT: MACHAKOS UNIVERSITY

P.O BOX 136-90100,
MACHAKOS,KENYA.

PROJECT:
PROPOSED POST GRADUATE COMPLEX

SHEET:
COLUMNS ELEV REBAR DETAILS

DESIGN: PATRICK MWANGI

DRAWN: PATRICK MWANGI

CHECKED:

DRAWING NO: S002

DATE

25-05-24

25-05-24

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SCALE: 1 : 20

SIGNATURE


p.m

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NOTES

- Reinforcement steel to be high yield round ribbed bars of yield strength 500Nmm²
- All reinforcement shall be inspected by structural engineer/s before concrete casting.
- Concrete cover to foundations to be 50mm, columns 40mm, beams 25mm slabs 20mm and stairs 15mm.
- Concrete to beams, slabs and columns to be class 20 and to foundation class 25



CLIENT: MACHAKOS UNIVERSITY

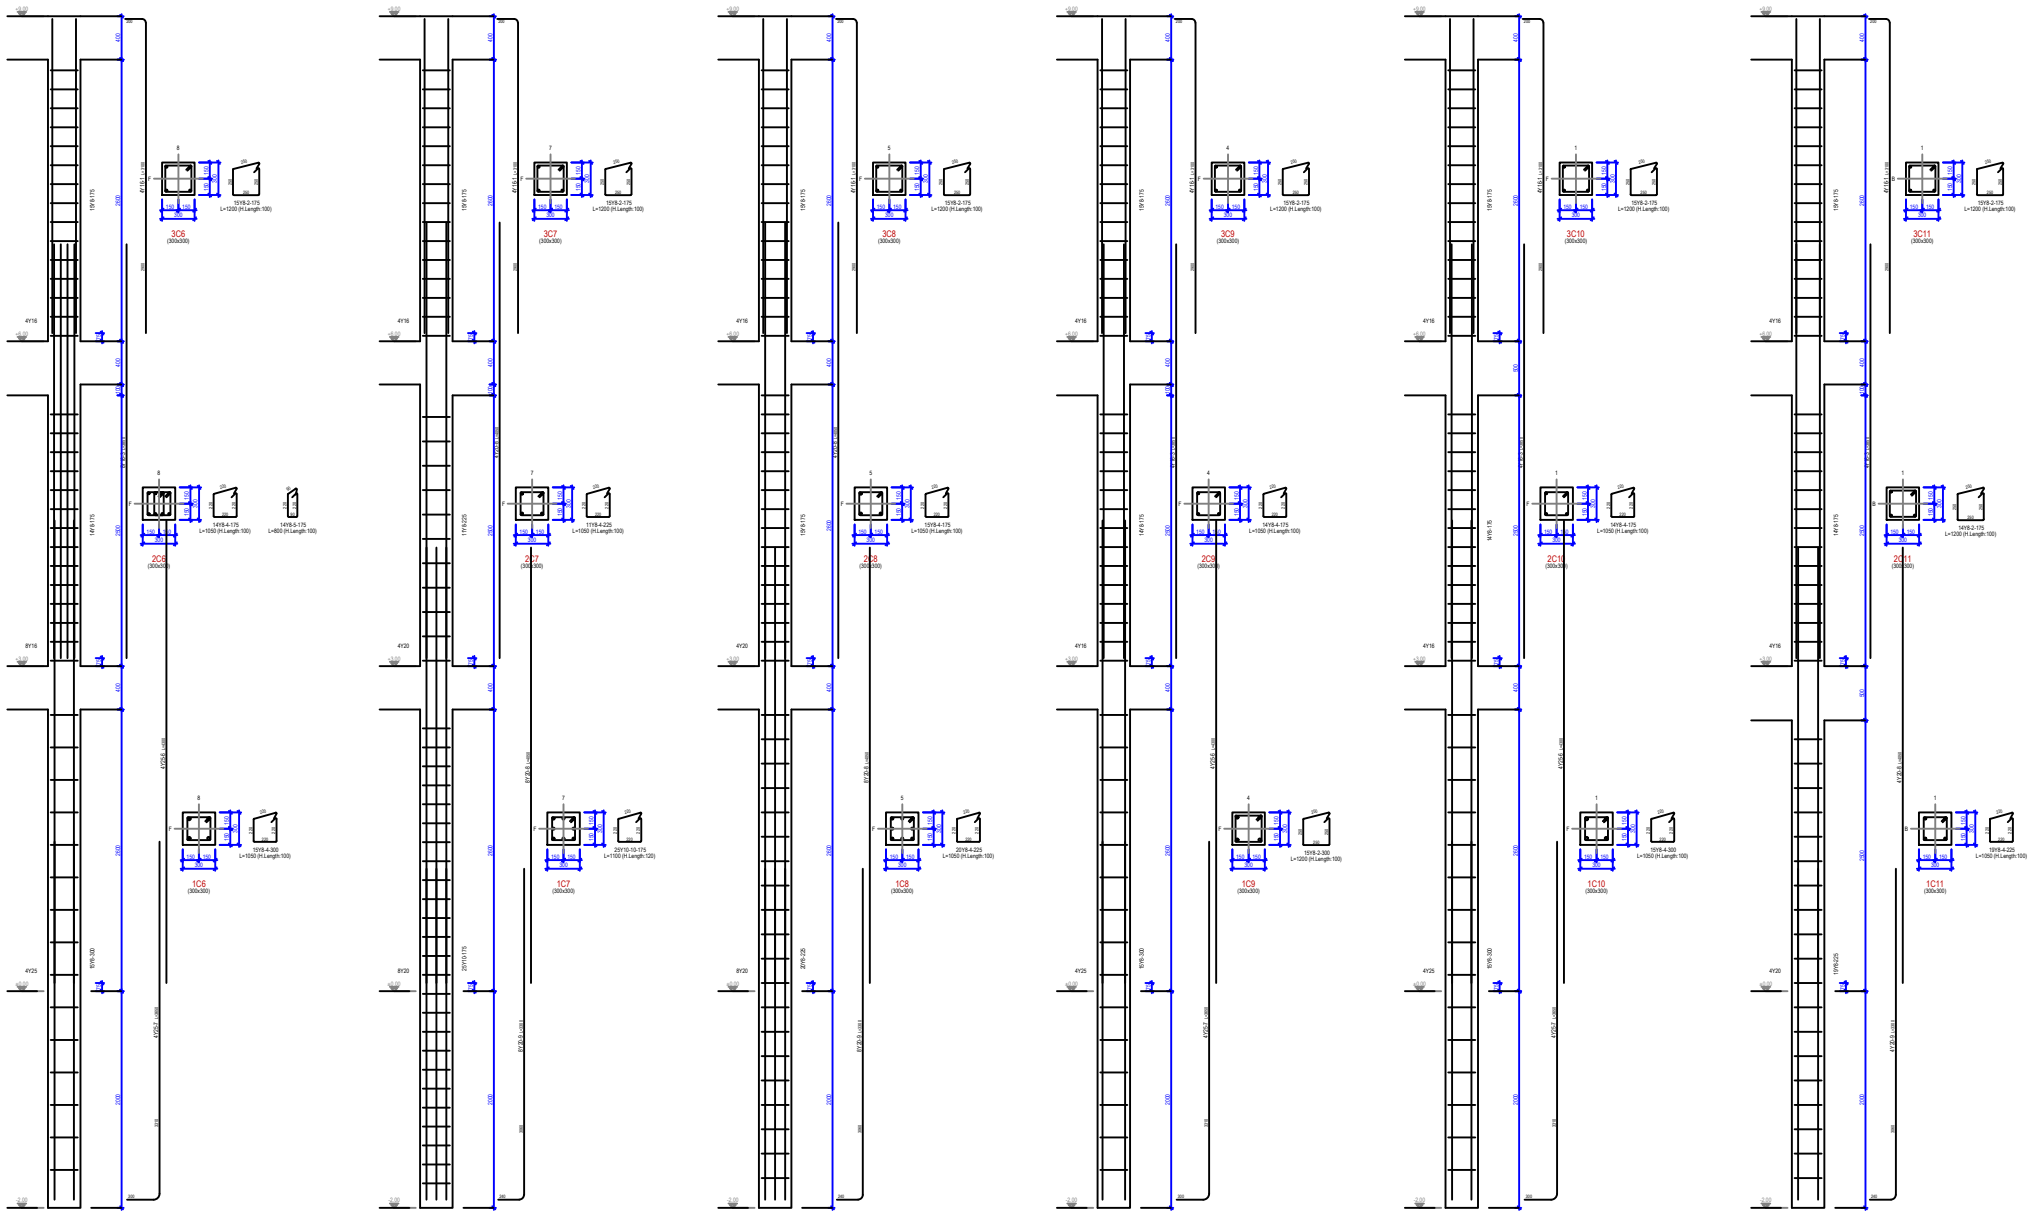P.O BOX 136-90100,
MACHAKOS,KENYA.

PROJECT:
PROPOSED POST GRADUATE COMPLEX

SHEET:
COLUMNS ELEV REBAR DETAILS

DESIGN: PATRICK MWANGI

DRAWN: PATRICK MWANGI

CHECKED:

DRAWING NO: S001

DATE

25-05-24

25-05-24

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SCALE: 1 : 20

SIGNATURE


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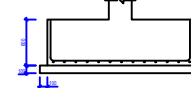
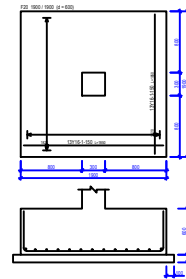
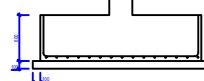
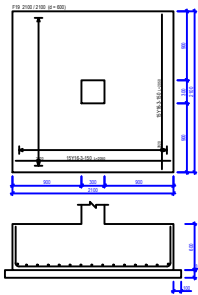
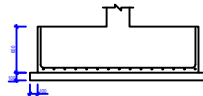
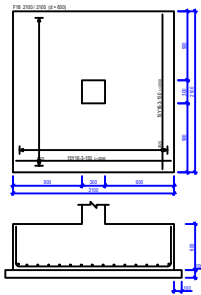
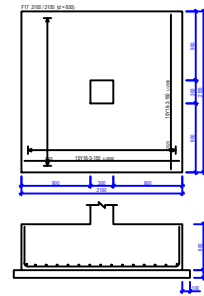
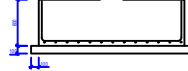
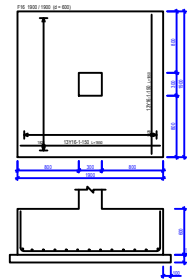
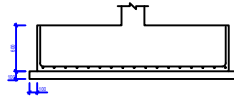
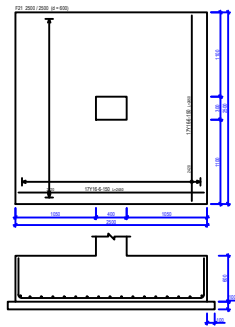
NOTES

- Reinforcement steel to be high yield round ribbed bars of yield strength 500Nmm²
- All reinforcement shall be inspected by structural engineer/s before concrete casting.
- Concrete cover to foundations to be 50mm, columns 40mm, beams 25mm slabs 20mm and stairs 15mm.
- Concrete to beams, slabs and columns to be class 20 and to foundation class 25



M1 Stairs Detail (Scale: 1/35)

CLIENT: MACHAKOS UNIVERSITY P.O BOX 136-90100, MACHAKOS,KENYA.	PROJECT:	DESIGN: PATRICK MWANGI	DATE	SIGNATURE	NOTES - Reinforcement steel to be high yield round ribbed bars of yield strength 500Nmm-2 - All reinforcement shall be inspected by structural engineer/s before concrete casting. - Concrete cover to foundations to be 50mm, columns 40mm, beams 25mm slabs 20mm and stairs 15mm. - Concrete to beams, slabs and columns to be class 20 and to foundation class 25
	PROPOSED POST GRADUATE COMPLEX	DRAWN: PATRICK MWANGI	25-05-24	p.m	
	SHEET:	CHECKED:	25-05-24	p.m	
		STAIRS REBAR DETAILS	
		DRAWING NO: S001	SCALE: 1 : 35		

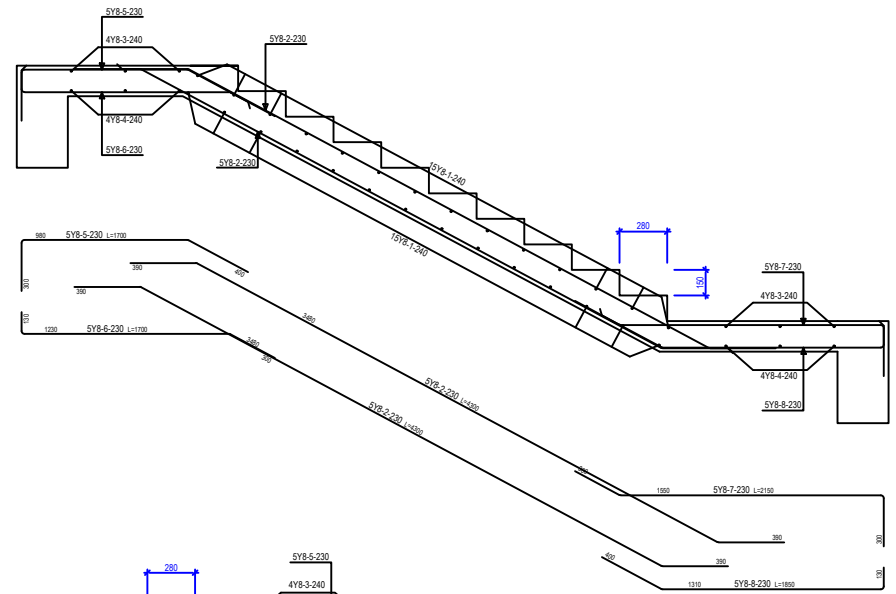

CLIENT: MACHAKOS UNIVERSITY

P.O BOX 136-90100,
MACHAKOS,KENYA.

PROJECT:
PROPOSED POST GRADUATE COMPLEX

SHEET:
FOOTING REBAR DETAILS

DESIGN: PATRICK MWANGI

DRAWN: PATRICK MWANGI

CHECKED:

DRAWING NO: S003

DATE

25-05-24

25-05-24

.....

SCALE: 1 : 20

SIGNATURE


p.m

p.m

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NOTES

- Reinforcement steel to be high yield round ribbed bars of yield strength 500Nmm²
- All reinforcement shall be inspected by structural engineer/s before concrete casting.
- Concrete cover to foundations to be 50mm, columns 40mm, beams 25mm slabs 20mm and stairs 15mm.
- Concrete to beams, slabs and columns to be class 20 and to foundation class 25

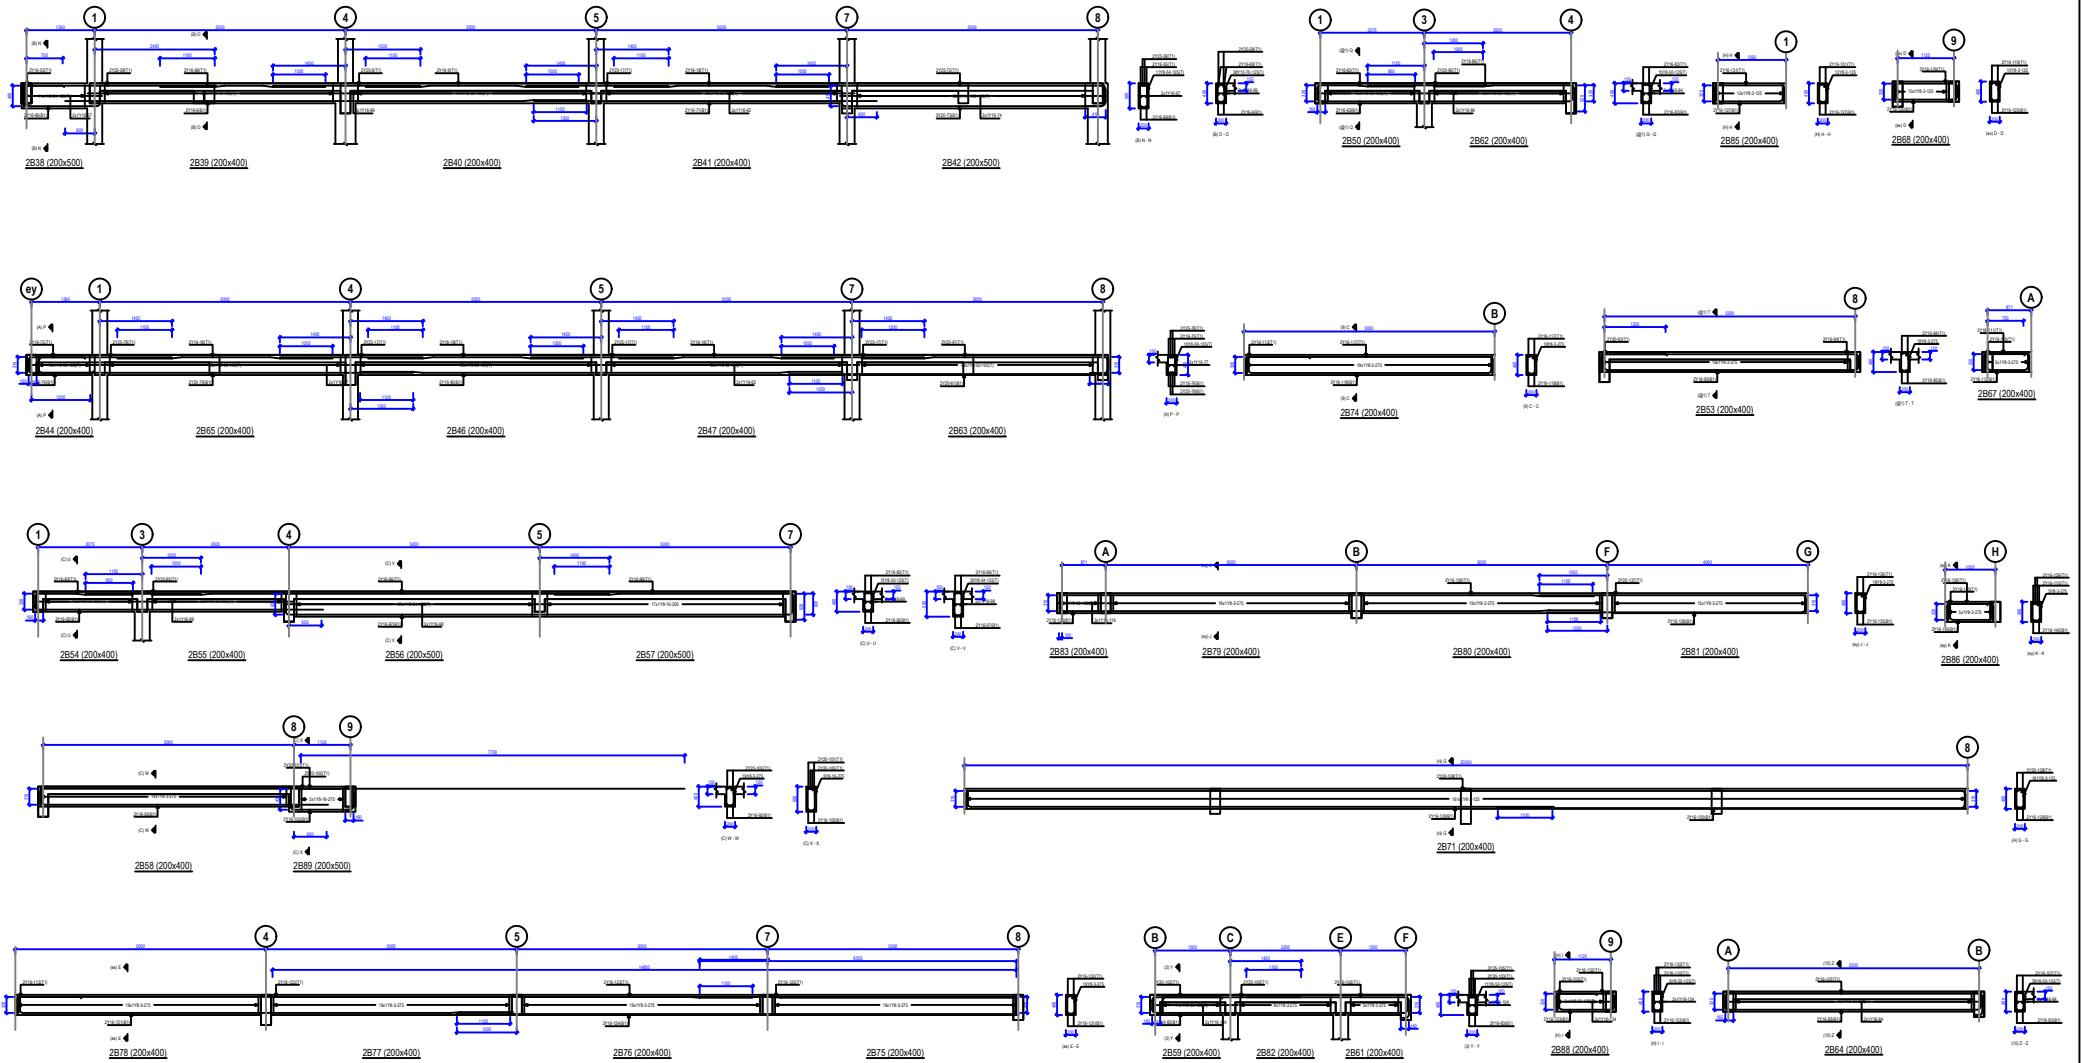

CLIENT: MACHAKOS UNIVERSITY

P.O BOX 136-90100,
MACHAKOS, KENYA.

PROJECT:
PROPOSED POST GRADUATE COMPLEX

SHEET:
BEAMS REBAR DETAILS

DESIGN: PATRICK MWANGI

DRAWN: PATRICK MWANGI

CHECKED:

DRAWING NO: 2 S002

DATE

25-05-24

25-05-24

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SCALE: 1 : 35

SIGNATURE

p.m









p.m

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NOTES

- Reinforcement steel to be high yield round ribbed bars of yield strength 500Nmm²
- All reinforcement shall be inspected by structural engineer/s before concrete casting.
- Concrete cover to foundations to be 50mm, columns 40mm, beams 25mm slabs 20mm and stairs 15mm.
- Concrete to beams, slabs and columns to be class 20 and to foundation class 25



CLIENT: MACHAKOS UNIVERSITY

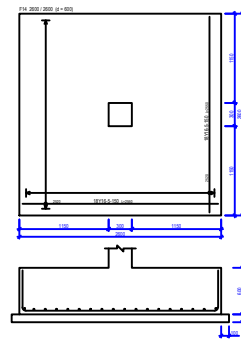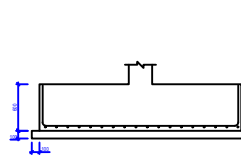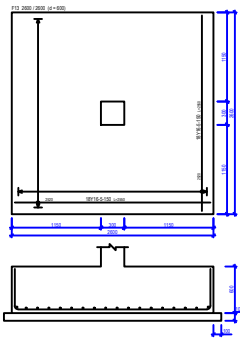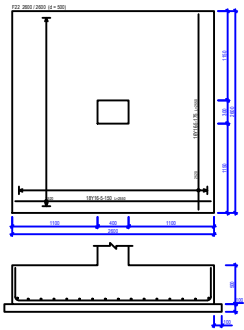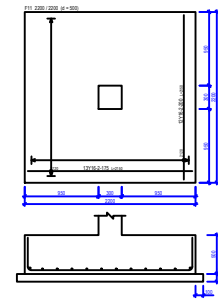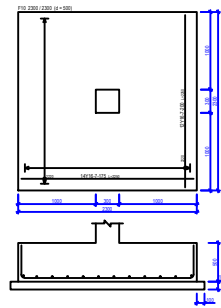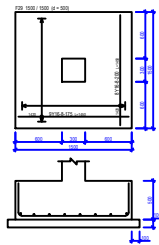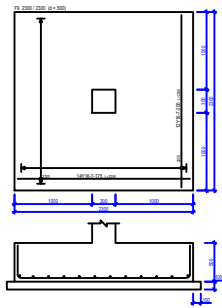P.O BOX 136-90100,
MACHAKOS,KENYA.

PROJECT:
PROPOSED POST GRADUATE COMPLEX

SHEET:
FOOTING REBAR DETAILS

DESIGN: PATRICK MWANGI

DRAWN: PATRICK MWANGI

CHECKED:

DRAWING NO: S002

DATE

25-05-24

25-05-24

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SIGNATURE

p.m

p.m


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SCALE: 1 : 20

NOTES

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CLIENT: MACHAKOS UNIVERSITY P.O BOX 136-90100, MACHAKOS,KENYA.	PROJECT: PROPOSED POST GRADUATE COMPLEX	DESIGN: PATRICK MWANGI	DATE	SIGNATRUE	NOTES - Reinforcement steel to be high yield round ribbed bars of yield strength 500Nmm-2 - All reinforcement shall be inspected by structural engineer/s before concrete casting. - Concrete cover to foundations to be 50mm, columns 40mm, beams 25mm slabs 20mm and stairs 15mm. - Concrete to beams, slabs and columns to be class 20 and to foundation class 25	
			25-05-24	p.m		
	DRAWN: PATRICK MWANGI	25-05-24	p.m			
	CHECKED:			
	DRAWING NO: S001	SCALE: 1 : 20				
SHEET: FOOTING REBAR DETAILS						



CLIENT: MACHAKOS UNIVERSITY

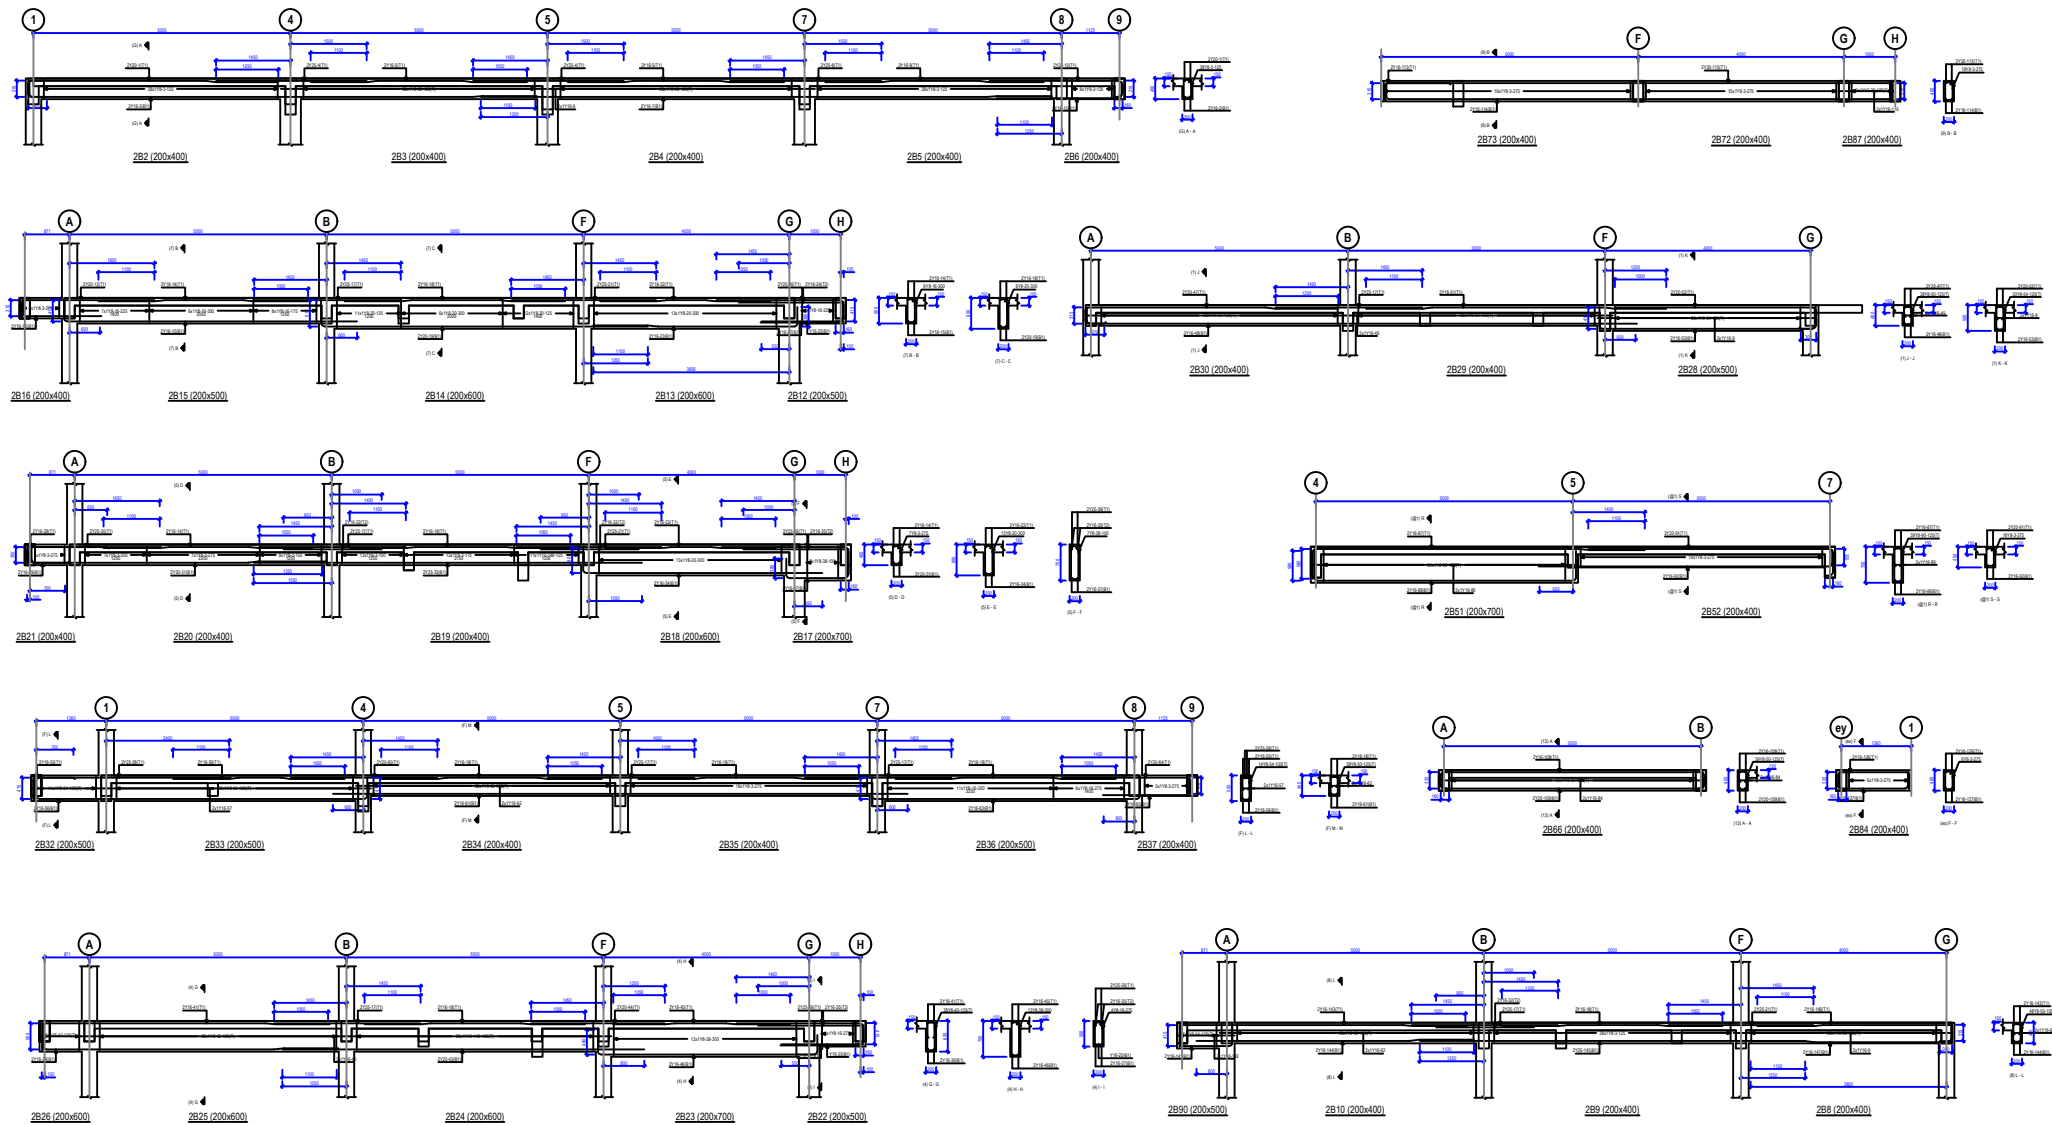P.O BOX 136-90100,
MACHAKOS, KENYA.

PROJECT:
PROPOSED POST GRADUATE COMPLEX

SHEET:
BEAMS REBAR DETAILS

DESIGN: PATRICK MWANGI

DRAWN: PATRICK MWANGI

CHECKED:

DRAWING NO: 2 S001

DATE

25-05-24

25-05-24

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SCALE: 1 : 35

SIGNATURE


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NOTES

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CLIENT: MACHAKOS UNIVERSITY

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MACHAKOS,KENYA.

PROJECT:
PROPOSED POST GRADUATE COMPLEX

SHEET:
BEAMS REBAR DETAILS

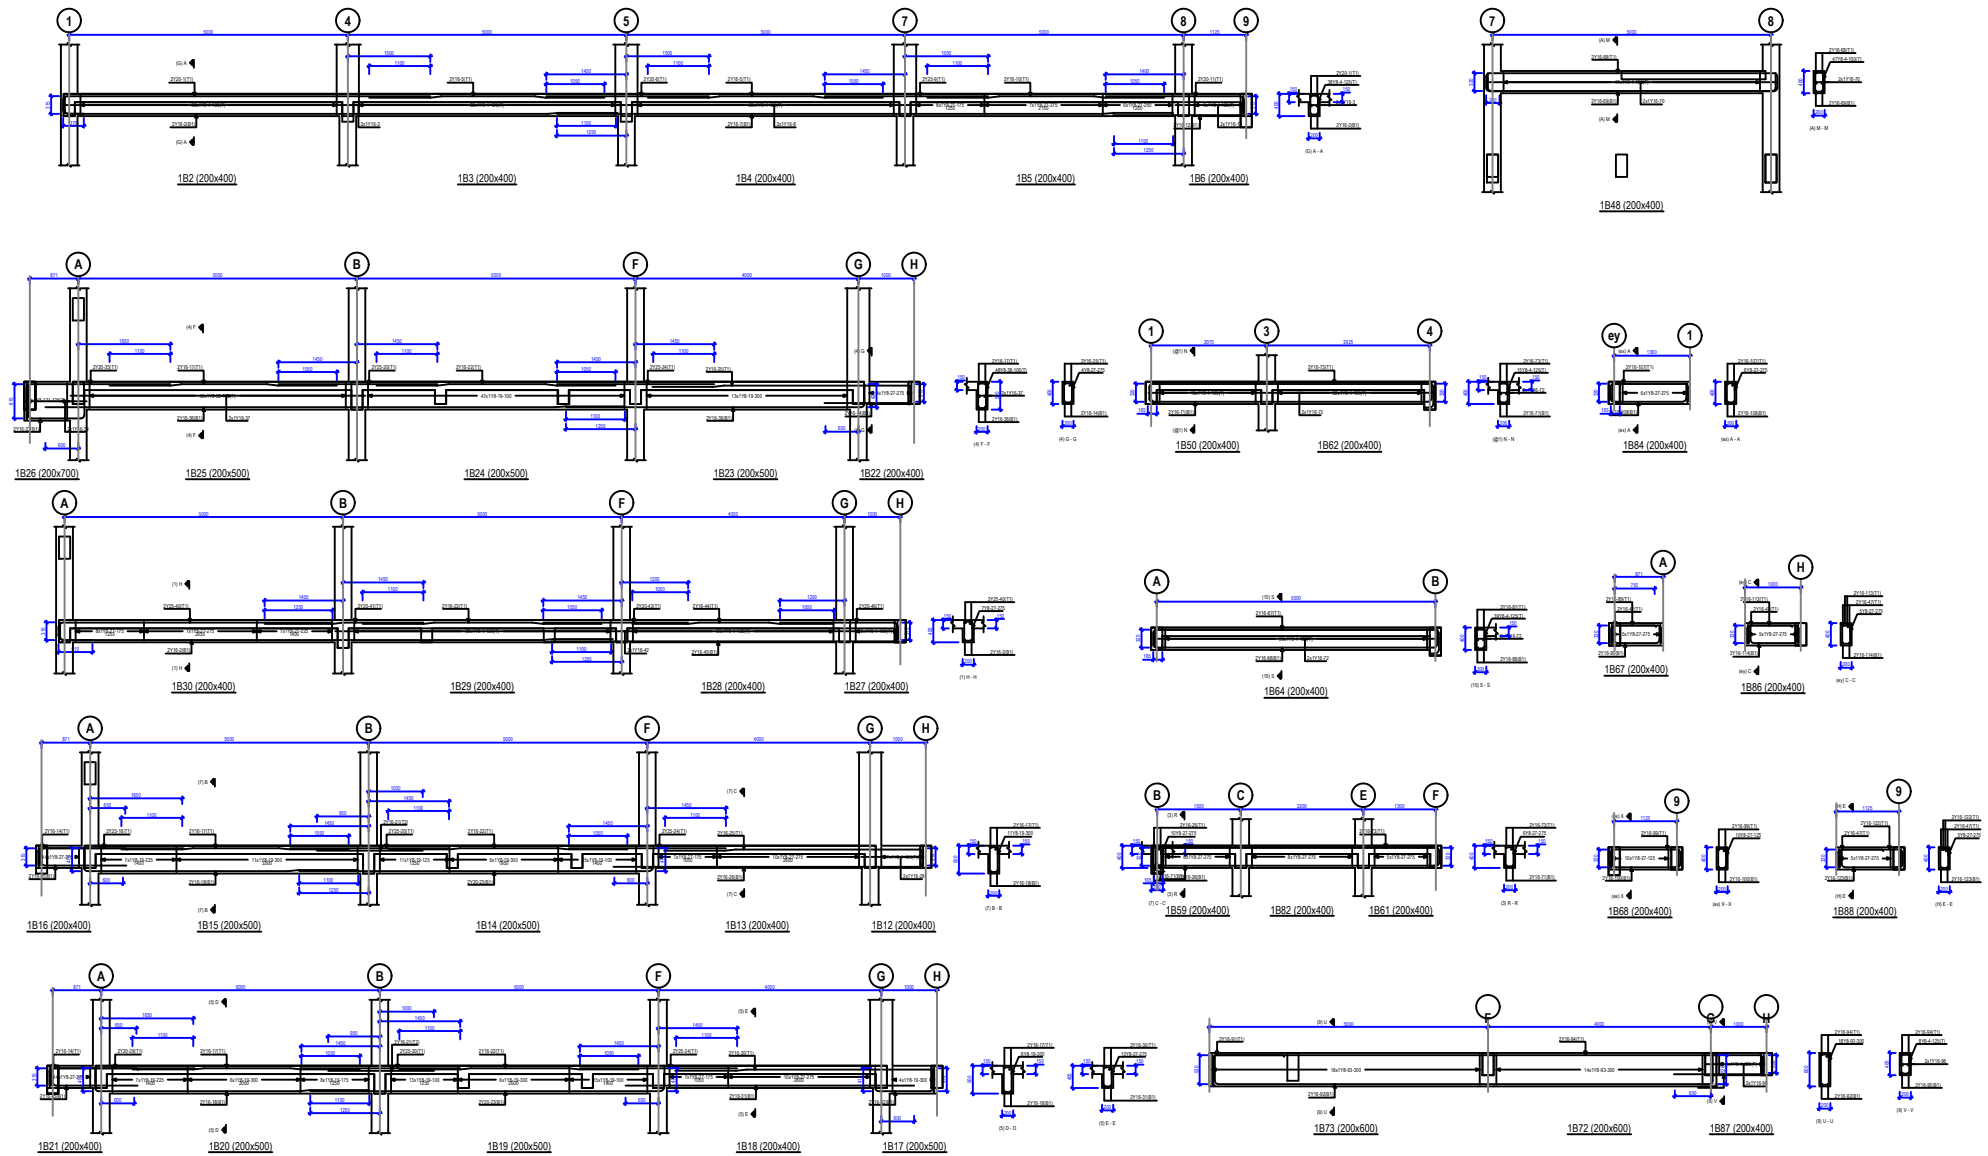DESIGN: PATRICK MWANGI

DRAWN: PATRICK MWANGI

CHECKED:

DRAWING NO: 1 S001

DATE

25-05-24

SIGNATURE

p.m

p.m

SCALE: 1 : 35

NOTES

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