

SAPP STRUCTURAL WAN K. SAMM

NC LICENSE NO. P-2519

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VALLEY, NC


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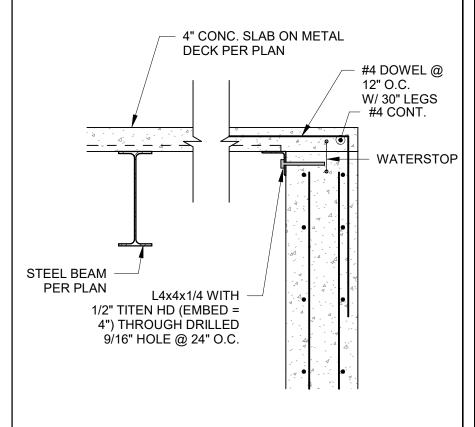
REVISION DESCRIPTION PROJ. NO. 22.046 DRAWN BY RETAINING **WALL PLAN**

ONC. ON 1.0C24 METAL CK W/ 6x6-W2.9xW2.9 W.W.F. 16x26 **GARAGE SLAB FRAMING PLAN**

ELEVATED SLAB NOTES

- 1. THE ELEVATED SLAB AND STEEL FRAMING SUPPORT SHOWN HAS BEEN DESIGNED IN CONFORMANCE WITH 2018 NC BUILDING CODE.
- 2. GRAVITY DESIGN LOADS:
- pD = 10 PSF (SUPERIMPOSED)
- pL = 60 PSF
- 3. ALL FABRICATION AND ERECTION OF STRUCTURAL STEEL FRAMING SHALL CONFORM TO AISC 303.
- 4. STRUCTURAL STEEL MATERIAL:
- W SHAPES = ASTM A992
- L ANGLE = ASTM A36
- 5. WELDING SHALL BE MADE WITH AWS D1.1, E70 WELDING ELECTRODES.
- 6. STEEL NON-COMPOSITE FORM DECKING SHALL BE RIBBEED-STEEL-SHEET FORM-DECK PANELS TO COMPLY WITH SDI SPECIFICATIONS AND COMMENTARY FOR NON-COMPOSITE STEEL FORM DECK IN SDI PUBLICATION NO.
- 31 AND WITH THE FOLLOWING:
- GALVANIZED-STEEL SHEET: ASTM A653, G90 ZINCO COATING
- THICKNESS = 0.0238 INCHES
- YIELD STRENGTH = 60 KSI
- 7. STEEL METAL DECK SHALL BE ATTACHED TO STEEL BEAMS BY WELDS WITH A 33/4 PATTERN AND SIDE LAPS SHALL BE MADE WITH #10 TEK SCREWS @ 24" O.C.
- 8. CONCRETE REINFORCEMENT BARS SHALL BE ASTM A 615, GRADE 60.
- 9. STEEL WELDED-WIRE REINFORCEMENTS SHALL BE ASTM A 1064 WITH 70 KSI MINIMUM YIELD STRENGTH.
- 10. CONCRETE CONSTRUCTION SHALL COMPLY WITH ACI 301 AND ACI 117.
- 11. CONCRETE SHALL BE NORMAL-WEIGHT CONCRETE WITH MIX MEETING THE FOLLOWING CRITERIA:
- 12. MINIMUM 28-DAY COMPRESSIVE STRENGTH = 3000 PSI (CONCRETE ON METAL DECK)
- MAXIMUM COARSE AGGREGATE = 1/2 INCH
- MAXIMUM WATER TO CEMENT RATIO = 0.60
- SLUMP = 5 INCHES (+/-1 INCH)
- AIR CONTENT = 4.5% (+/- 1.5%)
- CEMENT SHALL BE PORTLAND CEMENT ASTM C 150, TYPE II



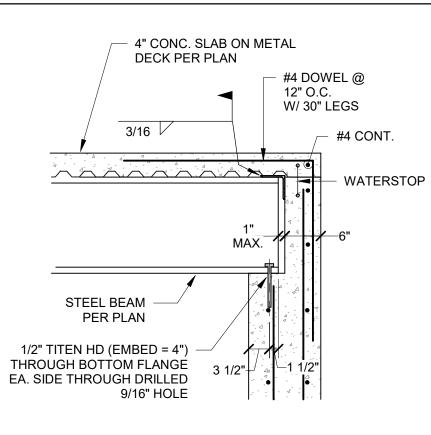

SEAL 053805
NC LICENSE NO. P-2519

1230 ASGI TRAIL
MAGGIE VALLEY, NC

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GARAGE SLAB FRAMING PLAN				
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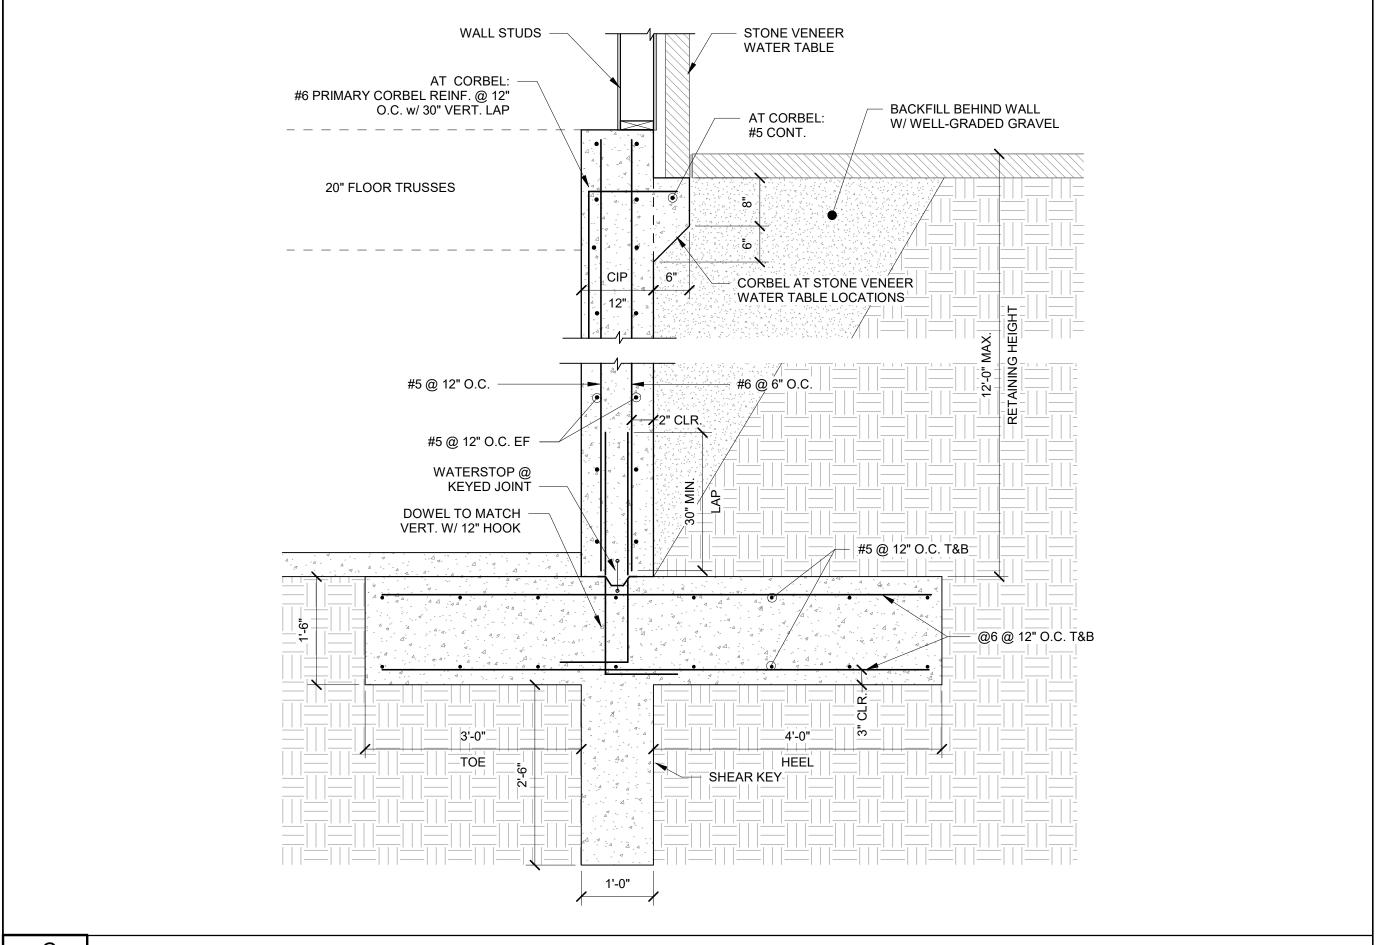
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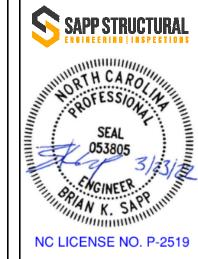
3/4" = 1'-0

BEAM BEARING ON WALL

3/4" = 1'-0"

DECK EDGE AT WALL







1230 ASGI TRAIL
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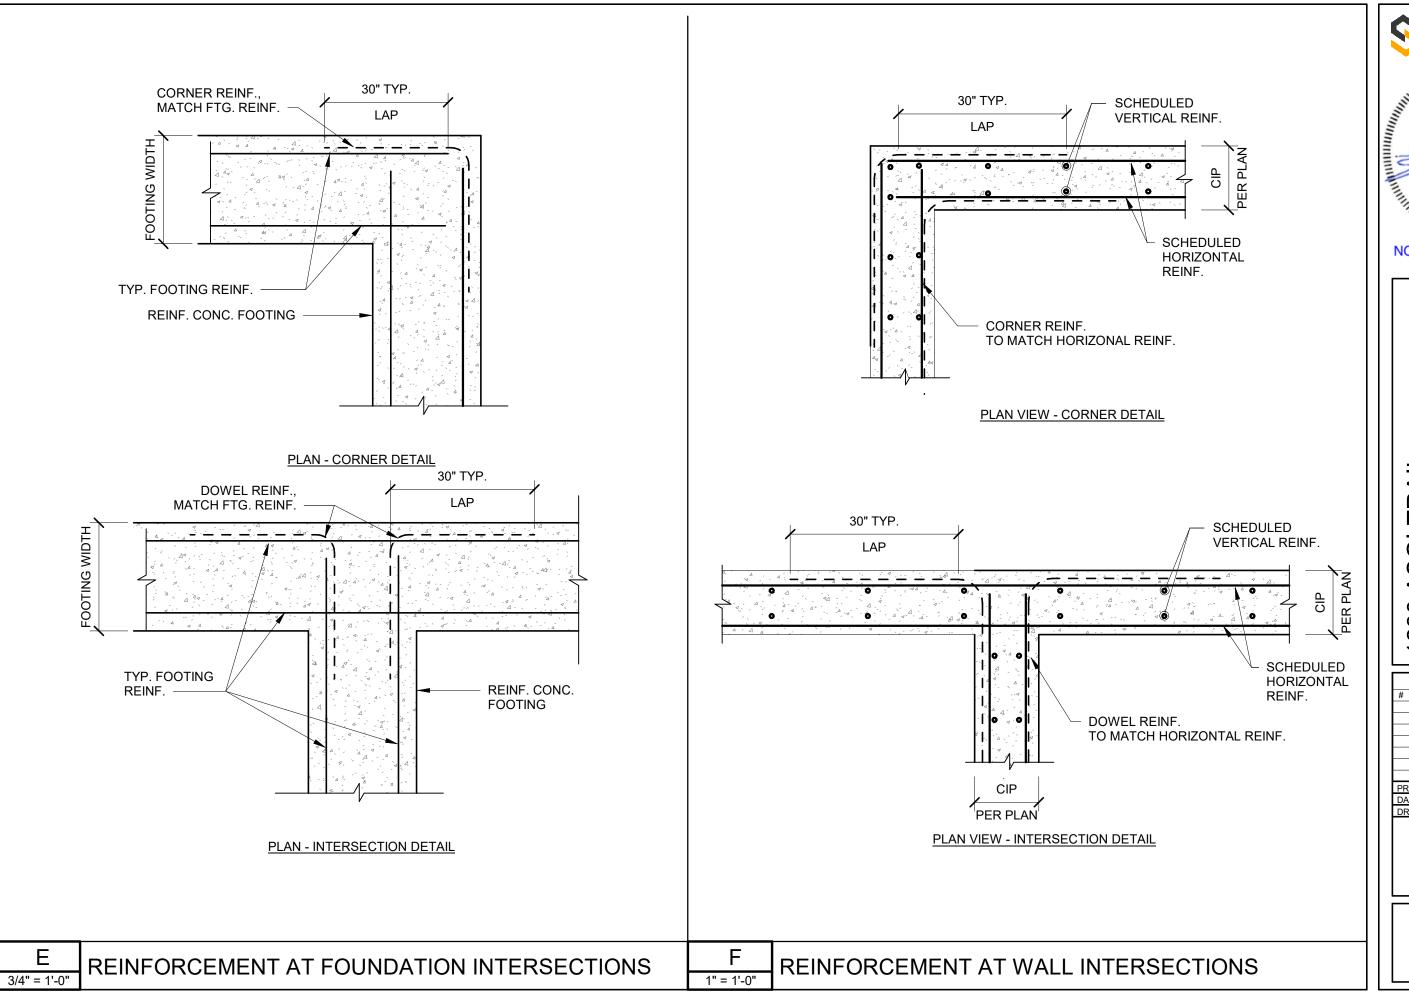
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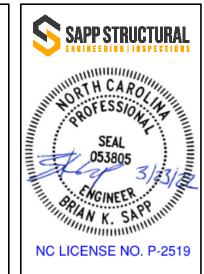
ASGI TRAIL MAGGIE VALLEY, NC 230

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D 3/4" = 1'-0"

GARAGE RETAINING WALL DETAIL




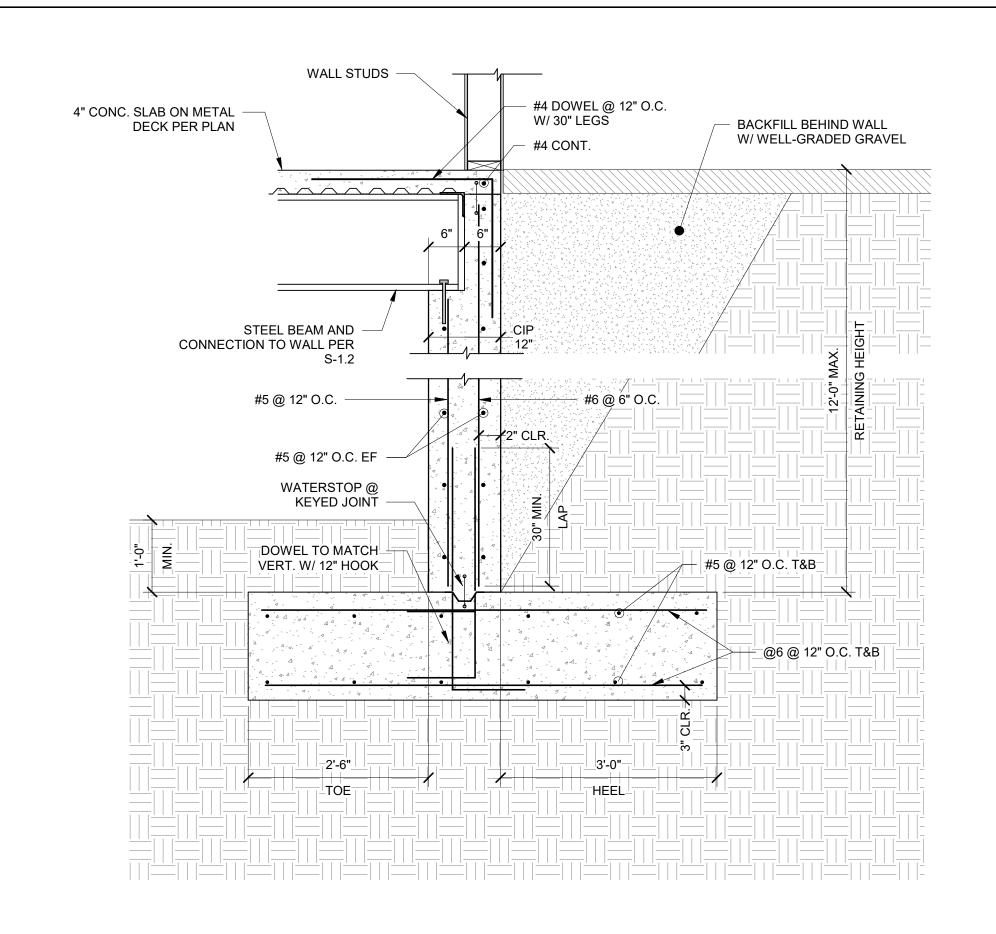

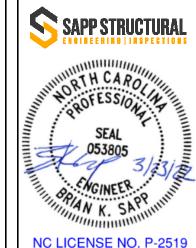

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NC LICENSE NO. P-2519

TRAIL VALLEY, NC ASGI MAGGIE 230

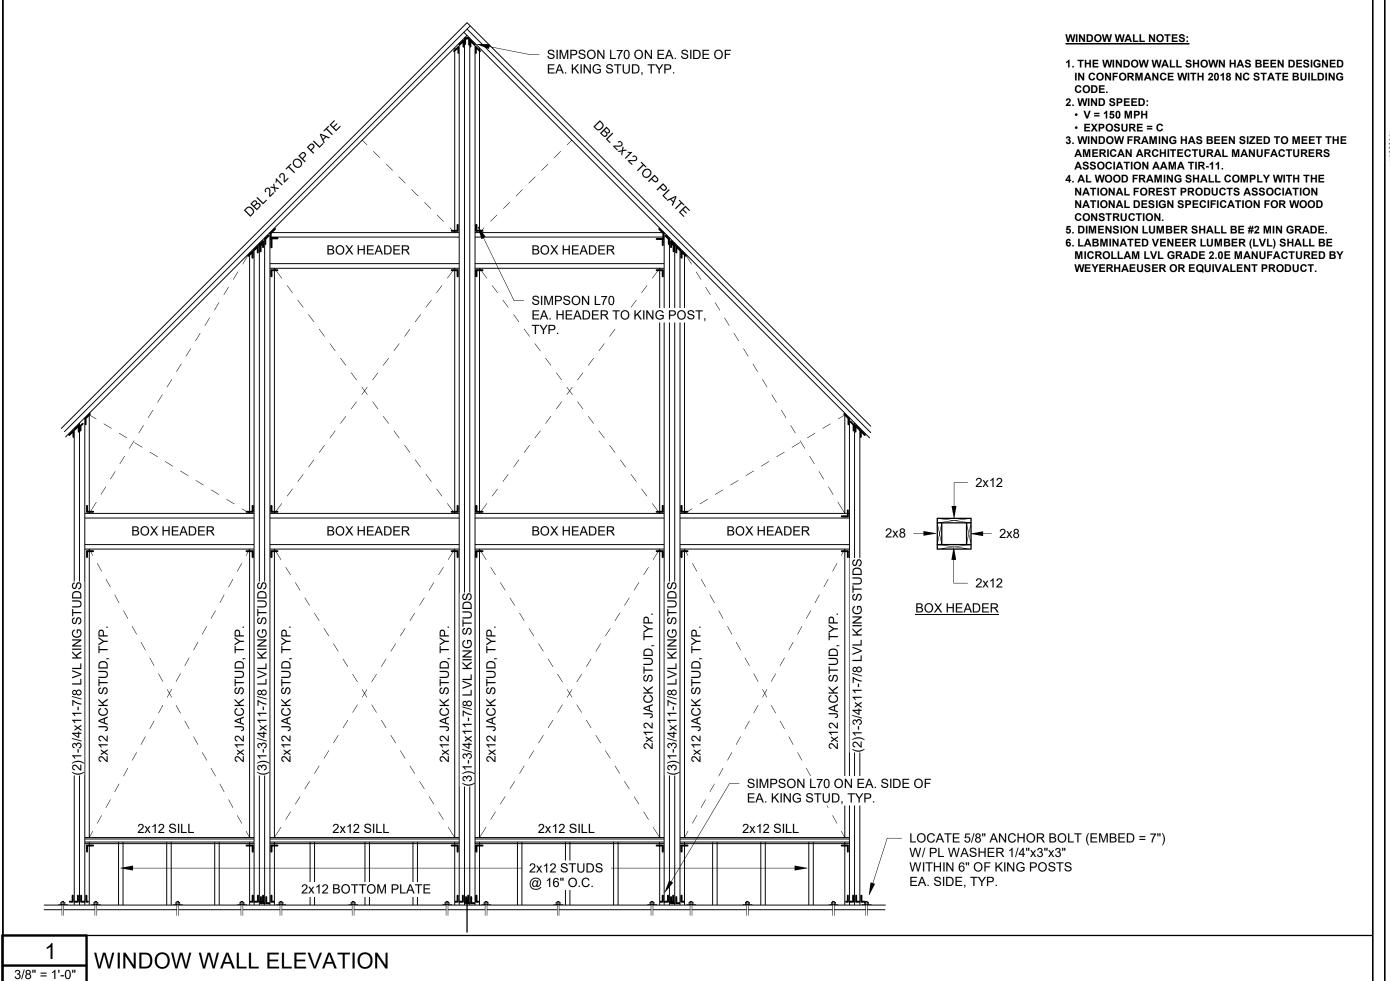REVISION DESCRIPTION PROJ. NO. 22.046 WINDOW WALL **ELEVATION**