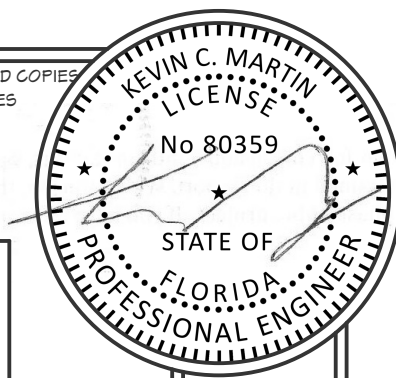


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CONSTRUCTION PLANS
FOR
NEW SINGLE FAMILY
AT
PARCEL ID: 14-03S-12E-10270-003000
167TH ROAD
LIVE OAK, FLORIDA 3206

GENERAL NOTES:

1. IT IS THE INTENT THAT THIS WORK BE IN CONFORMANCE WITH THE 2020 FLORIDA BUILDING CODE, 7TH ED. RESIDENTIAL AND ALL AUTHORITIES HAVING JURISDICTION OVER THIS TYPE OF CONSTRUCTION AND OCCUPANCY. CONTRACTOR SHALL DO THEIR WORK IN CONFORMANCE WITH ALL APPLICABLE CODES AND REGULATIONS.
2. THE CONTRACTOR SHALL VERIFY ALL CONDITIONS AND DIMENSIONS AT THE JOBSITE PRIOR TO COMMENCING WORK. CONTRACTOR SHALL REPORT ALL DISCREPANCIES THE DRAWINGS AND EXISTING CONDITION TO THE ENGINEER PRIOR TO COMMENCING WORK.
3. THESE DOCUMENTS, AS INSTRUMENTS OF SERVICE, ARE THE PROPERTY OF THE ENGINEER AND MAY NOT BE USED OR REPRODUCED WITHOUT EXPRESSED WRITTEN CONSENT OF THE ENGINEER.
4. ALL DETAILS AND SECTIONS SHOWN ON THESE DRAWINGS ARE INTENDED TO BE TYPICAL AND SHALL BE CONSTRUED TO APPLY TO AN SIMILAR SITUATION ELSEWHERE IN THE WORK, EXCEPT WHERE A DIFFERENT DETAIL IS SHOWN.
5. CONTRACTOR WILL INCORPORATE ALL NECESSARY LOCAL/STATE/FEDERAL BUILDING, FIRE, AND HANDICAP CODES INTO THE DESIGN AND BASE PROPOSAL FOR A COMPLETE TURN-KEY PROJECT.
6. PROJECT SHALL BE TURNED OVER TO OWNER IN A CLEAN CONDITION WITH ALL TRASH AND DEBRIS REMOVED FROM SITE. ALL WINDOWS AND GLASS CLEAN, ALL FLOORS CLEAN, ALL HORIZONTAL SURFACES DUSTED AND CLEANED, AND ALL PLUMBING AND TOILET FIXTURES CLEAN AND IN GOOD WORKING ORDER. CONTRACTOR SHALL HAUL ALL RUBBISH FROM SITE ON A REGULAR BASIS. DO NOT ALLOW TO ACCUMULATE.
7. CONTRACTOR TO OBTAIN ALL PERMITS, PAY ALL FEES AND TAXES. CONTRACTOR SHALL GUARANTEE ALL MATERIALS & WORKMANSHIP FREE FROM DEFECTS. FOR A PERIOD OF NOT LESS THAN ONE (1) YEAR FROM THE DATE OF ACCEPTANCE. CORRECTION OF ANY DEFECTS SHALL BE COMPLETED WITHOUT ADDITIONAL CHARGE ION AND SHALL INCLUDE INCLUDE REPLACEMENT OR REPAIR OF ANY OTHER PHASE OF THE INSTALLATION WHICH MAY HAVE BEEN DAMAGED THEREBY.
8. DIMENSIONS INDICATED ON THE DRAWINGS IN REFERENCE TO EXISTING CONDITIONS ARE THE BEST AVAILABLE DATE OBTAINABLE, BUT ARE NOT GUARANTEED. BEFORE PROCEEDING WITH ANY WORK DEPENDENT ON THE DATA INVOLVED, THE CONTRACTOR SHALL FIELD CHECK AND VERIFY ALL DIMENSIONS, GRADES, LINES, LEVELS, OR OTHER CONDITIONS OF LIMITATIONS AT THE SITE TO AVOID CONSTRUCTION ERRORS. IF ANY WORK IS PERFORMED BY THE CONTRACTOR OR ANY OF HIS SUBCONTRACTORS PRIOR TO ADEQUATE VERIFICATION OF APPLICABLE DATA, AT RESULTANT EXTRA COST FOR ADJUSTMENT OR WORK AS REQUIRED TO CONFORM TO EXISTING LIMITATIONS, SHALL BE ASSUMED BY THE CONTRACTOR WITHOUT REIMBURSEMENT OR COMPENSATION BY THE OWNER.
9. A DESIGNATED LOCATION FOR STORAGE OF CONSTRUCTION MATERIAL AND EQUIPMENT SHALL BE DETERMINED BY THE OWNER AND IDENTIFIED AT THE PRE-CONSTRUCTION MEETING.
10. CONTRACTOR PERSONNEL ARE CONFINED TO AREAS OF BUILDING NECESSARY FOR COMPLETION OF WORK. FREE ACCESS TO ALL PARTS OF THE BUILDING IS NOT ALLOWED.
11. CONTRACTOR IS RESPONSIBLE FOR SCHEDULING DELIVERY, RECEIVING, UNLOADING, UNCRATING, SORTING, SETTING IN PLACE, AND PROTECTING FROM DAMAGE ALL NEW EQUIPMENT FURNISHED BY THE CONTRACTOR. THIS SHALL ALSO APPLY TO ITEMS FURNISHED BY THE OWNER TO THE CONTRACTOR.
12. TERMITE PROTECTION SHALL BE PROVIDED BY REGISTERED TERMITICIDES, INCLUDING SOIL APPLIED PESTICIDES, BAITING SYSTEMS, AND PESTICIDES APPLIED TO WOOD, OR OTHER APPROVED METHODS OF TERMITE PROTECTION LABELED FOR USE AS A PREVENTATIVE TREATMENT TO NEW CONSTRUCTION. UPON COMPLETION OF THE APPLICATION OF THE TERMITE PROTECTIVE TREATMENT, A CERTIFICATE OF COMPLIANCE SHALL BE ISSUED TO THE BUILDING DEPARTMENT BY THE LICENSED PEST CONTROL COMPANY THAT CONTAINS THE FOLLOWING STATEMENT: THE BUILDING HAS RECEIVED A COMPLETE TREATMENT FOR THE PREVENTION OF SUBTERRANEAN TERMITES. TREATMENT IS IN ACCORDANCE WITH THE RULES AND LAWS ESTABLISHED BY FLORIDA DEPARTMENT OF AGRICULTURE AND CONSUMER SERVICES.
13. TERMITE PROTECTION TO BE DONE AFTER ALL EXCAVATION, BACKFILLING AND COMPACTION IS COMPLETE. ANY DISTURBED SOIL TREATMENT MUST BE RETREATED.
14. TREATMENT SHALL BE PROTECTED FROM RAINFALL BY 6 MIL VAPOR BARRIER. IF RAINFALL OCCURS BEFORE BARRIER PLACEMENT, SOIL MUST BE RETREATED.
15. PROTECTIVE SLEEVES AROUND METALLIC PIPING PENETRATING CONCRETE SLAB-ON-GRADE FLOORS SHALL BE NON-CELLULOSE CONTAINING MATERIALS AND RECEIVE AN APPLICATION OF TERMITICIDE IN ANNULAR SPACE BETWEEN SLEEVE AND PIPE.

ELECTRICAL NOTES:

1. ALL ELECTRICAL WIRING TO BE IN ACCORDANCE WITH 2020 FLORIDA BUILDING CODE, TTH EDITION, RESIDENTIAL AND 2018 NATIONAL ELECTRIC CODE (NEC).
2. ALL SMOKE DETECTORS AND CARBON MONOXIDE DETECTORS SHALL BE IN ACCORDANCE WITH THE 2020 FLORIDA BUILDING CODE, TTH EDITION.
3. ELECTRICAL CONTRACTOR SHALL PROVIDE ARC-FAULT CIRCUIT INTERRUPTERS IN LIVING, DINING, HALLWAYS, AND BEDROOMS PER 2020 FBC R3402.12
4. ALL OUTDOOR RECEPTACLES SHALL BE PROTECTED FROM MOISTURE PER 2017 FBC R3405.11
5. ALL PERMANENTLY INSTALLED LIGHTING FIXTURES SHALL COMPLY WITH THE MINIMUM REQUIREMENTS PER FBC-ENERGY CONSERVATION R404.
6. ELEVATORS SHALL BE IN ACCORDANCE WITH FBC 2020, TTH ED, SECTION R321.1

MECHANICAL NOTES:

1. ALL DUCT SIZING SHALL BE IN ACCORDANCE W/ ACCA MANUAL "D". PROVIDE DUCT TESTING IN ACCORDANCE W/ ASHRAE STANDARD 152.
2. DUCT LAYOUT AND ALL OTHER MECHANICAL COMPONENTS ARE SHOWN ON THE APPROVED DUCT LAYOUT PLAN INCLUDED IN THE ENERGY CALCULATION PACKAGE PERFORMED BY OTHERS.
3. ALL DUCTS & AIR HANDLERS NOT LOCATED IN CONDITIONED SPACE SHALL BE TESTED TO BE "SUBSTANTIALLY" LEAK FREE.
4. DUCTS IN GARAGE AND DUCTS PENETRATING THE WALLS OR CEILINGS SEPARATING THE DWELLING FROM THE GARAGE SHALL BE INSTALLED ACCORDING TO FBC R302.5.2
5. ALL INSULATION SPECIFICATIONS ARE INCLUDED IN THE ENERGY CALCULATION PACKAGE PERFORMED BY OTHERS. IF ANY INSTALLED INSULATION MATERIALS DO NOT MATCH THE ENERGY FORMS, NEW CALCULATIONS SHALL BE PERFORMED OR THE ORIGINAL APPROVED INSULATIONS SHALL BE INSTALLED.
6. ELEVATORS SHALL BE IN ACCORDANCE WITH THE FBC 2020, 7TH ED., SECTION R321.1

PLUMBING NOTES:

1. ALL WORK SHALL BE PERFORMED BY A LICENSED PLUMBING CONTRACTOR IN A FIRST-CLASS WORKMANLIKE MANNER. THE COMPLETE SYSTEM SHALL BE FULLY OPERATIVE.
2. ALL EXCAVATION & BACK FILL AS REQUIRED FOR THIS PHASE OF CONSTRUCTION SHALL BE A PART OF THIS CONTRACT,
3. ALL WORK SHALL BE COORDINATED WITH OTHER TRADES TO AVOID INTERFERENCE WITH THE PROCESS OF CONSTRUCTION.
4. VERIFY LOCATION, SIZE, TRAPS, INVERTS OF ALL EXISTING UTILITIES PRIOR TO BEGINNING CONSTRUCTION. ADVISE ENGINEER OF ANY DISCREPANCIES. ANY COST RESULTING FROM DISCREPANCIES NOT REPORTED AT THIS TIME SHALL BE PAID BY THE CONTRACTOR.
5. WATER PIPING TO BE TYPE "M" OR TYPE "L" COPPER ABOVE OR BELOW GRADE.
6. SOIL, WASTE & VENT PIPING TO BE PVC. #40 DVM.
7. ALL FIXTURES MUST BE PROVIDED WITH READILY ACCESSIBLE STOPS
8. WHERE DISSIMILAR METALS ARE TO BE JOINED, APPROVED INSULATING UNIONS SHALL BE USED.
9. INSULATE HOT WATER LINES WITH 1" THICK SNAP ON INSULATION FIRST 8 FEET FROM WATER HEATER.
10. CONDENSATE LINES TO BE COPPER/PVC DEPENDING ON PROJECT REQUIREMENTS.
11. INSULATE WITH 1/2" THICK ARMAFLEX INSULATION.


BUILDING STRUCTURE INFORMATION:

1st FLOOR CONDITIONED.....1,232 S.F.
TOTAL CONDITIONED: 1,232 S.F.

TOTAL SPACE.....1,232 S.F.
TOTAL COND. VOLUME.....9,856 CU.FT.
TYPE OF CONSTRUCTION.....5B
OCCUPANCY.....R-3
FIRE SPRINKLERS.....NO
MAX HEIGHT OF STRUCTURE.....<35'

| PLAN SHEETS | |
|-------------|-------------------------|
| Label | Title |
| A-0 | GENERAL NOTES |
| A-1 | ELEVATIONS |
| A-2 | ELEVATIONS |
| A-3 | FLOOR PLAN & SECTION |
| A-4 | ROOF PLAN |
| A-5 | ELECTRICAL LAYOUT |
| A-6 | PLUMBING/FIXTURE LAYOUT |
| A-7 | FLASHING DETAILS |
| A-8 | FLASHING DETAILS |
| S-1 - S-3 | STRUCTURAL PLANS |

GENERAL NOTES
NEW SINGLE FAMILY
16THH ROAD-(14-035-12E-10270-003000)
LIVE OAK, FLORIDA 32060



MARTIN ENGINEERING, LLC.
450 STATE RD. N #106-337
JACKSONVILLE, FL 32259
904-472-1459
FL CA#32027

PROJ.#: 22-880

DESIGNED:KCM

DRAWN: KCM



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DATE:12/2/2022

SHEET NUMBER

A-0

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FRONT ELEVATION

SCALE: 3/16" = 1'-0"

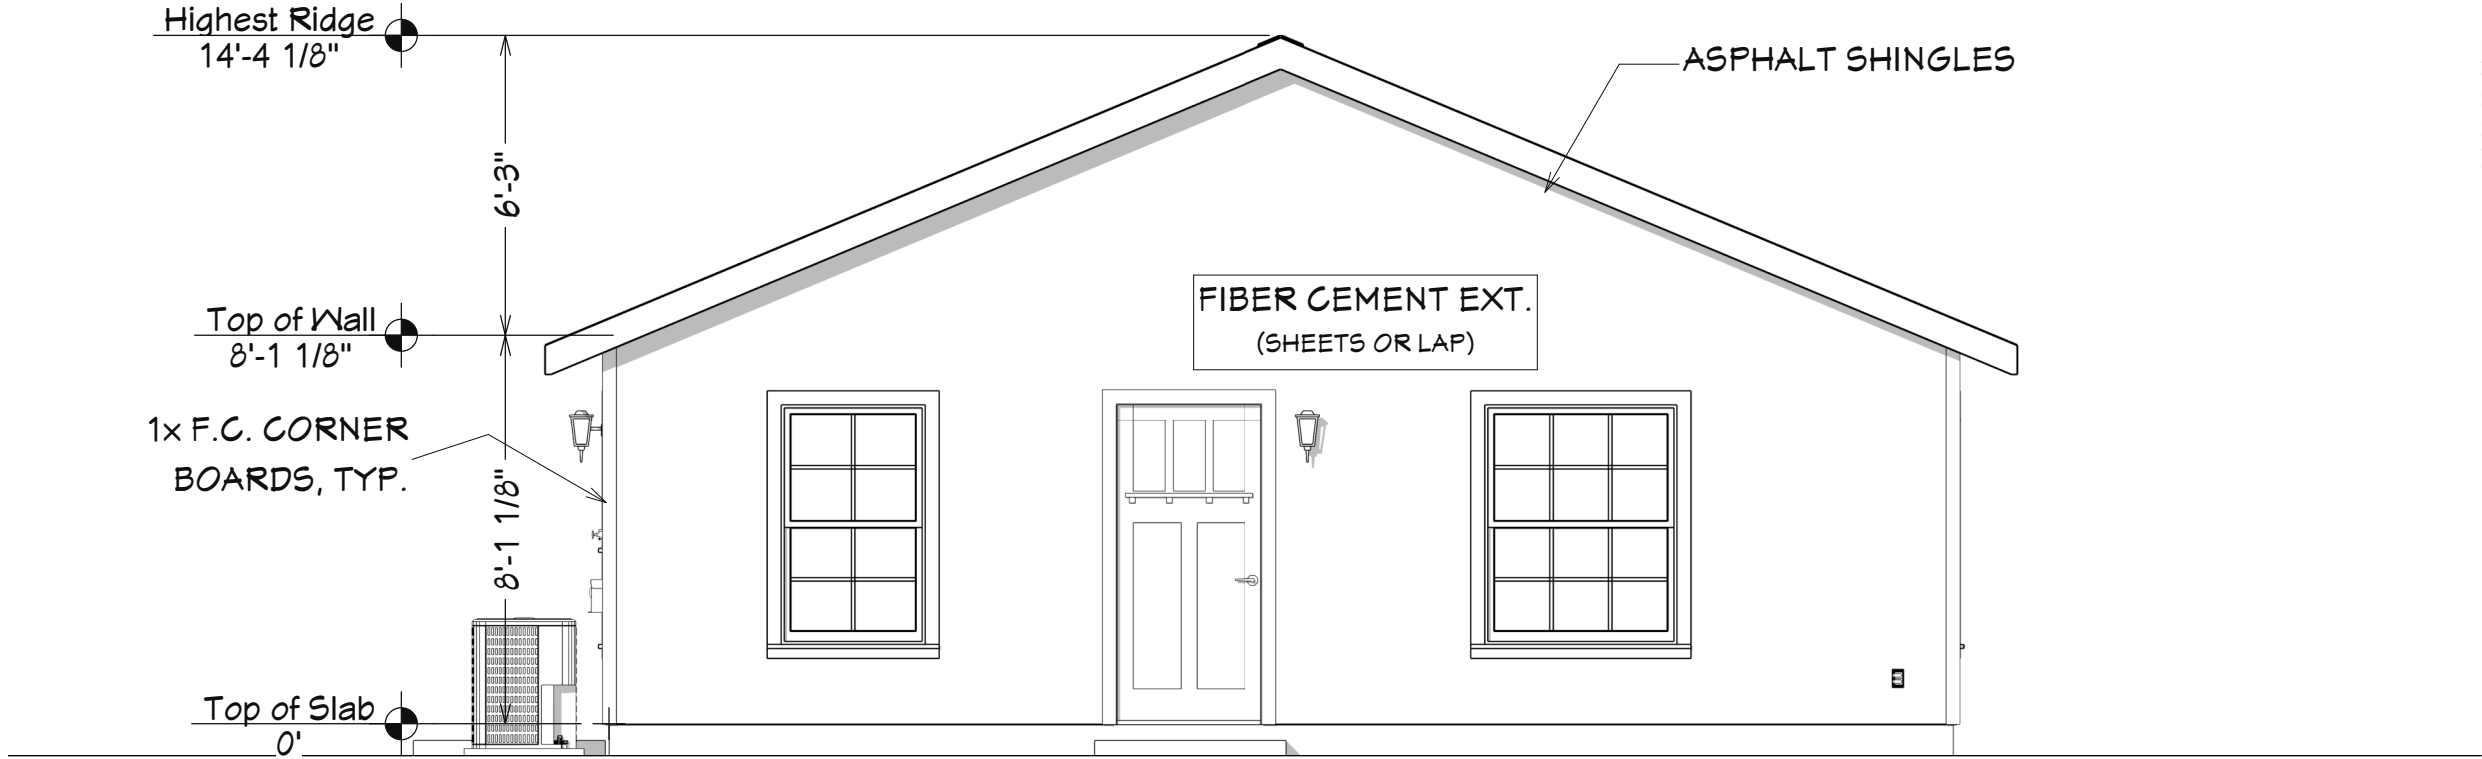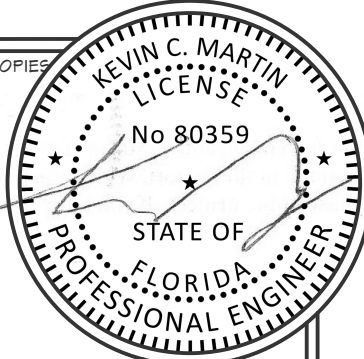

LEFT ELEVATION

SCALE: 3/16" = 1'-0"



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ELEVATIONS
NEW SINGLE FAMILY
16TH ROAD-(14-035-12E-10270-003000)
LIVE OAK, FLORIDA 32060

MARTIN ENGINEERING, LLC.
450 STATE RD. N #106-387
JACKSONVILLE, FL 32259
904-472-1459
FL CA#32027


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REAR ELEVATION

SCALE: 1/4" = 1'-0"

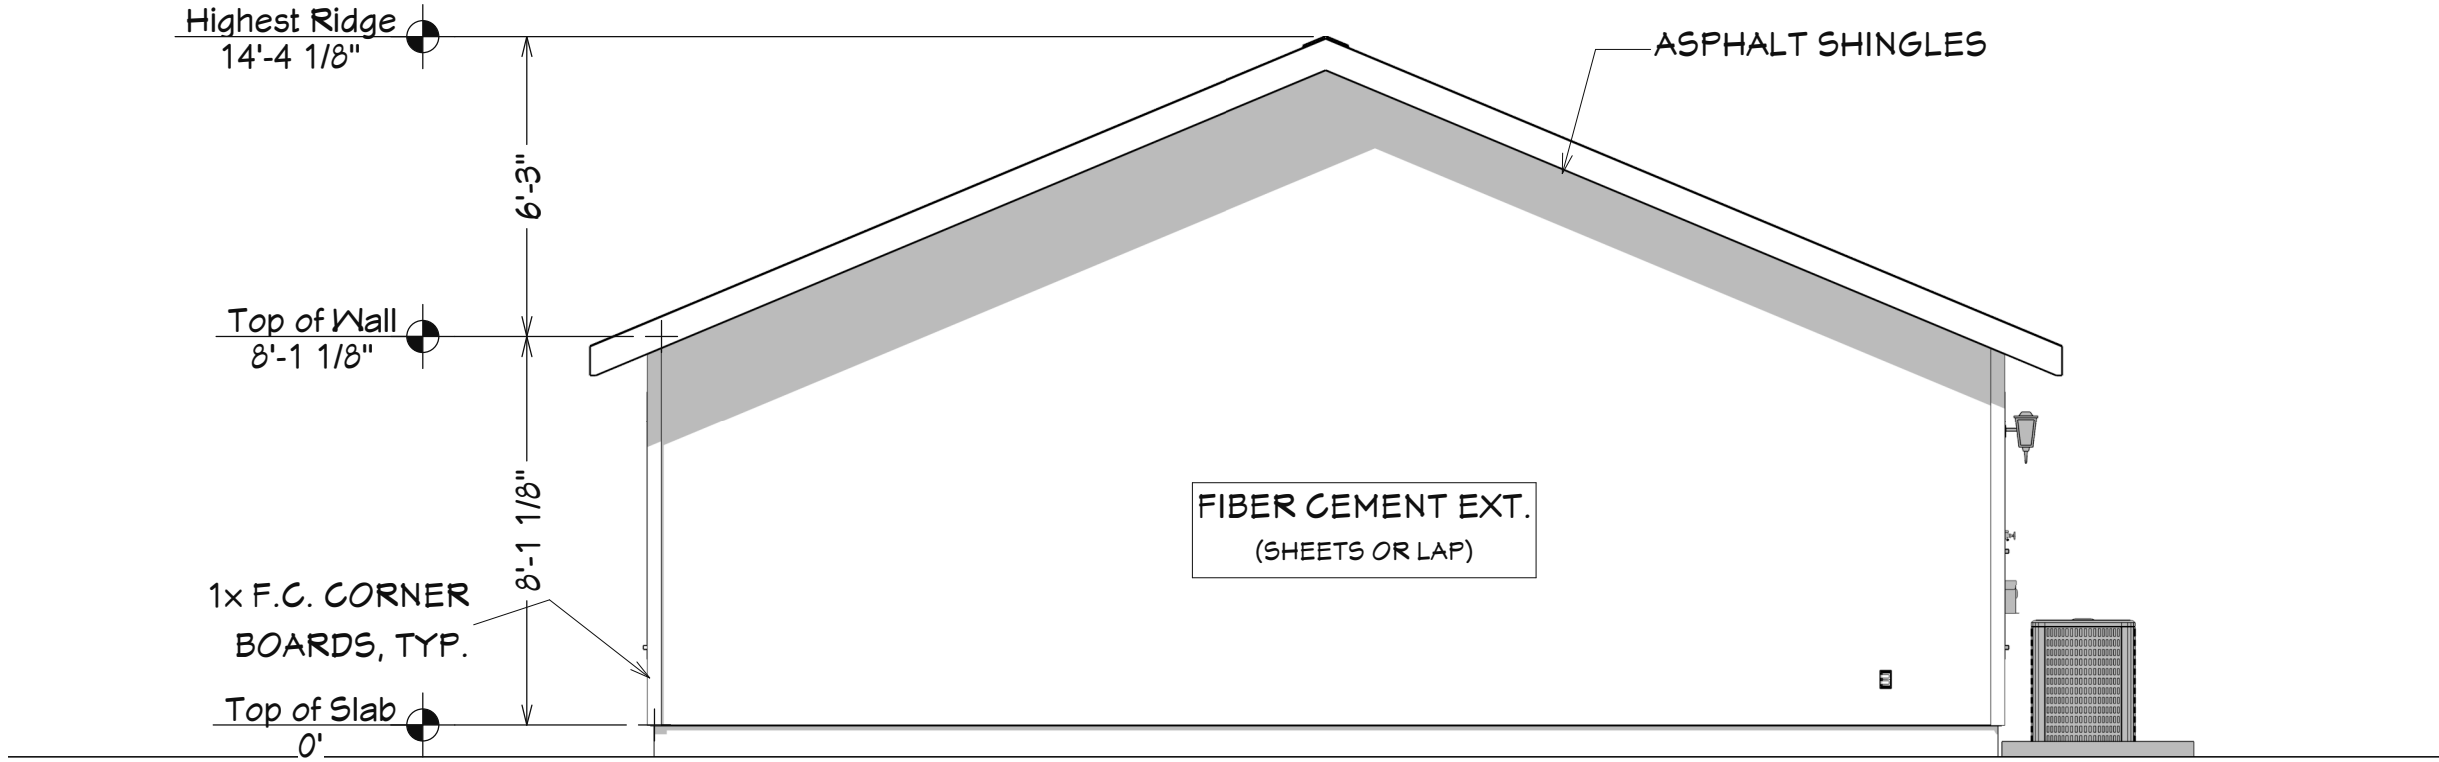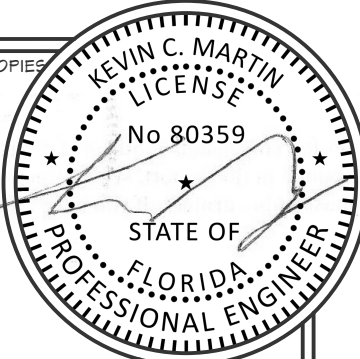

RIGHT ELEVATION



SCALE: 3/16" = 1'-0"
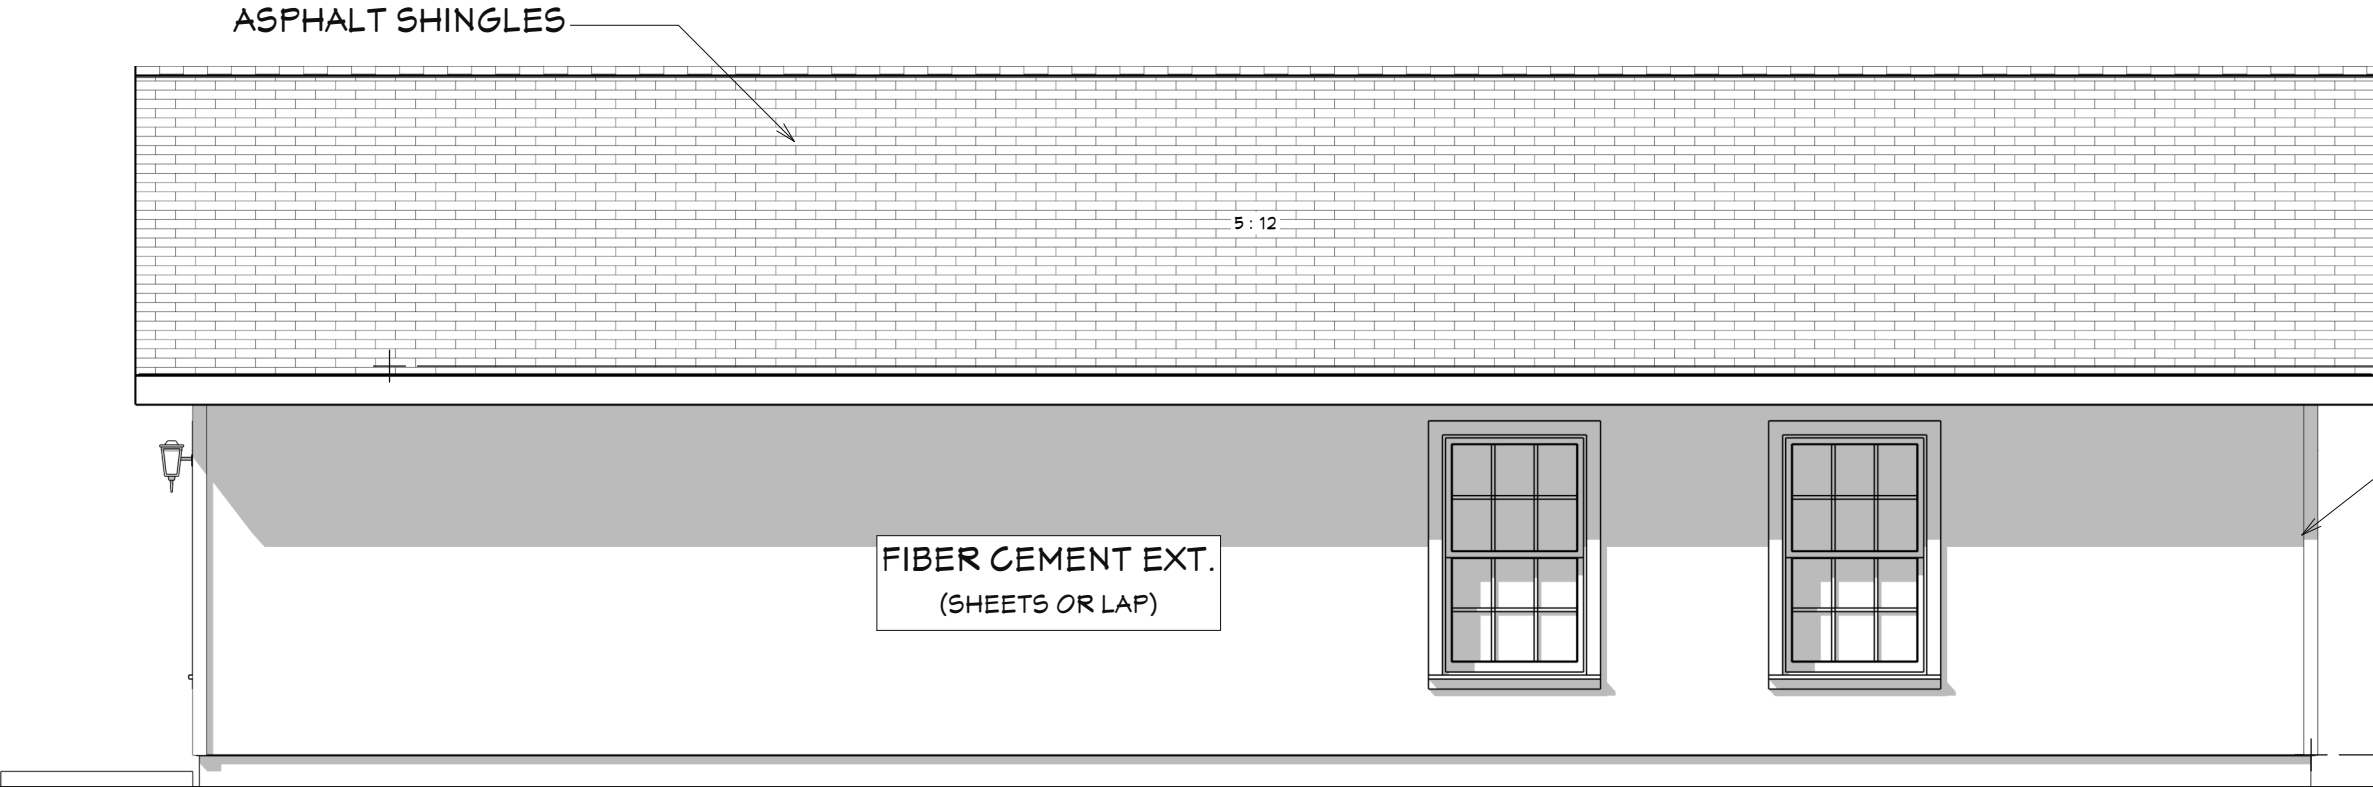
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ELEVATIONS
NEW SINGLE FAMILY
16TH ROAD-(14-035-12E-10270-003000)
LIVE OAK, FLORIDA 32060

MARTIN ENGINEERING, LLC.
450 STATE RD. N #106-387
JACKSONVILLE, FL 32259
904-472-1459
FL CA#32027


PROJ.#: 22-880
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SCALE: NOTED
DATE: 12/2/2022
SHEET NUMBER

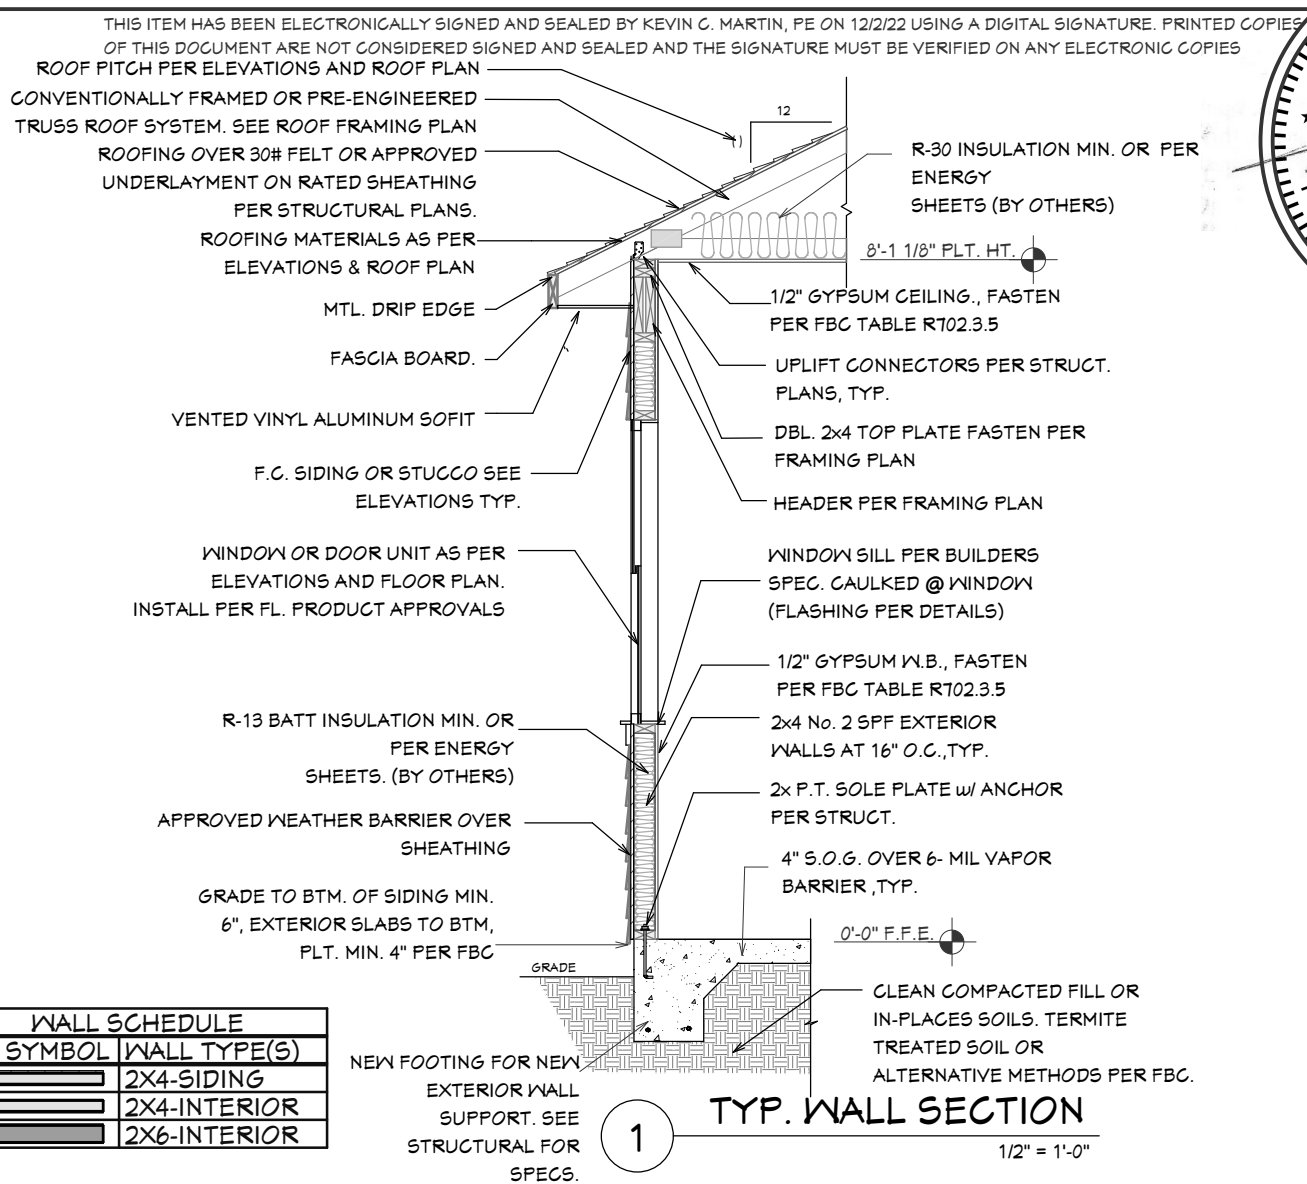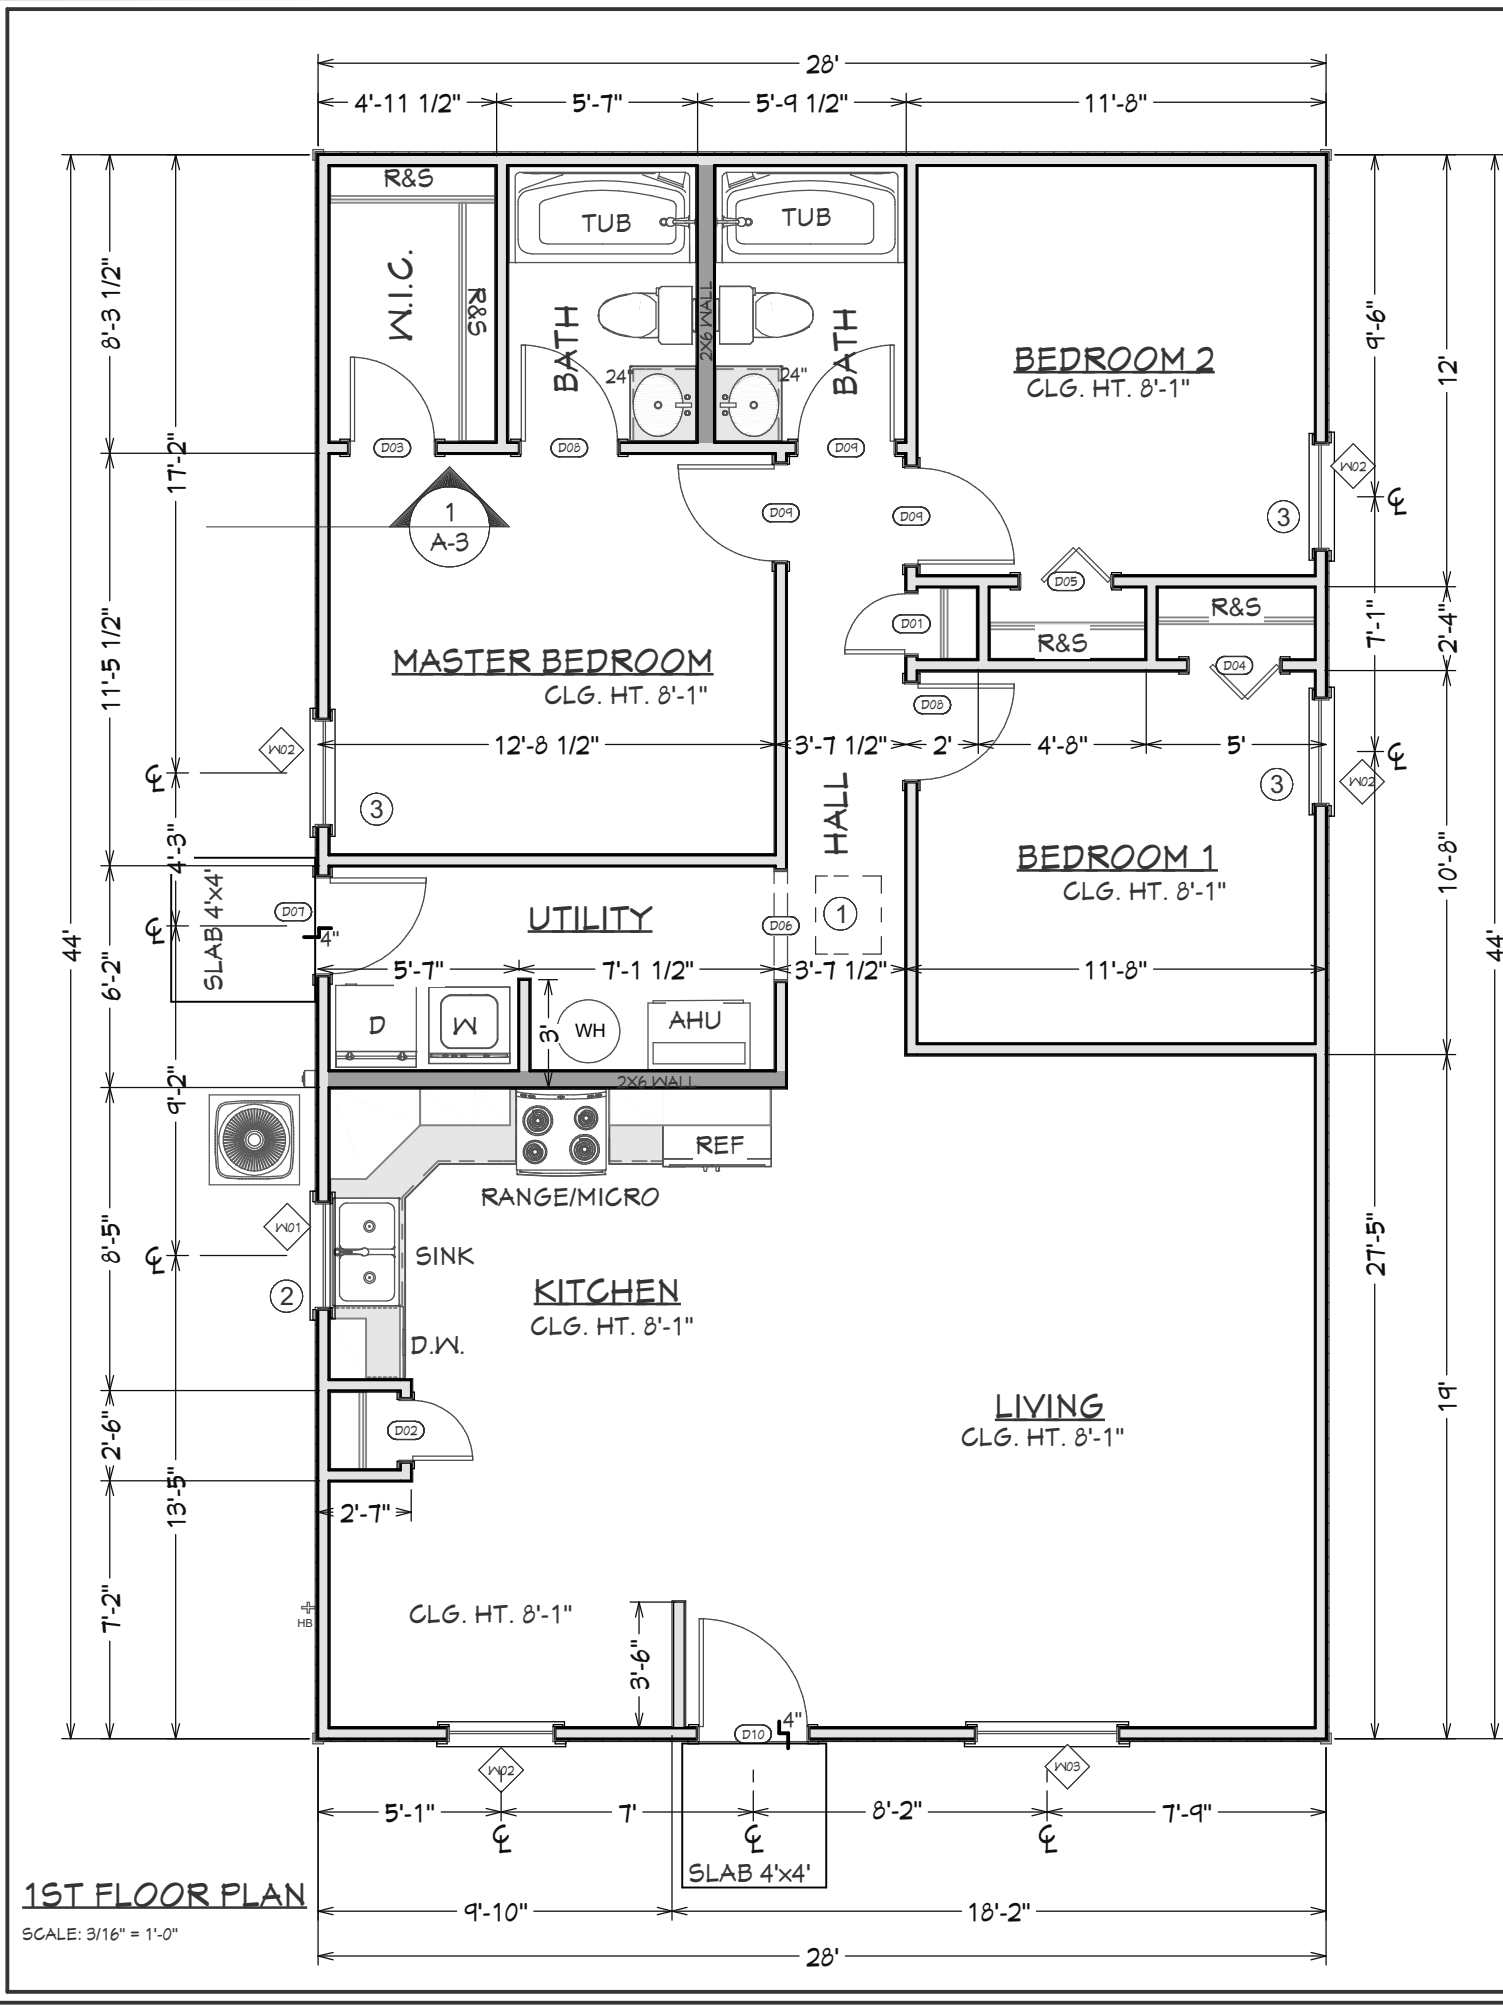

| DOOR SCHEDULE | | | | | | | |
|---------------|-------|-----|-----------|-------|--------|-----------------------|----------|
| NUMBER | LABEL | QTY | SIZE | WIDTH | HEIGHT | DESCRIPTION | COMMENTS |
| D01 | 1868 | 1 | 1868 L IN | 20" | 80" | HINGED-DOOR P04 | |
| D02 | 1868 | 1 | 1868 R IN | 20" | 80" | HINGED-DOOR P04 | |
| D03 | 2468 | 1 | 2468 L IN | 28" | 80" | HINGED-DOOR P04 | |
| D04 | 2668 | 1 | 2668 L | 30" | 80" | 2 DR. BIFOLD-DOOR P04 | |
| D05 | 2668 | 1 | 2668 R | 30" | 80" | 2 DR. BIFOLD-DOOR P04 | |
| D06 | 3068 | 1 | 3068 | 36" | 80" | DOORWAY | |
| D07 | 2868 | 1 | 2868 L EX | 32" | 80" | EXT. HINGED-DOOR E21 | |
| D08 | 2868 | 2 | 2868 L IN | 32" | 80" | HINGED-DOOR P04 | |
| D09 | 2868 | 3 | 2868 R IN | 32" | 80" | HINGED-DOOR P04 | |
| D10 | 3068 | 1 | 3068 L EX | 36" | 80" | EXT. HINGED-DOOR E21 | |

| WINDOW SCHEDULE | | | | | | | | |
|-----------------|--------|-----|--------|-------|--------|--------|-------------|----------|
| NUMBER | LABEL | QTY | SIZE | WIDTH | HEIGHT | BOTTOM | DESCRIPTION | COMMENTS |
| W01 | 3030SH | 1 | 3030SH | 36" | 36" | 44" | SINGLE HUNG | |
| W02 | 3050SH | 4 | 3050SH | 36" | 60" | 20" | SINGLE HUNG | |
| W03 | 4050SH | 1 | 4050SH | 48" | 60" | 20" | SINGLE HUNG | |
| TOTALS: | | | | | | | | 89.0 |

| FLORIDA BUILDING CODE NOTE SCHEDULE | |
|-------------------------------------|--|
| ① | FBC-R807.1-ATTIC ACCESS TO BE A MIN. 22"X30" IN SIZE IN A HALLWAY OR OTHER READILY ACCESSIBLE LOCATION |
| ② | HAZARDOUS. GLAZING. PER FBCR-308.4.3 |
| ③ | R310.2.1-EMERGENCY ESCAPE AND RESCUE OPENINGS (EGRESS) |

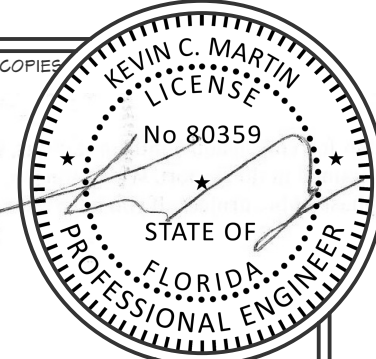



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FLOOR PLAN & SECTION
NEW SINGLE FAMILY
16TH ROAD-(14-035-12E-10270-003000)
LIVE OAK, FLORIDA 32060


MARTIN ENGINEERING, LLC.
450 STATE RD. N #106-387
JACKSONVILLE, FL 32254
904-472-1454
FL-CA#32027

PROJ.#: 22-880
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DRAWN: KCM
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DATE:12/2/2022
SHEET NUMBER

A-3

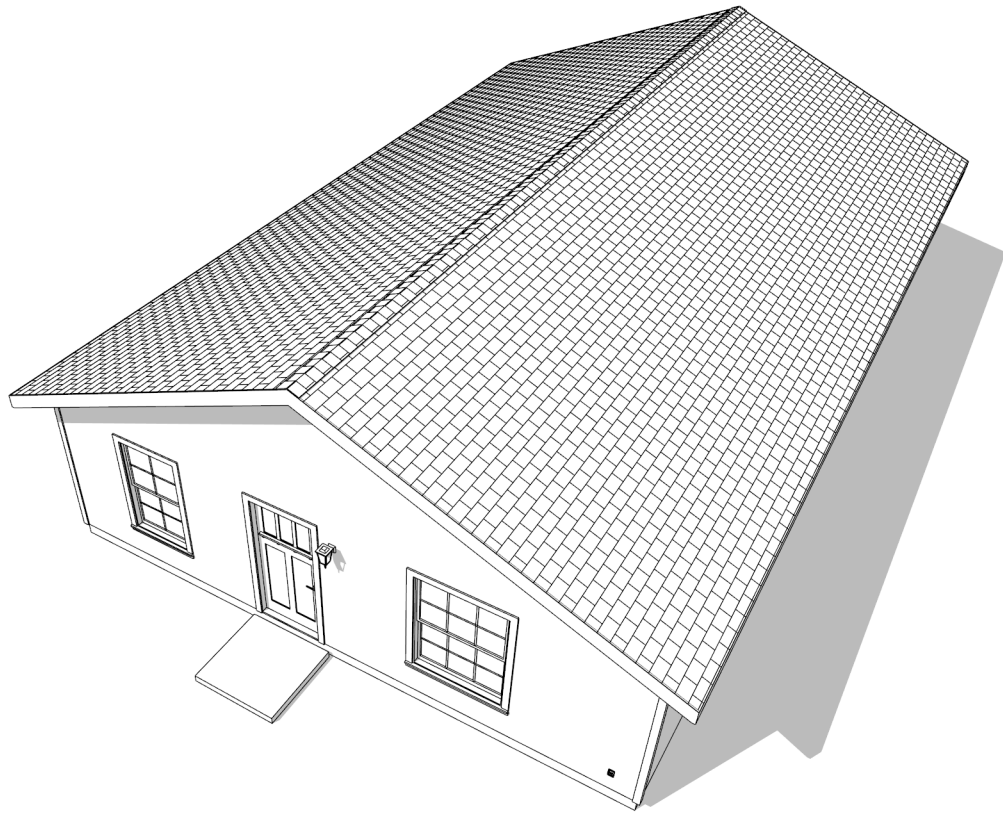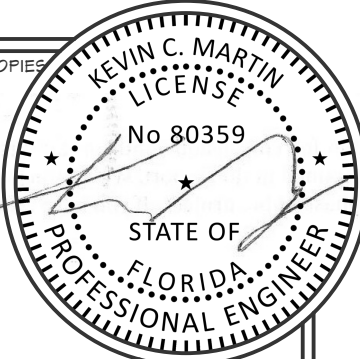

ROOF ISOMETRIC
SCALE: N.T.S.

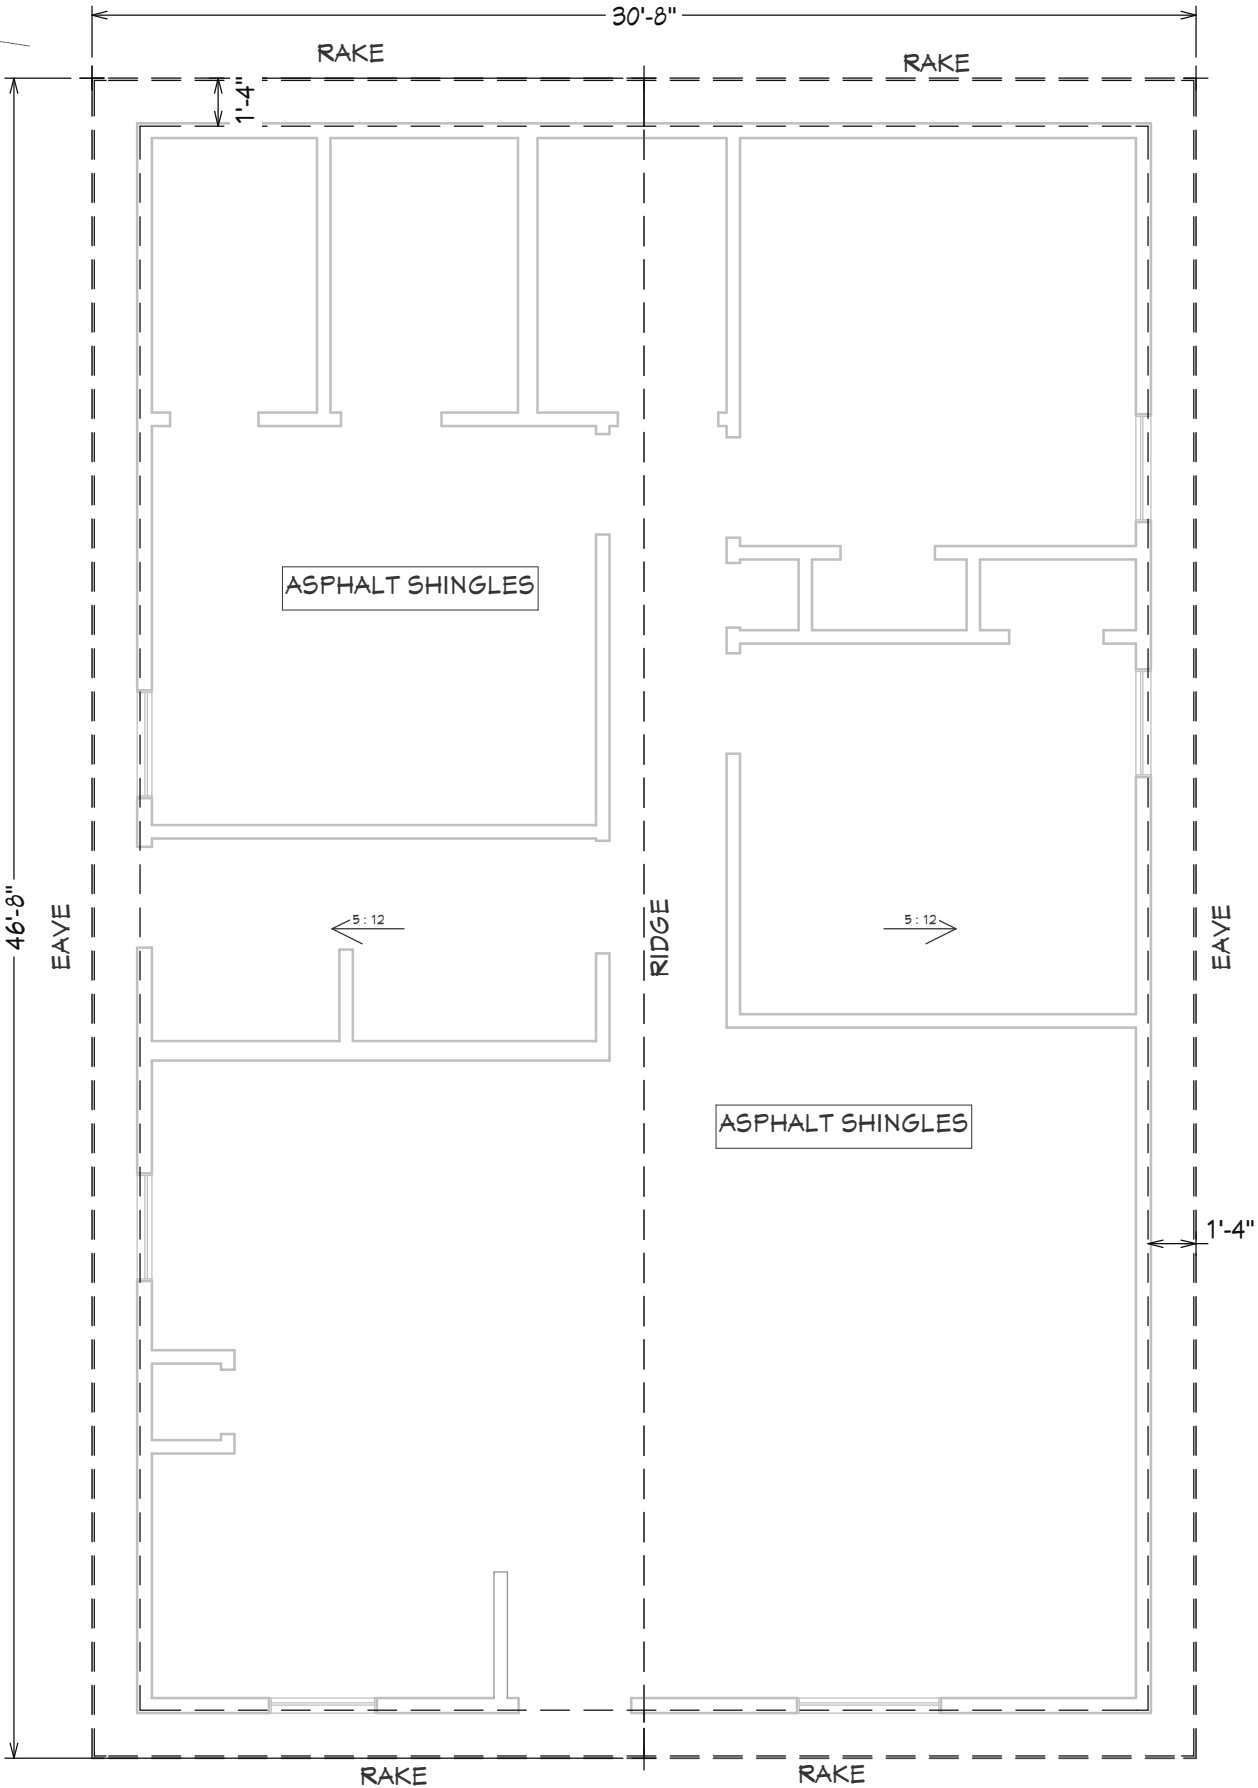

ROOF PLAN
SCALE: 3/16" = 1'-0"

VENTILATION CALCULATIONS

VENTILATION REQUIRED:
ATTIC SPACE = 1,233 SQFT
 $1,232 / 150 = 8.2$ SQFT
 $8.2 \times 144 = 1,181$ SQIN
 $1,181 \times 0.5(50\%) = 591$ SQIN NET FREE ROOF VENT REQ'D
 $1,181 \times 0.5(50\%) = 591$ SQIN NET FREE SOFFIT VENT REQ'D

UPPER ROOF VENT SPECS:
TYP. RIDGE VENT PROVIDES 15 SQIN/LIN. FT. NET FREE SPACE

UPPER ROOF VENT REQUIREMENTS:
 $591 \text{ SQIN} / 15 \text{ SQIN-LIN FT} = 40 \text{ LIN FT. OF RIDGE VENT REQUIRED}$

SOFFIT VENTS REQUIREMENTS:
LIN. FT OF SOFFIT AVAILABLE = 154'
AIR FLOW PER LIN. FT. = (3"x12") VENTS AT 6' O.C. = 6 SQIN
TOTAL = $6 \text{ SQIN/FT} \times 154' = 924 \text{ SQIN}$ NET FREE SOFFIT AREA PROVIDED > 591 SQIN REQUIRED

VENTILATION REQUIREMENTS SHALL BE IN ACCORDANCE
W/ SECTION R806.1 OF THE 2020 RESIDENTIAL FLORIDA BUILDING CODE.


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ROOF PLAN
NEW SINGLE FAMILY
16TH ROAD-(14-035-12E-10270-003000)
LIVE OAK, FLORIDA 32060

MARTIN ENGINEERING, LLC.
450 STATE RD. N #106-387
JACKSONVILLE, FL 32259
904-472-1459
FL CA#32027

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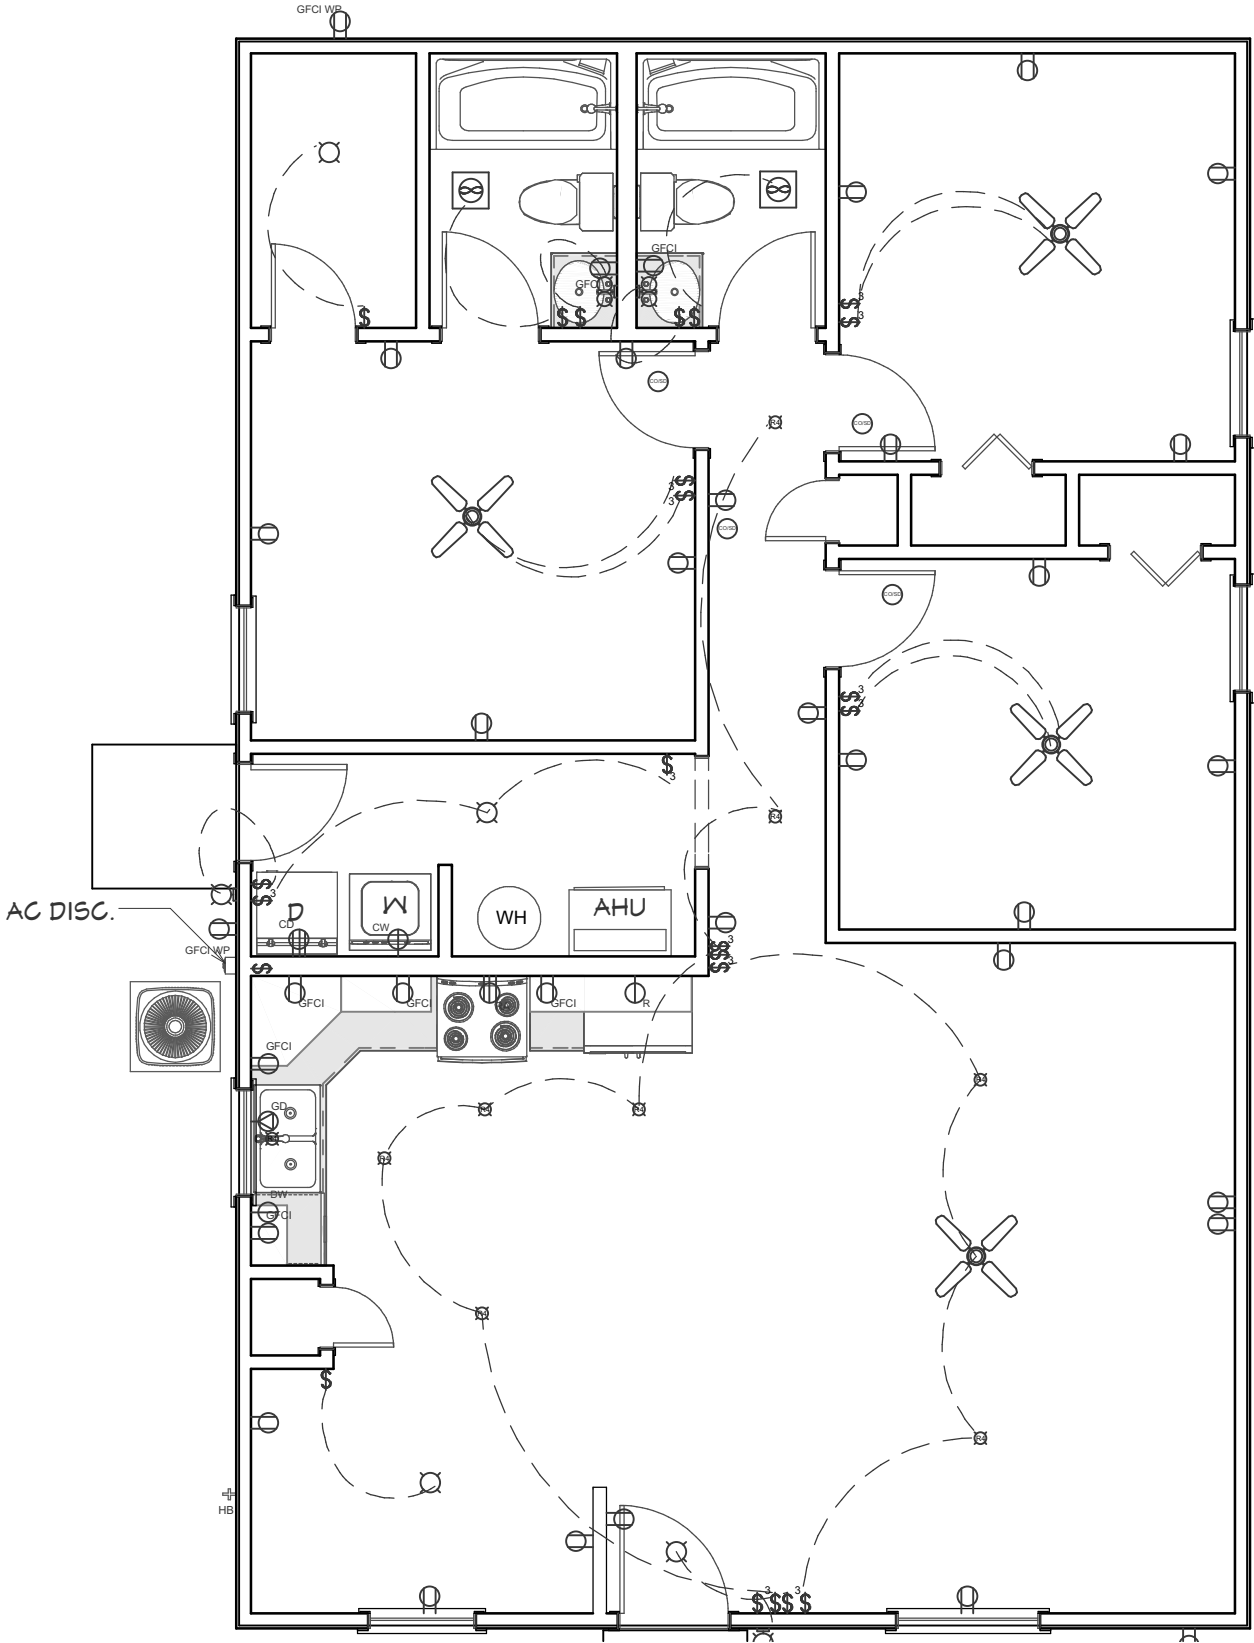
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| ELECTRICAL - DATA - AUDIO LEGEND | |
|----------------------------------|---|
| SYMBOL | DESCRIPTION |
| | CEILING FAN |
| | VENTILATION FANS: CEILING MOUNTED, WALL MOUNTED |
| | CEILING MOUNTED LIGHT FIXTURES: SURFACE/PENDANT, RECESSED, HEAT LAMP, LOW VOLTAGE |
| | WALL MOUNTED LIGHT FIXTURES: FLUSH MOUNTED, |
| | WALL SCONCE CHANDELIER LIGHT FIXTURE |
| | FLUORESCENT LIGHT FIXTURE |
| | 240V RECEPTACLE |
| | 110V RECEPTACLES: DUPLEX, WEATHER PROOF, GFCI |
| | SWITCHES: SINGLE POLE, WEATHER PROOF, 3-WAY, 4-WAY |
| | SWITCHES: DIMMER, TIMER |
| | AUDIO VIDEO: CONTROL PANEL, SWITCH |
| | SPEAKERS: CEILING MOUNTED, WALL MOUNTED |
| | WALL JACKS: CAT5, CAT5 + TV, TV/CABLE |
| | TELEPHONE JACK |
| | INTERCOM |
| | THERMOSTAT |
| | DOOR CHIME, DOOR BELL BUTTON |
| | SMOKE DETECTORS: CEILING MOUNTED, WALL MOUNTED |
| | ELECTRICAL BREAKER PANEL |

ELECTRICAL NOTES:

1. ELECTRICAL CONTRACTOR SHALL PROVIDE ARC-FAULT CIRCUIT INTERRUPTERS IN ALL BRANCH CIRCUITS THAT SUPPLY 120-VOLT, SINGLE PHASE, 15 & 20 AMP OUTLETS IN LIVING ROOMS, DINING ROOMS, HALLWAYS, BEDROOMS, DENS, SUNROOMS, RECREATION ROOMS, CLOSETS, OR SIMILAR AREAS PER 2017 FBC R3902.16
2. ALL PERMANENTLY INSTALLED LIGHTING FIXTURES SHALL COMPLY WITH THE MINIMUM REQUIREMENTS FOR HIGH-EFFICACY LAMPS PER FBC-ENERGY CONSERVATION R404

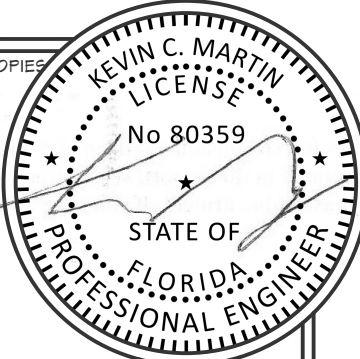

ELECTRICAL LAYOUT

SCALE: 3/16" = 1'-0"

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ELECTRICAL LAYOUT
NEW SINGLE FAMILY
16TH ROAD-(14-035-12E-10270-003000)
LIVE OAK, FLORIDA 32060

MARTIN ENGINEERING, LLC.
450 STATE RD. N #106-387
JACKSONVILLE, FL 32259
904-472-1459
FL-CA#32027

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| PROJ.#: 22-880 |
| DESIGNED:KCM |
| DRAWN: KCM |
| SCALE: NOTED |
| DATE:12/2/2022 |
| SHEET NUMBER |

PLUMBING NOTES:


1. ALL PLUMBING WORK SHALL BE PERFORMED IN ACCORDANCE WITH THE FLORIDA BUILDING CODE-RESIDENTIAL 11TH EDITION 2020. AND WITH ALL APPLICABLE REGULATIONS.
2. ALL HORIZONTAL SANITARY PIPING SHALL SLOPE AT 1-1/8" PER FOOT MINIMUM FOR 3' AND LARGER AND AT 1-1/4" SLOPE FOR 2-1/2" PIPES AND SMALLER
3. PLUMBING FIXTURES, FIXTURES SHALL BE AS SELECTED BY OWNER AND SHALL BE COMPLETE WITH DRAINS, TRAPS, SUPPLIES AND ANY OTHER ACCESSORY REQUIRED. FIXTURES AND FAUCETS SHALL COMPLY WITH THE FBC WATER SAVING STANDARDS.
4. MATERIALS:
 - PIPING, UPONOR PEX PIPING OR PVC:
 - A. SOIL, WASTE AND VENT, AND STORM, SANITARY PIPE, PVC, DWV SCHEDULE 40 UNDER GROUND, AND ABOVE GROUND.
 - B. DOMESTIC WATER PVC PIPE AND FITTINGS INSIDE BUILDING WALLS, PVC OUTSIDE UNDER GROUND.
 - C. CONDENSATE DRAIN, DWV PVC PIPE AND FITTINGS. INSULATE ALL ABOVE GROUND CONDENSATE PIPING WITH 1-1/2" FOAM PLASTIC INSULATION WITH SOLVENT SEALED SEAMS.
 - D. DOMESTIC WATER SUPPLY ASSEMBLY, CHROME FINISH TUBING WITH ANGLE SHUT OFF VALVES.
 - E. P & T RELIEF LINES COPPER PIPE AND FITTINGS.
 - F. DRAIN PAN LINES, DWV PVC AND FITTINGS.
5. ALL AUTOMATIC ELECTRIC WATER HEATERS SHALL MEET THE STANDARDS OF THE LATEST ENERGY EFFICIENCY CODE.
6. VALVES, DOMESTIC WATER VALVES SHALL BE OF BRONZE BODY, SWEAT ENDS.
7. HOSE BIBS, SHALL BE 3/4" ROUGH BRASS CONSTRUCTION WITH SHUT OFF VALVE AND VACUUM BREAKER.
8. ALL OUTDOOR FLOOR CLEAN OUTS SHALL BE TERMINATED UP TO GRADE AND SHALL BE MARKED.
9. CLEANOUTS SHALL BE PROVIDED AT THE BASE OF EACH WASTE OR SOIL STACK AS PER SECTION 108.3.4 FBCF
10. CONTRACTOR SHALL PROVIDE MAINTENANCE FREE MECHANICAL SHOCK ARRESTORS AT ALL FIXTURES WITH QUICK CLOSING VALVES.
11. VENT SYSTEMS USING AIR ADMITTANCE VALVES SHALL COMPLY WITH THIS SECTION. INDIVIDUAL AND BRANCH-TYPE AIR ADMITTANCE VALVES SHALL CONFORM TO ASSE 1050.
12. THE FLOW VELOCITY OF THE WATER DISTRIBUTION SYSTEM SHALL BE CONTROLLED TO REDUCE THE POSSIBILITY OF WATER HAMMER A WATER HAMMER ARRESTOR SHALL BE INSTALLED IN ACCORDANCE WITH MANUFACTURERS SPECIFICATIONS, WATER HAMMER ARRESTORS SHALL CONFORM TO ASSE 1010.
13. BATHTUB, SHOWER AND WHIRLPOOL BATHTUB VALVES. THE HOT WATER SUPPLIED TO BATHTUBS AND WHIRLPOOL BATHTUBS SHALL BE LIMITED TO A MAXIMUM TEMPERATURE OF 120 F (49 C) BY A WATER-TEMPERATURE-LIMITING DEVICE THAT CONFORMS TO ASSE 1010, EXCEPT WHERE SUCH PROTECTION IS OTHERWISE PROVIDED BY A COMBINATION TUB/ SHOWER VALVE IN ACCORDANCE WITH SECTION P2108.3 ACCESS PANEL FOR WHIRLPOOL BATHTUB PUMP SHALL BE PROVIDED PER FBCF 2120.1
14. DISHWASHER CONNECTION. THE COMBINED DISCHARGE FROM A SINK DISHWASHER, AND WASTE GRINDER IS PERMITTED TO DISCHARGE THROUGH A SINGLE 1- 1/2"(38 MM) TRAP. THE DISCHARGE PIPE FROM THE DISHWASHER SHALL BE INCREASED TO A MINIMUM OF 3/4"(19MM) IN DIAMETER AND SHALL CONNECT WITH A WYE FITTING BETWEEN THE DISCHARGE OF THE FOOD-WASTE GRINDER AND THE TRAP INLET OR TO THE HEAD OF THE FOOD GRINDER. THE DISHWASHER WASTE LINE SHALL RISE AND BE SECURELY FASTENED TO THE UNDERSIDE OF THE COUNTER BEFORE CONNECTING TO THE SINK TAIL PIECE OR THE FOOD GRINDER.
15. THE CONTRACTOR SHALL FIELD VERIFY ALL INVERT ELEVATIONS AND SIZE OF EXISTING SEWER AND WATER MAINS FOR CONNECTION OF NEW SERVICES.
- 16 - ALL PLUMBING FIXTURES SHALL BE DETERMINED BY OWNER
- 17- THESE DRAWINGS ONLY PROVIDE DESIGN LOCATIONS FOR THE EQUIVALENT DEPICTED HEREIN, THE PLUMBING CONTRACTOR SHALL OBTAIN SHOP DRAWINGS/ CUT SHEETS FROM THE EQUIVALENT SUPPLIER IN ORDER TO PLACE ROUGH-IN LINES AT OPTIMUM LOCATIONS FOR THE SPECIFIED EQUIPMENT.
- 18- THE PLUMBING CONTRACTOR SHALL PROVIDE FINAL CONNECTIONS TO ALL REQUIRED EQUIVALENT, UNLESS OTHERWISE NOTED.
19. NECESSARY, OBVIOUSLY REQUIRED PLUMBING ITEMS THAT ARE NOT SHOWN ON THESE DRAWINGS DOES NOT RELIEVE THE PLUMBING CONTRACTOR FROM THEIR RESPONSIBILITY OF INSTALLING A COMPLETELY OPERATING AND SAFE PLUMBING SYSTEM APPLICABLE w/ ALL CODES AS PREVIOUSLY DESCRIBED IN NOTE 1 ABOVE.
- 20-PIPE PROTECTION AS PER SECTION 305 FBCF ANY PIPE THAT PASSES UNDER A FOOTING OR THROUGH A FOUNDATION WALL SHALL BE PROVIDED WITH A RELIEVING ARCH, OR A PIPE SLEEVE PIPE SHALL BE BUILT INTO THE FOUNDATION WALL. THE SLEEVE SHALL BE TWO PIPE SIZES GREATER THAN THE PIPE PASSING THROUGH THE WALL PIPES PASSING THROUGH CONCRETE OR CINDER WALLS AND FLOORS OR OTHER CORROSIVE MATERIAL SHALL BE PROTECTED AGAINST EXTERNAL CORROSION BY A PROTECTIVE SHEATHING OR WRAPPING OR OTHER MEANS THAT WILL WITHSTAND ANY REACTION FROM THE LIME AND ACID OF CONCRETE, CINDER, OR OTHER CORROSIVE MATERIAL. SHEATHING OR WRAPPING SHALL ALLOW FOR MOVEMENT INCLUDING EXPANSION AND CONTRACTION OF PIPING MINIMUM WALL THICKNESS OF MATERIAL SHALL BE 0.010 INCH

PLUMBING LEGEND:

- ⊖ COLD WATER ACCESS
⊕ HOT WATER ACCESS
⊖ WASTE WATER ACCESS
- C/W — COLD WATER LINE
— H/W — HOT WATER LINE
— w/W — WASTE WATER


PLUMBING SCHEDULE

| NO. | DESCRIPTION | WASTE | WATER | |
|---------------------------|----------------|---|-------|------|
| | | | COLD | HOT |
| WC | WATER CLOSET | 3' | 1/2" | — |
| LAV. | LAVATORY | 1 1/4' | 1/2" | 1/2" |
| TUB/ SHUR | TUB / SHOWER | 1 1/2' | 1/2" | 1/2" |
| G.T. | GARDEN TUB | 1 1/2' | 1/2" | 1/2" |
| SHUR | SHOWER | 2' | 1/2" | 1/2" |
| SINK | KITCHEN SINK | 2' | 1/2" | 1/2" |
| W | CLOTHES WASHER | 2' | 1/2" | 1/2" |
| DW | DISH WASHER | 1" IW | — | 1/2" |
| REF. | REFRIGERATOR | — | 1/2" | — |
| PROVIDE ANTI-SCALD VALVE. | | PROVIDE MECH SHOCK ABSORBER TO EA. SUPPLY | | |

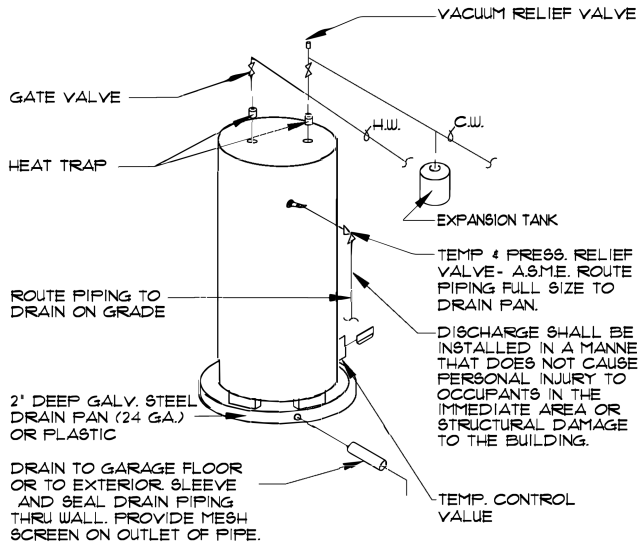


TYPICAL WATER HEATER DETAIL

THIS ITEM HAS BEEN ELECTRONICALLY SIGNED AND SEALED BY KEVIN C. MARTIN, PE ON 12/2/22 USING A DIGITAL SIGNATURE. PRINTED COPIES OF THIS DOCUMENT ARE NOT CONSIDERED SIGNED AND SEALED AND THE SIGNATURE MUST BE VERIFIED ON ANY ELECTRONIC COPIES

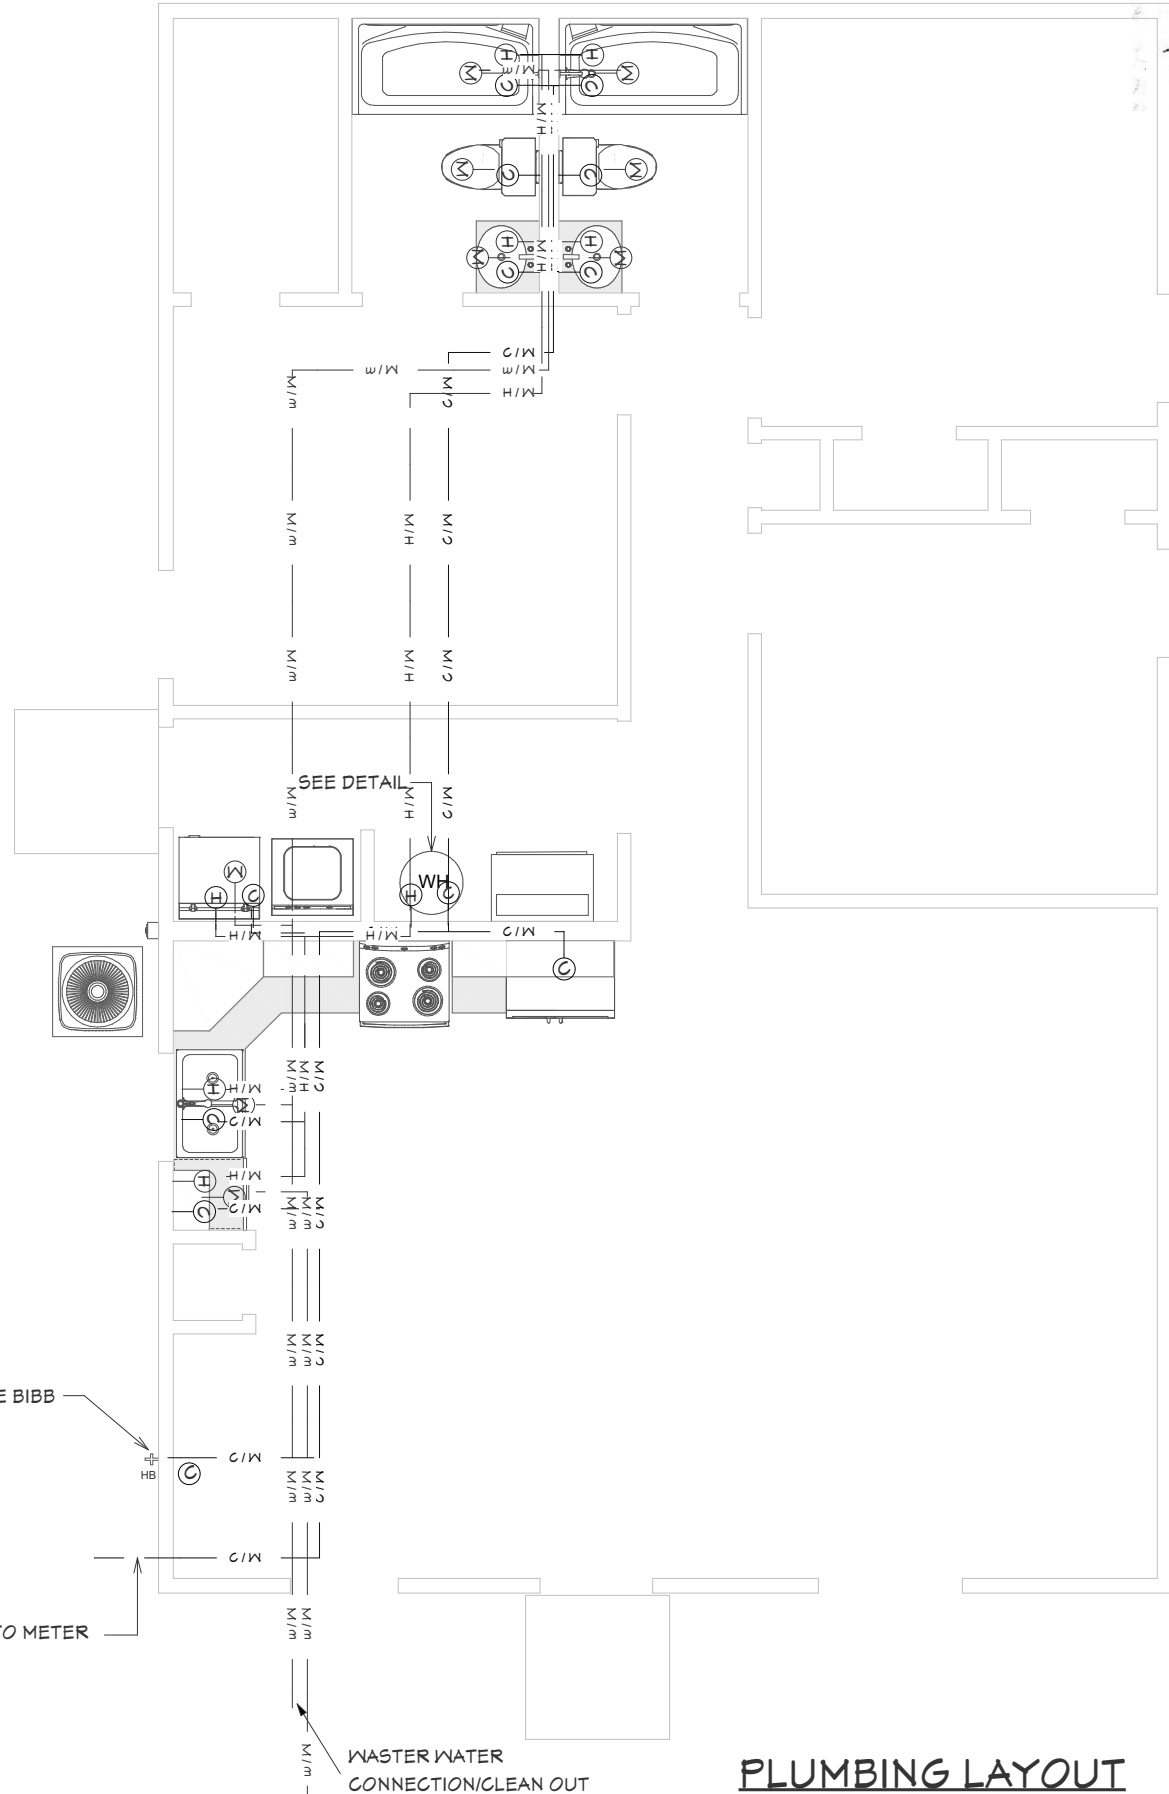

PLUMBING LAYOUT

SCALE: 3/16" = 1'-0"

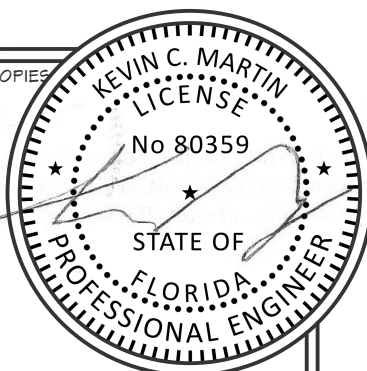

| REVISION TABLE | |
|----------------|-------------|
| NO. | DESCRIPTION |
| | |
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| | |
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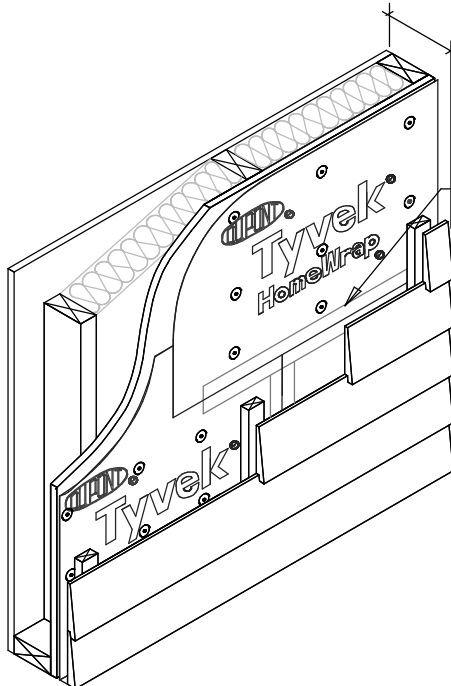
PLUMBING/FIXTURE LAYOUT
NEW SINGLE FAMILY
16TH ROAD-(14-035-12E-10270-003000)
LIVE OAK, FLORIDA 32060

MARTIN ENGINEERING, LLC.
450 STATE RD. N #106-387
JACKSONVILLE, FL 32259
904-472-1459
FL CA#32027

PROJ.#: 22-880
DESIGNED:KCM
DRAWN: KCM
SCALE: NOTED
DATE:12/2/2022
SHEET NUMBER

A-6

WEATHER BARRIER




TYPICAL WALL
WOOD SIDING
TYVEK HOMEWRAP
7/16" PLYWOOD SHEATHING
2"x4" WOOD STUDS
w/ R13 BATT INSULATION
1/2" GYPSUM BOARD

LAP AND TAPE TYVEK AT JOINTS


TYPICAL WALL ISOMETRIC

RESIDENTIAL WOOD FRAME STRUCTURE w/ WOOD SIDING (COOLING CLIMATE)

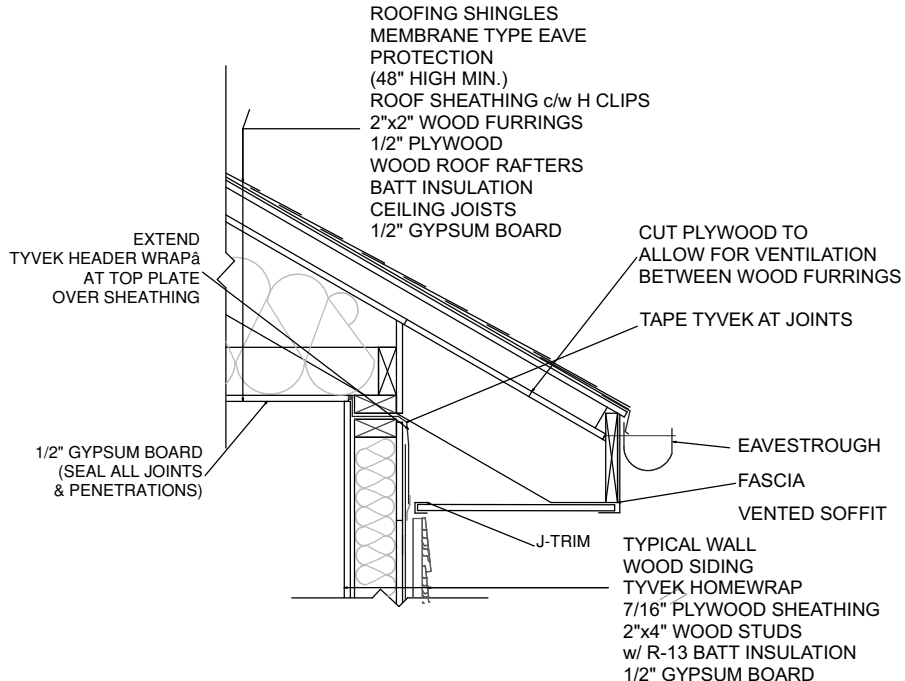


ROOF/ WALL INTERFACE DETAIL

RESIDENTIAL WOOD FRAME STRUCTURE w/ WOOD SIDING (COOLING CLIMATE)

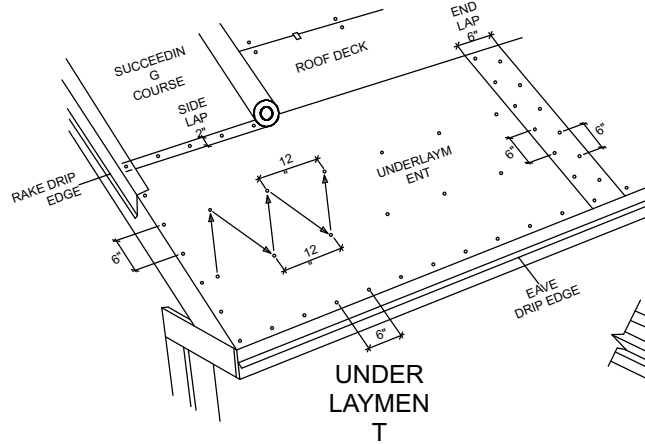


UNDER
LAYMEN
T

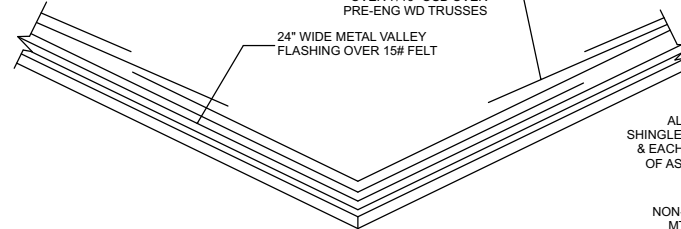


VALLEY FLASHING DETAIL

N.T.S.

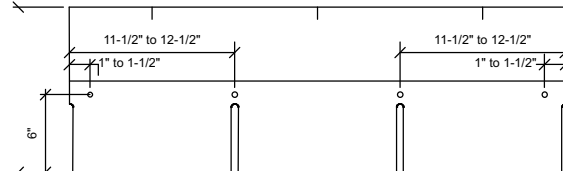


SHINGLE NAILING

NOTE: DETAILS ARE FOR SLOPES OF 3:12 OR GREATER, FOR SLOPES BELOW 3:12, ALL ROOFING UNDERLAYMENT SHALL BE SELF ADHERING SHEET MEMBRANE APPROVED BY THE SHINGLE MANUFACTURER FOR USE ON LOW SLOPE ROOFING PROJECTS

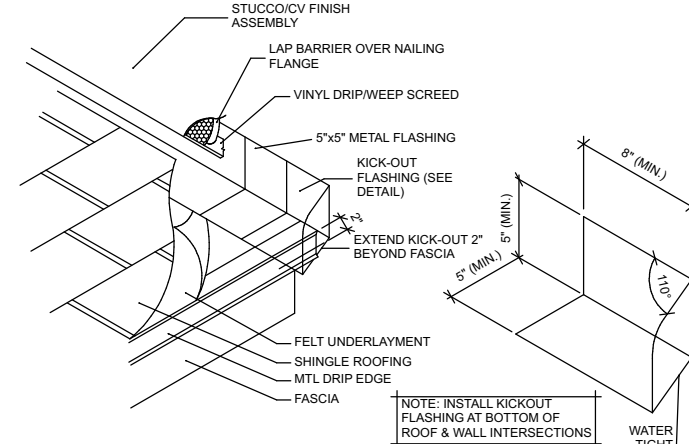


WALL/KICKOUT FLASHING DETAIL

N.T.S.

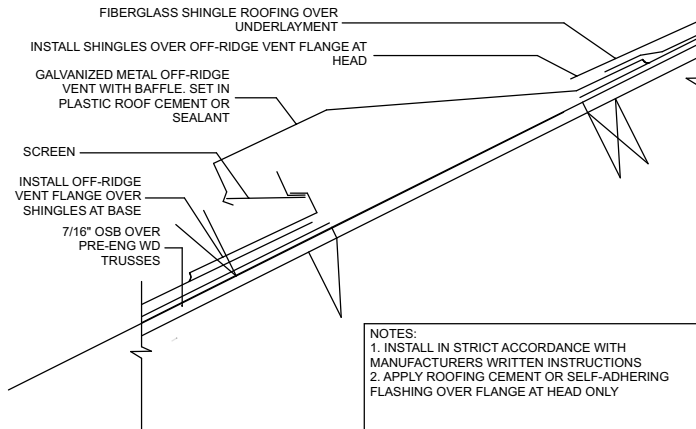


OFF-RIDGE VENT FLASHING DETAIL

N.T.S.

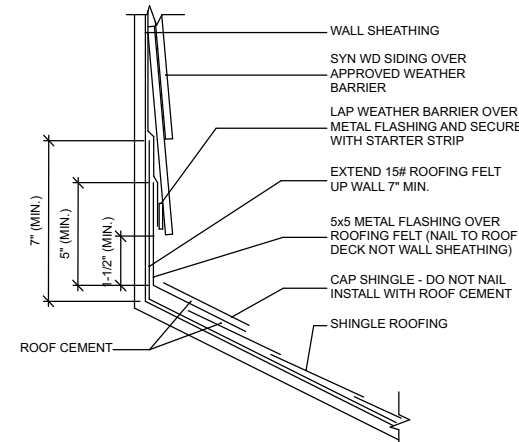


WALL FLASHING DETAIL - LAP SIDING

N.T.S.

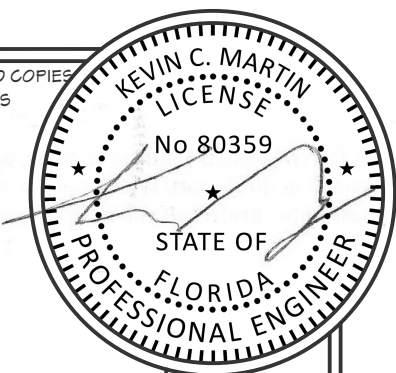[illegible]

FLASHING DETAILS
NEW SINGLE FAMILY
167TH ROAD-(14-035-12E-10270-0030000)
LIVE OAK, FLORIDA 32060



450 STATE RD. N #106-387
JACKSONVILLE, FL 32259
904-472-1459
FL CA#32027

ROJ.#: 22-880

DESIGNED:KCM

RAWN: KCM

SCALE: NOTED

ATE:12/2/2022

SHEET NUMBER

A-7

GENERAL STRUCTURAL NOTES

THE CONTRACTOR SHALL VERIFY ALL CONDITIONS AND DIMENSIONS AT THE JOBSITE PRIOR TO COMMENCING WORK. CONTRACTOR SHALL REPORT ALL DISCREPANCIES THE DRAWINGS AND EXISTING CONDITION TO THE ENGINEER PRIOR TO COMMENCING WORK.

DETAILS AND SECTIONS SHOWN ON THE DRAWINGS ARE TYPICAL AND APPLY TO SIMILAR SITUATIONS ELSEWHERE, EXCEPT AS OTHERWISE INDICATED. ADAPT REQUIREMENTS OF DETAILS, SECTIONS, PLANS, AND NOTES AT LOCATIONS WHERE CONDITIONS ARE SIMILAR.

DIMENSIONS INDICATED ON THE DRAWINGS IN REFERENCE TO EXISTING CONDITIONS ARE THE BEST AVAILABLE DATE OBTAINABLE, BUT ARE NOT GUARANTEED. BEFORE PROCEEDING WITH ANY WORK DEPENDENT ON THE DATA INVOLVED, THE CONTRACTOR SHALL FIELD CHECK AND VERIFY ALL DIMENSIONS, GRADES, LINES, LEVELS, OR OTHER CONDITIONS OF LIMITATIONS AT THE SITE TO AVOID CONSTRUCTION ERRORS. IF ANY WORK IS PERFORMED BY THE CONTRACTOR OR ANY OF HIS SUBCONTRACTORS PRIOR TO ADEQUATE VERIFICATION OF APPLICABLE DATA, AT RESULTANT EXTRA COST FOR ADJUSTMENT OR WORK AS REQUIRED TO CONFORM TO EXISTING LIMITATIONS, SHALL BE ASSUMED BY THE CONTRACTOR WITHOUT REIMBURSEMENT OR COMPENSATION BY THE OWNER.

STRUCTURAL DRAWINGS SHALL BE USED IN CONJUNCTION WITH JOB SPECIFICATIONS AND ARCHITECTURAL, MECHANICAL, ELECTRICAL, PLUMBING, AND SITE DRAWINGS. CONSULT THESE DRAWINGS FOR SLEEVES, DEPRESSIONS, AND OTHER DETAILS NOT SHOWN ON STRUCTURAL DRAWINGS.

CONTRACTOR SHALL LOCATE ALL BURIED UTILITIES PRIOR TO EXCAVATION FOR BUILDING FOUNDATIONS. THE STRUCTURAL ENGINEER SHALL BE NOTIFIED OF POTENTIAL CONFLICTS BETWEEN FOUNDATIONS AND BURIED UTILITIES.

CODE REQUIREMENTS:

THE BUILDING STRUCTURE IS DESIGNED IN ACCORDANCE WITH THE **2020 FLORIDA BUILDING CODE 7TH EDITION**. OTHER CODES IMPLEMENTED FOR DESIGN INCLUDE: ASCE7-16, ACI 315/318/530, NDS 2018, APA, A.I.S.C., ANSI. FOLLOW ALL APPLICABLE PROVISIONS OF THE FLORIDA BUILDING CODE AND OTHER RELATED CODES FOR ALL PHASES OF CONSTRUCTION.

TEMPORARY CONDITIONS:

THE STRUCTURAL INTEGRITY OF THE COMPLETED STRUCTURE DEPENDS ON INTERACTION OF VARIOUS CONNECTED COMPONENTS. PROVIDE ADEQUATE BRACING, SHORING, AND OTHER TEMPORARY SUPPORTS AS REQUIRED TO SAFELY COMPLETE THE WORK. THE STRUCTURE SHOWN ON THE DRAWINGS HAS BEEN DESIGNED FOR STABILITY UNDER FINAL CONFIGURATION ONLY.

FOUNDATIONS:

FOUNDATIONS ARE DESIGNED FOR AN ALLOWABLE SOIL BEARING PRESSURE OF 2,000 PSF ON COMPACTED FILL. NO GEOTECHNICAL REPORTS AND/OR IN-SITU SOIL DATA WAS GIVEN TO THE STRUCTURAL ENGINEER PRIOR TO DESIGN. THE BEARING CAPACITY USED FOR DESIGN IS BASED ON ALLOWABLE LOADS FROM THE 2020 FLORIDA BUILDING CODE FOR SANDY SOILS WITH NO CLAY, ORGANIC MATERIAL, OR OTHER DELETERIOUS MATERIALS THAT WOULD AFFECT DESIGN BEARING PRESSURE AND THE PERFORMANCE OF THE FOUNDATIONS.

BEFORE CONSTRUCTION COMMENCES, SOIL BEARING CAPACITY SHALL BE VERIFIED BY A SUBSURFACE INVESTIGATION,AS WELL AS FIELD AND LABORATORY TESTS PERFORMED BY A CERTIFIED TESTING LABORATORY, WHOSE REPORT SHALL INCLUDE ANALYSIS AND RECOMMENDATIONS FOR SITE PREPARATION IN ORDER TO BEAR THE FOUNDATION LOADS. ABOVE REPORT SHALL BE SUBMITTED TO THE STRUCTURAL ENGINEER FOR REVIEW BEFORE FOUNDATION CONSTRUCTION BEGINS.

CONCRETE:

REINFORCED CONCRETE CONSTRUCTION SHALL CONFORM TO THE FBC AND ACI 318 "BUILDING CODE REQUIREMENTS FOR REINFORCED CONCRETE". CONCRETE STRENGTHS SHALL BE VERIFIED BY STANDARD 28-DAY CYLINDER TESTS PER ASTM C39, AND SHALL BE AS FOLLOWS:

fc ABS W/C MIN CEMENT SLUMP USE
2,500 PSI 0.58 470 LBS 5" +/- 1" ALL SLABS, MONOLITHIC FOOTINGS, SPREAD FOOTINGS
3,000 PSI 0.58 470 LBS 5" +/- 1" TIEBEAMS, COLUMNS, WALLS, ELEVATED SLABS

CEMENT SHALL CONFORM TO ASTM C150, TYPE 1. FLY ASH CONFORMING TO ASTM C618, TYPE F OR TYPE C, MAY BE USED TO REPLACE UP TO 20% OF THE CEMENT CONTENT, PROVIDED THAT THE MIX STRENGTH IS SUBSTANTIATED BY TEST DATA. COARSE AGGREGATE SHALL CONFORM TO ASTM C33 WITH A MAXIMUM SIZE OF 3/4". FINE AGGREGATE SHALL BE CLEAN, DURABLE, NATURAL SAND CONFORMING TO ASTM C33.

A WATER-REDUCING ADMIXTURE CONFORMING TO ASTM C494, USED IN STRICT ACCORDANCE WITH THE MANUFACTURER'S RECOMMENDATIONS, SHALL BE INCORPORATED IN CONCRETE DESIGN MIXES. A HIGH-RANGE WATER-REDUCING ADMIXTURE CONFORMING TO ASTM C494, TYPE F OR G, MAY BE USED IN CONCRETE MIXES, PROVIDING THAT THE SLUMP DOES NOT EXCEED 8".

SLEEVES, OPENINGS, CONDUIT, AND OTHER EMBEDDED ITEMS NOT SHOWN ON THE STRUCTURAL DRAWINGS SHALL BE APPROVED BY THE STRUCTURAL ENGINEER BEFORE POURING. NO SLEEVE, OPENING, OR INSERT MAY BE PLACED IN BEAMS, JOISTS, OR COLUMNS UNLESS APPROVED BY THE ENGINEER. CONDUITS EMBEDDED IN SLABS SHALL NOT BE LARGER IN OUTSIDE DIMENSION THAN ONE THIRD OF THE THICKNESS OF THE SLAB AND SHALL NOT BE SPACED CLOSER THAN THREE DIAMETERS ON CENTER.

PROVIDE 3/4" CHAMFERS ON ALL EXPOSED CONCRETE EDGES, UNLESS NOTED OTHERWISE. WHERE INDICATED OR REQUIRED, SLOPE CONCRETE SLABS TO DRAINS SHOWN ON PLUMBING AND/OR ARCHITECTURAL DRAWINGS. ALL CONCRETE SHALL BE CURED IMMEDIATELY AFTER FINISHING OPERATIONS.

WOOD:

SAWN LUMBER SHALL BE SOUTHERN PINE #2 WITH THE ALLOWABLE FIBER STRESSES PER THE AWC NATIONAL DESIGN SPECIFICATION. ALL MANUFACTURED LUMBER SHALL BE 2.0E GLUED LAMINATED GEORGIA PACIFIC (OR EQUIV.) AND INSTALLED ACCORDING TO MANUFACTURES RECOMMENDATIONS. ALL HEADERS/BEAMS SHOULD BEAR FULLY ON POSTS AND/OR MULTI STUD GROUPS UNLESS NOTED OTHERWISE ON PLANS. CONTACT ENGINEER OF RECORD IF HEADER/BEAMS SIZE IS NOT SPECIFIED.

FRAMING ACCESSORIES AND STRUCTURAL FASTENERS SHALL BE MANUFACTURED BY SIMPSON COMPANY OR USP (OR APPROVED EQUAL) AND OF THE SIZE AND TYPE SHOWN ON THE DRAWINGS. HANGERS NOT SHOWN SHALL BE SIMPSON HU OF SIZE RECOMMENDED FOR MEMBER. ALL CONNECTORS SHALL BE GALVANIZED. UNLESS SHOWN OTHERWISE, INSTALL MAXIMUM SIZE AND NUMBER OF FASTENERS SHOWN IN LATEST SIMPSON CATALOG

ALL FRAMING NAILS SHALL BE COMMON NAILS AND SHALL BE OF THE SIZE AND NUMBER INDICATED ON THE DRAWINGS. MINIMUM NAILING REQ. NOT SHOWN SHALL BE AS INDICATED IN TABLE 2304.9.1 OF THE FBC. INSTALL 10d NAILS UNLESS OTHERWISE SPECIFIED ON THE PLANS OR DETAILS. BOLTS AND LAG SCREWS SHALL CONFORM TO ANSI/ASME STANDARD B18.1. ALL BOLTS AND LAG SCREWS SHALL BE INSTALLED WITH STANDARD CUT WASHERS.

ALL ANCHOR BOLTS AND THREADED ANCHOR RODS SHALL BE IN ACCORDANCE WITH ASTM A307, GRADE A, OR ASTM F1554, GRADE 36. ANCHOR ADHESIVES SHALL BE EITHER SET (EPOXY-TIE) OR AT (ARCYLIC-TIE) BY SIMPSON STRONG-TIE AND INSTALLED ACCORDING TO THE MANUFACTURES INSTRUCTIONS. ALL DRILLED ANCHOR HOLES SHALL BE CLEANED OF ALL DEBRIS AND BRUSHED OUT PRIOR TO INSTALLATION OF ANCHOR ADHESIVE.

ALL WOOD MEMBERS EXPOSED TO EXTERIOR CONCRETE, MASONRY, WEATHER, OR EARTH SHALL BE PRESSURE TREATED LUMBER. ALL NAILS DIRECTLY EXPOSED TO WEATHER SHALL BE GALVANIZED. FASTENER REQUIREMENTS IN PRESSURE TREATED LUMBER ARE AS FOLLOWS:
ACZA PRESERVATIVE: STANDARD CARBON STEEL.
ACQ & MCQ PRESERVATIVE: HOT DIPPED GALVANIZED.
SODIUM BORATE: STAINLESS STEEL CONNECTORS & FASTENERS (NOT REQ. FOR SILL PLATES OVER CONCR.& VAPOR BARRIER NOT DIRECTLY EXPOSED TO EARTH OR WEATHER)

REINFORCING STEEL:

REINFORCING STEEL SHALL CONFORM TO ASTM A615, GRADE 60, FOR DEFORMED BAR AND ASTM A185 FOR SMOOTH WELDED WIRE FABRIC (WWF), UNLESS OTHERWISE NOTED. REINFORCING STEEL TO BE WELDED SHALL CONFORM TO ASTM A706. REINFORCING STEEL SHALL BE SECURELY TIED IN PLACE WITH #16 ANNEALED IRON WIRE.

ALL DETAILING AND ACCESSORIES SHALL CONFORM TO ACI DETAILING MANUAL SP. 66. PROVIDE CHAIRS, SPACERS, BOLSTERS, AND ITEMS IN CONTACT WITH FORMS WITH HOT DIP GALVANIZED LEGS OR PLASTIC LEGS. ACCURATELY POSITION, SUPPORT, AND SECURE REINFORCEMENT AGAINST DISPLACEMENT BY FORMWORK CONSTRUCTION OR CONCRETE PLACEMENT OPERATIONS. "WET-STICKING" OF REINFORCING IS PROHIBITED.

REQUIRED CONCRETE COVER FOR REINFORCING STEEL (UNLESS NOTED OTHERWISE):
FOOTINGS 3" BOTTOM AND SIDES, 2" TOP
SLABS 3/4"
COLUMNS 1-1/2" TO TIES, 2" TOP
BEAMS 1-1/2" TO STIRRUPS
WALLS 1-1/2"

LAP SPLICE CONTINUOUS VERTICAL OR HORIZONTAL BARS IN CONCRETE MEMBERS IN ACCORDANCE WITH ACI 318, LATEST EDITION, FOR CLASS "B" TENSION LAP SPLICES. DO NOT SPLICE CONTINUOUS TOP BARS IN BEAMS AT ENDS OF CLEAR SPANS. DO NOT SPLICE CONTINUOUS BOTTOM BARS IN BEAMS IN CLEAR SPANS BETWEEN SUPPORTS. SHOW ALL SPLICES ON SHOP DRAWINGS. SPLICE LOCATIONS AND METHODS SUBJECT TO APPROVAL OF STRUCTURAL ENGINEER.

AT SLAB AND WALL OPENINGS PROVIDE A MINIMUM OF (2) #5 BARS ALL FOUR SIDES AND DIAGONALLY; EXTEND THESE BARS A LAP DISTANCE OR A MINIMUM OF 24" PAST THE OPENING OR HOOK BARS IF DISCONTINUOUS.

DOWEL ALL WALLS AND COLUMNS TO FOOTINGS WITH BAR SIZE AND SPACING TO MATCH VERTICAL REINFORCING UNLESS OTHERWISE SHOWN.

DESIGN CRITERIA:


DESIGN WAS BASED ON STRENGTH AND DEFLECTION CRITERIA OF THE 2020 FLORIDA BUILDING CODE 7th EDITION. IN ADDITION TO THE DEAD LOADS, THE FOLLOWING LOADS AND ALLOWABLES WERE USED FOR DESIGN, WITH LIVE LOADS REDUCED PER THE 2020 FBC:

| | LIVE LOAD | DEAD LOAD | DEFLECTION |
|---------------------------------|---------------|----------------------------------|-------------------------------------|
| ROOF: | 20 PSF | 15 PSF | L/240 - L/180 |
| FLOORS: | 40 PSF | 10 PSF | L/360 - L/240 |
| DECKS: | 60 PSF | 10 PSF | L/360 - L/240 |
| WALLS: | PER C&C BELOW | PER ASCE7-10 TBLE. C3-1 | L/240 - BRITTLE L/180 - FLEXIBLE |
| ULTIMATE WIND SPEED | | 120 MPH | PER ASCE 7-16 |
| NOMINAL WIND SPEED: | | 93 MPH | PER FBC R301.2.1.3 |
| EXPOSURE | | C | PER ASCE 7-16 |
| IMPORTANCE FACTOR | | 1.0 | CATEGORY II |
| INTERNAL PRESSURE COEFF | +/- 0.18 | ENCLOSED (PROTECTED OPENINGS) | |
| COMPONENTS & CLADDING PRESSURES | | PER TABLE & CHARTS ON THIS PAGE. | |
| WIND-BORNE DEBRIS REGION | | NO | |

WIND PRESSURES ON WALLS & ROOFS³

| EFFECTIVE AREA OF OPENING/ROOF ZONE | ROOF ZONES | | | | | | EXTERIOR WALLS | | | |
|-------------------------------------|------------|-------|-----------------|-------|---------|-------|----------------|-------|--------|-------|
| | ZONE 1, 2e | | ZONE 2n, 2r, 3e | | ZONE 3r | | ZONE 4 | | ZONE 5 | |
| 0 TO 10 | 16.2 | -30.9 | 16.2 | -49.4 | 16.2 | -58.7 | 21.7 | -23.7 | 21.7 | -29.1 |
| 10.1 TO 20 | 14.0 | -30.9 | 14.0 | -43.4 | 14.0 | -49.4 | 20.7 | -22.5 | 20.7 | -27.2 |
| 20.1 TO 50 | 14.0 | -26.3 | 14.0 | -35.3 | 14.0 | -36.5 | 19.5 | -21.3 | 19.5 | -24.6 |
| 50.1 TO 100 | 14.0 | -22.7 | 14.0 | -29.1 | 14.0 | -36.5 | 18.5 | -20.3 | 18.5 | -22.5 |
| 100.1 TO 500 | - | - | - | - | - | - | 16.2 | -18.1 | 16.2 | -18.1 |

- WIND PRESSURES SHOWN ABOVE ARE FOR STRUCTURES WITH A MEAN ROOF HEIGHT OF 30 FEET OR LESS WITH A ROOF PITCH BETWEEN 2/12 & 12/12 (VERT./HORIZ.). IF THE STRUCTURE IS OUTSIDE THESE PARAMETER PLEASE CONTACT THE ENGINEER.
- THE EFFECTIVE AREA IS EQUAL TO THE LENGTH * WIDTH OF THE PROPOSED OPENING OR SPAN. THE WIDTH SHALL BE PERMITTED TO BE NOT LESS THAN 1/3 OF THE SPAN LENGTH. THE EFFECTIVE AREA FOR FASTENERS SHALL NOT BE GREATER THAN THE TRIBUTARY AREA B/T FASTENERS.
- ALL WIND PRESSURE VALUES IN POUNDS PER SQ. FT(PSF) & ARE CONSIDERED NOMINAL VALUES(ASD) IN ACCORDANCE w/ FBC TABLE R301.2(2)

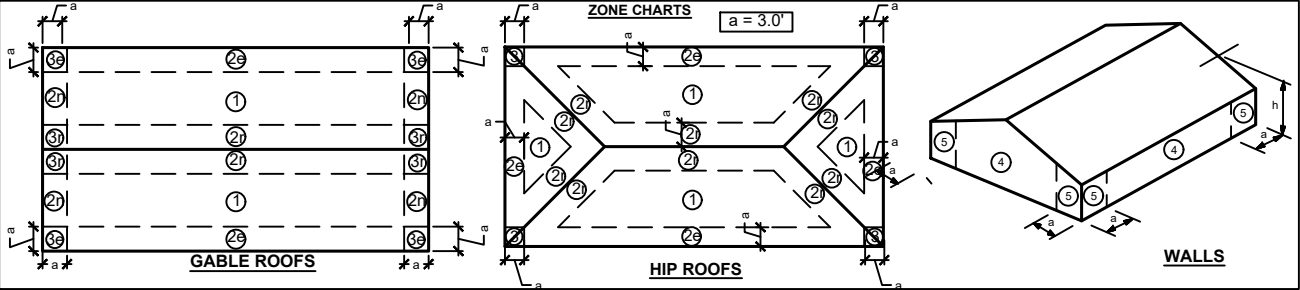

| ABBREVIATIONS | |
|---------------|---|
| BM | BEAM |
| CONT. | CONTINUOUS |
| CL | CENTER LINE |
| CLG | CEILING |
| CMU | CONCRETE MASONRY UNIT |
| DL | DEAD LOAD |
| EOR | ENGINEER OF RECORD |
| EXT. | EXTERIOR |
| FBC | FLORIDA BUILDING CODE (2020, 7TH EDITION) |
| FFE | FINISHED FLOOR ELEVATION |
| FTG | FOOTING |
| FPA | FLORIDA PRODUCT APPROVAL |
| INT. | INTERIOR |
| LG | LENGTH |
| LL | LIVE LOAD |
| LVL | LAMINATED VENEER LUMBER (2.0E, 1 3/4" WIDE MIN. U.N.O.) |
| MAX. | MAXIMUM |
| MIN. | MINIMUM |
| OR | "OR" MEANS THAT EITHER OPTION PROVIDED IS SUFFICE FOR THE APPLICATION |
| O.C. | ON CENTER SPACING |
| OPT | OPTIONAL |
| OSB | ORIENTED STAND BOARD (APA RATED MIN.) |
| PCF | POUNDS PER SQUARE FEET |
| PLYW. | PLYWOOD (APA RATED MIN.) |
| PSF | POUNDS PER SQUARE FEET |
| PSI | POUNDS PER SQUARE INCH |
| SS | STAINLESS STEEL |
| SPF | SPRUCE-PINE-FIR |
| SYP | SOUTHERN YELLOW PINE (No. 2 MIN.) |
| SW | SHEAR WALL |
| TYP | TYPICAL |
| U.N.O. | UNLESS OTHERWISE NOTED |
| w/ | WITH |
| w/o | WITHOUT |
| W.W.M/F | WELDED WIRE MESH OR FABRIC |

| SHEET INDEX | |
|-------------|--------------------------------|
| S-1 | GENERAL NOTES & SPECIFICATIONS |
| S-2 | FOUNDATION PLAN |
| S-3 | FRAMING PLAN |
| S-4 | TRUSS LAYOUT PLAN |
| S-5 - S-8 | STRUCUTRAL DETAILS |

| SYMBOL LEGEND | |
|--------------------|--|
| WALL SECTION | |
| ELEVATION | |
| DETAIL | |
| CALL OUT | |
| CUT/MATCH LINE | |
| ELEVATION DATUM | |
| SLAB STEP (INCHES) | |

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450 STATE ROAD 13 N., #106-387
JACKSONVILLE, FL 32259
904-472-1459

FL C.A.# 32027

| REVISIONS | | | |
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| No. | DATE | DESCRIPTION | APPROVED |
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NOTES

NEW SINGLE FAMILY
PARCEL#14-03S-12E-10270-003000-167th RD
LIVE OAK, FL 32060



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| PROJECT#: | 22-880 |
| DATE: | 12/2/22 |
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SHEET

S-1


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
| FOUNDATION LEGEND | |
|---|--------------------------|
|  | MONOLITHIC FOOTINGS |
|  | INTERIOR PARTITION WALLS |

ALL SLABS:
4" DEEP POURED CONC, SLAB W/ 6X6,
#10/10 W.W.W. OR FIBERMESH REINF.
OVER 6 MIL VAPOR BARRIER OVER
CLEAN COMPACTED FILL. SEE DETAIL 6
ON S-5 FOR TYP. JOINT DETAILS

NOTE TO CONTRACTOR: THE PLAN SHOWN ON THIS
SHEET IS FOR STRUCTURAL FOUNDATION
REQUIREMENTS AND LOCATIONS ONLY. REFER TO THE
ARCHITECTURAL PLANS FOR SLAB AND FOUNDATION
DIMENSIONS.

| FOUNDATION SCHEDULE | | | | | | |
|---------------------|---------|-------|---------|-------------------|------------|---------------------|
| TYPE MARK | WIDTH | LENG. | DEPTH | REINFORCING | | TYPE |
| | | | | BOTTOM | TRANSVERSE | |
| M12 | 1' - 0" | CONT. | 1' - 0" | (2) #5 CONTINUOUS | N/A | EXTERIOR MONOLITHIC |
| TE8 | 8" | CONT. | 1' - 0" | (1) #5 CONTINUOUS | N/A | THICKENED EDGE |
| | | | | | | |



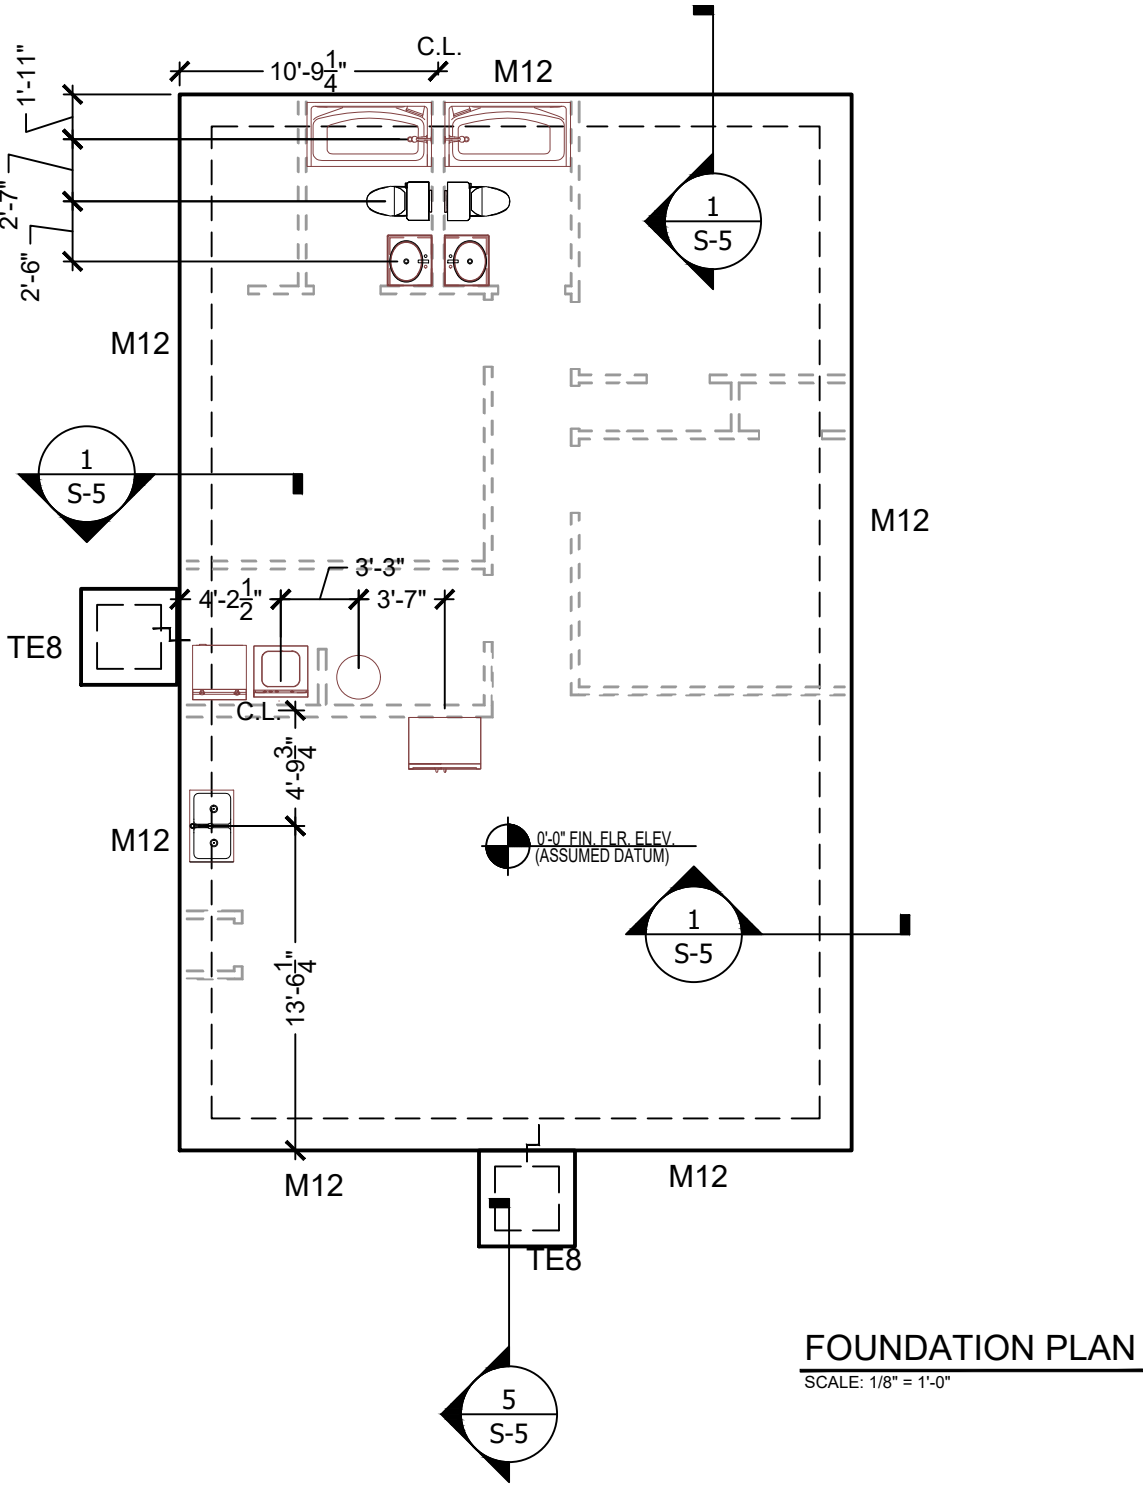

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FOUNDATION PLANS

NEW SINGLE FAMILY
PARCEL#14-03S-12E-10270-003000-167th RD
LIVE OAK, FL 32060


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S-2

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STRUCTURAL SHEATHING LEGEND

| TYPE | SHEATHING | FASTENERS | SHEATHING AREAS | | |
|---------------------|------------------------|--------------------------------|-----------------------|---------|--|
| | | | EDGES | FIELD | GABLE ENDS |
| ROOF | 7/16" OSB/PLY | 8d RING SHANK | 6" o.c. | 6" o.c. | 4" o.c. FIELD & EDGES 4' FROM ROOF EDGE/END WALL |
| FLOOR | 23/32" T&G OSB/PLY | 10d COMMON (GLUED & NAILED) | 6" o.c. | 6" o.c. | |
| **PORCH CEILINGS | 3/8" OSB/PLY | 8d COM./BOX | 3" o.c. | 6" o.c. | |
| WALLS | 7/16"(MIN.) OSB/PLY | 8d COM./BOX (U.N.O.) | SEE SHEAR WALL LEDGED | | |

1. ALL WOOD STRUCTURAL SHEATHING SHALL BE APA RATED, EXPOSURE 1.
2. STRUCTURAL WOOD PANELS NOMINAL THICKNESS & SPAN RATINGS SHALL MEET THE FOLLOWING MINIMUM REQUIREMENTS:

7/16" = .437" THICKNESS - 24/16 SPAN RATING
 15/32" = .469" THICKNESS - 32/16 SPAN RATING
 19/32" = .594" THICKNESS - 40/20 SPAN RATING
 23/32" = .719" THICKNESS - 48/24 SPAN RATING
3. ALL ROOF SHEATHING SHALL BE INSTALLED WITH THE LONG DIMENSION PERPENDICULAR TO THE ROOF SUPPORTS.
4. SHEATHING/SUBSTRATES & FASTENINGS FOR EACH ROOFING TYPE SHALL BE IN ACCORDANCE w/ THE FLORIDA PRODUCT APPROVAL.
5. FASTENERS FOR ROOF SHEATHING GREATER THAN $\frac{15}{32}$ " SHALL BE 8d COMMON(.131x2 $\frac{1}{2}$ ") RING SHANK NAILS U.N.O.
6. 2x BLOCKING FOR EDGE NAILING SHALL BE INSTALLED IF NOTED ON THE PLANS.

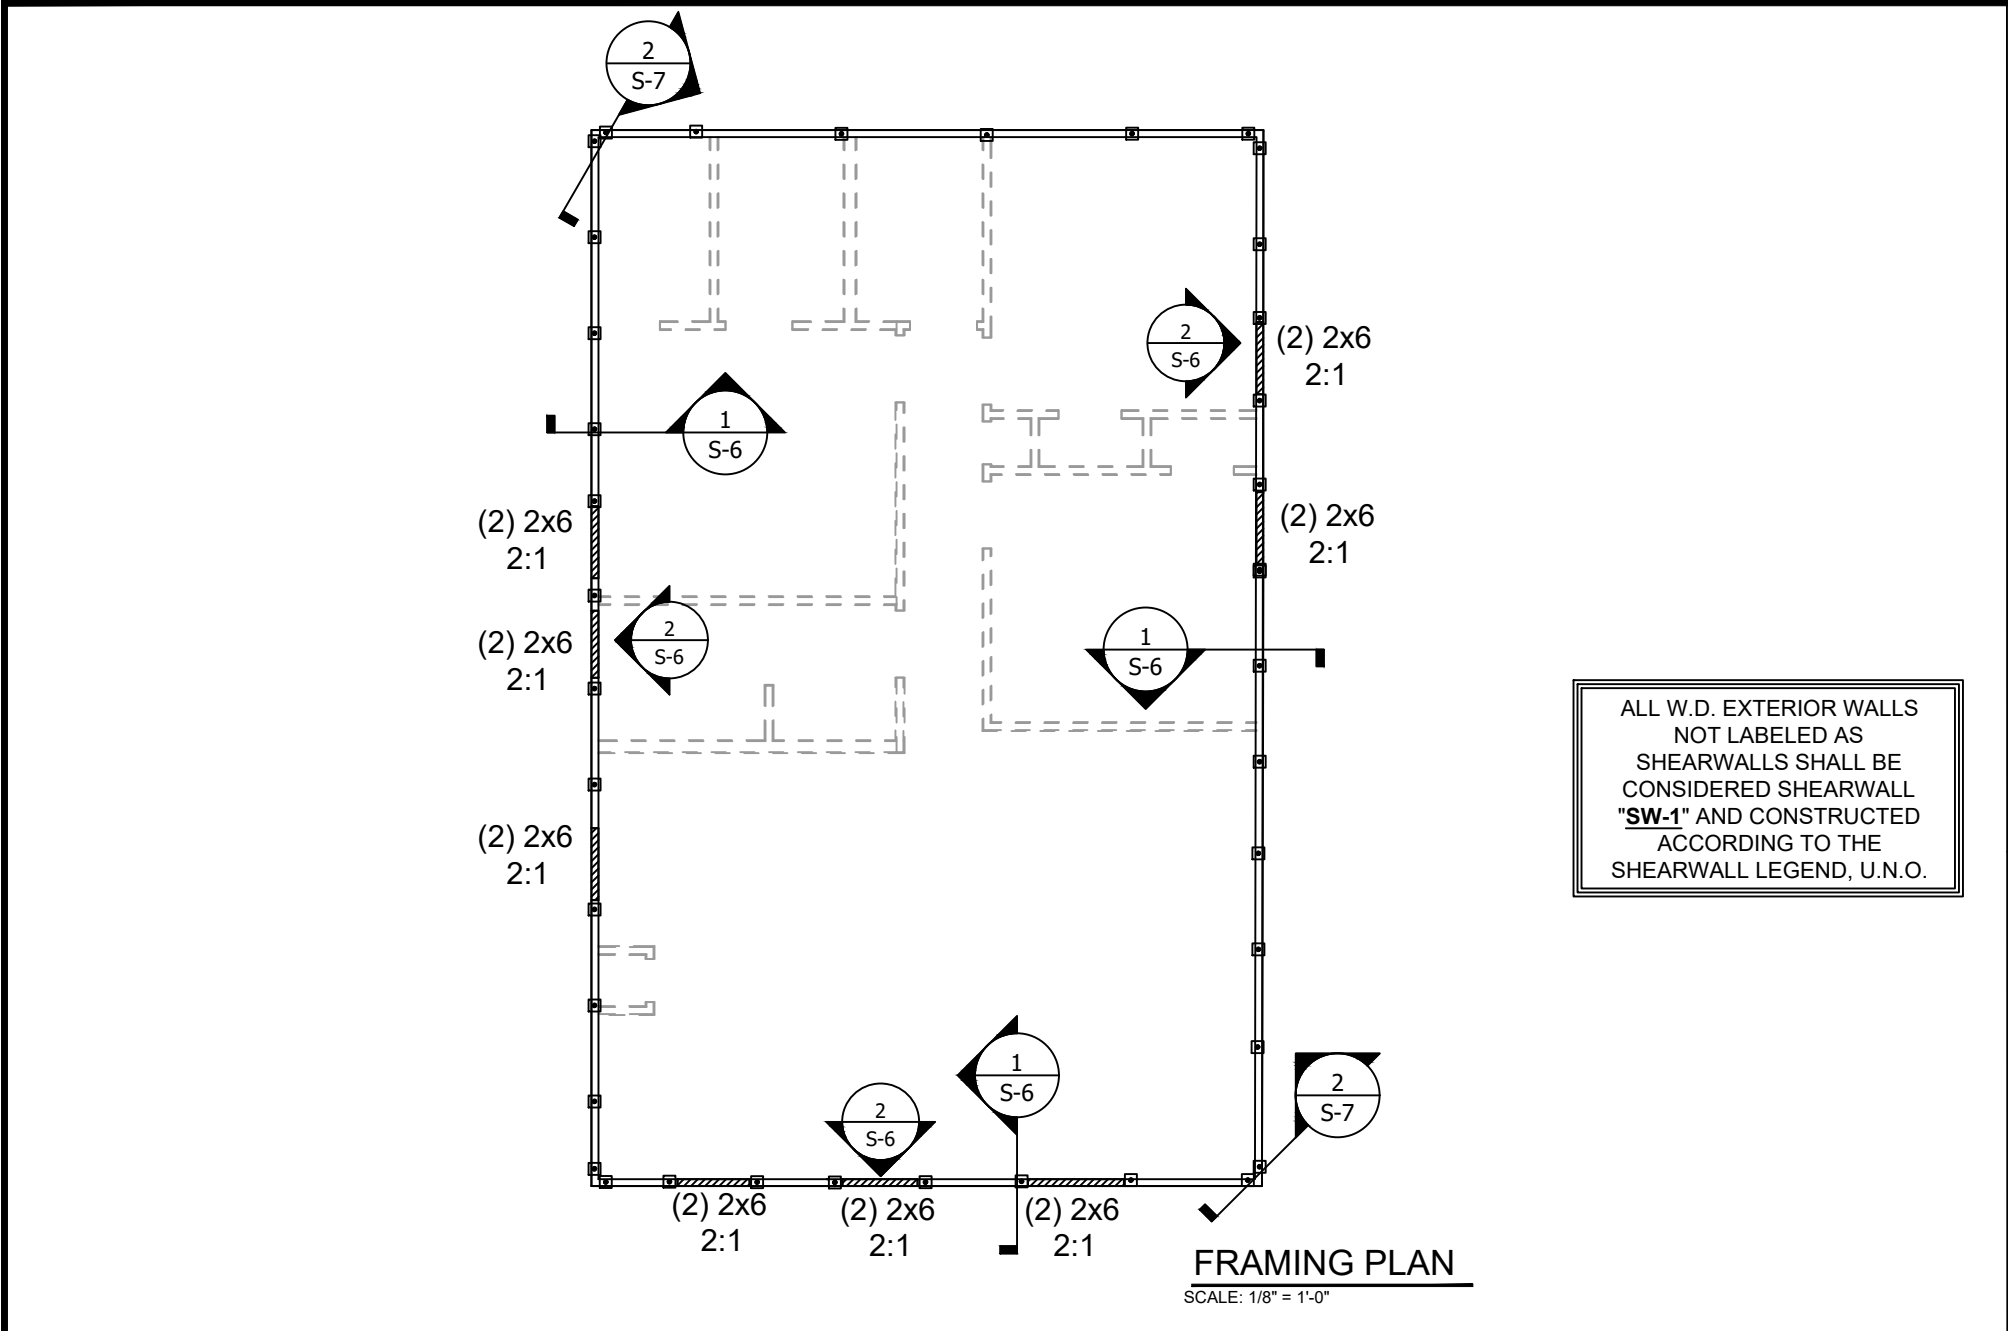SHEAR WALL LEGEND

| ID | SHEATHING | FASTENING | | | | SILL ANCHORS (STUBBIES) | END STUD GROUPS |
|------|-----------|----------------|------------------|--------|-----------|-------------------------|-----------------|
| | | VERTICAL EDGES | HORIZONTAL EDGES | | FIELD | | |
| | | | NAIL/SPACING | ROW | | | |
| SW-1 | 7/16" | 8d AT 6" | 8d AT 6" | SINGLE | 8d AT 12" | 48" O.C. | 2 |
| | | | | | | | |

1. ALL SHEATHING MUST BE MINIMUM OF $\frac{7}{16}$ " RATED OSB OR PLYWOOD & FASTENED PER THE TYPICAL DETAILS.
2. SHEATHING MAY BE INSTALLED HORIZONTALLY(U.N.O.). ALL HORIZONTAL EDGES MUST BE FULLY BLOCKED w/ 2x FRAMING LAID FLAT AGAINST BACK SIDE OF SHEATHING FOR NAILING.
3. A MINIMUM GAP OF $\frac{1}{8}$ " AT SHEATHING JOINTS MUST BE MAINTAINED.
4. HOLDDOWNS MUST BE PLACED AT EACH END OF SHEARWALL, U.N.O. SEE FRAMING PLAN/DETAILS FOR HOLDDOWNS TYPES, LOCATIONS, & INSTALLATION SPECS.
5. ALL SILL ANCHORS(STUBBIES) SHALL BE A MIN. OF 3/8" IN DIA. w/ 3"x3"x $\frac{1}{8}$ " SQUARE WASHER & NUT. PLACE ANCHORS ON EACH SIDE OF PLATE SPLICE. SEE TYPICAL ANCHOR DETAILS FOR INSTALLATION SPECS. FULL HT. ALL THREAD RODS MAY BE USED IN LIEU OF STUBBIES PROVIDED THE MINIMUM STUBBIE SPACING IN MAINTAINED.
6. EXTERIOR STUCCO FINISH REQUIRES A MIN. 15/32" RATED SHEATHING INSTALLED HORIZONTALLY w/ 2x FLAT WISE BLOCKED EDGES.
7. MINIMUM END STUDS FOR EACH SHEAR WALL SECTION ARE SHOWN IN TABLE ABOVE AND SHALL BE CONSTRUCTED PER THE TYPICAL CORNER FRAMING DETAIL.
8. SHEARWALL FASTENING SHOULD BE CONSTRUCTED PER THE TYPICAL SHEATHING FASTENING DETAILS AND NOTES.

FRAMING LEGEND

STRUCTURAL BEARING WALLS

OPENING HEADER BEAMS

SW-1

SHEARWALL SEGMENTS

No. OF PLIES

No. OF KING STUDS

SIZE OF HEADER

No. JACK STUDS

3/8" THREADED ROD AT 48" O.C.(U.N.O.) w/ 3"x3"x0.229" SQ. WASHER FROM DBL. TOP PLATE TO FTG. DRILL & EPOXY w/ MIN. 7" EMBEDMENT. PLACE WITHIN 3" OF HEADER STUD GROUP, TRUSS BEARINGS, AND AT END OF EACH SHEARWALL SEGMENT WHERE SHOWN. SEE TYP. ANCHOR DETAILS (2/S-7) FOR INSTALL SPECS.

FASTENER LEGEND

| NAIL | DIAMETER | LENGTH |
|-------------------------|---------------|-------------------|
| 8d COM./BOX | 0.131"/0.113" | 2 $\frac{1}{2}$ " |
| 8d RINGSHANK | 0.113" | 2 $\frac{3}{8}$ " |
| 10d x 1 $\frac{1}{2}$ " | 0.148" | 1 $\frac{1}{2}$ " |
| 10d COMMON | 0.148" | 3" |
| 10d RINGSHANK | 0.120" | 2 $\frac{7}{8}$ " |
| 12d COMMON | 0.148" | 3 $\frac{1}{4}$ " |
| 16d COMMON | 0.162" | 3 $\frac{1}{2}$ " |

1. ALL NAILS SHALL BE COMMON NAILS UNLESS OTHERWISE NOTED ON THE PLANS.

2. INSTALL 10d NAILS IF NOT OTHERWISE NOTED ON THE PLANS.

3. INSTALL THE APPROPRIATE FASTENERS FOR PRESSURE TREATED LUMBER. SEE NOTES ON SHEET S-1.

MARTIN ENGINEERING, LLC.

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FRAMING PLAN

NEW SINGLE FAMILY

PARCEL#14-03S-12E-10270-003000-167th RD

LIVE OAK, FL 32060


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SHEET

S-3

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| TRUSS TO TOP PLATE CONNECTOR SCHEDULE | | | | |
|---------------------------------------|------------------|-------------------------|------------------|------------------|
| TRUSS | TRUSS END | INTERIOR BEARING POINTS | | TRUSS END |
| | UPLIFT/CONNECTOR | UPLIFT/CONNECTOR | UPLIFT/CONNECTOR | UPLIFT/CONNECTOR |
| ALL TRUSSES | <615# / 1 | N/A | N/A | <615# / 1 |
| | | | | |

1. SIMPSON SDWC15600 TRUSS SCREWS THROUGH TOP PLATES/HEADERS INTO TRUSSES. INSTALL PER DETAILS AT S-8

** MULTI-PLY TRUSSES MUST HAVE (1) UPLIFT CONNECTOR PER TRUSS PLY UNLESS NOTED OTHERWISE.

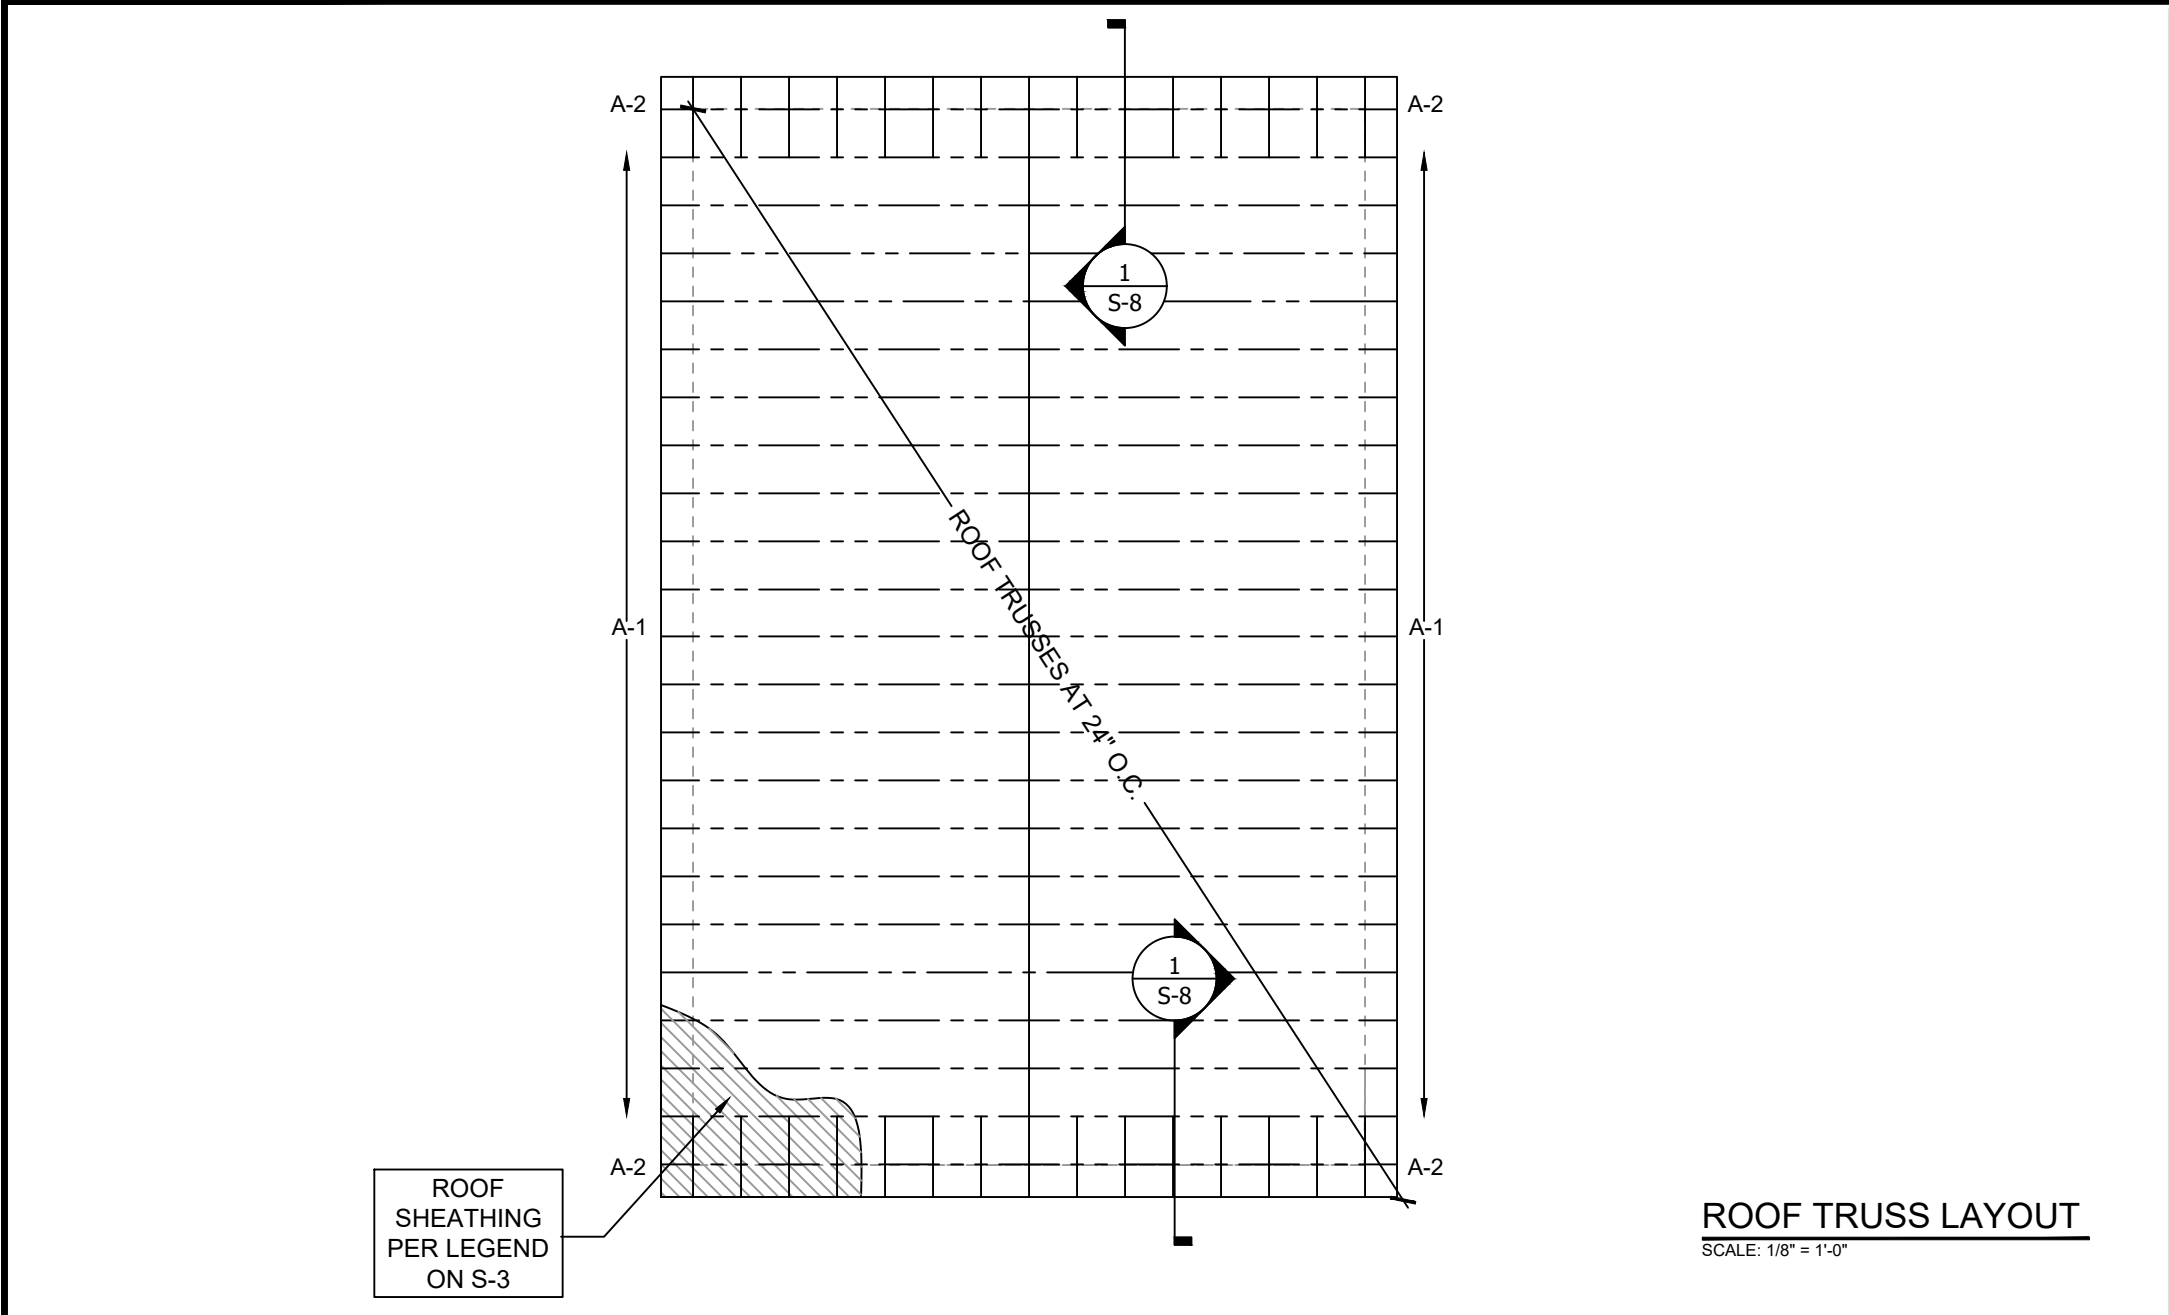- TRUSS NOTES:
1. ALL TRUSSES SHALL BE DESIGNED AND APPROVED BY THE DELEGATED TRUSS ENGINEER AND BE LICENSED IN THE STATE OF FLORIDA.

2. ALL TRUSSES SHALL BE DESIGNED TO MEET OR EXCEED THE ULTIMATE WIND SPEED, EXPOSURE CATEGORY, AND LOADINGS SPECIFIED ON THE STRUCTURAL NOTES PAGE S-1.

3. ALL ROOF AND FLOOR TRUSS ENGINEERING SHALL MATCH THE PROVIDED LAYOUT SHOWN IN THESE PLANS. ANY VARIATIONS FROM THE PROVIDED LAYOUTS SHOULD BE REPORTED TO THE ENGINEER OF RECORD BEFORE CONSTRUCTION BEGINS.

4. TRUSSES MUST BE CAPABLE OF TRANSFERRING LATERAL LOADS TO THE STRUCTURAL LOAD BEARING WALLS SHOWN ON THE FRAMING PLAN.

5. UPLIFTS HAVE BEEN CALCULATED BY THE ENGINEER OF RECORD AND ALL CONNECTIONS FROM TRUSSES TO STRUCTURE HAVE BEEN SPECIFIED AND SHOULD BE FOLLOWED. ANY QUESTIONS AS TO THE SIZE, TYPE, OR VALUE OF A NAIL, STRAP OR CLIP SHOULD BE VERIFIED BY THE STRUCTURAL ENGINEER.

6. PERMANENT TRUSS WEB BRACING SHALL BE INSTALLED WITH THE SAME QUANTITY AND LOCATIONS SHOWN ON THE TRUSS ENGINEERING SHOP DRAWINGS. CONTINUOUS LATERAL BRACING SHALL BE IN ACCORDANCE WITH THE DETAILS

7. GYPSUM CEILING: FASTENING SHALL BE IN ACCORDANCE w/ TABLE R702.3.5 OF THE FBC.

8. TABLE 2304.9.1 OF THE FLORIDA BUILDING CODE NAILING REQUIREMENTS ARE IN ADDITION TO THE STRAPPING REQUIREMENTS.

9. PROVIDE 5/8" TYPE X GYP. BD. @ GARAGE CLG. BENEATH HABITABLE SPACE & 1/2" MIN GYP. BD. @ GARAGE SIDE WALLS & UNDERSIDE OF STAIRWAY IF USED AS ACCESSIBLE SPACE.

10. ALL TRUSS FABRICATION, HANDLING, SHIPPING, INSTALLING, AND BRACING SHALL BE IN ACCORDANCE WITH BCSI 1-03 MANUAL (BUILDING COMPONENT SAFETY INFORMATION) PRODUCED BY THE SBCA AND TPI.
- OVER FRAMING NOTES:
1. ALL ROOF FRAMING MATERIALS SHALL BE No. 2 SOUTHERN YELLOW PINE (SYP) AT 24" O.C., U.N.O.


2. ALL ROOF RAFTERS AND COLLAR TIES TO BE A MIN. OF 2x6 No. 2 SYP. RIDGE BOARDS TO BE MIN. OF 2x8 No. 2 SYP.

3. ALL SLEEPERS TO BE A MIN. OF 2x8 No. 2 SYP FASTENED TO EACH TRUSS/RAFTER BELOW w/ (2) #10x3.5" W.D. SCREWS & WASHERS.


4. FASTEN ROOF RAFTERS TO RIDGE BOARDS AND "SLEEPERS" W/ SIMPSON A35 CLIPS, U.N.O.

5. FASTEN COLLAR TIES TO ROOF RAFTERS W/ (5) 10d NAILS AT EACH END.


6. COLLAR TIES SHALL NOT TO BE FASTENED LOWER THAN 2/3 OVERALL ROOF RAFTER HEIGHT.

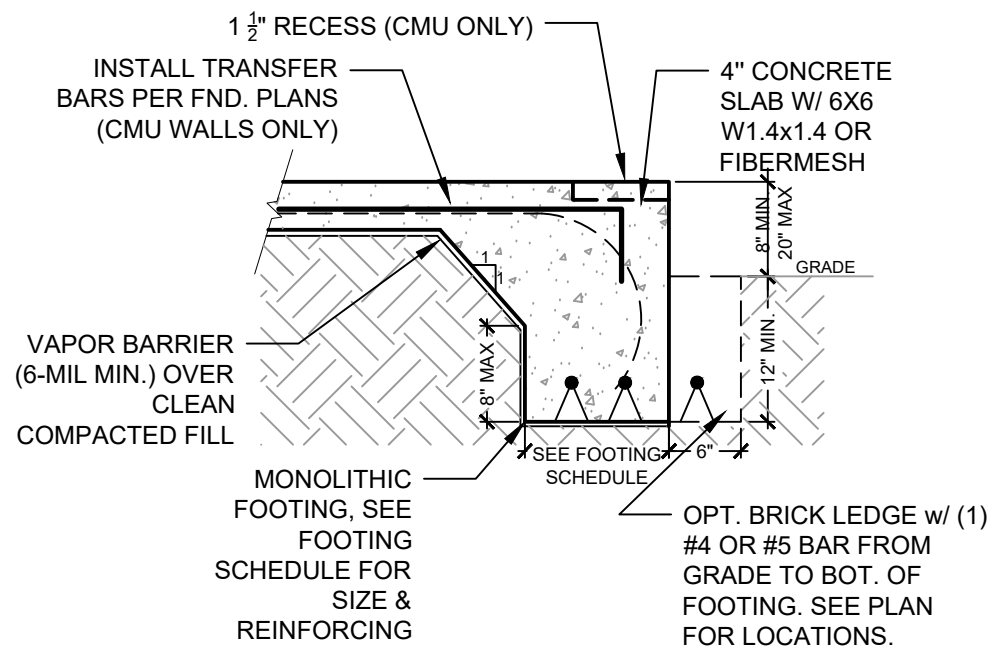


1 EXTERIOR MONOLITHIC FOOTING

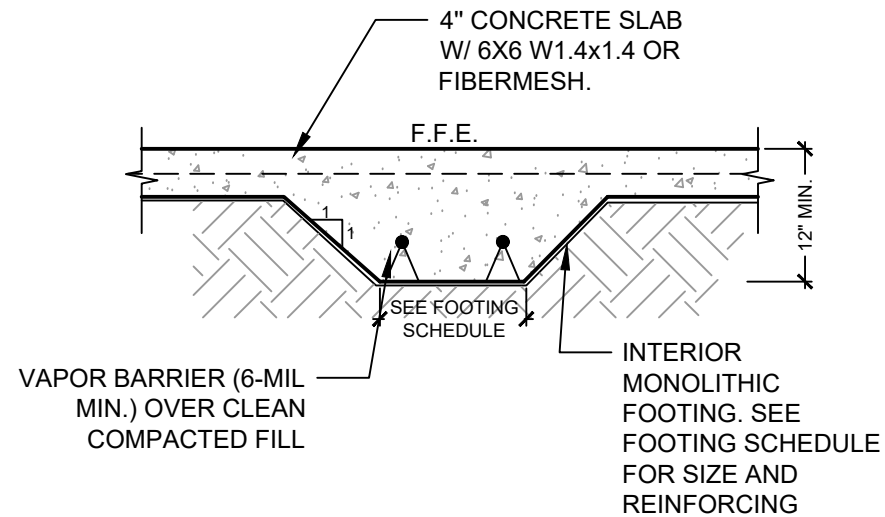


2 INTERIOR MONOLITHIC FOOTING

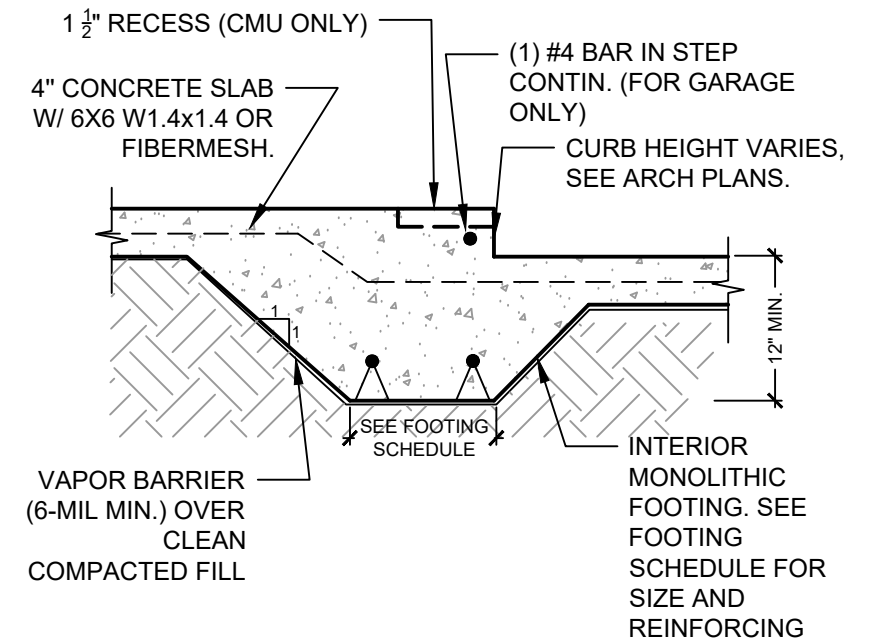


3 INTERIOR MONOLITHIC FTG.

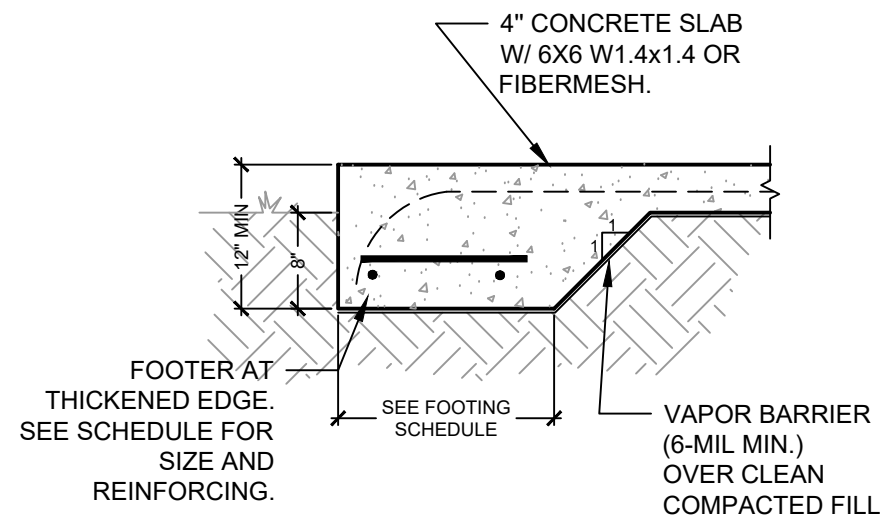

4 SPREAD FTG. AT THICKENED EDGE

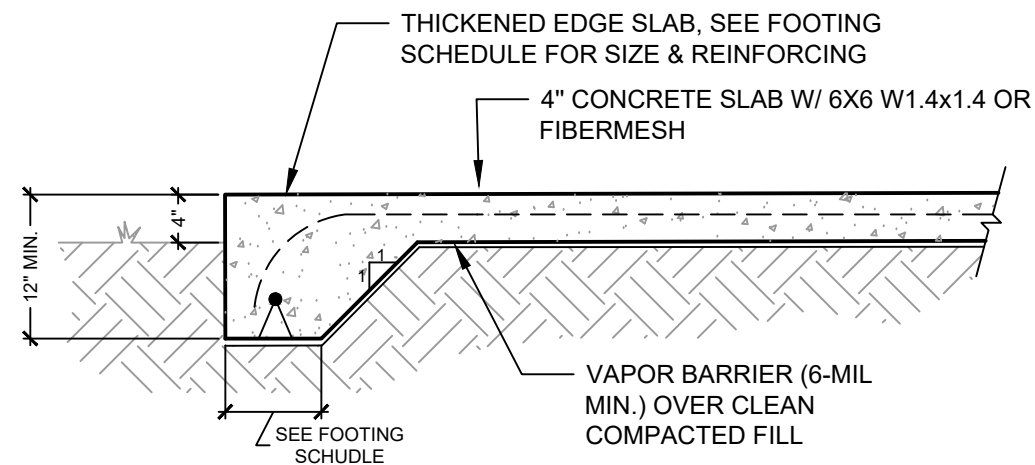

5 THICKENED EDGE SLAB

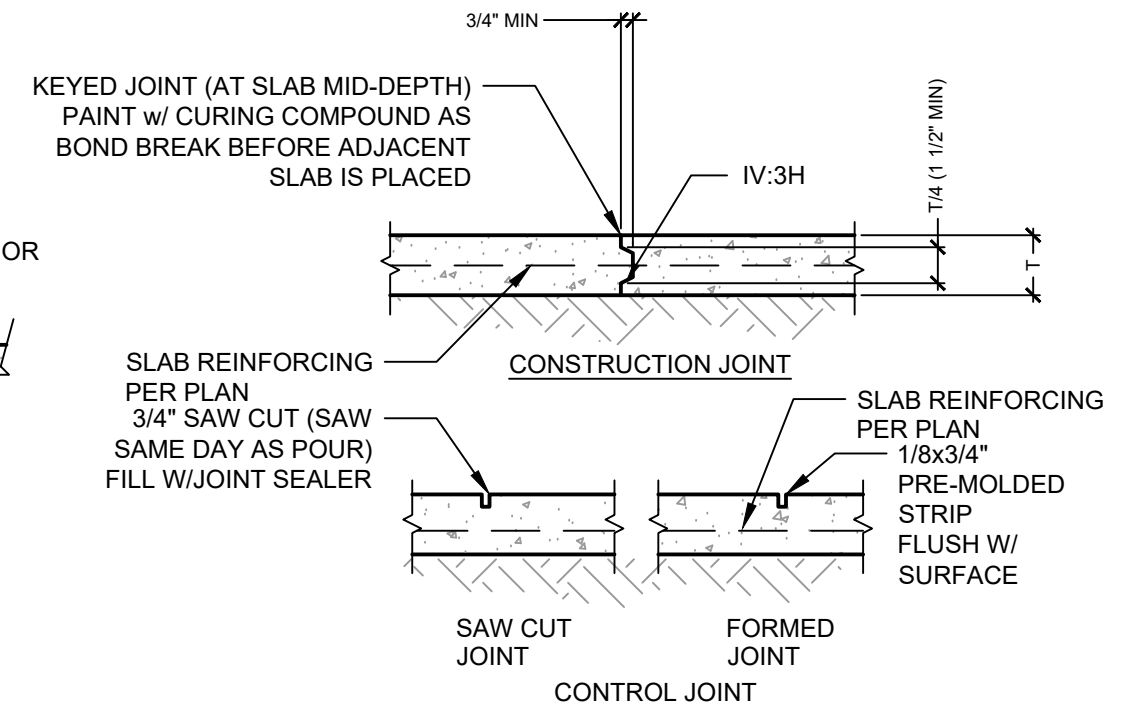

NOTE: CONTROL JOINTS TO BE 15'-0" OC MAX

6 TYPICAL JOINT DETAILS



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FOUNDATION DETAILS

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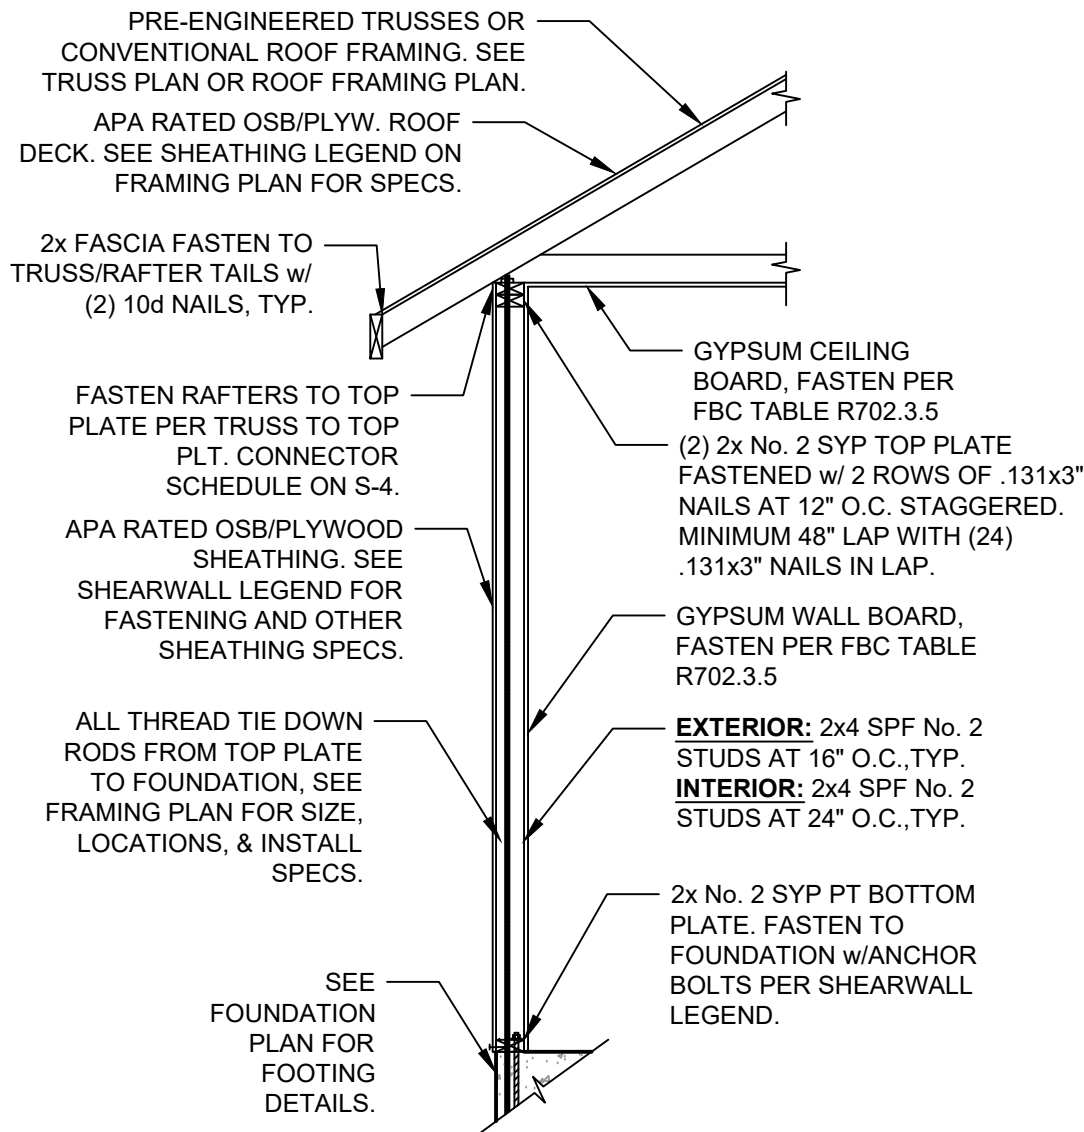
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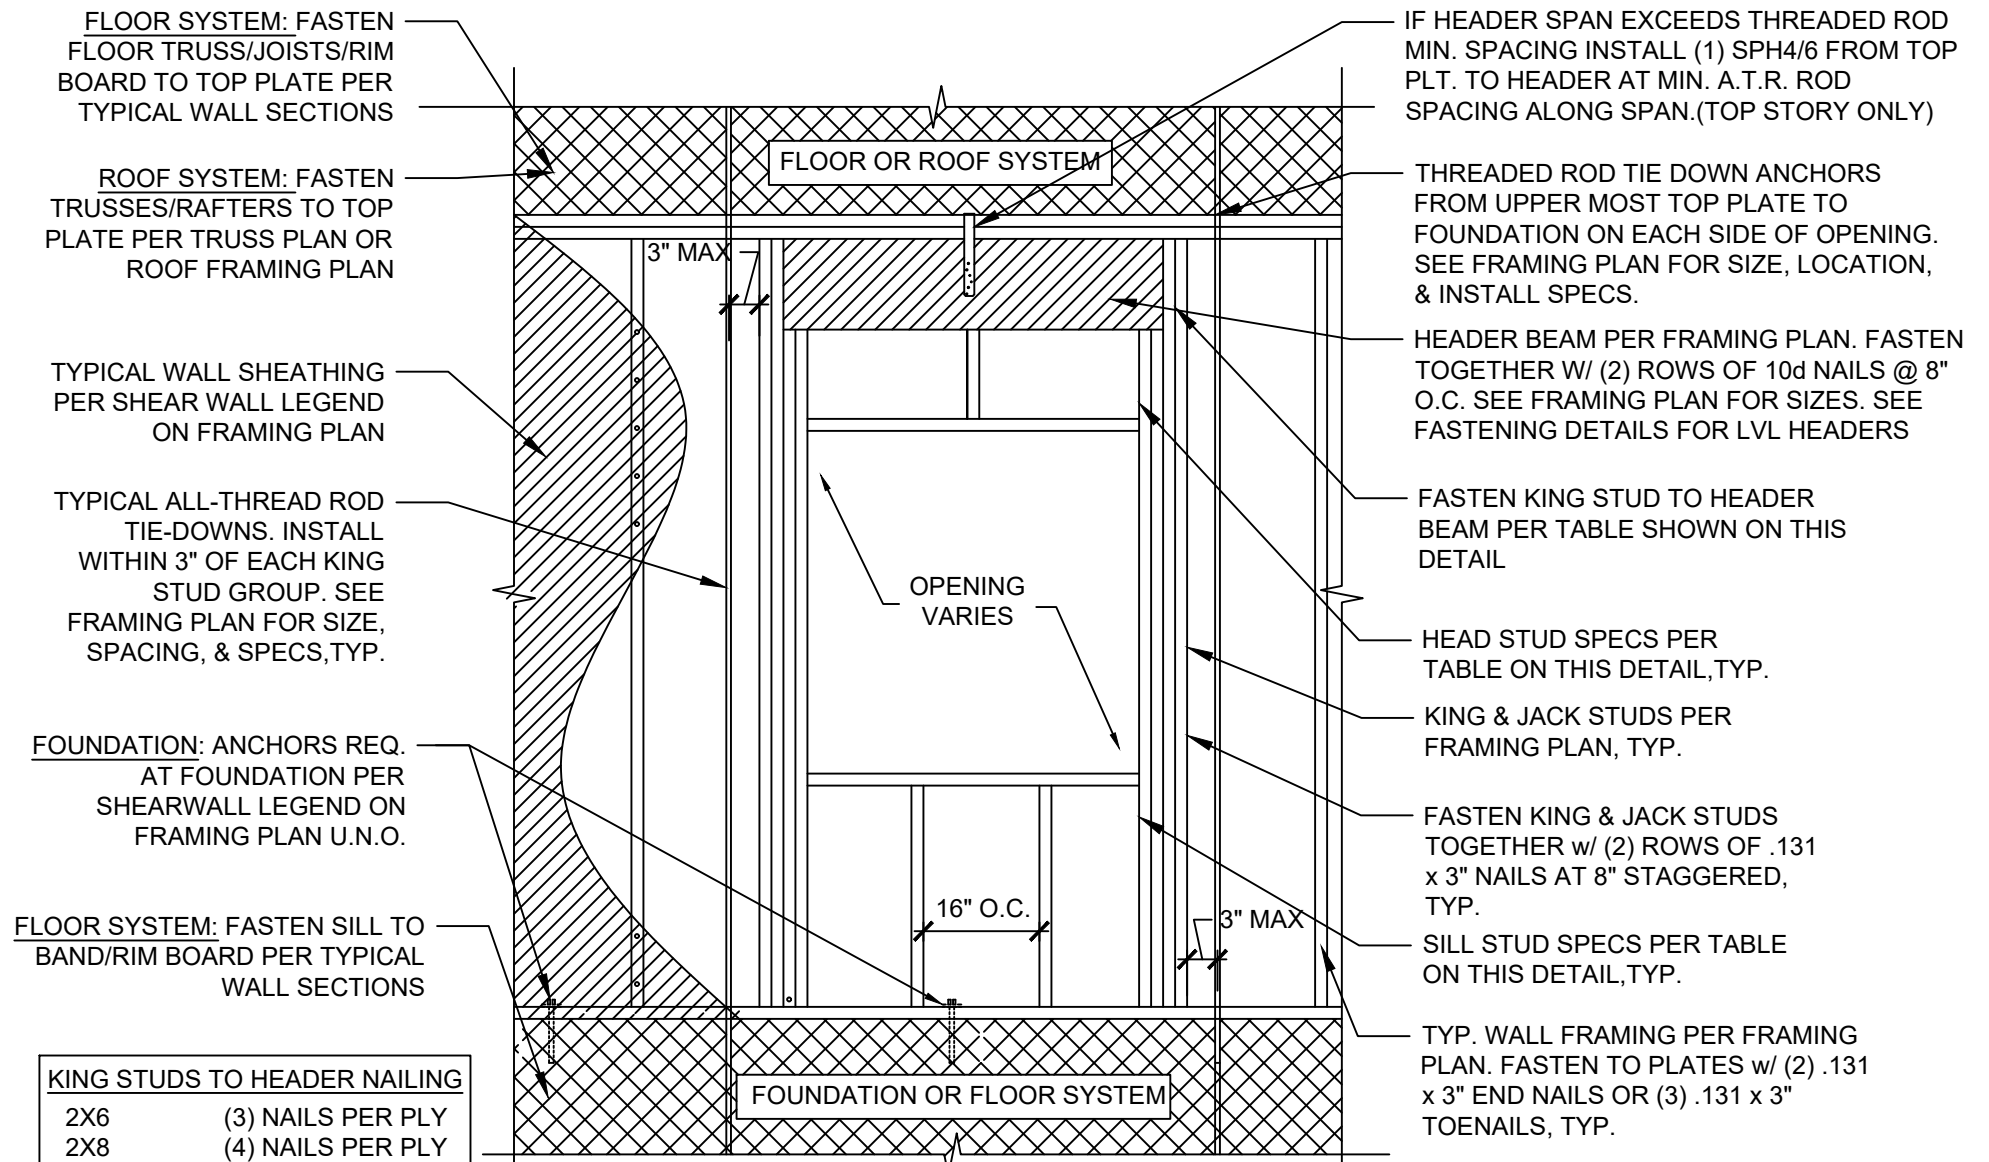
KEVIN C. MARTIN, P.E# 80359

SHEET

S-5



1 1-STORY WOOD



| KING STUDS TO HEADER NAILING | |
|------------------------------|-------------------|
| 2X6 | (3) NAILS PER PLY |
| 2X8 | (4) NAILS PER PLY |
| 2X10 | (5) NAILS PER PLY |
| 2X12 | (6) NAILS PER PLY |
| 9.5" LVL | (5) NAILS PER PLY |
| 11 7/8" LVL | (6) NAILS PER PLY |
| 14" LVL | (7) NAILS PER PLY |
| 16" LVL | (8) NAILS PER PLY |

| OPENING HEAD/SILL STUD SPECS | |
|----------------------------------|------------------------|
| OPENING WIDTH | ATTACHMENT |
| 0' - 8" | (3) .131"x3" TOE-NAILS |
| 8' - 12' | (6) .131"x3" TOE-NAILS |
| 12' - 18' | (2) A35 CLIPS |
| 2-PLY HEAD/SILL STUDS: 6' - 10' | |
| 3-PLY HEAD/SILL STUDS: 10' - 18' | |

2 TYPICAL HEADER DETAIL



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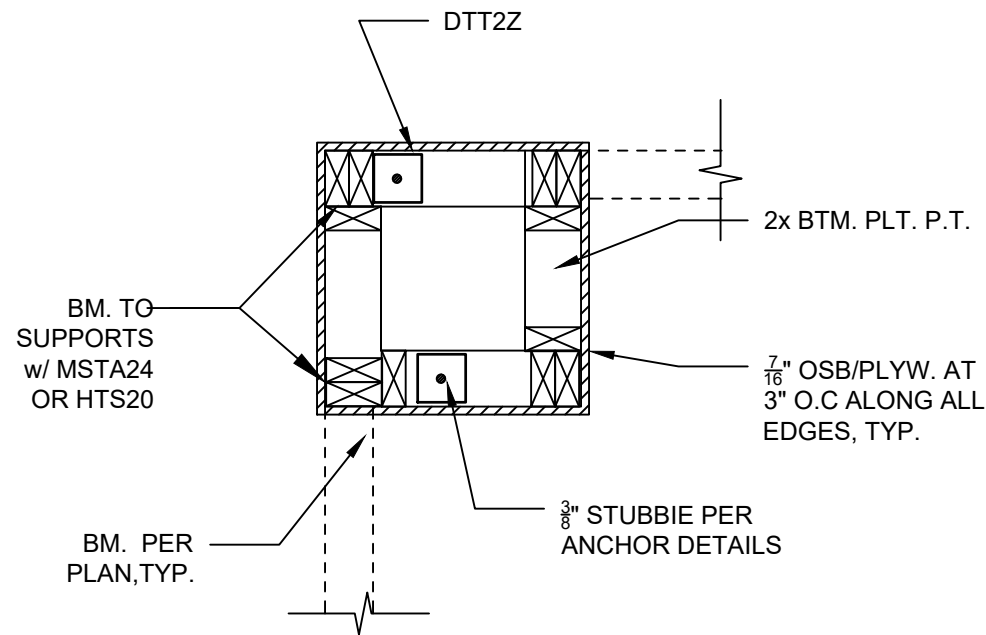
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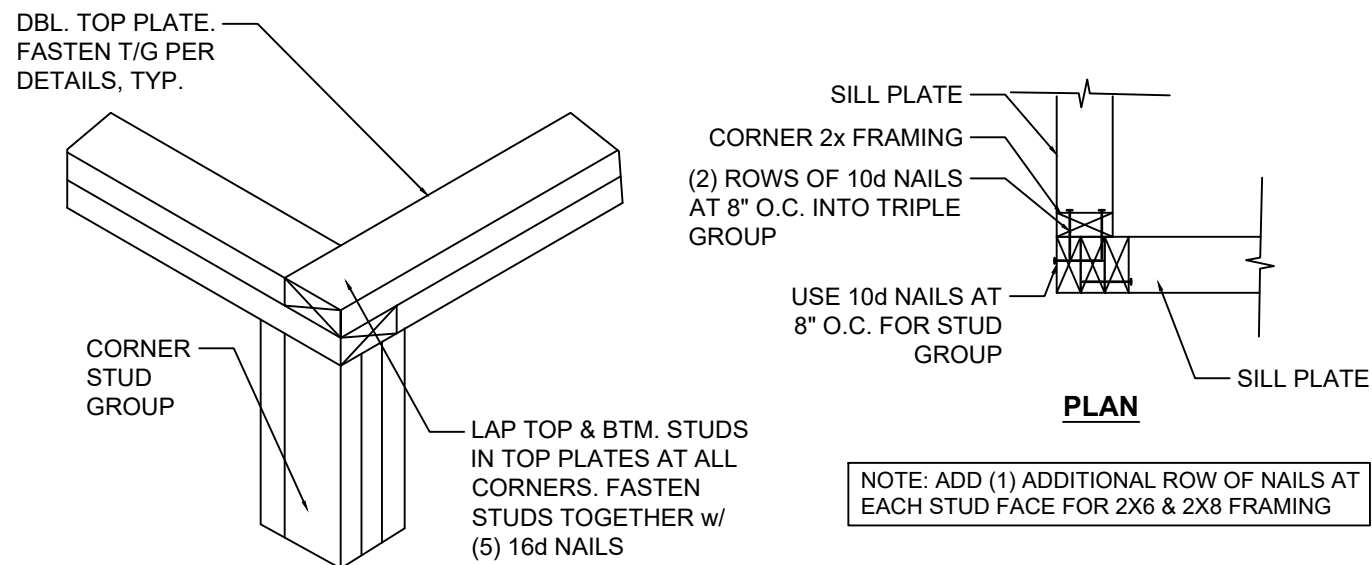
SHEET

S-6




1 TYP. BOX COLUMN DETAIL


NOTE: ANY FRAMING/SHEATHING WITHIN 6" OF EXIST. GRADE SHALL BE PRESSURE TREATED PER FBC.



2 CORNER FRAMING DETAIL

NOTE: ADD (1) ADDITIONAL ROW OF NAILS AT EACH STUD FACE FOR 2X6 & 2X8 FRAMING

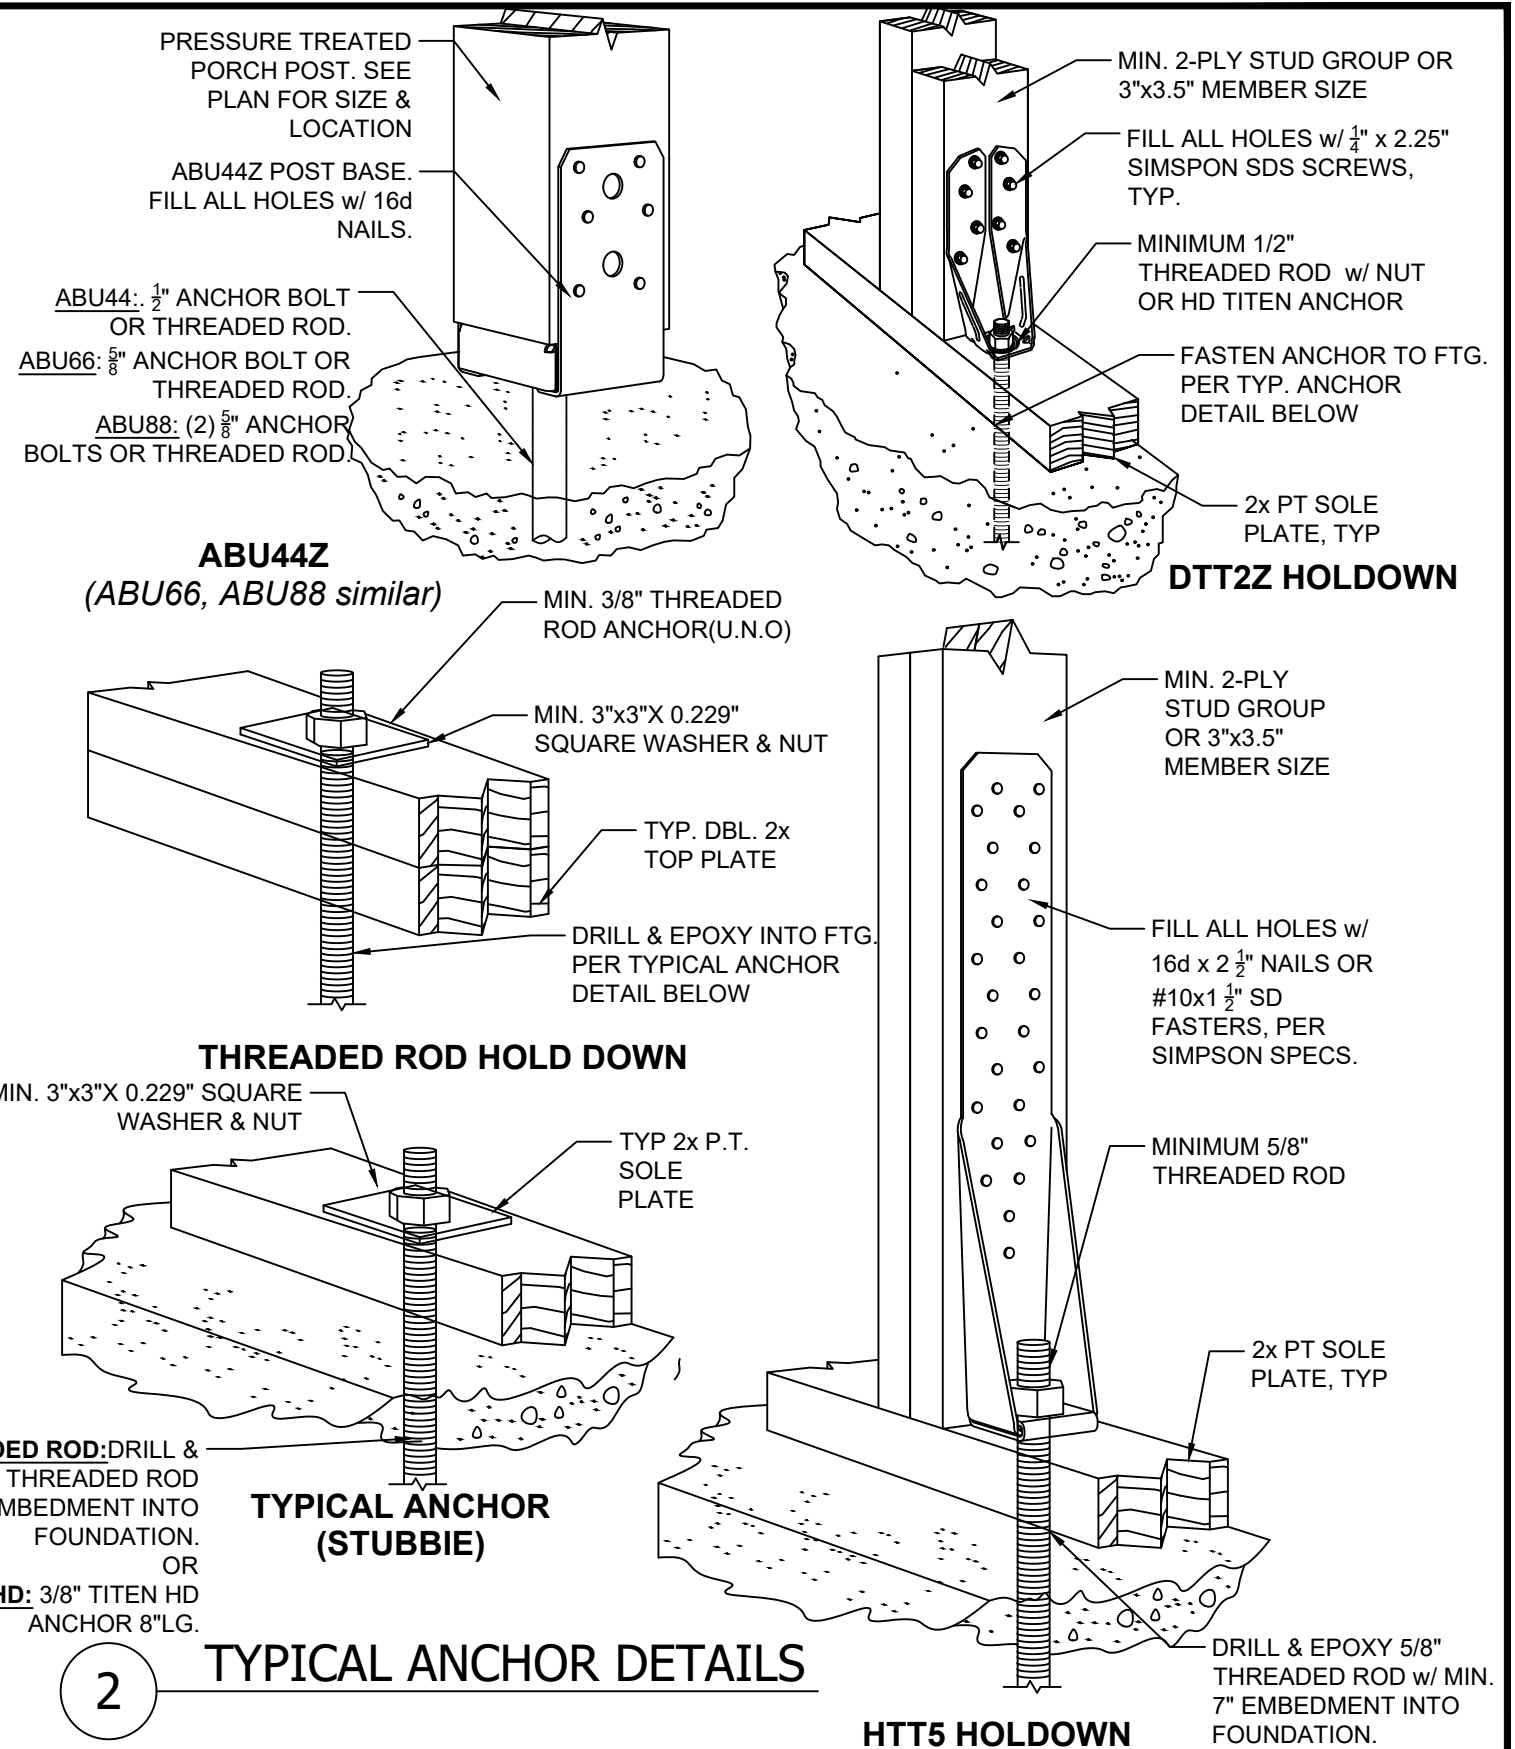

| | | | | | | | | | | | | |
|--|--|------|-------------|----------|-----------------|----------|-----------|---------|---|------------------|--|--|
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