




A EXTERIOR WALL SECTION

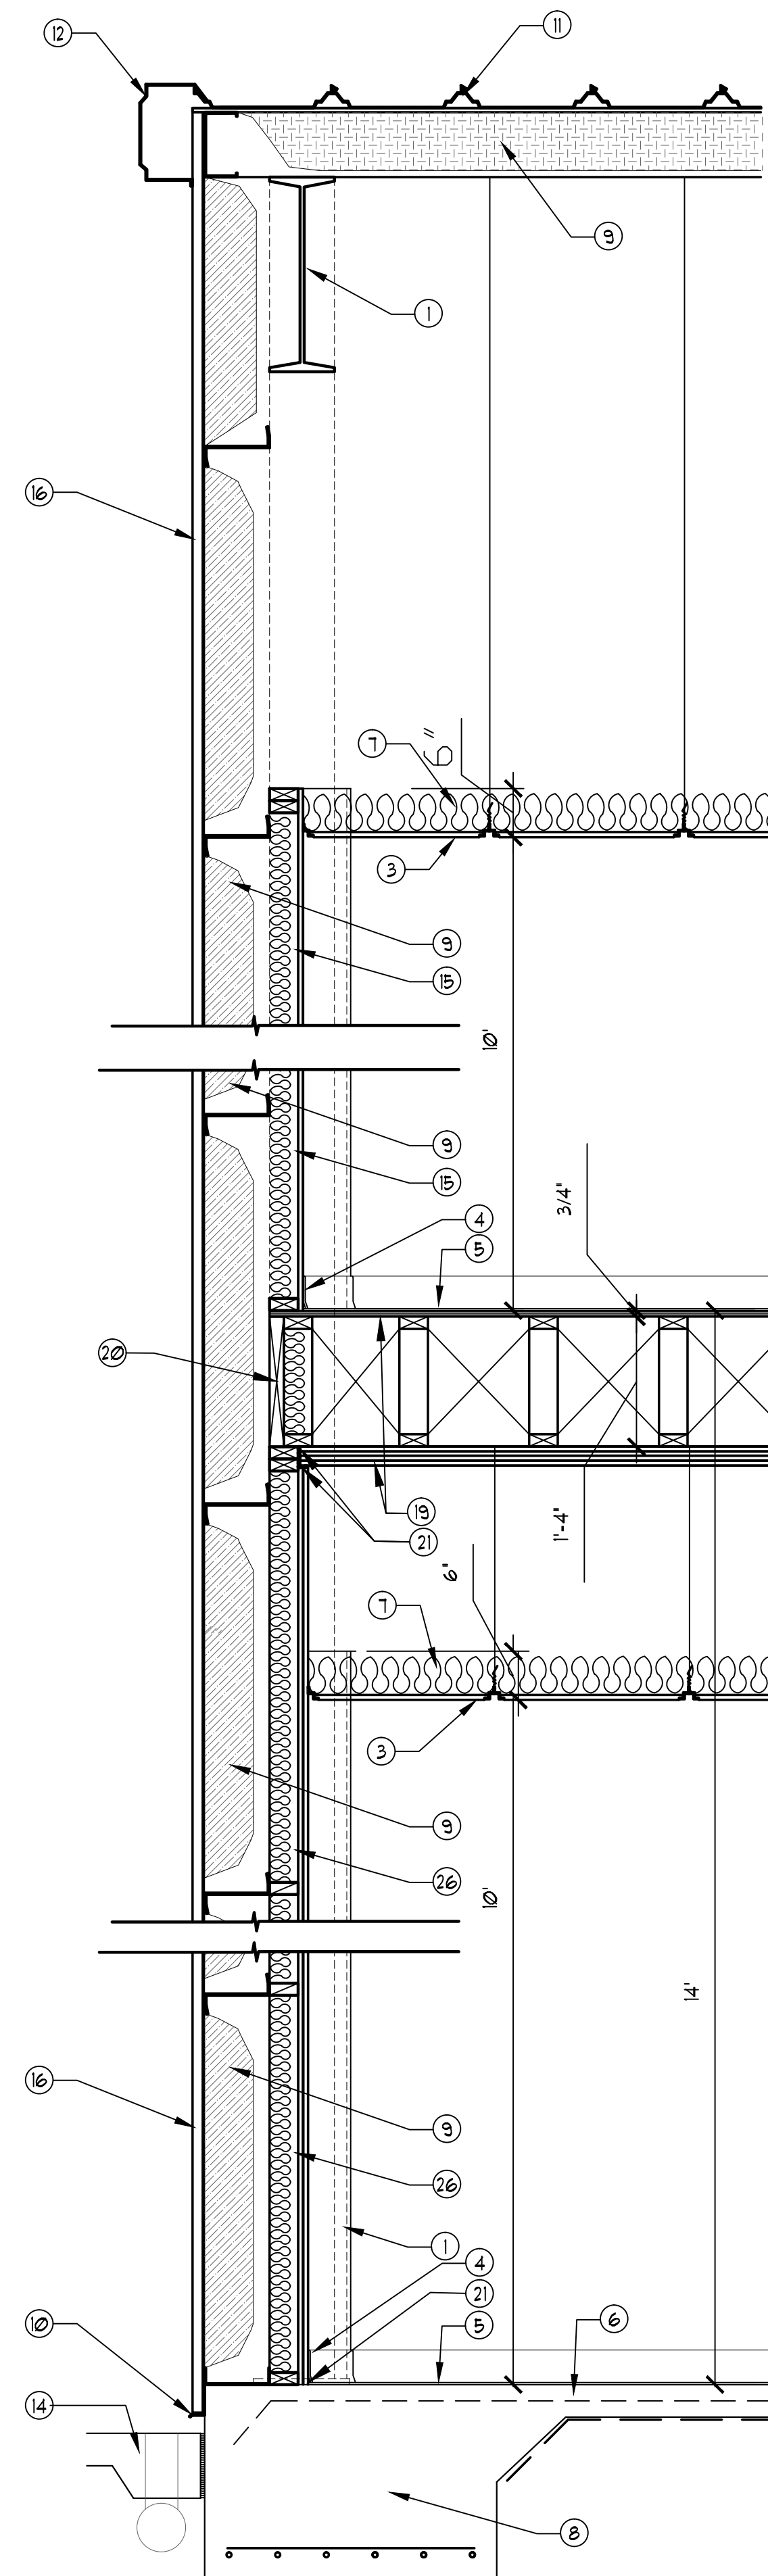

B EXTERIOR WALL SECTION

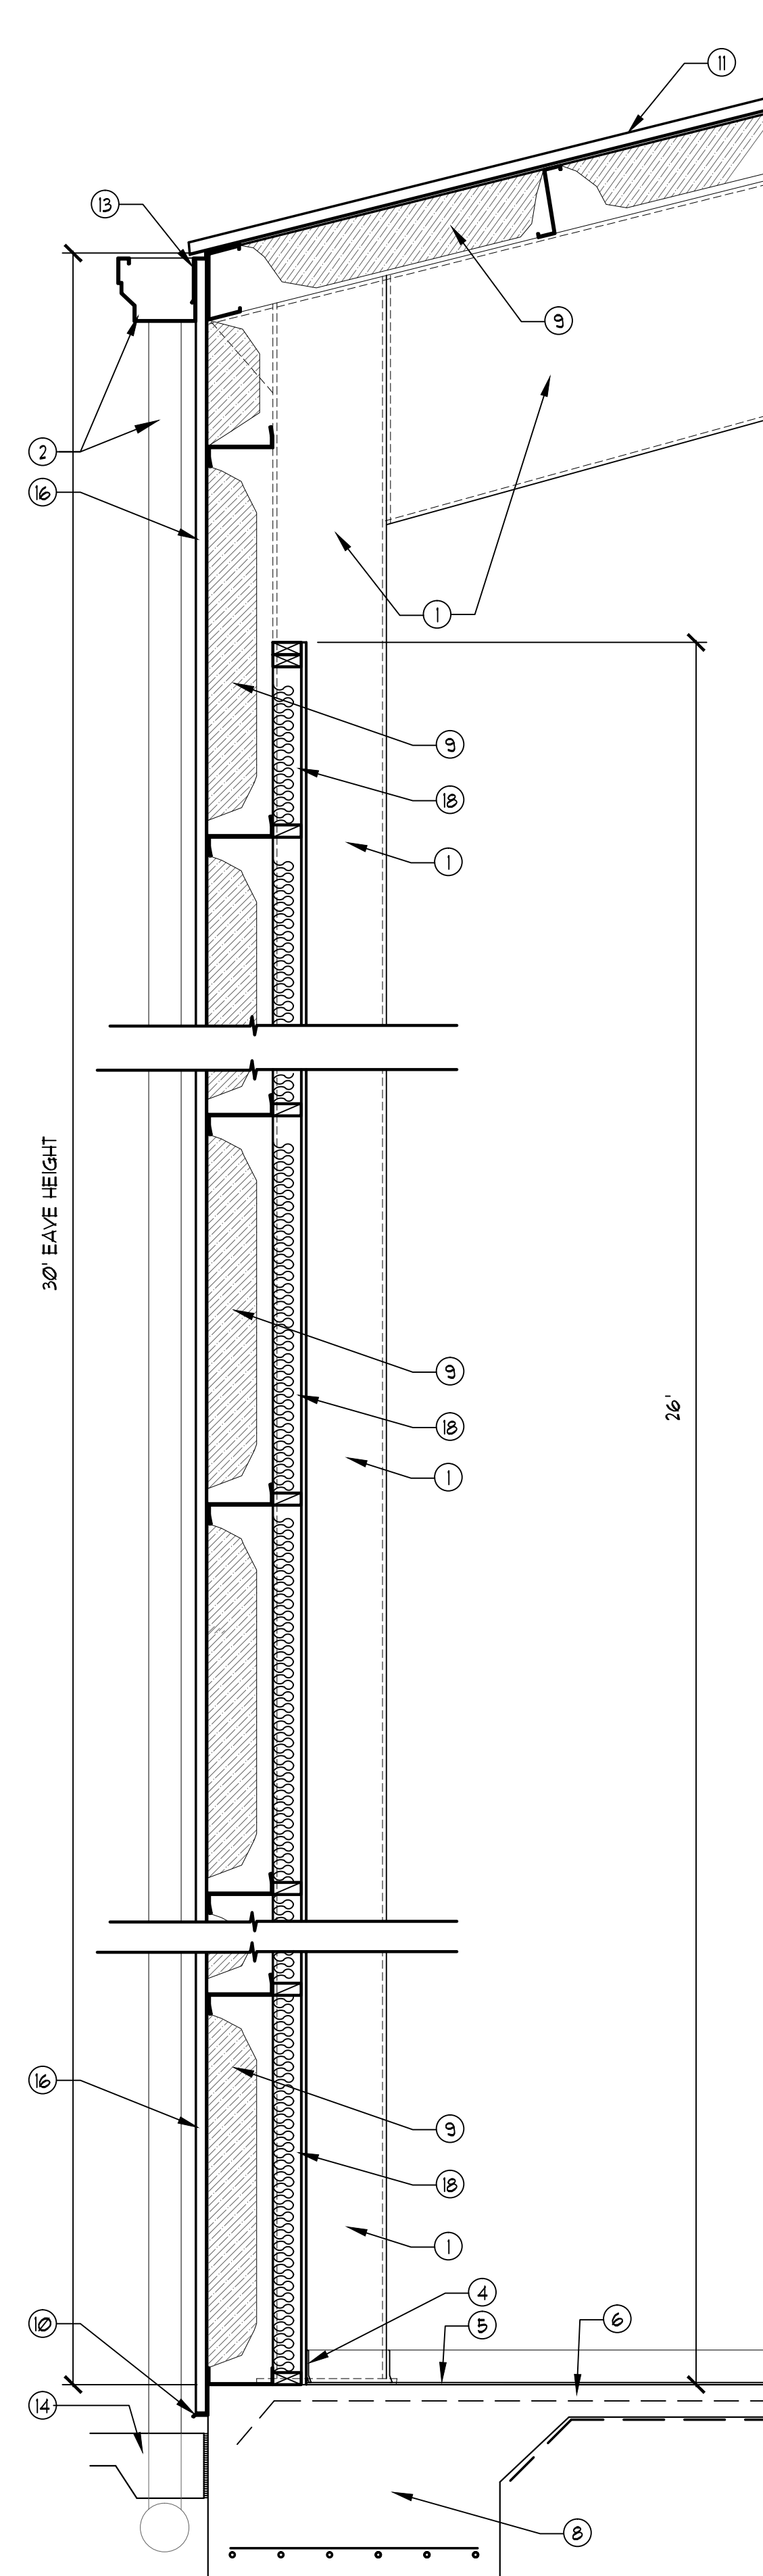

C EXTERIOR WALL SECTION

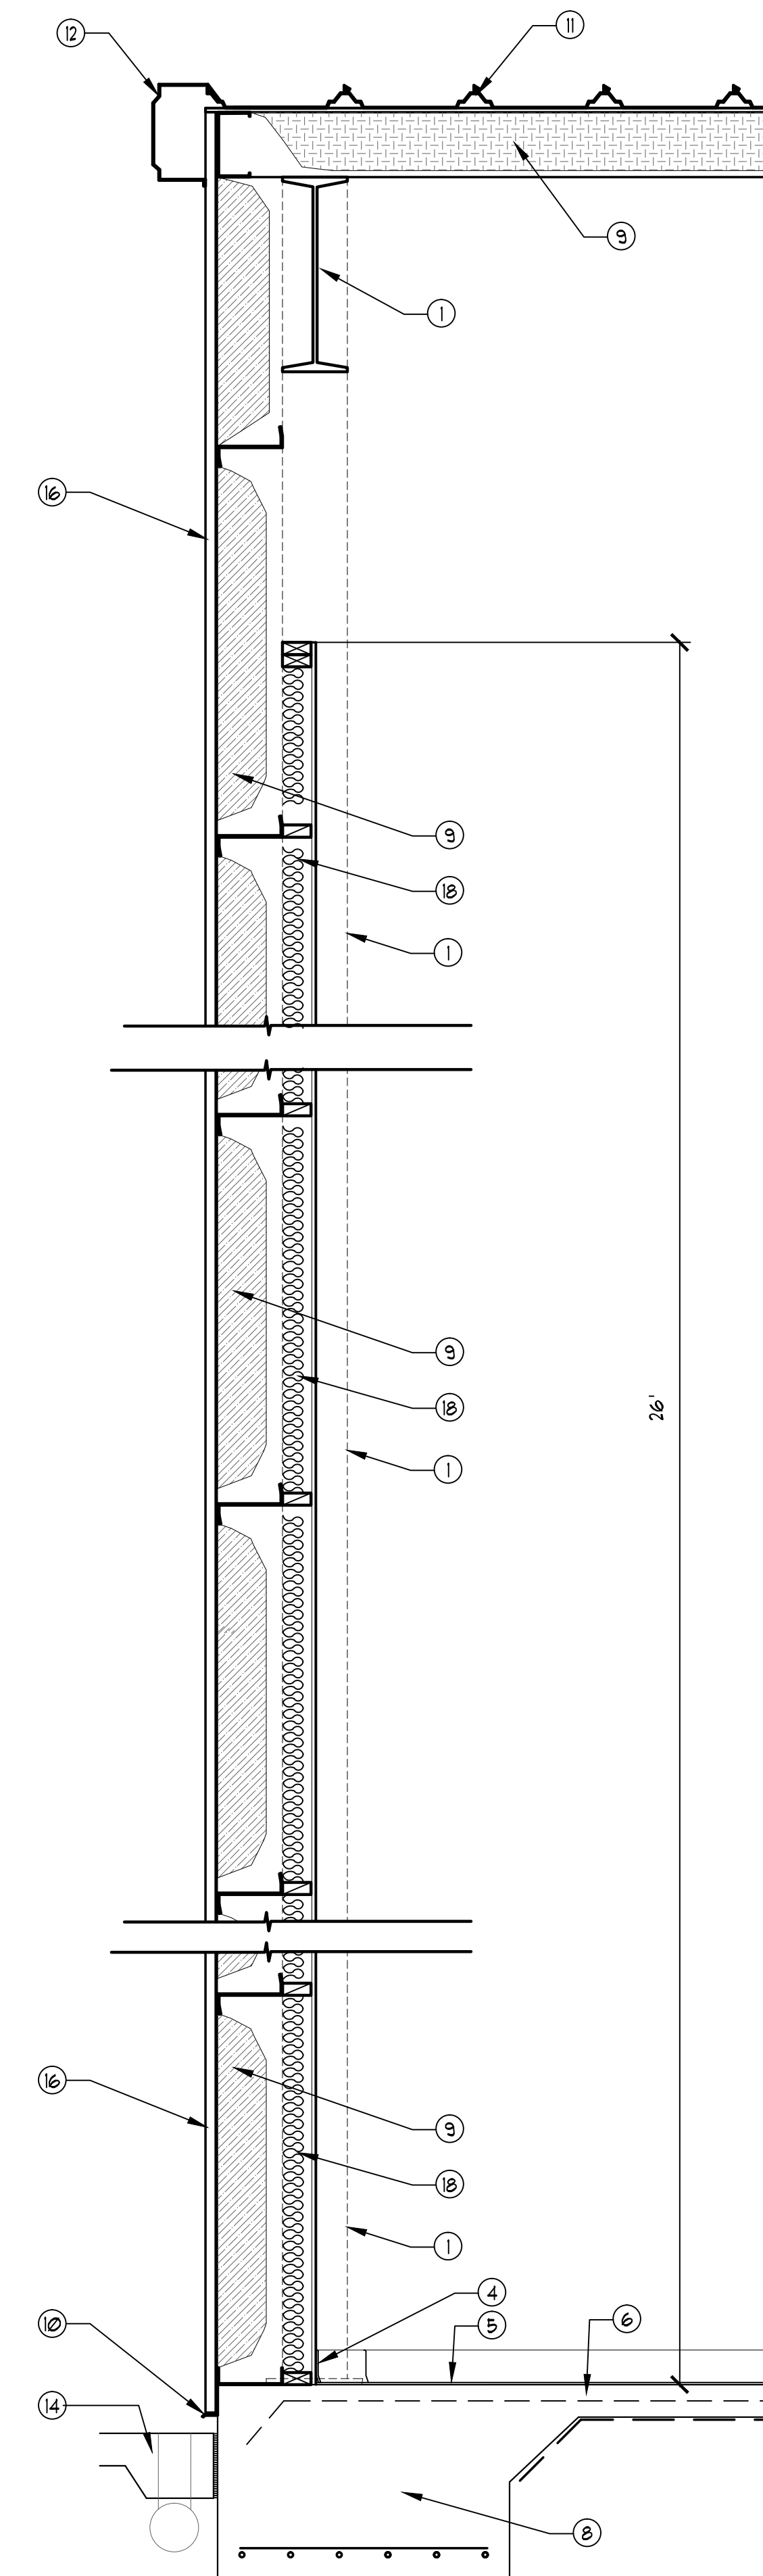

D EXTERIOR WALL SECTION

KEY NOTES

- ① PRE-ENGINEERED METAL BUILDING STRUCTURAL MAIN FRAME.
- ② 8" MT. BUILDING GUTTER & 6" SQUARE DOWNSPOUTS SIZED AND FURNISHED (BY METAL BUILDING MANUF.) TIE INTO UNDERGROUND STORMWATER PER CIVIL.
- ③ SUSPENDED ACOUSTICAL CEILING SYSTEM, ON PREFINISHED ALUM GRID, WITH REGULAR EDGE 2X2" CEILING TILES.
- ④ WALL BASE AS SPECIFIED IN FINISH SCHEDULE.
- ⑤ NEW FLOOR FINISH PER OWNER.
- ⑥ 4" CONC SLAB (SEE STRUCTURAL) W/ 6 MIL VAPOR BARRIER OVER WELL COMPACTED FILL AND TERMITE TREATMENT AS PER FLORIDA CODE
- ⑦ R-19 UNFACED BATT INSULATION LAYED ON TOP OF NEW SUSP. CEILING.
- ⑧ REINFORCED CONCRETE FOOTER, SEE STRUCTURAL FOR SIZE AND REINFORCEMENT REQUIRED.
- ⑨ R-1 VINYL FACED INSUL. BY METAL BUILDING MANUF.
- ⑩ METAL BUILDING WALL PANEL BASE FLASHING - CONTINUOUS.
- ⑪ PRE-FINISHED METAL BUILDING ROOF PANELS, PER METAL BUILDING MANUFACTURER FASTEN TO ROOF PURLING PER MANUFACTURER'S SHOP DRAWINGS.
- ⑫ PRE-FINISHED METAL BUILDING RAKE EAVE FLASHING
- ⑬ PRE-FINISHED METAL BUILDING EAVE FLASHING
- ⑭ CONCRETE SIDEWALKS SLOPE AWAY FROM BUILDING (MAX SLOPE 4%)
- ⑮ INTERIOR NON-BEARING WALL, 2X4 AT 16' O.C. BLOCKING AT MID-HEIGHT. SHEATHED ON EXPOSED INTERIOR SIDE WITH 1/2" GYP. BD. ALL CAVITIES FILLED WITH 4" THICK (R-13) BATT INSULATION.
- ⑯ PRE-FINISHED METAL BUILDING WALL PANELS, ANCHORED TO PRE-ENGINEERED METAL BUILDING COMPONENTS AS ILLUSTRATED IN METAL BUILDING SHOP DRAWINGS.
- ⑰ INTERIOR BEARING WALL, 2X4 AT 16' O.C. HORIZONTAL BLOCKING AT 4'-0" O.C. VERTICALLY. SHEATHED ON EXPOSED INTERIOR SIDE WITH 1/2" GYP. BD. ALL CAVITIES FILLED WITH 4" THICK (R-13) BATT INSULATION.
- ⑱ INTERIOR NON-BEARING GYMNASIUM WALL, 2X4 AT 16' O.C. HORIZ. BLOCKING AT 4'-0" O.C. VERTICALLY. SHEATHED ON EXPOSED INTERIOR SIDE WITH 1/2" GYP. BD. ALL CAVITIES FILLED WITH 4" THICK (R-13) BATT INSULATION.
- ⑲ 2-HR FIRE RATED FLOOR CEILING SYSTEM (UL DES. # L530)
PRE-ENGINEERED WOOD FLOOR JOISTS AT 16' O.C. MAX, WITH A 3/4" T&G STRUCTURAL PLYWOOD FLOOR DECK INSTALL PERPENDICULAR TO JOISTS ON THE TOP. THE BOTTOM OF THIS SYSTEM SHALL HAVE ONE LAYER OF 5/8" TYPE-X GYP. BD. SCREW ATTACHED TO THE BOTTOM OF THE WOOD TRUSSES, THEN 1/2" METAL (26 GA.) GALV. HAT FURRING CHANNELS AT 16' O.C. AND ONE SCREW ATTACHED BELOW THE FIRST GYP. BD. LAYER. THEN (7) TWO ADDITIONAL LAYERS OF 5/8" TYPE-X GYP. BD. SHALL BE SCREW ATTACHED TO THE BOTTOM OF THE HAT CHANNELS. ALL JOINTS SHALL BE TAPE & FLOATED.
- ⑳ FULL FLOOR SYSTEM HEIGHT RM JOIST, FIRE BLOCKING FOR FLOOR SYSTEM AT ALL EXTERIOR EDGES.
- ㉑ FIRE CAULKED CONT. JOINTS.
- ㉒ (2) 2X12 WOOD HEADER
- ㉓ INTERIOR SLOPED CAP WALL, 16' O.C. SHEATHED ON EXPOSED INTERIOR SIDE WITH 1/2" GYP. BD. ALL CAVITIES FILLED WITH 4" THICK (R-13) BATT INSULATION.
- ㉔ 2X6 WOOD JOISTS @ 16' O.C., HORIZONTAL SOFFIT FRAMING, SHEATHED ON UNDERSIDE WITH 5/8" PLYWOOD SHEATHING, AND FINISHED ON EXTERIOR FACE WITH A HARD-COAT STUCCO SYSTEM APPLIED TO A 5/8" BACKER BOARD. BACKER-BOARD MATERIAL SHALL BE AS REQUIRED BY THE SELECTED STUCCO SYSTEM SPECIFICATIONS. ALL WALL CAVITIES SHALL BE FILLED WITH 4" THICK (R-13) BATT INSULATION.
- ㉕ 2X6 WOOD JOISTS @ 16' O.C., HORIZONTAL SOFFIT FRAMING, SHEATHED ON UNDERSIDE WITH 5/8" GYP. BOARD.
- ㉖ 2-HR FIRE RATED INTERIOR BEARING WALL (UL DES. # E201), 2X4 AT 16' O.C. HORIZONTAL BLOCKING AT 4'-0" O.C. VERTICALLY. SHEATHED ON EXPOSED INTERIOR SIDE WITH (2) TWO LAYERS OF 5/8" TYPE-X GYP. BD. ALL CAVITIES FILLED WITH 4" THICK (R-13) BATT INSULATION.


REVISIONS
RELEASED FOR PERMITTING
05-8-2016

ARCHITECT'S SEAL & SIGNATURE



creating architecture as an art form

Charles E. Kunze Jr. 25 W. Cedar St., Suite #14, Pensacola, FL 32502
850-432-8438
LOHMAN REGISTRATION 1987

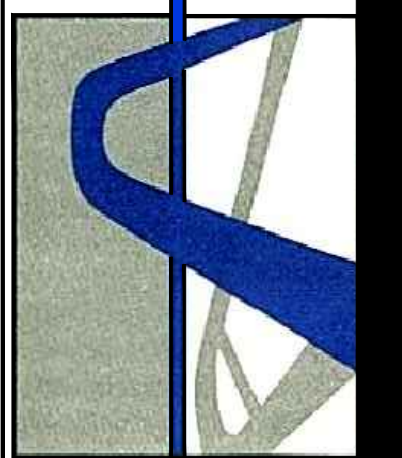


**NEW COMMUNITY CENTER
FOR THE
ISLAMIC CENTER
OF BATON ROUGE**

285 EAST AIRPORT BLVD.
BATON ROUGE, LA 70806
EAST BATON ROUGE PARISH

PROJ. NO.	2015-020C
DATE:	5-8-2016
DRAWN BY:	C.E.K.J.
CHECKED BY:	C.E.K.J.

SHEET TITLE
EXTERIOR WALL SECTIONS

A5.0

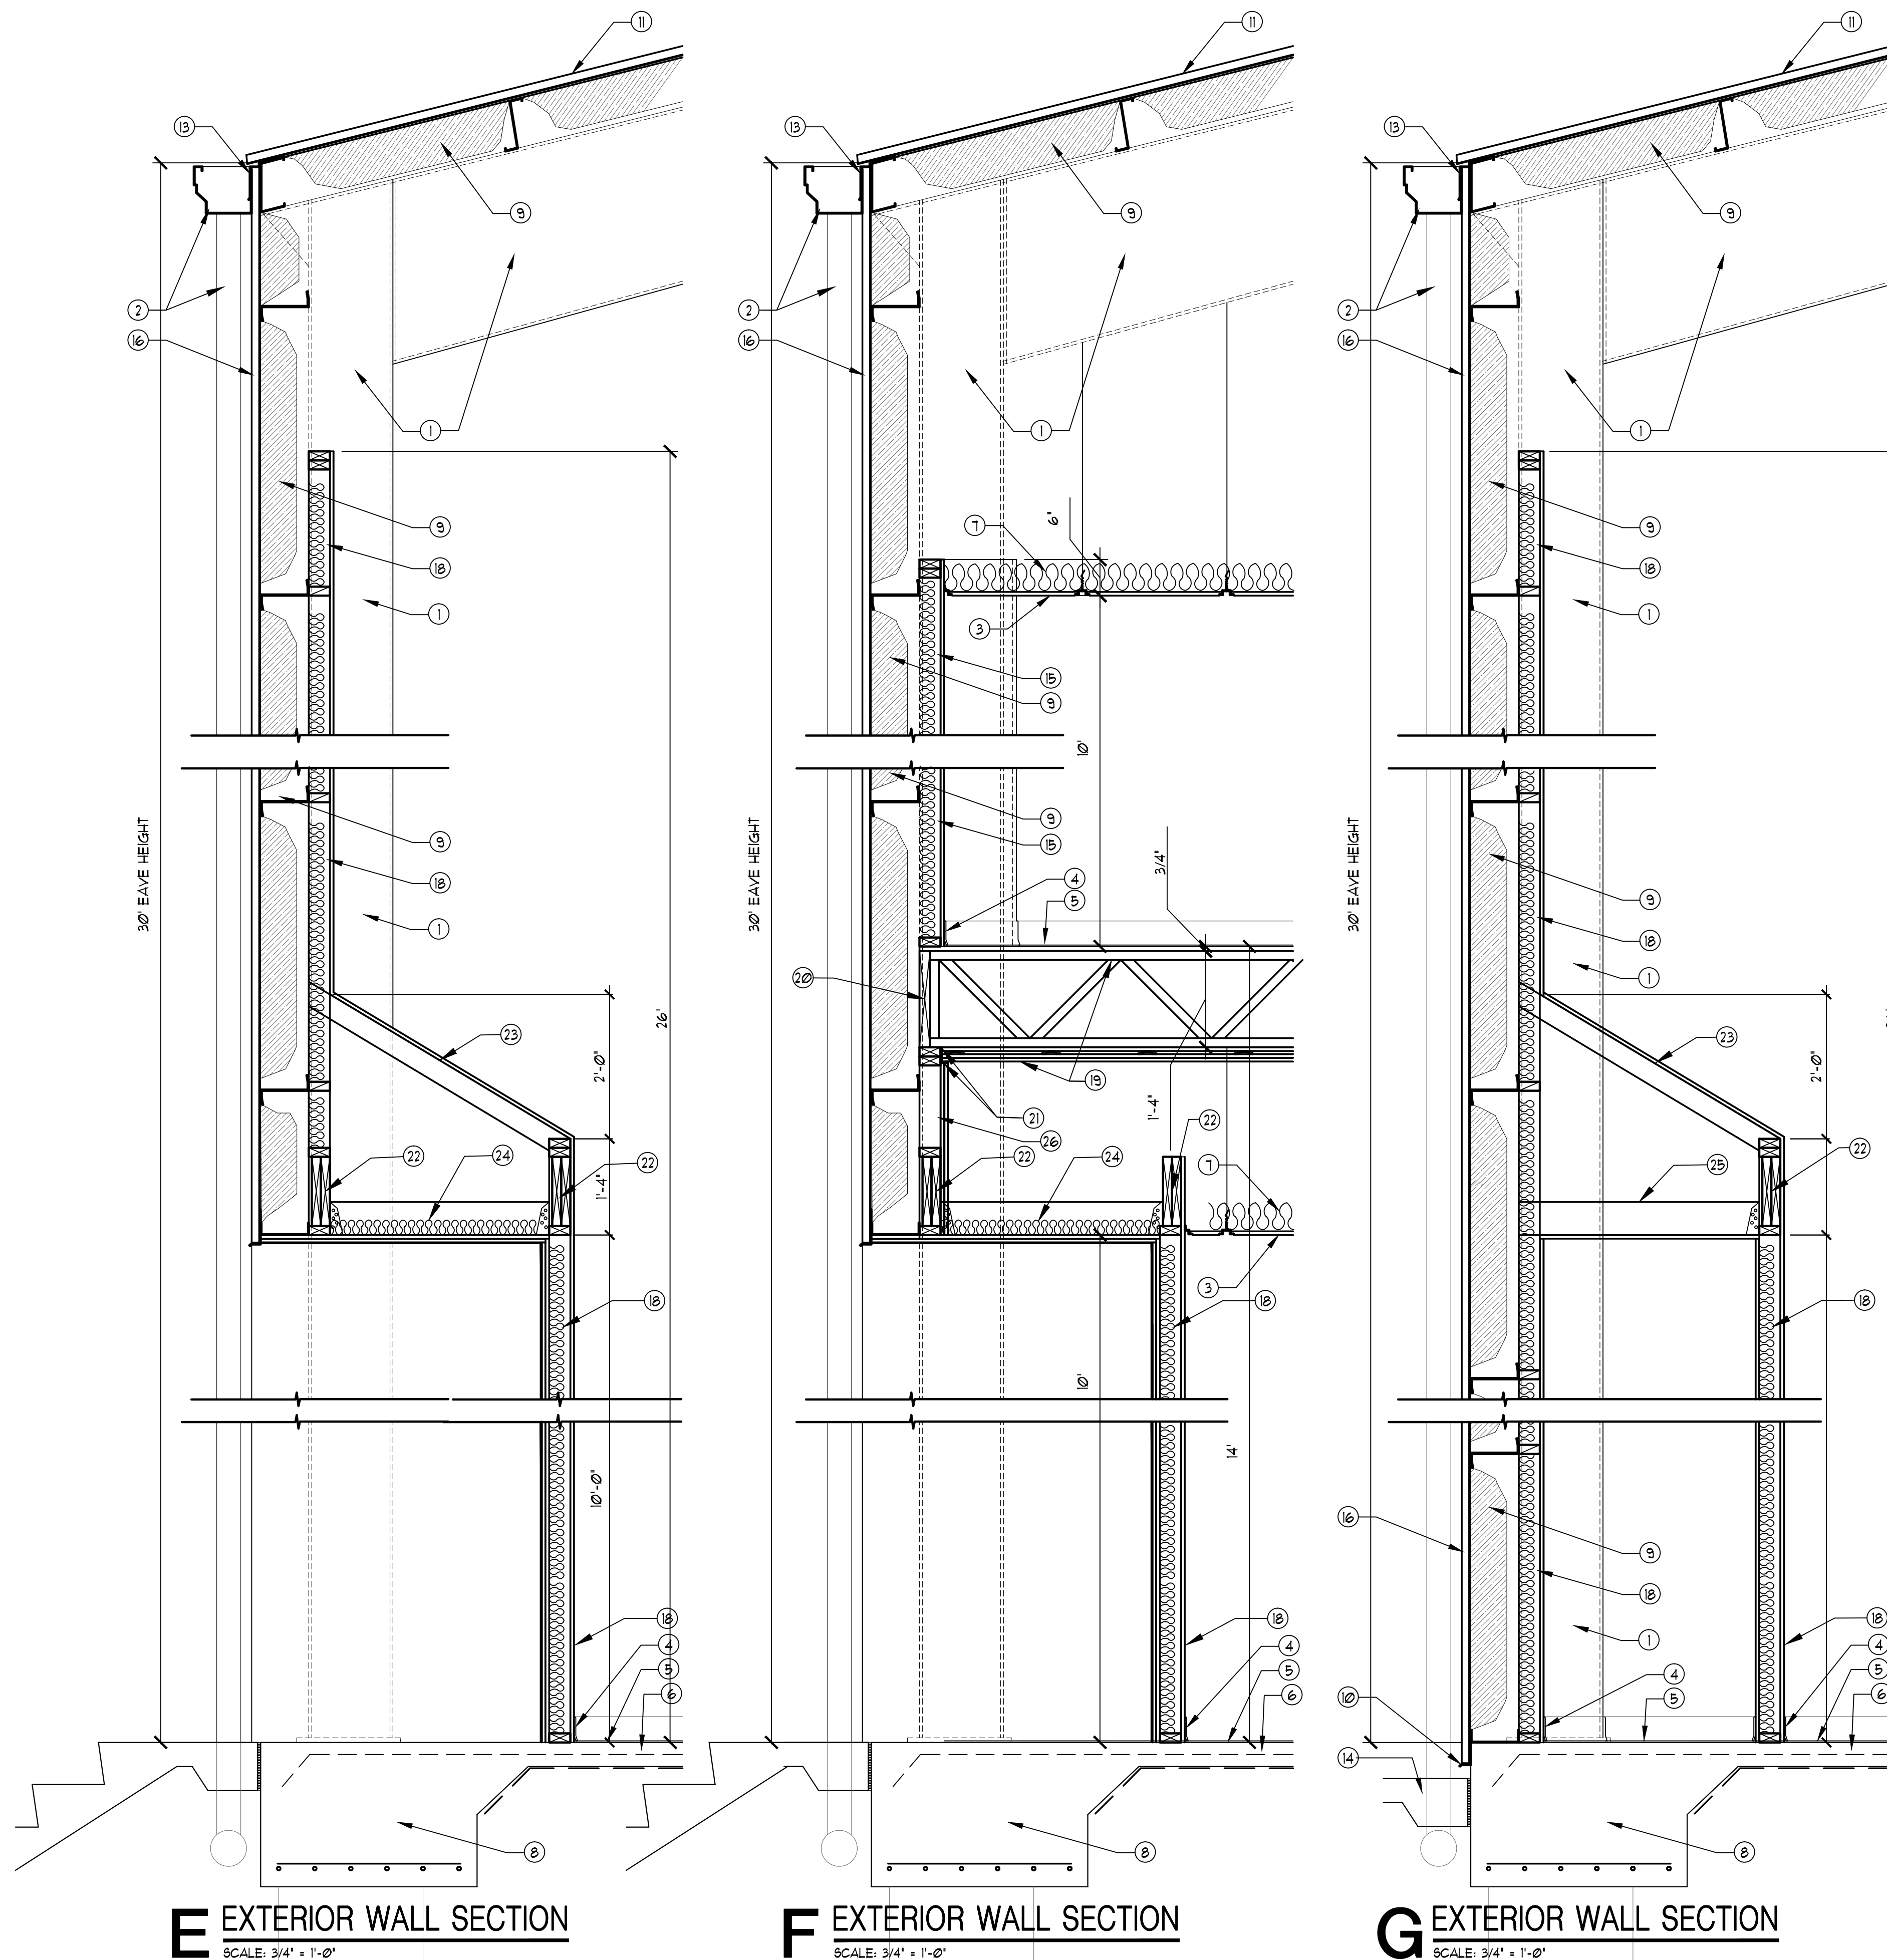

KEY NOTES

- 1) PRE-ENGINEERED METAL BUILDING STRUCTURAL MAIN FRAME.
- 2) 8" MTL. BUILDING GUTTER 4 6" SQUARE DOWNSPOUTS SIZED AND FURNISHED (BY METAL BUILDING MANUF.). TIE INTO UNDERGROUND STORMWATER PER CIVIL.
- 3) SUSPENDED ACOUSTICAL CEILING SYSTEM, ON PREFINISHED ALUM. GRID, WITH REGULAR EDGE 2'X2' CEILING TILES.
- 4) WALL BASE AS SPECIFIED IN FINISH SCHEDULE.
- 5) NEW FLOOR FINISH PER OWNER.
- 6) 4" CONC. SLAB (SEE STRUCTURAL) W/ 6 MIL VAPOR BARRIER OVER WELL COMPACTED FILL AND TERMITE TREATMENT AS PER FLORIDA CODE.
- 7) R-19 UNFACED BATT INSULATION LAYED ON TOP OF NEW SUSP. CEILING.
- 8) REINFORCED CONCRETE FOOTER, SEE STRUCTURAL FOR SIZE AND REINFORCEMENT REQUIRED.
- 9) R-11 VINYL FACED INSUL. BY METAL BUILDING MANUF.
- 10) METAL BUILDING WALL PANEL BASE FLASHING - CONTINUOUS.
- 11) PRE-FINISHED METAL BUILDING ROOF PANELS, PER METAL BUILDING MANUFACTURER, FASTEN TO ROOF PURLINS PER MANUFACTURER'S SHOP DRAWINGS.
- 12) PRE-FINISHED METAL BUILDING RAKE EAVE FLASHING.
- 13) PRE-FINISHED METAL BUILDING EAVE FLASHING.
- 14) CONCRETE SIDEWALKS SLOPE AWAY FROM BUILDING (MAX SLOPE 1/8").
- 15) INTERIOR NON-BEARING WALL, 2X4 AT 16" O.C., BLOCKING AT MID-HEIGHT, SHEATHED ON EXPOSED INTERIOR SIDE WITH 1/2" GYP. BD., ALL CAVITIES FILLED WITH 4" THICK (R-13) BATT INSULATION.
- 16) PRE-FINISHED METAL BUILDING WALL PANELS, ANCHORED TO PRE-ENGINEERED METAL BUILDING COMPONENTS AS ILLUSTRATED IN METAL BUILDING SHOP DRAWINGS.
- 17) INTERIOR BEARING WALL, 2X4 AT 16" O.C., HORIZONTAL BLOCKING AT 4'-0" O.C. VERTICALLY, SHEATHED ON EXPOSED INTERIOR SIDE WITH 1/2" GYP. BD., ALL CAVITIES FILLED WITH 4" THICK (R-13) BATT INSULATION.
- 18) INTERIOR NON-BEARING GYMNASIUM WALL, 2X4 AT 16" O.C., HORIZ. BLOCKING AT 4'-0" O.C. VERTICALLY, SHEATHED ON EXPOSED INTERIOR SIDE WITH 1/2" GYP. BD., ALL CAVITIES FILLED WITH 4" THICK (R-13) BATT INSULATION.
- 19) 2-HR. FIRE RATED FLOOR CEILING SYSTEM (UL DES. # LB38) PRE-ENGINEERED WOOD FLOOR JOISTS AT 16" O.C. MAX, WITH A 3/4" T&G STRUCTURAL PLYWOOD FLOOR DECK INSTALL PERPENDICULAR TO JOISTS ON THE TOP. THE BOTTOM OF THIS SYSTEM SHALL HAVE ONE LAYER OF 5/8" TYPE-X GYP. BD. SCREW ATTACHED TO THE BOTTOM OF THE WOOD TRUSSES, THEN 1/2" METAL (26 GA.) GALV. HAT FURRING CHANNELS AT 16" O.C. SHALL BE SCREW ATTACHED, BELOW THE FIRST GYP. BD. LAYER. THEN (2) TWO ADDITIONAL LAYERS OF 5/8" TYPE-X GYP. BD. SHALL BE SCREW ATTACHED TO THE BOTTOM OF THE HAT CHANNELS. ALL JOINTS SHALL BE TAPED & FLOATED.
- 20) FULL FLOOR SYSTEM HEIGHT RIM JOIST, FIRE BLOCKING FOR FLOOR SYSTEM AT ALL EXTERIOR EDGES.
- 21) FIRE CAULKED CONT. JOINTS.
- 22) (2) 2X12 WOOD HEADER.
- 23) INTERIOR SLOPED CAP WALL, 2X4 AT 16" O.C. SHEATHED ON EXPOSED INTERIOR SIDE WITH 1/2" GYP. BD., ALL CAVITIES FILLED WITH 4" THICK (R-13) BATT INSULATION.
- 24) 2X6 WOOD JOISTS @ 16" O.C. HORIZONTAL SOFFIT FRAMING, SHEATHED ON UNDERSIDE WITH 5/8" PLYWOOD SHEATHING, AND FINISHED ON EXTERIOR FACE WITH A HARD-COAT STUCCO SYSTEM APPLIED TO A 5/8" BACKER BOARD. BACKER-BOARD MATERIAL SHALL BE AS REQUIRED BY THE SELECTED STUCCO SYSTEM SPECIFICATIONS. ALL WALL CAVITIES SHALL BE FILLED WITH 4" THICK (R-13) BATT INSULATION.
- 25) 2X6 WOOD JOISTS @ 16" O.C. HORIZONTAL SOFFIT FRAMING, SHEATHED ON UNDERSIDE WITH 5/8" GYP. BOARD.
- 26) 2-HR. FIRE RATED INTERIOR BEARING WALL (UL DES. # J301) 2X4 AT 16" O.C. HORIZONTAL BLOCKING AT 4'-0" O.C. VERTICALLY, SHEATHED ON EXPOSED INTERIOR SIDE WITH (2) TWO LAYERS OF 5/8" TYPE-X GYP. BD., ALL CAVITIES FILLED WITH 4" THICK (R-13) BATT INSULATION.


REVISIONS
RELEASED FOR PERMITTING
05-8-2016

ARCHITECT'S SEAL & SIGNATURE



SEAL & SIGNATURE 5-8-2016

creating architecture as an art form

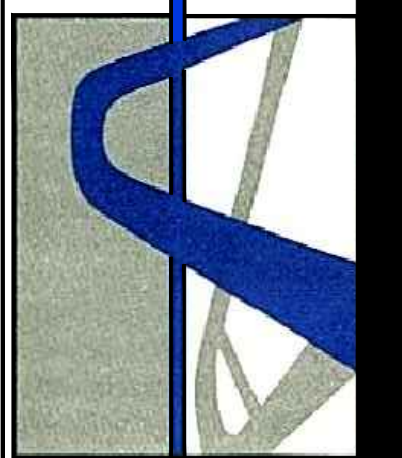

Charles E. Kunze Jr., 25 W. Cedar St., Suite 214, Pensacola, FL 32502
850-432-8438
LOUISIANA REGISTRATION NO. 5827


NEW COMMUNITY CENTER
FOR THE
ISLAMIC CENTER
OF BATON ROUGE

285 EAST AIRPORT BLVD.
BATON ROUGE, LA 70806
EAST BATON ROUGE PARISH

PROJ. NO. 2015-020C
DATE: 5-8-2016
DRAWN BY: C.E.K.J.
CHECKED BY: C.E.K.J.

SHEET TITLE
EXTERIOR WALL SECTIONS

A5.1

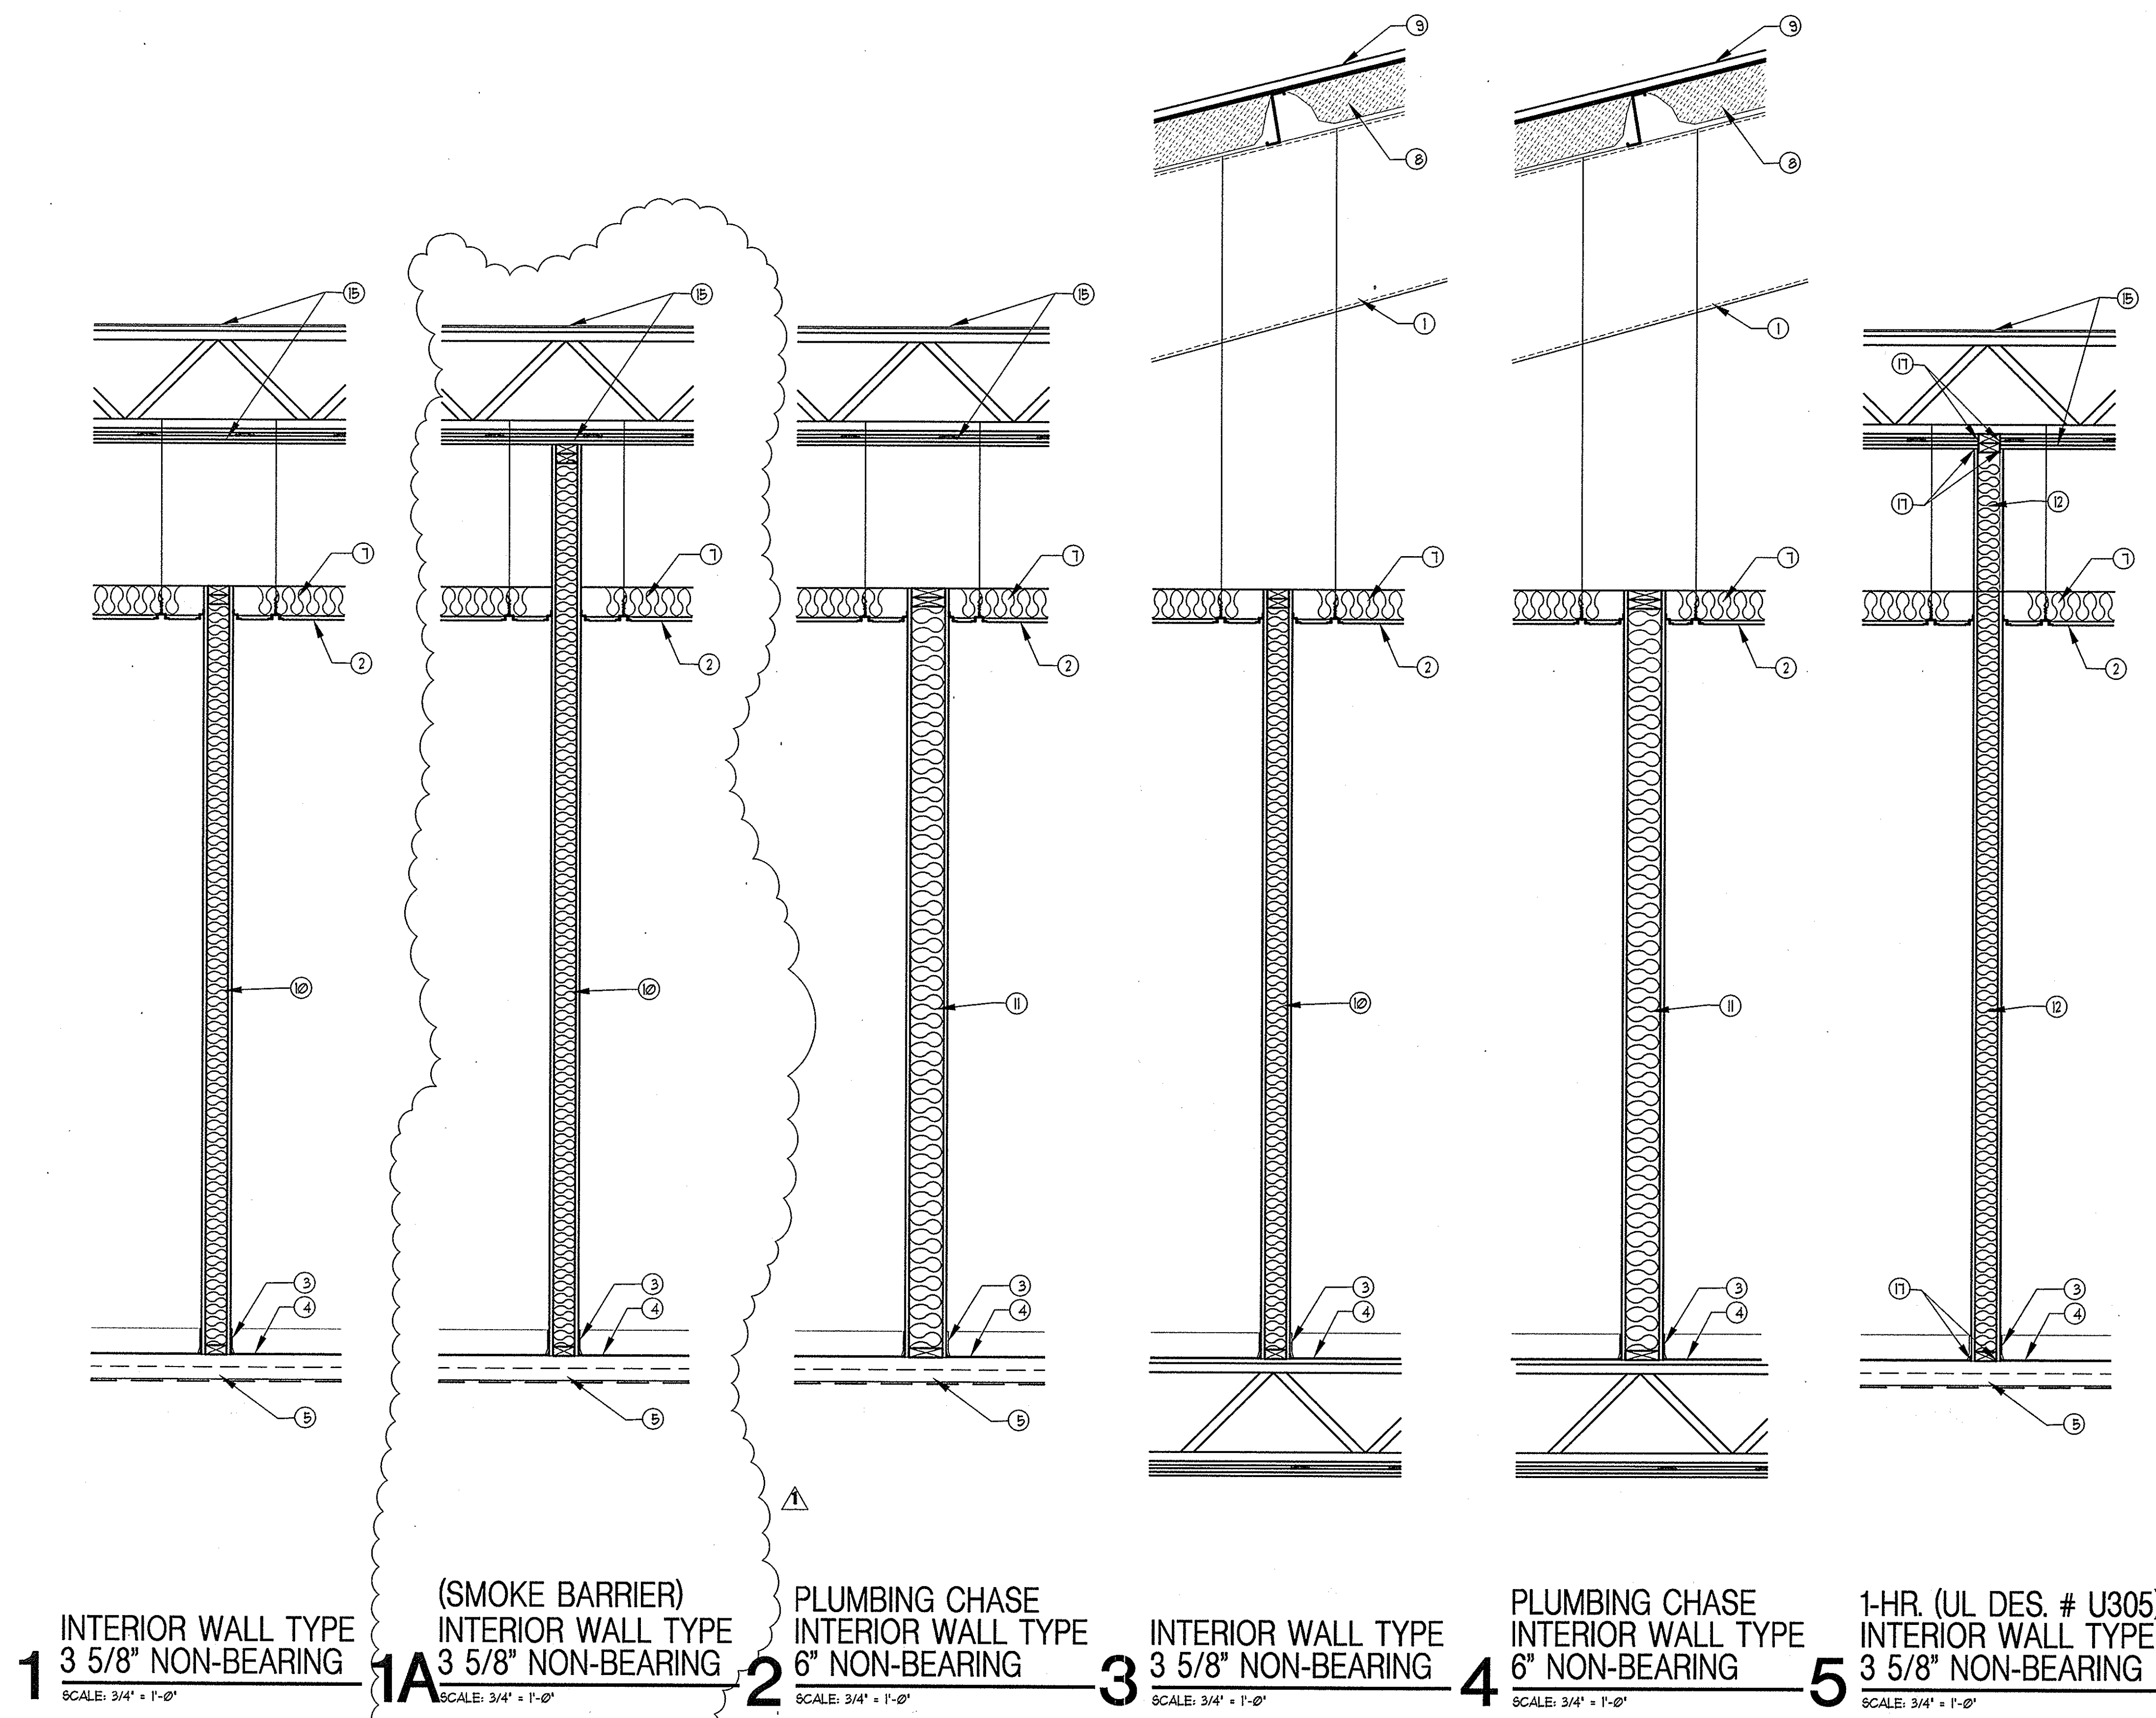

KEY NOTES

- 1 PRE-ENGINEERED METAL BUILDING STRUCTURAL MAIN FRAME.
- 2 SUSPENDED ACOUSTICAL CEILING SYSTEM, ON PREFINISHED ALUM. GRID, WITH TEGULAR EDGE 2'X2' CEILING TILES.
- 3 WALL BASE AS SPECIFIED IN FINISH SCHEDULE.
- 4 NEW FLOOR FINISH PER OWNER.
- 5 4" CONC. SLAB (SEE STRUCTURAL) W/ 6 MIL VAPOR BARRIER OVER WELL COMPACTED FILL AND TERMITE TREATMENT AS PER CODE.
- 6 SEE STRUCTURAL CONCRETE FOOTING REINFORCED PER STRUCTURAL.
- 7 R-13 UNFACED BATT INSULATION LAYED ON TOP OF NEW SUSP. CEILING.
- 8 R-11 VINYL FACED INSUL. BY METAL BUILDING MANUF.
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- 10 INTERIOR NON-BEARING WALL. 2X4 AT 16" O.C. BLOCKING AT MID-HEIGHT. SHEATHED ON BOTH SIDES WITH 1/2" GYP. BD., ALL CAVITIES FILLED WITH 4" THICK SOUND BATT. INSULATION.
- 11 INTERIOR NON-BEARING WALL. 2X6 AT 16" O.C. BLOCKING AT MID-HEIGHT. SHEATHED ON BOTH SIDES WITH 1/2" GYP. BD., ALL CAVITIES FILLED WITH 4" THICK SOUND BATT. INSULATION.
- 12 1-HR. FIRE RATED (UL DES. #305) INTERIOR NON-BEARING WALL. 2X4 AT 16" O.C. BLOCKING AT MID-HEIGHT. SHEATHED ON BOTH SIDES WITH 5/8" TYPE-X GYP. BD., ALL CAVITIES FILLED WITH 4" THICK SOUND BATT. INSULATION.
- 13 2-HR. FIRE RATED (UL DES. #201) INTERIOR BEARING WALL. 2X4 AT 16" O.C. BLOCKING AT MID-HEIGHT. SHEATHED ON BOTH SIDES WITH 5/8" TYPE-X GYP. BD., ALL CAVITIES FILLED WITH 4" THICK SOUND BATT. INSULATION.
- 14 2-HR. FIRE RATED (UL DES. #201) INTERIOR BEARING WALL. 2X6 AT 16" O.C. BLOCKING AT MID-HEIGHT. SHEATHED ON BOTH SIDES WITH 5/8" TYPE-X GYP. BD., ALL CAVITIES FILLED WITH 4" THICK SOUND BATT. INSULATION.
- 15 2-HR. FIRE RATED FLOOR CEILING SYSTEM (UL DES. #1538) PRE-ENGINEERED WOOD FLOOR JOISTS AT 16" O.C. MAX. WITH A 3/4" T&G STRUCTURAL FLYWOOD FLOOR DECK INSTALL PERPENDICULAR TO JOISTS ON THE TOP. THE BOTTOM OF THIS SYSTEM SHALL HAVE ONE LAYER OF 5/8" TYPE-X GYP. BD. SCREW ATTACHED TO THE BOTTOM OF THE WOOD TRUSSEES, THEN 1/2" METAL (26 GA) GALV. HAT FURRING CHANNELS AT 16" O.C. SHALL BE SCREW ATTACHED, BELOW THE FIRST GYP. BD. LAYER. THEN (2) TWO ADDITIONAL LAYERS OF 5/8" TYPE-X GYP. BD. SHALL BE SCREW ATTACHED TO THE BOTTOM OF THE HAT CHANNELS. ALL JOINTS SHALL BE TAPED & FLOATED.
- 16 FULL FLOOR SYSTEM HEIGHT RIM JOIST, FIRE BLOCKING FOR FLOOR SYSTEM AT ALL EXTERIOR EDGES.
- 17 FIRE CAULKED CONT. JOINTS.

Note: This agency does not enforce private deed and/or subdivision restrictions. However, the issuance of this permit does not release the owner and/or contractor/builder from complying with any such restrictions that may be attached to the property mentioned in this permit.

Note: "...A permit issued shall be construed to be a license to proceed with the work and shall not be construed as authority to violate, cancel, alter, or set aside any of the provisions of this code...."

Note: "...These drawings shall be kept at the site of work and shall be open to inspection by any building official or authorized representative...."

NOTED
REVIEWED BY: LINDSEY BICKHAM
DATE: MAR 01 2016
PARISH OF EAST BATON ROUGE
INSPECTION

REVISIONS
RELEASED FOR PERMITTING
05-8-2016
REV. #1 10-22-16

ARCHITECT'S SEAL & SIGNATURE

CHARLES E. KUNZE JR.
REG. NO. 5927
STATE OF LOUISIANA
REGISTERED ARCHITECT
Charles E. Kunze Jr.
SEAL & SIGNATURE 10-22-2016

creating architecture as an art form

Charles E. Kunze Jr., 25 W Cedar St., Suite #14, Pensacola, FL. 32502
850-432-18438
LOUISIANA REGISTRATION #201


NEW COMMUNITY CENTER
FOR THE
ISLAMIC CENTER
OF BATON ROUGE

285 EAST AIRPORT BLVD.
BATON ROUGE, LA 70806
EAST BATON ROUGE PARISH


PROJ. NO. 2015-020C
DATE: 5-8-2016
DRAWN BY: C.E.K.J.
CHECKED BY: C.E.K.J.

SHEET TITLE
INTERIOR WALL TYPES

A6.0

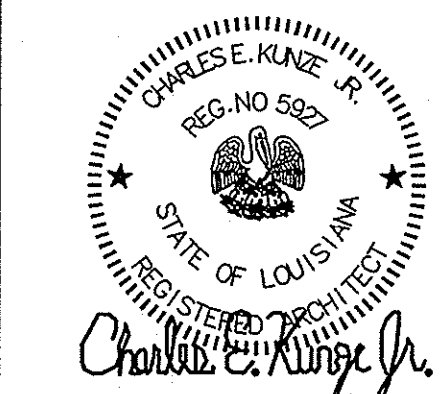

creating architecture as an art form

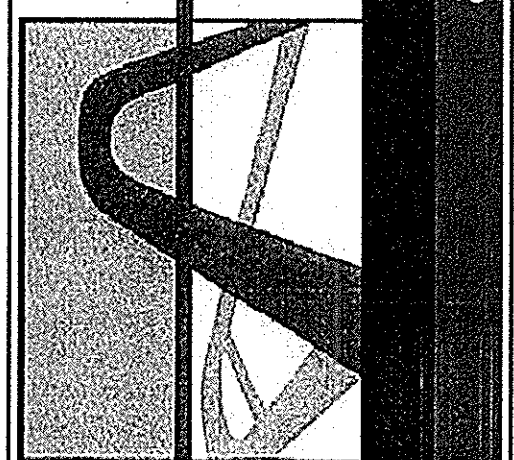

Charles E. Kunze Jr., 25 W Cedar St., Suite 214, Pensacola, FL 32502
850-432-8438

NEW COMMUNITY CENTER
FOR THE
ISLAMIC CENTER
OF BATON ROUGE

285 EAST AIRPORT BLVD.
BATON ROUGE, LA 70806
EAST BATON ROUGE PARISH

PROJ. NO. 2015-020C
DATE: 05-08-2016
DRAWN BY: C.E.K.J.
CHECKED BY: C.E.K.J.

SHEET TITLE
INTERIOR WALL TYPES

A6.1

Note: This agency does not enforce private deed and/or subdivision restrictions. However, the issuance of this permit does not release the owner and/or contractor/builder from complying with any such restrictions that may be attached to the property mentioned in this permit.


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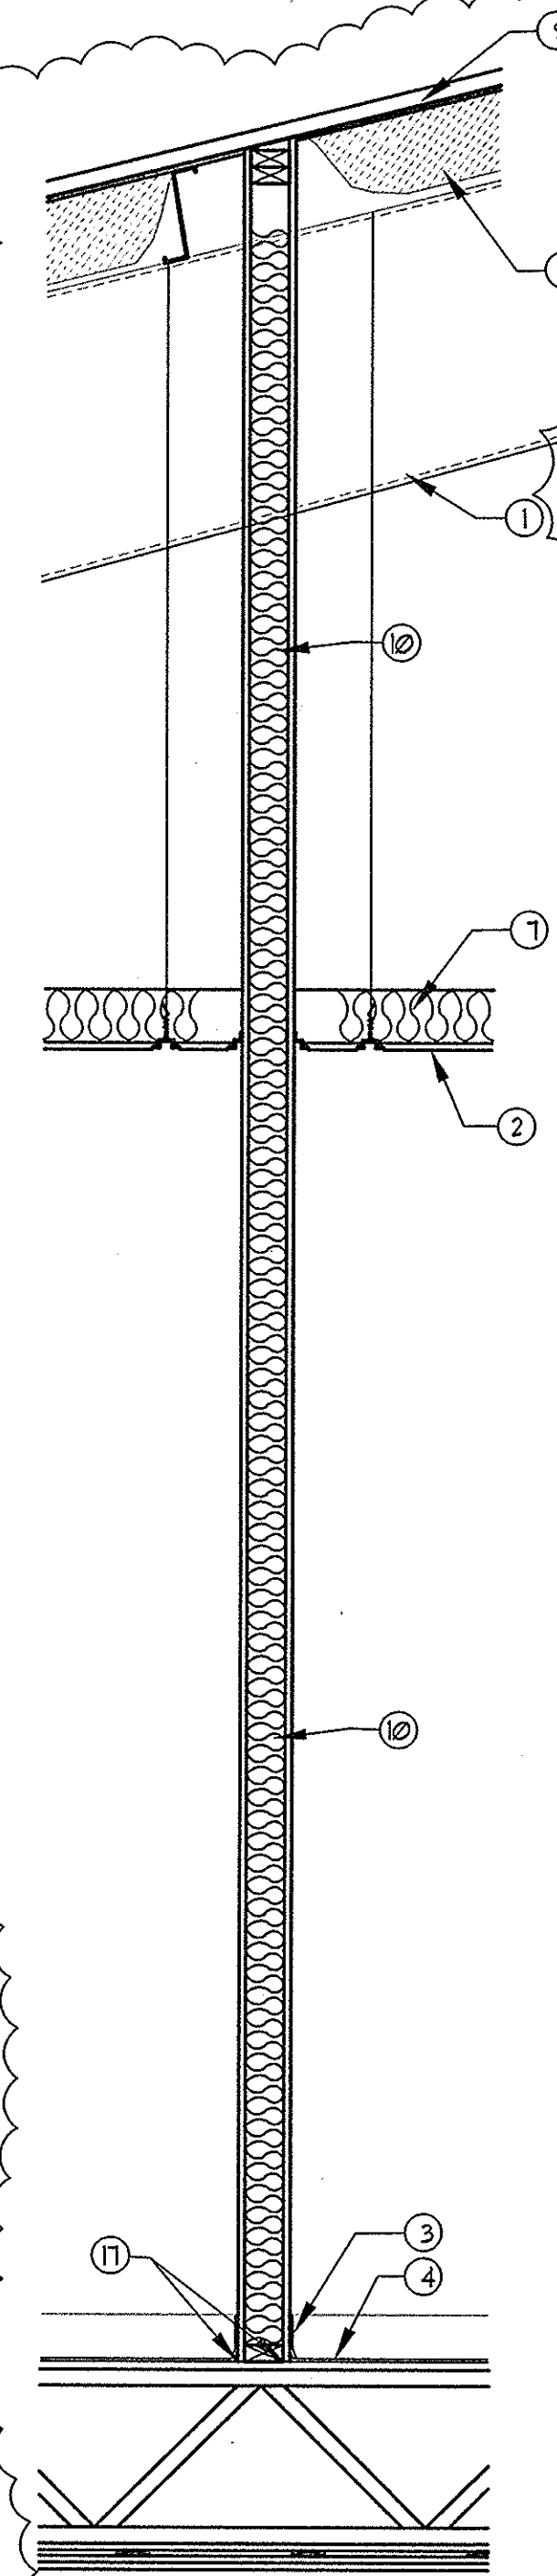
REVIEWED BY: LINDSEY BICKHAM
NOTED: SPECIAL CODE
COMPLIANCE BY THE
CITY OF BATON ROUGE
PARISH MAR 01 2017
INSPECTOR: J. KUNZ, D.E.W.

KEY NOTES


- 1 PRE-ENGINEERED METAL BUILDING STRUCTURAL MAIN FRAME.
- 2 SUSPENDED ACOUSTICAL CEILING SYSTEM, ON PREFINISHED ALUM GRID, WITH REGULAR EDGE 2'X2' CEILING TILES.
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- 12 1-HR. FIRE RATED (UL DES. #205) INTERIOR NON-BEARING WALL. 2X4 AT 16" O.C. BLOCKING AT MID-HEIGHT. SHEATHED ON BOTH SIDES WITH 5/8" TYPE-X GYP. BD., ALL CAVITIES FILLED WITH 4" THICK SOUND BATT. INSULATION.
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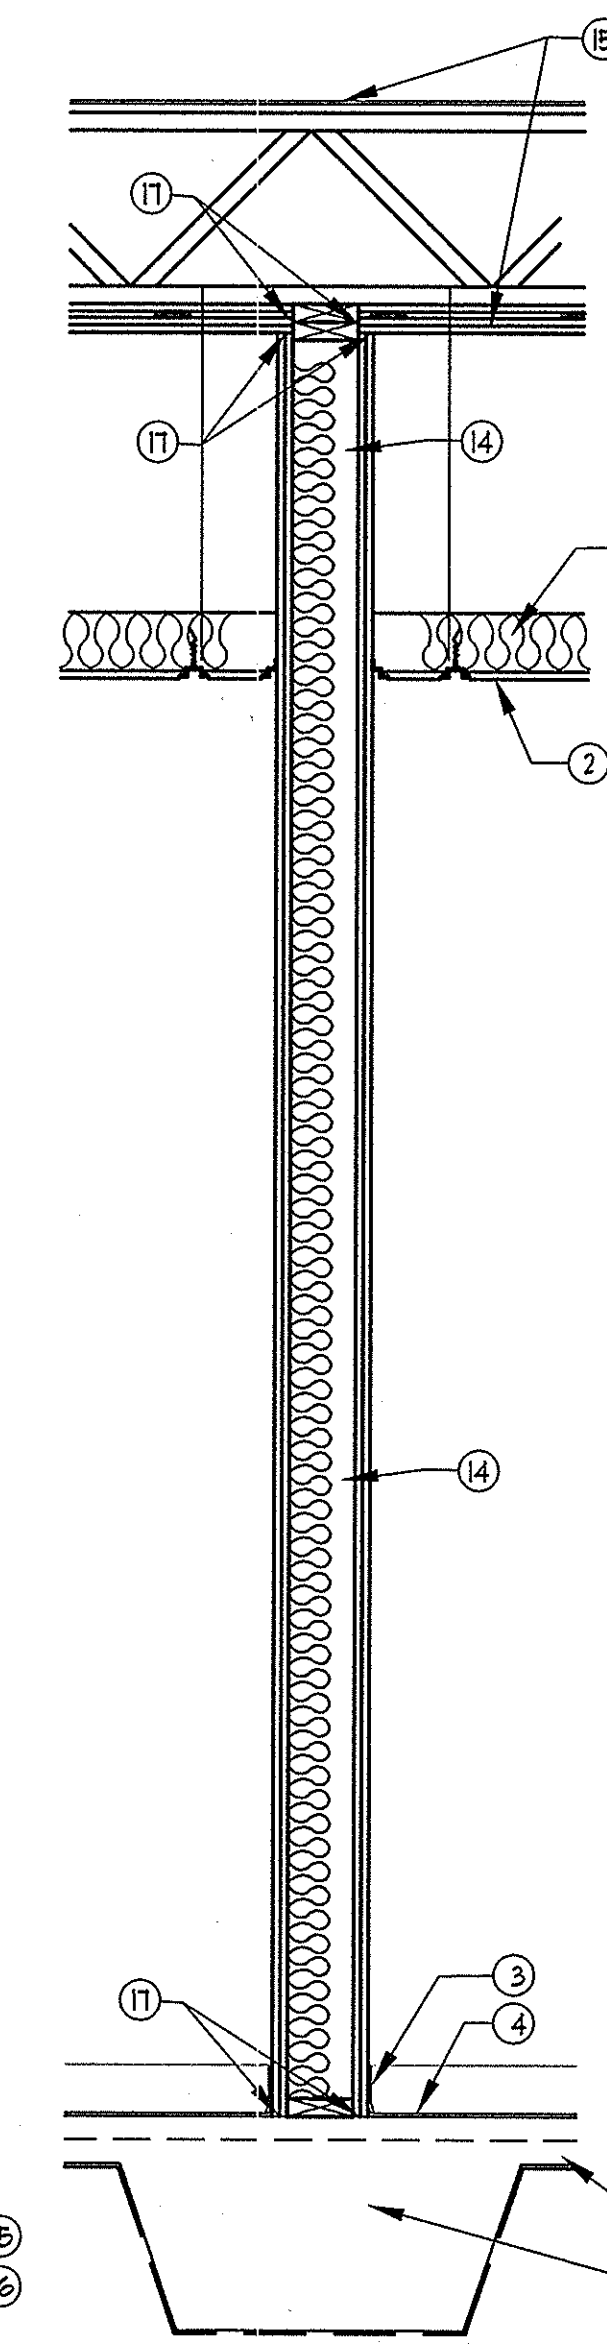
6 1-HR. (UL DES. # U305)
INTERIOR WALL TYPE
3 5/8" NON-BEARING
SCALE: 3/4" = 1'-0"




6A (SMOKE BARRIER)
INTERIOR WALL TYPE
3 5/8" NON-BEARING
SCALE: 3/4" = 1'-0"

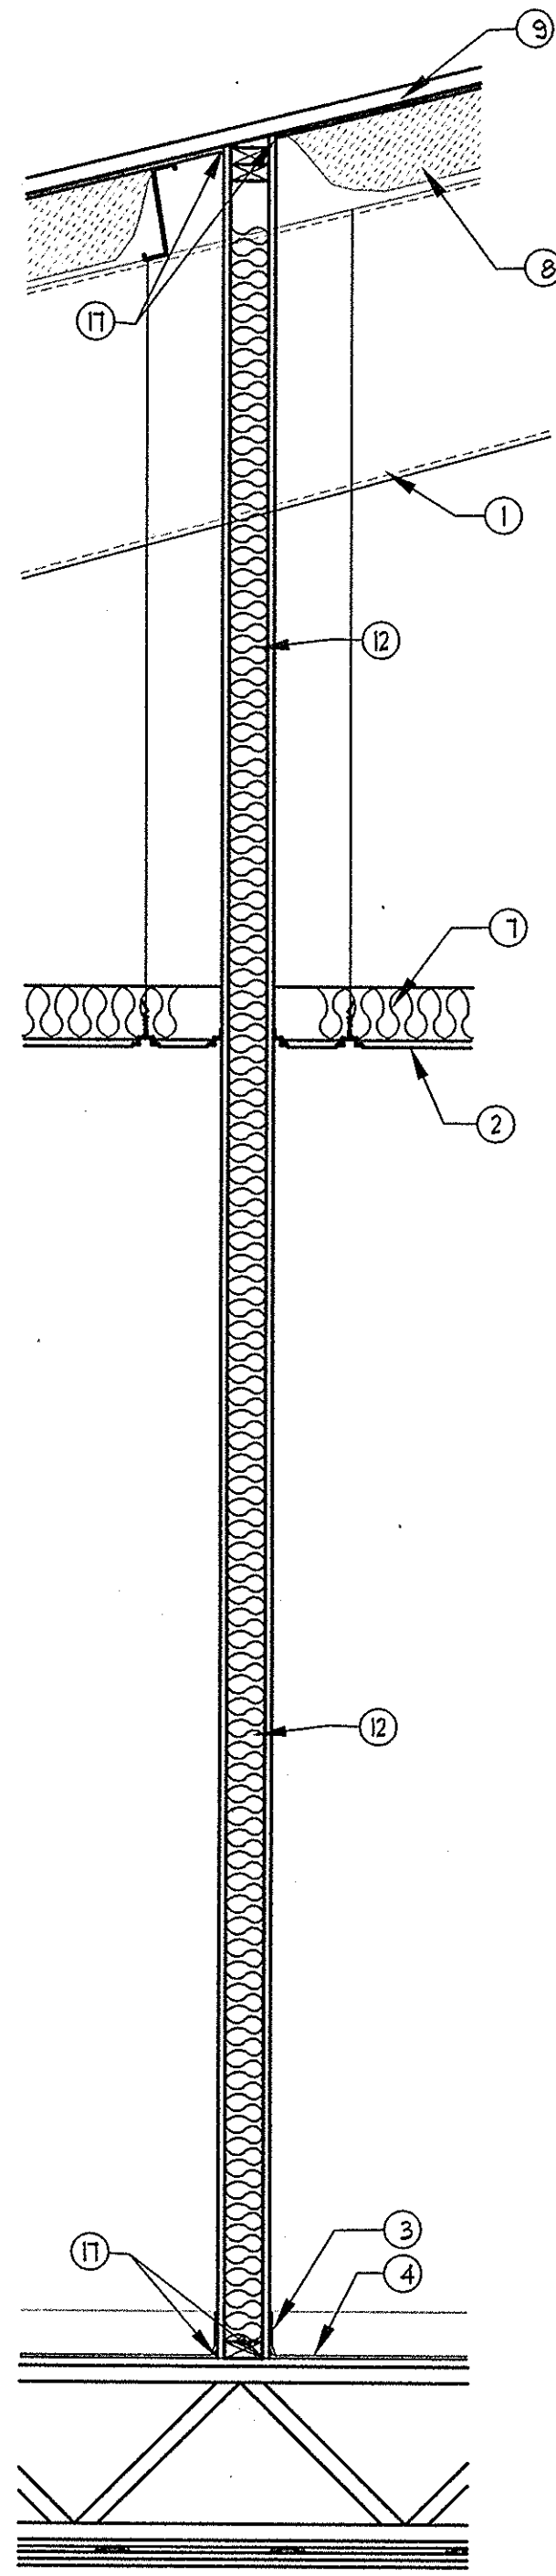

7 2-HR. (UL DES. # U301)
INTERIOR WALL TYPE
3 5/8" BEARING
SCALE: 3/4" = 1'-0"

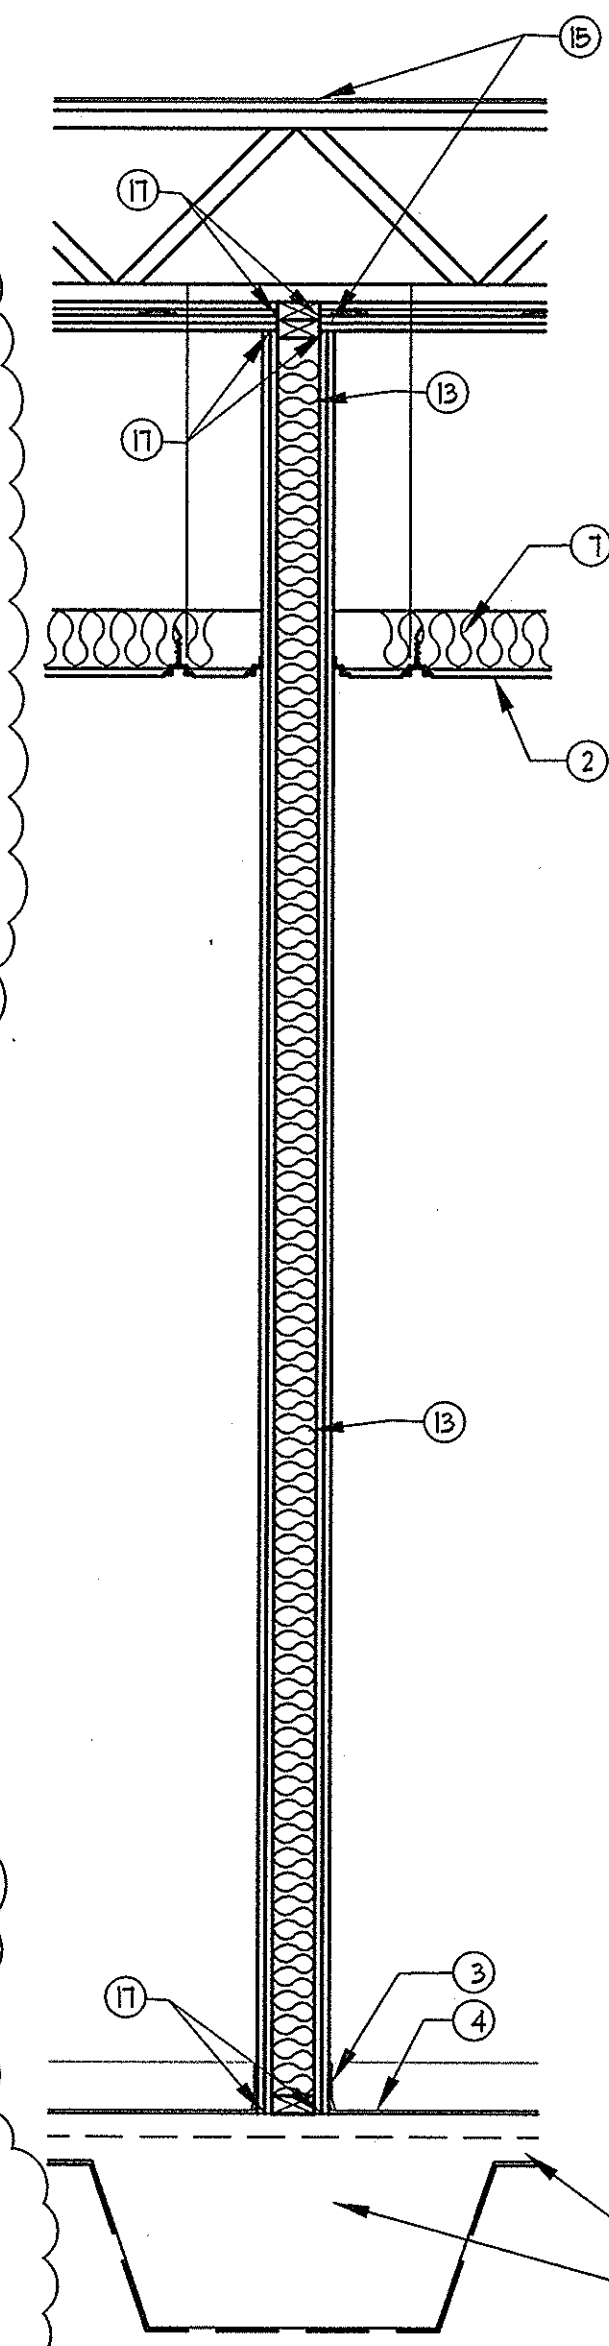

8 2-HR. (UL DES. # U301)
INTERIOR WALL TYPE
6" BEARING
SCALE: 3/4" = 1'-0"

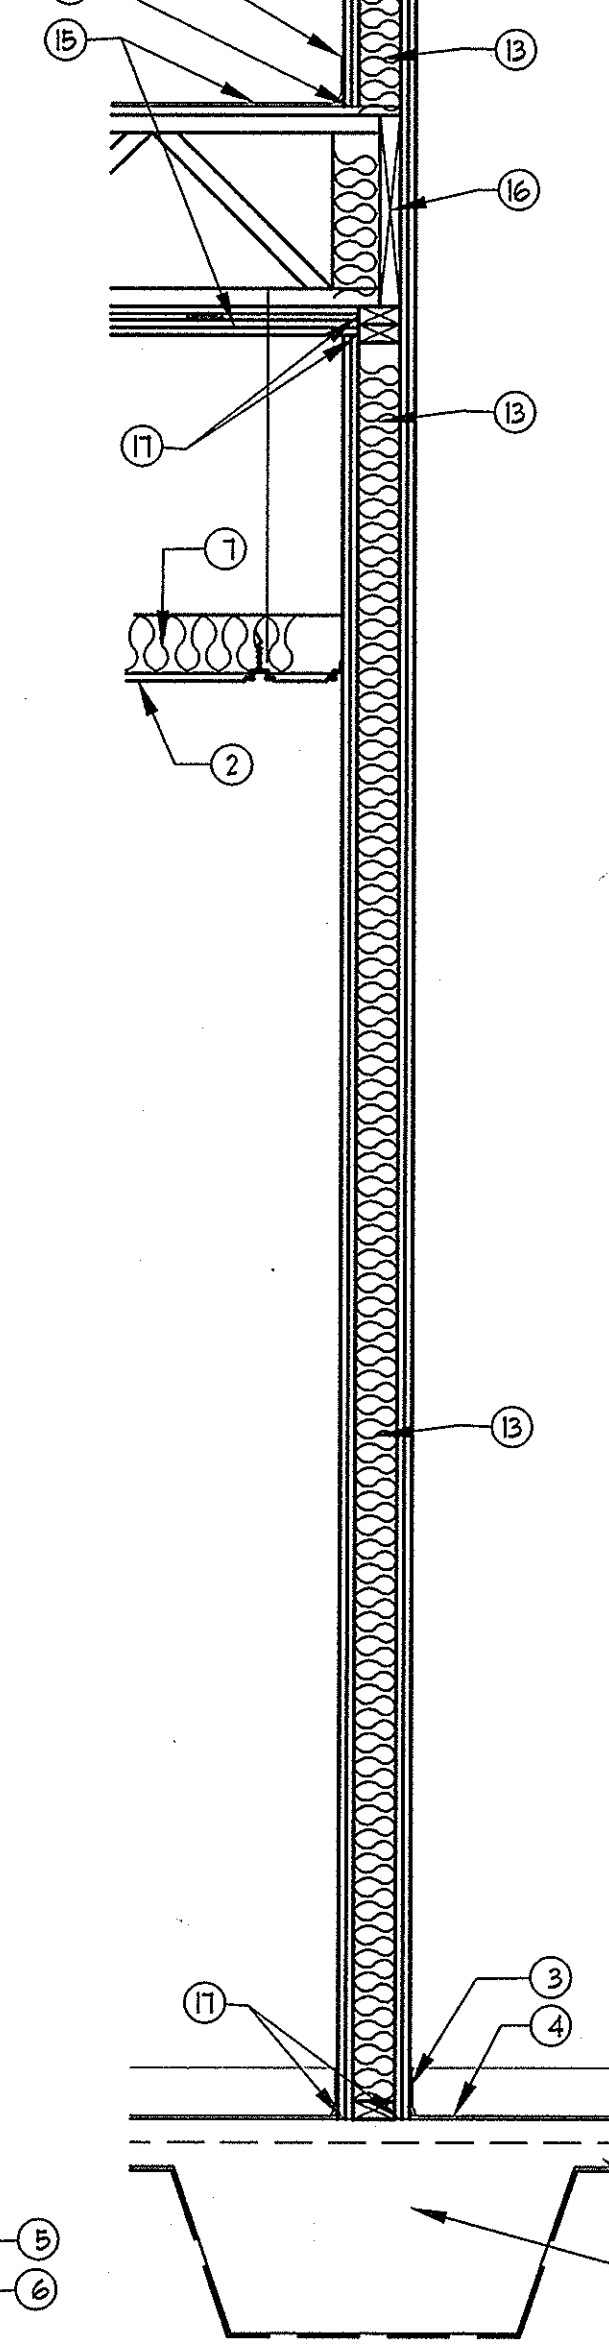

9 2-HR. (UL DES. # U301)
INTERIOR WALL TYPE
3 5/8" BEARING
SCALE: 3/4" = 1'-0"