APPROVED BC190130 03/04/2019 Page 1 of 13 Napier City Council

# **Approved Building Consent Documents**

Please Note: A copy of the stamped approved documents must be available on site for all inspections.

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Napier City Council

Stones Home

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3 Floor Plan Layout
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5 Elevations
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11 Roof contruction details
12 Linea Weatherboards - Details



# 278 Meeanee Road, Napier



Stones Secondary Dwelling

278 Meeanee Road

Napier

Drawing Title: Cover Page

Drawing Scale: Not To Scale

Designed by Gordon Sanson LBP 117656

Date Drawing Printed:

Monday, February 25, 2019

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PO Box 3394

Onekawa, Napier

278 Meeanee Road Lot 13 DDP 96 AREA: 0.4046 Ha EARTHQUAKE ZONE: 3 CORROSION ZONE: C CLIMATE ZONE: 2 WIND ZONE: HIGH

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PROPOSED NEW SECONDARY DWELLING to be located 25m max from primary dwelling

EXISTING DWELLING









Stones Secondary Dwelling

278 Meeanee Road Napier Drawing Title: Location Plan & Site Plan
Drawing Scale: As Shown

Designed by Gordon Sanson LBP 117656 Date Drawing Printed:

Onekawa, Napier

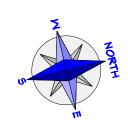
Monday, February 25, 2019

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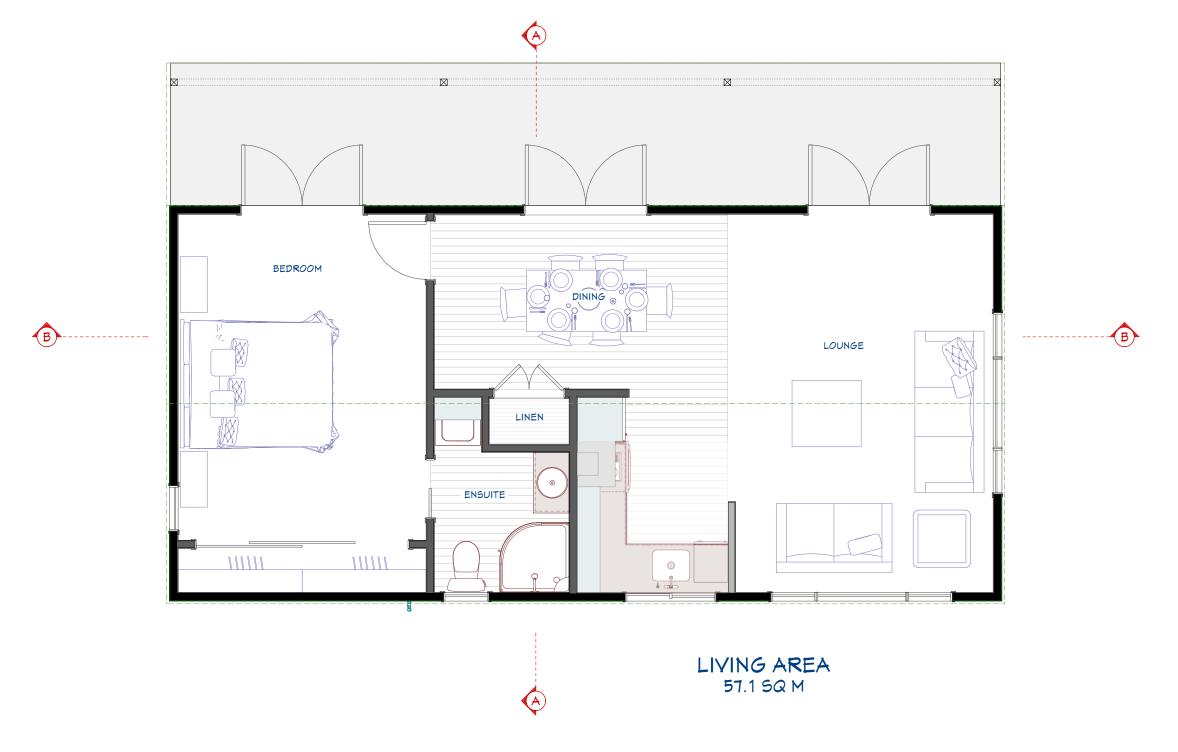
P 06-843 8834

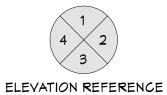
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2



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Stones Secondary Dwelling

278 Meeanee Road

Napier

Drawing Title: Floor Plan
Drawing Scale: 1:50

Drawing Scale: 1:50

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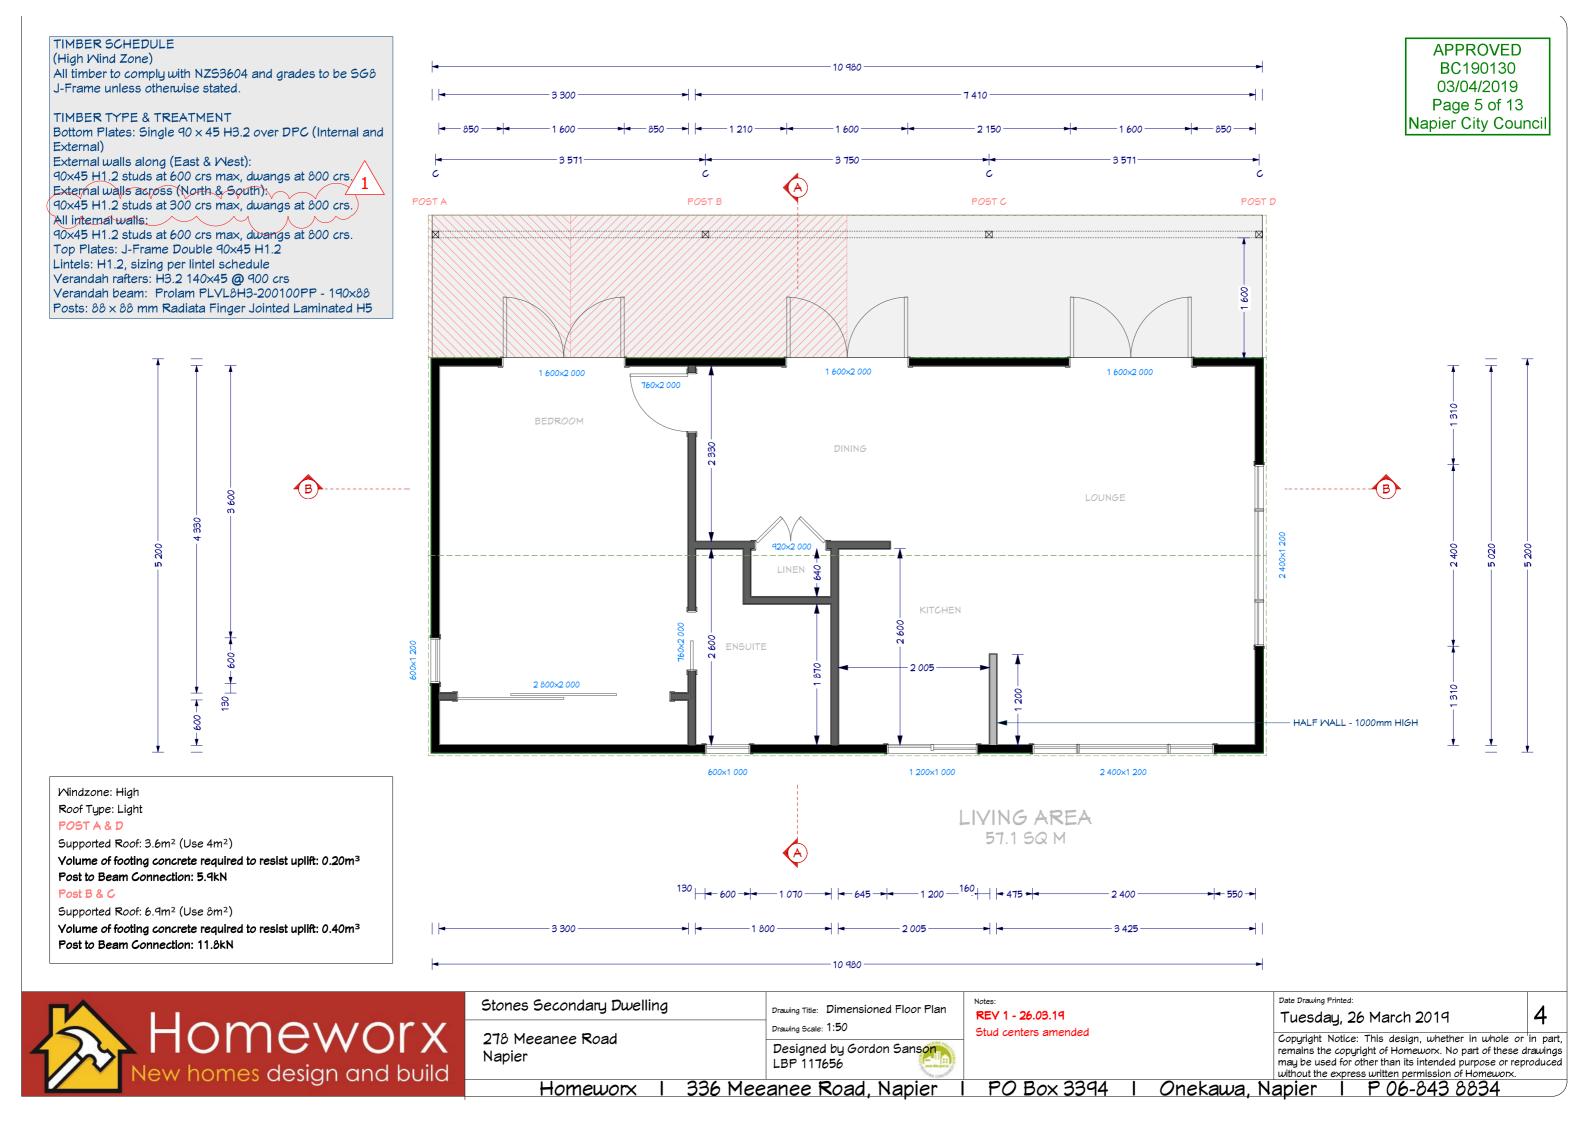
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336 Meeanee Road, Napier

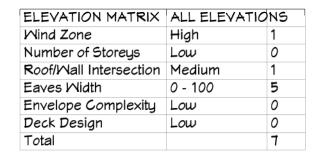
PO Box 3394

Notes:

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Cladding: Direct fixed Linea weatherboards

# **ELEVATION 2**

**ELEVATION 1** 

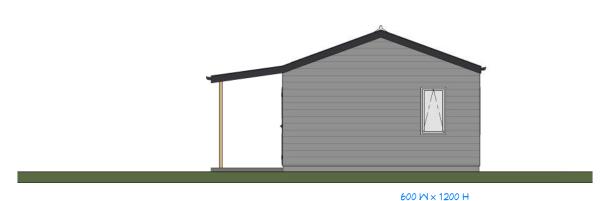


Colorsteel corrugate roofing Axent fascia and colorsteel gutter to PVC downpipes Powdercoated aluminiun joinery with tinted double glazing James Hardie weatherboard wall cladding Insulated concrete floor

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**ELEVATION 3** 



**ELEVATION 4** 

Windows to NZS4211:2008; Glazing to NZS4223.3 2016 All exterior joinery to be standard IGU double glazing units Safety glazing to comply with NZS4229:1999 part 3 as modified by NZBC Acceptable Solution F2/AS1



Stones Secondary Dwelling

278 Meeanee Road Napier

Drawing Title: Elevations Drawing Scale: 1:100 Designed by Gordon Sanson LBP 117656

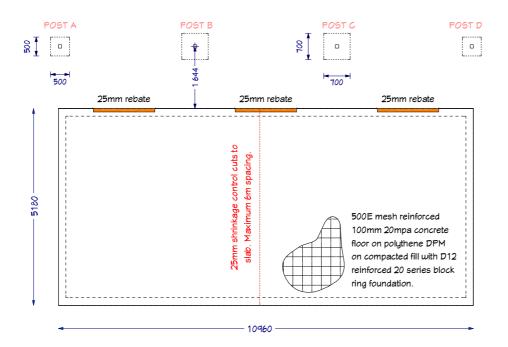
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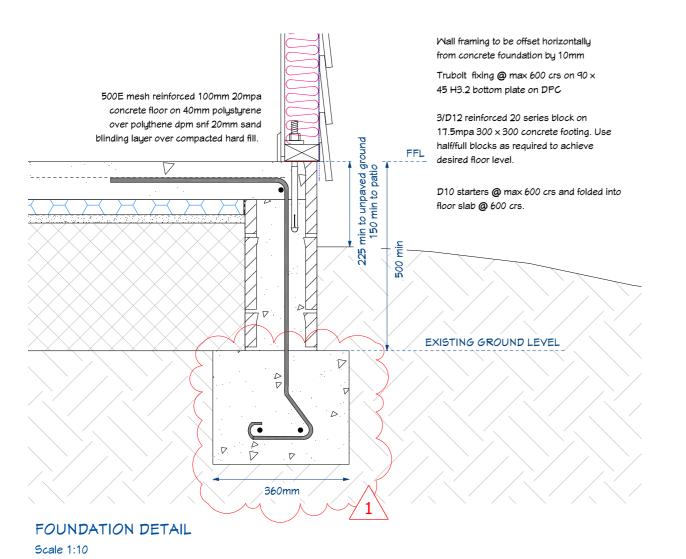
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#### **FOUNDATION PLAN**

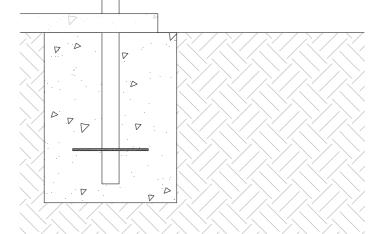
Scale 1:100



POST A & D: 500x500x900 (or 500 Øx900) footing
POST B & C: 700x700x900 (or 700 Øx900) footing

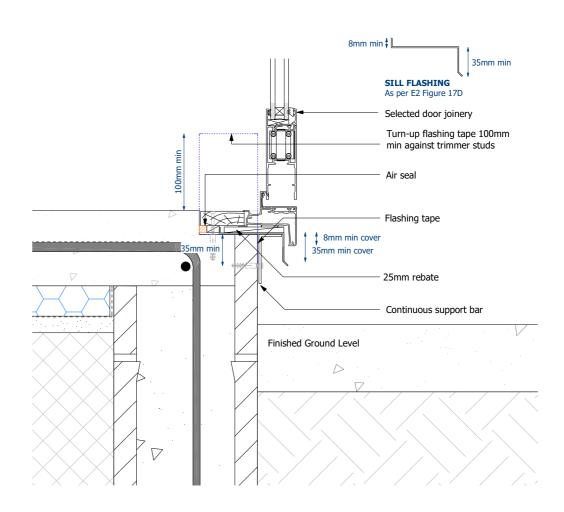
D12 bar passed through 200mm from post bottom 100mm concrete to underside of post

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#### POST FOOTING DETAIL

Scale 1:20



### DOOR REBATE DETAIL

Scale 1:5

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Stones Secondary Dwelling

278 Meeanee Road

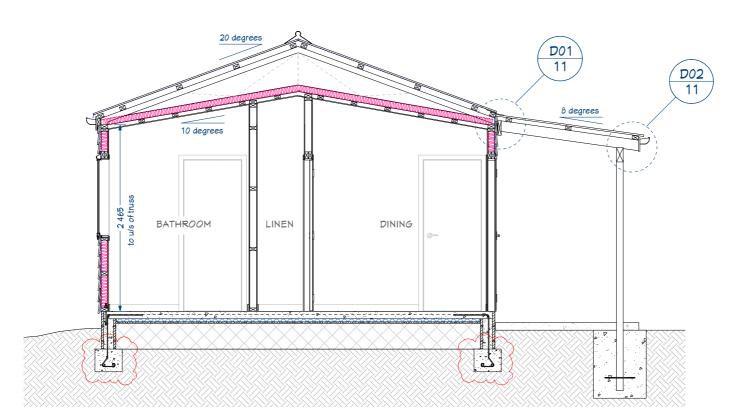
Drawing Title: Foundation Plan & details
Drawing Scale: As shown

Designed by Gordon Sanson LBP 117656 REV 1 - 26.03.19 Footings amended Date Drawing Printed:
Tuesday, 26 March 2019

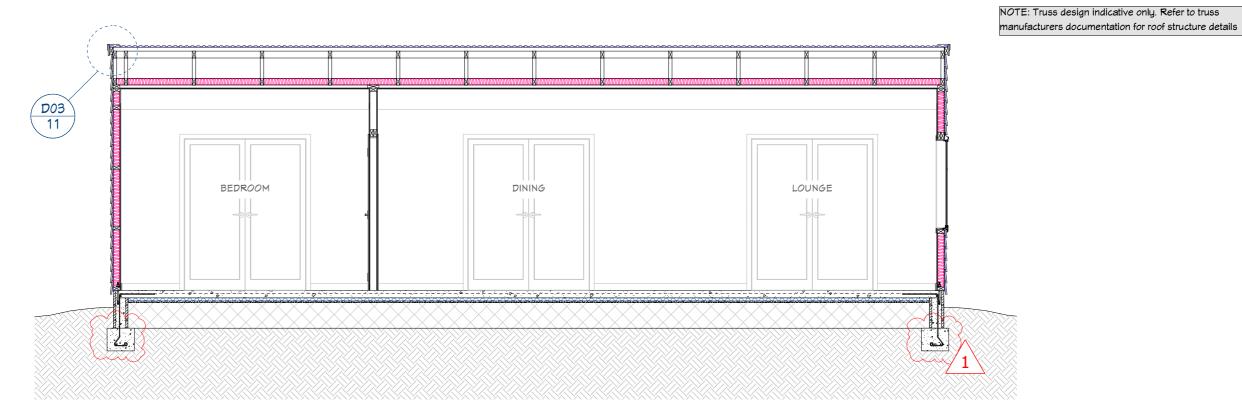
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CROSS SECTION A-A



CROSS SECTION B-B

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278 Meeanee Road

Drawing Title: Sections

Drawing Scale: 1:50

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ROOF: Colorsteel Corrugate roof over self supporting building underlay. Trusses as per

radiata H1.2 568 kiln dried gauged purlins. 135 continuous colorsteel gutter on 16x180 Axent

CEILINGS: 10mm gib ultraline ceilings on 75x40mm H1.2 radiata battens @ max 450 crs fixed to truss bottom chord. R3.6 batt ceiling

insulation. Square stopped scotia. 30mm bevel MDF scotia to wardrobes and cupboards.

WALLS: J-Frame  $90 \times 45$  per timber schedule. 10mm Gib interior linings stopped to level 4 and

DOORS: Hollow core interior doors with 18mm pine reveals and 60mm bevel edge architraves

FLOOR: 500E mesh reinforced 100mm concrete floor over 40mm polystyrene rigid insulation over

DPM and compacted fill with D12 steel reinforced

VERANDAH: 140x45 SG8 rafters @ 900 CRS on Prolam PLVL8H3-200100PP - 190x88 verandah

beam & 4 / 88 × 88 mm Radiata Finger Jointed

CLADDING: Linea weatherboards direct fixed over masons barricade building wrap.

WINDOWS: Powder coated aluminium joinery, double glazed with glass type per elevations. 18mm pine reveals with 60mm bevel edge architraves. 2000 standard head

300 × 300mm concrete footing.

Laminated H5 Posts

wall batts.

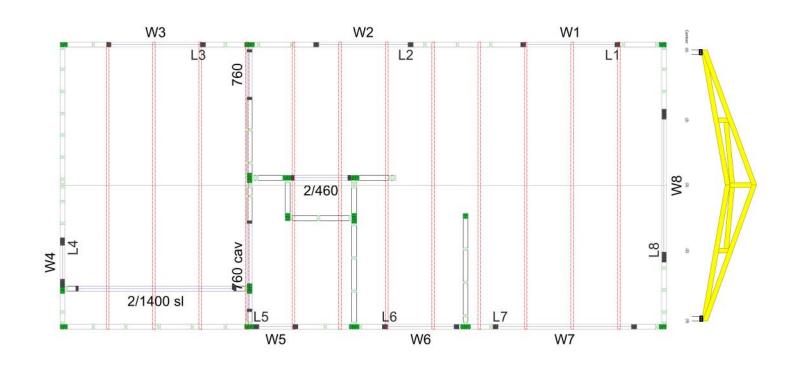
paint finish. 80mm bevel edge skirting. R2.6 Ultra

fascia to paint finish PVC down pipes.

truss manufacturers' documentation.75×50mm

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Rough Opening Schedule - Level 1							
Qty	Name	Height x Width	Fin. Height	Lintel Size			
1	L1 - W1	2015 x 1615	2015	1-PLL150			
1	L2 - W2	2015 x 1615	2015	1-PLL150			
1	L3 - W3	2015 x 1615	2015	1-PLL150			
1	L4 - W4	1215 x 615	2015	2-90x45 MSG8 H12			
1	L5 - W5	1015 x 615	2015	2-90x45 hyCHORD H12			
1	L6 - W6	1015 x 1215	2015	1-PLL150			
1	L7 - W7	1215 x 2415	2015	1-PLL200			
1	L8 - W8	1215 x 2415	2015	1-PLL200			
1	760	2035 x 815	2035	(None)			
1	760 cav	2075 x 1550	2075	(None)			
1	2/460	2035 x 975	2035	(None)			
1	2/1400 sl	2080 x 2820	2080	(None)			

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Napier

Drawing Title: Trusses & lintels plan

Drawing Scale: Not to scale

Designed by Gordon Sanson LBP 117656 Date Drawing Printed:

Monday, February 25, 2019

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#### LEGEND

•	LED DOWNLIGHT LIGHT- INT	
0	LED WALL MOUNTED LIGHT - EXT	
1	SINGLE LIGHT SWITCH	
2	DOUBLE LIGHT SMITCH	
3	TRIPLE LIGHT SMITCH	
1 >	SINGLE OUTLET	
2 ⊳	DOUBLE OUTLET	
TY▶	TV	
V&D ►	VOICE & DATA	
AC >	AIR CONDITIONING	
×	BATHROOM FAN	
	SMITCH BOARD	

SMOKE

ALLOW FOR ALL KITCHEN FIXTURES REFER TO SEPARATE KITCHEN DESIGN LAYOUT

ALL DOWN LIGHTS TO BE C.A RATED = CLOSED ABUTTED, & INSTALLED TO NZECP

DENOTED SMOKE ALARM FITTED WITH HUSH AND TEST FACILITIES COMFORMING WITH NZBC F7/AS1

RHEEM Optima 913 180 15 MAINS PRESSURE WATER HEATER TO BE INSTALLED AS PER MANUFACTURER'S INSTALLATION MANUAL

ALL LIGHTING TO COMPLY WITH G8

FOULWATER DESIGN TO AS/NZS3500.2

BATHROOM

Basin: 1 fixture unit Shower: 2 fixture units WC Pan: 6 fixture units Washing Machine: 5 fixture units

Sink & waste: 3 fixture units Dishwasher: 3 fixture units

DRAINAGE

Total 20 fixture units = 100mm @ 1:60 fall

100mm pipes to be min. 1:60 fall Pipes <100mm to be min. 1:40 fall All drains in slab to be min. 65mm Terminal Vent 50mm

FIXTURE PIPE SIZES: Sink: 50mm Vanity: 50mm Shower: 50mm

Washing machine: 50mm Water closet pan: 100mm

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Water pipes to be polybutylene Mains Supply 25mm black & blue Hold & Cold 20mm main feed with 15mm branch feed

STORMWATER DESIGN TO NZBC E1/AS1

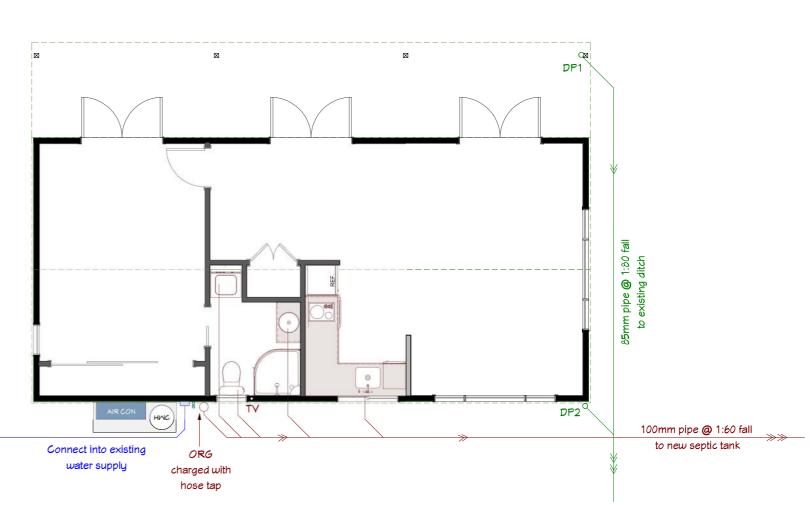
dp1 catchment 52 m<sup>2</sup> dp2 catchment 31.2 m<sup>2</sup>

(85mm downpipes pipe to be used)

MODIFIED CATCHMENT AREA

0.01 x (total roof area 83.2 m<sup>2</sup>) x rainfall 85mm = 71

Therefore use 85mm pipe @ 1:80 fall





Owner to confirm placement on site prior to wiring

PLUMBING PLAN

Drainage Plan indicative only. Refer to "as-built" plans on completion.

New homes design and build

Stones Secondary Dwelling

278 Meeanee Road

Drawing Title: Electrical & Plumbing Plan Drawing Scale:1:75

Designed by Gordon Sanson LBP 117656

REV 1 - 02.04.19 Note added

Date Drawing Printed:

Tuesday, 2 April 2019

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#### FINISHES KEY

Carpet (to bedroom and lounge)

Laminate (to kitchen, dining and bathroom)

#### DOOR HARDWARE

A Passage Door Hardware

B Sliding Door Hardware

C Dummy Door Hardware (Free turning)

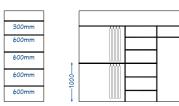
Mall Mounted Doorstop

Wall Mounted Latch Back Doorstop

HERMAL ENVELOPE		
uall area - Mest	17.29	sa m
uindow & door area - Mest	9.60	sa m
uall area - North	9.44	sa m
uindow & door area - North	2.88	sa m
uall area - East	22.12	sa m
uindow & door area - East	4.68	sa m
vall area - South	11.60	sa m
vindow & door area - South	0.72	sq m

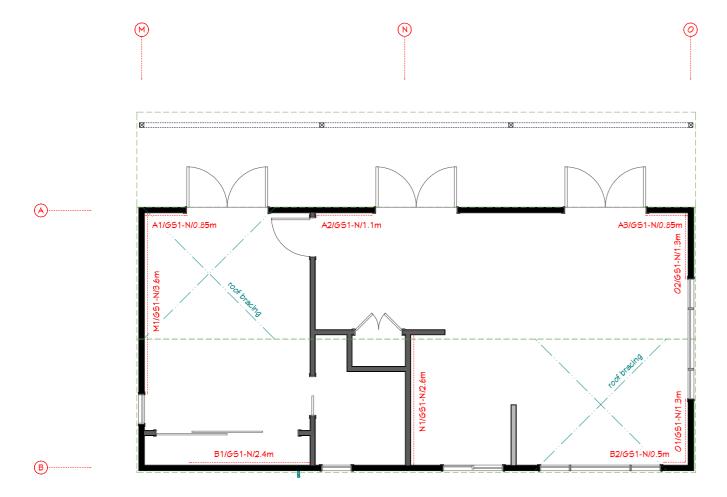
The building complies with NZ54218:2009 or the BPI and therefore with NZBC Clause H1

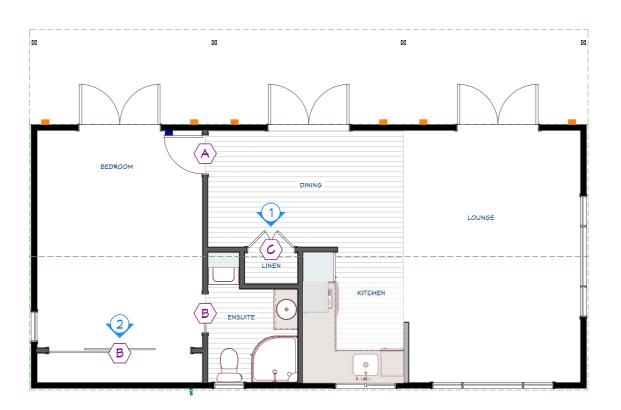
Refer to Design Navigator Calculations in Specifications.



Shelves 1 UT pine slats

Paint finish MDF
All shelves to be 300mm wide





BRACING PLAN

FINISHES PLAN

Homeworx
New homes design and build

Stones Secondary Dwelling

278 Meeanee Road

Napier

Drawing Title: Bracing & Finishes Plan

Drawing Scale:1:75

Designed by Gordon Sanson LBP 117656 Notes

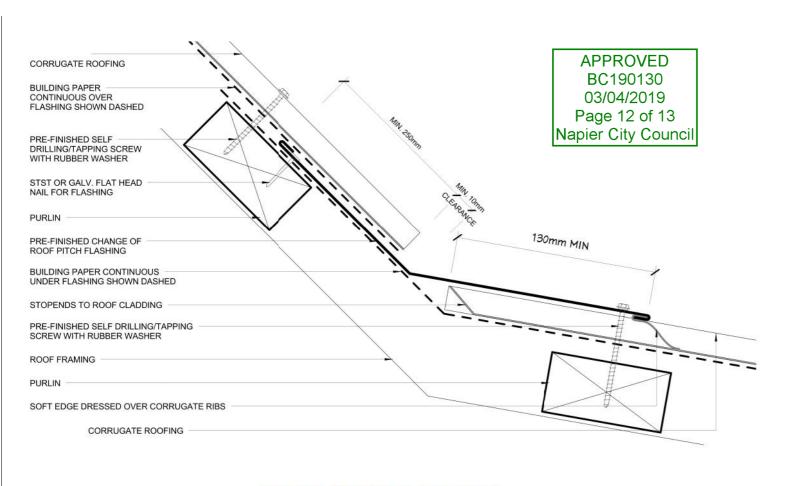
Refer to bracing calculations

Date Drawing Printed:

Tuesday, 26 March 2019

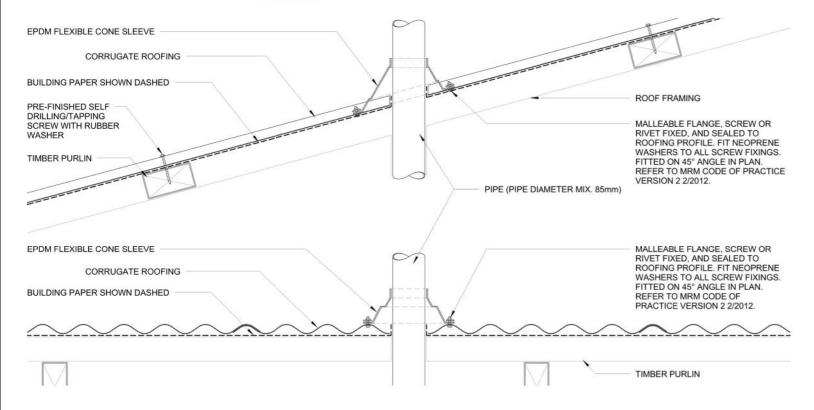
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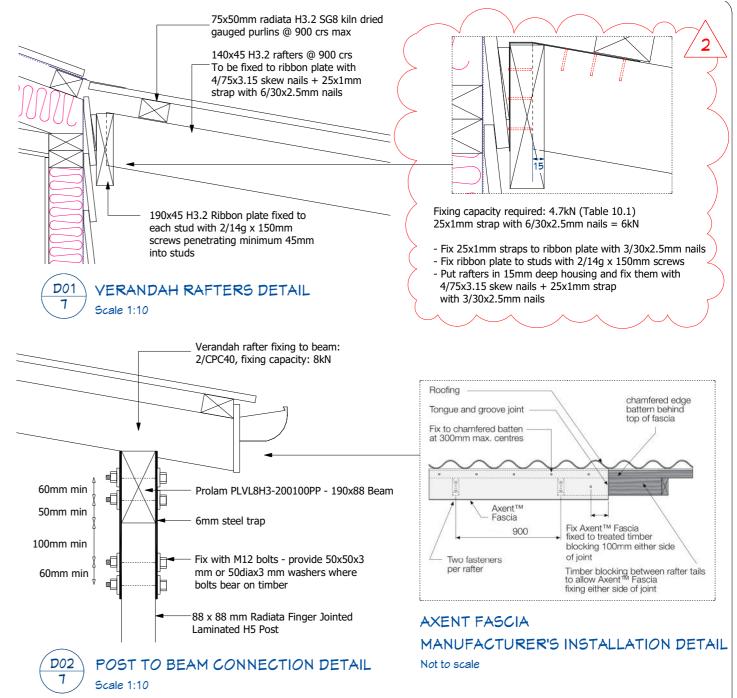
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## CHANGE OF ROOF PITCH DETAIL

Not to scale





Roof underlay Two crests, finish in next trough Corrugate roofing 50mm min overlap to barge board Timber packer Axent Fascia to finish 20mm under timber packer Bottom of timber packer to match weatherboards colour Linea weatherboards Masons barricade building wrap Roof structure - refer to truss manufacturer's documentation

BARGE DETAIL Scale 1:10

# PIPE PENETRATION DETAIL

Not to scale



Stones Secondary Dwelling

278 Meeanee Road

LBP 117656

Drawing Title: Roof details

Drawing Scale: As shown Designed by Gordon Sanson REV 1 - 26.03.19

Details 01, 02, 03 amended (rafter fixings and drip edge)

REV 2 - 02.04.19 Detail & note added Date Drawing Printed:

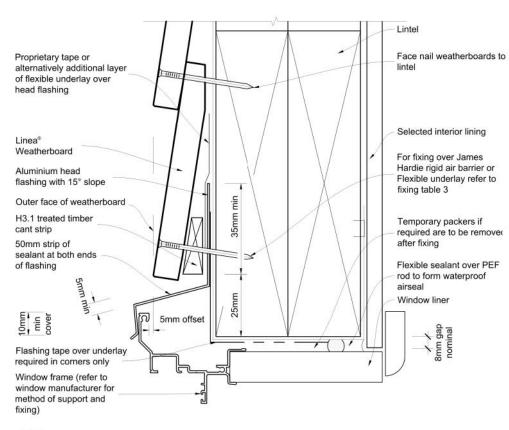
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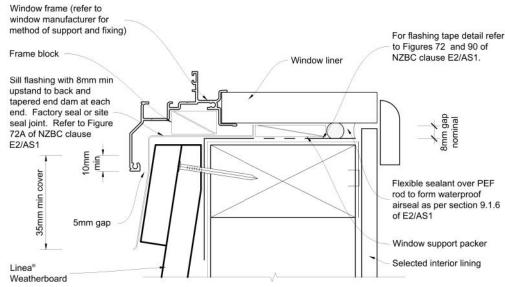
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Onekawa, Napier



When James Hardie rigid air barrier is used flashing tape to be applied to the entire window opening Sealant must be installed between head flashing and window flange in VH wind zones. Refer Figure 71 of E2/AS1

#### WINDOW HEAD DETAIL

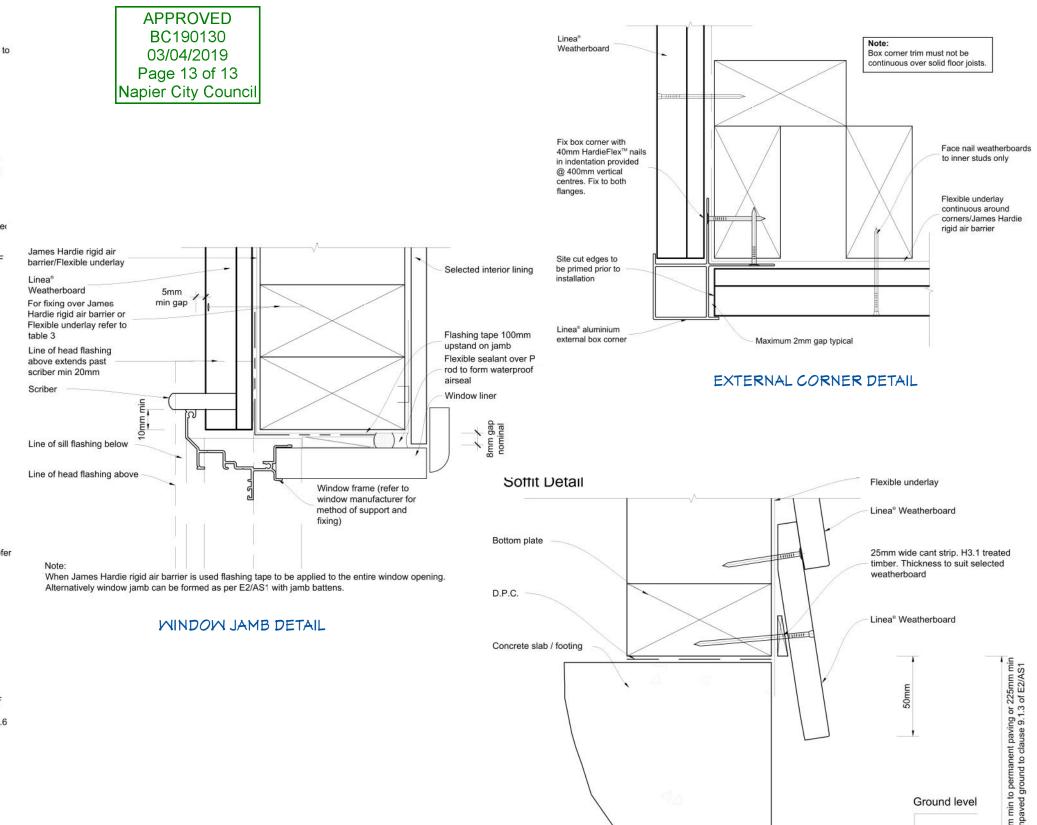


#### General notes for materials selection

- 1. Flashing materials must be selected based on environmental exposure, refer to NZS 3604 and Table 20 of NZBC clause E2/AS1.
- Flexible underlay must comply with acceptable solution E2/AS1.
- Flashing tape must have proven compatibility with the selected flexible underlay/James Hardie rigid air barrier and other materials with which it comes into contact.

Refer to the manufacturer or supplier for technical information for these materials.





# BASE OF WALL DETAIL



Stones Secondary Dwelling

278 Meeanee Road

Drawing Title: Linea Meatherboard details Drawing Scale: Not to scale

Designed by Gordon Sanson LBP 117656

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