APPROVED BC180675 17/08/2018 Page 1 of 21 Napier City Council

Approved Building Consent Documents

PLEASE NOTE
This consent is subject to construction monitoring

Please Note: A copy of the stamped approved documents must be available on site for all inspections.

Irene Cahill and Gunnar Kasch Kasch Ka



New Mestshore Home



Irene Cahill and Gunnar Kaschka

Drawing Title:

Drawing Scale

Date Drawing Printed:

Sunday, July 15, 2018

Copyright Notice: This design, whether in whole or in part, remains the copyright of Homeworx. No part of these drawings may be used for other than its intended purpose or reproduced without the

Homeworx

170 Charles Street

Westshore

336 Meeanee Road, Napier

LBP 117656

Designed by Gordon Sanson

PO Box 3394

Onekawa, Napier


06-843 8834

APPROVED

BC180675

17/08/2018

APPROVED BC180675 17/08/2018 Page 3 of 21 Napier City Council

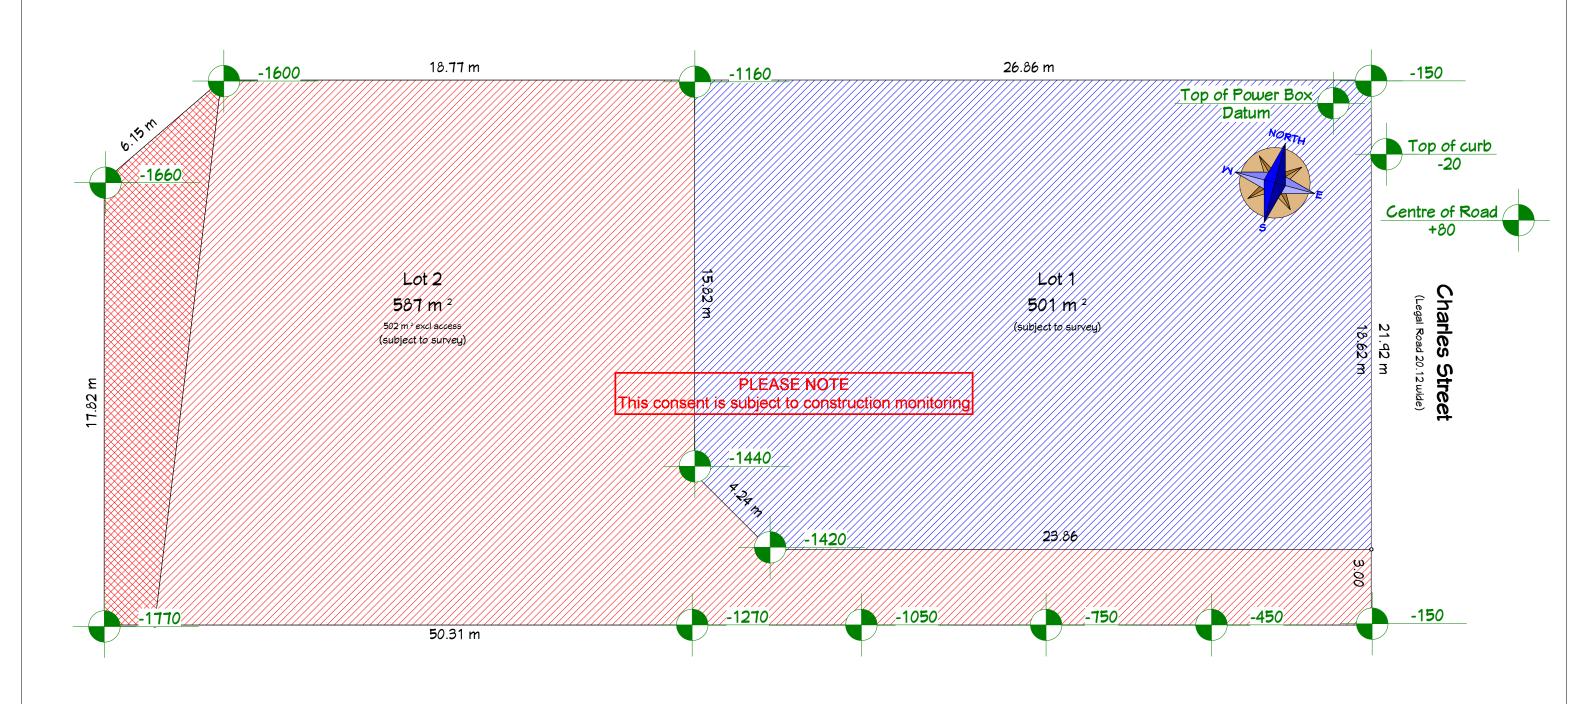

	Homeworx
L	New homes design and build
	Homeworx New homes design and build

Irene Cahill and Gunnar Kaschka	Drawing Title: Site and Subdivision
170 Charles Street	Drawing Scale: 1:150
Westshore	Designed by Gordon Sanson
Napier	LBP 117656

Subdivision plan to be submitted by Marwick Marshall

Date Drawing Printed: Sunday, August 12, 2018


Copyright Notice: This design, whether in whole or in part, remains the copyright of Homeworx. No part of these drawlings may be used for other than its intended purpose or reproduced without the express written permission of Homeworx.

336 Meeanee Road, Napier Homeworx

PO Box 3394


Onekawa, Napier

P 06-843 8834

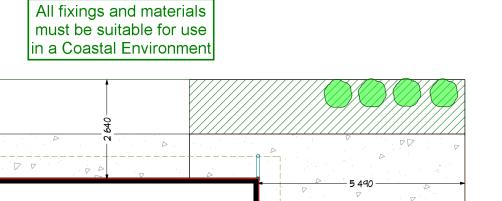

PLANNING ARPROVEDC BC180675 Page 4 of 21 Date Completed Nap 7608/20 Council

Floor Area 158.3 m² Site Area 300 m² Front Yard Area 93 m² Front Yard landscape Area 35m² (37%) Outdoor Living Area 226 m²

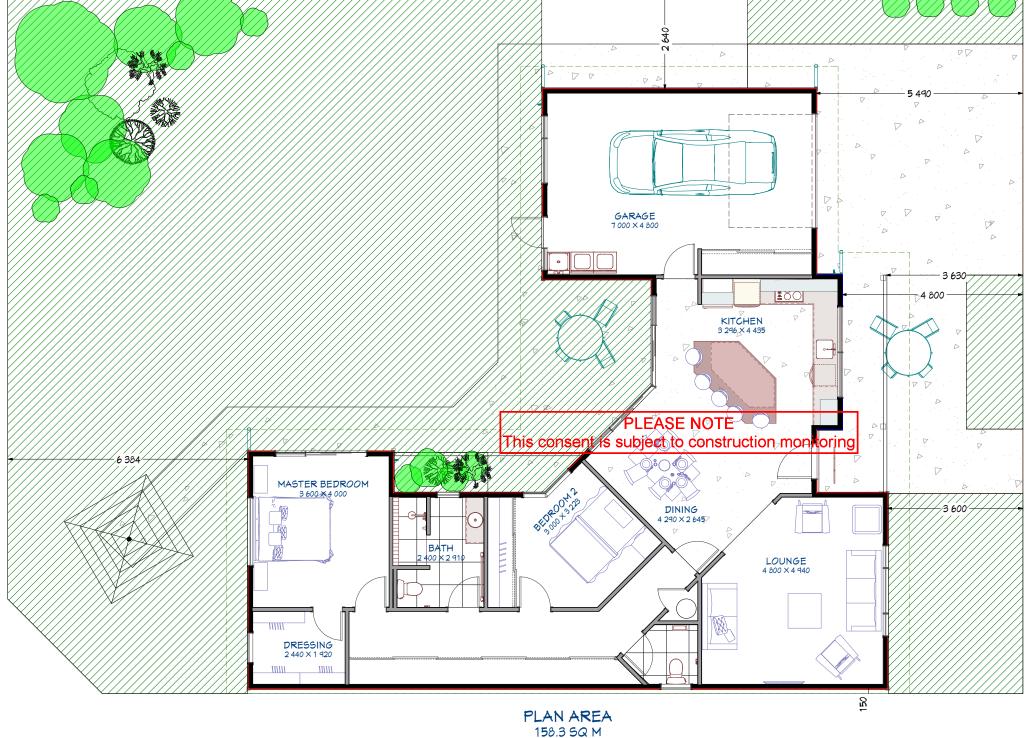

250	Homeworx ew homes design and build	
	ew homes design and build	

Irene Cahill and Gunnar Kaschka 170 Charles Street

Mestshore

Napier

Drawing Title: Site Plan Drawing Scale: 1:100

LBP 117656


Designed by Gordon Sanson

Dimensions are to framing

Date Drawing Printed:

Sunday, July 15, 2018

Copyright Notice: This design, whether in whole or in part, remains the copyright of Homeworx. No part of these drawings may be used for other than its intended purpose or reproduced without the express written permission of Homeworx.

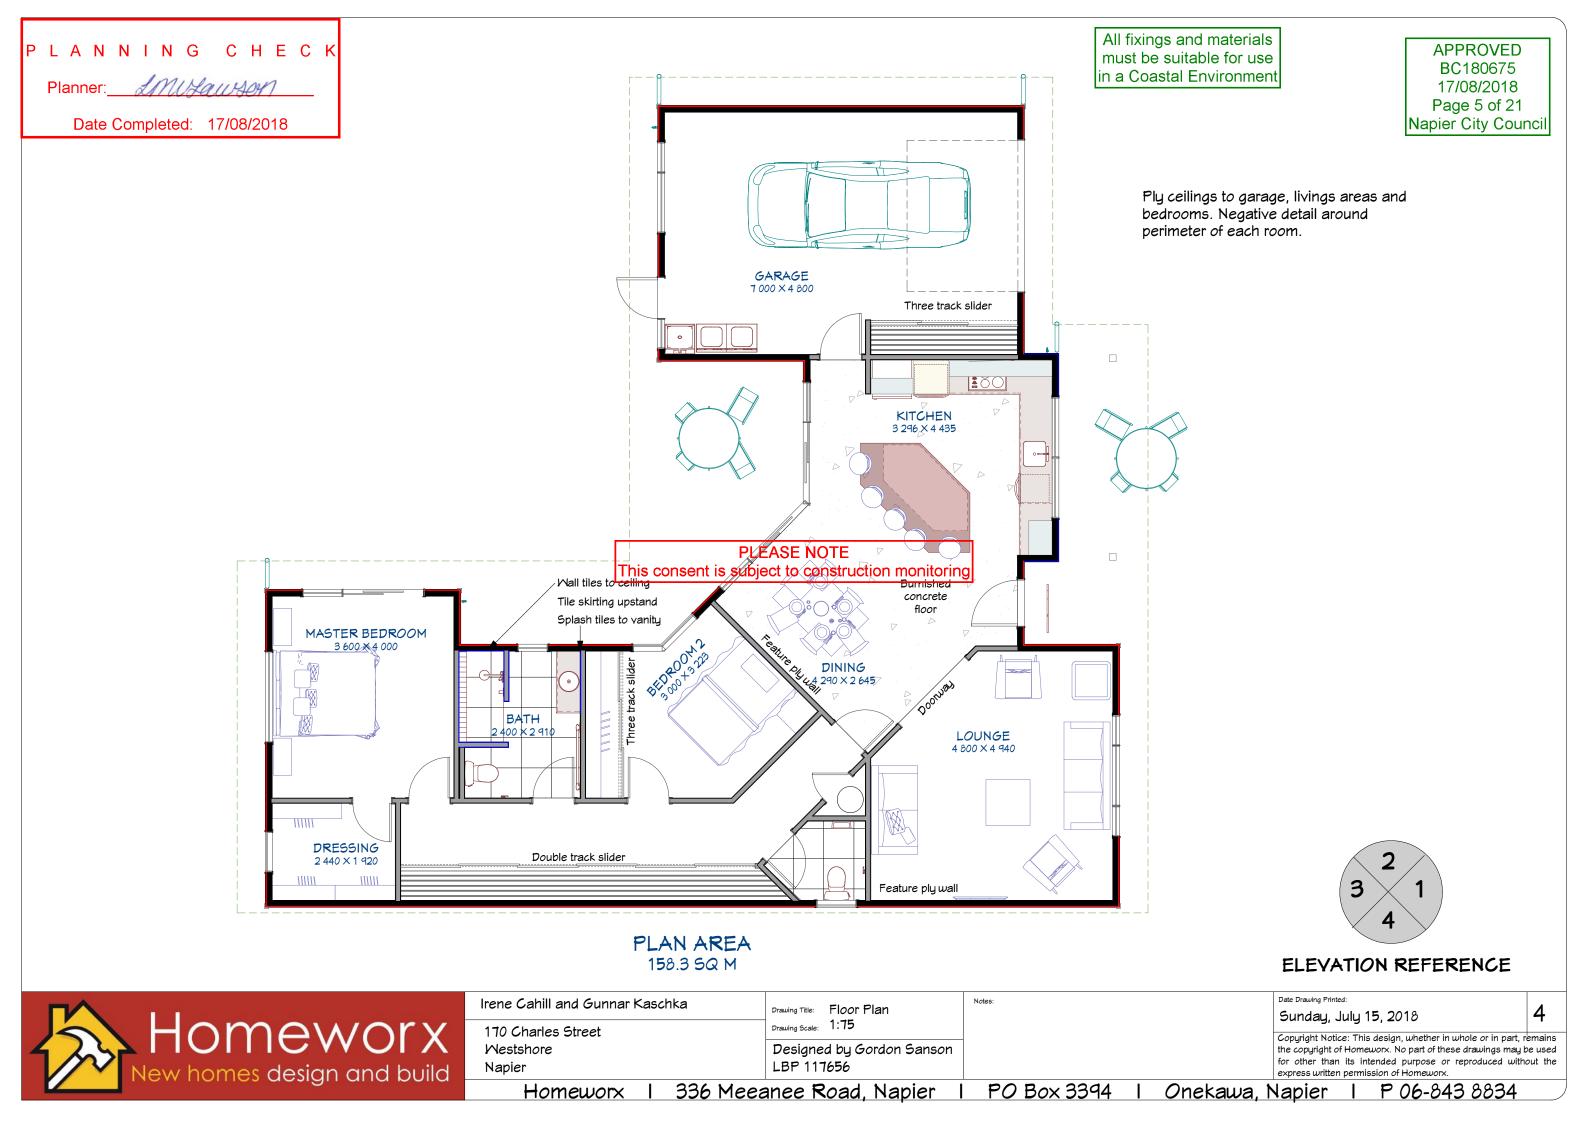

TIMBER SCHEDULE (High Wind Zone)

All timber to comply with NZS3602 and grades to be SG8 unless otherwise stated.

TIMBER TREATMENTS

Bottom Plates: Single 90 x 45 H3.2 over DPC (Internal and External)
Studs: 2.465 stud height (2.410 finished)
90 x 45 H1.2 J Frame @ 600 crs.
Dwangs to suit cladding

Sills: 1.800 of greater - double 90×45

H1.2


Top plates: double 90 x 45 H1.2 Lintels: H1.2. Sizing per schedule Trusses: H1.2 per truss design and

layout

Rafters: H1.2 - 250 × 50 @ 600 crs Purlins: H1.2 - 70 × 45 on flat. End spacing to be 0.600crs max and intermediate spacing @ max 900 crs

Fascia: H3.1 - 150 × 30



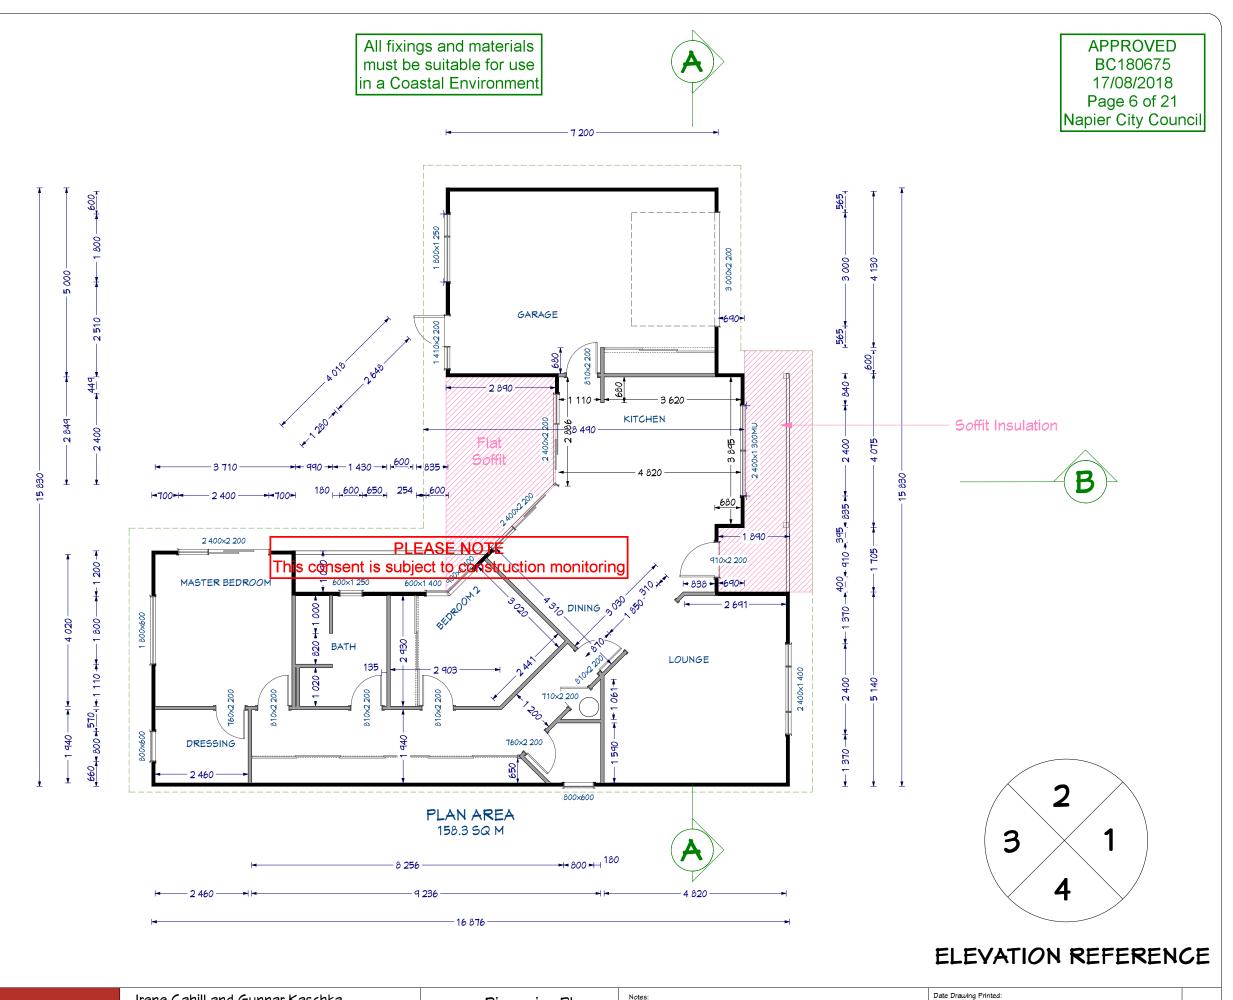



Irene Cahill and Gunnar Kaschka

170 Charles Street

Westshore
Napier

Drawing Title: Dimension Plan

Drawing Scale: 1:100

Designed by Gordon Sanson

LBP 117656

Sunday, August 12, 2018

Copyright Notice: This design, whether in whole or in part, remains the copyright of Homeworx. No part of these drawings may be used for other than its intended purpose or reproduced without the express written permission of Homeworx.

Homeworx I 336 Meeanee Road, Napier I PC

PO Box 3394 | Onekawa, Napier

P 06-843 8834



	ADDDOVED
ELEVATION MATRIX	ELECATION Y-50
Mind Zone	High BC180675
Number of Storeys	Single 7/98/2018
Roof/Mall Intersection	_{Non} ⊌age 7 of 21
Eaves Width	Mapier City Counc
Envelope Complexity	Medium (Linea & Pin
Deck Design	None 0
Total	2

ELEVATION MATRIX	ELEVATION 4	
Mind Zone	High	1
Number of Storeys	Single-Low	0
Roof/Wall Intersection	None	0
Eaves Width	0 - 100	5
Envelope Complexity	Low (Oblique)	0
Deck Design	None	0
Total		6

Linea direct fix, Shiplap pine on 20mm cavity, Oblique on 20mm cavity.

PLEASE NOTE

This consent is subject to construction monitoring

We come and production and prod

Colorcote Superdeck 5 rib roof

Marley Stormcloud Spouting on 30mm timber facia to PVC downpipes

James Hardie 180mm Smooth weatherboard cladding and Feature Shiplap Pine Cladding

Double glazed aluminium window joinery

Reinforced and Insulated Concrete Floor

650h × 800w (a)

Linea Oblique 300 vertical cladding

(t) tint

(c) clear

* safety glass

ELEVATION 4

ELEVATION 3

Homeworx New homes design and build Irene Cahill and Gunnar Kaschka

170 Charles Street Westshore

Drawing Title: Elevations
Drawing Scale: 1:100

Designed by Gordon Sanson LBP 117656 Windows to NZ54211:2008; Glazing to NZ54223.3 2016
All exterior joinery (excluding garage) to be standard IGU double glazing units
Safety glazing to comply with NZ54229:1999 part 3 as modified by

Date Drawing Printed: Sunday, July 15, 2018

Copyright Notice: This design, whether in whole or in part, remains the copyright of Homeworx. No part of these drawings may be used for other than its intended purpose or reproduced without the

Homeworx


336 Meeanee Road, Napier


PO Box 3394

Onekawa, Napier

for other than its intended purpose or reproduced without the express written permission of Homeworx.

Napier I P 06-843 8834

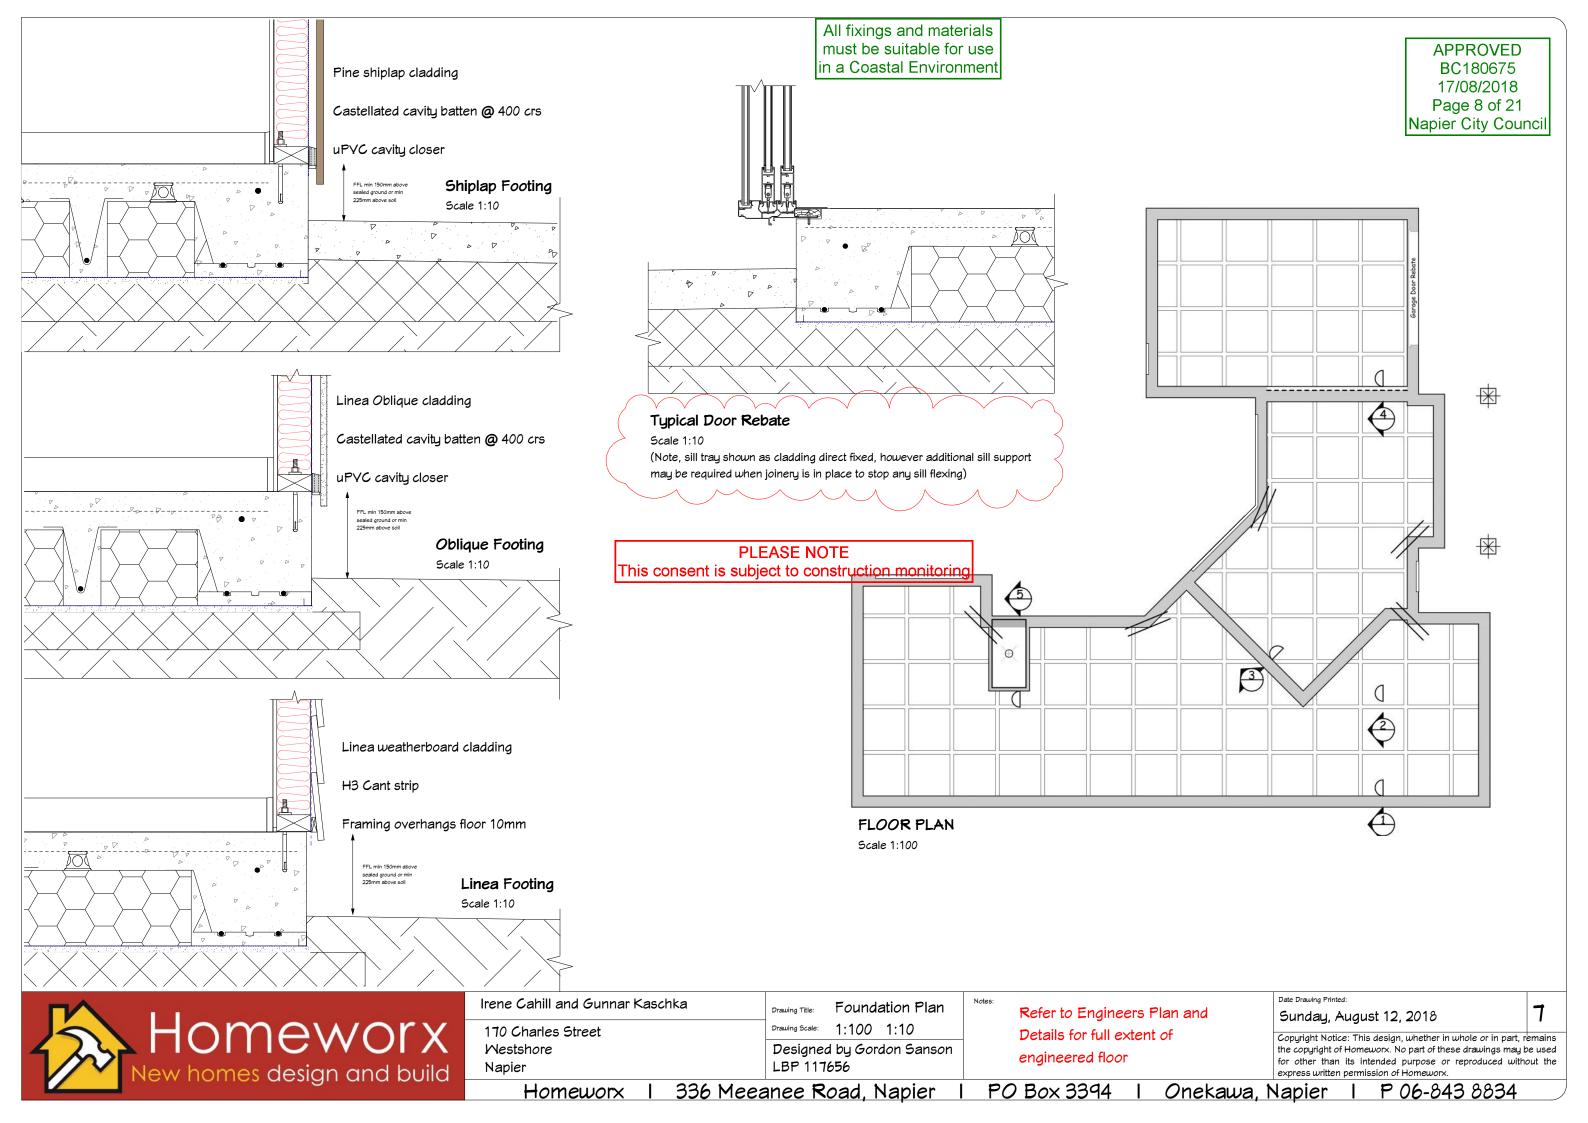

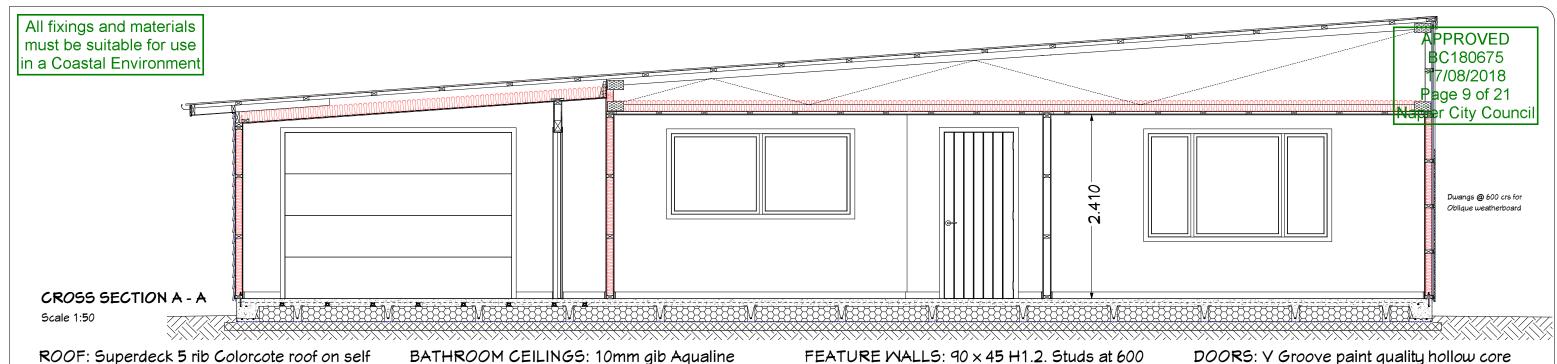

supporting building paper on 70 x 45 H1.2 purlins on 240 \times 45 H1.2 rafters @ 600 crs and trusses @ 900 crs per truss design and layout.

EAVES: Marley Storcloud gutter on 30mm timber fascia to paint finish PVC down pipes. Hardiflex 4.5mm soffit lining. (Note: Install insulation in soffit over outdoor living areas)

LIVING AREA CEILINGS: 10mm blonded poplar plu glued and brad fixed to timber ceiling battons fixed to truss bottom chord. Negative detail to perimeter. 1mm expansion joint

ew homes design and build

ceilings on 35mm Rondo battens @ max 450 crs fixed to truss bottom chord nogging with Rondo clips. R3.6 batt ceiling insulation.

MINDOMS: Powder coated aluminium joinery, double glazed. 18mm pine reveals with 40mm

bevel edge architraves.

external, 600 crs internal non-load bearing subject to constructional toring *Dwangs 800 crs. 10mm glb interior linings stopped to level 4 and paint finish. 65mm bevel This consent is subject to a construction monitoring

Homeworx

crs max external, 600 crs internal non-load bearing. Dwangs 800 crs. 10mm Okume ply stain or urethane finished as selected. 65mm bevel edge skirting. R2.6 Ultra wall batts.

CLADDING: Linea 180mm weatherboard direct fixed over building wrap on timber framing. Feature shiplap pine, direct fixed.

WALLS: 90 x 45 H1.2. Studs at 600 crs max PLEASE NO TELEASE NO TEL

PLEASE NOTE

PO Box 3394


with 4mm skins interior doors with 18mm paint quality pine reveals and 60mm MDF bevel edge architraves.

SLIDING DOORS: blonded poplar plywood doors


FLOOR: Engineered insulated engineered floor slab. Burnished floor finish to selected ares. Skim coat to base with paint finish.


express written permission of Homeworx

Onekawa, Napier

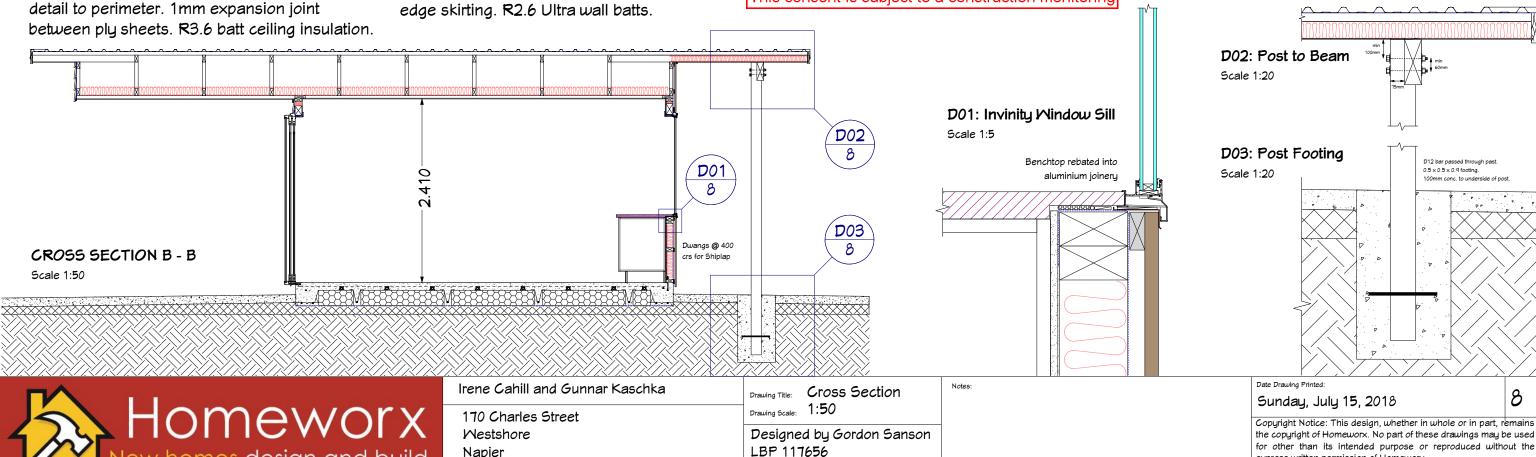

336 Meeanee Road, Napier

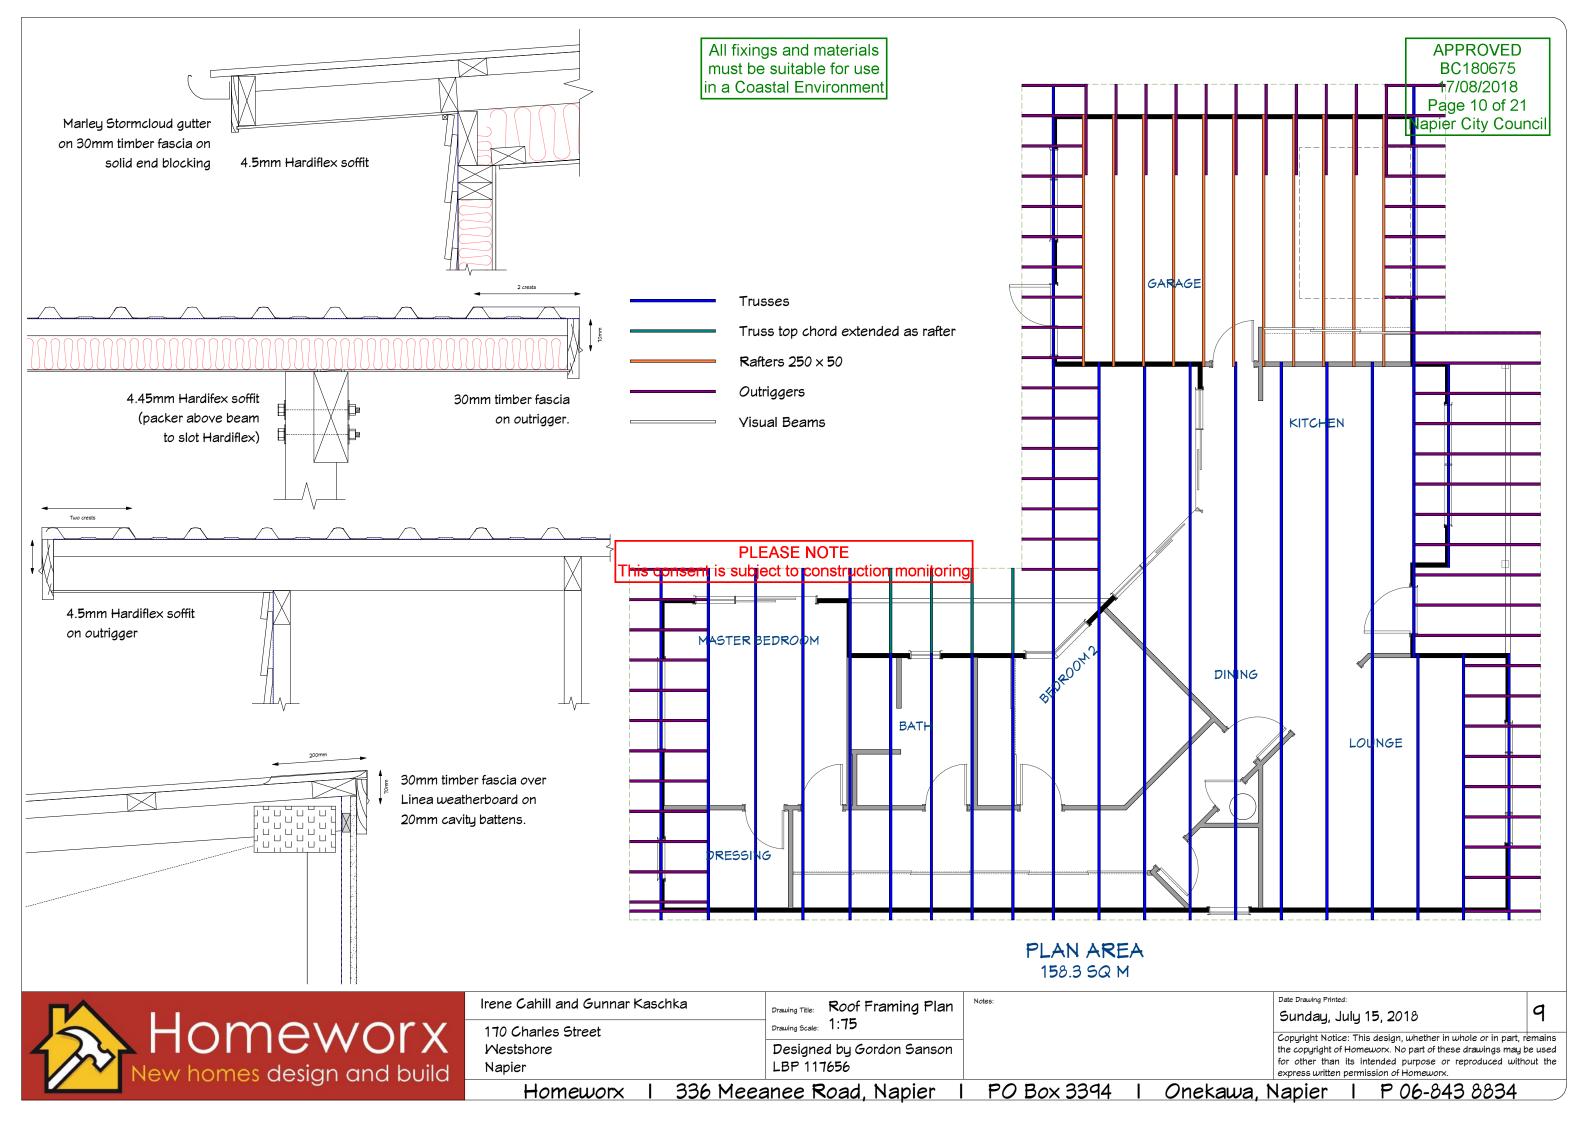

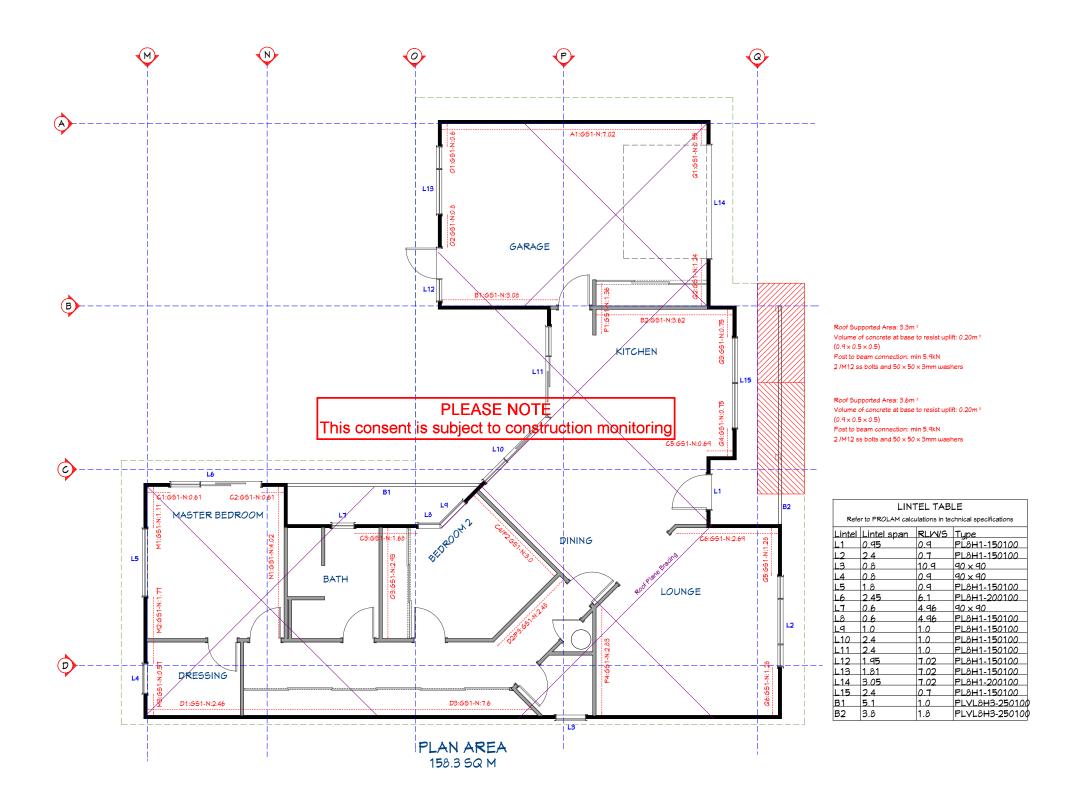

	11.	
250	Homeworx	
	Homeworx New homes design and build	_

Irene Cahill and Gunnar KaschkaDrawing Title:Bracing & Lintels170 Charles StreetDrawing Scale:1:100WestshoreDesigned by Gordon SansonNapierLBP 117656


Refer to Gib Ezybrace
Calculations in specifications

Sunday, July 15, 2018

Date Drawing Printed:

Copyright Notice: This design, whether in whole or in part, remains the copyright of Homeworx. No part of these drawings may be used for other than its intended purpose or reproduced without the express written permission of Homeworx.

Homeworx I 336 Meeanee Road, Napier I PO Box 3394 I Onekawa, Napier I P 06-843 8834

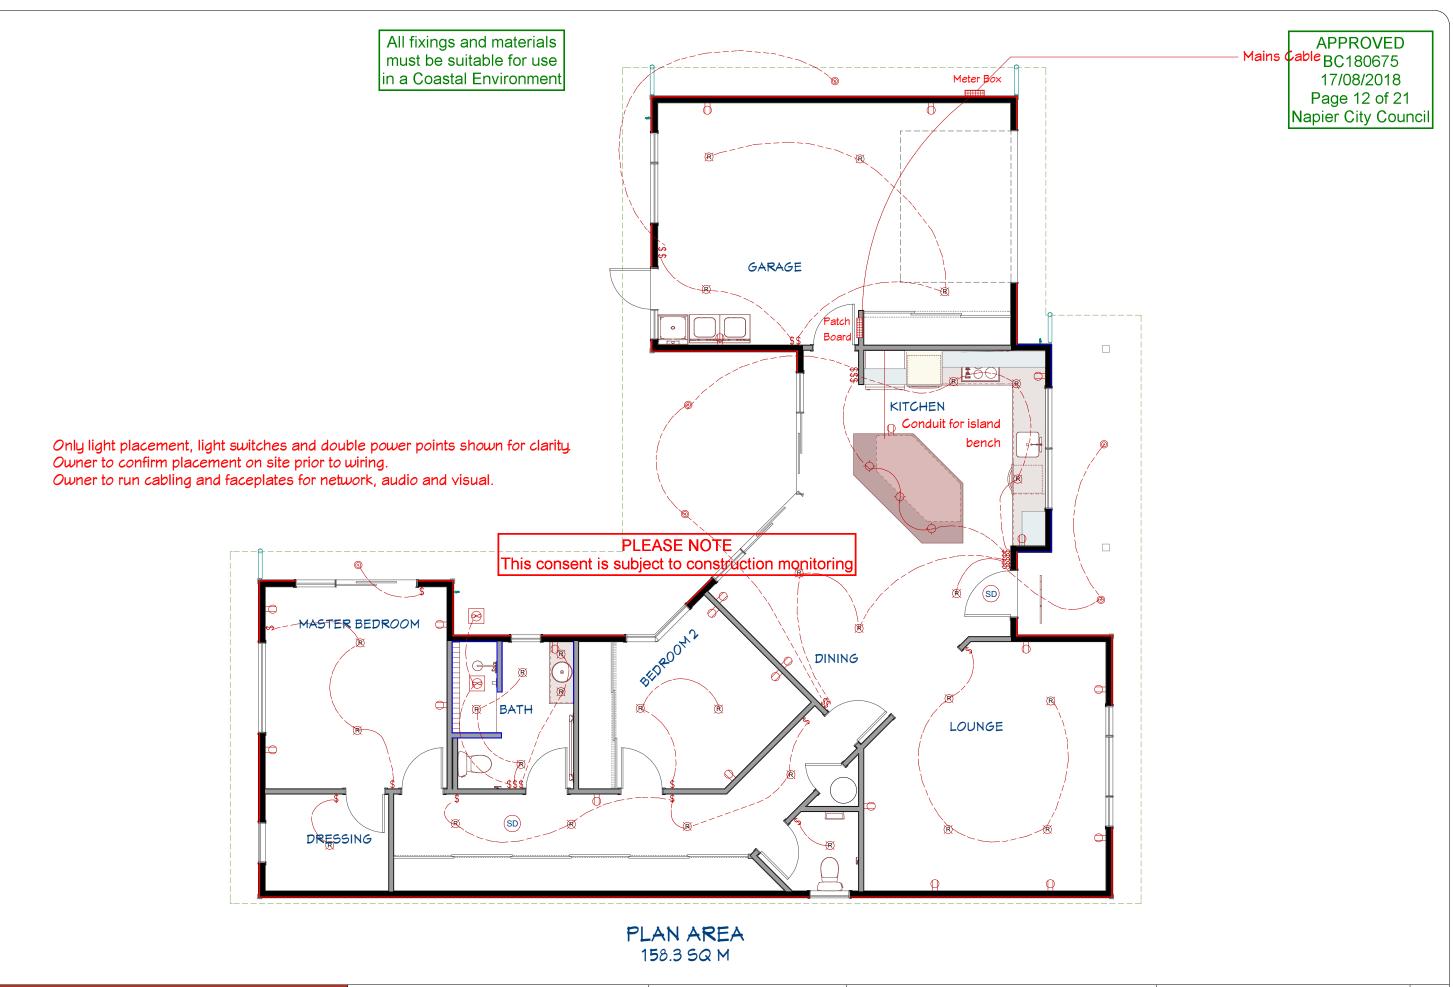



Irene Cahill and Gunnar Kaschka

170 Charles Street

Westshore
Napier

Drawing Title: Electrical Plan
Drawing Scale: 1:75

Designed by Gordon Sanson
LBP 117656


Notes:

Date Drawing Printed:
Sunday, July 15, 2018

| | | |

Copyright Notice: This design, whether in whole or in part, remains the copyright of Homeworx. No part of these drawings may be used for other than its intended purpose or reproduced without the express written permission of Homeworx.

APPROVED BC180675 17/08/2018 Page 13 of 21 Napier City Council

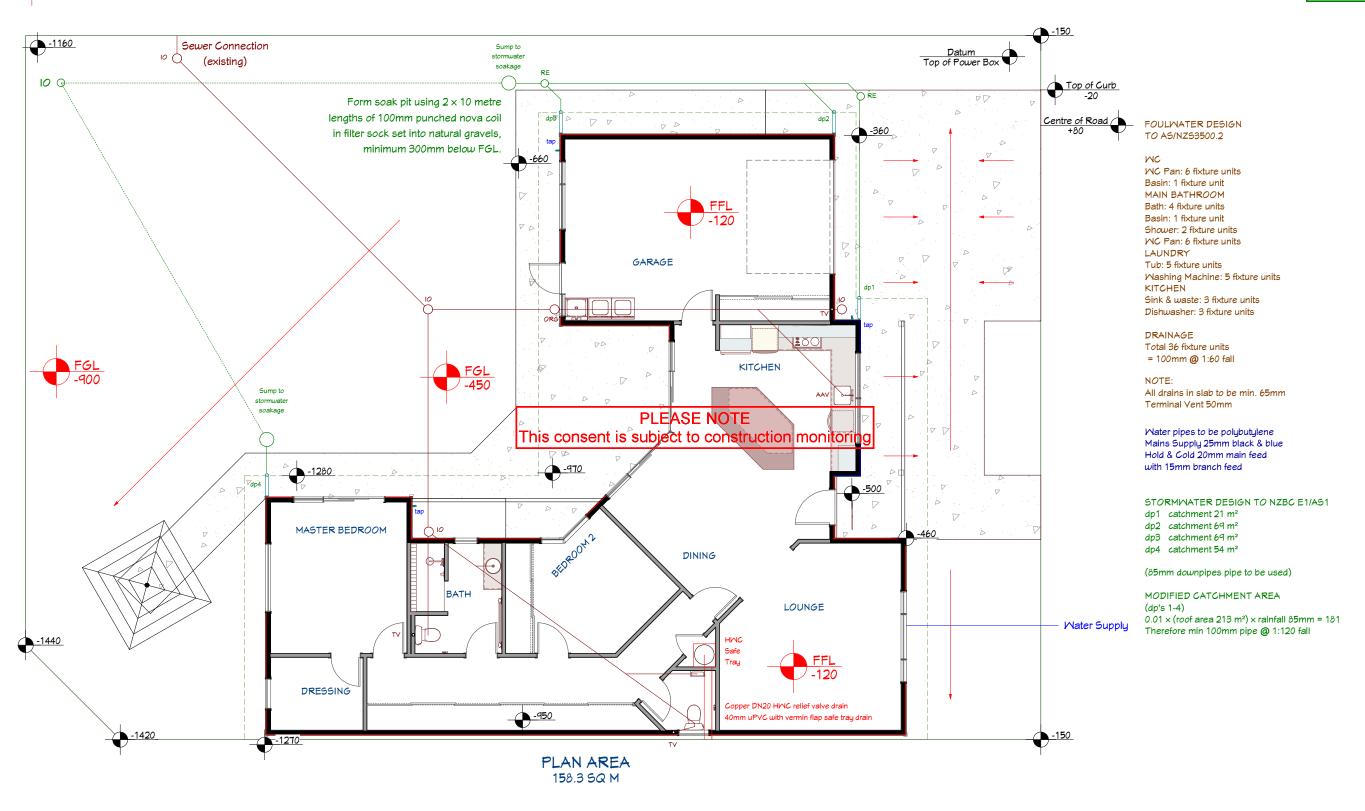

	11
20	Homeworx New homes design and build
	New homes design and build
	non nomes assign and bond

Irene Cahill and Gunnar Kaschka Drawing Title: Plumbing and Drainage Drawing Scale: 1:100 170 Charles Street Designed by Gordon Sanson Westshore LBP 117656 Napier

Homeworx

336 Meeanee Road, Napier


Tuesday, August 14, 2018


Date Drawing Printed:

Copyright Notice: This design, whether in whole or in part, remains the copyright of Homeworx. No part of these drawings may be used for other than its intended purpose or reproduced without the

12


SHELVING PLAN

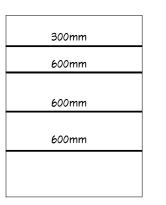

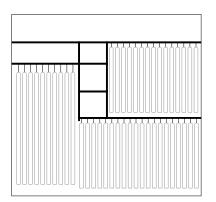

Shelves 1 & 3


Shelf 2

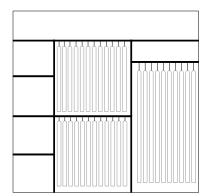

Shelves 4 & 5

DOOR HARDWARE

- Passage Door Hardware
- Privacy Door Hardware
- Dummy Door Hardware (Free turning)
- Slider Door Hardware
- Wall Mounted Doorstop
- Floor Mounted Doorstop
- Wall Mounted Magnetic Doorstop

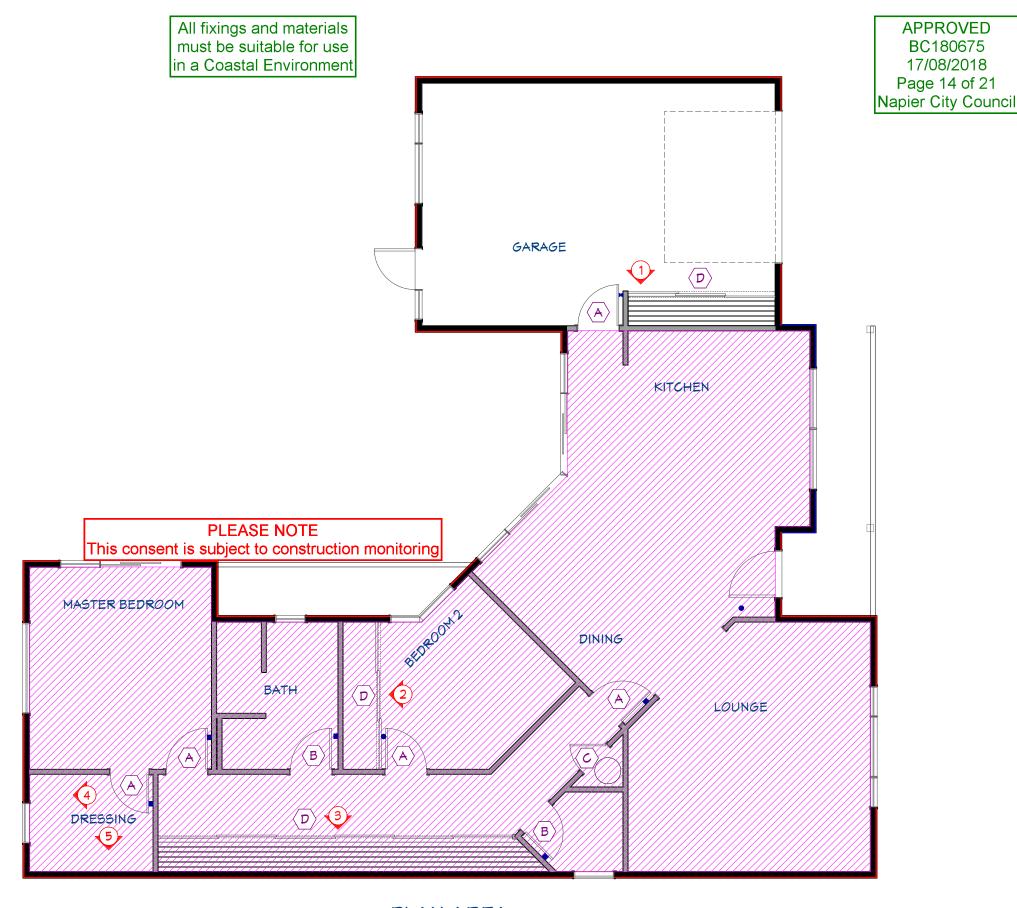

PLAN AREA 158.3 SQ M



Irene Cahill and Gunnar Kaschka

170 Charles Street

Mestshore

Drawing Title: Thermal Envelope Drawing Scale: 1:100

Designed by Gordon Sanson LBP 117656

Notes: This building complies with NZBC Clause H1 via the following

methods: The NZ54218:2009 Schedule Method, and; The NZ54218:2009 Calculation Method, and; The BPI Method

Date Drawing Printed:

Sunday, July 15, 2018


Copyright Notice: This design, whether in whole or in part, remains the copyright of Homeworx. No part of these drawings may be used for other than its intended purpose or reproduced without the


Homeworx


express written permission of Homeworx.

13

PO Box 3394 336 Meeanee Road, Napier Onekawa, Napier P 06-843 8834

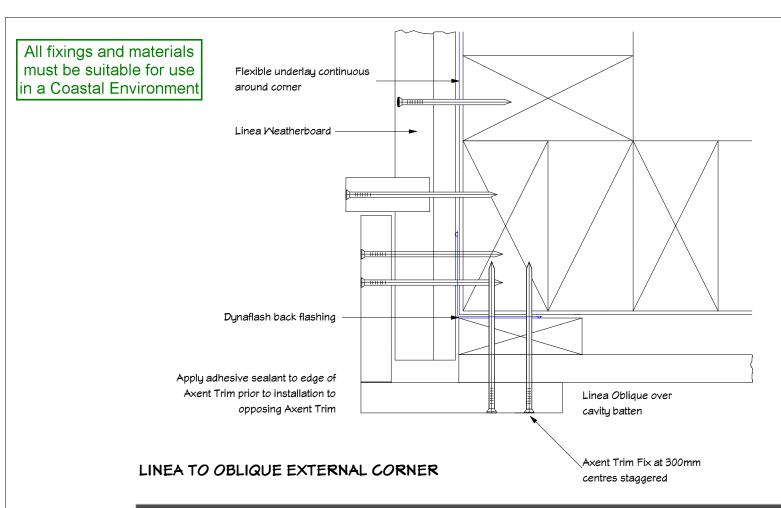

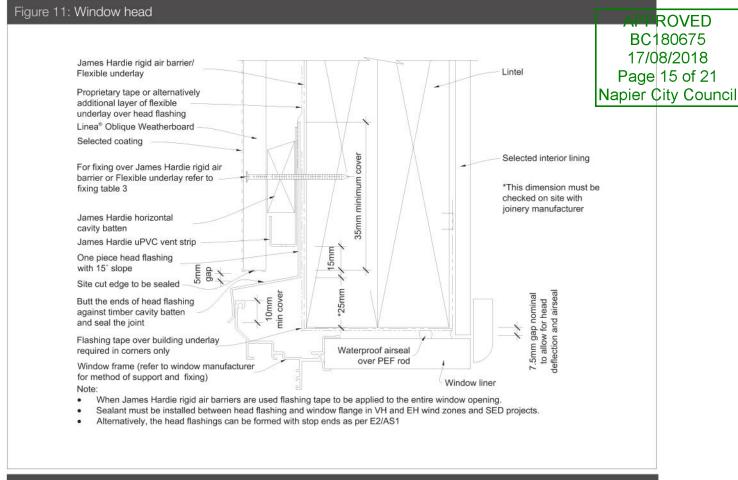

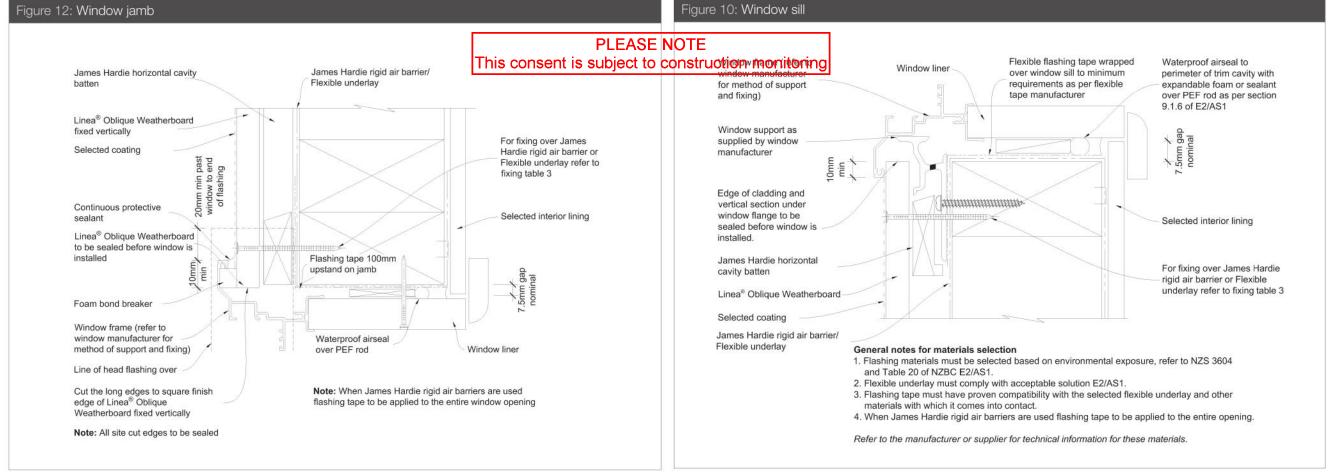



Irene Cahill and Gunnar Kaschka

170 Charles Street Westshore

Drawing Scale:

Linea Oblique Mindow Details

Designed by Gordon Sanson LBP 117656

Refer to Linea Oblique Technical Specification for full extent of details Date Drawing Printed:


Sunday, July 15, 2018


Copyright Notice: This design, whether in whole or in part, remains the copyright of Homeworx. No part of these drawings may be used for other than its intended purpose or reproduced without the


Homeworx

Onekawa, Napier

express written permission of Homeworx. P 06-843 8834

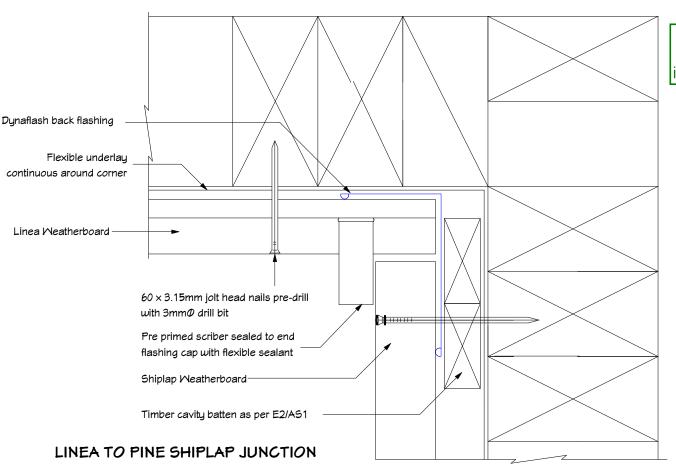

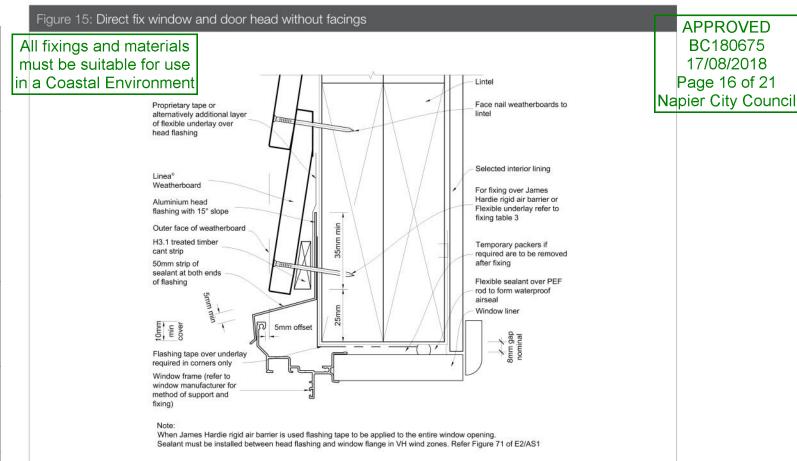

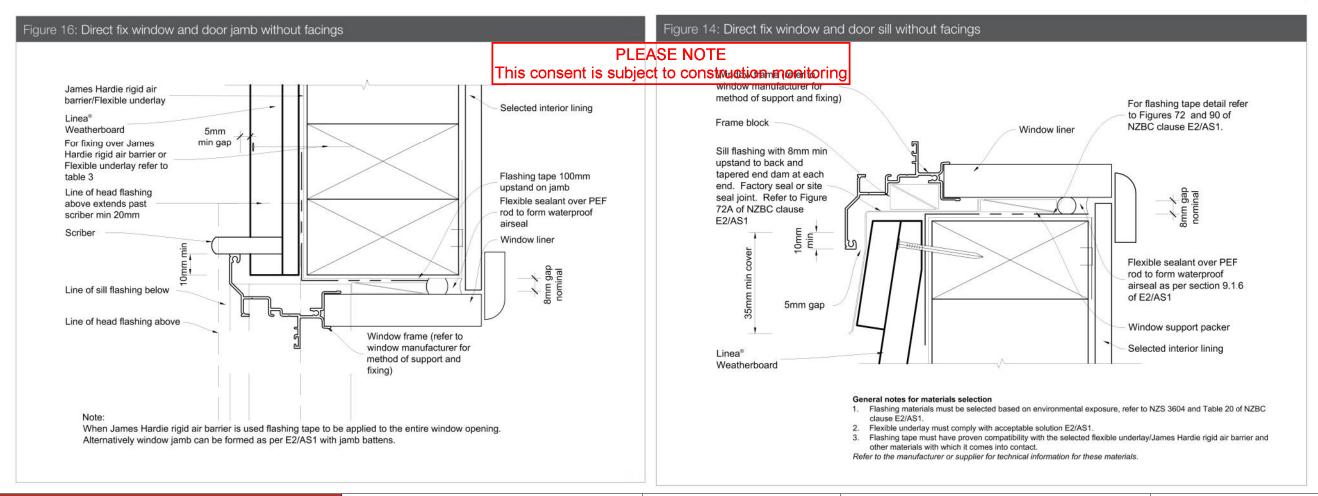



Irene Cahill and Gunnar KaschkaDrawing Title:170 Charles StreetDrawing Scale:WestshoreDesigned by Gordon SansonNapierLBP 117656

Re

Refer to Linea Weatherboard Technical Specification for full extent of details

PO Box 3394

Date Drawing Printed:


Sunday, July 15, 2018

Copyright Notice: This design, whether in whole or in part, remains the copyright of Homeworx. No part of these drawings may be used for other than its intended purpose or reproduced without the express written permission of Homeworx.

15

20.2 VC-201 - ALUMINIUM JOINERY HEAD BC180675 17/08/2018 Vertical Ship ap Weetherboard 17 of 21 Napier City Council (Vertical Framing) Additional Building Wrap or Flashing Tape See Note for details Cavity Closer Head Flashing must have 35mm upstand Minimum 15mm Drip edge (Cavity Closer to bottom of cladding) Head Flashing must **Building Wrap dressed** into opening with Head Flashing to provide minimum 10mm cover Flashing Tape at comers to Joinery head flange Continuous Air Seal (Sealant over Backing Rod) Aluminium Joinery (indicitive) Seal head flashing to Joinery head flange for Very High Wind Zones

20.3 VC-202 - ALUMINIUM JOINERY JAMB

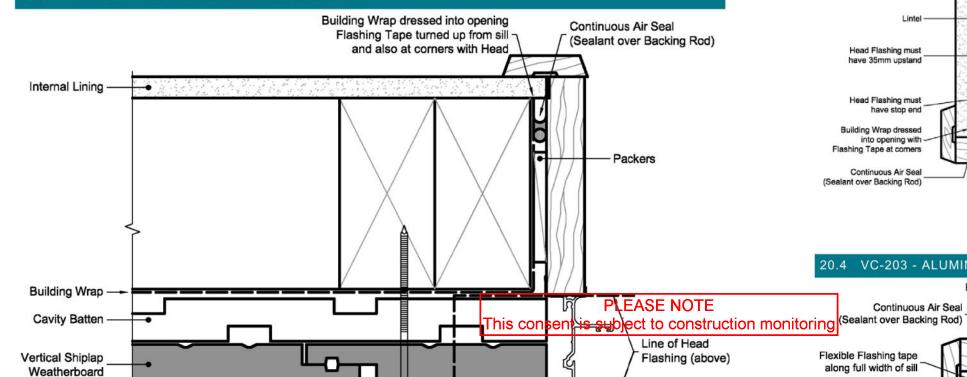

Minimum 20mm

Homeworx

Head Flashing Extension

Refer to Pine Shiplap Technical Specification for full extent of details

20.4 VC-203 - ALUMINIUM JOINERY SILL **Packers** Continuous Air Seal Aluminium Joinery (indicitive) Flexible Flashing tape Frame Block along full width of sill (-) () () **Building Wrap** Minimum 8mm cover dressed into opening Sill Support Bar Vertical Shiplap Weatherboard



Irene Cahill and Gunnar Kaschka Notes: Drawing Title: Drawing Scale: 170 Charles Street Westshore Designed by Gordon Sanson LBP 117656 336 Meeanee Road, Napier

Foam bond breaker

Joinery cover over Weatherboards

Minimum 10mm

Sunday, July 15, 2018

Copyright Notice: This design, whether in whole or in part, remains the copyright of Homeworx. No part of these drawings may be used for other than its intended purpose or reproduced without the express written permission of Homeworx.

PO Box 3394

Onekawa, Napier

P 06-843 8834

16

APPROVED BC180675 17/08/2018 Page 18 of 21 Napier City Council



5	Homeworx New homes design and build
	New homes design and build

Irene Cahill and Gunnar Kaschka

Drawing Title: Drawing Scale:

Date Drawing Printed:

Sunday, July 15, 2018

17

Designed by Gordon Sanson LBP 117656 **Mestshore**

PO Box 3394

Copyright Notice: This design, whether in whole or in part, remains the copyright of Homeworx. No part of these drawings may be used for other than its intended purpose or reproduced without the express written permission of Homeworx.

170 Charles Street

Napier

APPROVED BC180675 17/08/2018 Page 19 of 21 Napier City Council



336 Meeanee Road, Napier

Homeworx

PO Box 3394

Onekawa, Napier

P 06-843 8834

New homes design and build

APPROVED
BC180675
17/08/2018
Page 20 of 21
Napier City Council




336 Meeanee Road, Napier

Homeworx

PO Box 3394

Onekawa, Napier

P 06-843 8834

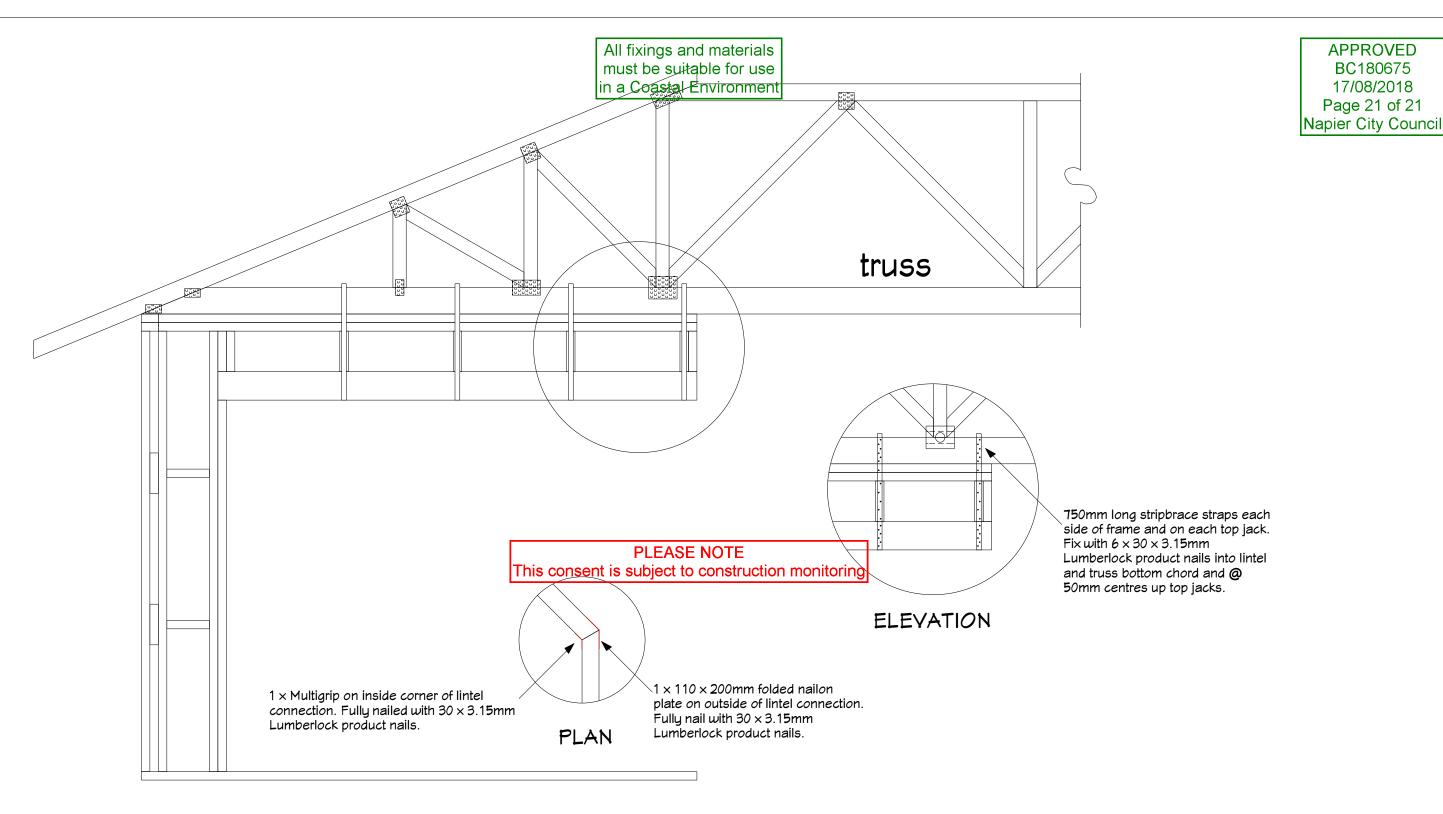

PILLARLESS FRAME DETAIL

Scale

Homeworx



Irene Cahill and Gunnar Kaschka Drawing Title: Drawing Scale: 170 Charles Street Mestshore Designed by Gordon Sanson LBP 117656

336 Meeanee Road, Napier

Date Drawing Printed: Sunday, August 12, 2018

Copyright Notice: This design, whether in whole or in part, remains the copyright of Homeworx. No part of these drawings may be used for other than its intended purpose or reproduced without the express written permission of Homeworx.

PO Box 3394 Onekawa, Napier

P 06-843 8834

APPROVED

BC180675

17/08/2018 Page 21 of 21