LOAD SCHEDULE AND COMPUTATION

= 118.17 AMPERES

PANEL "PP" MAIN: 150AT 2P 230V 1Ø 3-WIRE 230V									
FEEDER	LOAD DESCRIPTION	AMP. PER CIRCUIT	VOLTS	CIRCUIT BREAKER			HOMERUN		
NO.				TRIP	FRAME	POLE	WIRE	CONDUIT	
1	PANEL LP	59.29	230	70	100	2	2#14mm2 THHN	25mmØ PVC	
2	BLOWER	6.52	230	20	50	2	3#3.5mm2 THHN	20mmØ PVC	
3	ACCU MAIN DINING	13.00	230	30	50	2	3#3.5mm2 THHN	20mmØ PVC	
4	ACCU MAIN DINING	13.00	230	30	50	2	3#3.5mm2 THHN	20mmØ PVC	
5	BLOWER	6.52	230	20	50	2	3#3.5mm2 THHN	20mmØ PVC	
6	CONVENIENCE OUTLET	3.13	230	20	50	2	3#3.5mm2 THHN	20mmØ PVC	
7	ACU OFFICE	10.00	230	30	50	2	3#3.5mm2 THHN	20mmØ PVC	
8	ACU VIP 3	10.00	230	30	50	2	3#3.5mm2 THHN	20mmØ PVC	
9	ACU VIP 2	10.00	230	30	50	2	3#3.5mm2 THHN	20mmØ PVC	
10	ACU VIP 1	13.00	230	30	50	2	3#3.5mm2 THHN	20mmØ PVC	
	TOTAL	144.46							
	IPP = [144.46 +	0.25 (13)	0.80 D	.F		USE	: 2# 50mm2 TH 1# 50mm2 Ø F		

(EXISTING)

LOAD SCHEDULE AND COMPUTATION

FEEDER NO.	LOAD DESCRIPTION	AMP. PER CIRCUIT	VOLTS	CIRCUIT BREAKER			HOMERUN		
				TRIP	FRAME	POLE	WIRE	CONDUIT	
1	LIGHTINGS	5.44	230	20	50	2	2#3.5mm2 THHN	20mmØ PV	
2	LIGHTINGS	3.26	230	20	50	2	2#3.5mm2 THHN	20mmØ PV	
3	LIGHTINGS	4.56	230	20	50	2	2#3.5mm2 THHN	20mmØ PV	
4	LIGHTINGS	2.17	230	20	50	2	2#3.5mm2 THHN	20mmØ PV	
5	EMERGENCY LIGHTS	6.26	230	20	50	2	3#3.5mm2 THHN	20mmØ PV	
6	CONVENIENCE OUTLET	6.26	230	20	50	2	3#3.5mm2 THHN	20mmØ P\	
7	CONVENIENCE OUTLET	7.82	230	20	50	2	3#3.5mm2 THHN	20mmØ PV	
8	CONVENIENCE OUTLET	7.82	230	20	50	2	3#3.5mm2 THHN	20mmØ PV	
9	UPRIGHT FREEZER	3.50	230	20	50	2	3#3.5mm2 THHN	20mmØ PV	
10	UPRIGHT FREEZER	3.50	230	20	50	2	3#3.5mm2 THHN	20mmØ PV	
11	REFRIGERATOR	4.35	230	20	50	2	3#3.5mm2 THHN	20mmØ PV	
12	ICE MAKER	4.35	230	20	50	2	3#3.5mm2 THHN	20mmØ P\	
	TOTAL	59.29							

GENERAL NOTES

- 1. THE ELECTRICAL INSTALLATION WORKS HEREIN SHALL BE DONE IN ACCORDANCE WITH THESE PLANS AND SPECIFICATIONS, THE APPLICABLE PROVISION OF THE LATEST EDITION OF THE PHILIPPINE ELECTRICAL CODE, THE RULES AND REGULATIONS OF THE LOCAL ENFORCING AUTHORITIY AND THE REQUIREMENTS OF THE LOCAL AND POWER TELEPHONE COMPANIES. THE ELECTRICAL WORKS SHALL BE UNDER THE IMMEDIATE SUPERVISION OF A DULY LICENSED ELECTRICAL ENGINEER OR MASTER ELECTRICIAN.
- 2. THE ELECTRIC SERVICE VOLTAGE SHALL BE SINGLE PHASE- 2 WIRE + GROUND 230 VOLTS.
- 3. THE ELECTRICAL INSTALLATION SHALL BE DONE IN IMC CONDUITS AND PVC CONDUITS, FLEXIBLE CONDUITS SHALL BE USED WHERE REQUIRED THE USED OF PVC CONDUITS SHALL BE LIMITED TO 15mm DIA. AND 20mm DIA. SIZE. THE MINIMUM SIZE FOR ALL CONDUITS SHALL BE IN 15mm DIA. ELECTRICAL TRADE SIZE, FOR STEEL CONDUITS PANASONIC AND ALLIED BRANDS OR APPROVED LOCAL EQUIVALENT SHALL BE USED. WHERE NON-METALLIC CONDUITS ARE ALLOWED TO BE USED, PVC CONDUITS SCHEDULE 48, ATLANTA AND EMERALD BRANDS OR APPROVED EQUIVALENT SHALL BE USED.
- 4. ALL WIRES SHALL BE COPPER AND THERMOPLASTIC INSULATED TYPE 'THHN" UNLESS OTHERWISE INDICATED, THE MINIMUM SIZE FOR POWER SHALL BE 3.5mm2 AND FOR LIGHTING SHALL BE 2.0mm2. THE CONTROL WIRES SHALL BE 2.0mm2, ALL OTHER WIRES SHALL BE AS INDICATED OR AS SPECIFIED ELSEWHERE ON THE PLANS. PHELPS DODGE AND COLUMBIA BRANDS OR EQUIVALENT SHALL BE USED.
- 5. THE CONTRACTOR SHALL VERIFY AND ORIENT THE ACTUAL LOCATION OF SERVICE ENTRANCE FOR CONNECTION TO THE POWER SUPPLY AND ALSO THE ACTUAL LOCATION OF THE TELEPHONE AND CABLE TV SYSTEM SERVICE ENTRANCE FOR CONNECTION TO THE TELEPHONE AND CABLE FACILITIES.
- 6. ALL SERVICE ENTRANCE EQUIPMENT, SWITCHES, PANEL BOARDS, LIGHTING FIXTURES AND ALL NON CURRENT CARRYING METAL PARTS SHALL BE PROPERLY GROUNDED IN ACCORDANCE WITH THE PHILIPPINE ELECTRICAL CODE.
- 7. ALL 20 AMPERE CIRCUIT HOMERUNS TO THE PANEL BOARDS MORE THAN 30 METERS IN LENGTH SHALL BE NO. 3.5mm2 UNLESS OTHERWISE SPECIFIED.
- 8. ALL FEEDERS AND BRANCH CIRCUITS SHALL BE INSTALLED AS INDICATED ON THE PLANS, BRANCH CIRCUIT HOMERUN WIRES SHALL BE INSTALLED IN INDIVIDUAL HOMERUN CONDUITS.
- 9. PULLBOX OR PULLBOXES OR MANHOLES OR HANDHOLES SHALL BE PROVIDED EVEN IF NOT INDICATED ON THE PLANS, IF THE FIELD CONDITION IS REQUIRED.
- 10. THE MOUNTING HEIGHTS OF WIRING DEVICES SHALL BE AS FOLOWS

LIGHT SWITCHES

CONVENIENCE OUTLET

VOICE AND DATA TELEPHONE OUTLET

1.40 METER ABOVE FLOOR FINISH

0.30 METER ABOVE FLOOR FINISH

0.30 METER ABOVE FLOOR FINISH


VOICE AND DATA TELEPHONE OUTLET


PANEL BOARD AND CABINETS

0.30 METER ABOVE FLOOR FINISH

1.40 METER ABOVE FLOOR FINISH @ CENTER OR AS REQUIRED

ALL MOUNTING HEIGHTS SHALL BE SUBJECT FOR ARCHITECTS APPROVAL PRIOR TO INSTALLATION

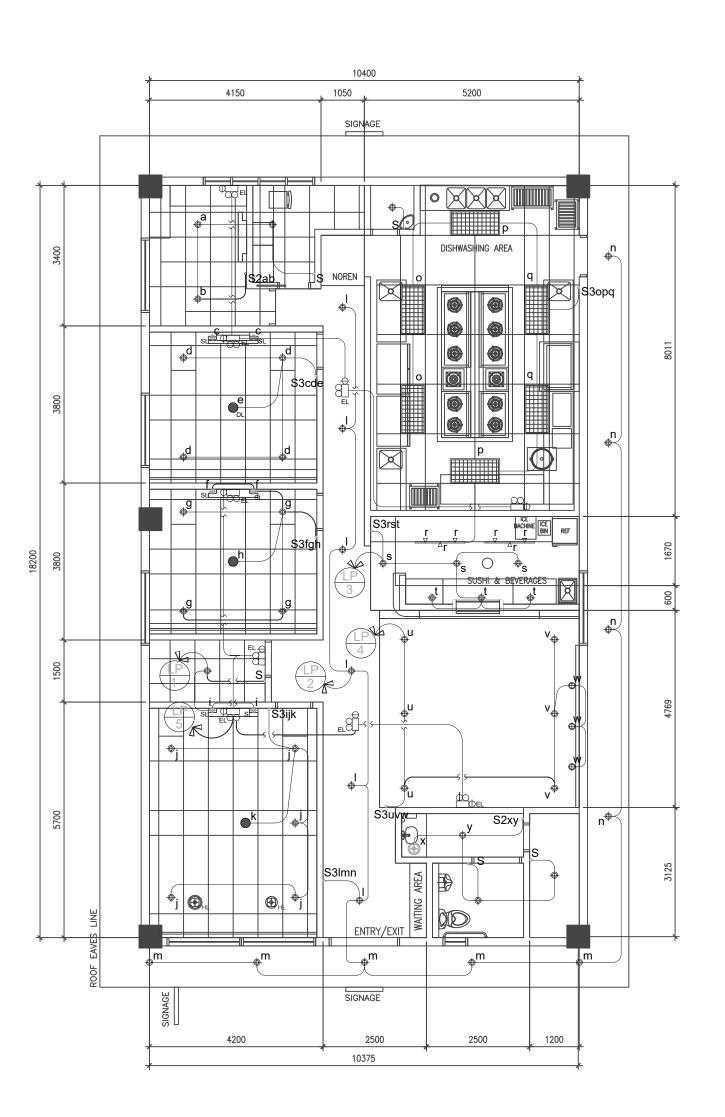

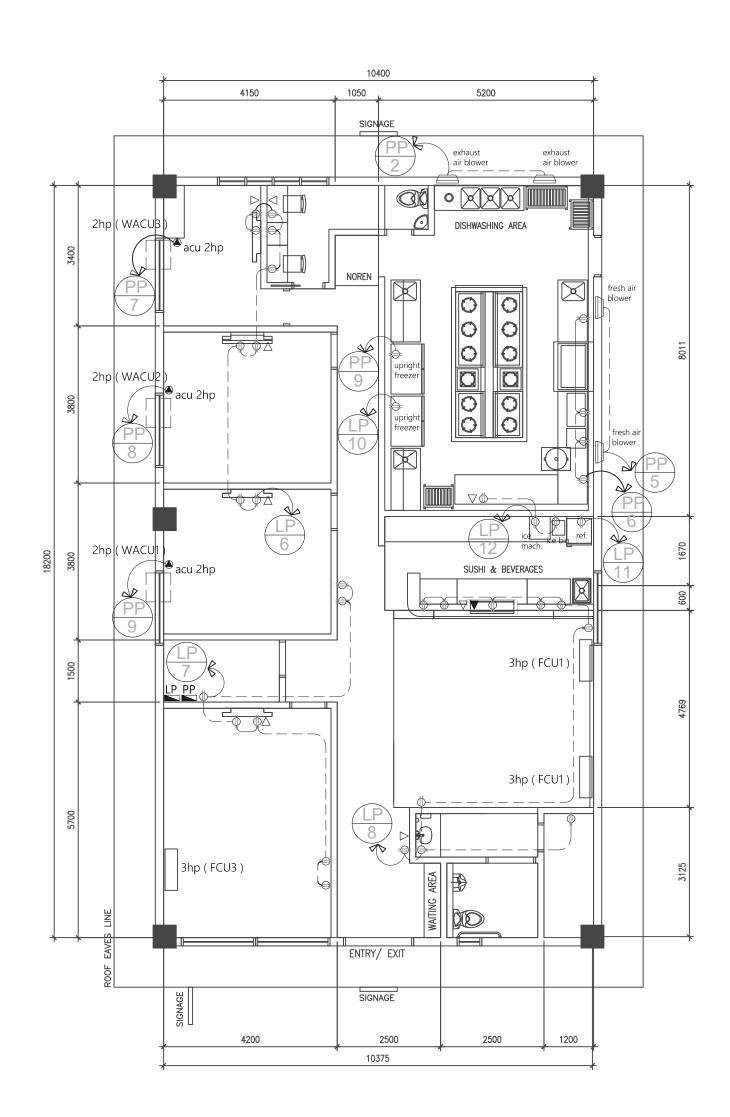

LEGEND

1 X 24 WATTS DAYLIGHT TROFER LIGHT
9 WATTS LED WARM WHITE PINLIGHT
6 WATTS LED WARM WHITE PINLIGHT
HANGING LAMP
ACCENT WALL LIGHT
TRACK LIGHT
CEILING FAN WITH LIGHT
300 X 300mm CEILING EXHAUST FAN
EMERGENCY LIGHT
CONVENIENCE OUTLET
CCTV
PHONE OUTLET
DATA OUTLET

SPLIT TYPE AIR CONDITIONING UNIT

WINDOW TYPE AIR CONDITIONING OUTLET

| 2 # 50mm2 THHN | IN 50mm0 PVC | EXISTING | | 150AT 2P 230V IN NEMA ENCLOSURE | 150 AT 2P 20AT 2P 20A

LIGHTING SYSTEM LAYOUT SCALE 1:100 MTS. P

POWER SYSTEM LAYOUT SCALE 1:100 MTS.

POWER SINGLE LINE DIAGRAM

CONTRACTOR	CHECKED BY.	SUBMITTED BY.		PROJECT	OWNER SHEET CONTENT	DESIGN BY.	SHEET NO.	
				VATALDAMDA			CADD BY. jst	E-1
			ONAL ELECTRICAL ENGINEER	YATALDAMPA		AS SHOWN	DATE NOV. 2024	
		PRC. NO.	PTR. NO.	LOCATION DIOSDADO MACAPAGAL BOULEVARD, PASAY CITY	ADDRESS		ADDROVED BY	
		TIN. NO.	NO. ISSUED ON				APPROVED BY.	