## **GENERAL NOTES:**

1) ALL WIRE AND CONDUIT MUST BE INSTALLED IN ACCORDANCE WITH PLANS AND SPECIFICATIONS, AND MUST MEET ALL APPLICABLE CODES.

2) ALL WIRE AND CABLE MUST BE RATED FOR FIRE ALARM USE PER THE LATEST REVISIONS OF THE NATIONAL ELECTRICAL CODE SECTION 760. THIS IS A POWER LIMITED FIRE ALARM SYSTEM, ALL CABLE MUST BE MARKED **FPL**, **FPLR**, **CI OR FPLP**.

3) ALL CONDUCTORS MUST TEST FREE OF GROUND BEFORE MAKING CONNECTION TO THE FIRE ALARM CONTROL PANEL.

4) TO RETAIN WARRANTY, THE FIRE ALARM EQUIPMENT MUST BE POWERED UP UNDER THE DIRECTION OF A QUALIFIED MANUFACTURERS TECHNICIAN.

5) THE LIFE SAFETY SYSTEM IS A COMPLETELY SUPERVISED SYSTEM.

FEET BETWEEN FEED AND RETURN CIRCUITS.

6) INSTALLING ELECTRICAL CONTRACTOR SHALL COORDINATE ALL FIELD CHANGES WITH THE FIRE ALARM CONTRACTOR INCLUDING CHANGES IN DEVICES, WIRE, CONDUIT RUNS AND OPERATION IN THE SYSTEM. FIRE ALARM CONTRACTOR SHALL NOT BE HELD RESPONSIBLE FOR UNDOCUMENTED CHANGES, OR THE RESULTS CAUSED BY THOSE CHANGES.

7) LIFE SAFETY AUDIBLE SHALL BE AUDIBLE THROUGHOUT THE SPACE AND SHALL HAVE A SOUND PRESSURE LEVEL NOT LESS THAN 15db ABOVE AMBIENT NOISE LEVEL MEASURED AT 4'0" ABOVE FINISHED FLOOR.

8) MAIN BUILDING FIRE ALARM & SUPPRESSION SYSTEMS SHALL BE CLASS "B" IN CONFIGURATION. PRE-ACTION & DELUGE ALARM SYSTEMS SHALL BE CLASS "A" IN CONFIGURATION. CLASS "A" APPLICATIONS SHALL MAINTAIN A MINIMUM SEPARATION OF 4

9) LOCATE ALL PULL STATIONS AND HORN/STROBE UNITS AT SPECIFIED HEIGHTS PER NFPA 72 AND ADA SEE DETAIL SHEET.

10) SMOKE DETECTOR LOCATIONS ARE FOR REFERENCE ONLY AND SHALL BE INSTALLED PER NFPA 72. 11) ELECTRICAL CONTRACTOR SHALL COORDINATE ALL ROUGH-IN INSTALLATION WITH THE FIRE ALARM CONTRACTOR.

12) SMOKE DETECTORS ON CEILINGS MUST BE NO MORE THAN 15' FROM A WALL AND/OR NO MORE THAN 30' FROM EACH OTHER. REDUCED SPACING MAY ALSO BE REQUIRED. SEE PLAN DRAWINGS FOR PROJECT-SPECIFIC LOCATIONS.

13) ALL FIRE ALARM DEVICES SHALL BE RIGIDLY AND SECURELY FASTENED TO WALLS OR CEILINGS.

14) NO SMOKE DETECTOR SHALL BE LOCATED CLOSER THAN 36" TO ANY AIR REGISTER OR DIFFUSER.

15) NO HEAT DETECTOR SHALL BE LOCATED CLOSER THAN 24" TO ANY AIR REGISTER OR DIFFUSER.

16) NO HEAT DETECTOR SHALL BE LOCATED CLOSER THAN 36" TO ANY PART OF ANY HEAT GENERATING DEVICE (FUSES, BOILERS, WATER HEATERS, ECT.) IN MECHANICAL ROOMS.

17) NO HEAT DETECTOR SHALL BE LOCATED CLOSER THAN 18" TO ANY PART OF ANY LIGHT

18) INITIATING AND SIGNALING CIRCUITS ARE SEPARATE YET MAY BE RUN IN SAME CONDUIT.

19) ALL CONDUCTORS SHALL BE LABELED BY ZONE AND ALL COLOR CODES SHALL MATCH.

20) DEVICES THAT ARE UNABLE TO BE INSTALLED PERMANENTLY DURING DEVICE TRIM SHALL BE SPLICED THROUGH TO ALLOW DEVICES AND CIRCUIT DOWNSTREAM TO BE PRE-TESTED. THIS INCLUDES ALL CIRCUITS (SPEAKER CIRCUITS, STROBE CIRCUITS, ADDRESSABLE LOOP CIRCUITS, 24VDC CIRCUITS, FIREFIGHTERS TELEPHONE CIRCUITS, ETC.)

21) THESE DRAWINGS DO NOT SUPERSEDE THE CONTRACT DRAWINGS AND SPECIFICATIONS, THEY ARE INTENDED AS A SUPPLEMENT ONLY AND MUST BE USED IN CONJUNCTION WITH THE CONTRACT DOCUMENTS. THEY DO NOT MODIFY THE CONTRACTORS OBLIGATIONS TO CONFORM TO THE PROJECTS ORIGINAL DESIGN CRITERIA.

## INITIATING DEVICES SYMBOL QTY DESCRIPTION MODEL # BACK BOX / DIMENSIONS E MANUAL PULL STATION - ADDRESSABLE SIGA-278 SINGLE-GANG, BY E.C.

INPUT - OUTPUT MODULES


SYMBOL QTY DESCRIPTION MODEL # BAC


1 DUAL-INPUT MODULE

## NOTIFICATION DEVICES


	NOTH ICATION DEVICES							
	SYMBOL	QTY	DESCRIPTION	MODEL #	BACK BOX / DIMENSIONS			
	Œ	. 3	SYNC. MULTI-CANDELA CEILING SPENCER/STROBE	GC-S7VM (WHITE) GCF-S7VM ("FIRE")	4" SQ, 2.125" DEEP BY EC			
٠	r	,	SYNC MULTI-CANDELA CEUNG STRORE	GC-VM (W/O "FIRE")	4" SQ, 2.125" DEEP BY EC			


_										
ſ	WIRE CODE									
II.	ALL WIRING AND INSTALLATION METHODS SHALL BE IN COMPLIANCE WITH CURRENT RELEVENT NATIONAL ELECTRICAL CODE ARTICLES AND RELATED SECTION CODE REQUIREMENTS.									
	WIRING INSTALLATION NOTES:  * LABEL ALL ZONE WIRES WITH ZONE NUMBER TAG AND DESCRIPTION.  * LABEL ALL SIGNAL CIRCUIT WIRES WITH SIGNAL CIRCUIT NUMBER TAG AND DESCRIPTION.  * LABEL ALL NETWORK, ANNUNCIATOR AND I/O CONTROL CIRCUIT WIRING WITH CIRCUIT NUMBER TAG AND DESCRIPTION.  * VERIFY WITH OWNER AND GENERAL CONTRACTOR THAT OPEN CABLE IS ALLOWED ON SPECIFIC SITE.  * VERIFY WITH OWNER AND GENERAL CONTRACTOR FOR ANY SPECIFIC SITE REQUIREMENTS FOR ELECTRICAL INSTALLATION OF WIRING.									
	Letter	Qly	Open Wiring Cable Type	Conduit Wiring Cobin Type	Stars	Function				
ı	С	1 Pair	FPL(P) Red/Blk	Red/Blue THHN	14	Horn / Strobe				
ı	D	2 Pair	FPL(P) Red/Blk	Red/Blue THHN	14	Horn / Strobe Loop				
ı	J	1 Pair	Twisted FPL(P) Red/Blk	Twisted	16	Speaker				
	K	2 Pair			16	Speaker Loop				
	Р	1 Pair		Red/Black THHN	14	24VDC Power				
	S	1 Pair	Twisted FPL(P) Red/Blk	Red Mellow	16	Signature Data Line				

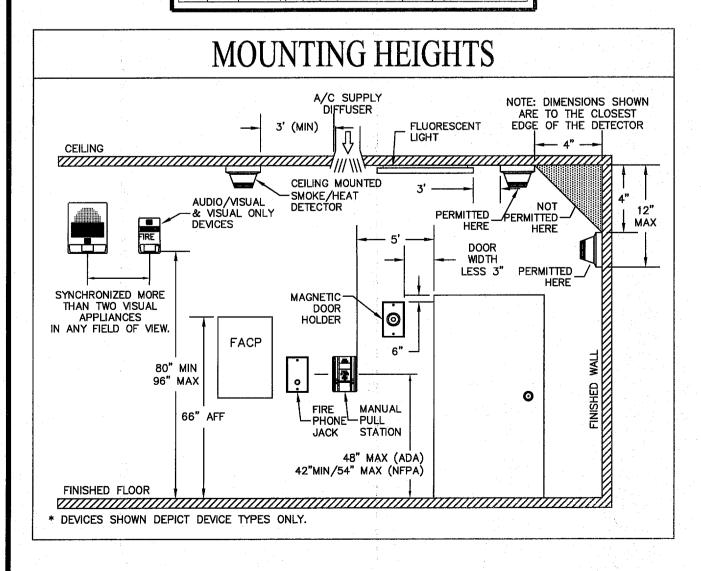

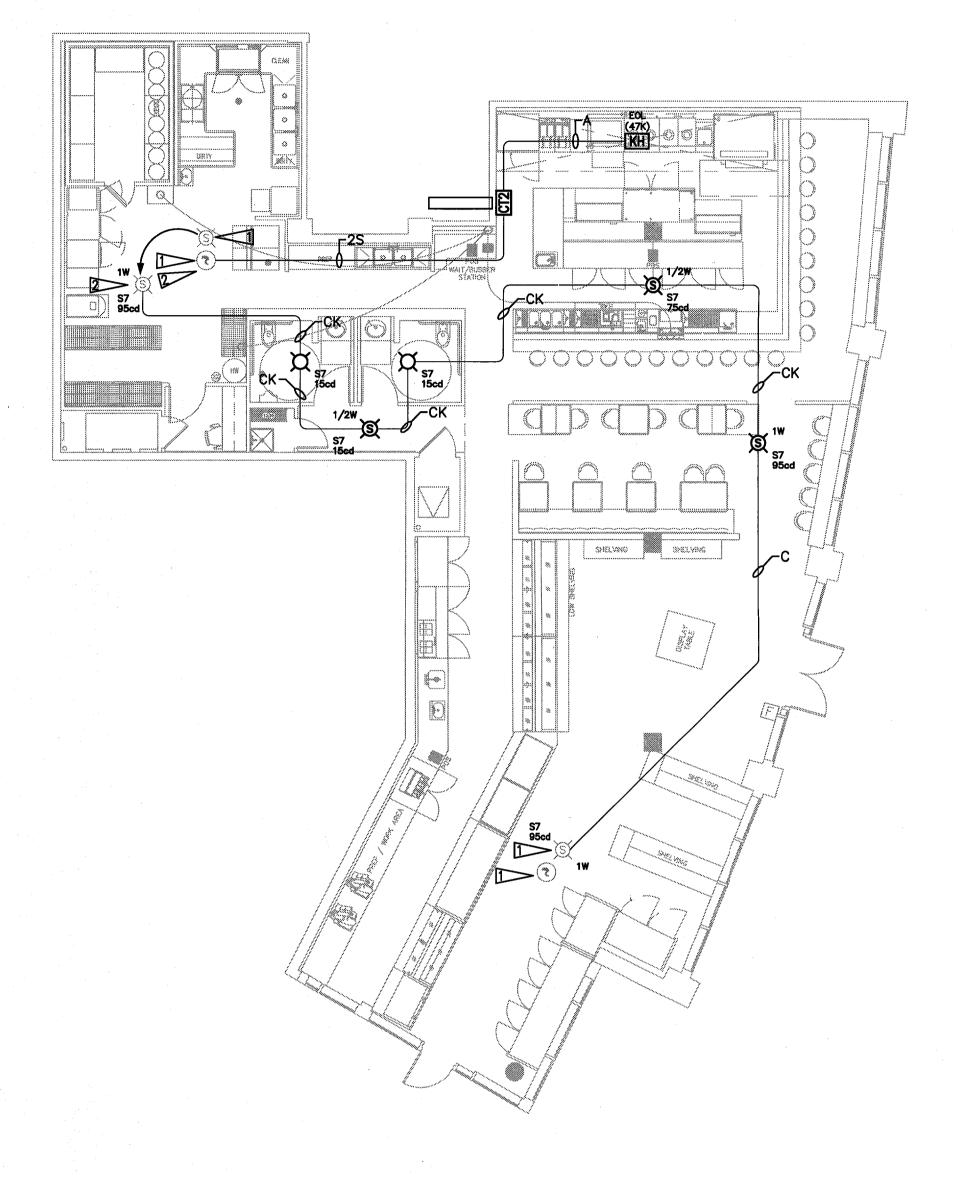


 $\frac{\text{MARKET HALL T.I.}}{1/8" = 1'-0"}$ 

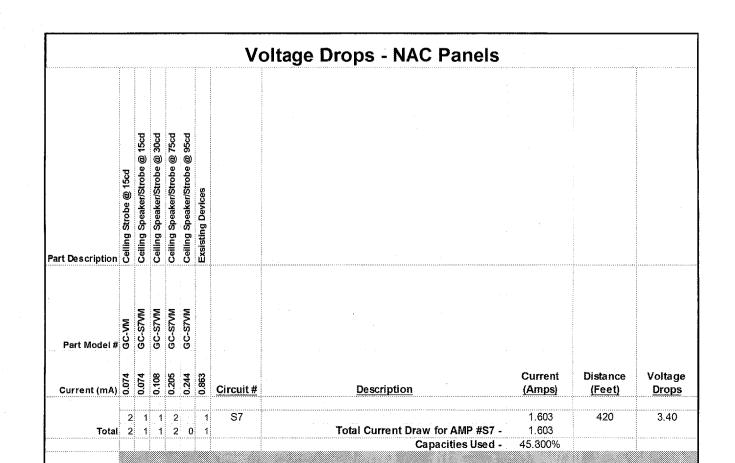


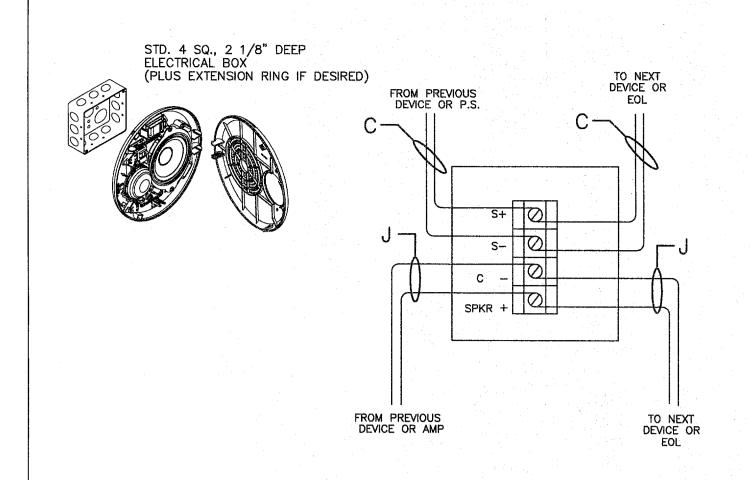

1 GC-S7VM - (CEILING SPEAKER STROBE)
scale: NONE

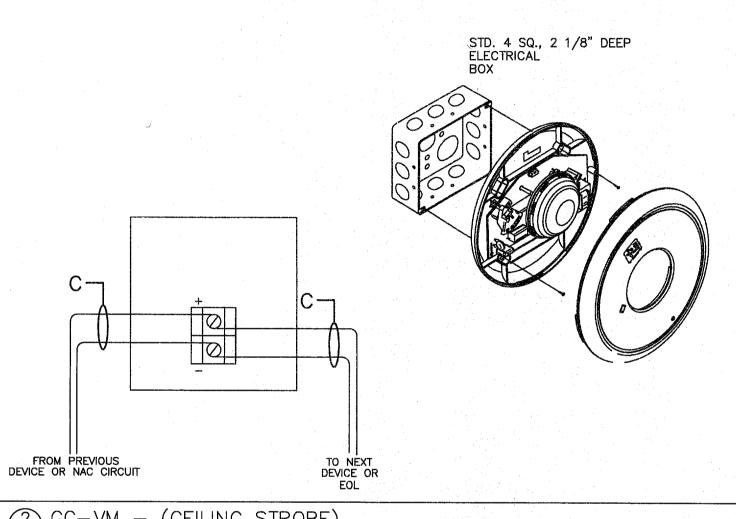

2 GC-VM - (CEILING STROBE)
SCALE: NONE

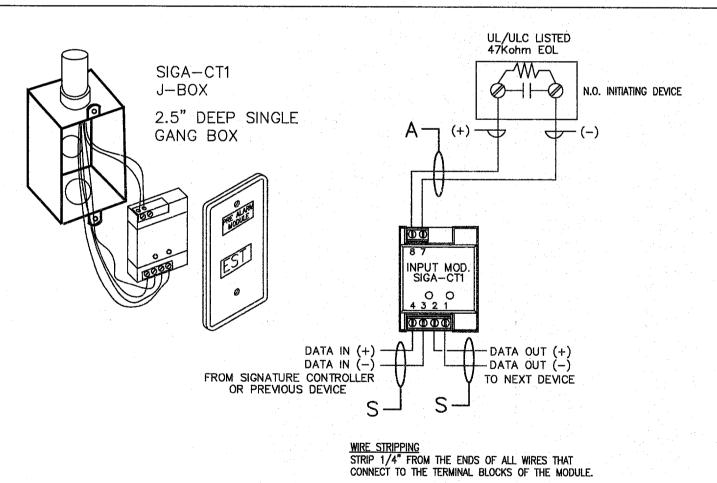

3 SIGA-CT1 - (SINGLE INPUT MODULE)
scale: NONE

FLAG NOTES:

RELOCATE EXISTING DEVICE TO NEW CEILING. MOVE IF SHOWN.

SPLICE EXISTING WIRING AT DEVICE FOR CONNECTION OF NEW WIRING FOR ADDITIONAL DEVICES & TO MAINTAIN CIRCUIT INTEGRITY. ("T-TAPPING IS NOT ALLOWED)



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DOCUMENTATION AVAILABLE TO CONVERGINT TECHNOLOGIES

DOCUMENTATION: CHESMORE BUCK

DRAWING SHEETS: E-1.0

DRAWING DATE: 5-7-2014

FINAL REVIEW DONE BY:

REV DESCRIPTION DATE APPROVED

0 ISSUED FOR PERMIT 9-II-I4

DRAWN BY: CHRIS C.
PROJECT ENGINEER: JAY B.
PROJECT MANAGER: DAVID J.
JOB NUMBER: 301-FN-D545
SCALE: I/8"=I'-0" DATE:

MARKET HALL T.I.@
THE OLIVIAN
809 OLIVE WAY

SEATTLE, WA 98101

1ST FLOOR

FIRE ALARM SYSTEM

DRAWING: FA-1-1

ST FLOOR. JOINT VENTURE BETWEEN

JOINT VENTURE BETWEEN

6436168