BUILDER/CONTRACTOR:



50 E 2500 N NORTH LOGAN, UT 84341 (435) 752-1480

It is the contractor's responsibility to verify all details and dimensions

All work shall be performed in accordance with all applicable national, state, and local codes and regulations.

All dimensions are to rough frame of studs or to the outside of masonry.


Final cabinet layout will be designed by cabinet supplier.

All footings to be below frost line and must rest on undisturbed soil capable of handling the building.


All penetrations are to be sealed in accordance with state and local codes.



FIRST FLOOR PLAN LAYOUT

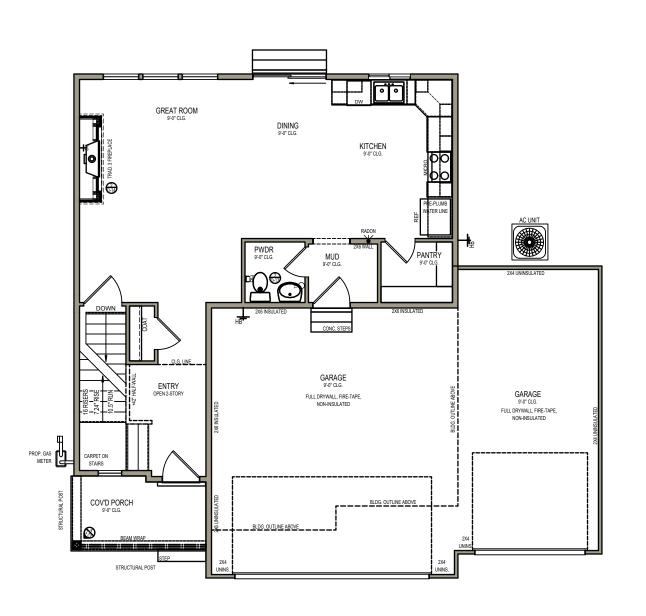

SECOND FLOOR PLAN LAYOUT

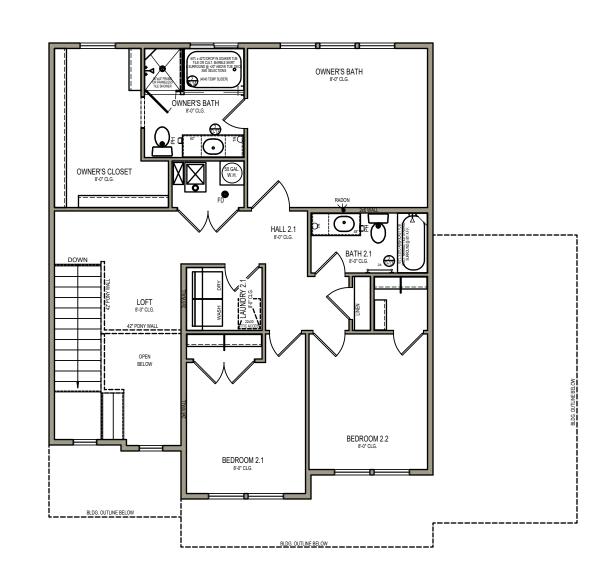

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Plan current up to: Addendum

Proj: Vineyard 59 Client: Tanner Hunt & Ashleigh Loos

Tanner Hunt & Ashleigh Loos Residence

Vineyard Subdivision Phase 2, Lot 59, SF, Acres Parcel:

> 555 North 275 East Providence, UT, 84332

PERSCRIPTIVE METHOD ON INSULATION

R-19 BATT INSULATION IN WALLS R-49 INSULATION IN ATTIC R-10 INSULATION ON INSIDE OF FND WALL - 4'-0" MIN U-.32 WINDOWS R-40 BETWEEN GARAGE & FLOOR ABOVE R-30 WITH CANTILEVER NO INSULATION IN GARAGE

BUILDING AREA

MAIN LEVEL: UPPER: UNFIN. BASEMENT: GARAGE: PORCH: COLD STORAGE: PATIO:	787.15 1096.76 698.26 753.85 67.81 50.03 100.00
FINISHED AREA:	1883.91

"FINISHED SQUARE FOOTAGE CALCULATIONS FOR THIS HOUSE WERE MADE BASED ON PLAN DIMENSIONS AND MAY VARY FROM THE FINISHED SQUARE FOOTAGE OF THE HOUSE AS BUILT."

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	PLANS PRINTED ON 11 x 17 PAPER ARE 1/2 THE SCALE NOTED.	

Date: 11/09/2020

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SCALE: 1/4" = 1'-0"

SHEET:

GENERAL CONSTRUCTION NOTES

GENERAL INFO:

-WHEN CALLING FOR AN INSPECTION, CONTRACTOR MUST PROVIDE PERMIT NUMBER, ADDRESS, TYPE OF INSPECTION, AND DATE INSPECTION IS NEEDED. INSPECTIONS NEED TO BE CALLED IN MIN. OF 24-48 HRS BEFORE INSPECTION IS NEEDED.

-WORK IS NOT TO BEGIN BEFORE PERMIT IS ISSUED, AND PLANS MUST BE FOLLOWED AS APPROVED EVEN IF THEY EXCEED CODE. THE APPROVED SET OF PLANS AND INSPECTION CARD NEED TO BE ON BUILDING SITE FOR ALL INSPECTIONS.

-THE FOLLOWING INSPECTIONS ARE REQUIRED. PLEASE MAKE SURE THAT ALL ITEMS LISTED BELOW ARE COMPLETE AND READY FOR INSPECTION. NOTE: THIS MAY VARY FROM CITY TO CITY.

FOOTINGS:

-BE SURE THAT ALL SETBACKS ARE CORRECT.

-SETBACKS ARE MEASURED FROM THE PROPERTY LINE, NOT THE SIDEWALK. -LOT CORNERS ARE TO BE STAKED OR OTHERWISE EASY TO LOCATE. -FOOTINGS ARE TO BE CONTINUOUS EXCEPT THROUGH GARAGE DOORWAY THAT IS 8' OR WIDER. -HORIZONTAL STEEL IS TO BE TIED IN PLACE. -INTERIOR WALL FOOTINGS ARE NOT INSPECTED AT THE TIME OF OUTSIDE FOOTINGS, BUT

MUST BE INSPECTED BEFORE FLOOR IS POURED. -THE STEEL IS TO BE CLEAN & FREE OF GREASE & MUD.

FOUNDATION:

-ALL STEEL MUST BE TIED IN PLACE. -ALL OPENINGS ARE TO BE DOUBLE WARPED WITH STEEL.

-VERTICAL STEEL MUST BE BENT AND ON THE SITE FOR INSPECTION.

UNDERGROUND PLUMBING:

-ALL PIPES INCLUDING WATER & WASTE AS APPLICABLE ARE TO BE INSTALLED & STUBBED AT LEAST 2" PAST THE FOUNDATION. -PRESSURE TESTS ARE TO BE PROVIDED AS REQUIRED. -PIPING IS NOT TO BE COVERED EXCEPT THE MINIMUM NEEDED TO HOLD THE PIPES IN PLACE WITH NO JOINTS COVERED.

UNDERGROUND MECHANICAL:

-IN PLACE AND NOT COVERED AND ALL JOINTS TO BE IN PLACE.

TEMPORARY POWER:

-THE TEMPORAY POWER IS TO BE IN PLACE WITH THE UNDERGROUND OR OVERHEAD PIPING

-THE SERVICE BASE IS TO BE SECURELY INSTALLED AND PROTECTED FROM DAMAGE AND A GROUND ROD MUST BE INSTALLED.

AT THE CITY OFFICES.

BUILDING WATER:

-ALL PIPES ARE TO BE INSTALLED AT REQUIRED DEPTHS.

-BEFORE WATER METER IS INSTALLED OWNER/CONTRACTOR MUST SIGN UP FOR UTILITIES AT THE CITY OFFICES.

BUILDING SEWER:

-ALL PIPES ARE TO BE INSTALLED AT PROPER SLOPES

ROUGH FOUR WAY:

-FRAMING CANNOT BE APPROVED UNTIL THE ELECTRICAL, PLUMBING, AND MECHANICAL ROUGHS ARE FINISHED.

ELECTRICAL:

-ALL WIRING INSTALLED.

-RECESS CANS INSTALLED.

-ALL WIRES IN BOX NEED TO BE MADE UP AND GROUNDS MECHANICALLY CONNECTED.

-ALL BONDING INSTALLED AND CONNECTED. -ALL VENT FANS AND DUCTS INSTALLED.

-NO WIRES TOUCHING GUSSETTS

PLUMBING:

-ALL WASTE, WATER, AND GAS PIPING INSTALLED WITH APPROPRIATE PRESSURE TEST

-ALL SHOWER PANS INSTALLED AND FILLED WITH WATER.

MECHANICAL:

-THE FURNACE AND ALL DUCTS NEED TO BE INSTALLED, COMBUSTION AIR DUCTS NEED TO BE INSTALLED AND PROPERLY SIZED.

-ANY COOLING DUCTS, OR PIPING SIZED. -IF HOT WATER HEATER IS USED, THE PIPES NEED TO BE INSTALLED AND UNDER

APPROPRIATE PRESSURE.

-PRE-FAB FIREPLACES INSTALLED INCLUDING THE FLUES, COMBUSTION AIR, AND FIRE BLOCKING.

-FRAMING IS TO BE APPROVED PRIOR TO THE SIDING, OR BRICK BEING INSTALLED. -ALL FRAMING MEMBERS ARE TO BE INSTALLED. -INTERIOR STAIRS INSTALLED.

-ALL BLOCKING AND BRACING INSTALLED. -ALL WINDOWS ARE TO BE INSTALLED.

DRYWALL:

-ALL DRYWALL TO BE NAILED OR SCREWED IN PLACE. -USE FIRE RATED DRYWALL IN GARAGE.

-A FIRE WALL FROM SLAB TO TRUSS, REQ. BETWEEN GARAGE, & STRUCTURE, USING TYPE X -A DOUBLE LAYER OF TYPE X REQ. FOR CEILINGS IN GARAGES.

-FOR BOND BEAMS AND GROUTING POURS, ALL STEEL MUST BE IN PLACE AND CLEAN OUTS OPEN. -FIREPLACES, STEEL REINFORCING, CLEARANCES, AND SEISMIC BRACING ARE REQUIRED PRIOR TO COVERING.

GAS METER:

-THE GAS LINE MUST BE INSTALLED AND THE REQUIRED PRESSURE TEST PROVIDED. -AT LEAST ONE GAS APPLIANCE MUST BE INSTALLED AND READY TO BE TURNED ON. -COMBUSTION AIR INSTALLED.

PERMANENT POWER:

-PERMANENT POWER WILL NOT BE APPROVED UNTIL AFTER THE BUILDING PERMIT IS FINALIZED. -ALL WIRING, COVERS, LIGHTS, RECEPTACLES, SWITCHES, AND BONDING SHALL BE IN PLACE. -BREAKER BOX AND MAIN DISCONNECT LABELED.

FINAL INSPECTION:

-THE BUILDING NEEDS TO FINISHED INCLUDING FLOOR COVERINGS, READY FOR PERMANENT POWER, PLUMBING, AND MECHANICAL SYSTEMS FINISHED.

-ALL STEPS, GUARDRAILS, AND HANDRAILS INSTALLED.

-EXTERIOR GRADING AND CONCRETE WORK FINISHED. -CITY SIDE WALK AND CURB (IF REQ'D) INSTALLED TO CITY SPECS.

-A LADDER NEEDS TO BE PROVIDED SO THAT THE ATTIC AREA AND ROOF CAN BE INSPECTED. OCCUPANCY PERMITS SHALL NOT BE GRANTED UNTIL FINAL INSPECTION IS COMPLETED. INSPECTION REQUIREMENTS VARY FROM CITY TO CITY AND ARE SUBJECT TO THEIR

FOOTING:

REQUIREMENTS.

1. ALL FOOTINGS SHALL BEAR 12" INTO UNDISTURBED EARTH.

2. FOOTINGS SHALL STEP 1 TO 1.5 RATIO AS REQ'D.

3. EXTERIOR WALL FOOTINGS SHALL BEAR AT A MINIMUM DEPTH OF 30" FOR FROST OR WEATHER PROTECTION.

CONCRETE

4. ALL CONCRETE SHALL BE BATCHED WITH THE FOLLOWING BAG MIX PER CUBIC YARDS: STRUCTURAL 5 1/2 BAG - 3000 PSI

EXTERIOR FLAT WORK 6 BAG - 4000 PSI

5. ALL CONCRETE SHALL BE PLACED CURED AND PROTECTED AS SPECIFIED IN COMPLIANCE WITH UBC STANDARDS AND PRACTICES. 4" MAX SLUMP

REINFORCEMENT STEEL:

6. ALL REARS SHALL COMPLY TO ASTM A - 615 GRADE A.O. ALL WELDED WIRE FABRIC SHALL CONFORM TO ASTM A - 185 MINIMUM LAP 6".

7. ALL REBARS SHALL BE SECURELY TIED AND HELD IN PLACE 3" ABOVE EARTH.

CONCRETE WALLS OR COLUMNS:

8. ALL VERTICAL REINFORCEMENT IN COLUMNS OR WALLS SHALL BE DOWELED FROM THE FOOTING OR STRUCTURE BELOW WITH REBAR OF THE SAME SIZE & SPACING REQ'D ABOVE AND CAP SPLICES 12" MIN.

GENERAL CONCRETE:

9. NO ALUMINUM PRODUCTS SHALL BE EMBEDDED IN CONCRETE, ELECTRICAL CONDUITS SHALL BE PLACED IN MID-HEIGHT OF SLABS AND SHALL HAVE AN O.D. LESS THAN 1/3 SLAB

FOUNDATION WALL REINFORCEMENT:

10. FOLLOW ENGINEERING SPECIFICATIONS.

STRUCTURAL STEEL:

11. ALL STRUCTURAL STEEL SHALL CONFORM WITH ASTM 1 - 36 UNO. USE A-307 BOLTS FOR FIELD CONNECTIONS.

12. ALL FRAMING LUMBER SHALL MEET THE MINIMUM REQUIREMENTS FOR ITS USE.

13. ALL ENDS OF POINTS OF SUPPORTS SHALL BE PROPERLY SUPPORTED AND ALL LOADS MUST BE ABLE TO BE TRACED TO THE FOOTING FOR ALL WOOD JOISTS OF TRUSS RAFTERS.

<u>NAILING:</u>

14. NAILING AS SPECIFIED BY THE ENGINEERING.

BRICK MASONRY:

15. ALL MASONRY SHALL BE REINFORCED WITH BOTH HORIZONTAL AND VERTICAL REINFORCEMENT ALL BLOCK CELLS OR BRICK CAVITIES WITH REINFORCEMENT SHALL BE GROUTED FULL USING CONCRETE GROUT. CELLS SHALL BE ALIGNED TO PRESERVE UNOBSTRUCTED VERTICAL CAVITIES OF 2" OF 3" MIN. USE 2000PSI GROUT WITH 4'-0" LIFTS ONLY. USE PEA GRAVEL IN GROUT FOR CELLS 4'x4' MIN. SLUMP. 7" TO 10" SLUMP (AVOID SEPARATION) DO NOT USE CELL REINFORCING TO ROD GROUT.

16. ALL BRICK SHALL BE INSTALLED ACCORDING TO MANUFACTURED SPECIFICATIONS. USE 22 GA. TIES @ 16" O.C. EACH WAY FOR MASONRY TIE. USE #9 WIRE @ 16" O.C., USE 1" GROUT FOR BRICK SPACING. SHEETING:

17. 5/8" SHEETING SHALL RUN PERPENDICULAR TO ROOF TRUSSES, STAGGERING JOISTS, SPACINGS SHALL BE DETERMINED BY MANUFACTURER.

18. ICE BARRIER SHALL BE INSTALLED @ ALL ROOF EDGES, & EVES.

ICE BARRIER SHALL BE INSTALLED AT ROOF TO WALL CONNECTING AND IS TO EXTEND UP WALL 18". 19. ALL REQUIRED EGRESS WINDOWS , INCLUDING ONE IN EVERY BASEMENT AND BEDROOM SHALL HAVE A MINIMUM CLEAR OPEN ABLE AREA OF 5.7 SQ. FT. A MIN. HEIGHT OF 24" AND A MIN. WIDTH OF 20" AND A FINISHED SILL HEIGHT OF NOT MORE THAN 44".

20. WINDOW WELLS SHALL PROVIDE NET CLEAR OPENING OF 9 SQUARE FEET WITH A MINIMUM DIMENSION OF 36".

DAMPROOFING:

21. DAMP PROOFING IS REQUIRED FOR ALL FOUNDATIONS ENCLOSING BASEMENTS BELOW FINISH

22. ALL HONEY COMBING THAT CANNOT BE COMPLETED & FULLY DAMP PROOFED MUST BE GROUTED BEFORE DAMPROOF.

BLOCKING:

23. FIRE BLOCKING IS REQ'D IN WALLS AT ALL SOFFITS, DROPPED CEILINGS, COVE CEILINGS, AND AT THE FLOOR AND CEILING LEVELS OF ALL SHAFTS AND CHASES.

24. ALL CHASES MUST BE BLOCKED @ EACH FLOOR LEVEL AND OR EVERY 6'.

25. UNDER STAIR SPACE THAT IS ENCLOSED AND USABLE SHALL HAVE THE WALLS & CEILINGS 5/8" TYPE X SHEETROCK.

26. MINIMUM 2x6 WALL BLOCKING IS REQ'D FOR SHOWER PAN.

27. RIM JOISTS SHALL BE PROTECTED WHERE CONCRETE WILL BE POURED AGAINST THEM.

28. ATTIC VETILATION LOCATED IN GABLE ENDS ONLY SHALL BE A TOTAL OF 1/150th OF THE AREA OF THE SPACE VENTILATED.

29. ATTIC ACCESS OPENINGS ARE REQ'D FOR ALL ATTICS 30" OR GREATER IN HEIGHT.

30. CRICKETS ARE REQ'D WHERE CHIMNEYS OR OTHER VERTICAL SURFACES INTERSECT SLOPED ROOF AREAS, THEREBY CREATING WATER, SNOW, OR ICE DAMMING CONDITIONS.

31. ALL CRICKETS MUST EXTEND PAST EXTERIOR FINISHES BY 4".

32. STEP FLASHINGS OR FLASHINGS SHALL BE COUNTER FLASHED AT CHIMNEY OR WALL INTERSECTIONS WITH ROOFS.

33. GLASS IF INSTALLED IN OR WITHIN 12" OF DOORS, SHALL BE TEMPERED, UNLESS THE GLASS IN THE DOOR HAS ONE DIMENSION LESS THAN 3" OF THE BOTTOM EDGE OF THE GLASS ADJACENT TO THE DOOR IS 60" OR MORE FROM THE FLOOR.

34. FINISH GRADING SHALL SLOPE 2% AWAY FROM ALL BUILDINGS OR PROVIDE EQUIVALENT DRAINAGE PROTECTION.

35. ADDRESS NUMBERS ARE REQUIRED FOR ALL BUILDINGS, AND SHALL BE AT LEAST 3" HIGH SO AS TO BE PLAINLY VISIBLE FROM THE STREET FRONTING THE PROPERTY

ELECTRICAL:

36. METER PANELS SHALL BE AT LEAST 36" AWAY FROM ALL DOORS AND WINDOWS.

37. MAIN DISCONNECTS ARE REQ'D ON EXTERIOR OF ALL BUILDINGS.

38. BREAKER PANELS SHALL NOT BE LOCATED ON THE EXTERIOR OF THE BUILDING.

39. UFER GROUNDS ARE REQ'D IN ADDITION TO WATER PIPE GROUNDS. AND ELIMINATE THE NEED OF DRIVEN ROD ELECTRODES.

40. INSTALL A MIN. OF (2) GFCI RECEPTACLES (ONE REAR, ONE FRONT OF EXTERIOR OF HOME.)

41. ALL REQ'D REC. SHALL BE PLACED SO THAT AT NO POINT ALONG THE FLOOR LINE OF WALLS, COUNTERS, ETC. SHALL THE DISTANCE TO A REC. BE GREATER THAN 6'.

42. SMOKE DETECTORS SHALL BE INSTALLED IN EACH BEDROOM AND ADJACENT HALLWAYS AND ON EACH LEVEL. THEY SHALL BE WIRED IN SERIES AND HAVE BATTERY BACKUP.

43. GFCI OUTLETS TO BE MOUNTED IN GARAGE 48" ABOVE PAD LEVEL.

MECHANICAL:

44. GAS METERS SHALL BE LOCATED PER LOCAL FUEL COMPANY AND SHALL BE A MIN. OF 3' FROM ELECTRICAL METER PANELS AND PERMANENT AIR VENTS.

45. ADEQUATE COMBUSTION AIR IS REQ'D FOR ALL FUEL BURNING APPLIANCES.

46. VENTILATING FANS ARE REQUIRED FOR ALL BATHROOMS WITH TUBS OR SHOWERS

47. ALL BATHROOM FANS SHALL BE VENTED TO THE EXTERIOR OF THE BUILDING.

48. DRYER VENT SHALL BE A MIN. OF 14" WITH (2) ELBOWS.

THAT HAVE NO OPEN ABLE WINDOW TO THE EXTERIOR.

49. RANGE AND COOKTOP CLEARANCES TO UNPROTECTED COMBUSTIBLES SHALL BE 30"

50. ALL HEATING SUPPLY DUCTS SHALL BE INSULATED IN UNINSULATED AREAS AS PER CODE

PLUMBING:

CITY WATER CONNECTIONS.

51. VENTING IS REQ'D FOR ALL FIXTURE TRAPS AS PER CODE.

52. NO PIPING SHALL BE INSTALLED SO AS TO BE SUBJECT TO FREEZING.

53. NO LEAD OR ACID BEARING SOLDERS OR FLUES ARE ALLOWED FOR POTABLE H20 PIPING. 54. PRESSURE REDUCING VALVES ARE REQ'D WHEN WATER PRESSURE EXCEEDS 60 PSI.

55. BACK FLOW PROTECTION IS REQUIRED FOR ALL HOSE BIBS, LAWN SPRINKLER SYSTEMS, AND ALL OTHER OUTLETS HAVING HOSE THREADS OR POSING POTENTIAL CROSS CONNECTIONS WITH

56. FLOOR DRAINS SHALL BE PROVIDED NEAR ALL WATER HEATERS.

57. FLOOR DRAINS SHALL BE FULLY VISIBLE AND ACCESSIBLE

58. WATER CLOSET SPACES SHALL BE A MIN. OF 30" IN WIDTH AND ALLOW FOR A MIN. FRONT CLEARANCE OF 24".

60. UNFINISHED PLUMBING DWV ROUGH - INS SHALL BE PROPERLY VENTED & CAPPED OFF.

59. AIR GAP PROTECTION IS REQ'D ON ALL DISHWASHER DRAIN CONNECTIONS TO THE DMV SYSTEM.

61. ALL OUTSIDE OR GARAGE FAUCETS SHALL BE FROST PROTECTED & WILL DRAIN WHEN SHUT OFF.

GRADING & DRAINAGE:

62. FINISH GRADE SHALL BE FINISHED IN SUCH A WAY THAT ALL DRAINAGE FOR ANY GIVEN LOT SHALL FLOW TOWARD THE STREET, & SHALL NOT FLOW OVER INTO HOME.

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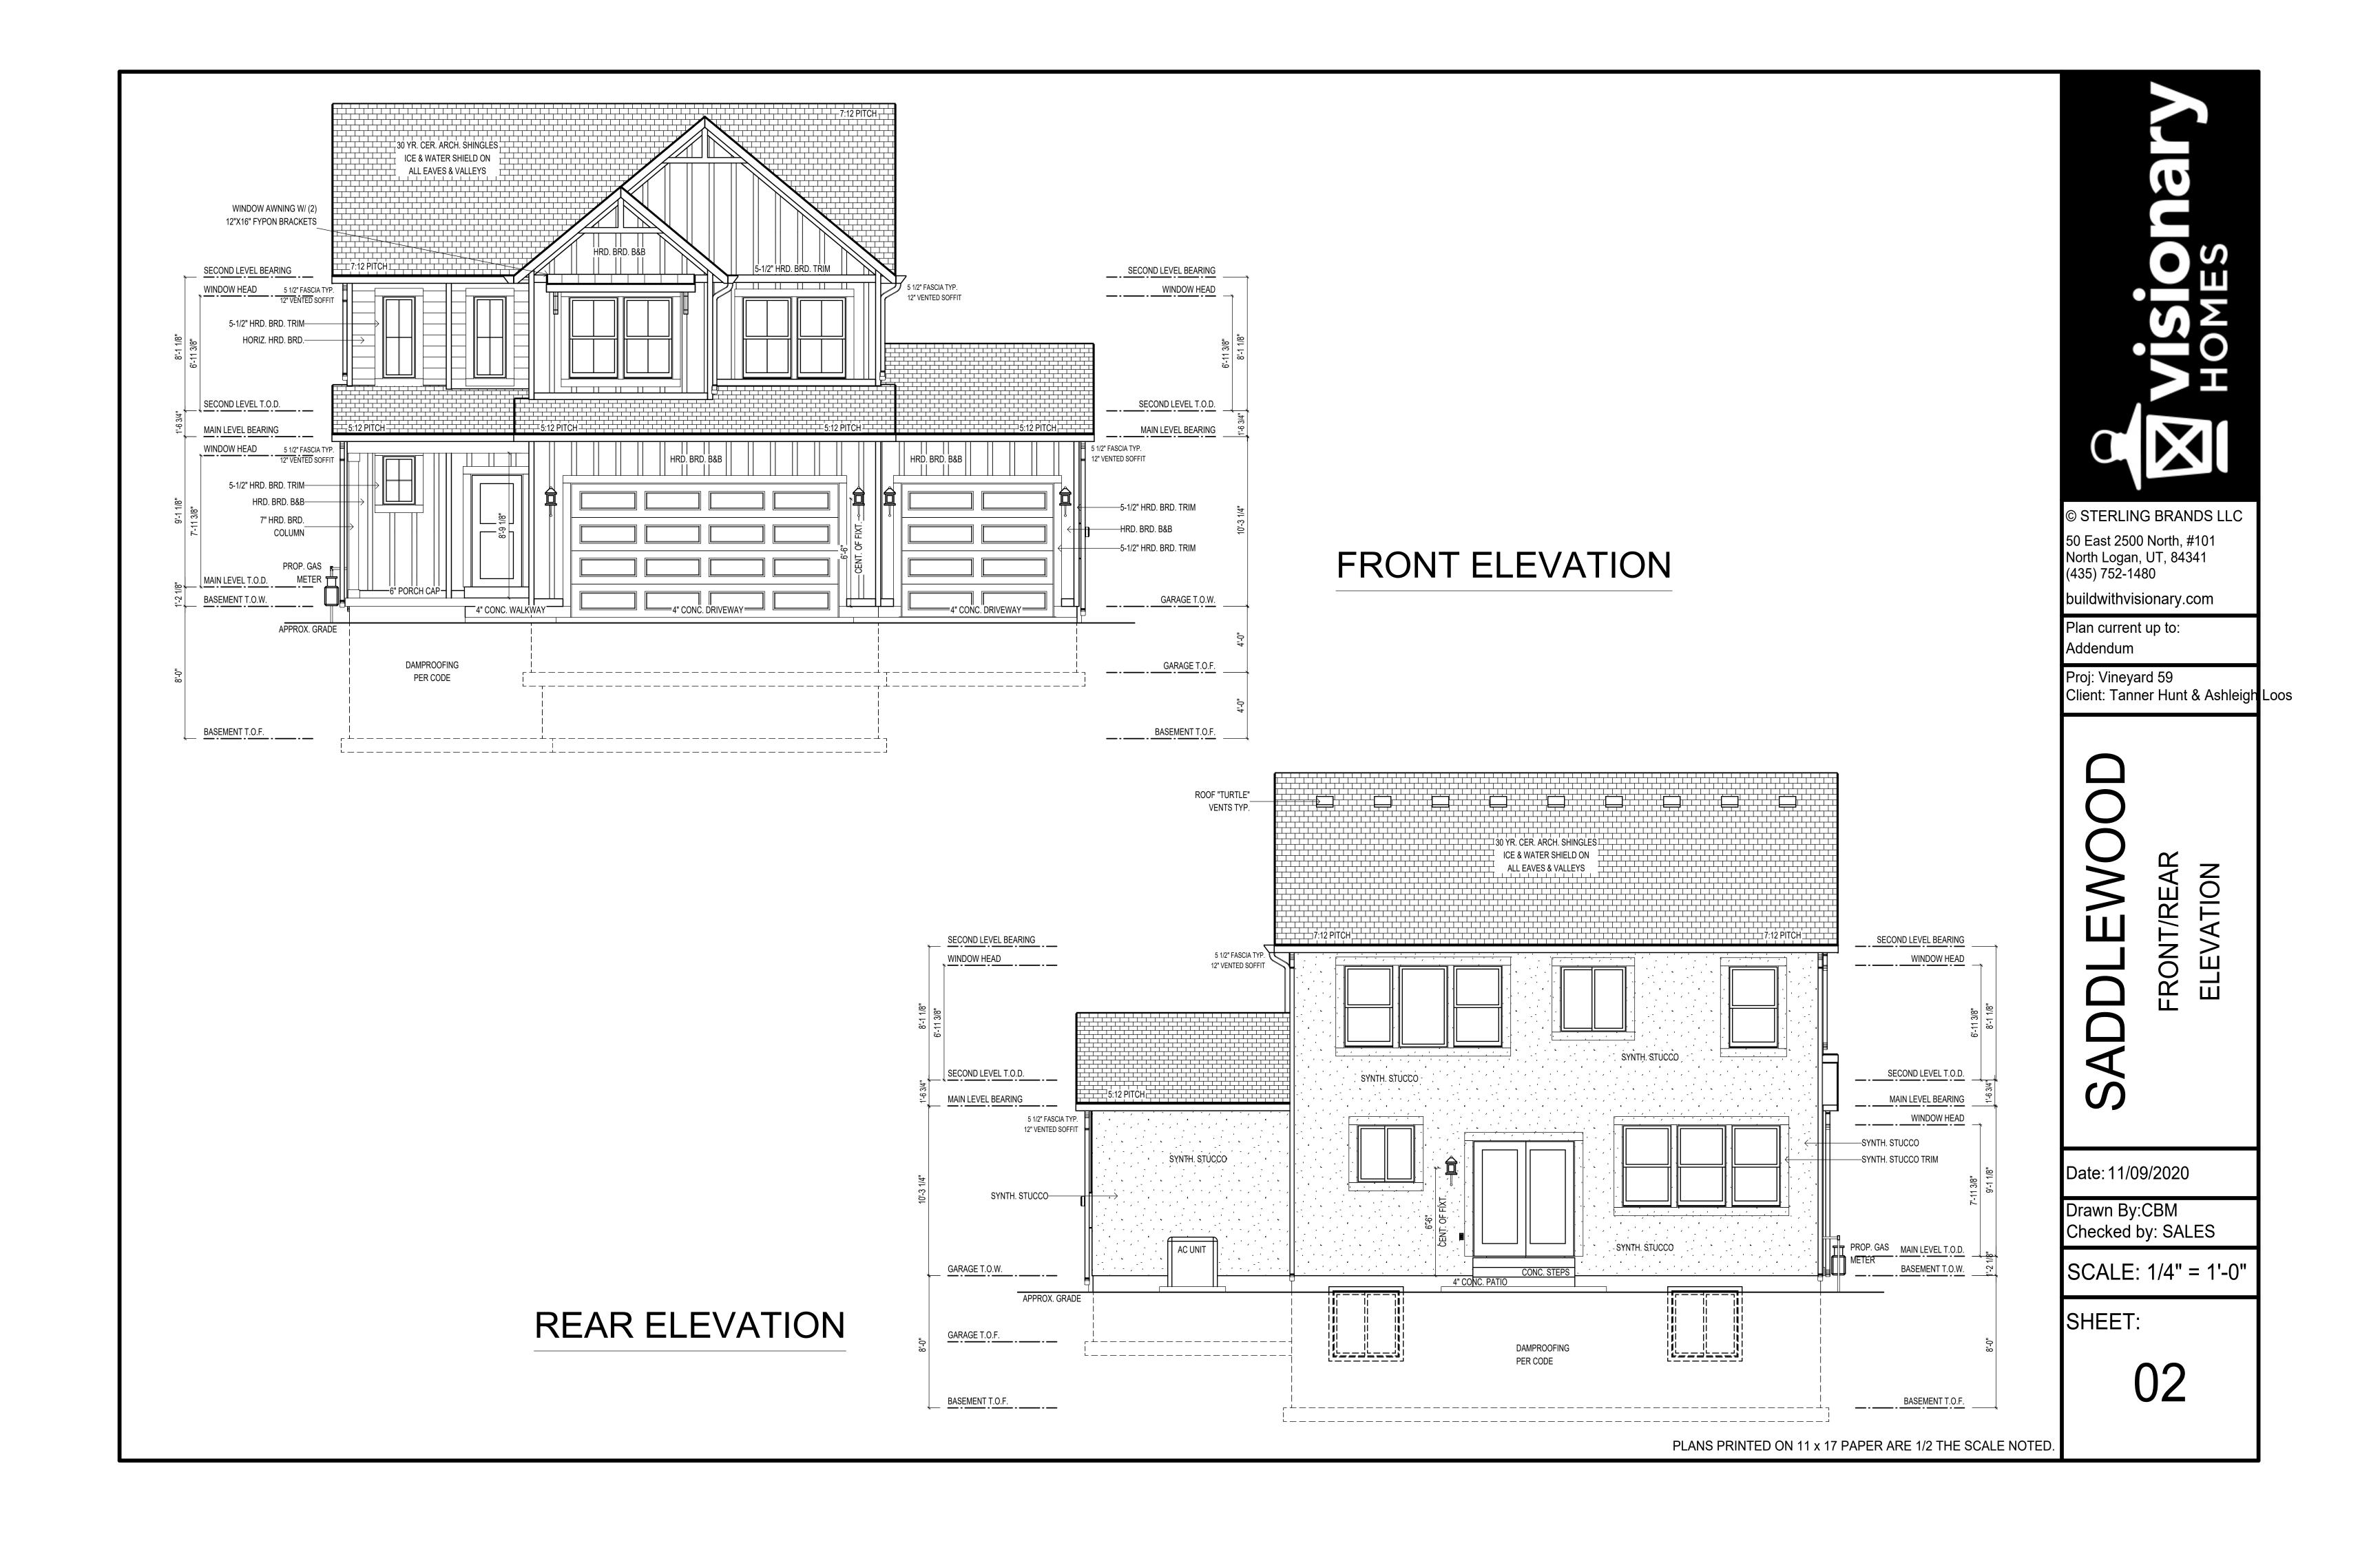
Proj: Vineyard 59 Client: Tanner Hunt & Ashleigh Loos


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SHEET:

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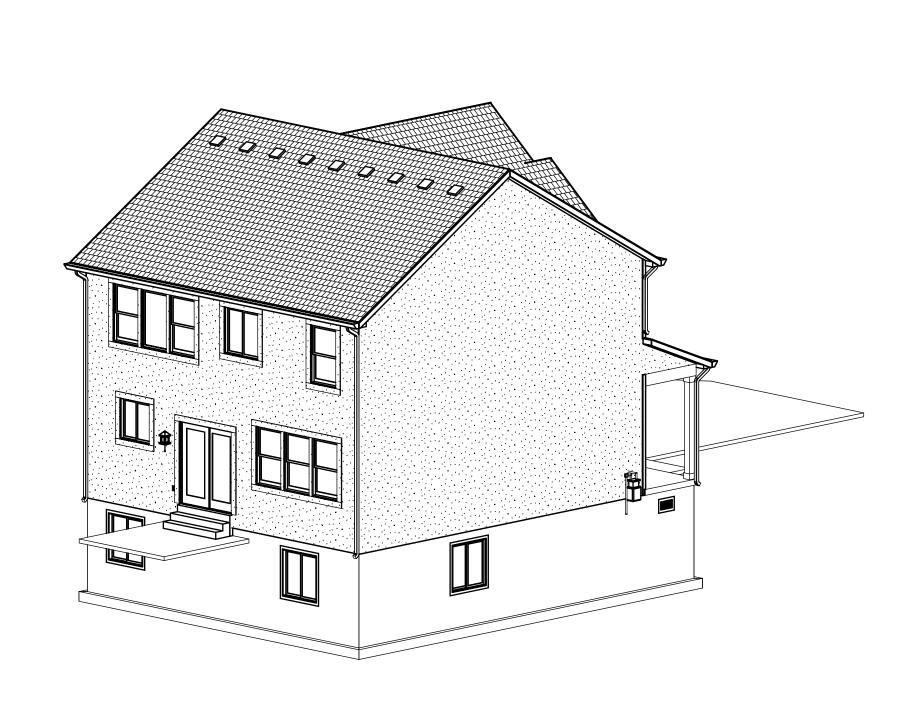






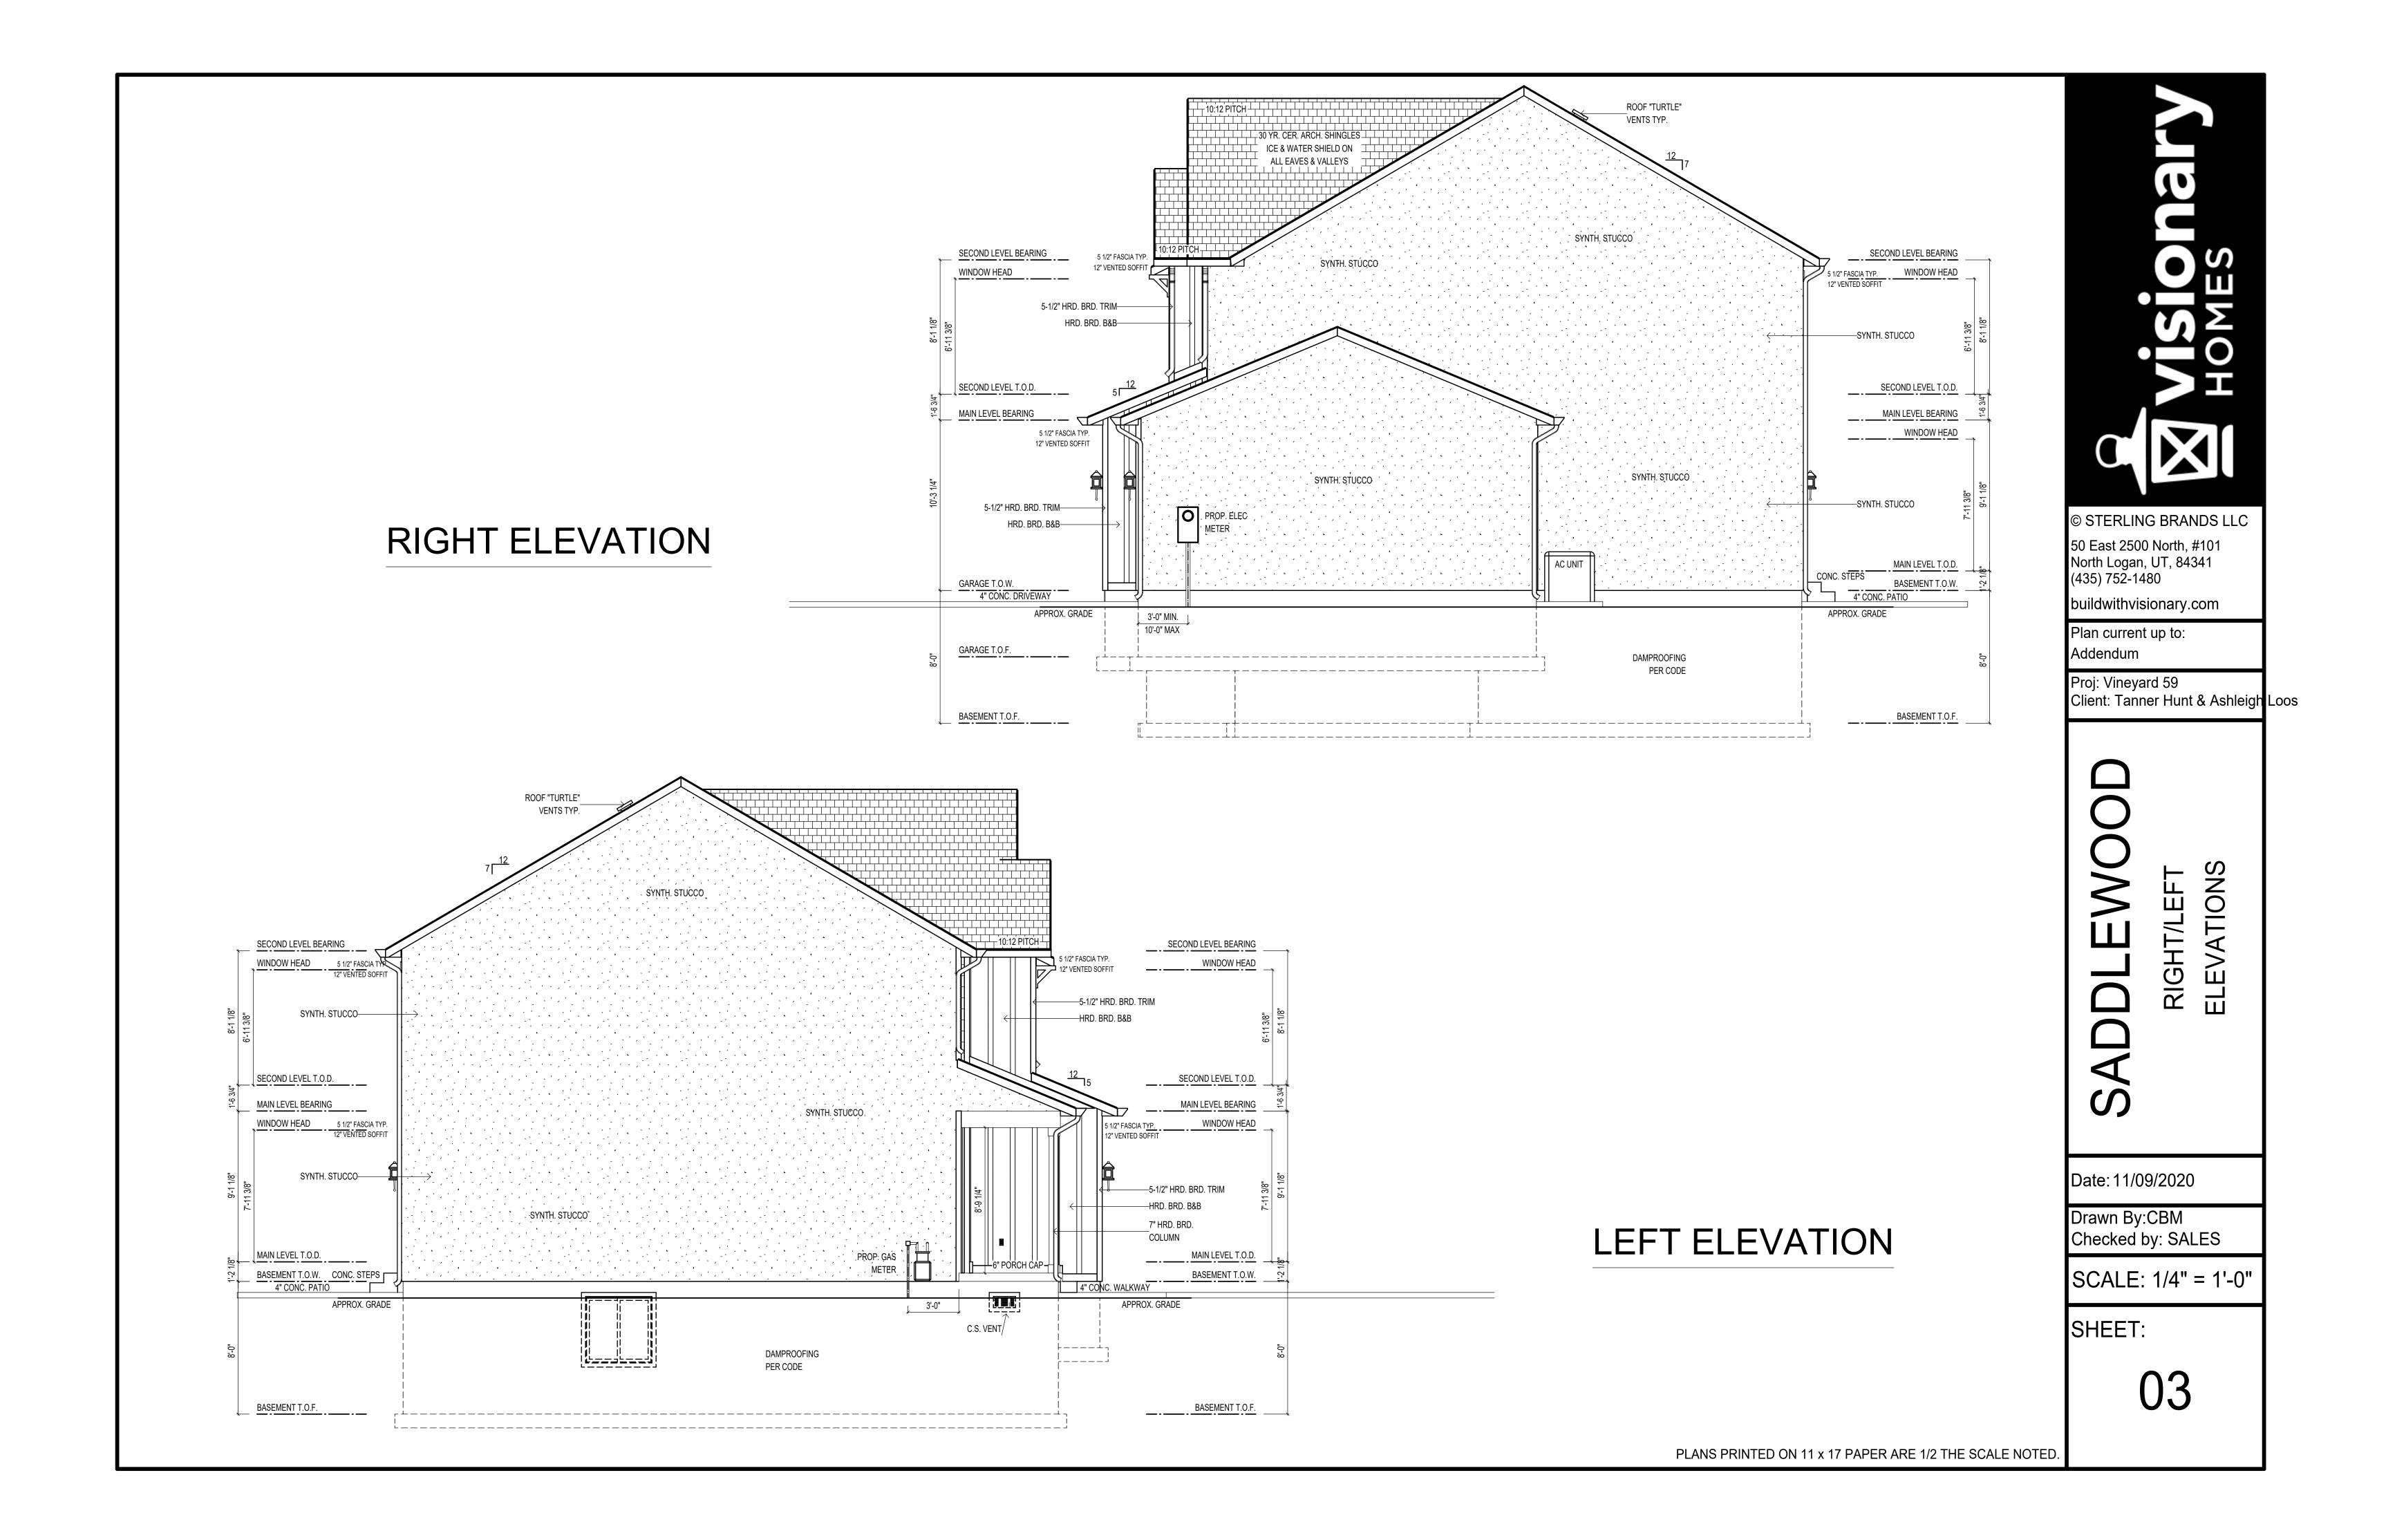


FRONT RIGHT ELEVATION



REAR LEFT ELEVATION

FRONT LEFT ELEVATION

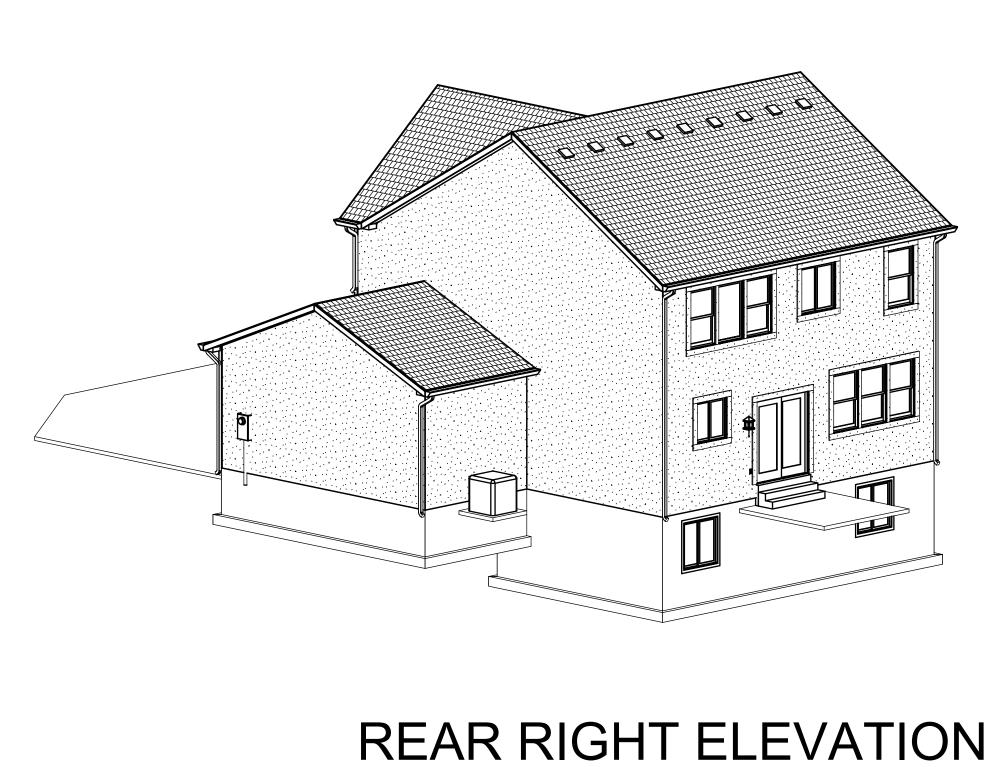

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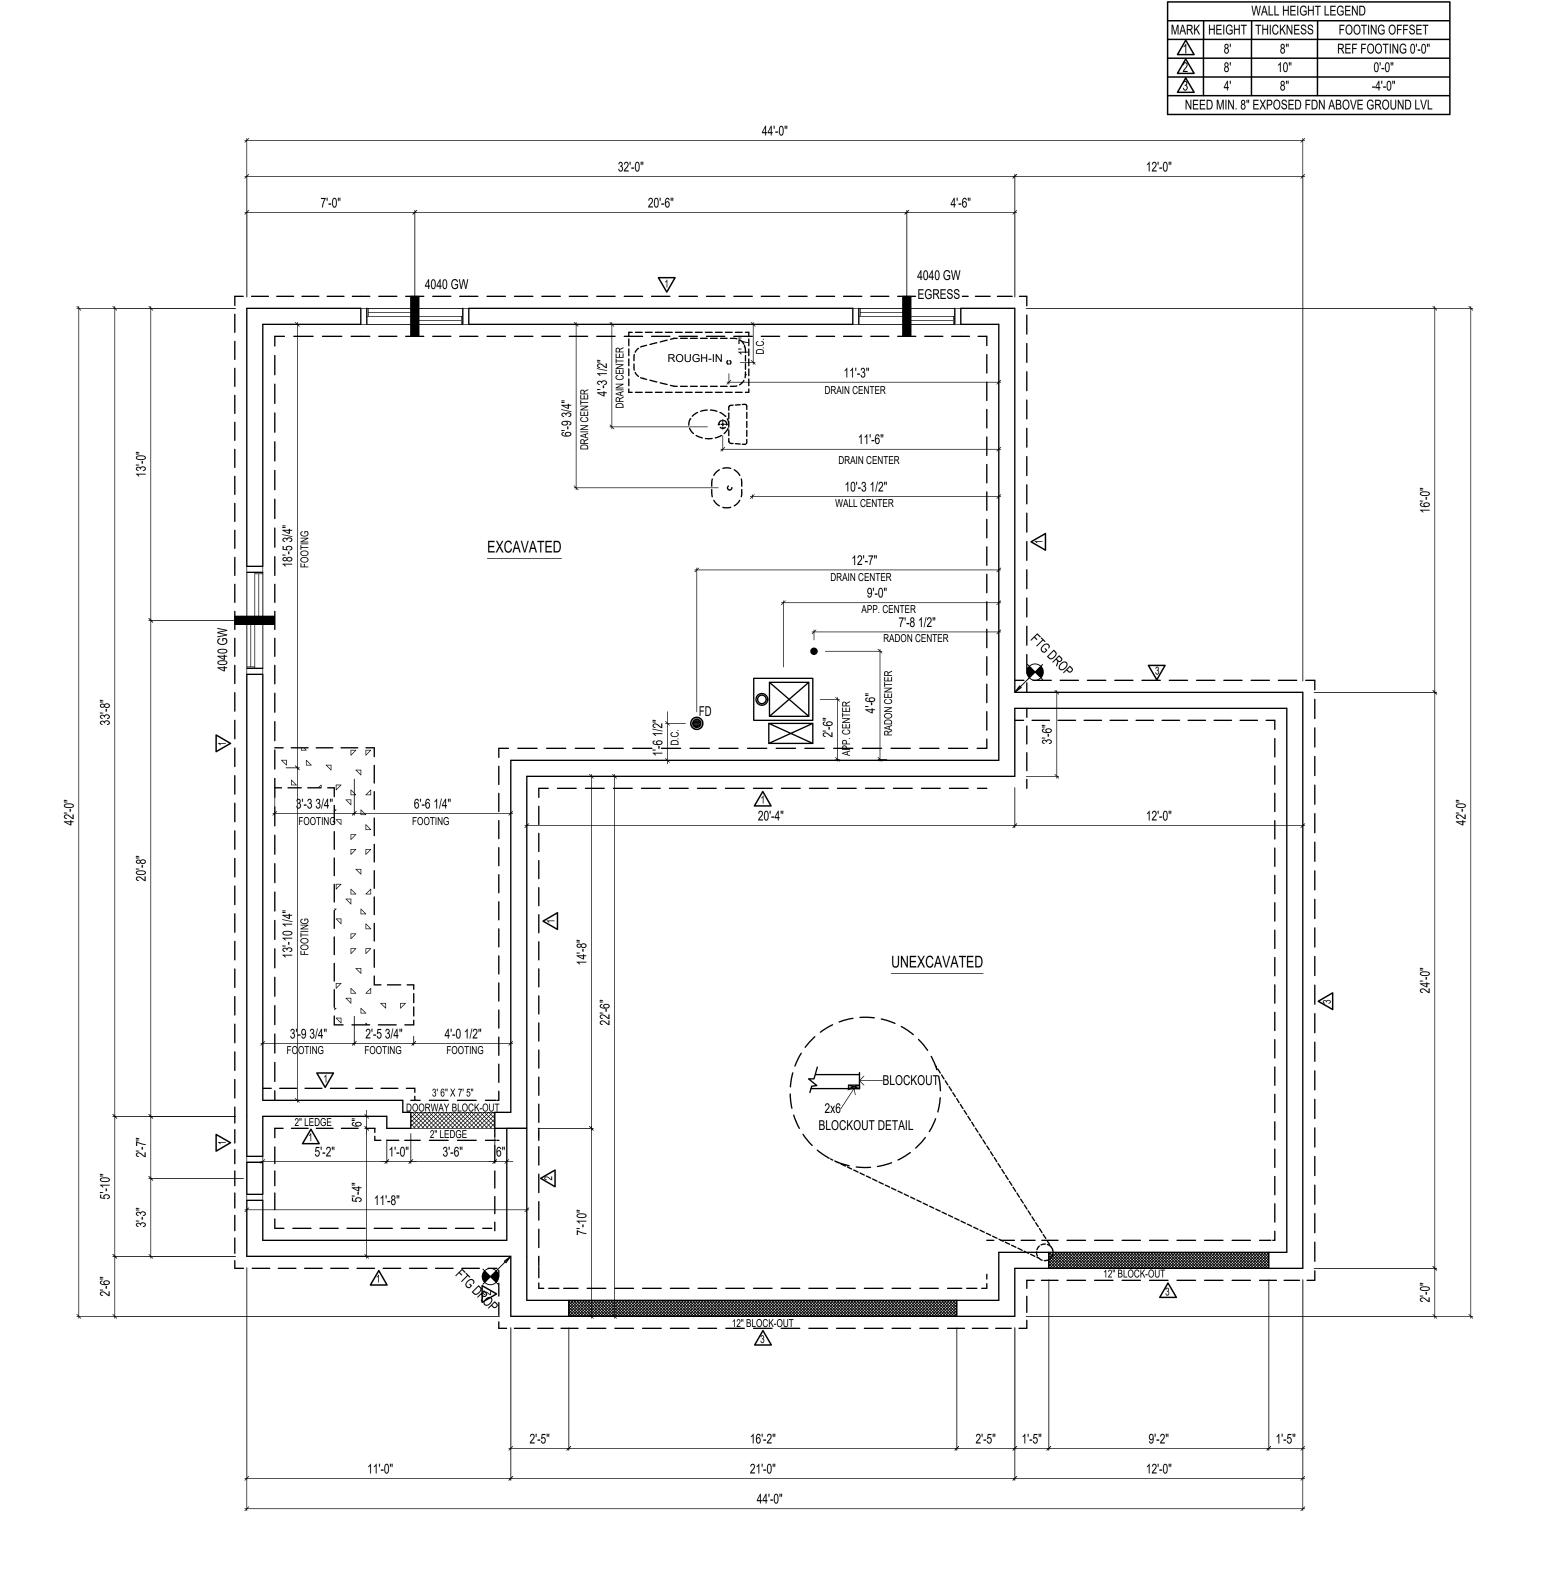
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SHEET:

04





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SADDLEWOOD FOUNDATION PLAN

Date: 11/09/2020

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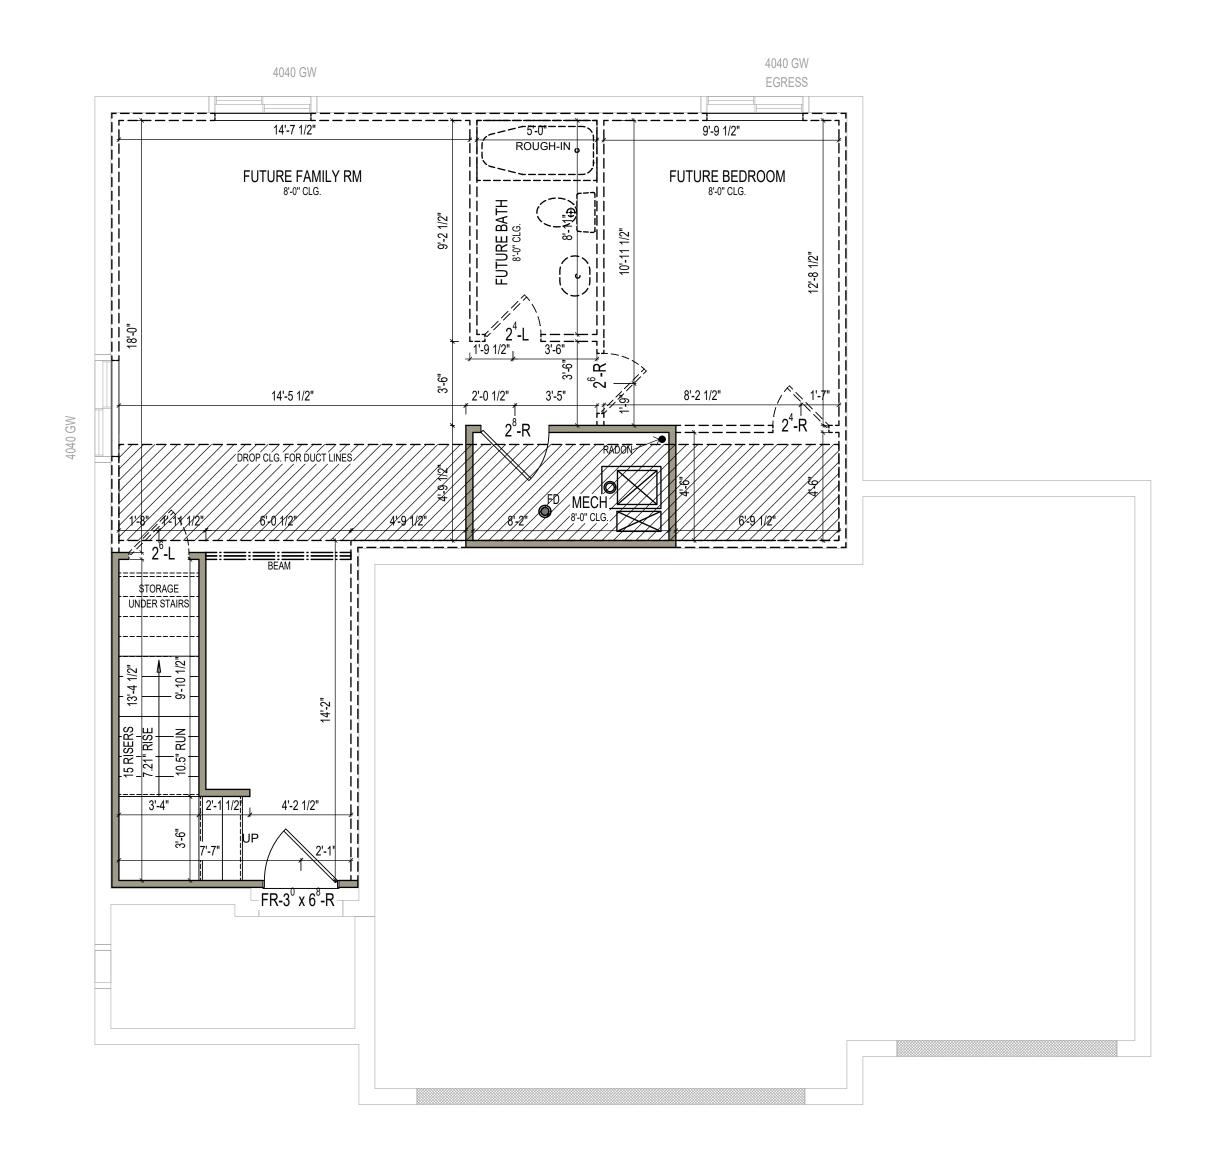
SCALE: 1/4" = 1'-0"

SHEET:

05

FOUNDATION PLAN

BASEMENT



BASEMENT LEVEL FLOOR PLAN

DIMENSION PLAN 8' CEILINGS UNLESS NOTED OTHERWISE



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BASEMENT LEVEL FLOOF DIMENSION PLAN


Date: 11/09/2020

Drawn By:CBM Checked by: SALES

SCALE: 1/4" = 1'-0"

SHEET:

6D

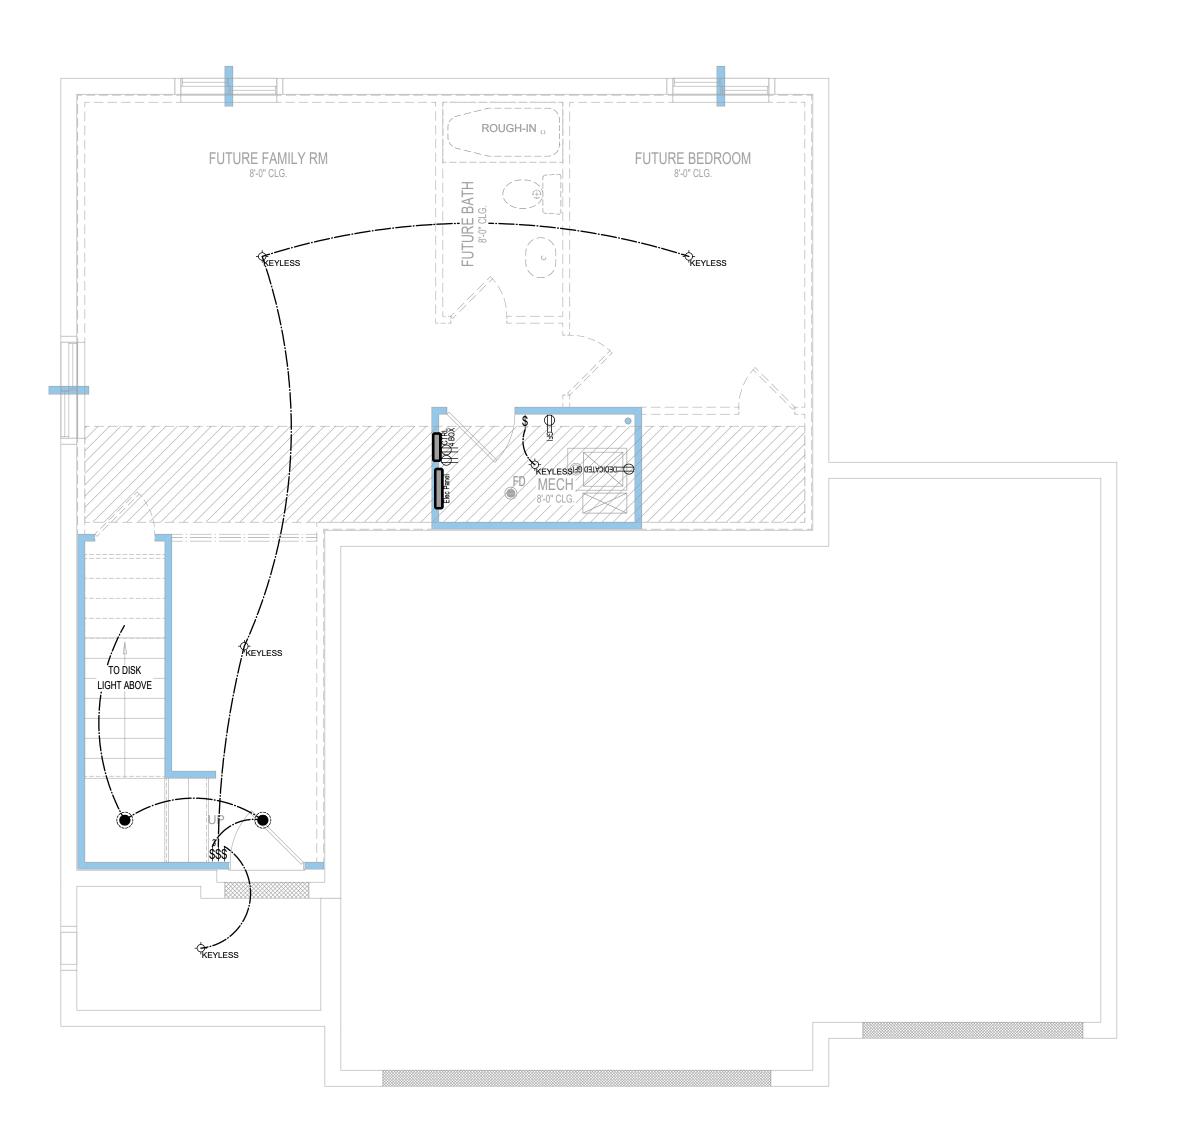

BASEMENT LEVEL FLOOR PLAN

ELECTRICAL LAYOUT

-ADD CONTROL4 DELUXE SMART HOME AUTOMATION PACKAGE

-LOCATIONS OF ELECTRICAL TERMINATIONS AND ELECTRICAL PANEL ARE APPROXIMATE ONLY, UNLESS NOTED OTHERWISE ON SPECIFIED HOME PLANS

-WIRING FOR FUTURE SATELLITE INCLUDED

-ALL INTERIOR LIGHTS TO BE L.E.D.

	OUTLETS
\leftarrow	DUPLEX OUTLET
⊕ USB	USB DUPLEX OUTLET
⊕ CLG	CEILING OUTLET
⊗-	FLOOR OUTLET
G FI	GROUND FAULT INTERRUPTER DUPLEX
─ 42"GFI	GFI DUPLEX 42" ABOVE FLOOR FINISH
₩P GFI	WEATHER PROOF GFI DUPLEX
RADON GFI	GFI DUPLEX FOR RADON FAN
DEDICATED GFI	DEDICATED GFI DUPLEX
DEDICATED HEAT TAPE GFI	DEDICATED GFI DUPLEX FOR HEAT TAP
220	220 VOLT OUTLET
∇	TV/DATA/ETHERNET RECEPTACLE
	SWITCHES
\$	SINGLE POLE SWITCH
3 \$	3-WAY SWITCH
\$	4-WAY SWITCH
C4 \$	CONTROL4 SMART HOME SWITCH
3C4 \$	3-WAY CONTROL4 SMART HOME SWITC
D \$	DIMMER SWITCH
3D \$	3-WAY DIMMER SWITCH
Ψ	LIGHTING FIXTURES
-()-	CEILING LIGHT FIXTURE
	6" L.E.D. DISK LIGHT
	RECESSED CAN LIGHT
	HANGING CEILING LIGHT FIXTURE
HANGING	KEYLESS LIGHT FIXTURE
T	EXTERIOR WALL LIGHT FIXTURE
0000	WALL STRIP LIGHTING
•	BATH FAN
LED	LED WALL STAIR LIGHT
	BOX FOR FUTURE FAN OR LIGHT
. ф	PENDANT LIGHT
PENDANT	FLOOD LIGHT
U.C.	UNDER CABINET LIGHTING
U.С.	ONDER OADINET EIGHTING
CFP	CEILING FAN
	ACCESSORIES & SERVICE
<u>S</u>	SMOKE DETECTOR
60	CARBON MONOXIDE DETECTOR
©	DOOR BELL CHIME
(DB)	DOOR BELL BUTTON
Т	PROGRAMMABLE THERMOSTAT
0	SINK GARBAGE DISPOSAL
	GARAGE DOOR OPENER BUTTON
CTRL 1 POY	CONTROL 4 SERVICE PANEL
T T BOX	ELECTRICAL SERVICE PANEL



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DDLEWOOR PLAN


Date: 11/09/2020

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SCALE: 1/4" = 1'-0"

SHEET:

6E

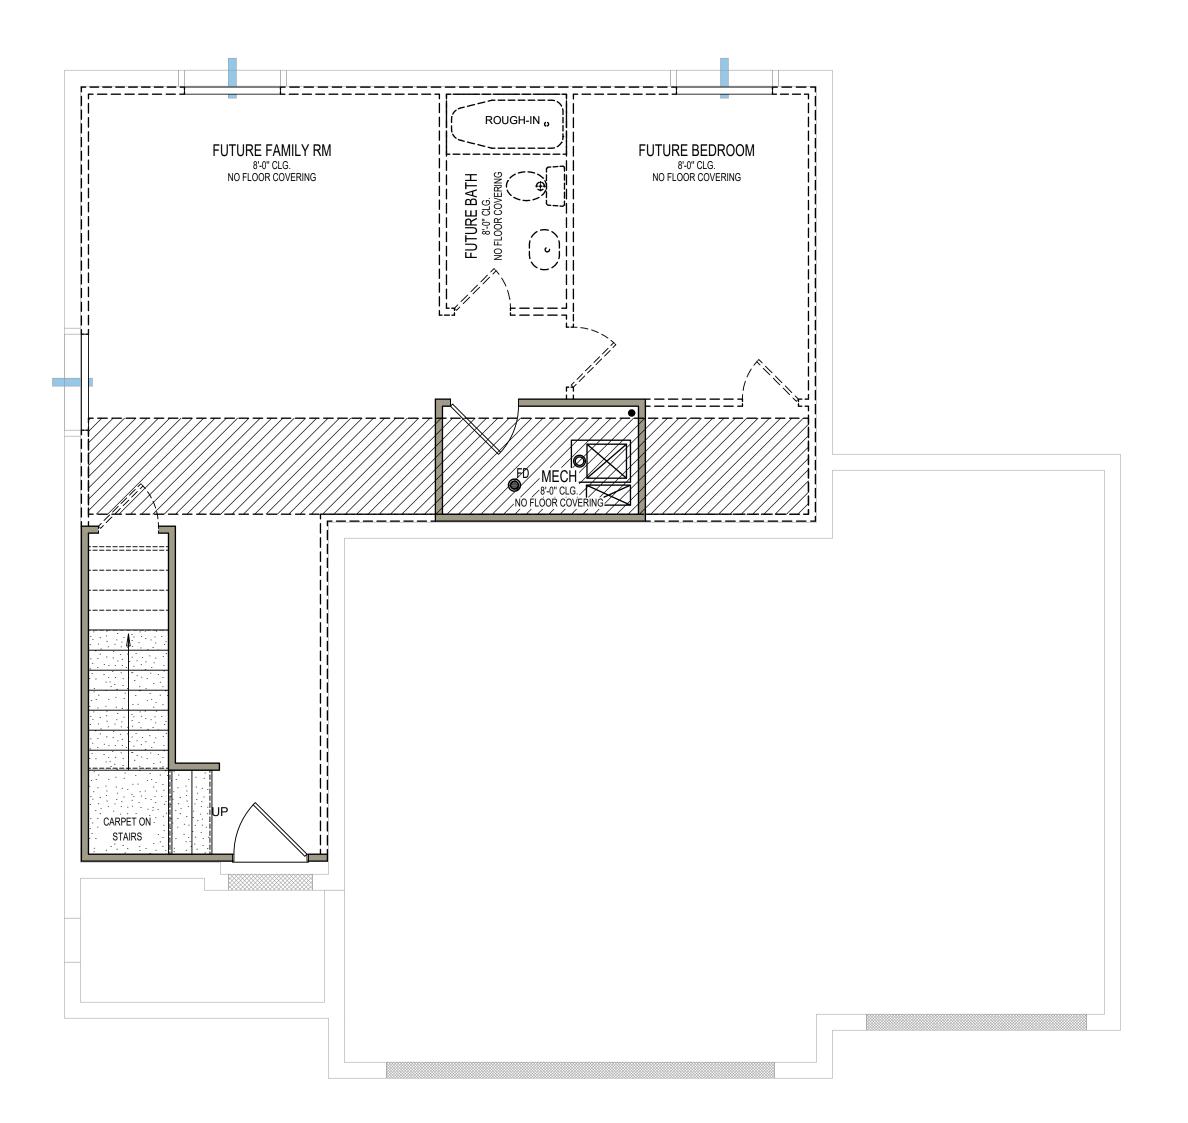

BASEMENT LEVEL FLOOR PLAN

FINISHES & FLOORING UNFINISHED BASEMENT



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SADDLEWOODD

BASEMENT LEVEL FLOOR PLAN
FINISHES, & FLOORING


Date: 11/09/2020

Drawn By:CBM Checked by: SALES

SCALE: 1/4" = 1'-0"

SHEET:

6F

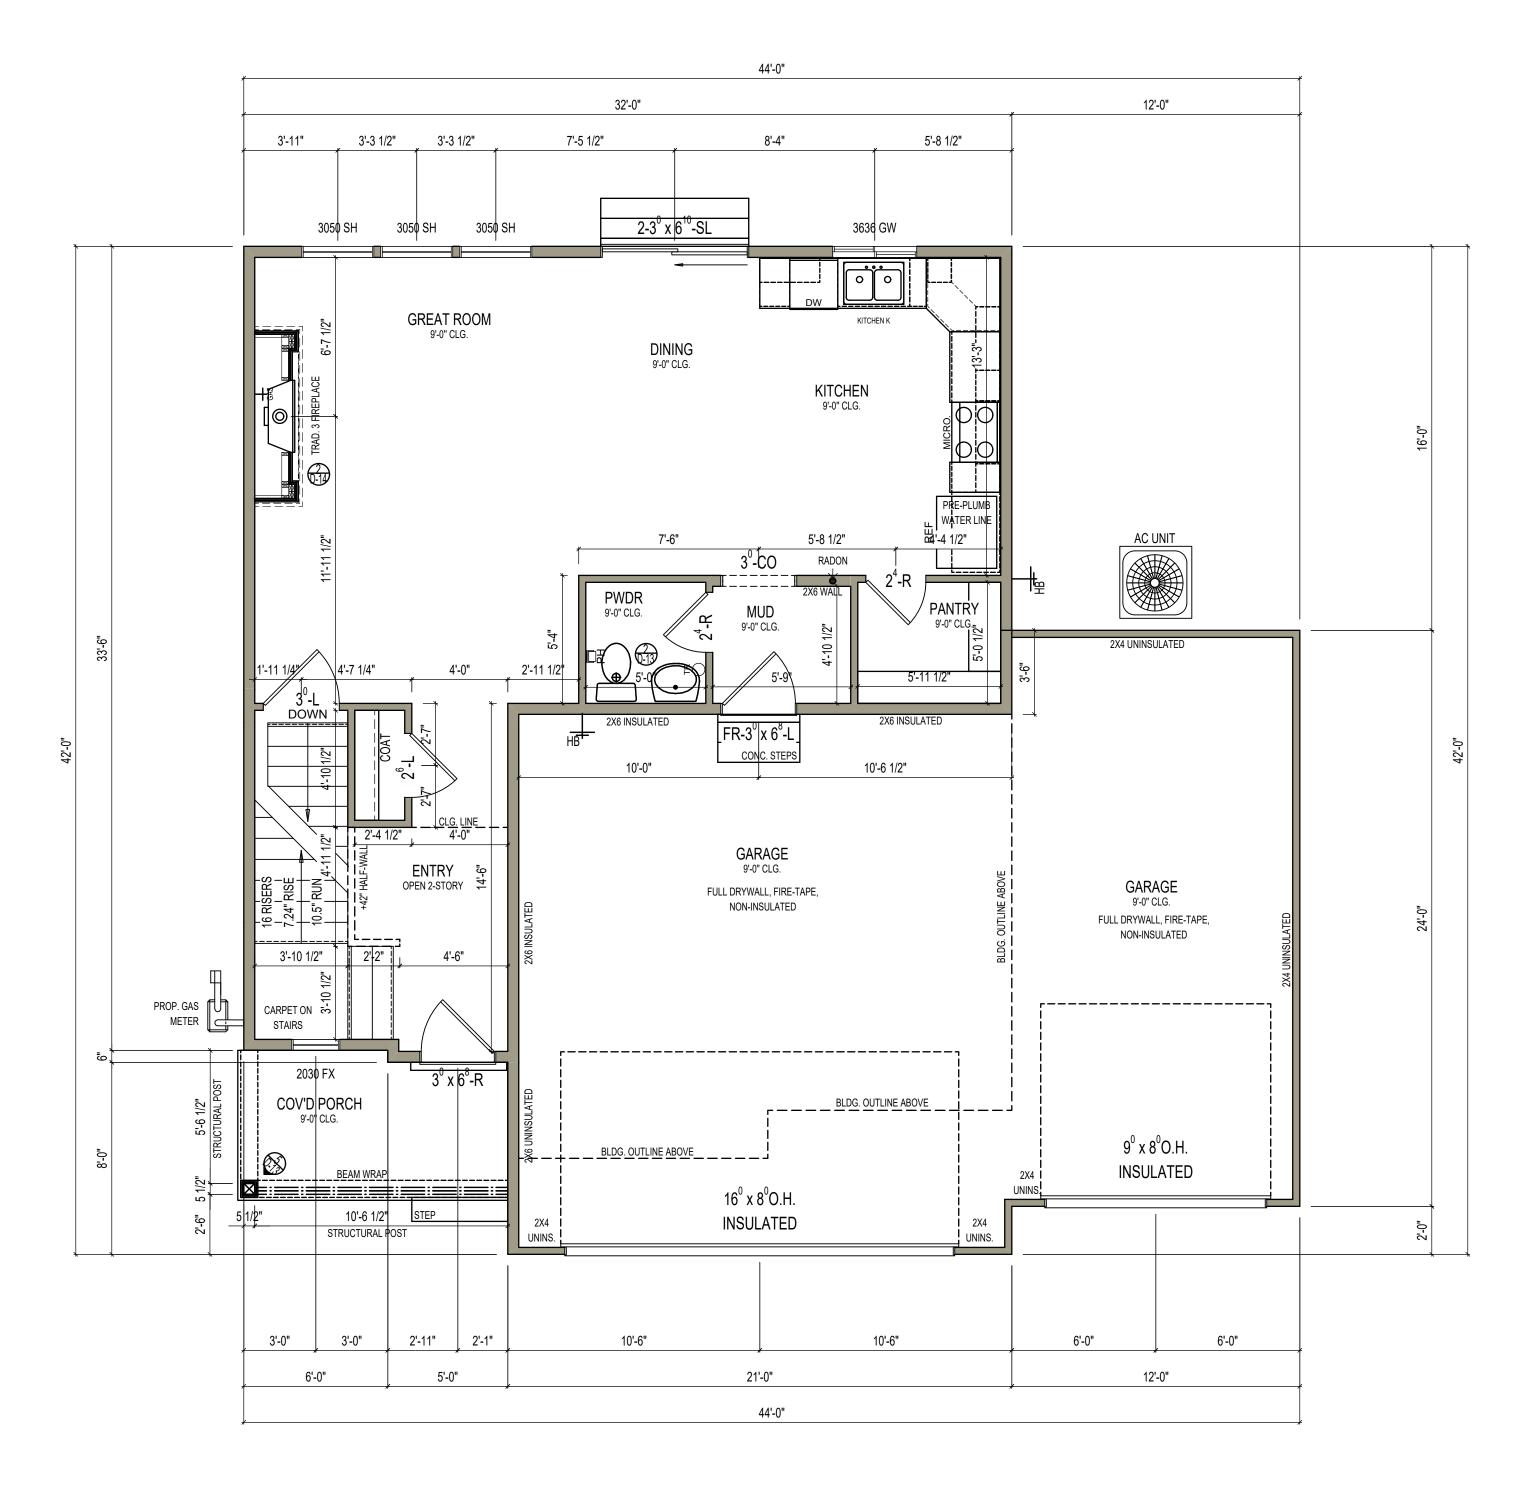

MAIN LEVEL FLOOR PLAN

DIMENSION PLAN 9' CEILING HEIGHT UNLESS NOTED OTHERWISE



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DIMENSION PL MAIN LEVEL


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SCALE: 1/4" = 1'-0"

SHEET:

7D



MAIN LEVEL FLOOR PLAN

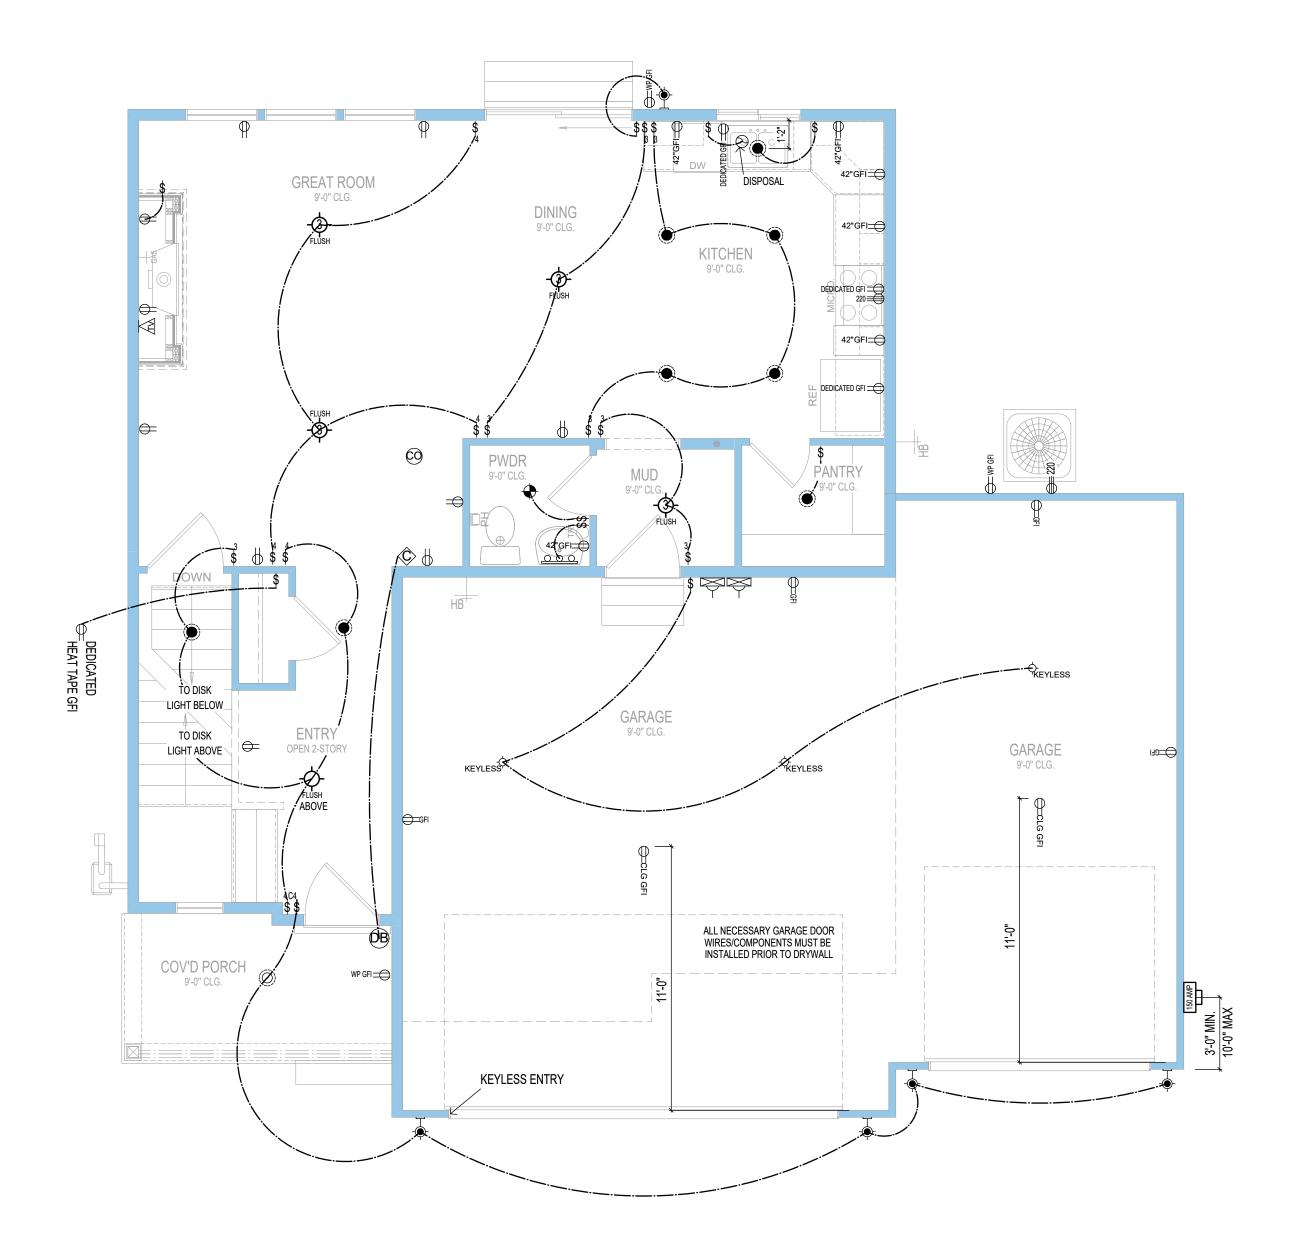ELECTRICAL LAYOUT

-ADD CONTROL4 DELUXE SMART HOME AUTOMATION PACKAGE

-LOCATIONS OF ELECTRICAL TERMINATIONS AND ELECTRICAL PANEL ARE APPROXIMATE ONLY, UNLESS NOTED OTHERWISE ON SPECIFIED HOME PLANS

-WIRING FOR FUTURE SATELLITE INCLUDED

-ALL INTERIOR LIGHTS TO BE L.E.D.

	OUTLETS
\leftarrow	DUPLEX OUTLET
⊕ USB	USB DUPLEX OUTLET
⊕ CLG	CEILING OUTLET
⊗-	FLOOR OUTLET
G FI	GROUND FAULT INTERRUPTER DUPLEX
─ 42"GFI	GFI DUPLEX 42" ABOVE FLOOR FINISH
₩P GFI	WEATHER PROOF GFI DUPLEX
RADON GFI	GFI DUPLEX FOR RADON FAN
DEDICATED GFI	DEDICATED GFI DUPLEX
DEDICATED HEAT TAPE GFI	DEDICATED GFI DUPLEX FOR HEAT TAPE
220	220 VOLT OUTLET
$\underline{\mathbb{V}}$	TV/DATA/ETHERNET RECEPTACLE
	SWITCHES
\$	SINGLE POLE SWITCH
3 \$	3-WAY SWITCH
4 \$	4-WAY SWITCH
C4 \$	CONTROL4 SMART HOME SWITCH
3C4 \$	3-WAY CONTROL4 SMART HOME SWITCH
, ,	DIMMER SWITCH
3D \$	3-WAY DIMMER SWITCH
<u>'</u>	LIGHTING FIXTURES
	CEILING LIGHT FIXTURE
•	6" L.E.D. DISK LIGHT
0	RECESSED CAN LIGHT
	HANGING CEILING LIGHT FIXTURE
KEYLESS	KEYLESS LIGHT FIXTURE
<u></u>	EXTERIOR WALL LIGHT FIXTURE
0000	WALL STRIP LIGHTING
•	BATH FAN
LED	LED WALL STAIR LIGHT
-	BOX FOR FUTURE FAN OR LIGHT
PENDANT	PENDANT LIGHT
显	FLOOD LIGHT
U.C.	UNDER CABINET LIGHTING
CFP	CEILING FAN
Ц	ACCESSORIES & SERVICE
<u>S</u>	SMOKE DETECTOR
60	CARBON MONOXIDE DETECTOR
©	DOOR BELL CHIME
OB)	DOOR BELL BUTTON
	PROGRAMMABLE THERMOSTAT
0	SINK GARBAGE DISPOSAL
	GARAGE DOOR OPENER BUTTON
T (MI NOTRL	CONTROL 4 SERVICE PANEL
₩₩ ⁴ BÖX	ELECTRICAL SERVICE PANEL



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Plan current up to:
Addendum

Proj: Vineyard 59 Client: Tanner Hunt & Ashleigh Loos

ADDLEWOOR PLAN MAIN LEVEL FLOOR PLAN FI FOTRICAL LAYOUT


Date: 11/09/2020

Drawn By:CBM Checked by: SALES

SCALE: 1/4" = 1'-0"

SHEET:

7E

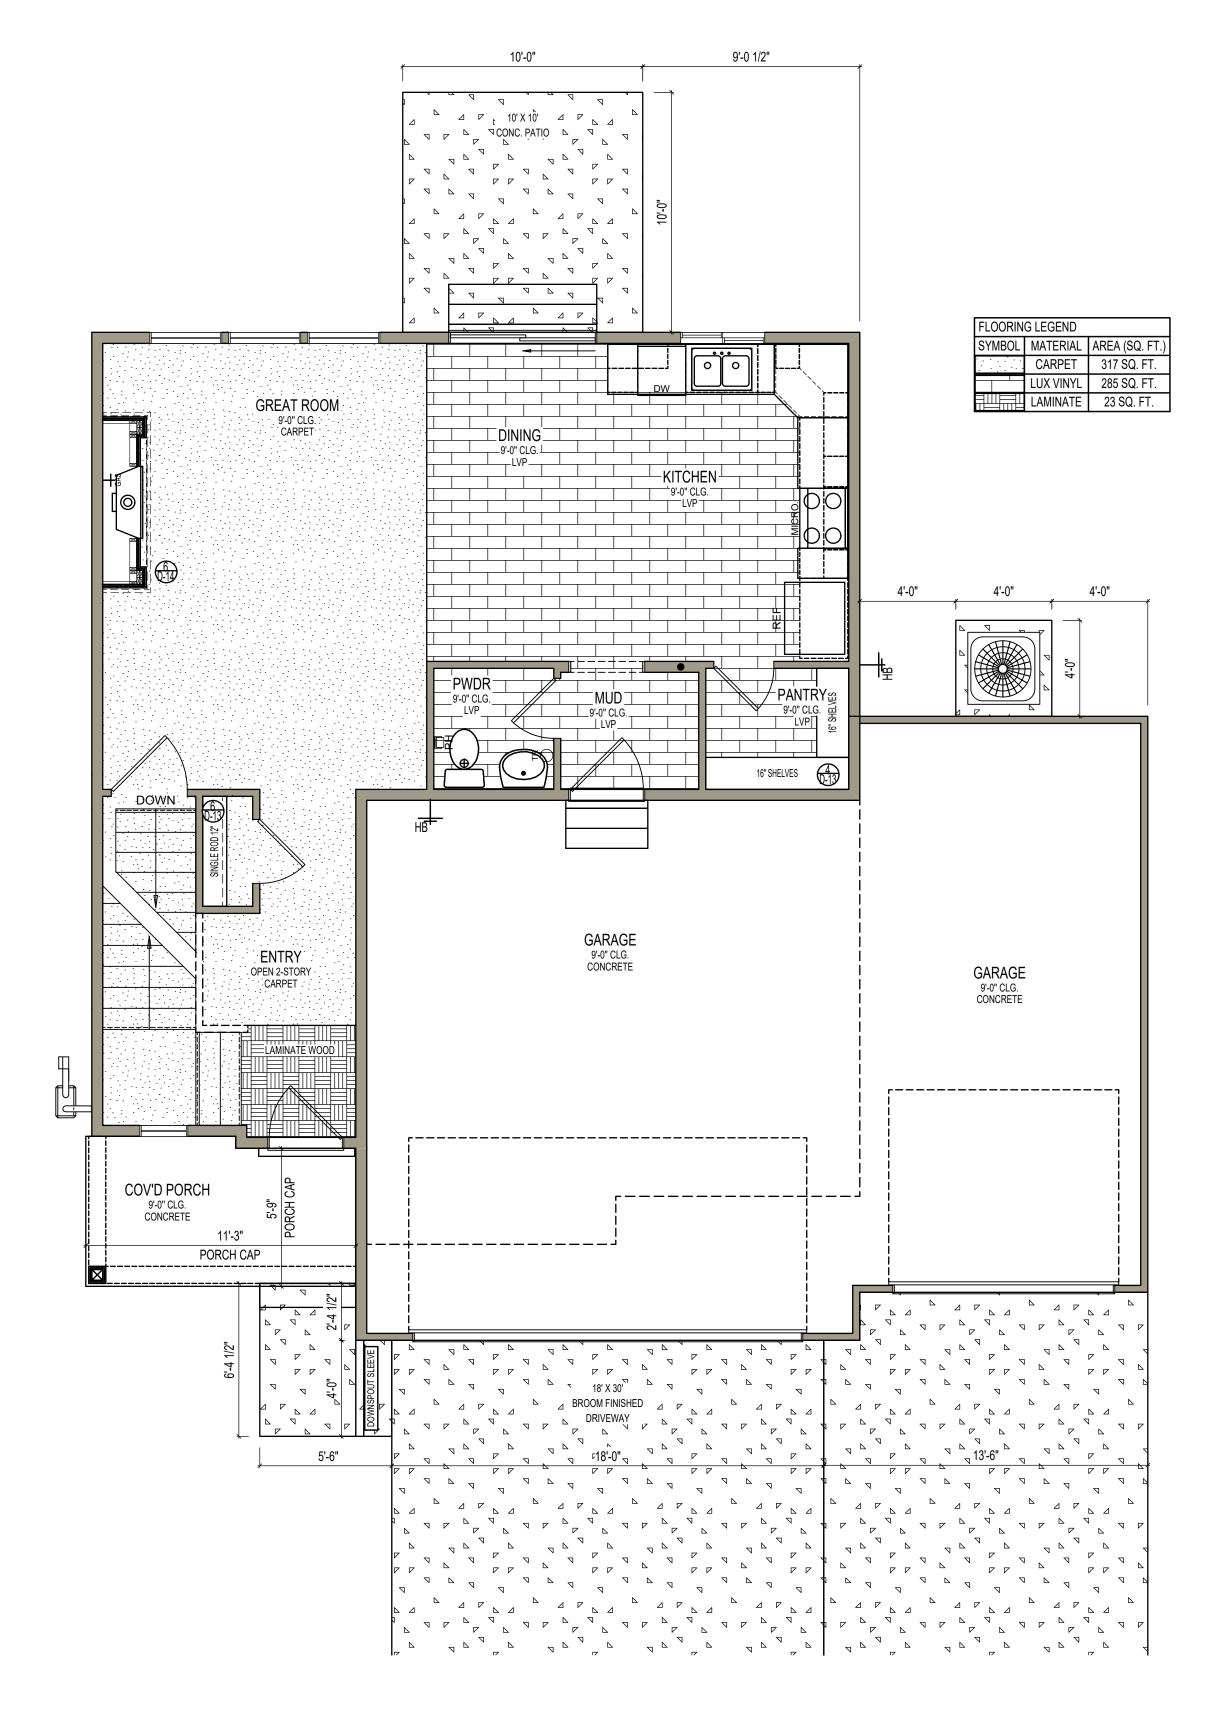

MAIN LEVEL FLOOR PLAN

FINISHES, FLOORING & FLATWORK JAMB & CASE ALL DOORS & WINDOWS



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FLOORING, **MAIN LEVEL** INISHES,


Date: 11/09/2020

Drawn By:CBM Checked by: SALES

SCALE: 1/4" = 1'-0"

SHEET:

7F

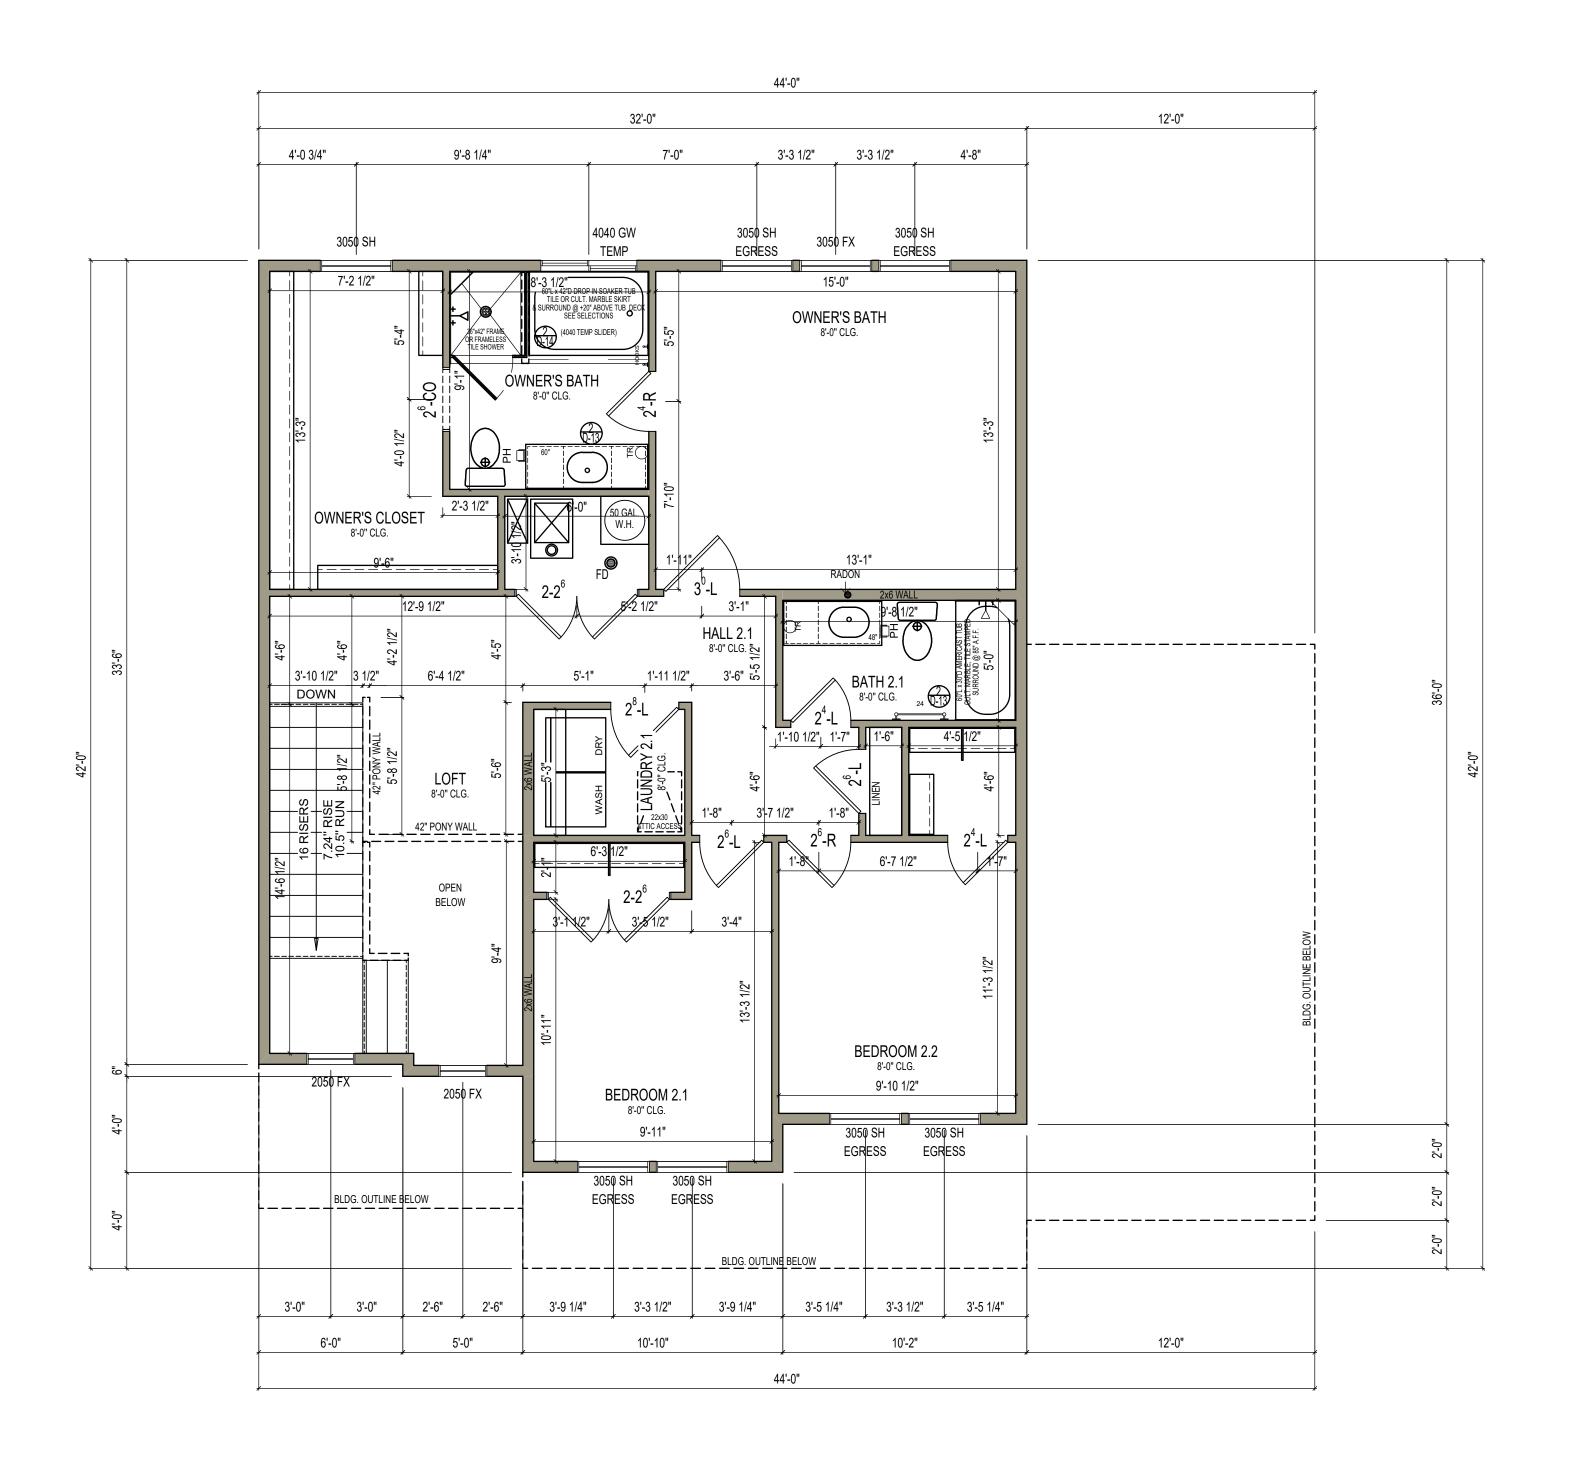

SECOND LEVEL FLOOR PLAN

DIMENSION PLAN

8' CEILING HEIGHT UNLESS NOTED OTHERWISE



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집 FLOOR SECOND LEVEL FLOOR DIMENSION PLAN


Date: 11/09/2020

Drawn By:CBM Checked by: SALES

SCALE: 1/4" = 1'-0"

SHEET:

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	PROGRAMMABLE THERMOSTAT
0	SINK GARBAGE DISPOSAL
₩	GARAGE DOOR OPENER BUTTON
MINTE	CONTROL 4 SERVICE PANEL
4444 box	CONTINUE T CENTICE I ANLE

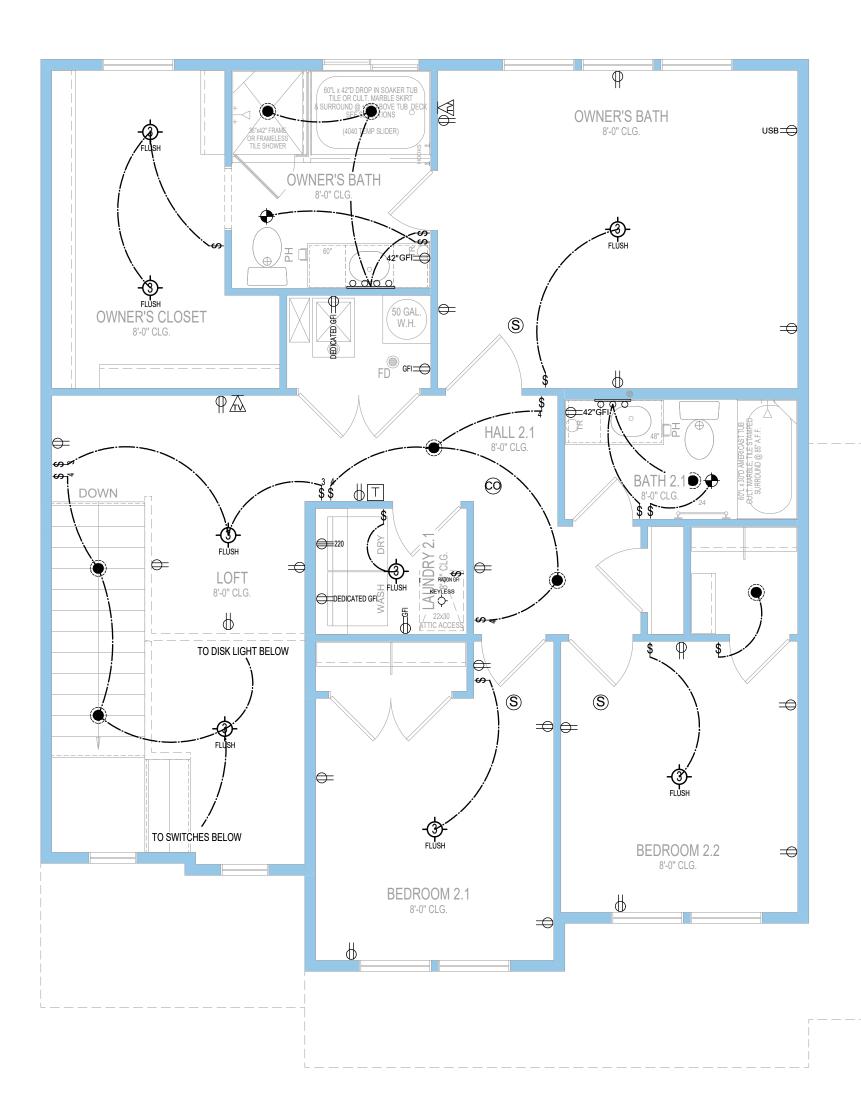

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DDLEWOOR PLAN OND LEVEL FLOOR PLAN FI ECTRICAL LAYOUT


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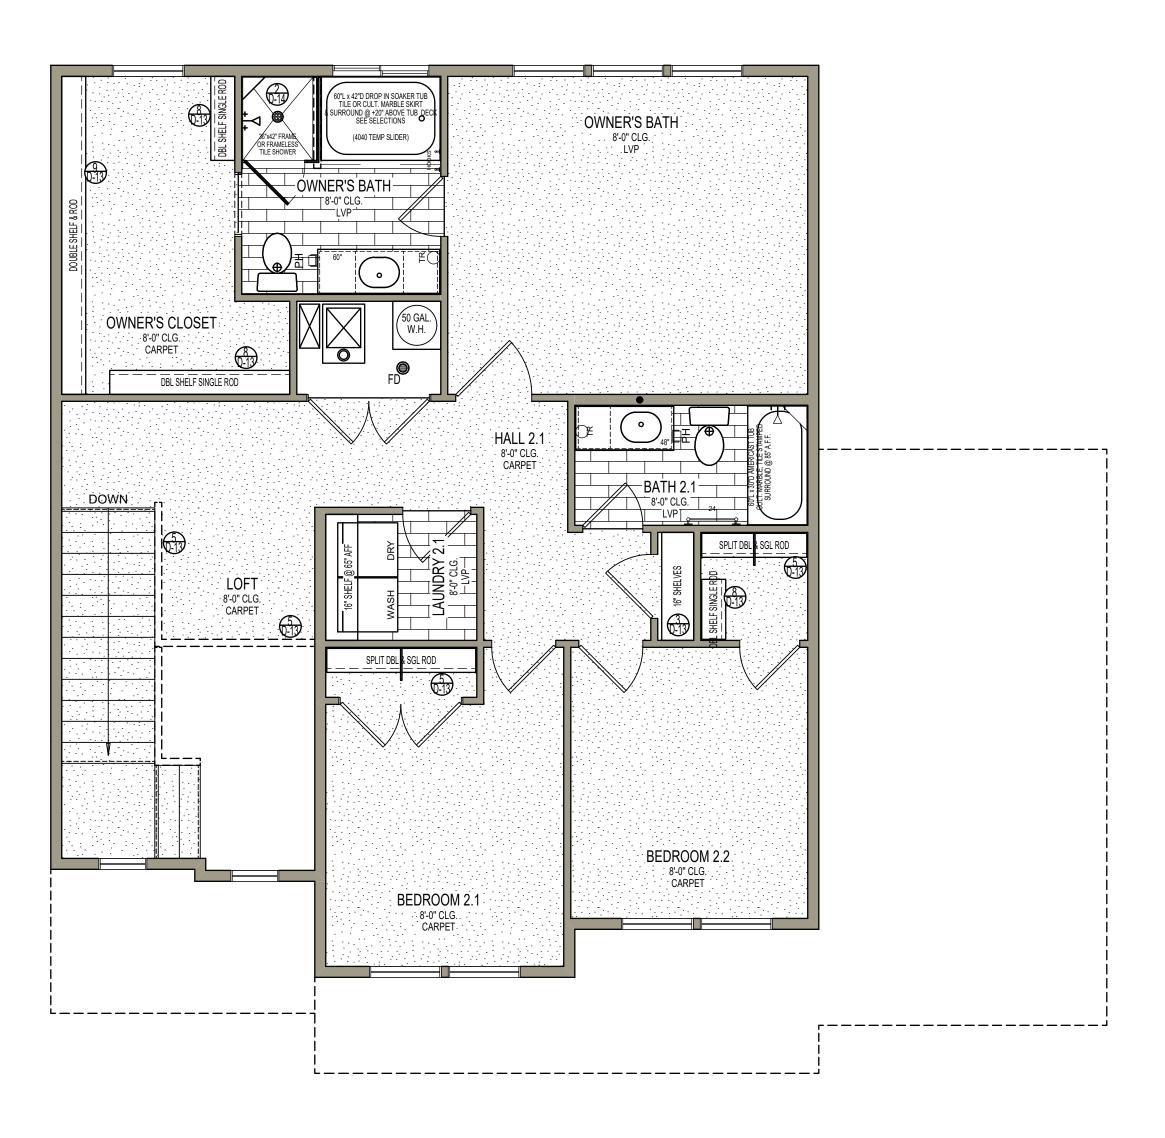
Drawn By:CBM Checked by: SALES

SCALE: 1/4" = 1'-0"

SHEET:

8E



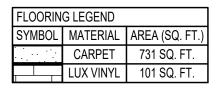

SECOND LEVEL FLOOR PLAN

FINISHES & FLOORING

JAMB & CASE ALL DOORS & WINDOWS



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ADDLEWOOR PLAN INISHES, & FLOORING


Date: 11/09/2020

Drawn By:CBM Checked by: SALES

SCALE: 1/4" = 1'-0"

SHEET:

8F

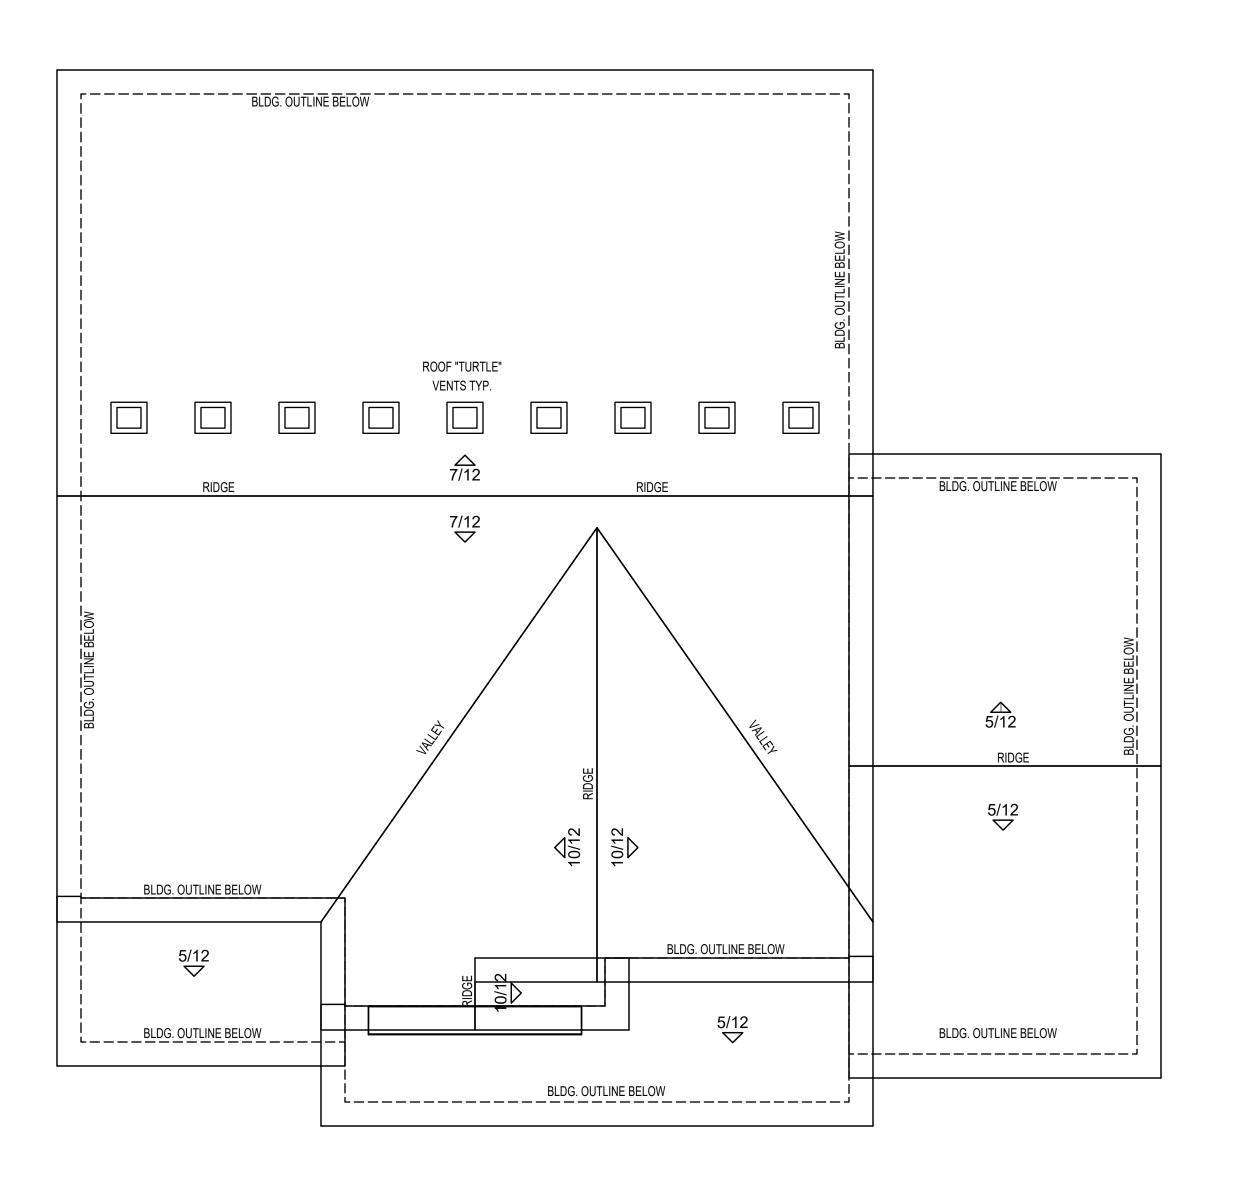

ROOF PLAN

BIRDS-EYE VIEW



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ROOF PLAN BIRDS-EYE VIEW

Date: 11/09/2020

Drawn By:CBM Checked by: SALES

SCALE: 1/4" = 1'-0"

SHEET:

