


576-V-2847  
VRC OUTLET SCRUBBER - TRAIN 2

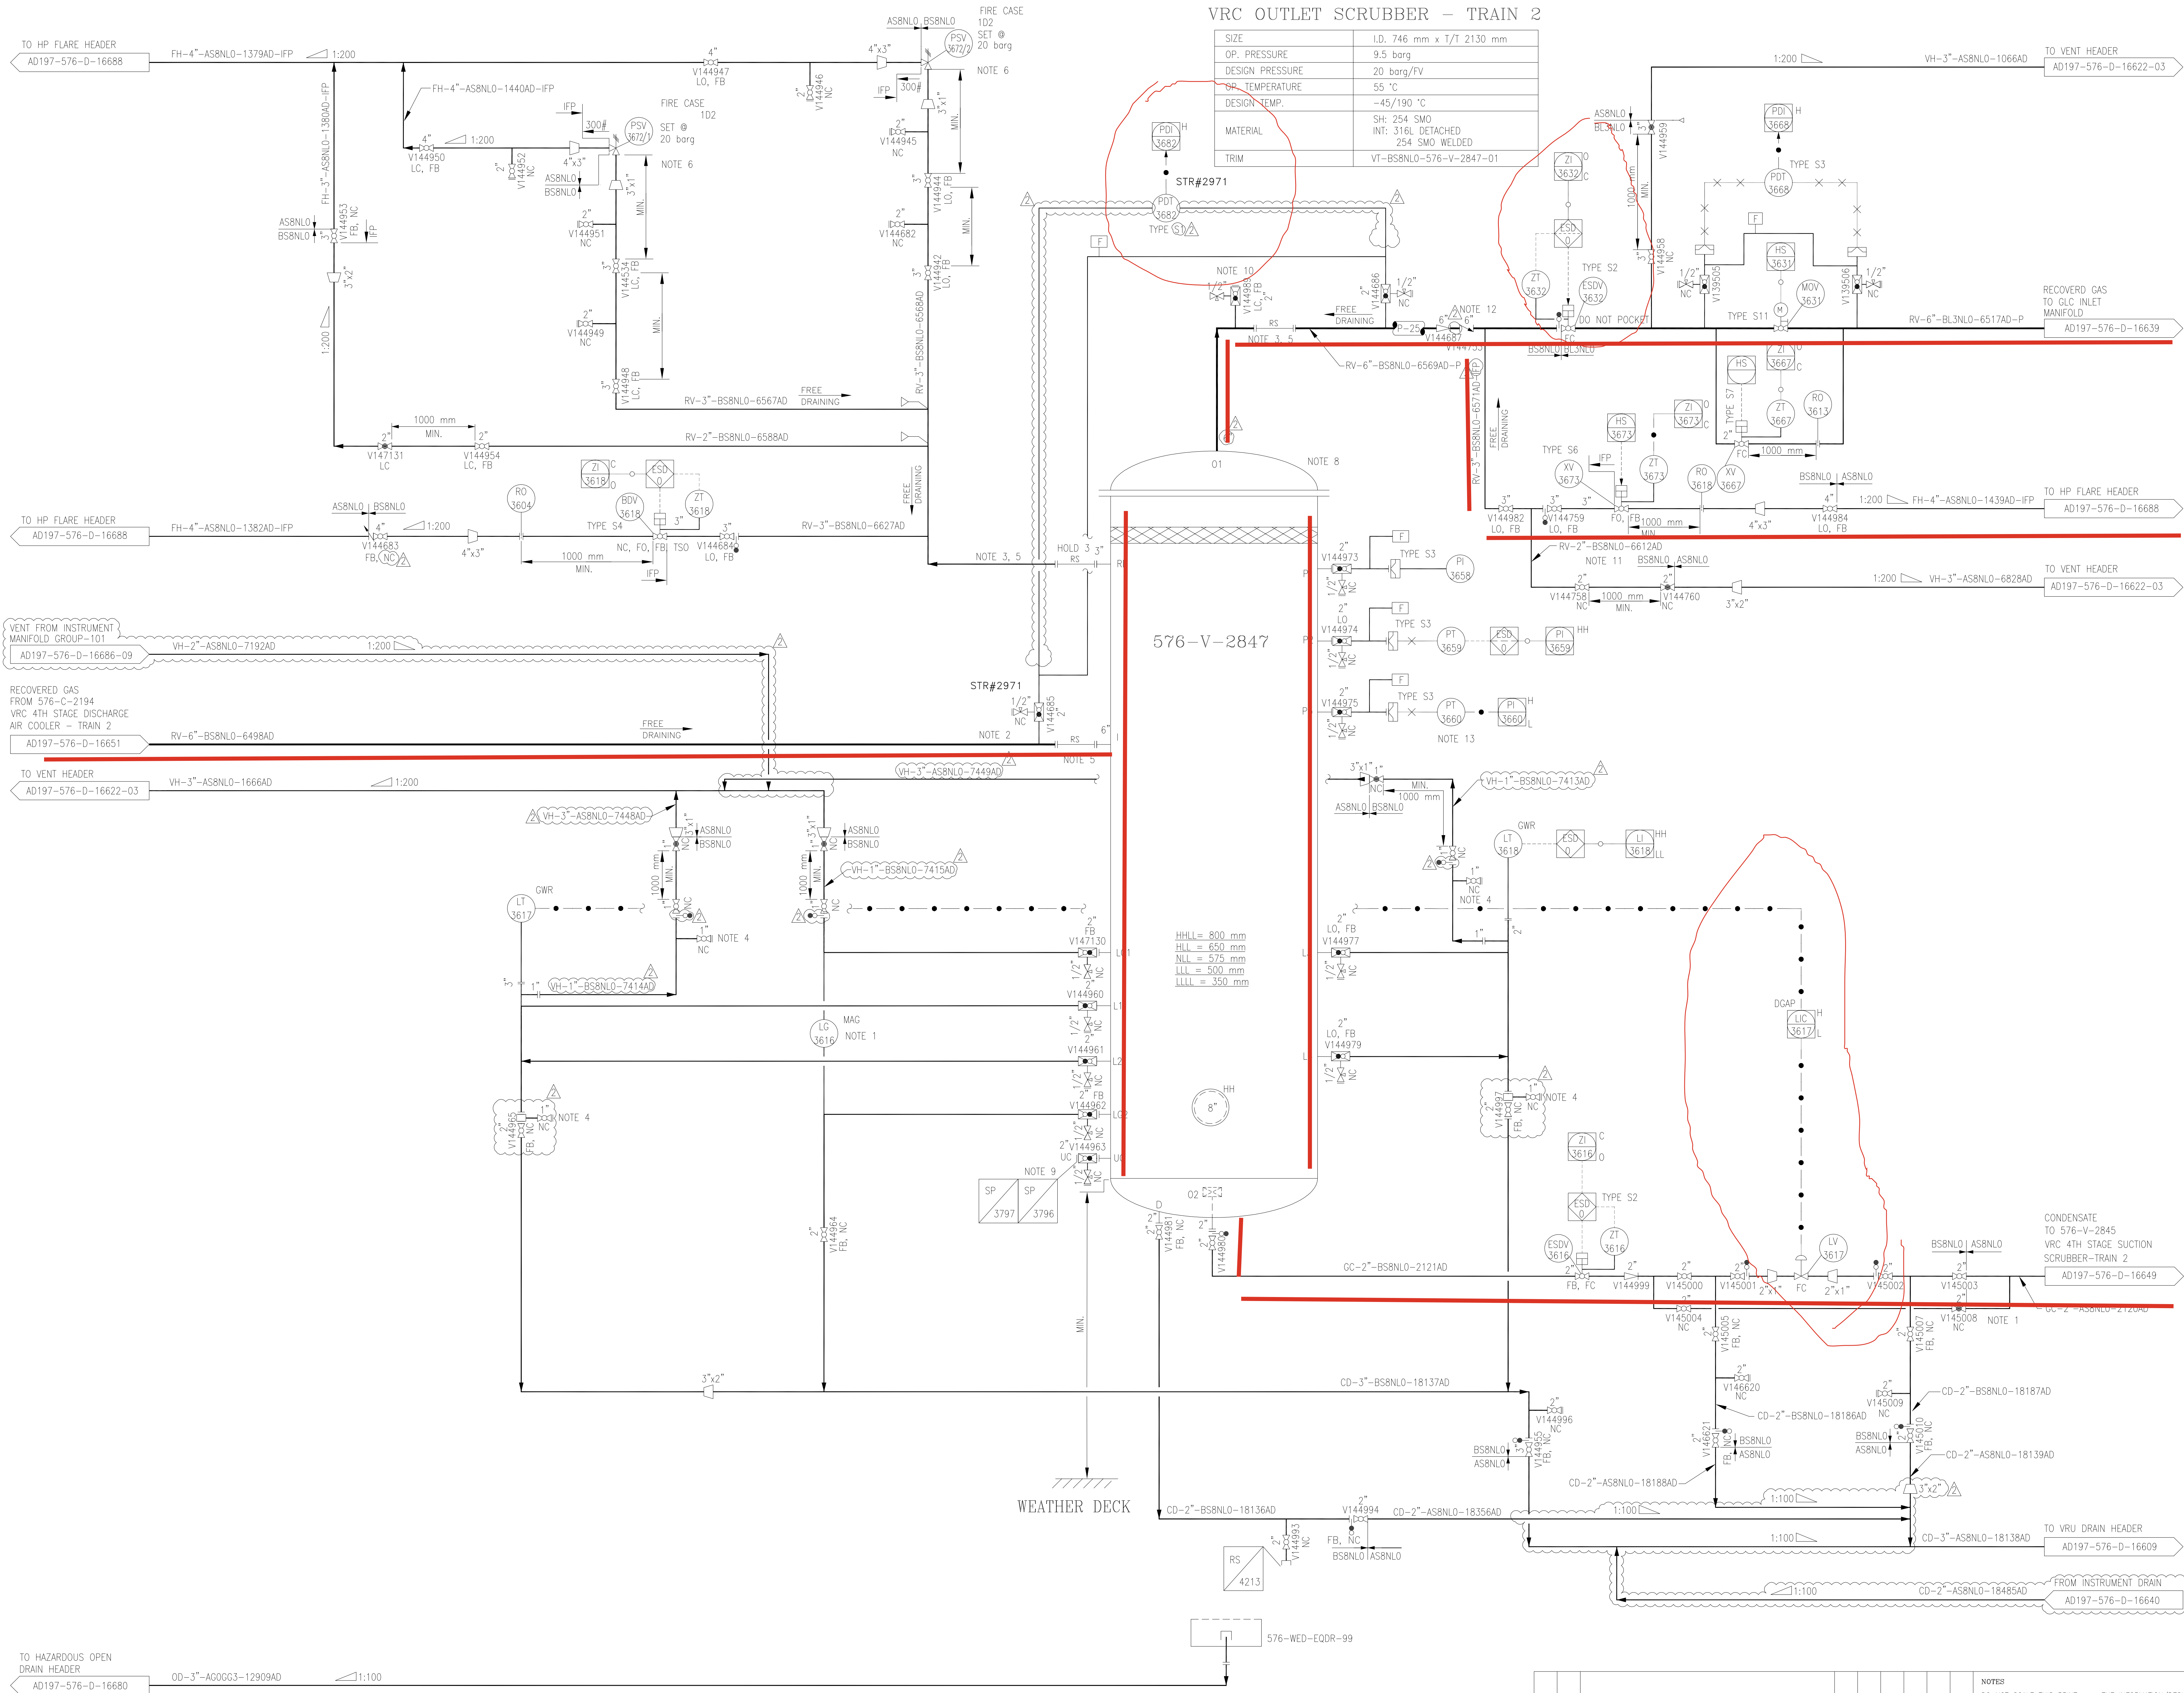

GENERAL NOTES:

- A. FOR GENERAL NOTES, SYMBOLS, ABBREVIATIONS AND TYPICALS, REFER TO DRAWING AD197-473-D-10500 TO 10508.
- B. ALL INSTRUMENT AND SPECIAL PIPING ITEM TAG NUMBERS TO BE PRECEDED BY THE AREA CODE 576 UNLESS INDICATED OTHERWISE.
- C. PERFORMANCE GUARANTEE OF THE COMPLETE VRU PACKAGE SHALL BE RESPONSIBILITY OF THE PACKAGE VENDOR.
- D. REV-0 OF THIS P&ID IS DEVELOPED FROM TRAIN-1 REV-0 P&IDs. REV-B&C OF THIS P&ID (TRAIN-2) WAS NOT ISSUED AS VRU SYSTEM TRAIN-1 & TRAIN-2 ARE IDENTICAL.

NOTES:

1. LEVEL GAUGE LG-3616 TO BE VISIBLE FROM GLOBE VALVE V145008.
2. 10D STRAIGHT LENGTH.
3. REMOVABLE SPOOL FOR INSPECTION AND MAINTENANCE.
4. 1" BALL VALVE WITH BLIND FLANGE SHOULD BE PROVIDED FOR IN SITU - CALIBRATION AND TESTING.
5. BLIND FLANGE TO ISOLATE THE PIPE UPSTREAM AND DOWNSTREAM OF REMOVABLE SPOOL TO BE PROVIDED IN THE WAREHOUSE.
6. BLIND FLANGE TO BE PROVIDED IN THE WAREHOUSE FOR PSV INLET/ OUTLET NOZZLE. TO BE USED WHEN THE RELIEF VALVE IS REMOVED.
7. DELETED
8. REMOVABLE TOP HEAD.
9. DEDICATED PORTABLE ASSEMBLY WITH FLANGE ADAPTOR CHECK VALVE AND QUICK HOSE CONNECTION TO BE PROVIDED IN WAREHOUSE.
10. PROVISION TO MEASURE H<sub>2</sub>S CONTENT BY PORTABLE DEVICE AFTER MAINTENANCE PURGING.
11. VENTING ARRANGEMENT DURING START-UP AND DURING STAND-BY CONDITION. XV-3673 WILL OPEN DURING START-UP IF PRESSURE REACHES 1.6 barg AND CLOSE IF PRESSURE REACHES 0.6 barg BASED ON THE PRESSURE READING ON PT-3607 ON FIRST STAGE COMPRESSOR SUCTION.
12. DISSIMILAR TYPE CHECK VALVES THESE ITEMS TO BE PLACED IN RS.D.
13. PT-3660 SIGNAL TO BE CONFIGURED IN DEDICATED DCS SCREEN FOR BDV-3618 PERFORMANCE TESTING TO MEASURE TIME BETWEEN OPERATING PRESSURE AND 100 Psig (6.9 BARG).
14. THE BALANCED BELLOWS TYPE BONNET VENT OF PRESSURE SAFETY VALVE SHALL BE ROUTED TO SAFE LOCATION WITHOUT CAUSING ANY BACK PRESSURE TO THE VALVE. REFER INSTRUMENT HOOK-UP DRAINING No. AD197-576-I-50338.
15. FOR PASSIVE FIRE PROTECTION INSULATION LIMITS, REFER PASSIVE FIRE PROTECTION REPORT AD197-473-G-07006.
16. THE COAT BACK OF INSULATION SHOULD BE EXTENDED OVER THE FLANGES AND 1m UPSTREAM SIDE OF THE VALVE.
17. DELETED
18. FOR INSTRUMENT VENTS FROM PT/PDT, REFER P&ID No. AD197-576-D-16621.

HOLDS:

1. DELETED.
2. DELETED.
3. DELETED.
4. DELETED.
5. DELETED.
6. DELETED.
7. DELETED.
8. DELETED.
9. DELETED.
10. DELETED.

UMM LULU PHASE II FULL FIELD DEVELOPMENT PROJECT PACKAGE 2  
UMM LULU SUPER COMPLEX AND SUBSEA COMPOSITE POWER CABLES

TECHNIP JOB No. 9451Y  
TECHNIP DRG. No. 9451Y-600-PID-0021-120  
DOC. CLASS 1

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BUDGET REF: EL02E  
TITLE: ULSC-UMM LULU GAS TREATMENT PLATFORM  
PIPING AND INSTRUMENTATION DIAGRAM  
ULGTP VRC 4TH STAGE DISCHARGE SCRUBBER-TR.2

DRG No. AD197-576-D-16652  
AREA SECTION NUMBER  
2

SCALE: NTS  
CAD FILE: AD197-576-D-16652-R2.DWG

ISSUE DATE	REMARKS	DESIGNER	SD	ENG	ENG	SNR	CDL
2 JUL 06 2017	ISSUED FOR CONSTRUCTION (IFC3)	RKV	PP	DG	RS		
1 NOV 03 2016	ISSUED FOR CONSTRUCTION (IFC2)	RK	APM	ER	CP	RS	
0 MAR 31 2016	ISSUED FOR CONSTRUCTION (IFC-1)	RK	APM	ER	CP	RS	

NOTES  
DO NOT SCALE THIS PRINT.  
ALL WORK TO BE CARRIED OUT IN ACCORDANCE WITH THE CONTRACT SPECIFICATION.  
EXPLANATIONS OF ABBREVIATIONS, SYMBOLS ETC ARE GIVEN IN ADMA-OPCOS CODES OF PRACTICE OP-00.  
FOR COMPLETE LIST OF DRAWINGS SEE DRAWING LIST No. AD197-SCH-10001

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