

KEYED PLAN NOTES (XX)

- SELF-SERVE DRINKS AND CONDIMENT STAND NOOK; REFER TO EQUIPMENT PLAN
- COUNTER TOP; REFERENCE SHEET A-1.1
- ELECTRIC SERVICE; REFER TO ELECTRICAL DRAWINGS
- SERVICE COUNTER PARTITION BY G.C.; REFER TO DETAILS ON TECHNOLOGY PLAN FOR ADDITIONAL INFORMATION; COORDINATE COUNTERTOP/FINISHES INSTALLATION RESPONSIBILITIES WITH THE DECOR SUPPLIER; MAXIMUM COUNTER HEIGHT = 32" A.F.F.
- MENU BOARD BULKHEAD ABOVE; REFER TO SECTION DRAWINGS AND REFLECTED CEILING PLAN
- INTERIOR WALK-IN BOX WITH FLOOR ON CONCRETE SLAB. VERIFY SIZE WITH MANUFACTURER. INSTALL ALTRO STRONGHOLD 30 SAFETY FLOORING
- LINE OF CANOPY/OVERHANG ABOVE
- ELECTRICAL PANEL LOCATION; RECESS ELECTRICAL CONTACTOR PANEL AND PANELS "A", "B" AND "M" IN FURRED OUT WALL ADJACENT TO EXTERIOR FRAMING; G.C. TO VERIFY PANEL SIZES PRIOR TO FURR-OUT TO INSURE ADEQUATE SPACE.
- STAINLESS STEEL PANEL BEHIND FRY DUMP, HOODS, CONTINUOUS BETWEEN HOODS AND SUPPLIED BY G.C. AND INSTALLED BE G.C. +/- 24'-0"
- CAN WASH; DUROCK SUBSTRATE ON ALL SIDES, FLOOR TO CEILING
- INDICATES 5/8" PLYWOOD BACKING ON WALLS FOR EQUIPMENT AS INDICATED ON PLAN OR SHELF SUPPORT FROM 48" A.F.F. TO 96" A.F.F. BEHIND 3-COMPARTMENT SINK AND PREP SINK AND ON BULKHEAD AT MENU BOARD WALL FROM 7'-0" A.F.F. TO BOTTOM OF ROOF TRUSSES.
- DROP PORTION OF SERVICE COUNTER TO ALLOW FOR THE INSTALLATION OF RECESSED HEATED SHELVING UNIT; COORDINATE REQUIRED WIDTH AND HEIGHT OF RECESS WITH EQUIPMENT SUPPLIER
- PROVIDE CONTINUOUS INSULATION AT DRIVE-THRU COLUMNS; REFER TO SHEET A-1.2

GENERAL PLAN NOTES

- EXTERIOR DIMENSIONS ARE TO FACE OF SHEATHING; INTERIOR DIMENSIONS ARE TO STUD
- OVERALL DIMENSIONS TO EXTERIOR WALLS ARE THE SAME AS TO THE OUTSIDE FACE OF FOUNDATION WALL BELOW
- ALL ANGLED WALLS ARE AT 90° UNLESS NOTED OTHERWISE
- FIRE EXTINGUISHER SHALL COMPLY WITH ALL APPLICABLE BUILDING CODES AND LOCAL RESTRICTIONS
- ELEVATION OF DRIVE-THROUGH LANE 2" (MAXIMUM) BELOW FINISH FLOOR ELEVATION; DRIVE-THROUGH LANE AT SAME ELEVATION AS FINISH FLOOR IS PREFERRED; REFER TO SECTION DRAWINGS
- PROVIDE CORNER GUARDS AT ALL OUTSIDE KITCHEN CORNERS AND WALL ENDS; REFER TO SHEET A-1.1
- PROVIDE ADDITIONAL BLOCKING IN WALLS BEHIND PLUMBING FIXTURES FOR SUPPORT OF WATER LINES, TYP.
- ALL WALLS AT EXPOSED TRUSSES TO BE FRAMED AND FINISHED TO THE ROOF DECK, TYP.
- SUBSTRATE PANELS:
KITCHEN - CREW - RESTROOMS:
5/8" USG "DUROCK" PANELS AT FINISH FLOOR TO 24" A.F.F.
5/8" WATER RESISTANT GYPSUM BOARD FROM 24" A.F.F. TO 6" ABOVE FINISHED CEILING
- DINING ROOM & SERVICE AREA:
5/8" PLYWOOD FROM FINISH FLOOR TO 36" A.F.F.
5/8" TYPE USG "SHEETROCK" GYPSUM WALL BOARD FROM 36" TO 6" ABOVE CEILING
- PROVIDE SOUND ATTENUATION BATT INSULATION IN ALL RESTROOM AND OFFICE WALLS TO UNDERSIDE OF ROOF DECK ABOVE, TYP.

CLS# 211

BK# 3857

No.	Description	Date
3	REVISED	5/10/23
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2	REVISED	4/20/23
1	REVISED	4/3/23
-	ISSUED FOR BID	3/22/23

△ - REVISIONS

BURGER KING
SIZZLE PROTOTYPE
MARION, NORTH CAROLINA

CARROLLS, LLC
SYRACUSE, NEW YORK








FLOOR PLAN



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Date: 2/23/2023
DrawnBy: CJP
CheckedBy: PJM
Job Number: 22083A

Drawing No.
A-1.0

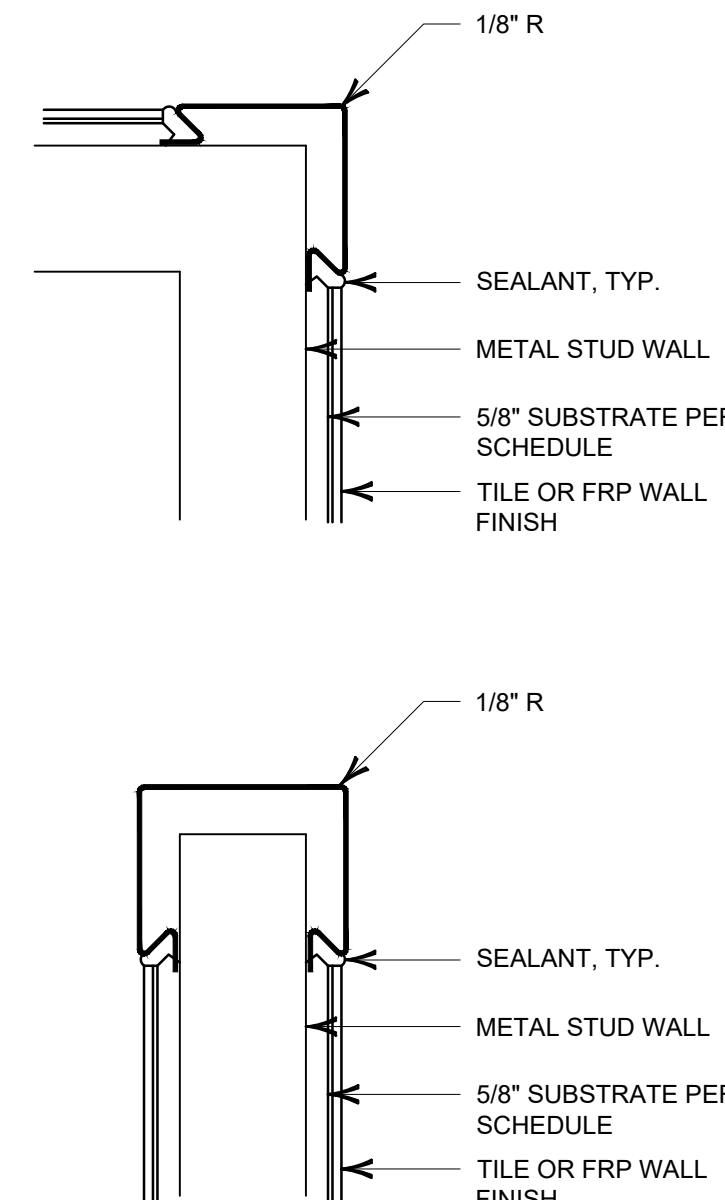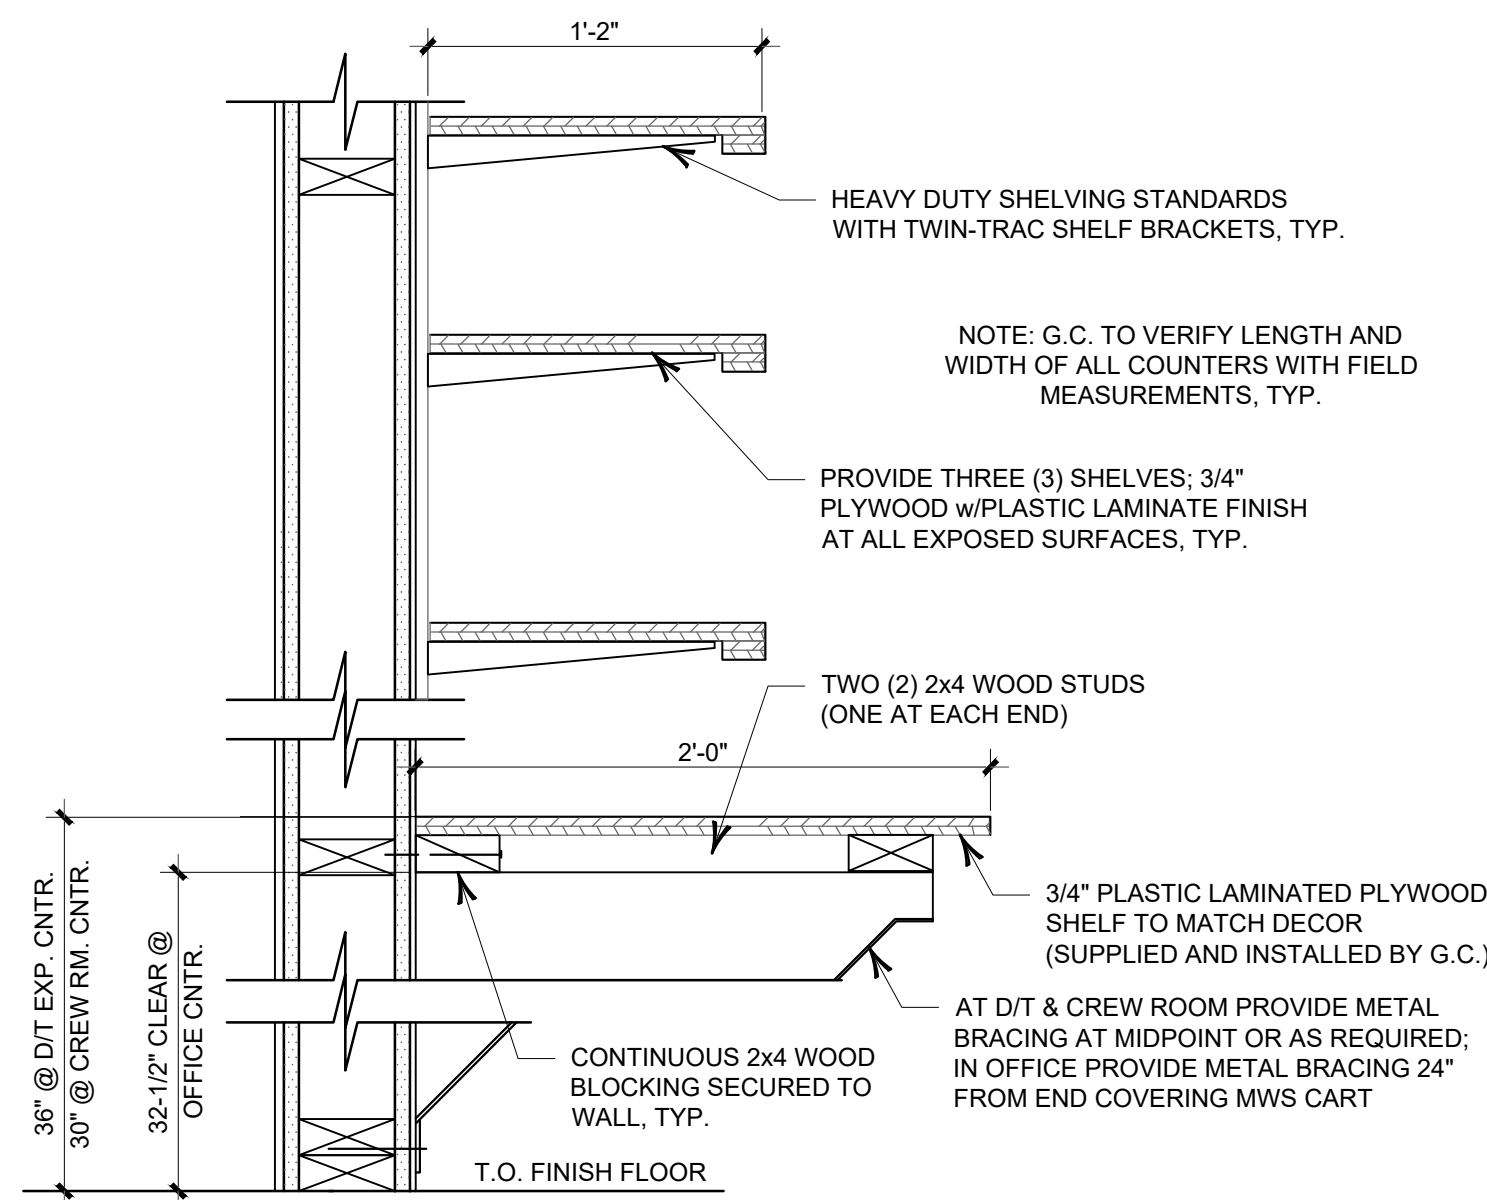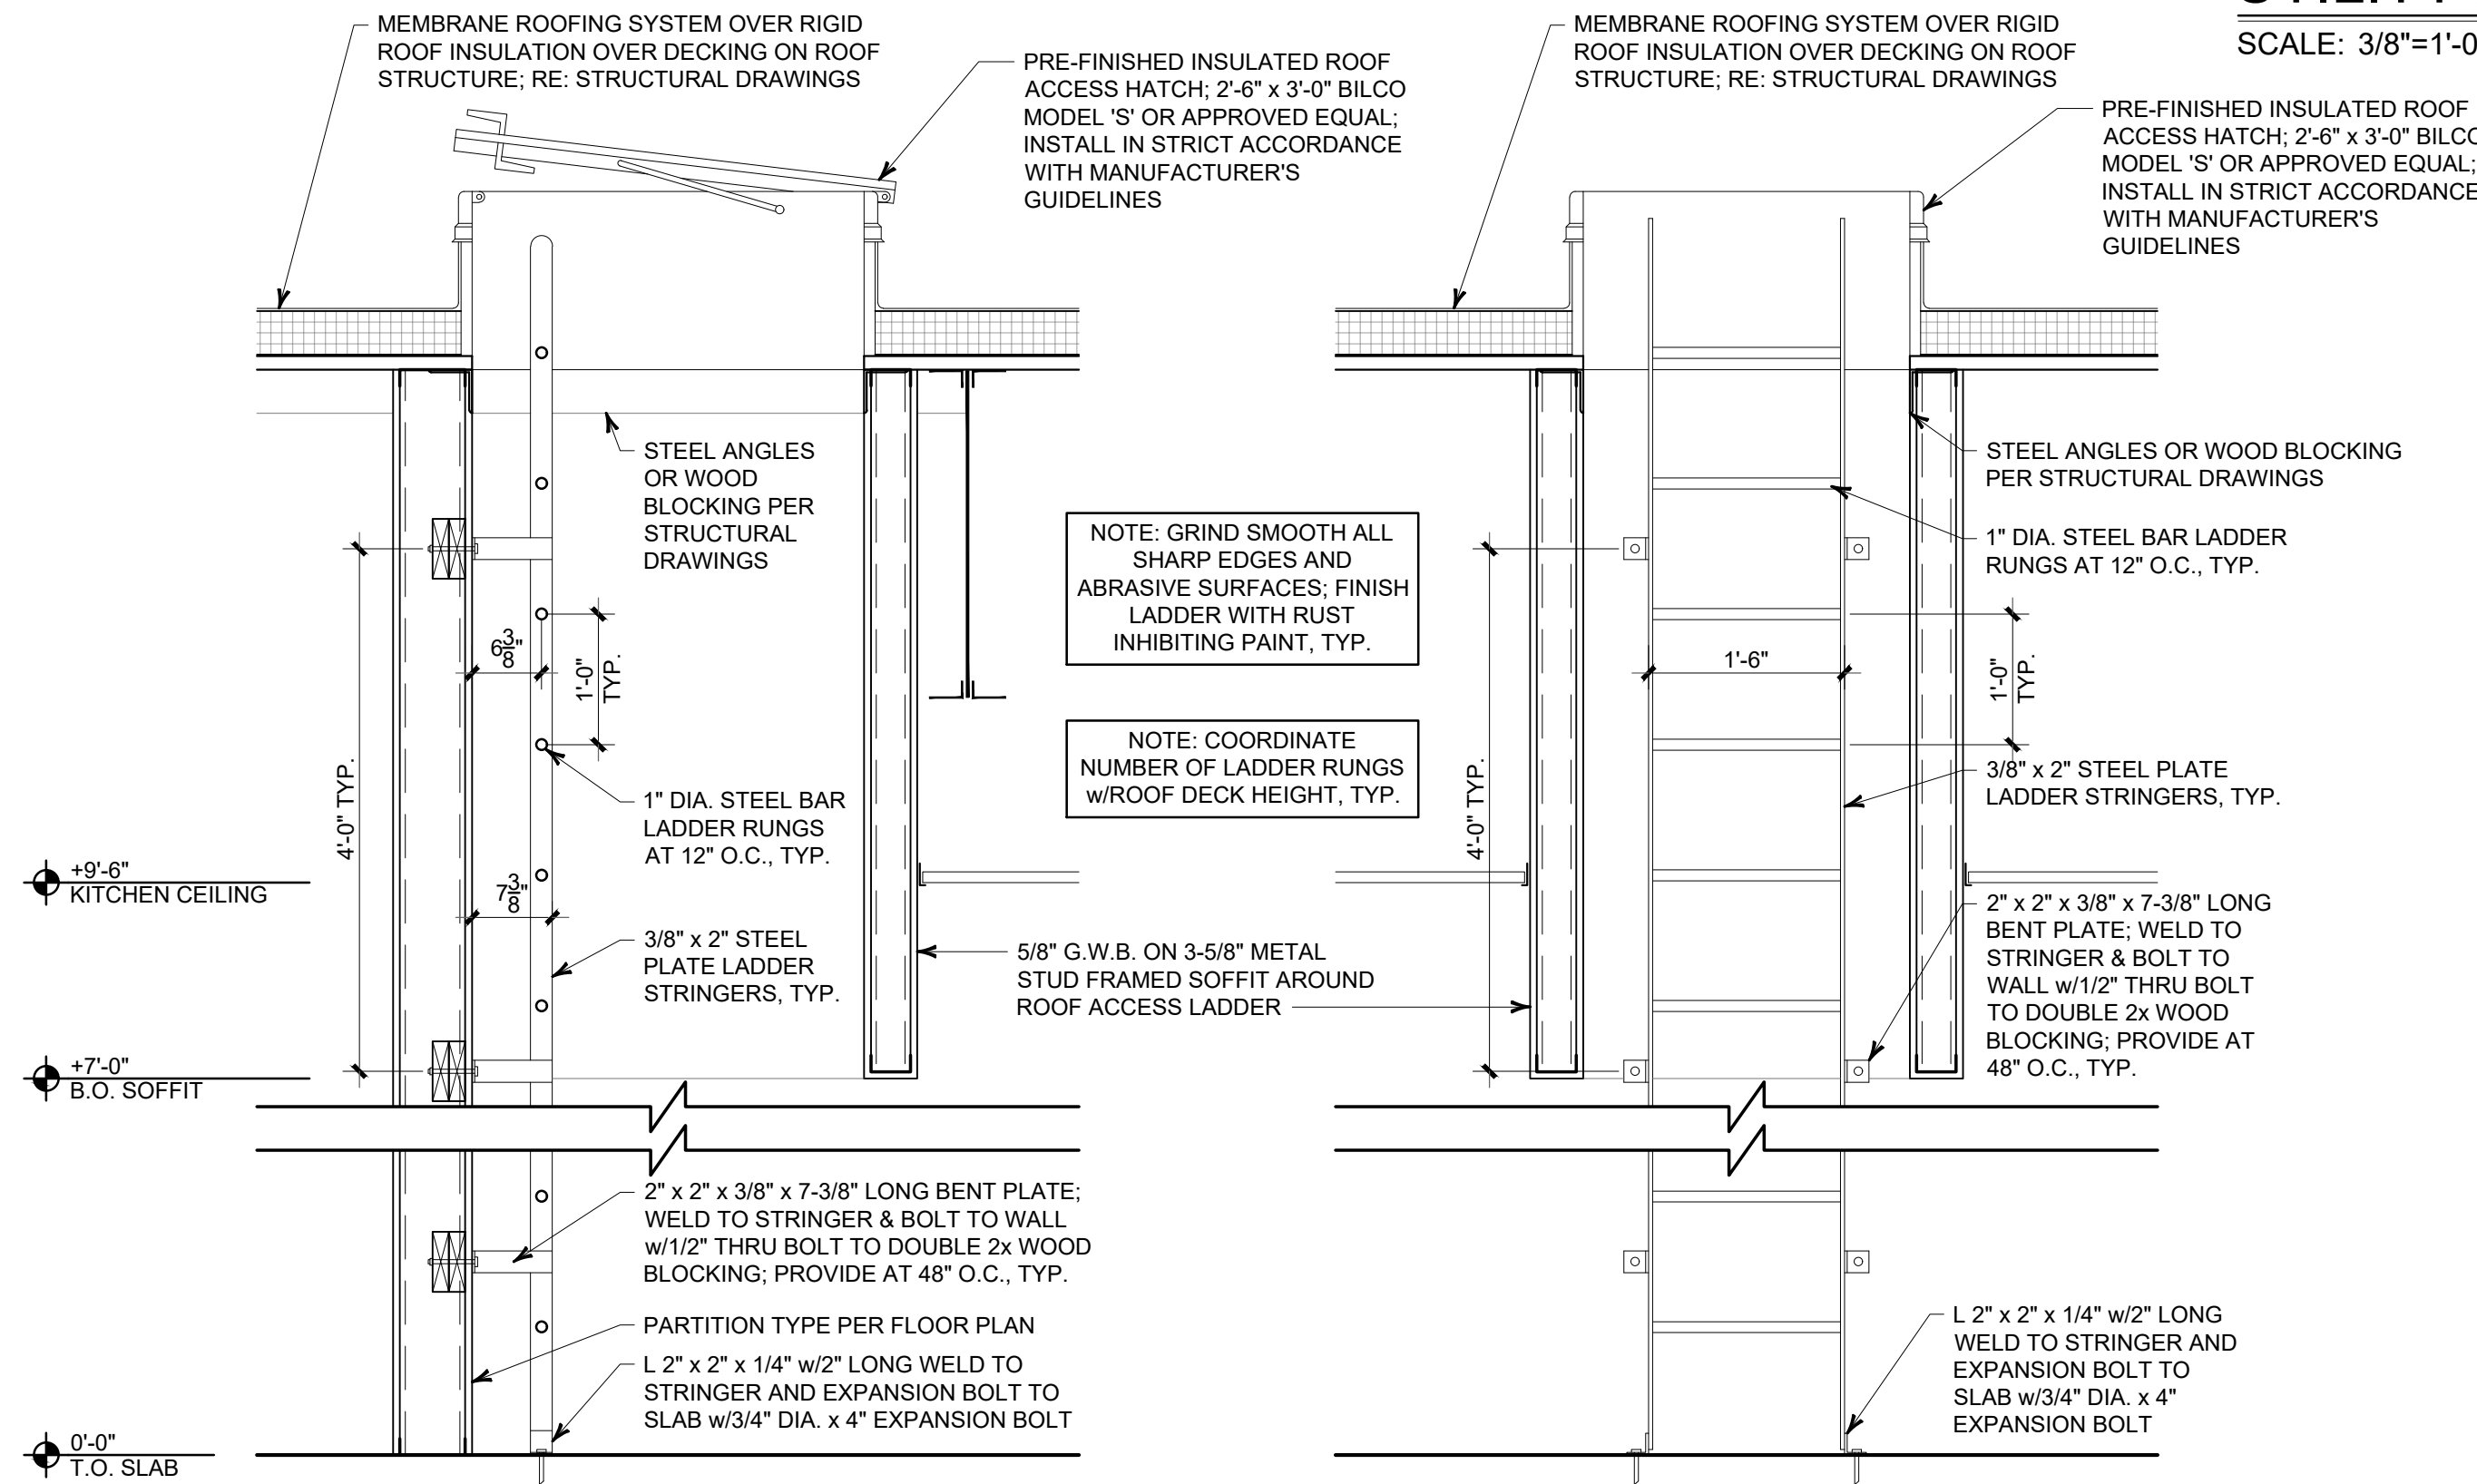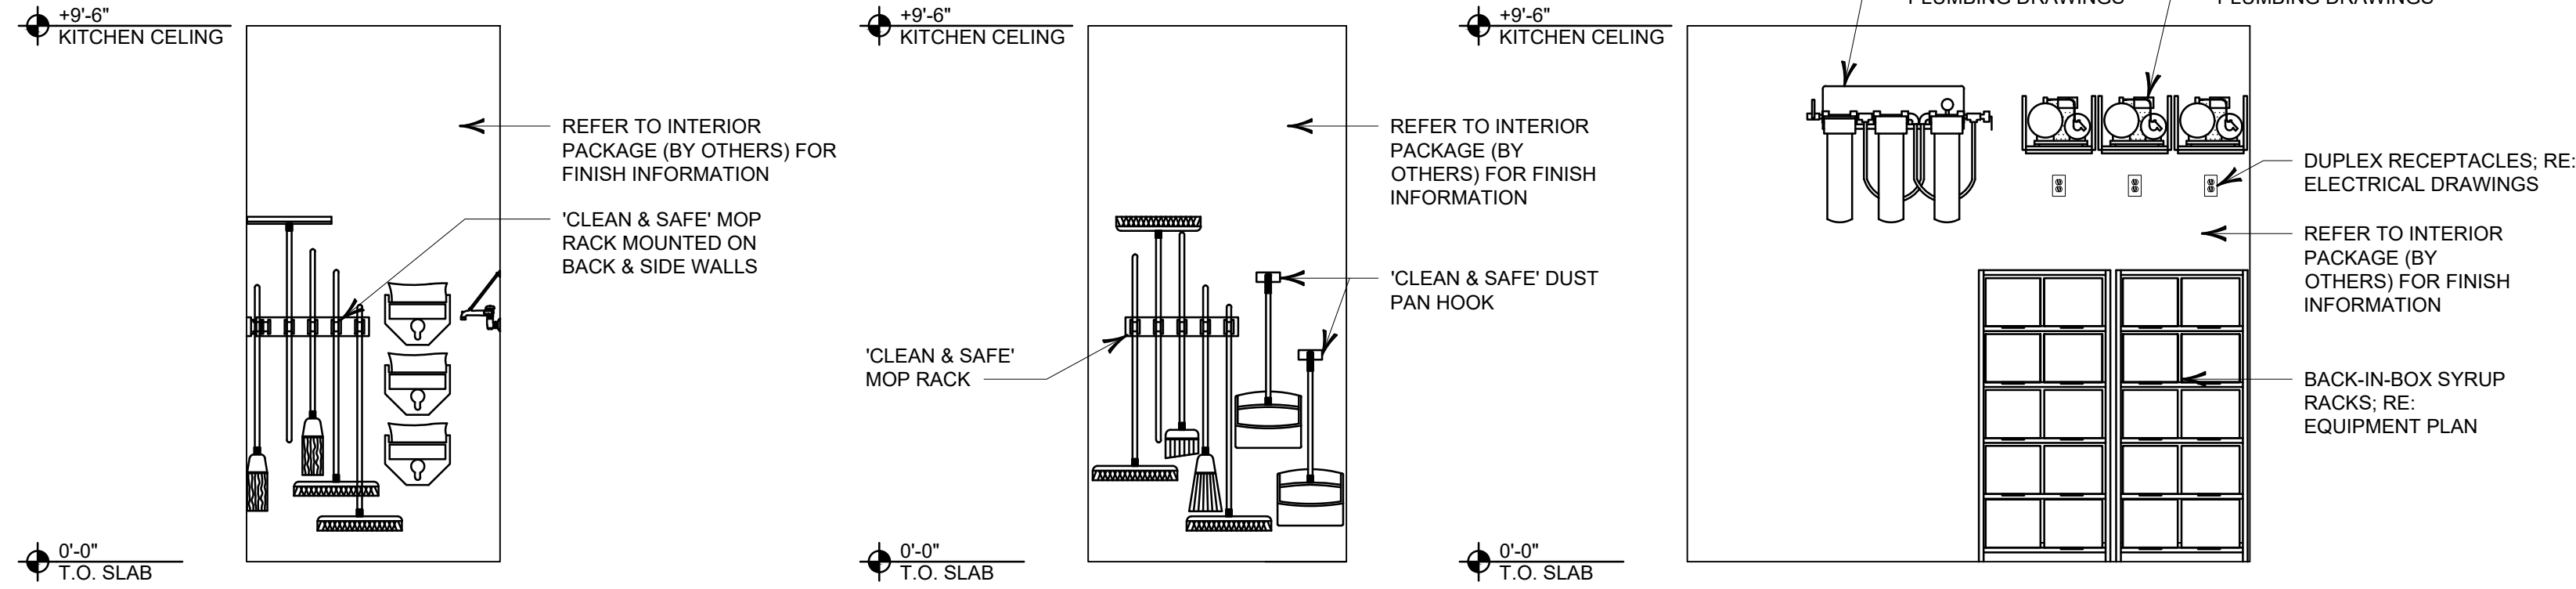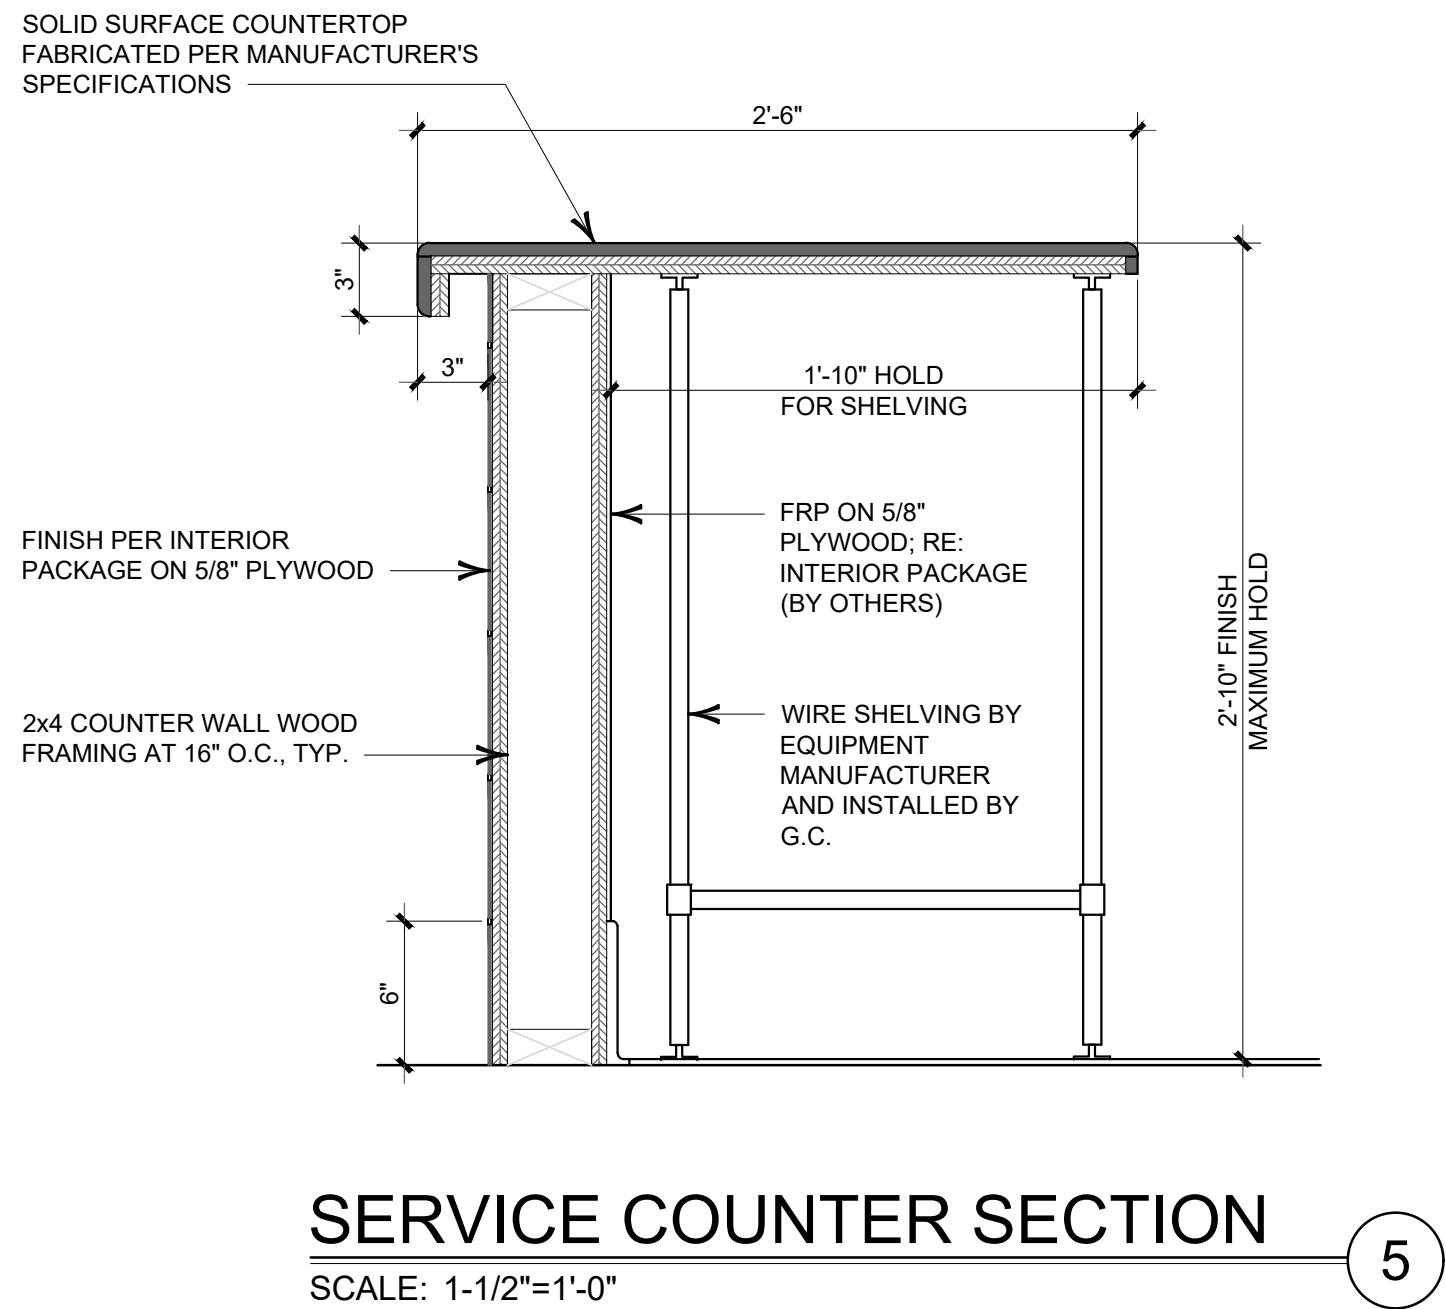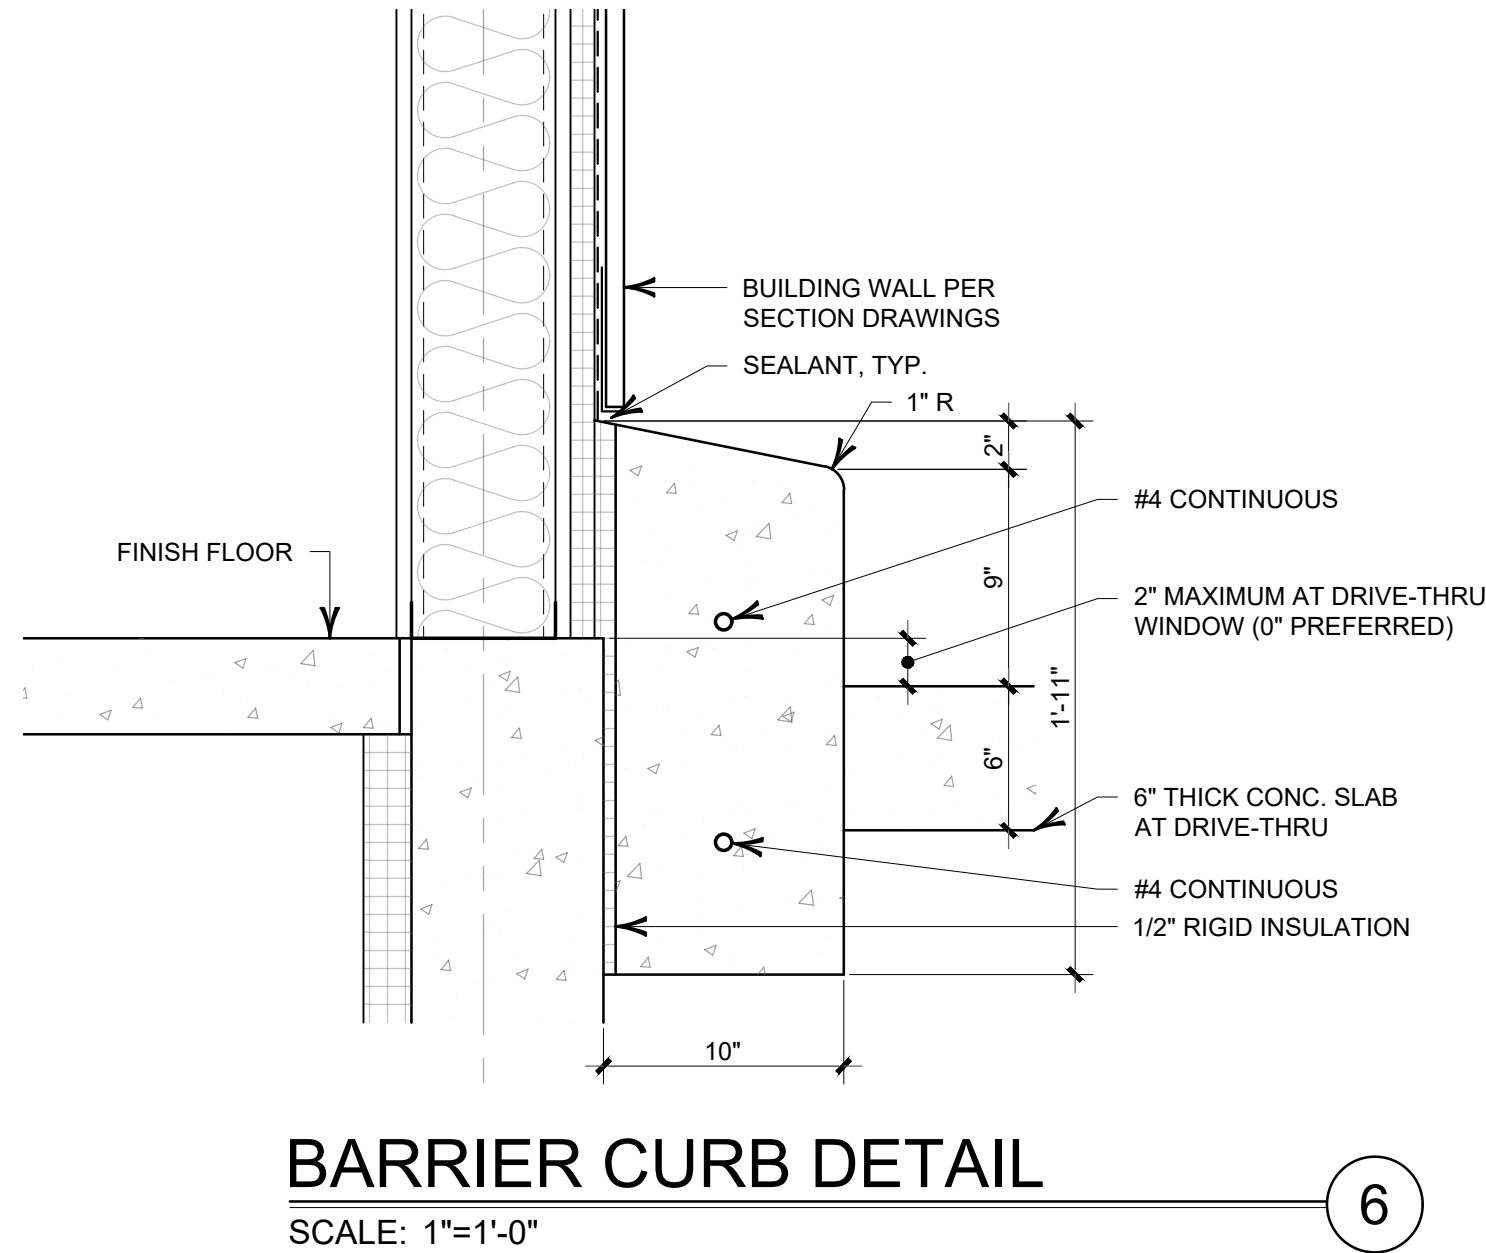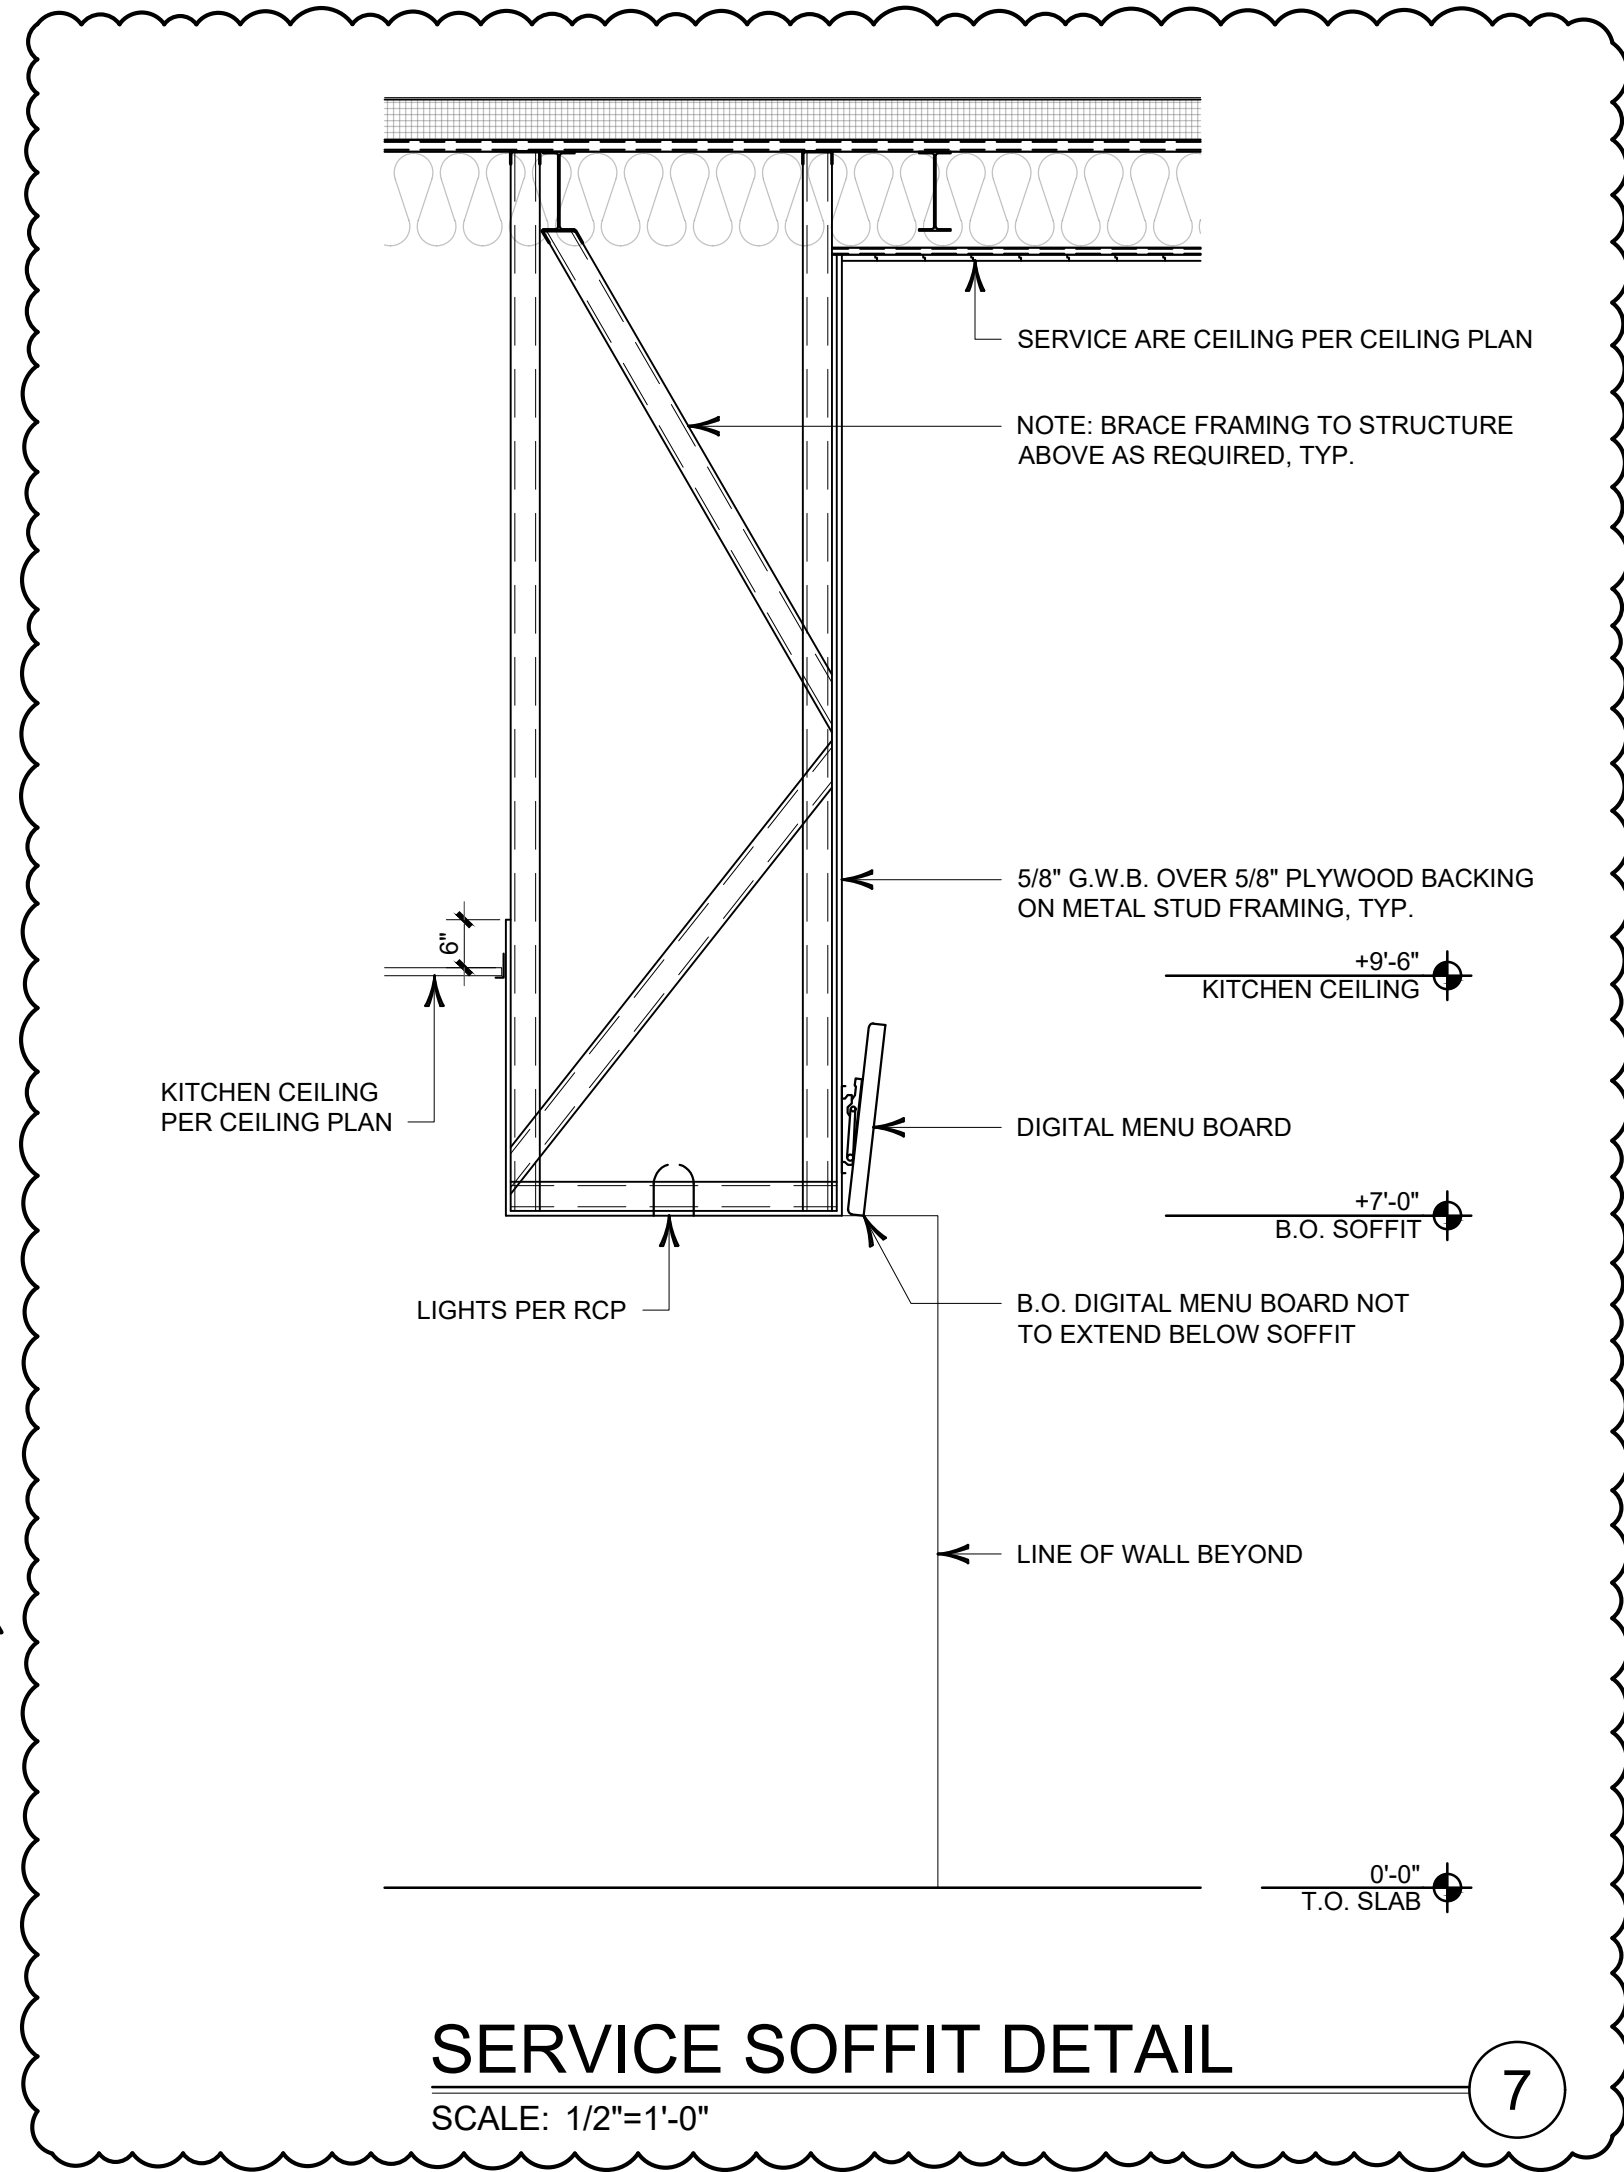

CLS# 211 BK# 3857


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**BURGER KING
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**MISCELLANEOUS
DETAILS**




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GENERAL RESTROOM NOTES:

1. RESTROOM WALL FINISHES NOT SHOWN FOR CLARITY; FOR INTERIOR FINISHES, REFER TO INTERIOR DECOR SHEETS (BY OTHERS)
2. PLUMBING FIXTURES TO BE PROVIDED BY THE GENERAL CONTRACTOR.
3. ALL PLUMBING FIXTURES, FAUCETS AND ACCESSORIES TO BE A-D-A COMPLIANT
4. ALL FIXTURES, FAUCETS, ACCESSORIES, ETC., TO BE COORDINATED WITH M-E-P DRAWINGS, INTERIOR DECOR SHEETS (BY OTHERS) AND SHALL BE APPROVED BY THE OWNER, TYP.
5. ALL EXPOSED PIPING UNDER LAVATORIES TO BE INSULATED TO PROTECT FROM CONTACT. THERE SHALL BE NO SHARP OR ABRASIVE SURFACES UNDER LAVATORIES.
6. DUE TO TIGHT CLEARANCES, G.C. IS REQUIRED TO LAYOUT RESTROOMS CONSIDERING ALL FINISHES AND TO REPORT ANY DISCREPANCIES TO THE ARCHITECT IMMEDIATELY. CONTRACTOR IS TO ENSURE THAT FIXTURES AND ACCESSORIES DO NOT INTERFERE WITH REQUIRED A-D-A CLEARANCES, TURNING RADII, DOOR SWING CLEARANCES, ETC., TYP.
7. DIMENSIONS ON ENLARGED RESTROOM PLANS ARE CLEAR FROM FACE OF BASIC WALL FINISH

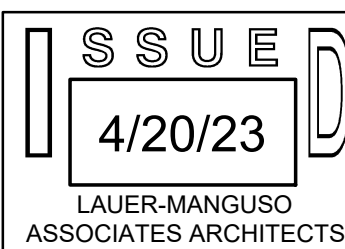


RESTROOM SIGN DETAIL

SCALE: 1/2"=1'-0"

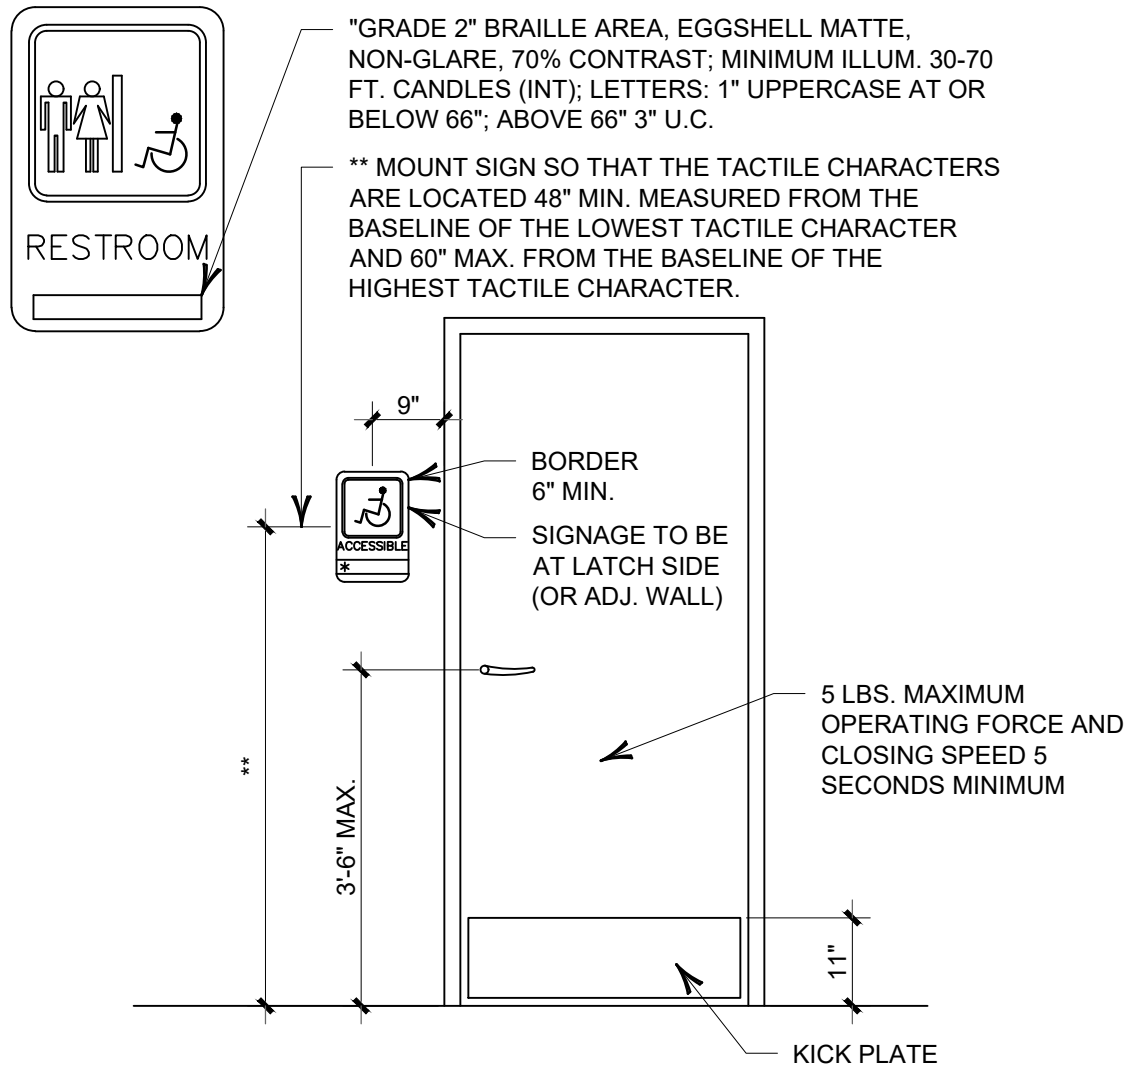
RESTROOM ACCESSORIES:

- A. GRAB BARS: BOBRICK 250 LBF. MINIMUM; HORIZONTAL BARS - 33"MIN TO 36" MAX. HEIGHT TO THE TOP OF THE GRIPPING SURFACE; VERTICAL BAR - 39" MIN. TO 41" HEIGHT TO THE BOTTOM OF BAR; PROVIDE THE REQUIRED QUANTITY AND LENGTH AS INDICATED ON THE DRAWINGS OR AS REQUIRED BY THE GOVERNING CODE; THE BAR SHALL BE 1-1/2" IN DIAMETER AND MOUNTED WITH 1-1/2" CLEARANCE FROM THE WALL.
- B. WALL MOUNTED SOAP DISPENSER AND HAND SANITIZER DISPENSER (36" MAX. HEIGHT) SUPPLIED BY "ECOLAB" AND INSTALLED BY THE G.C.; NOTE: SOAP AND HAND SANITIZER DISPENSERS TO BE PROVIDED AT EACH KITCHEN HAND SINK.
- C. MIRROR: (BOTTOM OF REFLECTIVE SURFACE AT 40" MAXIMUM HEIGHT) MODEL B-165-1836 (18"x36") STAINLESS STEEL CHANNEL FRAME MIRROR WITH THEFT RESISTANT SCREWS BY BOBRICK OR APPROVED EQUIVALENT.
- D. TOILET PAPER HOLDER; 9" TWIN JUMBO MODEL #58250 BY NORTH AMERICAN CORPORATION.
- E. PAPER WASTE RECEPTACLE: (REQUIRED) MODEL B-3644 AS MANUFACTURED BY BOBRICK OR APPROVED EQUIVALENT. (ROUGH OPENING 16"W x 29-1/4"H x 4"D MIN.)
- F. ELECTRIC HAND DRYER: EXCEL DRYER MODEL XL-W MOUNTED ON SOLID SURFACE; NOTE: HAND DRYER TO BE INSTALLED AT A MAXIMUM HEIGHT OF 48" FROM FINISH FLOOR ELEVATION TO TOP OF SENSOR OR PER A-D-A REQUIREMENTS; NOTE: PROVIDE PAPER TOWEL DISPENSER "SAN JAMAR" MODEL #T-1490BK AT EACH HAND SINK IN KITCHEN.
- G. TOILET SEAT COVER DISPENSER: BY ROCHESTER MIDLAND CORP. PRODUCT CODE 25132000 (WHITE PLASTIC) - OPTIONAL / VERIFY WITH OWNER (NOT SHOWN)
- H. SANITARY NAPKIN DISPOSAL: BOBRICK CONTRA SERIES B-270, SURFACE MOUNTED (NOT SHOWN)
- I. COAT HOOK: BOBRICK MODEL B-6717 TO BE MOUNTED ON INSIDE OF EACH RESTROOM DOOR FOR SINGLE OCCUPANCY RESTROOMS.; MOUNT AT 38"-40" A.F.F. FOR A-D-A ACCESSIBLE LOCATIONS AND AT 48" A.F.F. MAXIMUM FOR NON-A-D-A ACCESSIBLE LOCATIONS.
- J. WALL MOUNTED HORIZONTAL BABY CHANGING TABLE; KOALA KARE 'KB200' OR APPROVED EQUAL; COLOR AS SELECTED BY OWNER.
- K. INSTALL STEEL LAVATORY CONCEALED ARM CARRIER BY ZURN AT ALL RESTROOM LAVATORIES; MODEL #Z1231-F/AM-0124.024. (NOT SHOWN)
- L. CUSTOM CORIAN SINK SUPPORTED BY 3-1/2"W X 24" H 1/8" MTL. PL. SCREWED TO STUDS w/1-1/8" STEEL TUBES FOR SUPPORT, ALL WELDED; NOTE: PROVIDE SELF CLOSING FAUCETS IN RESTROOMS; SELF-CLOSING FAUCETS ARE ALLOWED IF THE FAUCET REMAINS OPEN FOR AT LEAST 10 SECONDS
- M. WATER CLOSET; AMERICAN STANDARD 'MADERA FLOWSIE' 16-1/2" HEIGHT, 1.6 GPF FLUSHOMETER TOILET SYSTEM

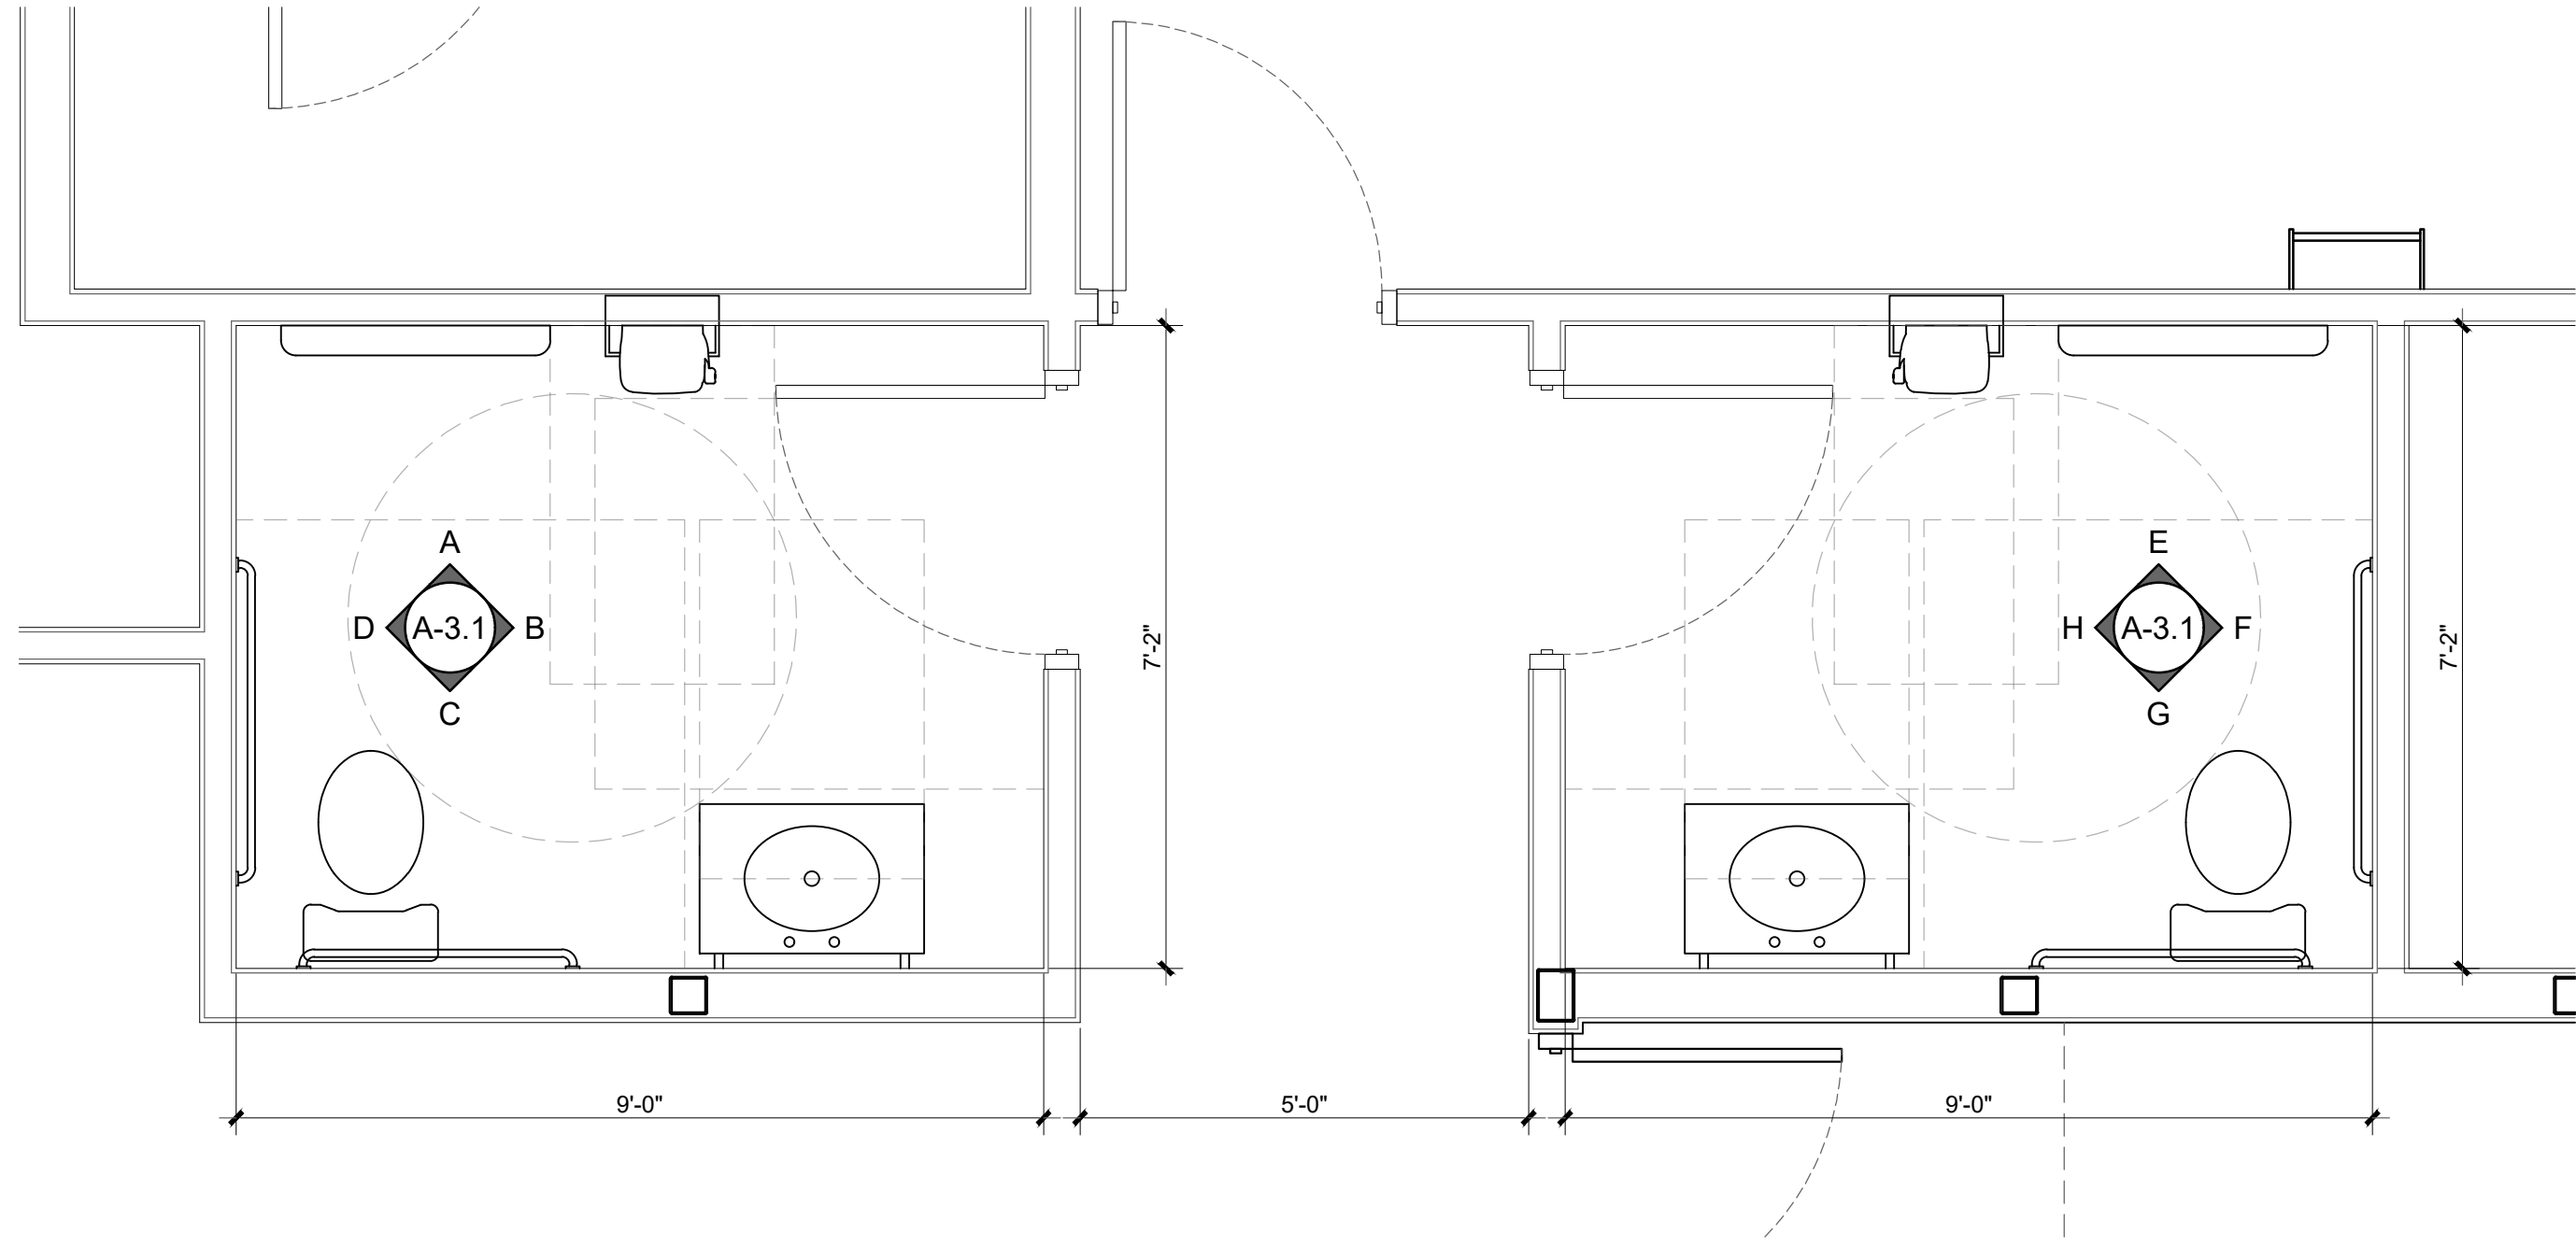


ENLARGED RESTROOM PLANS

SCALE: 1/2"=1'-0"

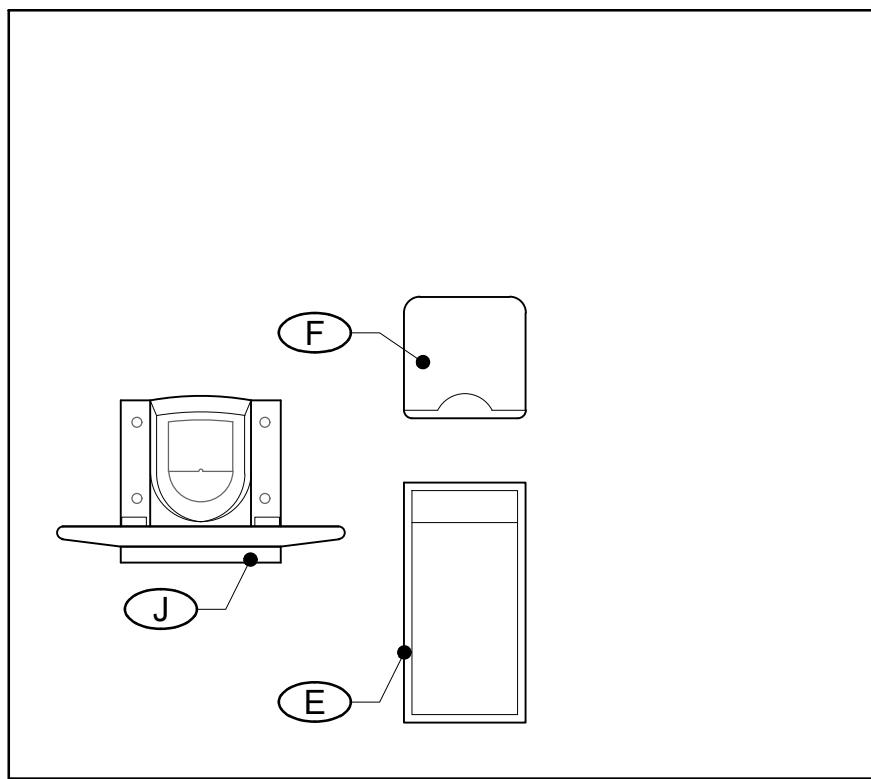


ELEVATION

SCALE: 1/2"=1'-0"

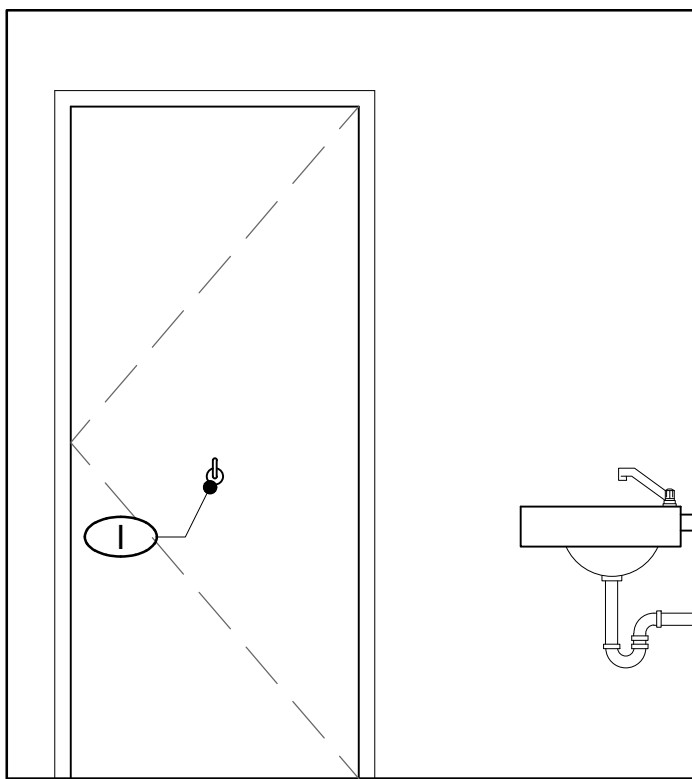


ELEVATION

SCALE: 1/2"=1'-0"

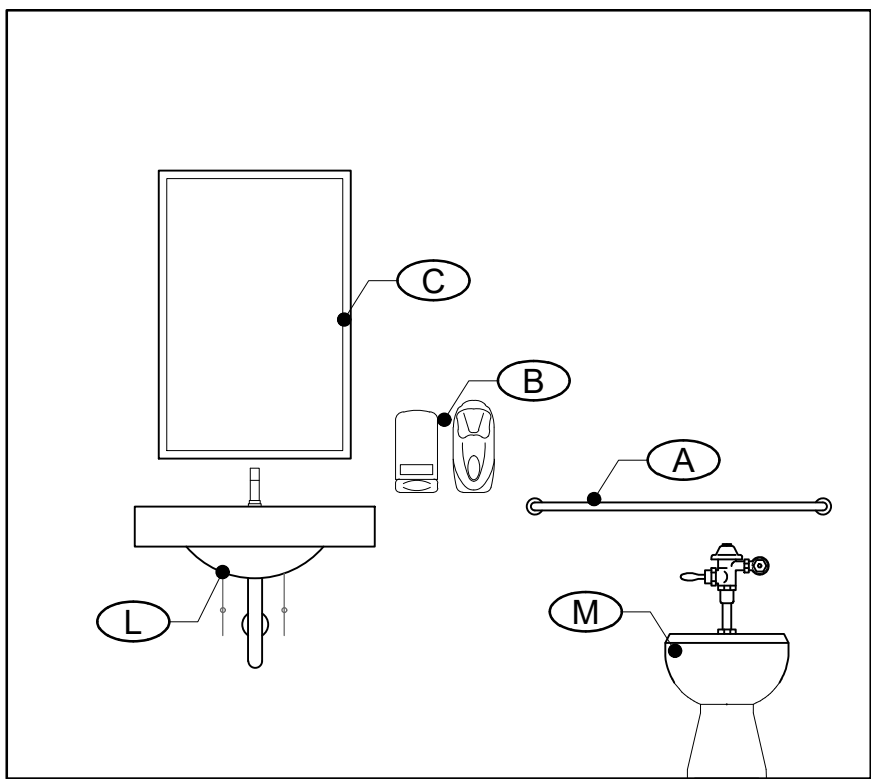


ELEVATION

SCALE: 1/2"=1'-0"

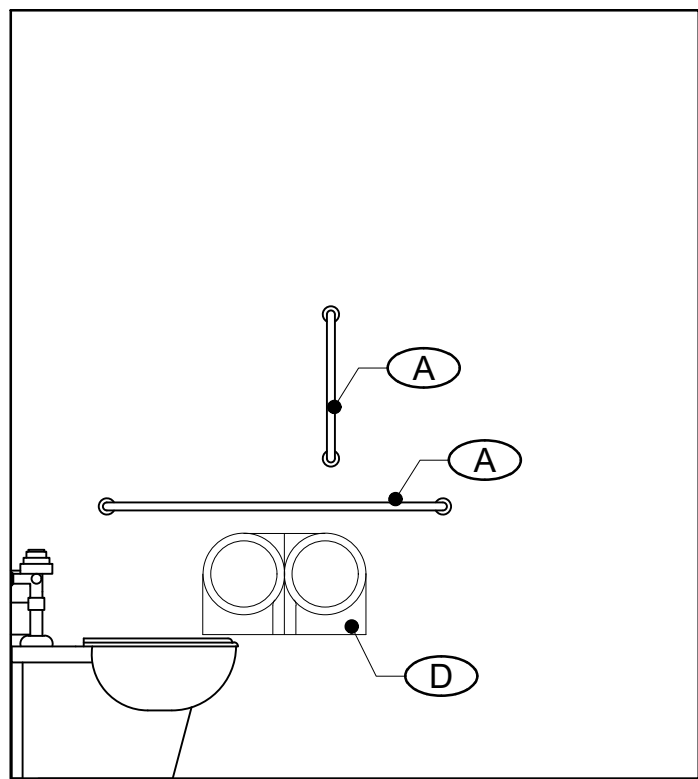


ELEVATION

SCALE: 1/2"=1'-0"

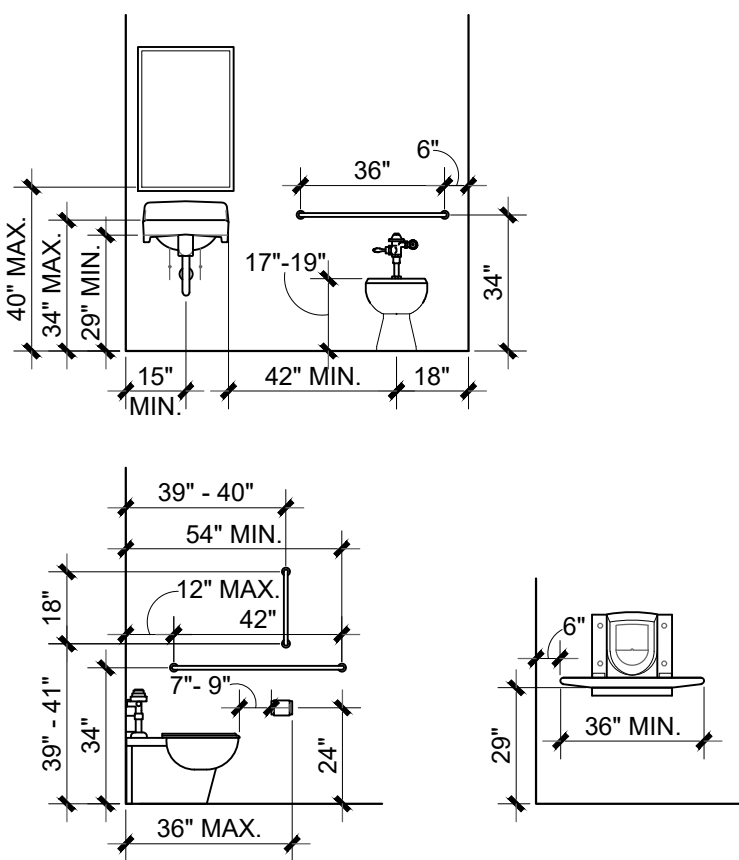


TYP. FIXTURE MOUNTING HEIGHTS

SCALE: 1/2"=1'-0"

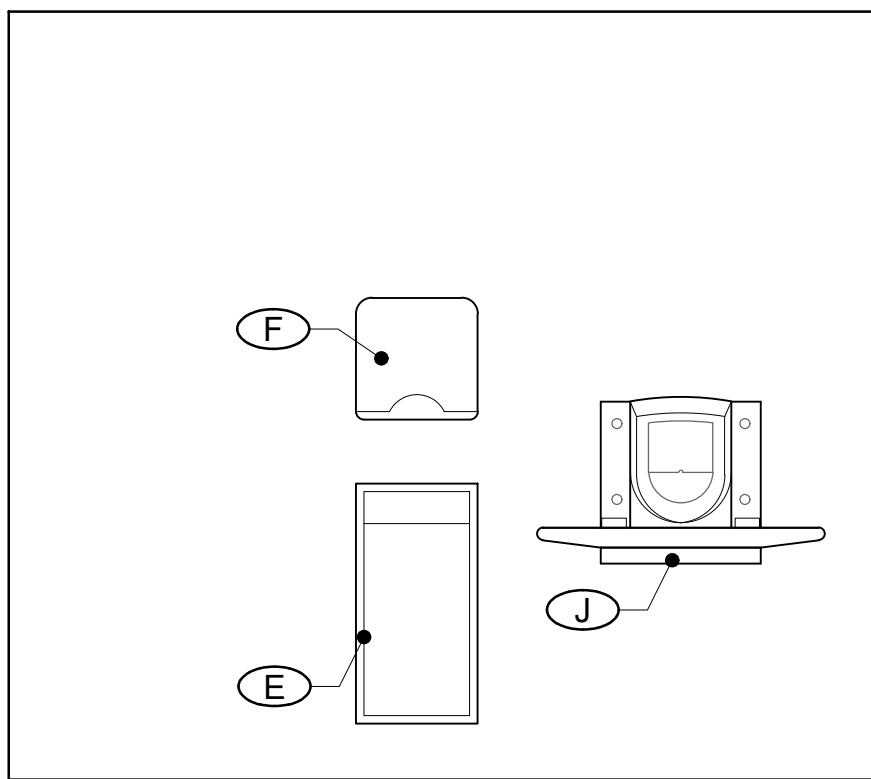


ELEVATION

SCALE: 1/2"=1'-0"

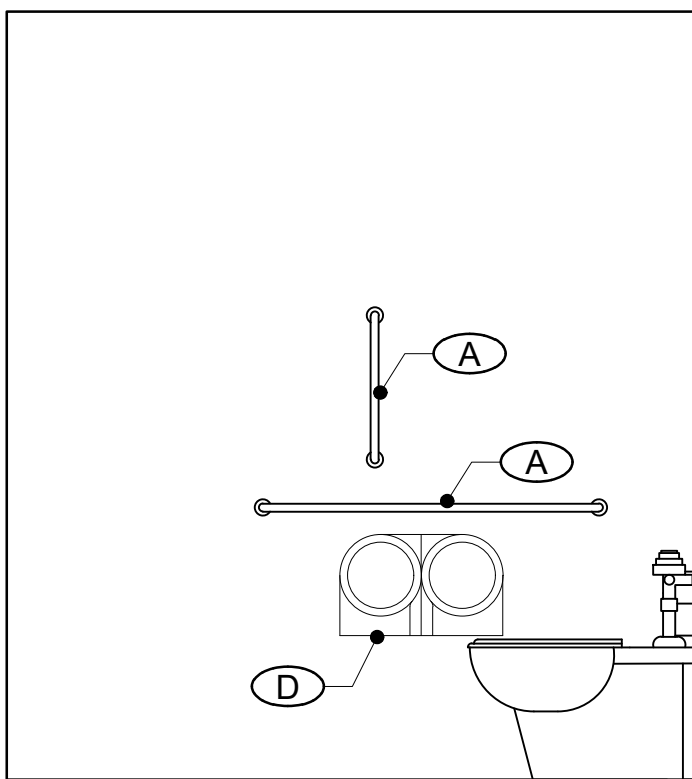


ELEVATION

SCALE: 1/2"=1'-0"

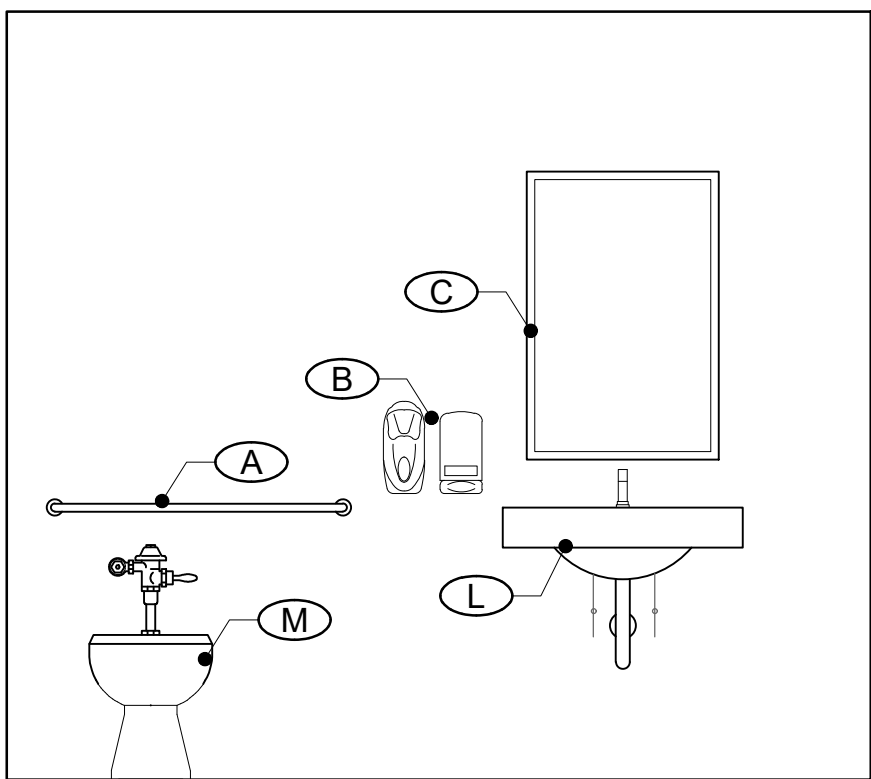

ELEVATION

SCALE: 1/2"=1'-0"

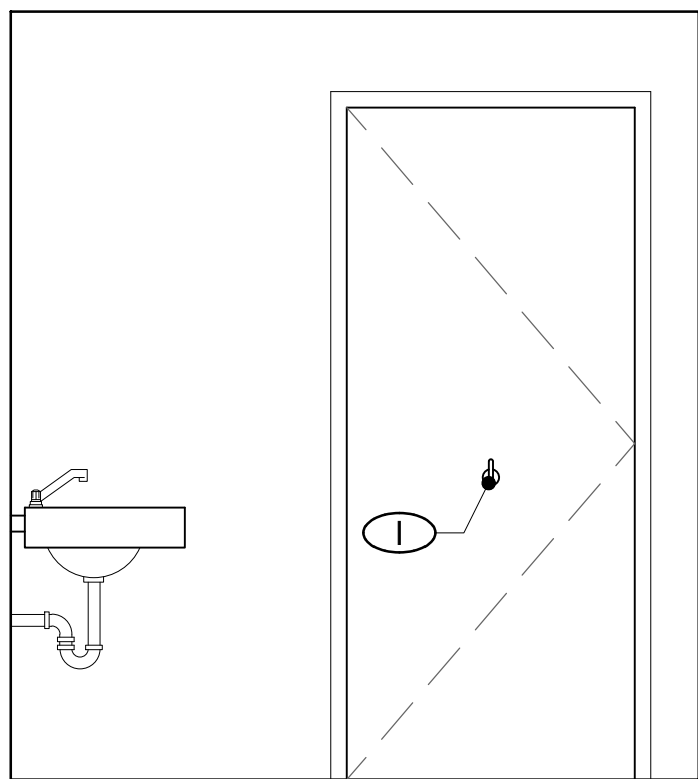

ELEVATION

SCALE: 1/2"=1'-0"

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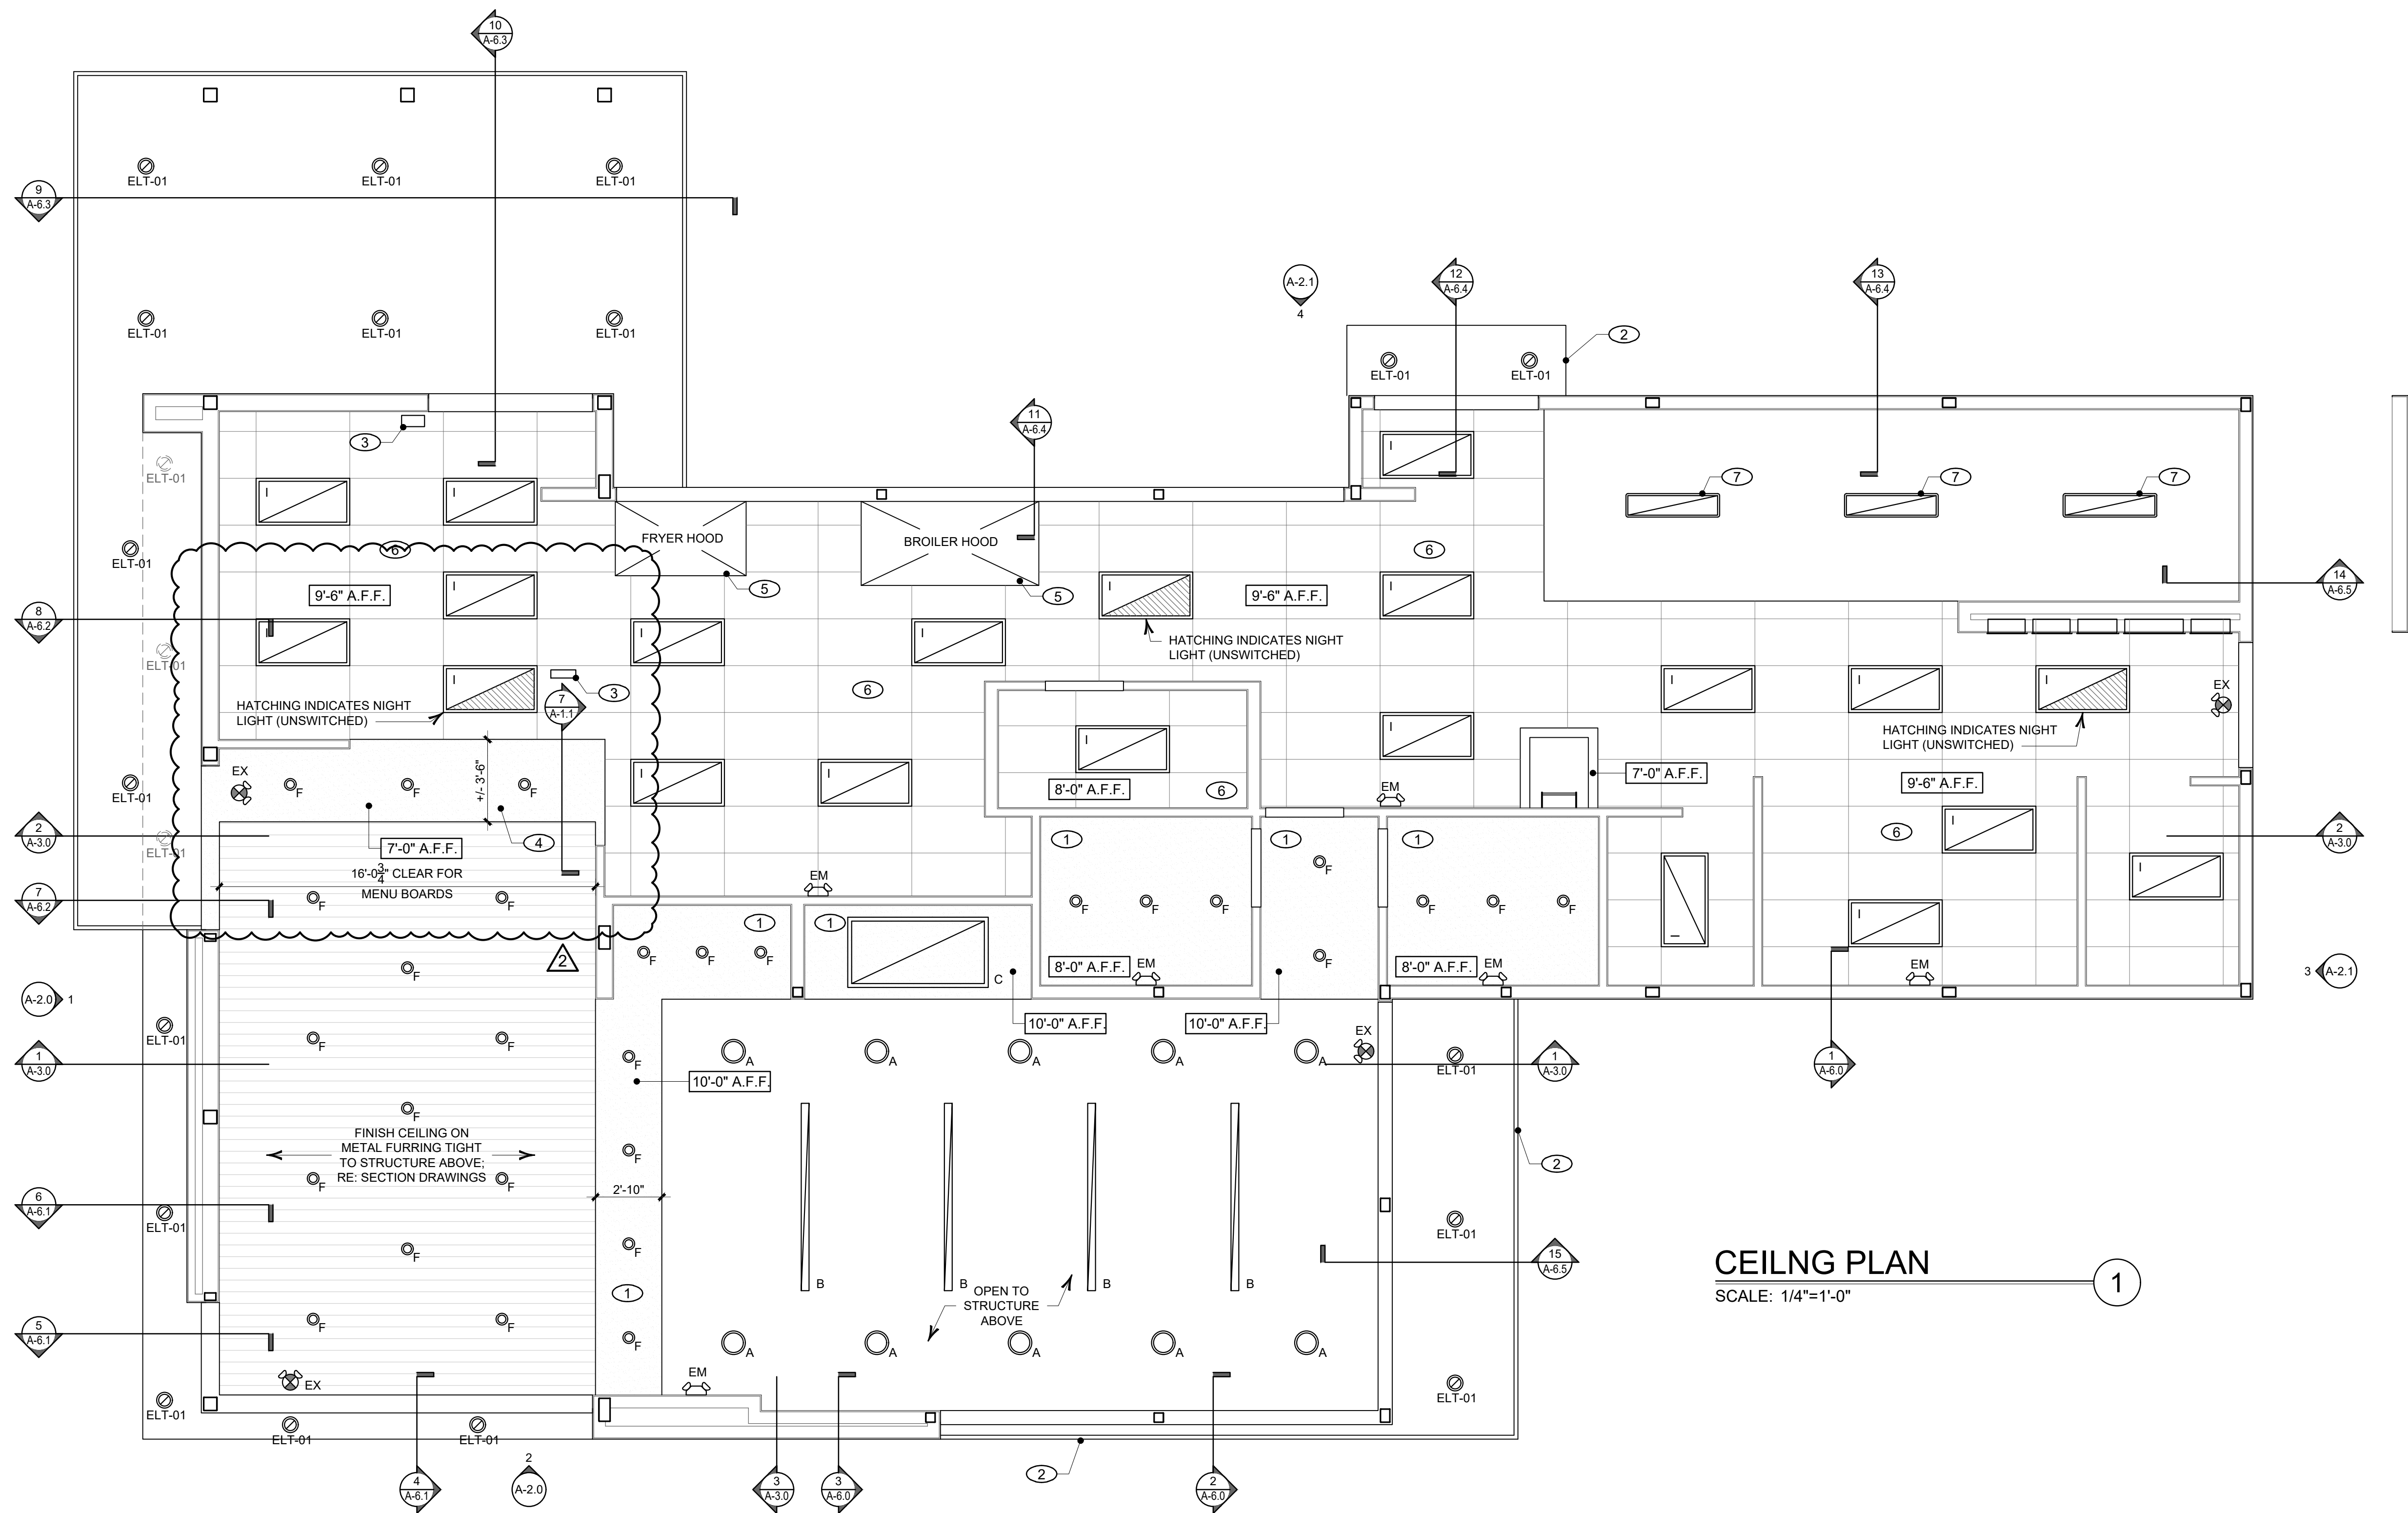
CARROLS, LLC
SYRACUSE, NEW YORK

ACCESSIBILITY
DETAILS



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Date: 3/2/2023
DrawnBy: CJP
CheckedBy: PJM
Job Number: 22083A
Drawing No.
A-3.1



CEILING PLAN
SCALE: 1/4"=1'-0"

KEYED CEILING NOTES (XX)

1. USG DRYWALL SUSPENSION SYSTEM W/ 1/2" GYPSUM BOARD
2. PREFABRICATED METAL CANOPY
3. STAINLESS STEEL SERVICE CHASE
4. MENU BOARD AND HEADER; REFERENCE SECTION DRAWINGS
5. MECHANICAL EXHAUST HOOD ABOVE
6. ACT-2 (KITCHEN) KITCHEN SUSPENDED ACOUSTICAL TILE CEILING.
USG 24x48x58 GYPSUM CEILING TILES #3270 (STIPPLE DESIG, WASHABLE) TO BE LAID IN EXPOSED WHITE HDG G-60 STEEL WALUMINUM CAP TEE GRID (NOT FIRE RATED CEILING)
-OR-
ARMSTRONG # 793 (24X48 5/8") GEORGIAN HIGHLY WASHABLE TO BE LAID IN EXPOSED WHITE HDG G-60 STEEL WALUMINUM CAP TEE GRID (NOT FIRE RATED CEILING)
7. WALK-IN BOX LIGHTING TO BE PROVIDED BY WALK-IN MANUFACTURER

GENERAL CEILING NOTES

1. DINING ROOMS ARE DESIGNED TO A 35 - 40 FOOT-CANDLE LEVEL; KITCHENS ARE DESIGNED TO 50 FOOT-CANDLE LEVEL; RESTROOMS ARE DESIGNED TO 50 FOOT-CANDLE; FOR ADDITIONAL INFORMATION ON LIGHTING REQUIREMENTS REFER TO BURGER KING LIGHTING STANDARDS POSTED AT DESIGNWITHBK.COM/COMMON_DOCUMENTS
2. ALL DIMENSIONS SHOWN ON REFLECTED CEILING PLAN ARE FROM FACE OF WALL FINISH UNLESS NOTED OTHERWISE
3. THE REFERENCE HEIGHTS INDICATED ON PLAN ARE FROM ABOVE FINISH FLOOR (A.F.F.)
4. GENERAL CONTRACTOR TO COORDINATE DINING ROOM LIGHTING WITH APPROVED INTERIOR DECOR DRAWINGS
5. CONTRACTOR SHALL VERIFY FIXTURE QUANTITIES AND ALSO MAKE PROPER ADJUSTMENTS FOR ANY CHANGES IN PLAN DUE TO ADDITIONAL REQUIREMENTS, LOCAL CODES, ETC.
6. FOR HVAC PLAN, SECTIONS, DUCT LOCATIONS, SUPPLY AND RETURN GRILLE SIZES AND ADDITIONAL INFORMATION, REFER TO MECHANICAL SHEETS
7. ALL FIXTURES SHALL BE LOCATED IN THE CENTER OF CEILING TILES UNLESS NOTED OTHERWISE
8. REFERENCE ELECTRICAL SHEETS FOR LIGHTING LAYOUT REQUIREMENTS AND ADDITIONAL INFORMATION
9. REFERENCE INTERIOR DECOR SHEETS FOR FINISH SPECIFICATIONS
10. CONTRACTOR TO COORDINATE PENDANT LIGHT LOCATIONS WITH DECOR SUPPLIER DRAWINGS
11. AT AREAS OPEN TO STRUCTURE ABOVE, ALL EXPOSED STRUCTURE, ROOF DECKING, MECHANICAL EQUIPMENT, DUCTWORK, CONDUITS, ETC. TO BE PAINTED IN ACCORDANCE WITH INTERIOR PACKAGE (BY OTHERS), TYP.
12. REFER TO ELECTRICAL DRAWINGS FOR LIGHT FIXTURE TYPES & LEGEND

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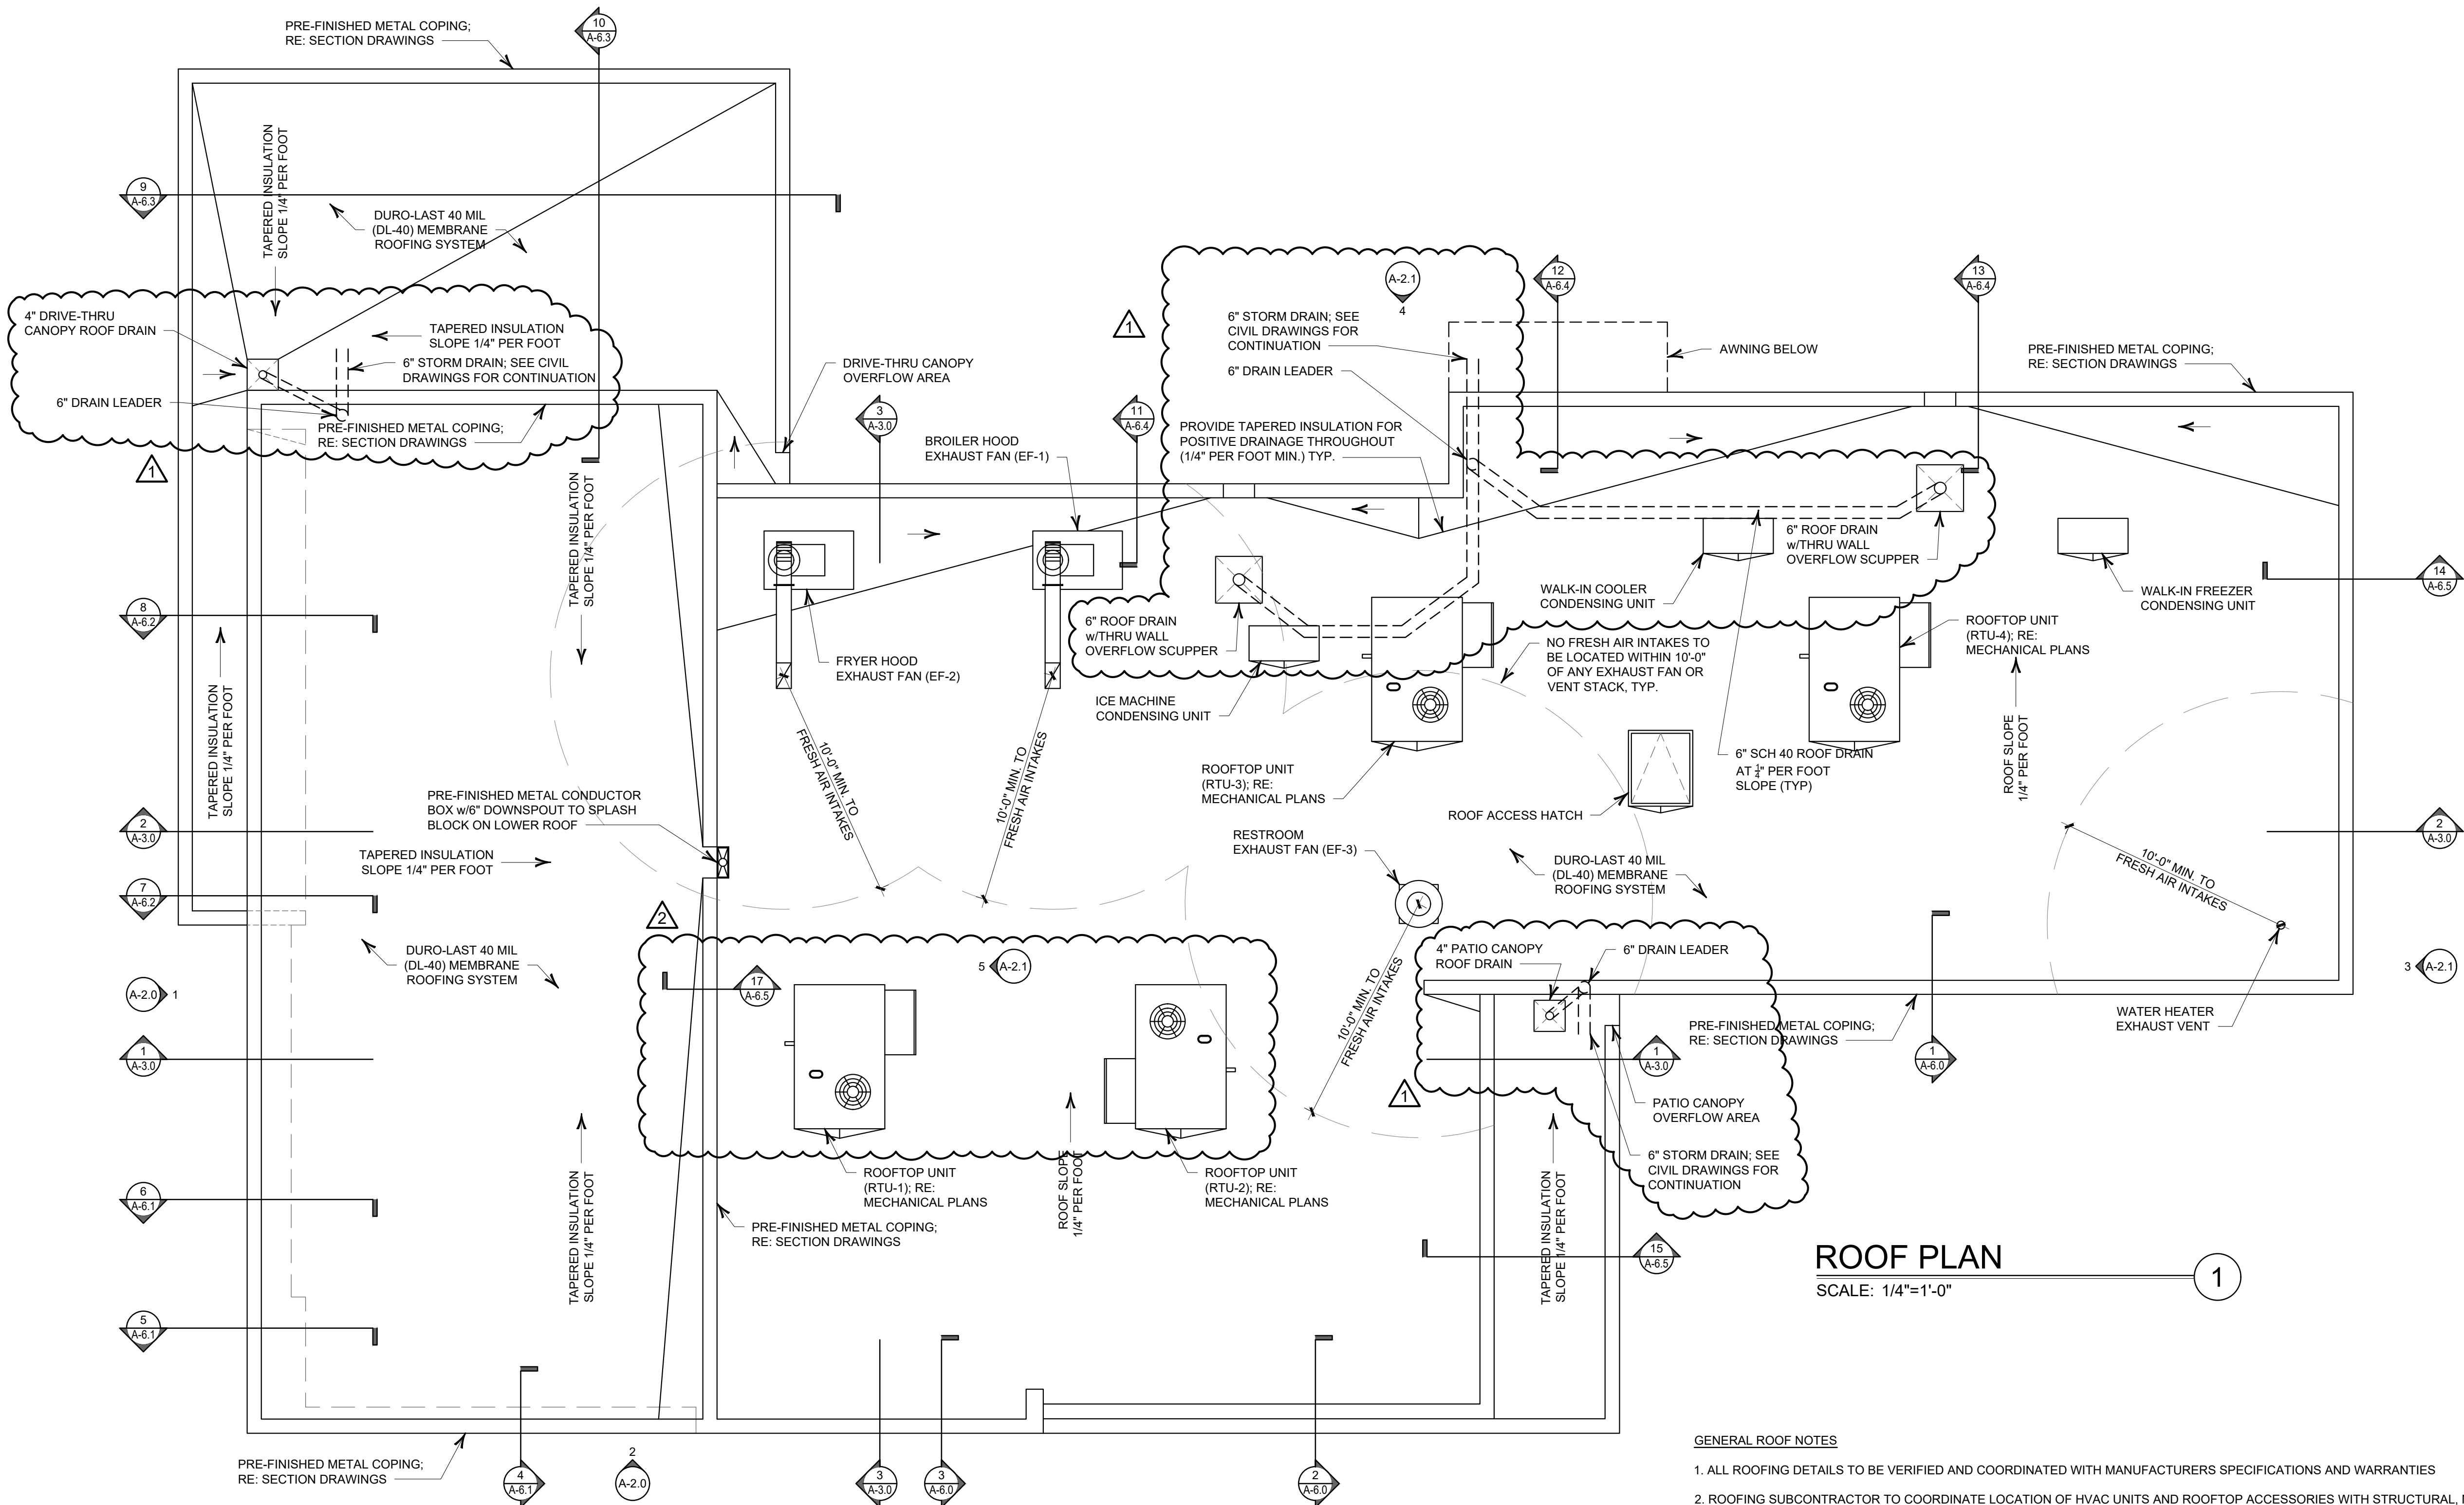
REFLECTED
CEILING PLAN



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ROOF PLAN

SCALE: 1/4"=1'-0"

ROOFING INFORMATION

-LOW' ROOF AREA:

PROVIDE DURO-LAST 40 MIL (DL-40) MEMBRANE ROOFING SYSTEM ON MIN. R-30 RIGID POLYISOCYANURATE ROOFING INSULATION ON METAL DECKING. POLYISOCYANURATE TO HAVE A MIN. R-VALUE OF R-6 PER INCH OF INSULATION

-TOWER' ROOF AREA:

PROVIDE DURO-LAST 40 MIL (DL-40) MEMBRANE ROOFING SYSTEM ON TAPERED ROOF INSULATION WITH A MIN. THICKNESS OF 1" (R-6) ON METAL DECKING AND MIN. R-38 BATT INSULATION IN ROOF CAVITY PER SECTION DRAWINGS. POLYISOCYANURATE TO HAVE A MIN. R-VALUE OF R-6 PER INCH OF INSULATION

GENERAL ROOF NOTES

- ALL ROOFING DETAILS TO BE VERIFIED AND COORDINATED WITH MANUFACTURERS SPECIFICATIONS AND WARRANTIES
- ROOFING SUBCONTRACTOR TO COORDINATE LOCATION OF HVAC UNITS AND ROOFTOP ACCESSORIES WITH STRUCTURAL, MECHANICAL AND ELECTRICAL DRAWINGS FOR PLACEMENT AND TAPERED RIGID INSULATION BOARD LAY-OUT AND SUBSEQUENT INSTALLATION IN ORDER TO AVOID PONDING WATER CONDITIONS ATTRIBUTABLE TO BOARD LAY-OUT ISSUES
- ROOF SYSTEMS SPECIFIED SHALL BE APPLIED ONLY BY MANUFACTURER APPROVED APPLICATOR IN ORDER TO MEET GUARANTEE REQUIREMENTS
- COORDINATE LOCATION OF MECHANICAL UNITS WITH STRUCTURAL AND MECHANICAL DRAWINGS
- HVAC CONDENSATE LINES TO TERMINATE AT ROOF DRAIN OR AS REQUIRED BY LOCAL CODE
- REFER TO STRUCTURAL AND M-E-P DRAWINGS FOR ADDITIONAL INFORMATION
- ALL CURBS AND PIPE PENETRATIONS SHALL HAVE A MINIMUM OF 16" CLEAR FROM EACH OTHER FOR ROOF FLASHING PURPOSES. ALL EQUIPMENT SHALL HAVE A MINIMUM OF 16" CLEAR FROM ALL ADJACENT PARAPETS. ALL HVAC MOUNTED EQUIPMENT (DISCONNECT BOXES, GFCI, PIPE SUPPORTS) SHALL NOT BE CLOSER THAN 16" FROM EACH OTHER OR CURB. NO UNISTRUT PIPE SUPPORTS SHALL BE USED AS VERTICAL MEMBERS FOR MOUNTING EQUIPMENT TO ROOF SURFACE
- PONDING WATER IS DEFINED AS WATER THAT DOES NOT DRAIN OR DISSIPATE FROM THE ROOF WITHIN 48 HOURS AFTER PRECIPITATION
- CONTRACTOR SHALL "SUGAR-IN" ALL ASPHALT; BLEED-OUT ON PLIES WITH ADDITIONAL GRANULES TO MATCH EXISTING COLORATION OF THE MINERAL SURFACE CAP SHEET
- ALL FLASHING CEMENTS, ASPHALTS, PRODUCTS AND ACCESSORIES SHALL BE APPROVED BY ROOFING MANUFACTURER WITH THE MANUFACTURES'S BRAND; ALL ASPHALTS SHALL BE AMERICAN MANUFACTURED PRODUCTS
- THE ROOF STRUCTURE SHALL NOT BE USED FOR STOCKPIILING OF EQUIPMENT OR MATERIALS UNLESS APPROVED BY THE ARCHITECT, STRUCTURAL ENGINEER AND THE JOIST MANUFACTURER
- THE ROOFING SYSTEM SHALL BE AS PER DRAWINGS AND PER MANUFACTURERS SPECIFICATIONS
- COORDINATE ROOF ELEVATIONS WITH STRUCTURAL DRAWINGS. REFER TO SPECIFICATION SHEET FOR ROOF RELATED ITEMS, INCLUDING GUARANTEES, CURBS, FLASHING, ETC.
- PROVIDE PITCH PAN WITH CONDUIT OVER OFFICE FOR SATELLITE DISH / ANTENNA

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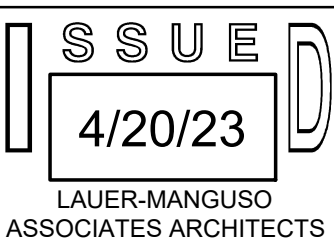
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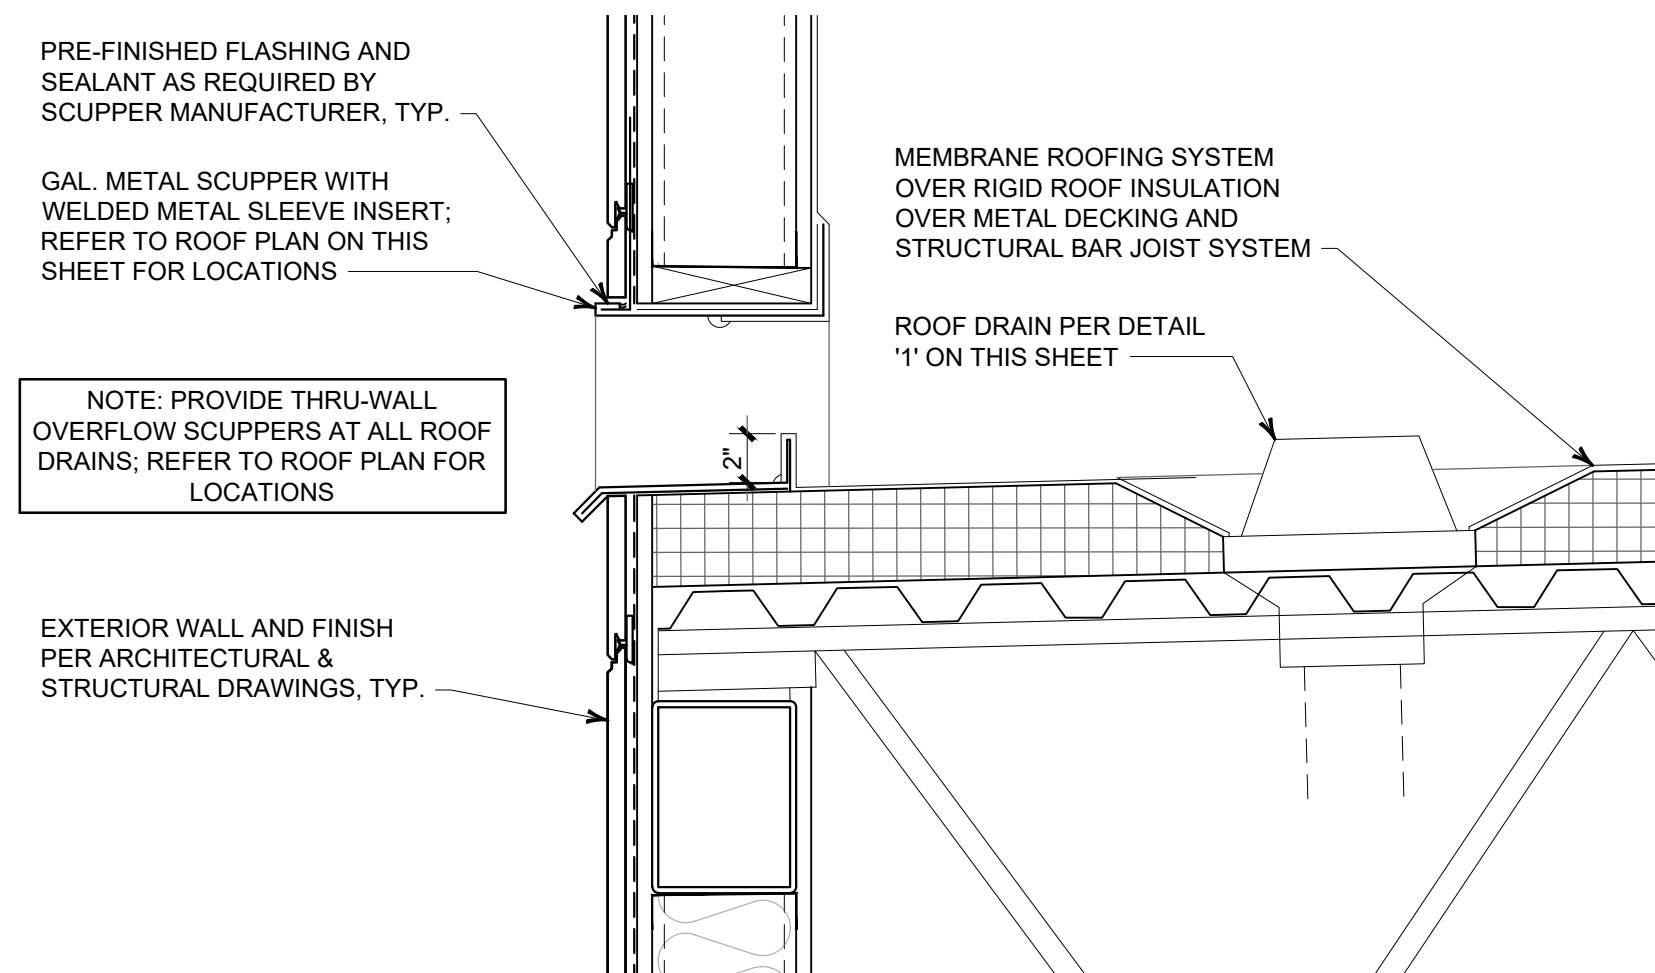
ROOF PLAN



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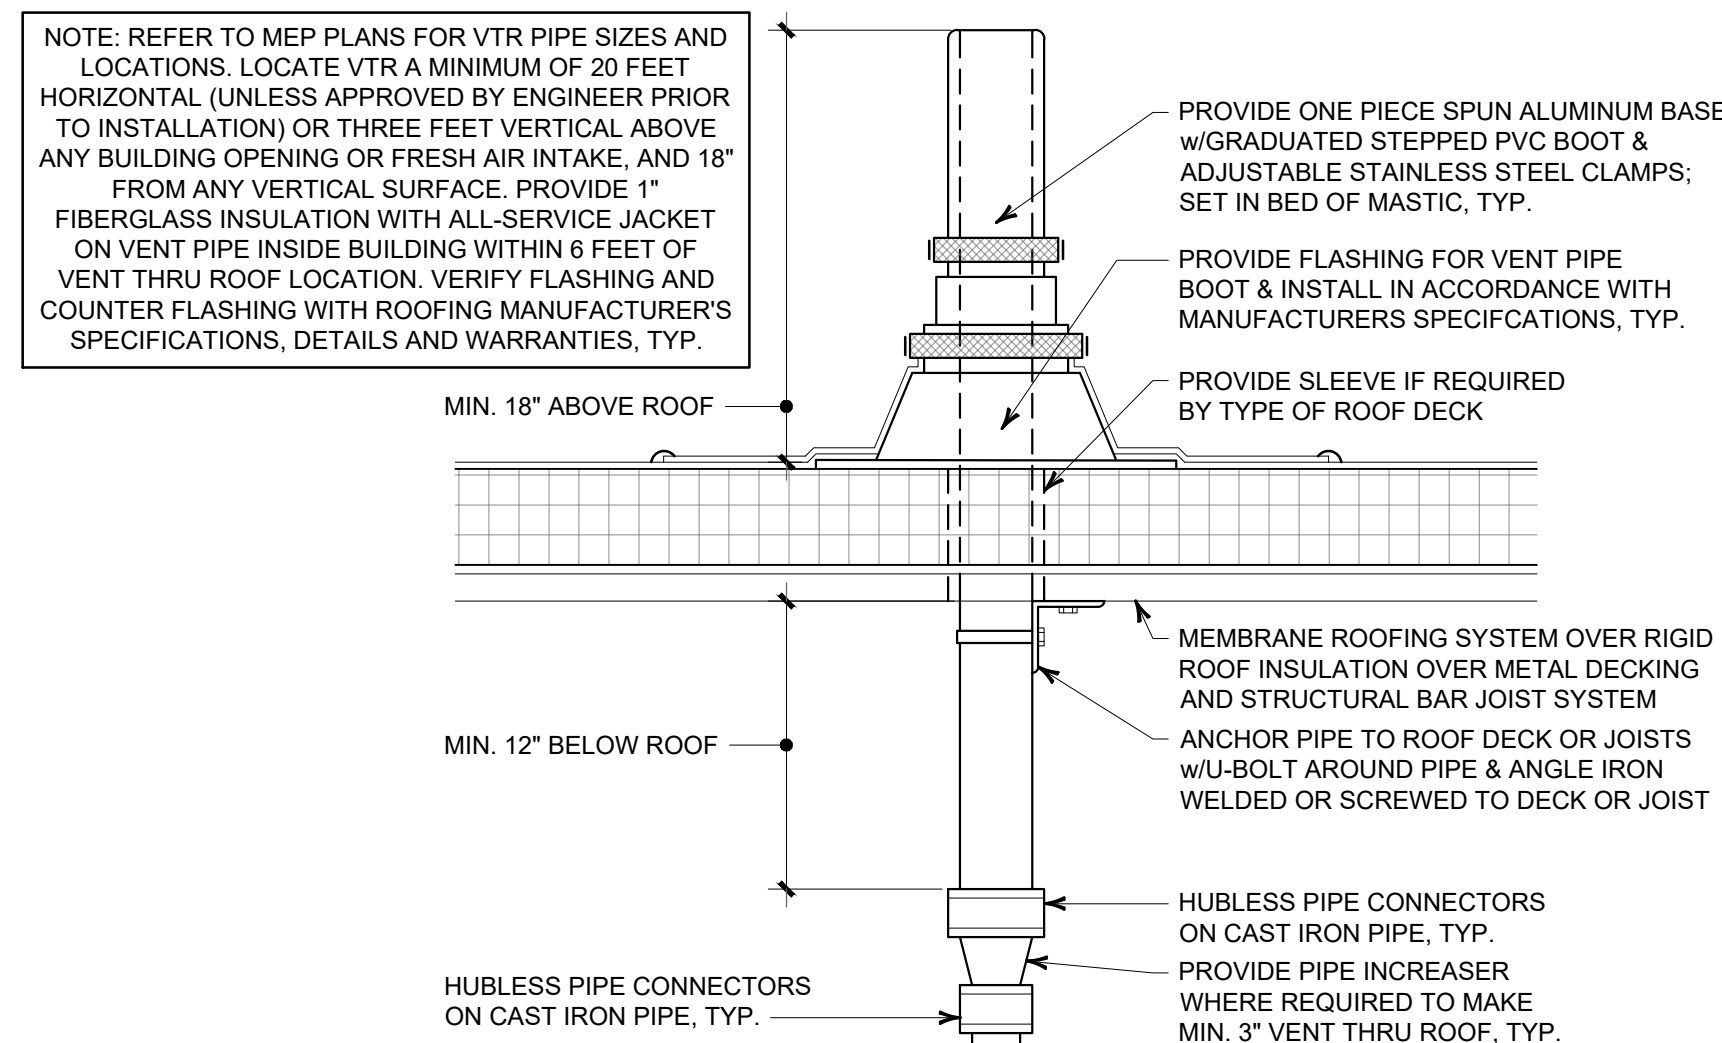
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A-5.0



THRU-WALL OVERFLOW SCUPPER DETAIL

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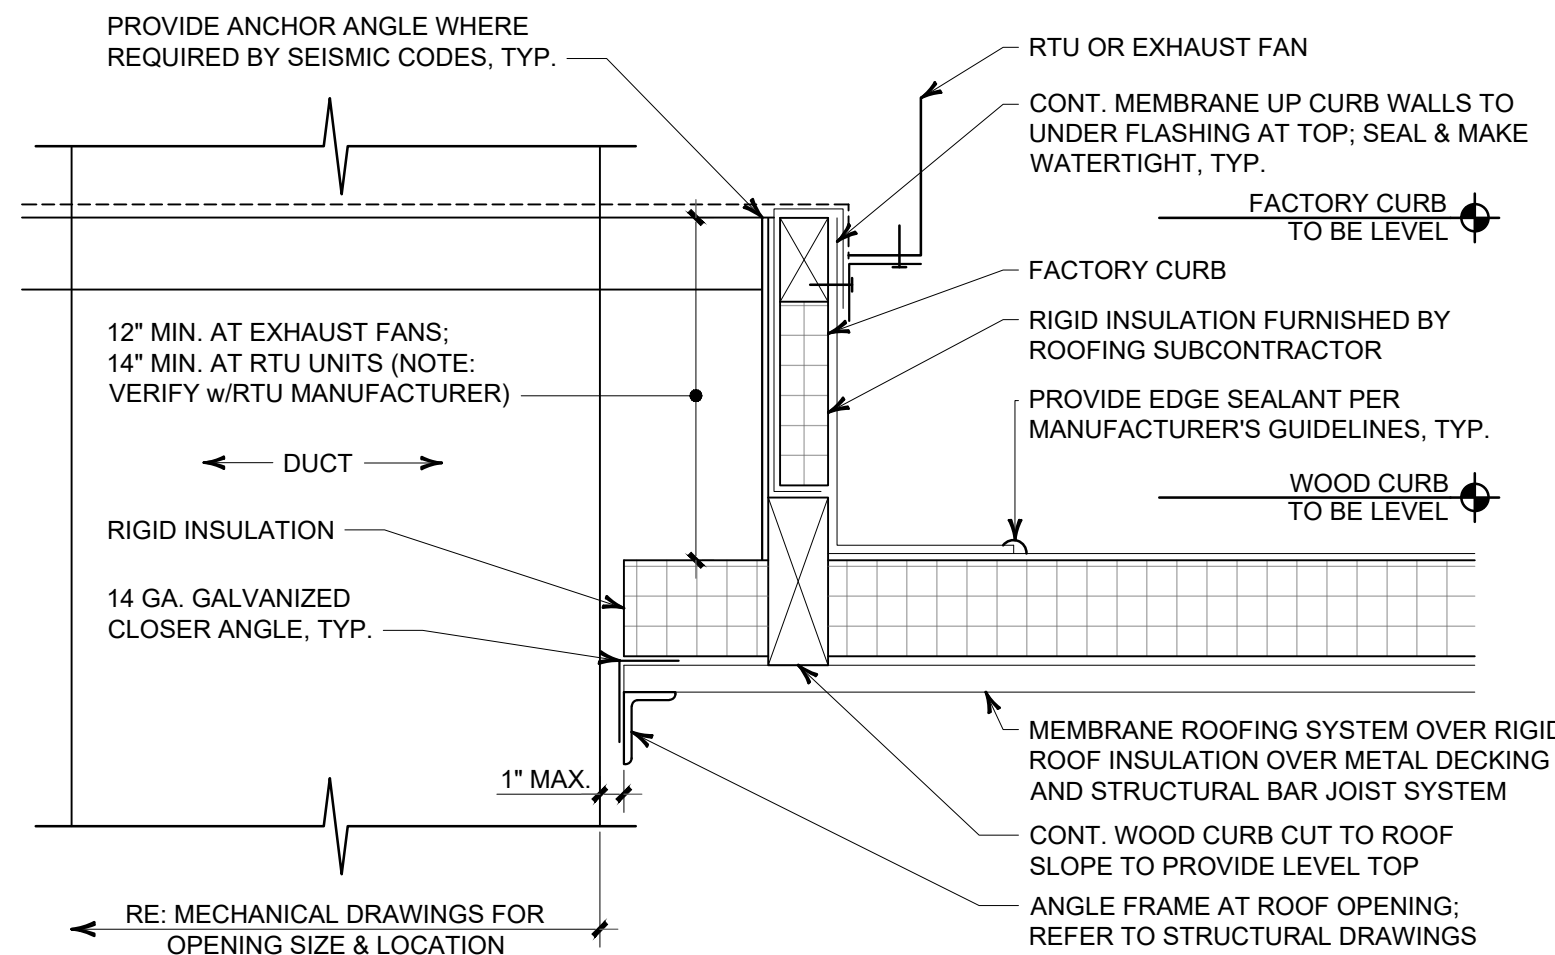
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TYPICAL VENT THRU ROOF (VTR DETAIL)

SCALE: 1-1/2"=1'-0"


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TYPICAL RTU & EXHAUST FAN CURB DETAIL

SCALE: 1-1/2"=1'-0"


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NOTE: PIPE STANDS GOOD FOR 1/2" TO 3-1/2" STEEL PIPE SIZES ONLY

NOTE: SUPPORT SPACING FOR PIPE SIZES: 1/2" = 6'-0"; 3/4" = 8'-0"; 1" = 8'-0"; 1-1/4" AND LARGER = 10'-0"


NOTE: PLACE DECK PLATES ON ROOFING. SET PIPE STAND FREE ON DECK PLATES. STACK PIPE STAND WITH SPACERS WHERE REQUIRED TO ELEVATE PIPING. INSTALL GAS PIPE TO ALLOW FOR EXPANSION & CONTRACTION. PRIMER COAT AND PAINT EXTERIOR GAS PIPE LIGHT GREEN COLOR

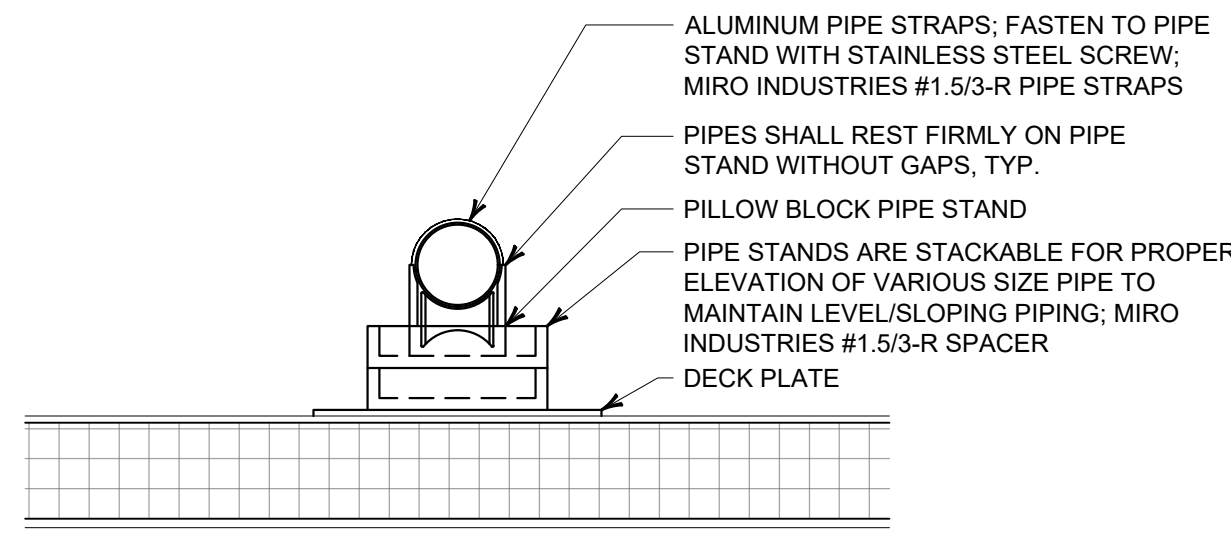

TYPICAL ROOF BLOCKING PIPE SUPPORT DETAILS

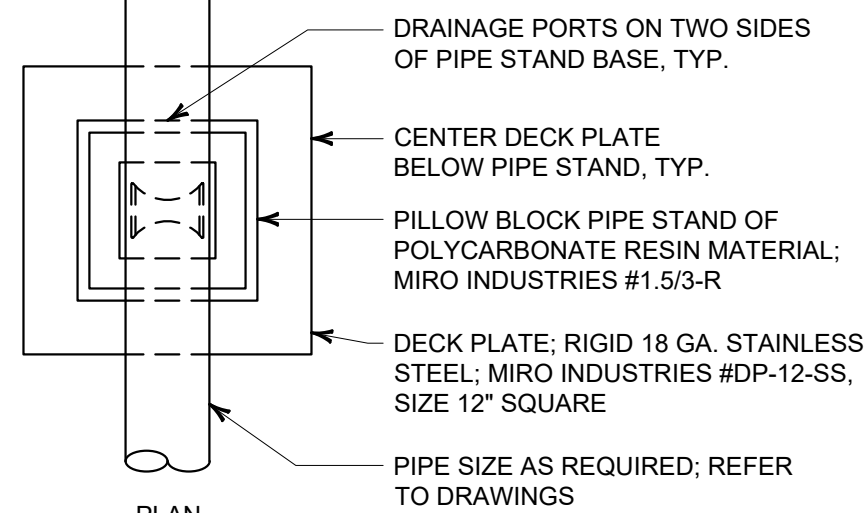SCALE: 1-1/2"=1'-0"


5

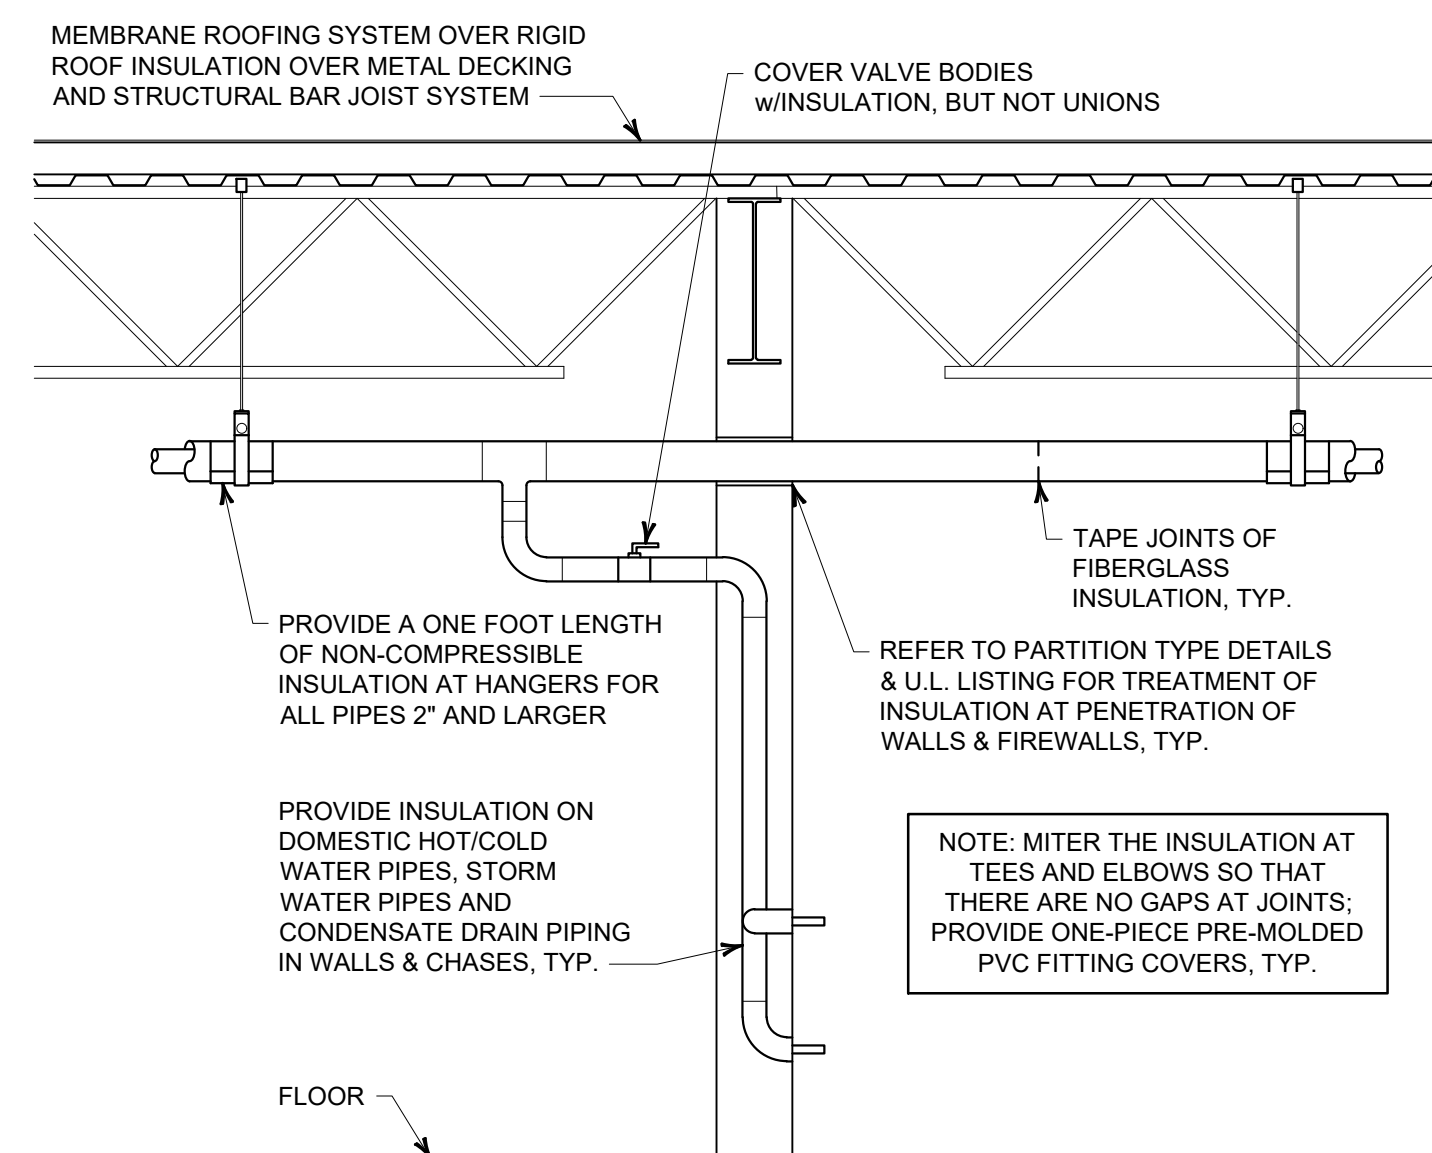

TYPICAL PIPE INSULATION

SCALE: NOT TO SCALE

4

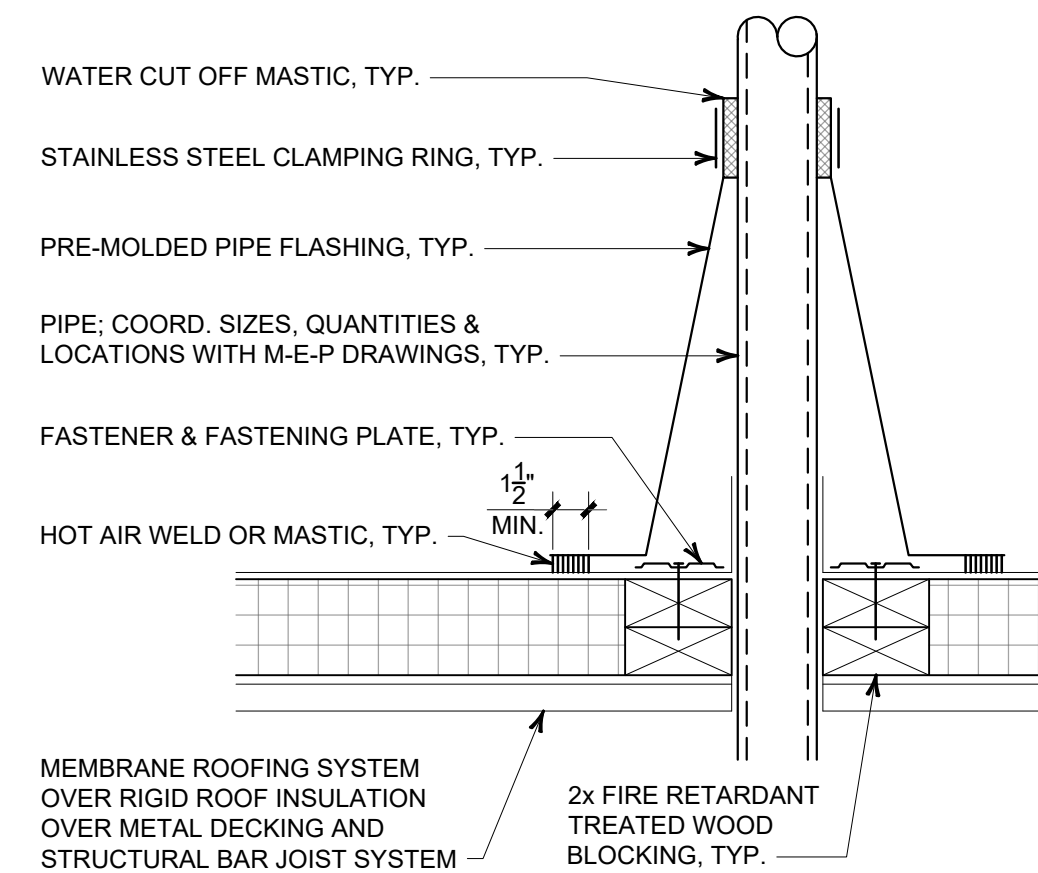

TYP. THRU-ROOF PIPE DETAIL

SCALE: 1-1/2"=1'-0"

3


NOTE: PROVIDE UPPER ATTACHMENT AS REQUIRED FOR CASES NOT SHOWN HERE. DO NOT INSTALL HANGER INSIDE INSULATION OR OTHERWISE PENETRATE VAPOR BARRIER. DO NOT HANG ONE PIPE FROM ANOTHER EXCEPT IN CHASES. TRAPEZOID HANGERS MAY BE USED FOR MULTIPLE PARALLEL PIPES. LOCATE HANGERS AS CLOSE AS POSSIBLE TO TURNS AND TEES OF PIPE. PROVIDE SUPPLEMENTARY STEEL STRUTS BETWEEN JOISTS IF REQUIRED. LOCATE HANGERS TO TAKE LOAD OFF OF EQUIPMENT CONNECTIONS. ANCHOR WATER PIPE AGAINST SWAYING DUE TO CHANGES IN WATER VELOCITY. PROVIDE SEISMIC BRACING IF/AS REQUIRED BY LOCAL AUTHORITIES. CHAINS OR PERFORATED STRAP IRON OR STEEL IS NOT ACCEPTABLE. REFER TO CODE FOR FURTHER INFORMATION.

MAX. HANGER SPACING FOR PIPE SIZE:

COPPER: 4" = 12'-0"; 3" = 11'-0"; 2-1/2" = 10'-0"; 2" = 9'-0"; 1-1/2" = 8'-0"; 1-1/4" = 7'-0"; 1" = 6'-0"; 3/4" = 6'-0"; 1/2" = 5'-0"

CAST IRON: 10'-0" AND ONE NEAR ALL JOINTS


STEEL: 4" = 14'-0"; 3" = 12'-0"; 2-1/2" = 11'-0"; 2" = 10'-0"; 1-1/2" = 9'-0"; 1" = 7'-0"; 3/4" = 6'-0"; 1/2" = 5'-0"

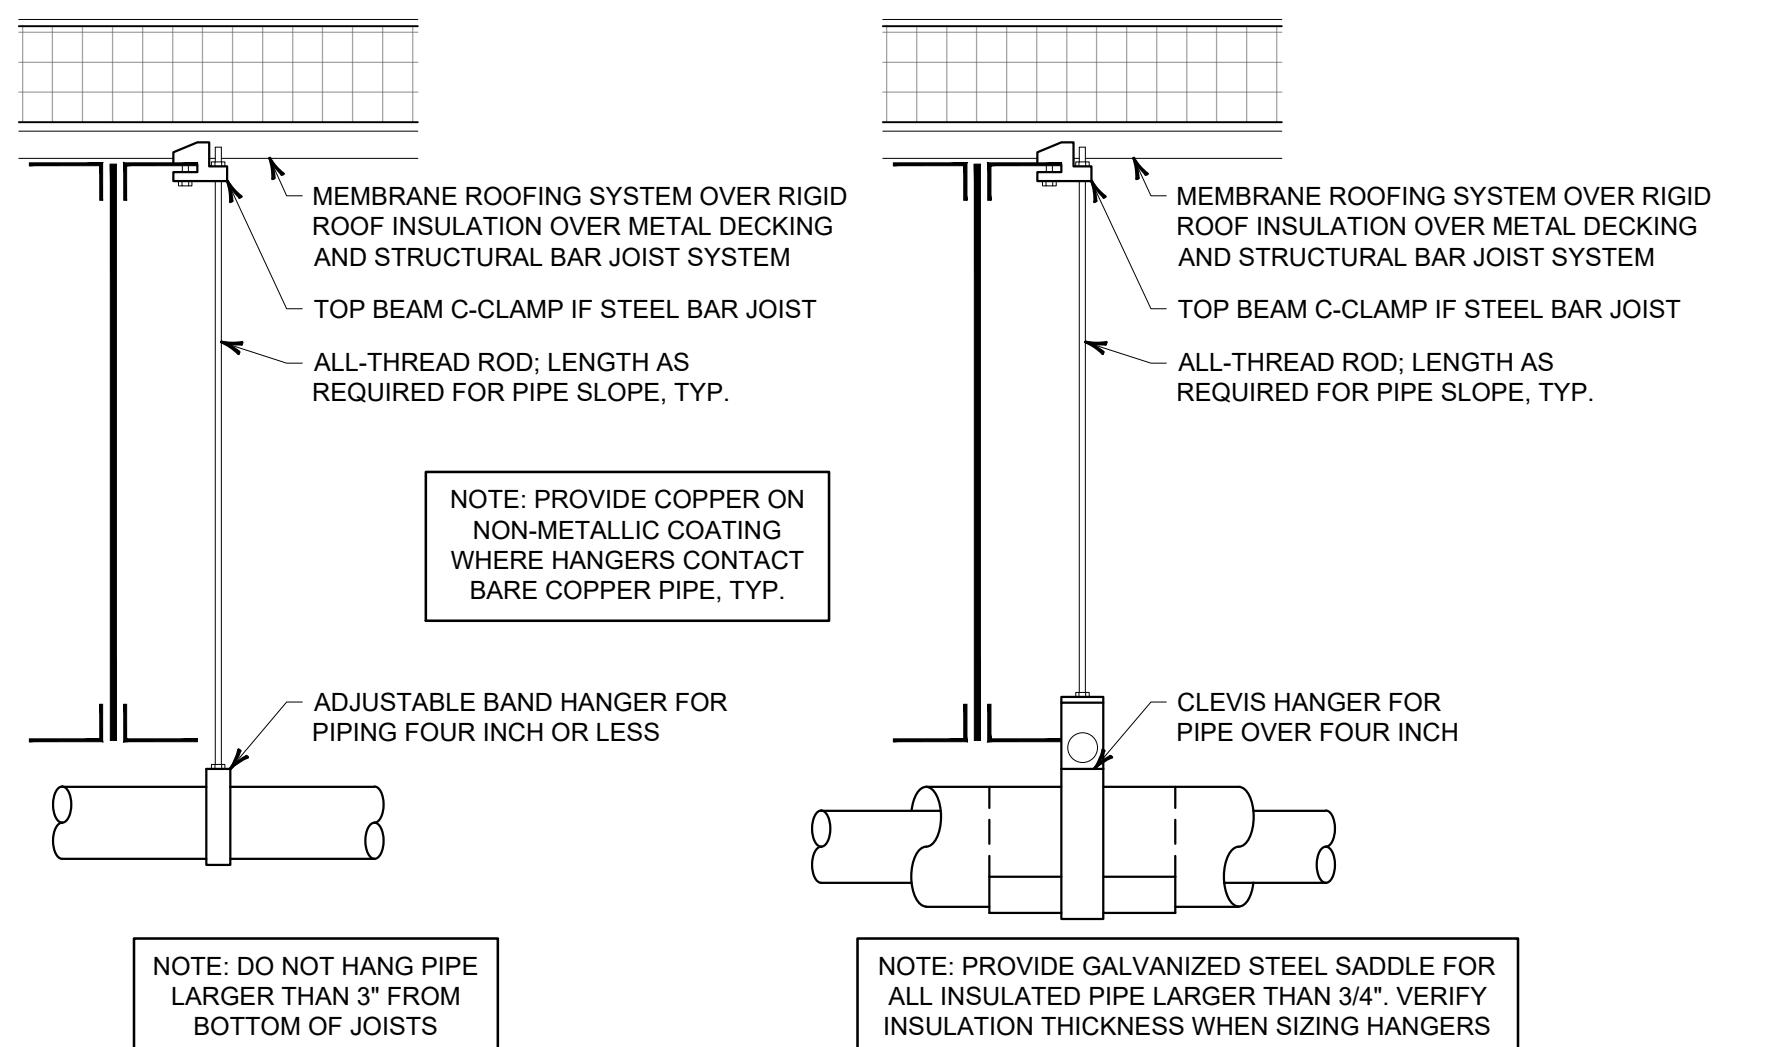

TYPICAL PIPE HANGER DETAIL

SCALE: 1-1/2"=1'-0"

2

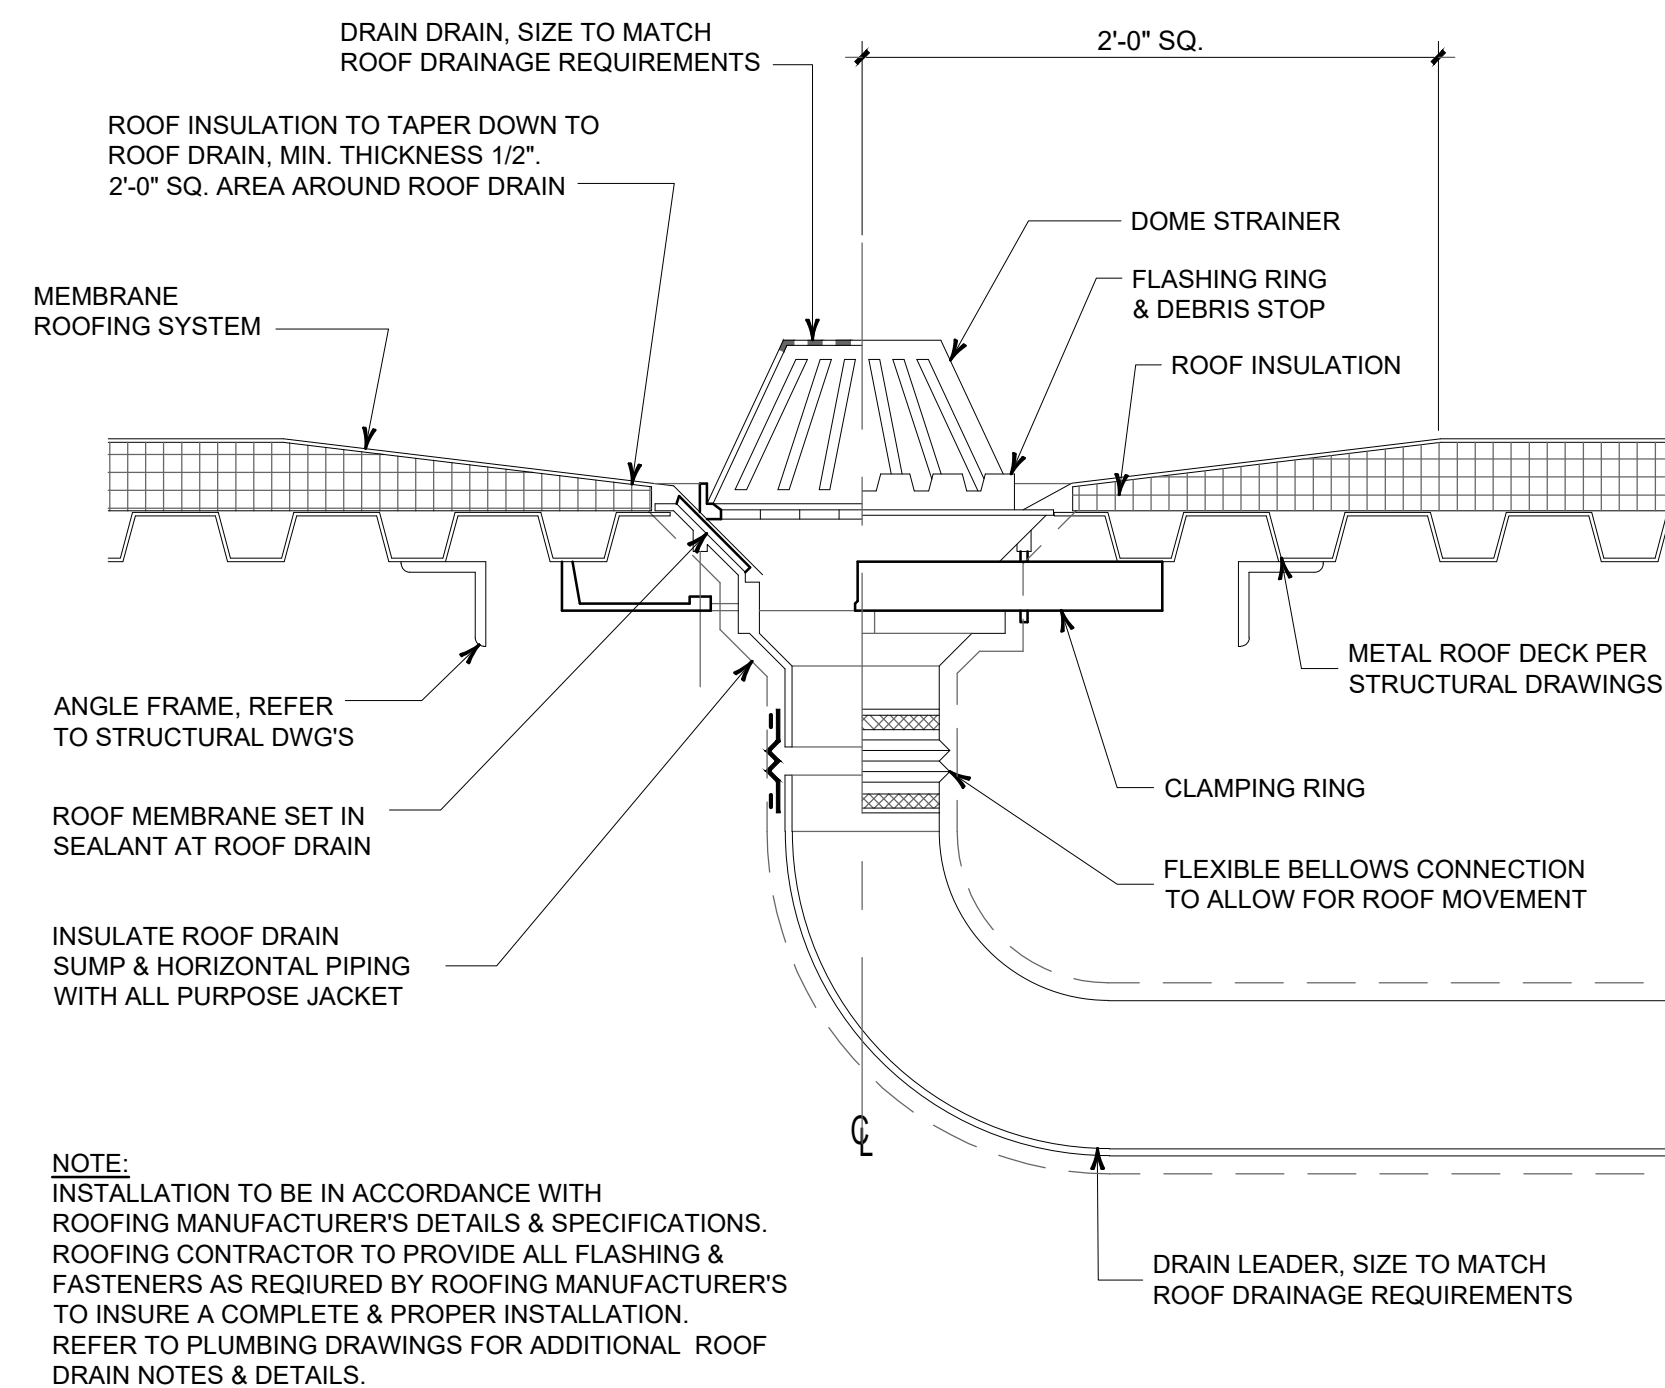

ROOF DRAIN DETAIL

SCALE: 1-1/2"=1'-0"

1

CLS# 211 BK# 3857


No.	Description	Date
2	REVISED	4/20/23
1	REVISED	4/3/23
-	ISSUED FOR BID	3/22/23

△ - REVISIONS

**BURGER KING
SIZZLE PROTOTYPE**
MARION, NORTH CAROLINA

CARROLLS, LLC
SYRACUSE, NEW YORK

ROOF DETAILS

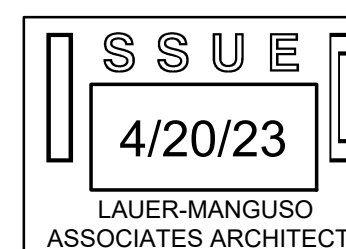

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Date: 3/3/2023
DrawnBy: CJP
CheckedBy: PJM
Job Number: 22083A

Drawing No.
A-5.1