




KIDS POOL PLAN

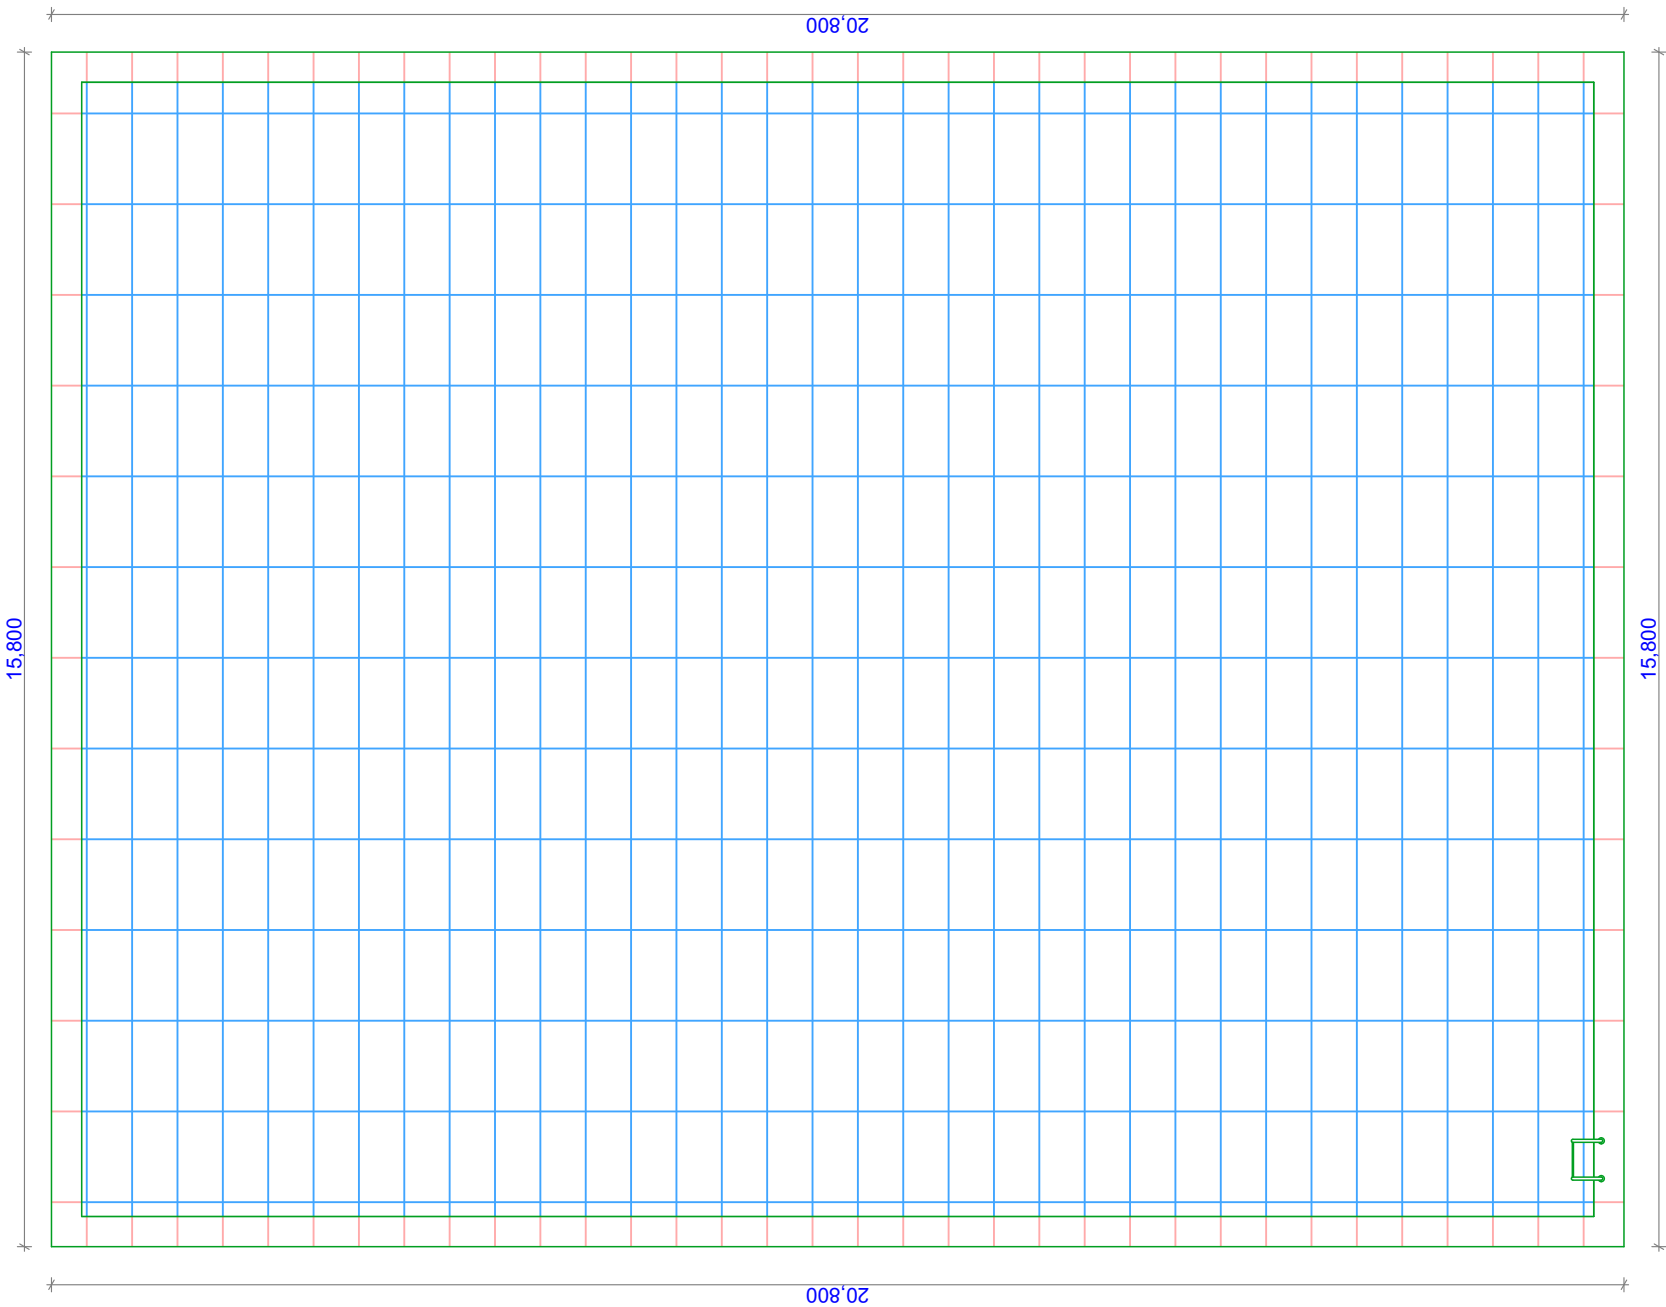


FAMILY POOL PLAN

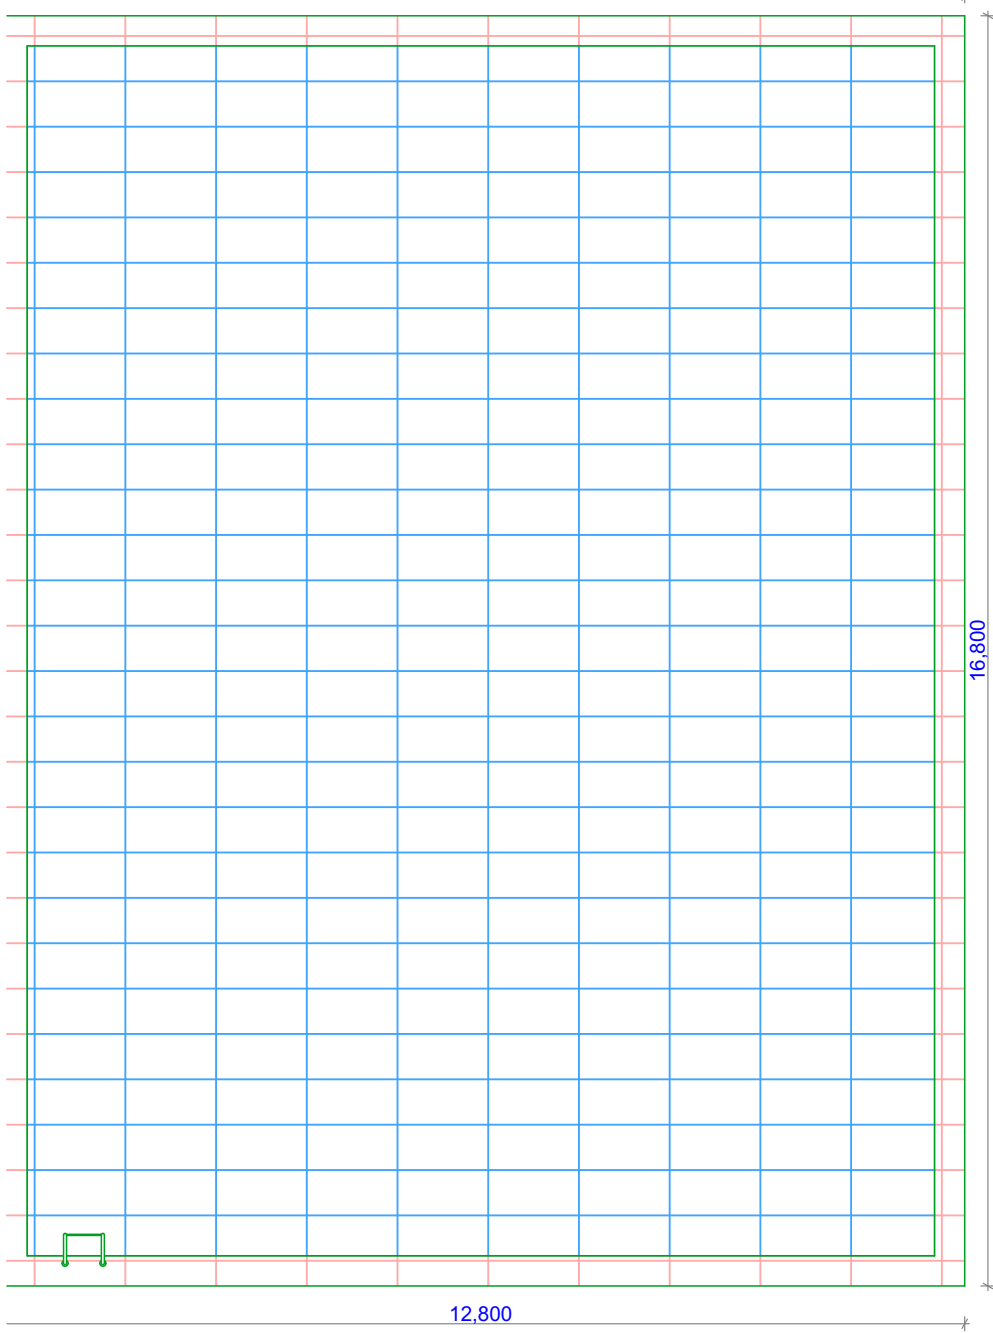


FUN POOL PLAN

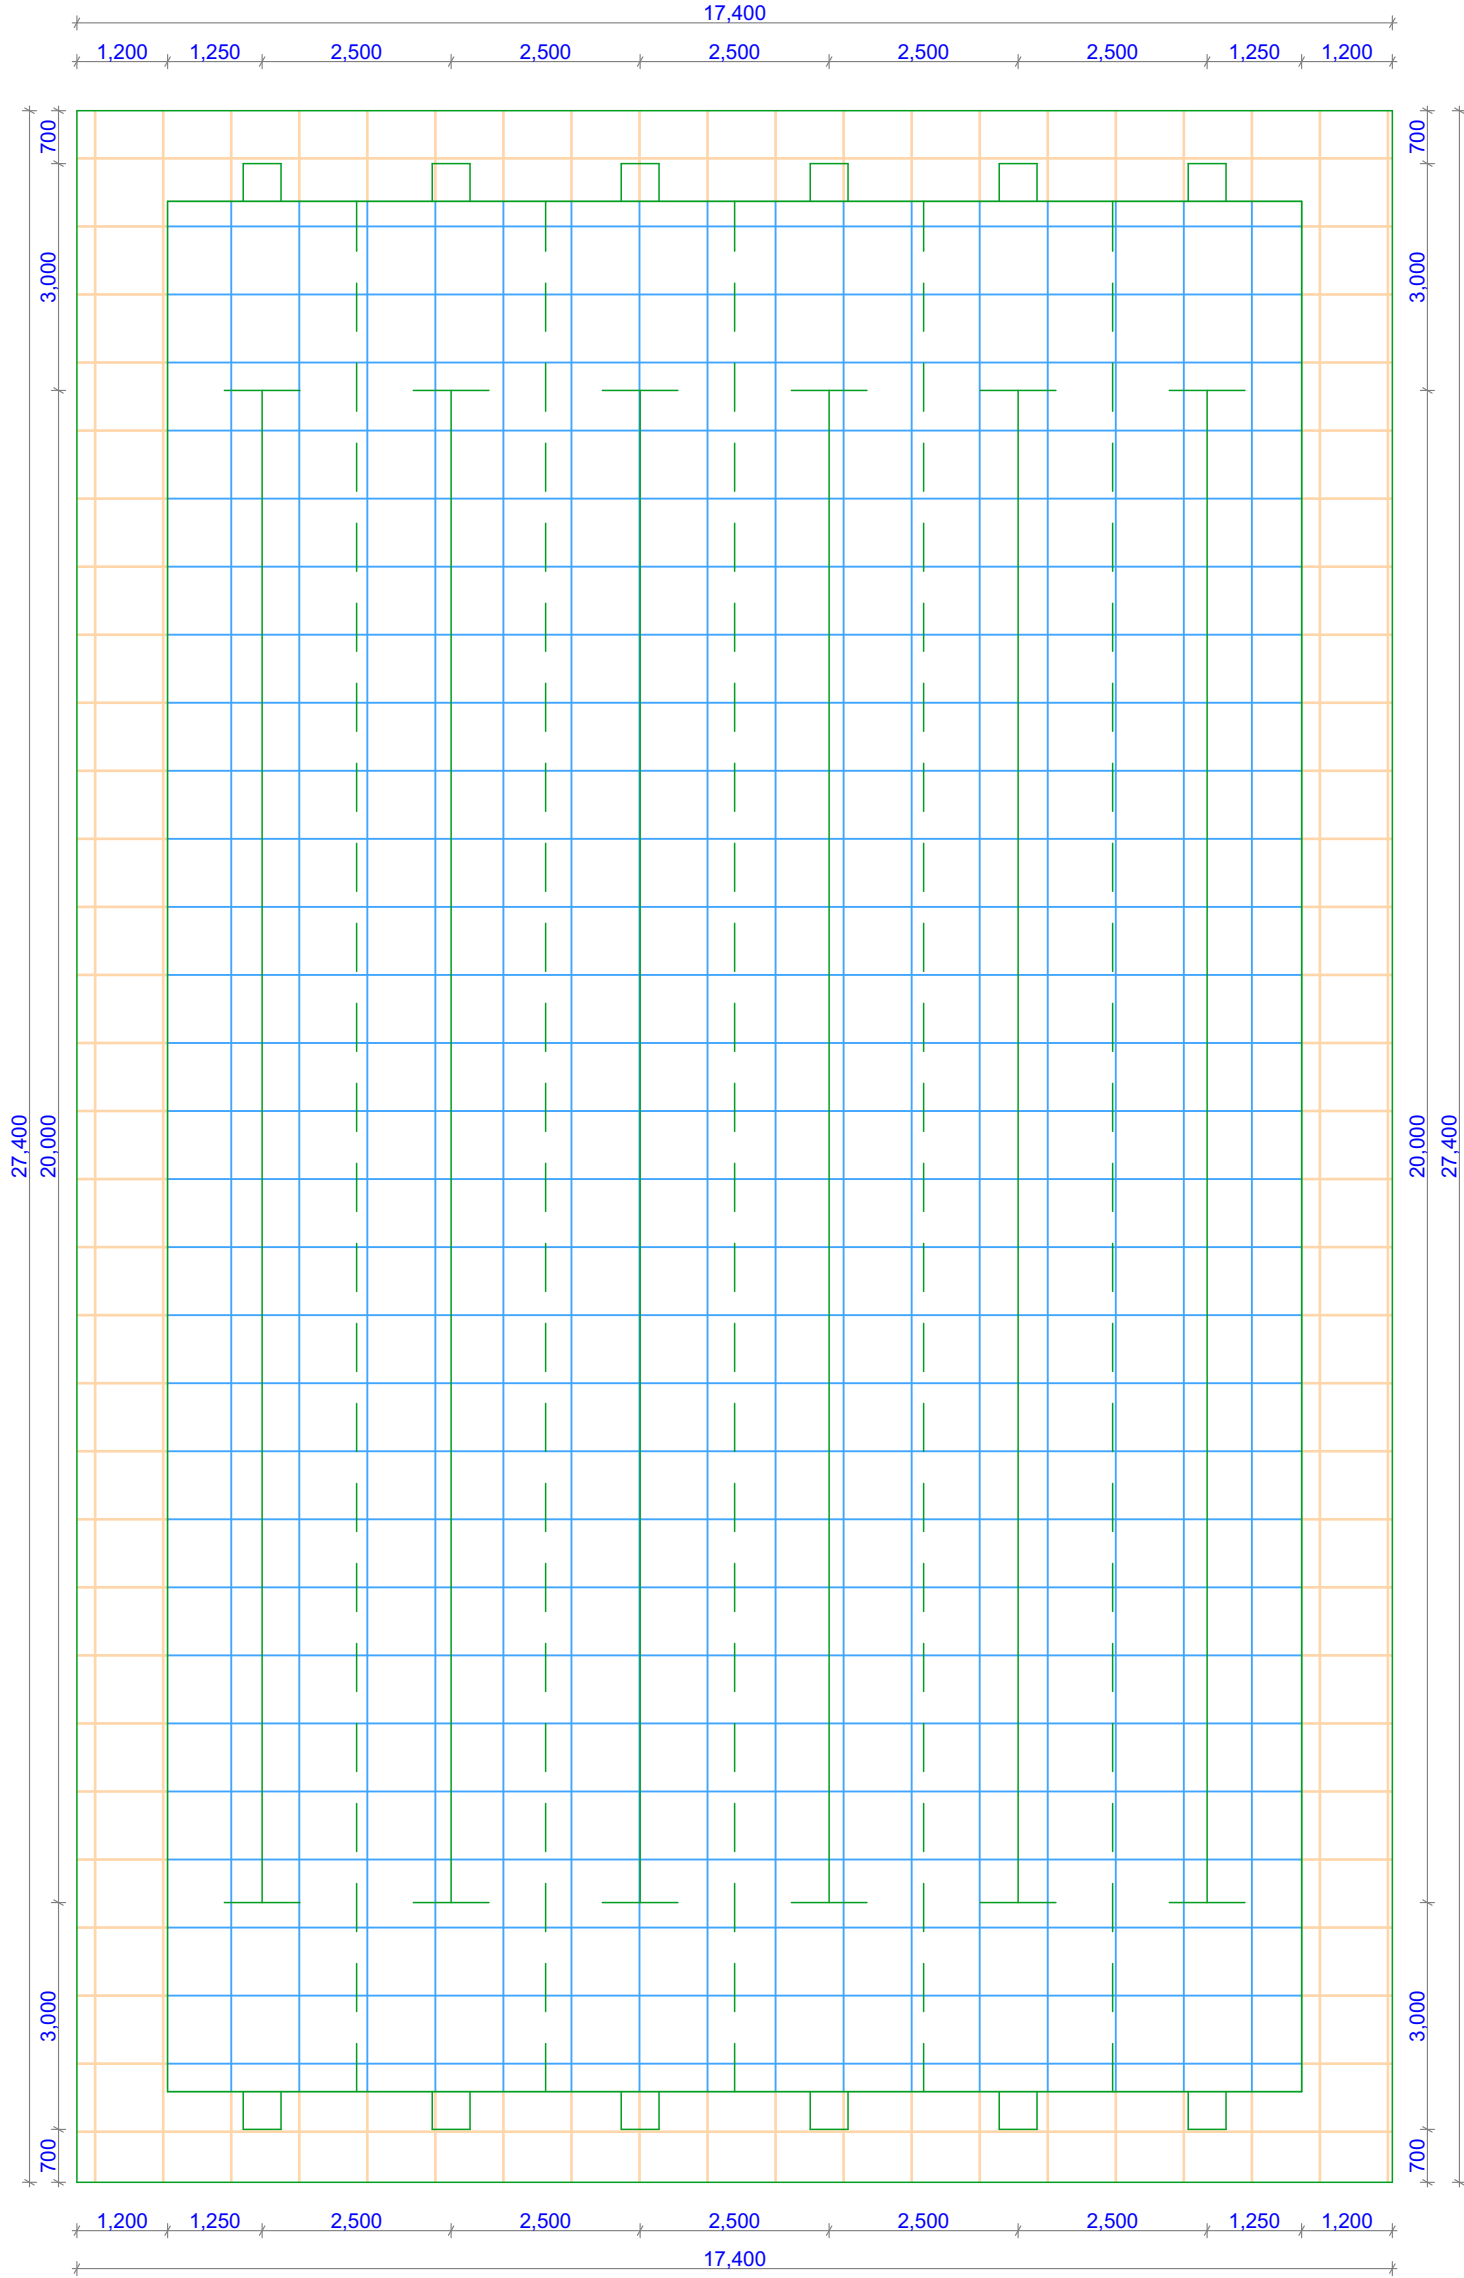

TRAINING POOL PLAN

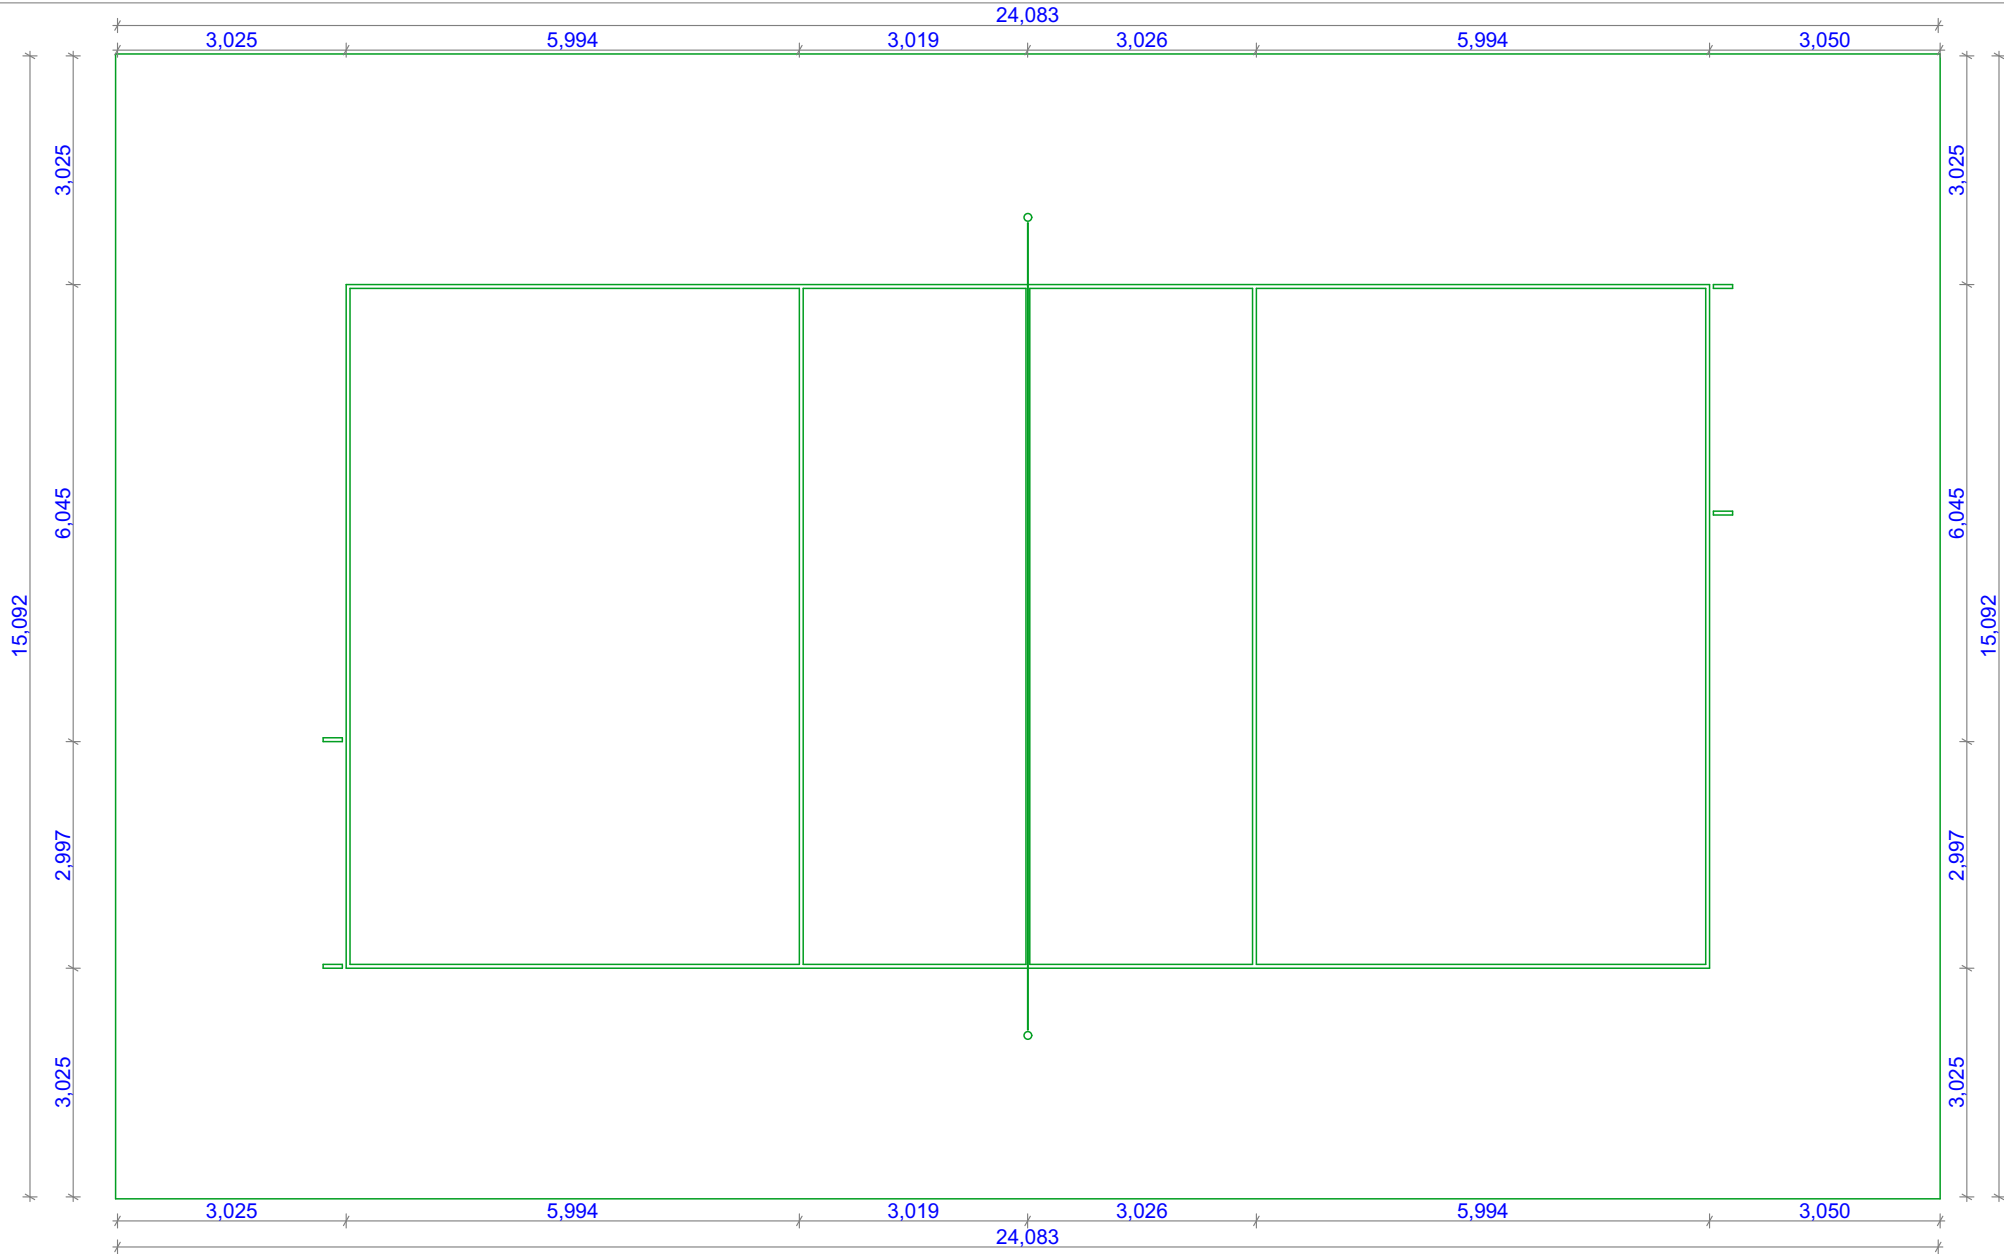

VOLLEYBALL COURT

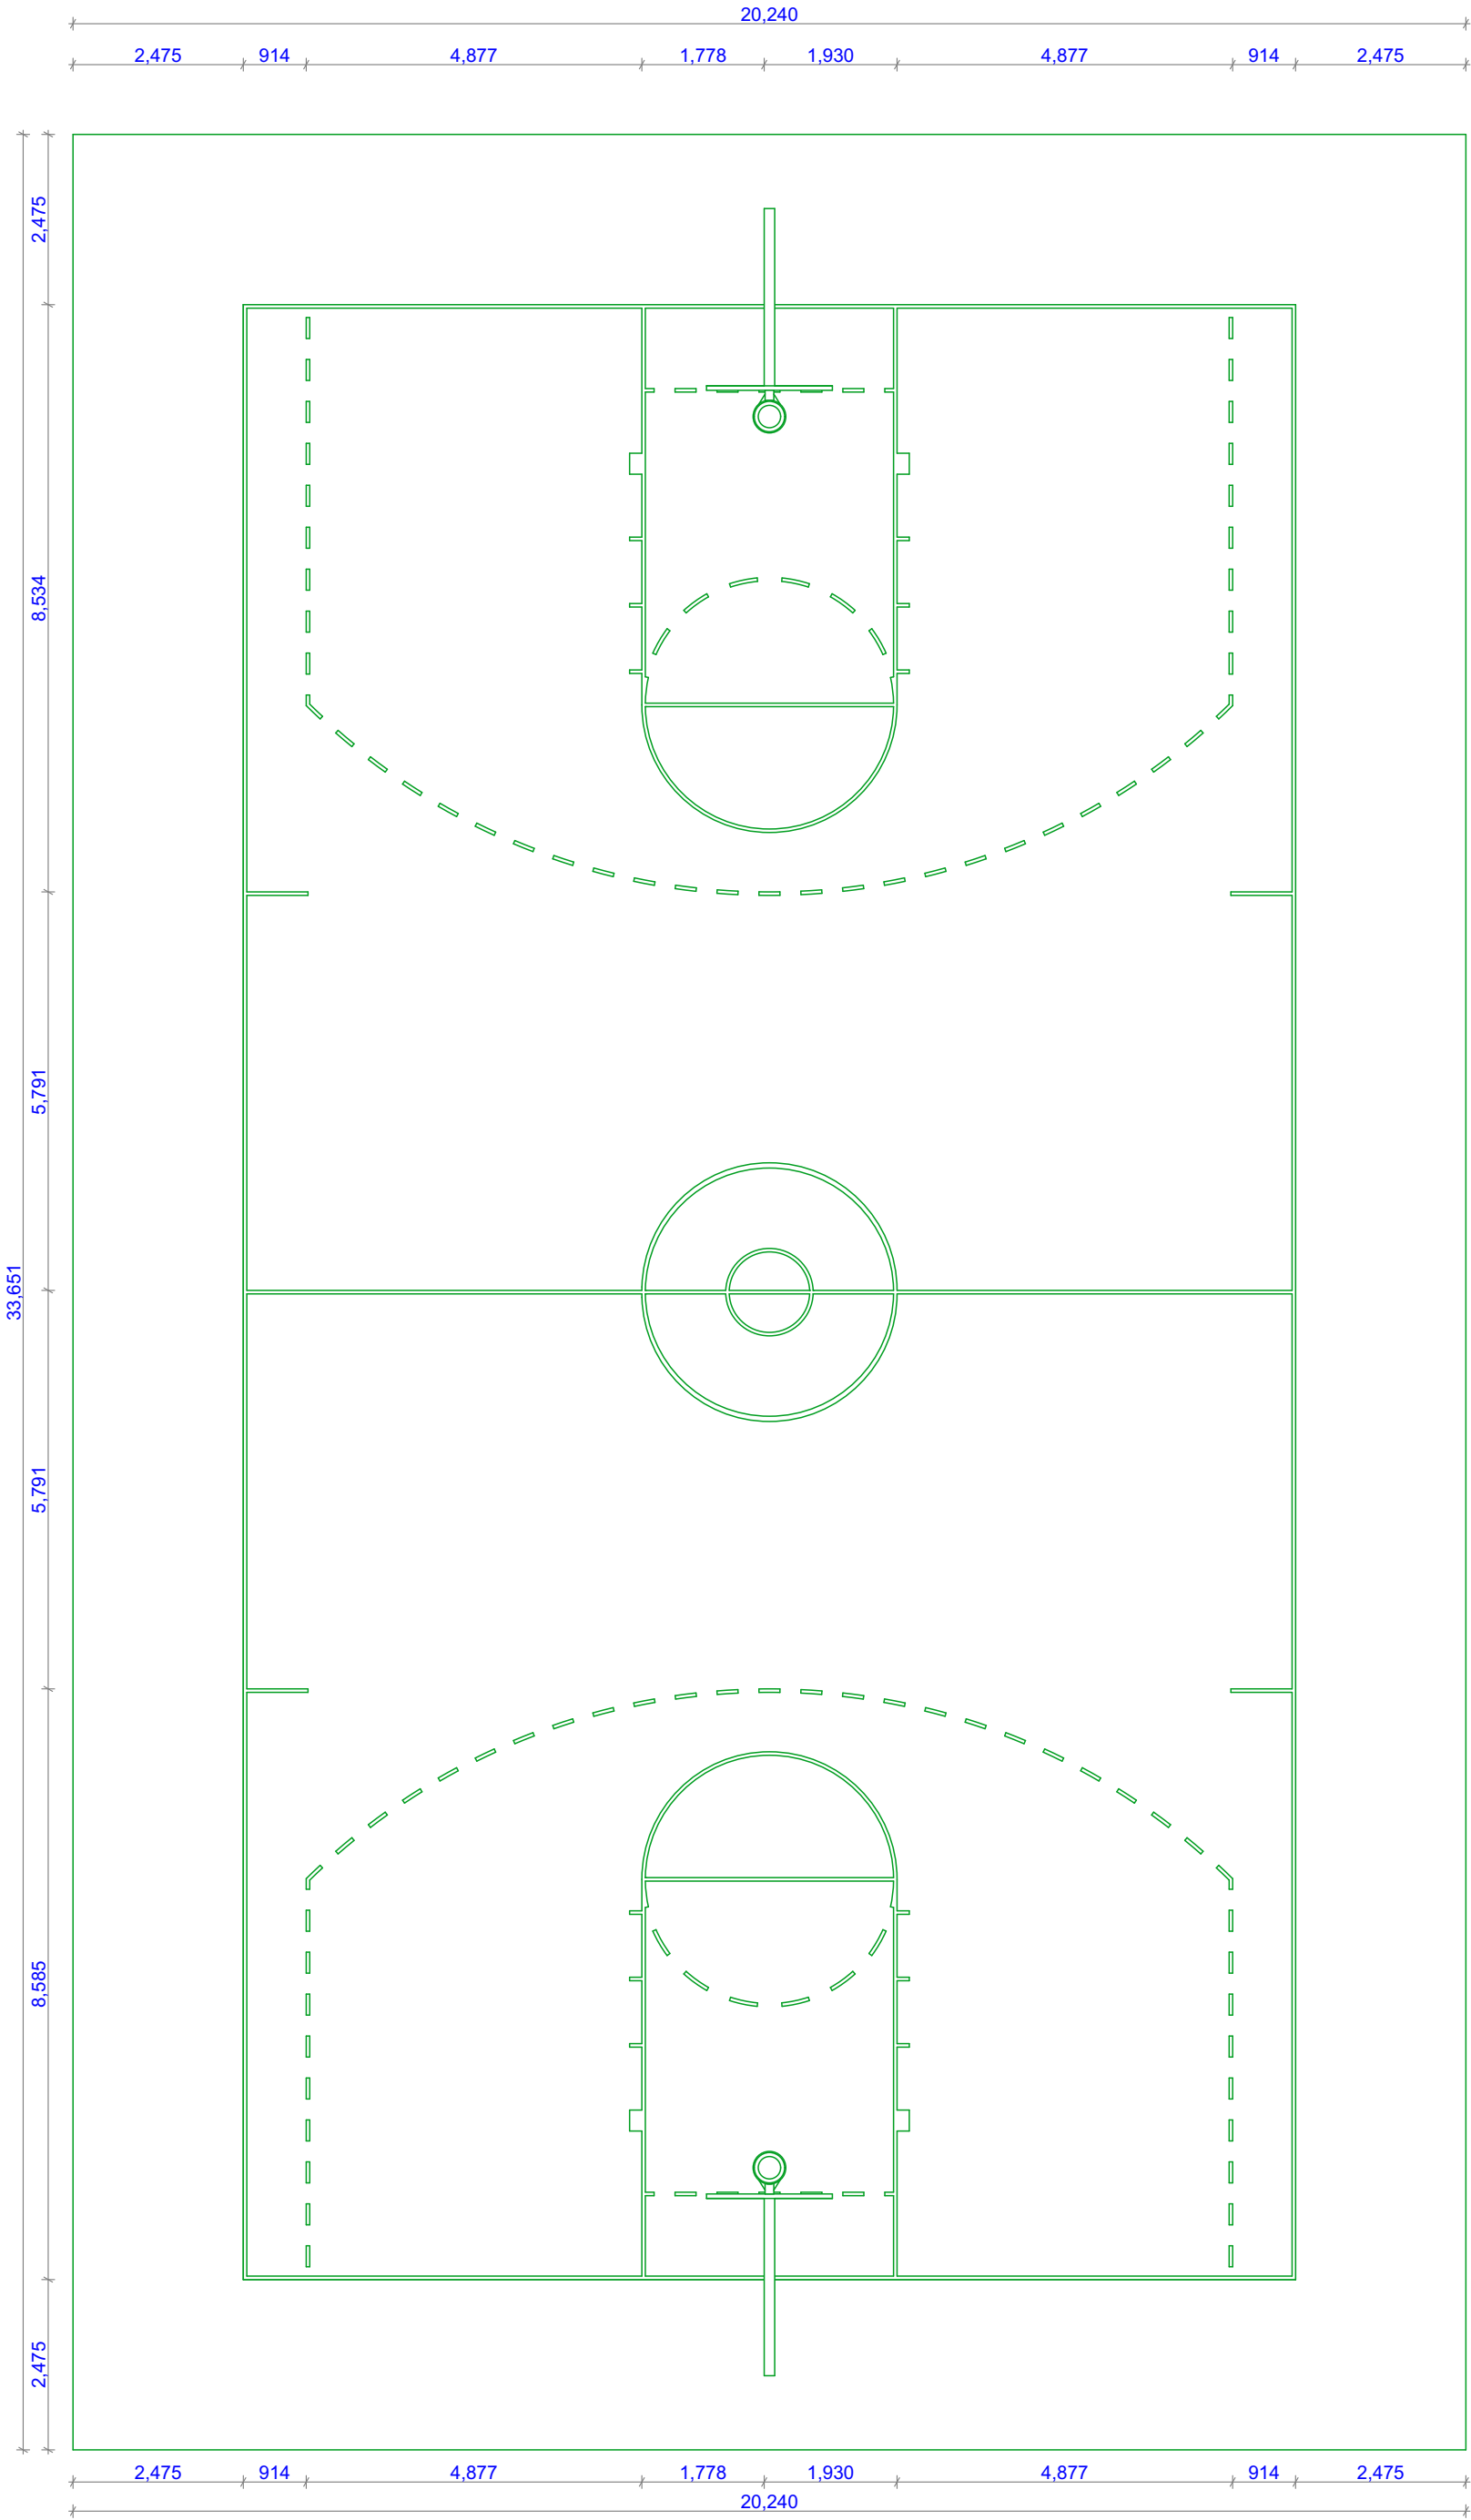

BASKETBALL COURT PLAN

FINISHES SCHEDULE				
<div><div><div><div>Floor</div><div>Ceiling</div><div>Walls</div><div>Skirting</div></div></div><div><div>1. 1:3 mix cement sand floor screed not less than 20mm level or to fall as necessary.</div><div>3. 50mm thick 600x600mm precast concrete paving slabs laid on and including 50mm sand bed and pointed in cement and sand.</div><div>4. 3 coats of approved plastic emulsion paint to 13mm 1:2:3 cement sand lime mix plastered surfaces of internal wall/ceiling surface.</div><div>5. fair face finish to machine cut external walls with cement sand (1:3) mix mortar pointing forming half round recessed joints.</div></div></div>				
NOTES				
<div><div>1. All dimensions in mm unless stated otherwise.</div><div>2. Only figured dimensions to be used.</div><div>3. All dimensions to be checked on site and any discrepancy referred to the Architect.</div><div>4. All foundations to be carried to hard ground bottom to structural engineer's details and specifications.</div><div>5. All reinforced concrete works to structural engineer's details and specifications.</div><div>6. All drain pipes passing under the slab to be encased in 150mm thick concrete.</div><div>7.Pv denotes permanent ventilations above doors and window openings where shown except toilets and bathrooms doors.</div><div>8. D.P.C denotes damp proof course to be provided on all walls at least 150mm above ground level.</div><div>9. All soil vent pipes to be provided with dome on top.</div><div>10 . Water meter to be 300mm above ground level.</div><div>11. 75mm diameter rain water down pipes to be provided with rain water trough off shoe away from the wall.</div><div>12. All drains and plumbing works to be constructed according to by-laws.</div><div>13. All walls less than 200mm thick to be reinforced with hoop iron at every alternative courses.</div></div>				
REVISIONS				
REF	AMENDMENTS	PARTICULARS	DATE	INITIAL
REFERENCE DRAWINGS				
Drawn by: Nyongesa S.K		Date: FEBRUARY 2018		
Checked by: E.M.P.N.G.J.W & W.				
Architect				
CM NYONGESA S.K				
BACHELOR OF THE BUILT ENVIRONMENT (CONSTRUCTION MANAGEMENT) YEAR FOUR				
PROJECT B 2017/2018				
REG:EABQ/01775/2014				
Client THE TECHNICAL UNIVERSITY OF KENYA HAILLE SELLASIE AVENUE NAIROBI				
Signature: P.O. BOX: 52428 - 00200 , NAIROBI - KENYA TEL: E-mail:				
Location: 11381/19 NAIROBI				
LR NO.....COUNTY				
Jurisdiction: BCM DEGREE FULFILMENT				
Job Title: VOLLEYBALL & BASKETBALL COURTS & SWIMMING POOLS FLOOR PLANS				
Drawing Title: SCHEME DESIGNS - PLAN, ELEVATIONS & SECTIONS				
Scale: 1:100 BUT NOT TO BE SCALED.				
Drawing No. 017/EABQ/01775/2014				