THESE PLANS ARE CERTIFIED AND DESIGNED FOR THIS STRUCTURE LOCATED AT THIS ADDRESS/LOT LOCATION ONLY. TO USE THESE PLANS TO BUILD IN OTHER LOCATIONS AND AVOID ANY COPYRIGHT OR LICENSE INFRINGEMENT, IT IS NECESSARY TO CONTACT MARTIN ENGINEERING, LLC. TO RECEIVE A SITE SPECIFIC DESIGN AND RELEASE FOR ANY EXTENDED USAGE.



CONSTRUCTION PLANS FOR NEW SINGLE FAMILY AT PARCEL ID: 2848-001-004 OCALA, FL 34471

GENERAL NOTES:

- 1. IT IS THE INTENT THAT THIS WORK BE IN CONFORMANCE WITH THE **2020 FLORIDA BUILDING CODE, TTH ED. RESIDENTIAL** AND ALL AUTHORITIES HAVING JURISDICTION OVER THIS TYPE OF CONSTRUCTION AND OCCUPANCY. CONTRACTOR SHALL DO THEIR WORK IN CONFORMANCE WITH ALL APPLICABLE CODES AND REGULATIONS.
- 2. THE CONTRACTOR SHALL VERIFY ALL CONDITIONS AND DIMENSIONS AT THE JOBSITE PRIOR TO COMMENCING WORK. CONTRACTOR SHALL REPORT ALL DISCREPANCIES THE DRAWINGS AND EXISTING CONDITION TO THE ENGINEER PRIOR TO COMMENCING WORK.
- 3. THESE DOCUMENTS, AS INSTRUMENTS OF SERVICE, ARE THE PROPERTY OF THE ENGINEER AND MAY NOT BE USED OR REPRODUCED WITHOUT EXPRESSED WRITTEN CONSENT OF THE ENGINEER.
- 4. ALL DETAILS AND SECTIONS SHOWN ON THESE DRAWINGS ARE INTENDED TO BE TYPICAL AND SHALL BE CONSTRUED TO APPLY TO ANY SIMILAR SITUATION ELSEWHERE IN THE WORK, EXCEPT WHERE A DIFFERENT DETAIL IS SHOWN.
- 5. CONTRACTOR WILL INCORPORATE ALL NECESSARY LOCAL/STATE/FEDERAL BUILDING, FIRE, AND HANDICAP CODES INTO THE DESIGN AND BASE PROPOSAL FOR A COMPLETE TURN-KEY PROJECT.
- 6. PROJECT SHALL BE TURNED OVER TO OWNER IN A CLEAN CONDITION WITH ALL TRASH AND DEBRIS REMOVED FROM SITE. ALL WINDOWS AND CLASS CLEAN, ALL FLOORS CLEAN, ALL HORIZONTAL SURFACES DUSTED AND CLEANED, AND ALL PLUMBING AND TOILET FIXTURES CLEAN AND IN GOOD WORKING ORDER. CONTRACTOR SHALL HAUL ALL RUBBISH FROM SITE ON A REGULAR BASIS. DO NOT ALLOW TO ACCUMULATE.
- T. CONTRACTOR TO OBTAIN ALL PERMITS, PAY ALL FEES AND TAXES. CONTRACTOR SHALL GUARANTEE ALL MATERIALS & WORKMANSHIP FREE FROM DEFECTS. FOR A PERIOD OF NOT LESS THAN ONE (1) YEAR FROM THE DATE OF ACCEPTANCE. CORRECTION OF ANY DEFECTS SHALL BE COMPLETED WITHOUT ADDITIONAL CHARGE ION AND SHALL INCLUDE INCLUDE REPLACEMENT OR REPAIR OF ANY OTHER PHASE OF THE INSTALLATION WHICH MAY HAVE BEEN DAMAGED THEREBY.
- 8. DIMENSIONS INDICATED ON THE DRAWINGS IN REFERENCE TO EXISTING CONDITIONS ARE THE BEST AVAILABLE DATE OBTAINABLE, BUT ARE NOT GUARANTEED. BEFORE PROCEEDING WITH ANY WORK DEPENDENT ON THE DATA INVOLVED, THE CONTRACTOR SHALL FIELD CHECK AND VERIFY ALL DIMENSIONS, GRADES, LINES, LEVELS, OR OTHER CONDITIONS OF LIMITATIONS AT THE SITE TO AVOID CONSTRUCTION ERRORS. IF ANY WORK IS PERFORMED BY THE CONTRACTOR OR ANY OF HIS SUBCONTRACTORS PRIOR TO ADEQUATE VERIFICATION OF APPLICABLE DATA, AT RESULTANT EXTRA COST FOR ADJUSTMENT OR WORK AS REQUIRED TO CONFORM TO EXISTING LIMITATIONS, SHALL BE ASSUMED BY THE CONTRACTOR WITHOUT REIMBURSEMENT OR COMPENSATION BY THE OWNER.
- 9. A DESIGNATED LOCATION FOR STORAGE OF CONSTRUCTION MATERIAL AND EQUIPMENT SHALL BE DETERMINED BY THE OWNER AND IDENTIFIED AT THE PRE-CONSTRUCTION MEETING.
- 10. CONTRACTOR PERSONNEL ARE CONFINED TO AREAS OF BUILDING NECESSARY FOR COMPLETION OF WORK, FREE ACCESS TO ALL PARTS OF THE BUILDING IS NOT ALLOWED.
- 11. CONTRACTOR IS RESPONSIBLE FOR SCHEDULING DELIVERY, RECEIVING, UNLOADING, UNCRATING, SORTING, SETTING IN PLACE, AND PROTECTING FROM DAMAGE ALL NEW EQUIPMENT FURNISHED BY THE CONTRACTOR. THIS SHALL ALSO APPLY TO ITEMS FURNISHED BY THE OWNER TO THE CONTRACTOR.
- 12. TERMITE PROTECTION SHALL BE PROVIDED BY REGISTERED TERMITICIDES, INCLUDING SOIL APPLIED PESTICIDES, BAITING SYSTEMS, AND PESTICIDES APPLIED TO WOOD, OR OTHER APPROVED METHODS OF TERMITE PROTECTION LABELED FOR USE AS A PREVENTATIVE TREATMENT TO NEW CONSTRUCTION. UPON COMPLETION OF THE APPLICATION OF THE TERMITE PROTECTIVE TREATMENT, A CERTIFICATE OF COMPLIANCE SHALL BE ISSUED TO THE BUILDING DEPARTMENT BY THE LICENSED PEST CONTROL COMPANY THAT CONTAINS THE FOLLOWING STATEMENT: THE BUILDING HAS RECEIVED A COMPLETE TREATMENT FOR THE PREVENTION OF SUBTERRANEAN TERMITES. TREATMENT IS IN ACCORDANCE WITH THE RULES AND LAWS ESTABLISHED BY FLORIDA DEPARTMENT OF AGRICULTURE AND CONSUMER SERVICES.
- 13. TERMITE PROTECTION TO BE DONE AFTER ALL EXCAVATION, BACKFILLING AND COMPACTION IS COMPLETE. ANY DISTURBED SOIL TREATMENT MUST BE RETREATED.
- 14. TREATMENT SHALL BE PROTECTED FROM RAINFALL BY 6 MIL VAPOR BARRIER. IF RAINFALL OCCURS BEFORE BARRIER PLACEMENT, SOIL MUST BE RETREATED.
- 15. PROTECTIVE SLEEVES AROUND METALLIC PIPING PENETRATING CONCRETE SLAB-ON-GRADE FLOORS SHALL BE NON-CELLULOSE CONTAINING MATERIALS AND RECEIVE AN APPLICATION OF TERMITICIDE IN ANNULAR SPACE BETWEEN SLEEVE AND PIPE.

ELECTRICAL NOTES:

- 1. ALL ELECTRICAL WIRING TO BE IN ACCORDANCE WITH 2020 FLORIDA BUILDING CODE, 7TH EDITION, RESIDENTIAL AND 2018 NATIONAL ELECTRIC CODE (NEC).
- 2. ALL SMOKE DETECTORS AND CARBON MONOXIDE DETECTORS SHALL BE IN ACCORDANCE WITH THE 2020 FLORIDA BUILDING CODE, TTH EDITION.
- 3. ELECTRICAL CONTRACTOR SHALL PROVIDE ARC-FAULT CIRCUIT INTERRUPTERS IN LIVING, DINING HALLWAYS, AND BEDROOMS PER 2020 FBC R3902.12
- 4. ALL OUTDOOR RECEPTACLES SHALL BE PROTECTED FROM MOISTURE PER 2017 FBC R3905.11
- 5. ALL PERMANENTLY INSTALLED LIGHTING FIXTURES SHALL COMPLY WITH THE MINIMUM REQUIREMENTS PER FBG-ENERGY CONSERVATION R404.
- 6. ELEVATORS SHALL BE IN ACCORDANCE WITH FBC 2020, 7TH ED, SECTION R321.1

MECHANICAL NOTES:

- 1. ALL DUCT SIZING SHALL BE IN ACCORDANCE W/ ACCA MANUAL "D". PROVIDE DUCT TESTING IN ACCORDANCE W/ ASHRAE STANDARD 152.
- 2. DUCT LAYOUT AND ALL OTHER MECHANICAL COMPONENTS ARE SHOWN ON THE APPROVED DUCT LAYOUT PLAN INCLUDED IN THE ENERGY CALCULATION PACKAGE PERFORMED BY OTHERS.
- 3. ALL DUCTS & AIR HANDLERS NOT LOCATED IN CONDITIONED SPACE SHALL BE TESTED TO BE "SUBSTANTIALLY" LEAK FREE.
- 4. DUCTS IN GARAGE AND DUCTS PENETRATING THE WALLS OR CEILINGS SEPARATING THE DWELLING FROM THE GARAGE SHALL BE INSTALLED ACCORDING TO FBC R302.5.2
- 5. ALL INSULATION SPECIFICATIONS ARE INCLUDED IN THE ENERGY CALCULATION PACKAGE PERFORMED BY OTHERS. IF ANY INSTALLED INSULATION MATERIALS DO NOT MATCH THE ENERGY FORMS, NEW CALCULATIONS SHALL BE PERFORMED OR THE ORIGINAL APPROVED INSULATIONS SHALL BE INSTALLED.
- 6. ELEVATORS SHALL BE IN ACCORDANCE WITH THE FBC 2020, 7TH ED., SECTION R321.1

PLUMBING NOTES:

- 1. ALL WORK SHALL BE PERFORMED BY A LICENSED PLUMBING CONTRACTOR IN A FIRST-CLASS WORKMANLIKE MANNER. THE COMPLETE SYSTEM SHALL BE FULLY OPERATIVE.
- 2. ALL EXCAVATION & BACK FILL AS REQUIRED FOR THIS PHASE OF CONSTRUCTION SHALL BE A PART OF THIS CONTRACT,
- 3. ALL WORK SHALL BE COORDINATED WITH OTHER TRADES TO A VOID INTERFERENCE WITH THE PROCESS OF CONSTRUCTION.
- 4. VERIFY LOCATION, SIZE, TRAPS, INVERTS OF ALL EXISTING UTILITIES PRIOR TO BEGINNING CONSTRUCTION. ADVISE ENGINEER OF ANY DISCREPANCIES. ANY COST RES UL TING FROM DISCREPANCIES NOT REPORTED AT THIS TIME SHALL BE PAID BY THE CONTRACTOR.
- 5. WATER PIPING TO BE TYPE "M" OR TYPE "L" COPPER ABOVE OR BELOW GRADE.
- 6. SOIL, WASTE & VENT PIPING TO BE PVC. #40 DVW.
- 7. ALL FIXTURES MUST BE PROVIDED WITH READILY ACCESSIBLE STOPS
- & . WHERE DISSIMILAR METALS ARE TO BE JOINED, APPROVED INSULATING UNIONS SHALL BE USED. 9. INSULATE HOT WATER LINES WITH 1" THICK SNAP ON INSULATION FIRST & FEET FROM WATER
- 10. CONDENSATE LINES TO BE COPPER/PVC DEPENDING ON PROJECT REQUIREMENTS
- 11. INSULATE WITH 1/2" THICK ARMAFLEX INSULATION

BUILDING STRUCTURE INFORMATION:

CONDITIONED SPACE: 1ST FLOOR	1,951 S.F.
CONDITIONED YOLUME	17,559 CU.FT.
TYPE OF CONSTRUCTION	5B
OCCUPANCY:	R-3
FIRE SPRINKLERS:	NO
MAX HEIGHT OF STRUCTURE	<35'

	PLAN SHEETS
Label	Title
A-000	GENERAL NOTES
SITE	SITE PLAN
A-001	ELEVATIONS
A-002	ELEVATIONS
A-003	FLOOR PLAN
A-004	SECTIONS
A-005	SECTIONS
A-006	ROOF PLAN
E-001	ELECTRICAL LAYOUT
A-007	FLASHING DETAILS
A-008	FLASHING DETAILS

SITE MAP

N.T.S.

PROJ.#: 22-857 CODE: FBCR-2020 SHEET NUMBER

DRAWN: KCM

DATE: 1/20/2023

SITE

REVISION TABLE

NO. | DESCRIPTION | DATE

MARTIN ENGINEERING, LLC. 22-890-6445 Sandhill Road.3 JACKSONVILLE, FL 32259 904-472-1459 FL CA#32027

GENERAL NOTES
NEW SINGLE FAMILY
PARCEL ID: 2848-001-004
OCALA, FL 34471

CONTRACTOR:

HOLECHEK CONTRACTING, LLC.

ZONING INFORMATION:

RLD-90

FRONT B.R.L. - 20' SIDES B.R.L. - 5' REAR B.R.L. - 10'

MAX LOT COVERAGE - 45%

PROJECT STATISTICS:

LOT SIZE: 22,618 SQ. FT.

EXIST. SFR AREA: 3,005 SQ. FT.

DRIVEWAY/. WALKWAYS: 1,375 SQ. FT. (+/-)

PAVERS/POOL: 1,300 SQ. FT. (+/-)

NEW DETACHED GARAGE: 288 SQ.F.T.

TOTAL LOT COVERAGE: 5,968 SQ. FT (26.4%)

SCOPE OF WORK:

NEW DETACHED GARAGE STRUCTURE

SITE PLAN NOTES:

- 1. SITE SURVEY TO BE COMPLETED TO VERIFY PIN LOCATIONS AND HOME LOCATION PRIOR TO PLACEMENT OF ANY CONCRETE FOR FOUNDATIONS..
- 2. ALL SITE PLAN INFORMATION IS BASED ON SURVEY PROVIDED BY ASSOCIATED SURVEYORS, INC. DATED 9-5-1998
- 3. CALL BEFORE YOU DIG: DIAL 811 (SUNSHINE LOCATES)

	REVISION TABLE	
NO.	DESCRIPTION	DATE


MARTIN ENGINEERING, LLC. 22-890-6445 Sandhill Road.3 JACKSONVILLE, FL 32259 904-472-1459 FL CA#32027


SITE PLAN


NEW SINGLE FAMILY
PARCEL ID: 2848-001-004


OCALA, FL 34471


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DESIGNED: KCM	SCALE: NOTED	9
DRAWN: KCM	DATE: 1/20/2023	

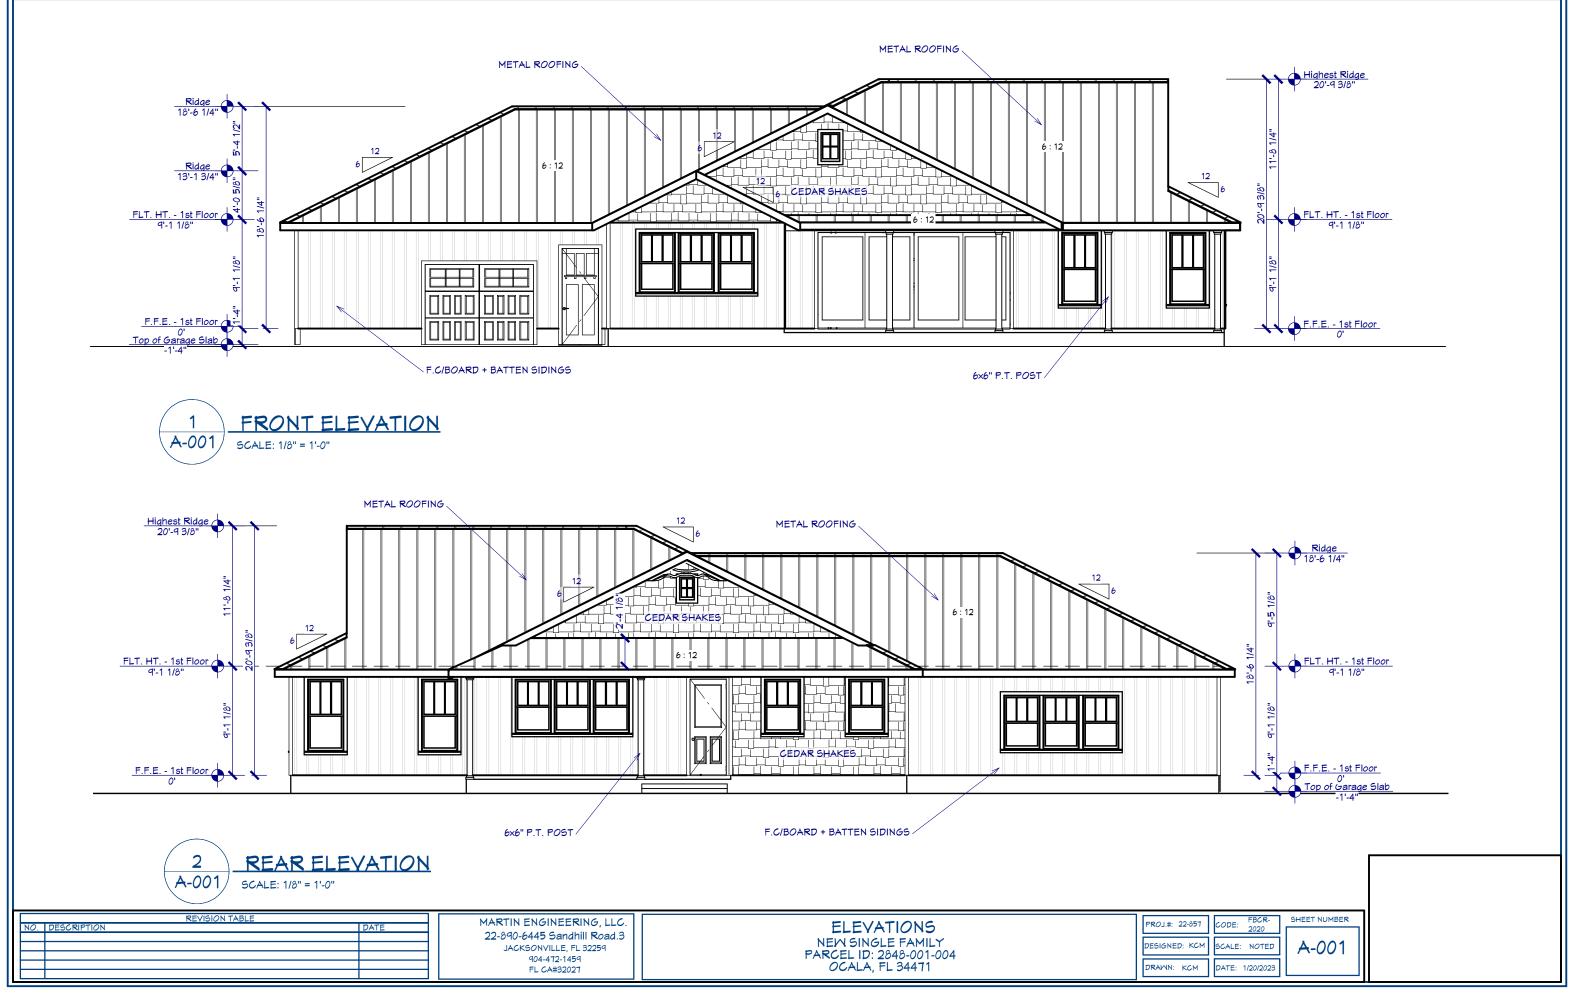


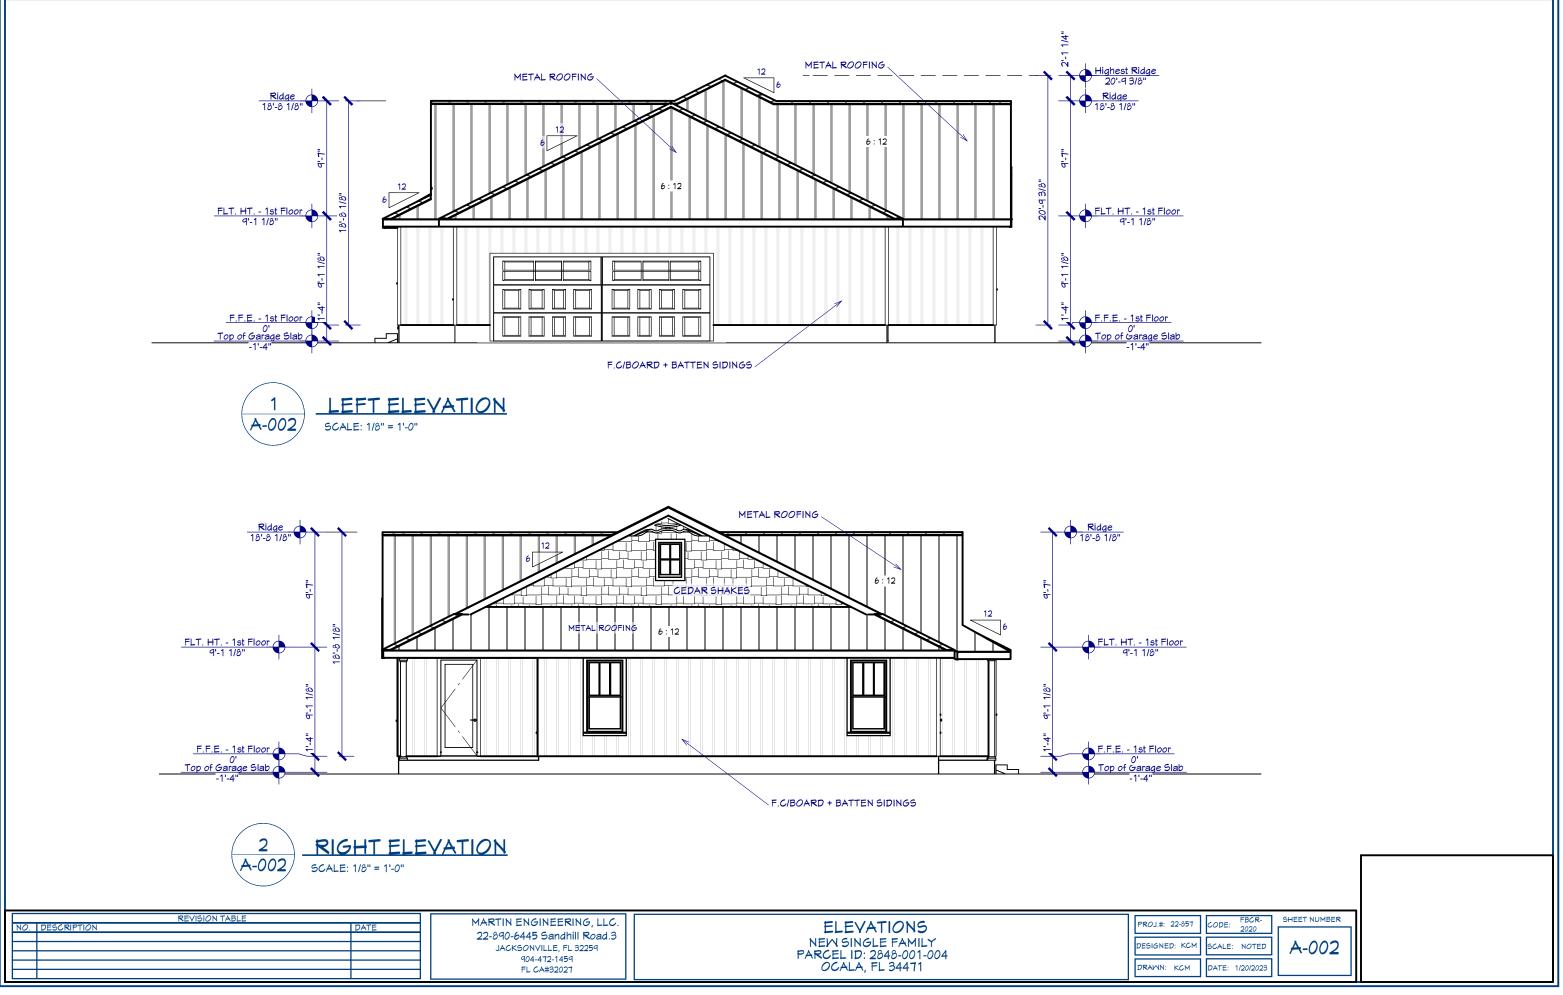

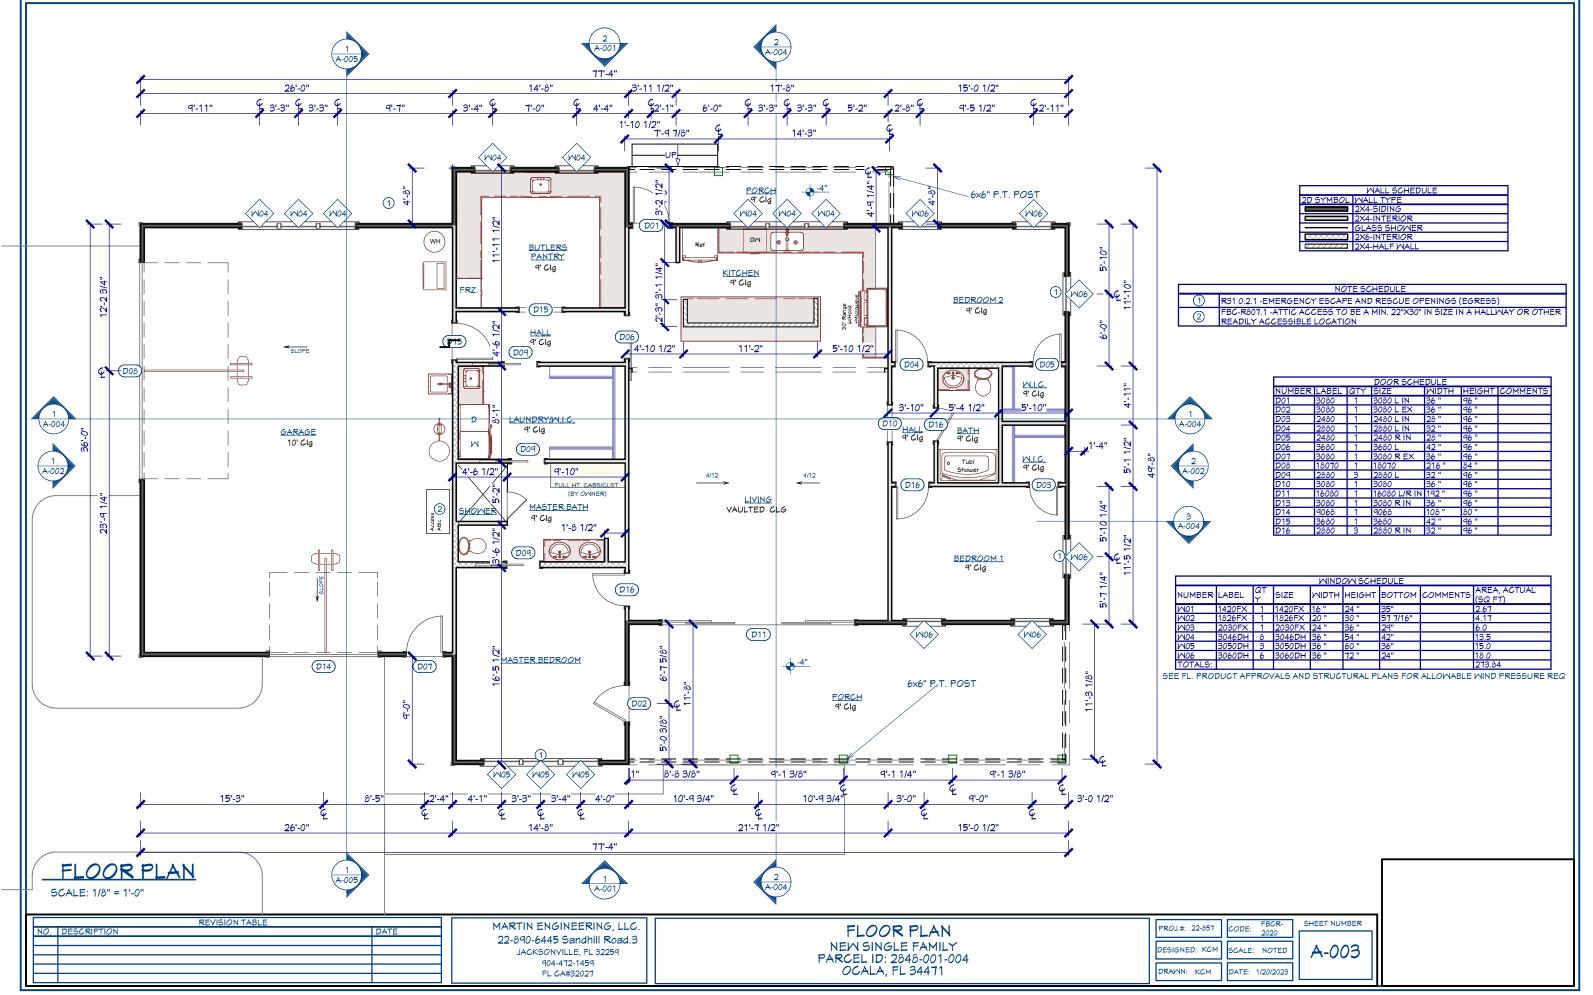


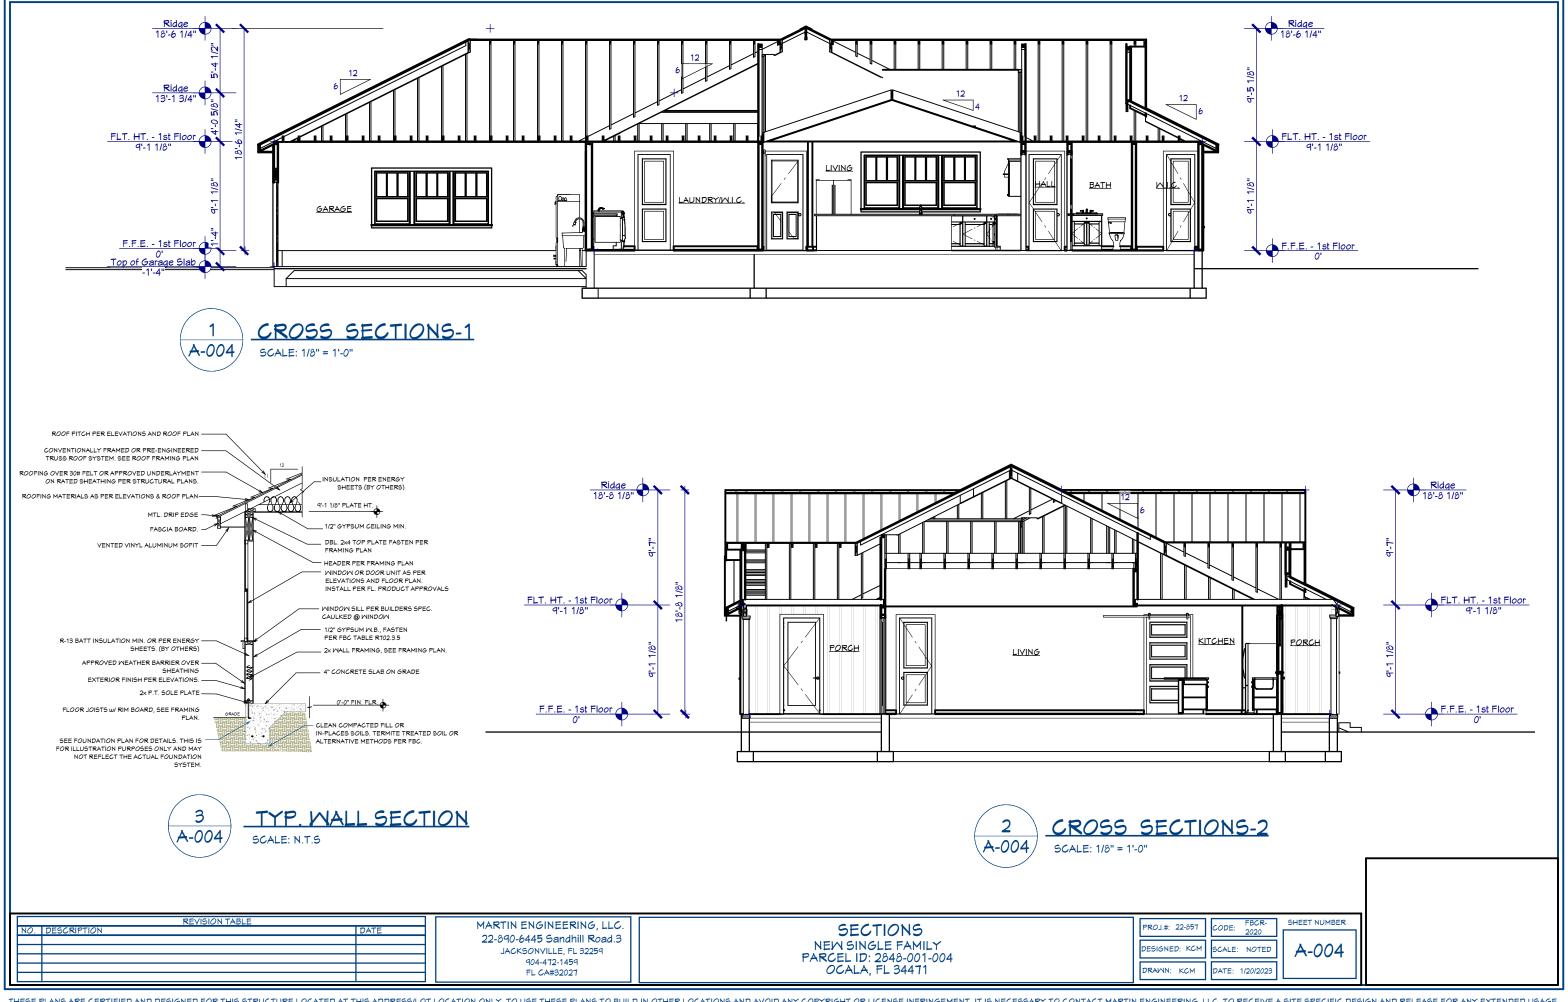

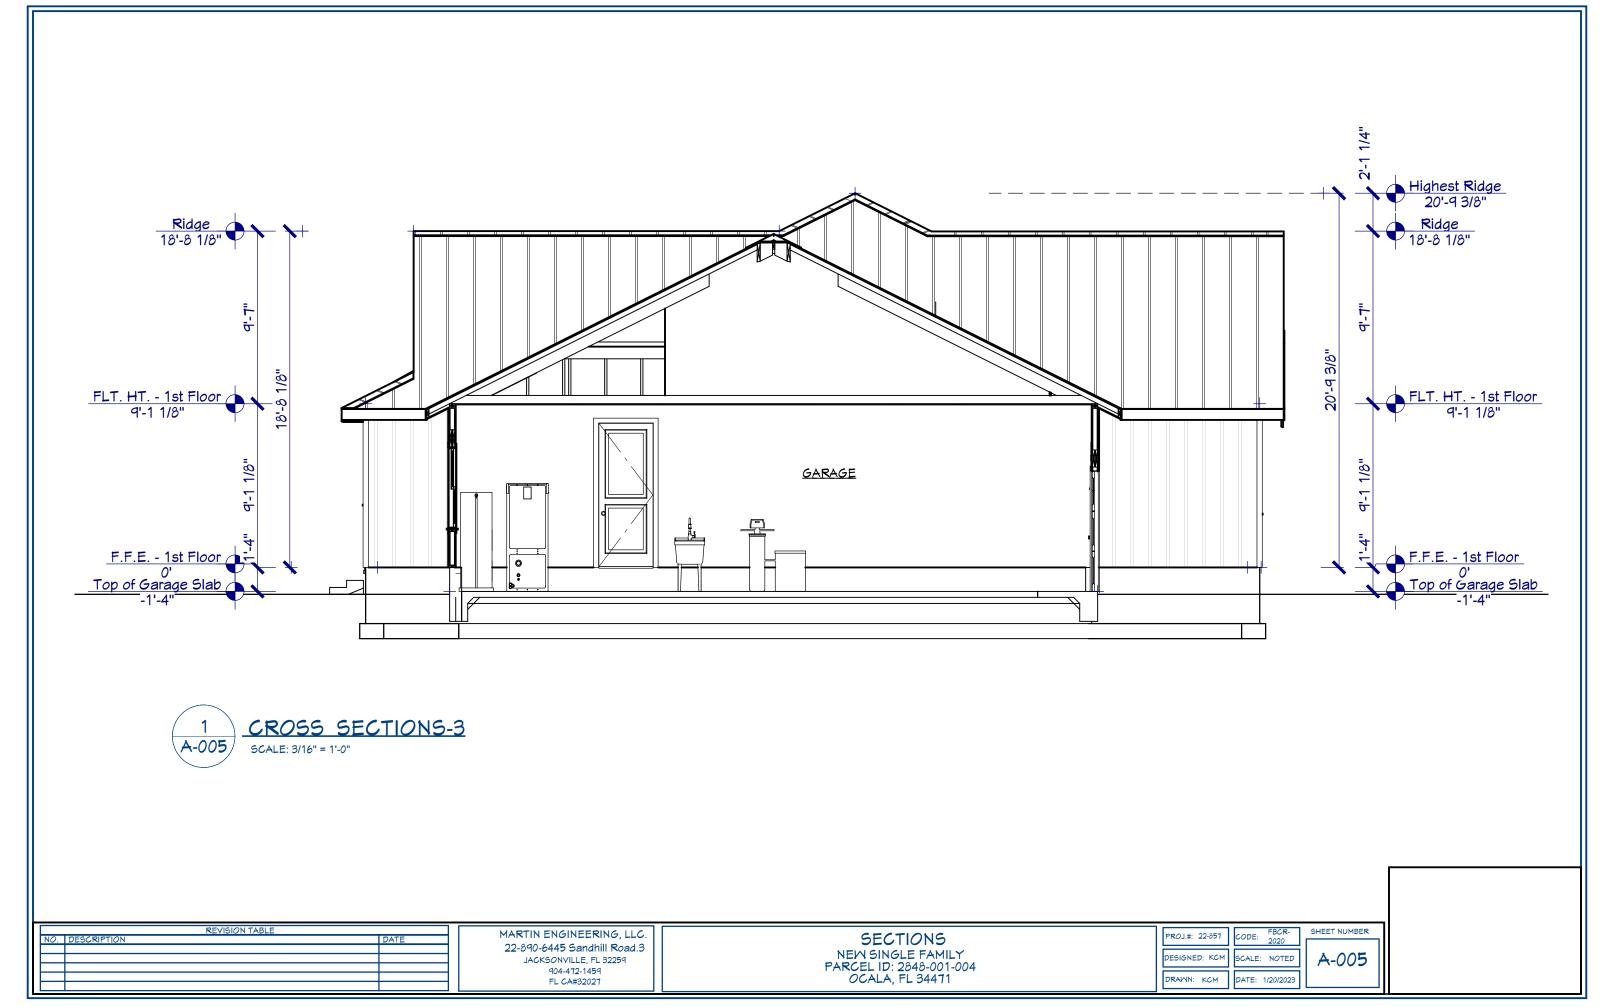

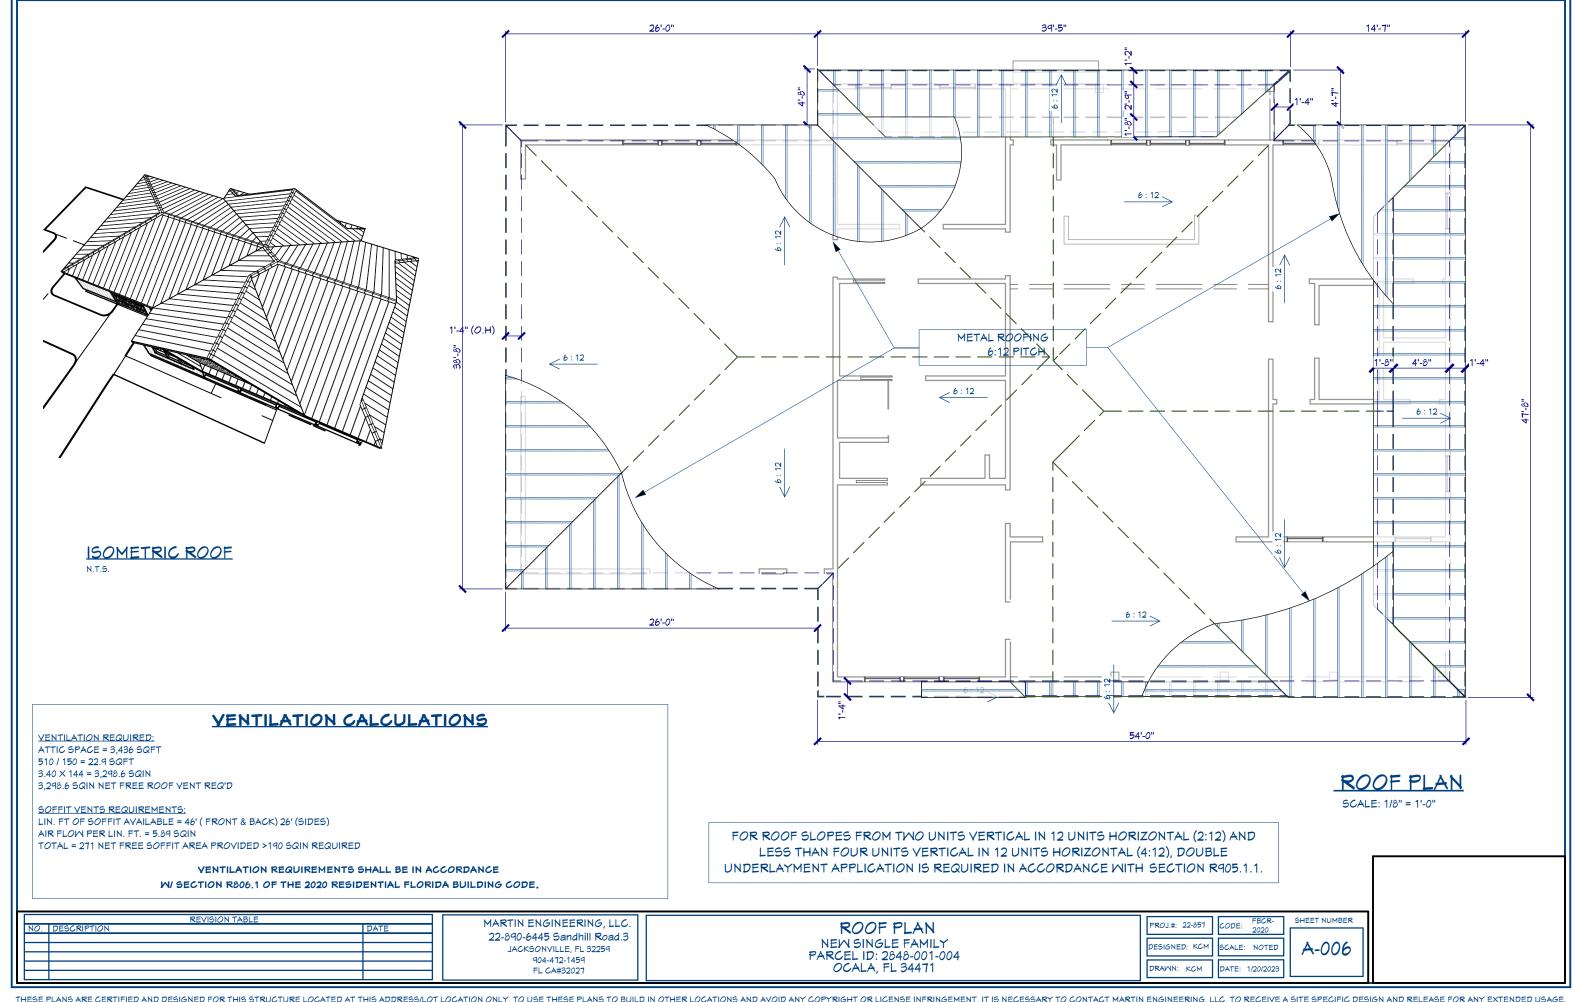

2D SYMB <i>O</i> L	QTY	ELECTRICAL SCHEDULE DESCRIPTION	COMMENTS
(R)	31	RECESSED DOWN LIGHT 6	
X	4	PORCH LANTERN	
•	3	GRAN ANDR <i>O</i> S 27 1/2"	
⊗ ♦	3	EXHAUST (LIGHT)	
ŭ	3	CONTEMPORARY GLASS SCONCE	
	4	LONG SURFACE MOUNTED FLUORESCENT LIGHT [96M9D]	
$\cancel{*}$	4	CONTEMPORARY (3 LIGHTS)	
ÇD	1	CLOTHES DRYER	
См	1	CLOTHES WASHER	
	22	DUPLEX	
\Diamond	2	DUPLEX, CEILING MOUNTED	FOR GARAGE DOOR OPENER
₩ _{RA}	1	ELECTRIC RANGE	
GFCI	16	GFCI	
Фм	1	MICROMAVE	
$\bigcirc_{\!\!\!\!R}$	2	REFRIGERATOR	
\$	23	SINGLE POLE	
\$3	4	THREE MAY	
\$4	3	FOUR WAY	
C5/TV	4	CAT5 W TV	
CO/SD	4	COISMOKE DETECTOR	

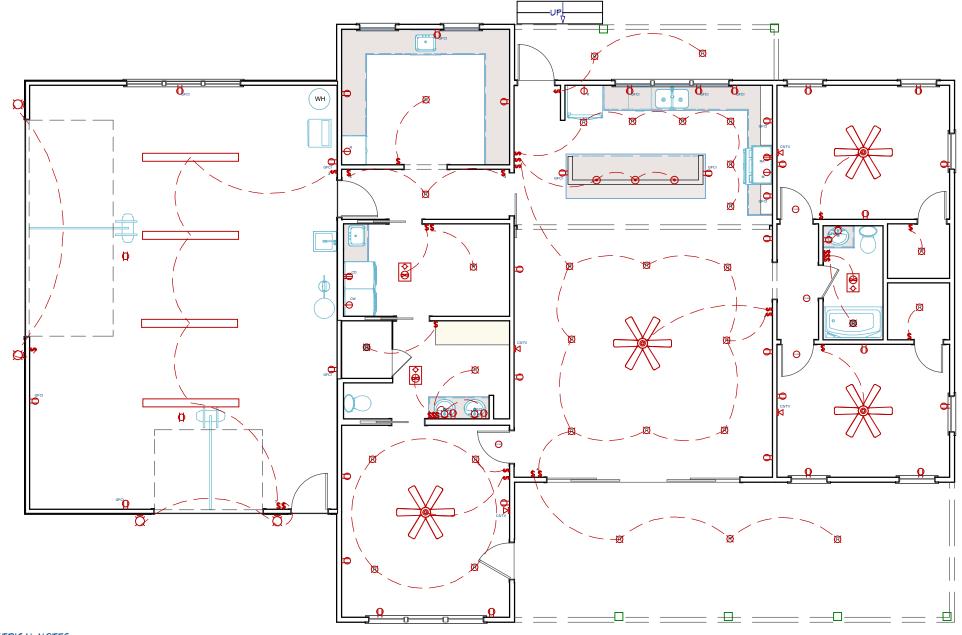

ELECTRICAL NOTES:

- 1. ELECTRICAL CONTRACTOR SHALL PROVIDE ARC-FAULT CIRCUIT INTERRUPTERS IN ALL BRANCH CIRCUITS THAT SUPPLY 120-VOLT, SINGLE PHASE, 15 & 20 AMP OUTLETS IN LIVING ROOMS, DINING ROOMS, HALLWAYS, BEDROOMS, DENS, SUNROOMS, RECREATION ROOMS, CLOSETS, OR SIMILAR AREAS PER 2017 FBC R3902.16
- 2. ALL PERMANENTLY INSTALLED LIGHTING FIXTURES SHALL COMPLY WITH THE MINIMUM REQUIREMENTS FOR HIGH-EFFICACY LAMPS PER FBC-ENERGY CONSERVATION R404

ELECTRICAL LAYOUT

SCALE: 3/16" = 1'-0"

REVISION TABLE	MARTIN ENGINEERING, LLC.	TI TOTOLON IN ANOUT	PROJ.#: 22-857 CODE: FBCR- SHEET NUMBER
REVISION TABLE NO. DESCRIPTION DATE	1 1	ELECTRICAL LAYOUT	PROJ.#: 22-051 CODE: 2020
	22-890-6445 Sandhill Road.3	NEW SINGLE FAMILY	DECICNED, ROM CONE, NOTED E 001
	JACKSONVILLE, FL 32259	PARCEL ID: 2848-001-004	DESIGNED: NOM SCALE: NOTED E-001
	904-472-1459 FL CA#32027		
	FL CA#32027	OCALA, FL 34471	DRAMN: KCM DATE: 1/20/2023

MEATHER BARRIER ROOFING PLACE SHINGLES 3/8" OVER EAVE & RAKE EDGES TO PROVIDE DRIP EDGE TYPICAL WALL WOOD SIDING TYVEK HOMEWRAP VALLEY SHINGLE INSTALLATION: INSTALL SHINGLES USING WEAVE METHOD 1. EXTEND (1) FULL END SHINGLE MIN. 12" PAST CENTER LINE OF VALLEY, SEE MANUF WRITTEN INSTRUCTION FOR ADDITIONAL INSTALLATION ALONG RAKES, CEMENT SHINGLES TO UNDERLAYMENT & EACH OTHER IN A 4" WIDTH-OF ASPHALT PLASTIC ROOF 7/16" PLYWOOD SHEATHING 2"x4" WOOD STUDS w/ R13 BATT INSULATION 1/2" GYPSUM BOARD 2. DO NOT NAIL 6" MIN. FROM VALLEY CENTER LINE NON-CORRODING MTL EAVE DRIF TRIM 6"-7" FROM END LAP AND TAPE TYVEK AT JOINTS TRIM TABS FROM ALL FIBERGLASS SHINGLE ROOFING OVER 15# FELT OVER 7/16" OSB OVER PRE-ENG WD TRUSSES STARTER COURSE-SHINGLES STARTER COURSE PLACE SHINGLES CLOSE TOGETHER BUT DO NOT CROWD **UNDER** LAYMEN OVER EAVE & RAKE EDGES TO PROVIDE DRIP VALLEY FLASHING DETAIL FIRST COURSE STUCCO/CV FINISH ASSEMBLY LAP BARRIER OVER NAILING FLANGE 11-1/2" to 12-1/2" 11-1/2" to 12-1/2" 1" to 1-1/2" 1" to 1-1/2"-VINYL DRIP/WEEP SCREED 5"x5" METAL FLASHING TYPICAL WALL ISOMETRIC KICK-OUT RESIDENTIAL WOOD FRAME STRUCTURE W/ WOOD SIDING (COOLING CLIMATE) DETAIL) SHINGLE NAILING NOTE: DETAILS ARE FOR SLOPES OF 3:12 OR GREATER, FOR SLOPES BELOW 3:12, ALL ROOFING UNDERLAYMENT SHALL BE SELF ADHERING SHEET MEMBRANE APPROVED BY THE SHINGLE MANUFACTURER FOR USE ON LOW SLOPE ROOFING PROJECTS — FELT UNDERLAYMENT SHINGLE ROOFING - MTL DRIP EDGE NOTE: INSTALL KICKOLIT FLASHING AT BOTTOM OF ROOF & WALL INTERSECTIONS ROOFING SHINGLES MEMBRANE TYPE EAVE WATER TIGHT SEAL WALL/KICKOUT FLASHING DETAIL PROTECTION (48" HIGH MIN.) ROOF SHEATHING c/w H CLIPS 2"x2" WOOD FURRINGS 1/2" PLYWOOD WOOD ROOF RAFTERS FIBERGLASS SHINGLE ROOFING OVER WALL SHEATHING UNDERLAYMENT BATT INSULATION SYN WD SIDING OVER - APPROVED WEATHER BARRIER INSTALL SHINGLES OVER OFF-RIDGE VENT FLANGE AT CEILING JOISTS GALVANIZED METAL OFF-RIDGE 1/2" GYPSUM BOARD CUT PLYWOOD TO **EXTEND** VENT WITH BAFFLE. SET IN PLASTIC ROOF CEMENT OF LAP WEATHER BARRIER OVER ALLOW FOR VENTILATION TYVEK HEADER WRAPÂ METAL FLASHING AND SECURE WITH STARTER STRIP SEALANT AT TOP PLATE BETWEEN WOOD FURRINGS OVER SHEATHING SCREEN EXTEND 15# ROOFING FELT TAPE TYVEK AT JOINTS INSTALL OFF-RIDGE VENT FLANGE OVER SHINGLES AT BASE 5x5 METAL FLASHING OVER - ROOFING FELT (NAIL TO ROOI DECK NOT WALL SHEATHING) 7/16" OSB OVER PRE-ENG WD CAP SHINGLE - DO NOT NAIL - EAVESTROUGH 1/2" GYPSUM BOARD - SHINGLE ROOFING (SEAL ALL JOINTS/ & PENETRATIONS) **FASCIA** ROOF CEMENT-NOTES: 1. INSTALL IN STRICT ACCORDANCE WITH MANUFACTURERS WRITTEN INSTRUCTIONS 2. APPLY ROOFING CEMENT OR SELF-ADHE FLASHING OVER FLANGE AT HEAD ONLY VENTED SOFFIT TYPICAL WALL WOOD SIDING TYVEK HOMEWRAP WALL FLASHING DETAIL - LAP SIDING 7/16" PLYWOOD SHEATHING OFF-RIDGE VENT FLASHING DETAIL 2"x4" WOOD STUDS w/ R-13 BATT INSULATION 1/2" GYPSUM BOARD N.T.S. ROOF/ WALL INTERFACE DETAIL RESIDENTIAL WOOD FRAME STRUCTURE w/ WOOD SIDING (COOLING CLIMATE) SHEET NUMBER MARTIN ENGINEERING, LLC. PROJ.#: 22-857 FLASHING DETAILS 22-890-6445 Sandhill Road.3 NEW SINGLE FAMILY DESIGNED: KCM CALE: NOTED A-007 JACKSONVILLE, FL 32259 PARCEL ID: 2848-001-004 904-472-1459

FL CA#32027

OCALA, FL 34471

DRAWN: KCM

DATE: 1/20/2023

