





M.E. RINKER, Sr. HALL
SCHOOL OF BUILDING CONSTRUCTION

UNIVERSITY OF FLORIDA-GAINESVILLE
PROJECT NO. BR-191

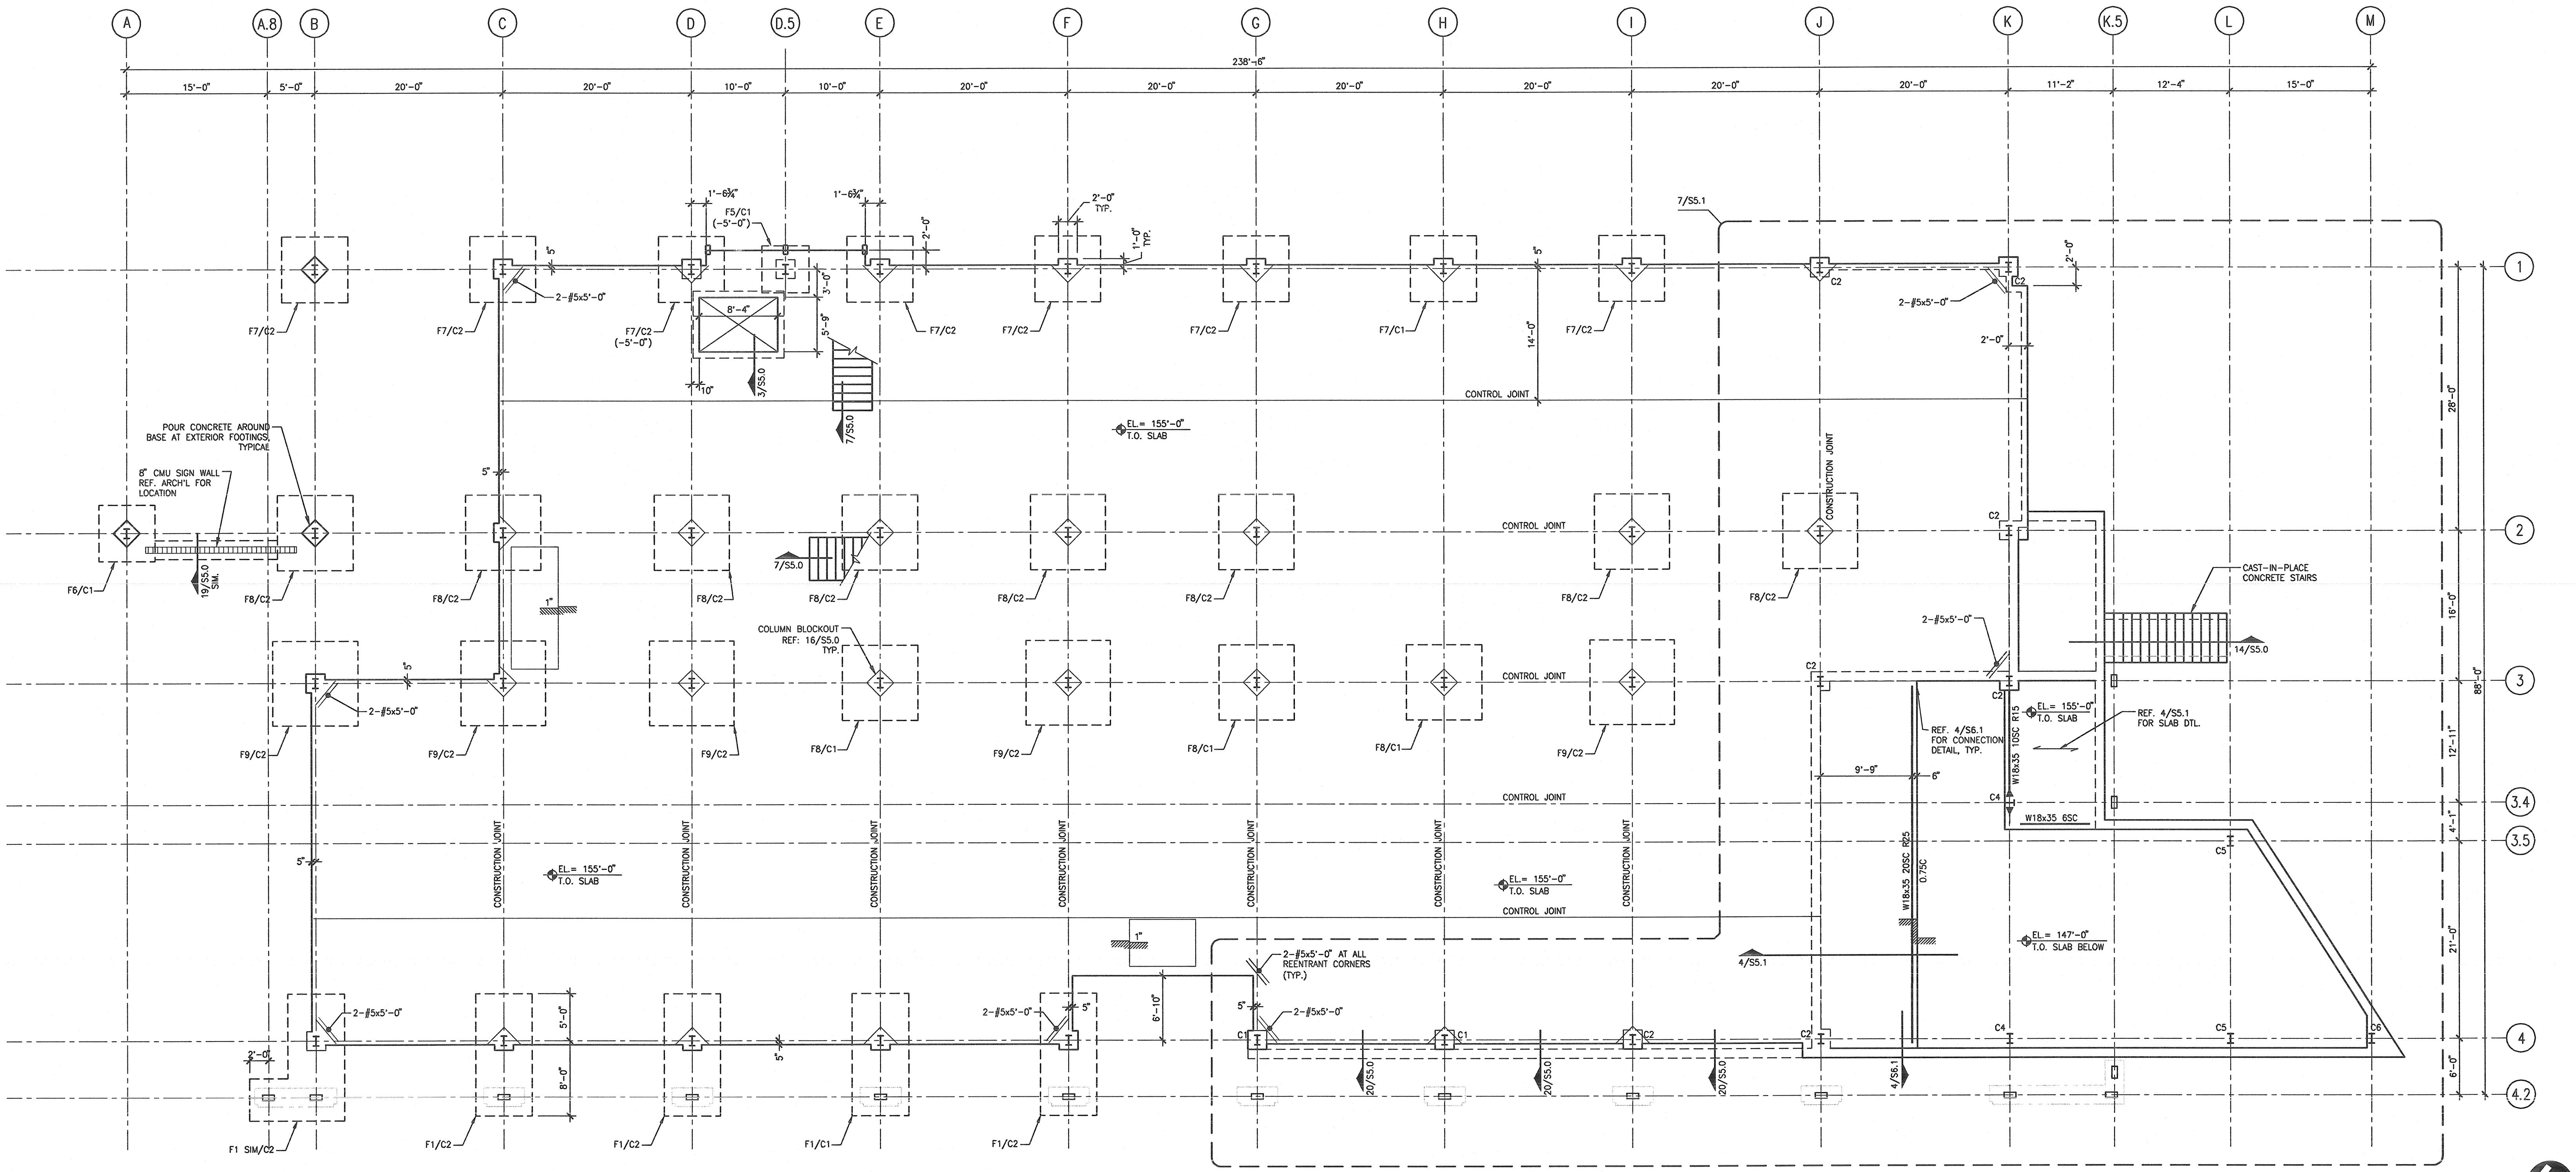

1 1/8" = 1'-0" PLAN

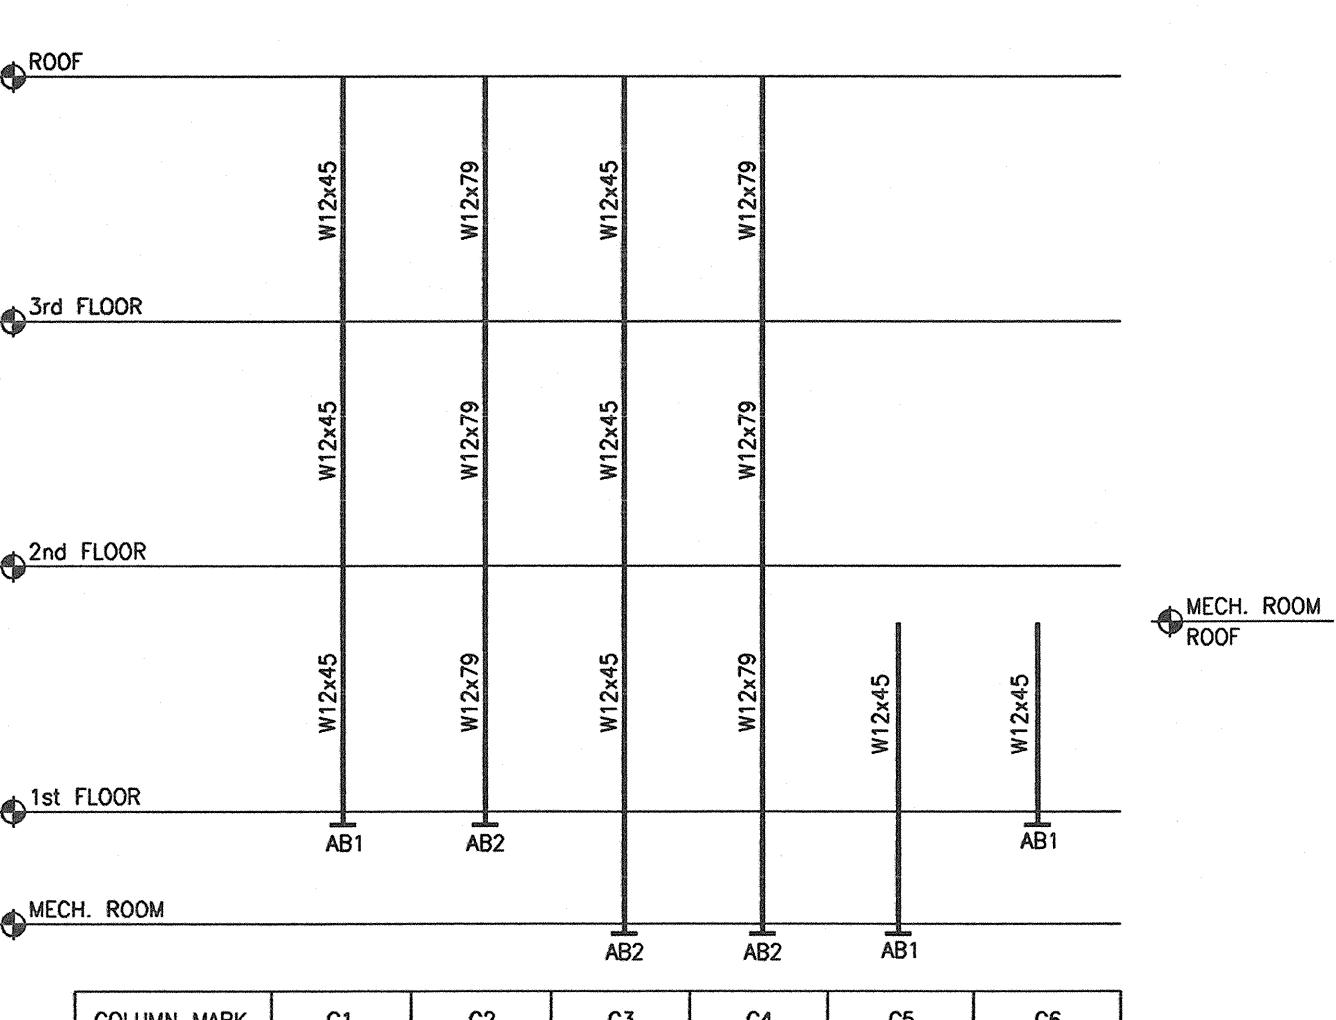

COLUMN SCHEDULE

4 N.T.S. SCHEDULE

SPREAD FOOTING SCHEDULE					
MARK	SIZE IN PLAN	THICKNESS	REINFORCEMENT EA. WAY		
			BOTTOM	TOP	
F1	6'-0" x 13'-0"	18"	#8-#12	#6-#12	
F5	5'-0" x 5'-0"	18"	5-#8	5-#8	
F6	6'-0" x 6'-0"	18"	6-#8	6-#8	
F7	7'-0" x 7'-0"	18"	7-#8	7-#8	
F8	8'-0" x 8'-0"	24"	8-#8	8-#8	
F9	9'-0" x 9'-0"	24"	9-#8	9-#8	
F10	10'-0" x 10'-0"	24"	10-#8	10-#8	

NOTE: BASE PLATES TO BE 20x20x1 GRADE 50, TYPICAL U.N.O.
SEE 18/S5.0 FOR PLATE REQUIREMENTS AT CONCRETE PLINTHES.

2. REF. 18/S5.0 FOR ANCHOR BOLT SIZE.

COLUMN SCHEDULE

4 N.T.S. SCHEDULE

SPREAD FOOTING SCHEDULE

3 NONE SCHEDULE

- FOUNDATION / S.O.G. NOTES:
1. SLAB ON GRADE TO BE 5" THICK, 4000 PSI NORMAL WEIGHT CONCRETE REINFORCED WITH WWF 6x6-W2.9w/2.9 U.N.O. LONG STRIP CONSTRUCTION MUST BE USED, RE 2/S5.0.
 2. TOP OF FOOTING ELEVATION TO BE 2'-0" BELOW TOP OF SLAB, TYPICAL U.N.O.
 3. REFER TO ARCHITECTURAL DRAWINGS FOR EXACT DIMENSIONS OF SLAB ON GRADE.
 4. REFER TO ARCHITECTURAL DRAWINGS FOR EXTENT AND DIMENSIONS OF DEPRESSED SLAB AREAS, RAMPS AND SLOPES.
 5. REFER TO ARCHITECTURAL DRAWINGS FOR ELEVATOR AND STAIR LOCATIONS AND DIMENSIONS.
 6. REFER TO ARCHITECTURAL DRAWINGS FOR CMU WALL LOCATIONS.
 7. REFER TO ARCHITECTURAL DRAWINGS FOR CMU WALL LOCATIONS.

FOUNDATION/S.O.G. NOTES

2 NONE PLAN NOTES

100% CONSTRUCTION DOCUMENTS

FOUNDATION SLAB-ON-GRADE PLAN

DATE 11-21-01 DRAWING NUMBER

SCALE AS NOTED

DRAWN BY/DECODED BY LMR/JLD

S1.0

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