Working Drawings

1	Cover Sheet	N/A
2	Legends / Notes	N/A
3	Site Plan	1:200 @ A3
4	Floor Plan - Upper	1:100 @ A3
5	Floor Plan - Lower	1:100 @ A3
6	Elevations 1 of 2	1:100 @ A3
7	Elevations 2 of 2	1:100 @ A3
8	Sections / Details	as per dwg.
9	Slab Layout	1:100 @ A3
10	Electrical Plan	1:100 @ A3
11	Bracing Plan	1:100 @ A3
12	Landscaping Plan	1:200 @ A3



Issue	Date	Description

Proposed New Residence For:

XXX

XXX



Example Working Drawings Sloping Site

ALL WORKS SHALL COMPLY WITH BUT NOT LIMITED TO THE BUILDING CODE OF AUSTRALIAN AND THE CURRENT AUSTRALIAN STANDARDS

General Notes

- Dishwasher provision under sink drainer including cold water connection & GPO
- Ventilation to internal wc / bath to be an exhaust fan in accordance with BCA F5.4 & AS 1668.2
- O/head cupboards to 2250mm AFL with MDF bulkhead over
- · All openings to have 2100mm AFL
- Robe fitout (1) shelf with hanging rail
- PVC Downpipes
- Lift off hinges to w/c, Ensuite, Bathroom
- Dimensions are to be verified prior to commencement of work
- Given dimensions are to have priority to scaled dimensions
- All stairs are to have 190mm maximum risers and 240mm minimum goings
- All wet areas to be in accordance with the current Building Code of Australia 3.8.1 & current AS.
- Floor wastes to wet areas
- Denotes Smoke Detector

Site Notes

- Contractor to verify all boundary clearances & site set-out dimensions prior to commencement of construction
- Levels & contours are based on assumed datum. Prior to construction the relevant authority should be contacted for possible minimum floor level requirements & flood information
- $\bullet \ \text{Retaining walls greater than 1m high (cut or fill) are required to be engineer designed \& certified}\\$
- $\bullet \ \text{Batters to comply appropriate soil classification described in table 3.1.1.1. BCA Vol.2.}$
- Vehicular cross-over to be constructed as per local council requirements and/or approval
- Driveways, paths, porch, alfresco area finish as per specifications
- Scrape away vegetation & cut & fill to provide a level building platform
- Finish surface to be graded away from house at minimum of 1:20 for at least 1m
- Surface water to be channelled to council stormwater drainage system
- The driveway & pathways indicated on plan are suggested layouts
- All ground levels are approximate only
- All works to be constructed in accordance with the current Building Code of Australia, the current Australian Standards and all relevant current trade & technical manuals

Stormwater / Drainage Notes

- Drainage to be in accordance with part 3 of the BCA. Point to meet local authority requirements
- All plumbing & draining is to comply with the standard sewerage by-laws & requirements of the local authority
- All downpipes to be installed in accordance the current Building Code of Australia 3.5.2.5, each downpipe must not serve more than 12m of qutter length
- Stormwater system to local authority requirements (owner / applicant / builder to ensure no storm water runoff occurs onto adjoining properties, back onto any structures & no ponding under sub floor areas
- Stormwater approval for legal discharge to be obtained from local authority prior to work commencing. Discharge is proposed to: kerb & channel, rubble pit to council requirements, inter allotment drainage, storm water service main, canal or river.

Energy Efficiency

To comply with BCA 3.12 (unless otherwise stated)

AS PER ENERGY RATING ASSESSMENT CERTIFICATE

Construction Notes

This building has been designed in accordance with the current building code of australia, building act ammendment & australian standards

Roofing	Colorbond sheet, Pitch as specified on drawings
Ceiling Height	As specified on drawings
Joinery Level	As specified on drawings
Footings	To engineers design & detail
Slab Height	To engineers design & detail
Termite Management	In accordance with BCA volume 2, 3.1.3 termite risk management and A.S. 3660.1/1995
External Walls - Brick Veneer	230mm - 110mm Brickwork, 50mm Cavity, 70mm Timber Studs
Internal Linings	10mm Plasterboard
	6 mm Villaboard to all wet areas
Ceiling Linings	10mm Plasterboard
Soffit Linings	4.5mm Hardiflex
Window Flashing	To All Windows. As per manufacturers details
Roof Bracing	Speed Brace. As per manufacturers details
Fascia	Metal Fascia Fixed To Standard Rafter Bracket, Complete With Mitre Angles, Joining Sleeves Etc
Downpipes	PVC

Timber Schedule

Guttering

Smoke Alarms

Note: all timber sizes are based on the current timber engineering code AS 1720. All member types are analyzed using limit state principles incorporatings the latest timber technology available. All of the member types accessible using timber sizes meet the loading and serviceability criteria outlined in AS 1170.1 saa loading code and as 1684.2 - 2010 - residential timber-framed construction - part 1 - design criteria. All timber framing to be in accordance with AS 1684.3-2010

To Be Hard Wire Installed In Accordance With Part 3.7.2 Of The B.C.A.

Colorbond

Wall Framing	Seasoned Pine		
Top Plate (Load Bearing)	2 / 35 X 70 (MGP 12)		
Bottom Plate (Load Bearing)	35 X 70 (MGP 12)		
Bottom Plate (Non Load Bearing)	35 X 70 (MGP 10)		
Studs (Load Bearing)	35 X 70 (MGP 12) @ 450 cts.		
Studs (Non Load Bearing)	35 X 70 (MGP 10) @ 600 cts. (max. height 3000mm)		
Nogging:	35 X 70 (MGP 10)		
Jam studs:	Beside open. up to 1400mm wide Beside open. up to 2300mm wide Beside open. up to 3300mm wide	2 / 35 X 70 (MGP 12) 3 / 35 X 70 (MGP 12) 4 / 35 X 70 (MGP 12)	

Roof framing: Prefabricated timber roof trusses @ specified 600 cts.

Trusses to be engineer designed & fixed in accordance with

manufacturer's specifications & tie down details

Lintels & beams: As specified by engineer designed & fixed in accordance with manufacturer's specifications & tie down details

Bearers & joists As specified by engineer designed & fixed in accordance with manufacturer's specifications & tie down details

Articulation Joints

- (a) Verticle articulations joints must be provided in unreinforced masonry walls except where the site soli classification is A or S b) Articulation joints between masonry elements must have a width not less than 10 mm and be provided (see **Figures 3.3.1.7**
 - Articulation joints between masonry elements must have a width not less than 10 mm and be provided (see **Figures 3.3.1.7** and **3.3.1.8**)-
 - (i) in straight, continuous walls having no openings, at not more than 6 m centres and not closer than the height of the wall away from corners; and
 - (ii) where the height of the wall changes by more than 20%, at the position of change in height; and
 - (iii) where openings more than 900x900 mm occur, at not more than 5 m centres, and positioned in line with one edge of the opening; and
 - (iv) where walls change in thickness; and
 - (v) at control or construction joints in footing slabs; and
 - (vi) at junctions of walls constructed of different masonry materials; and
 - (vii) at deep chases (rebates) for service pipes.
- (c) For all articulation joints in cavity walls, extendable masonry anchors must be built in at every fourth course (see **Figure 3.3.1.9**). For veneer construction the extendable ties may be omitted.
- (d) For single leaf masonry walls stabilised by return walls, or engaged piers, any articulation joints must be within 300 mm of the vertical support (see **Figures 3.3.1.3** and **3.3.1.4(b)**).
- (e) Where masonry is required to be waterproof all joints must be sealed with a flexible, compressible material (see **Figure 3.3.1.9**).
- (f) Articulation joints must not be constructed adjacent to arched openings.
- (g) Articulation joints must not be located in unreinforced masonry above garage door openings or the like unless the panel of masonry is laterally supported with masonry ties or other suitable means.

DEVELOPMENT NEAR UNDERGROUND UTILITY SERVICES

For the purpose of this section of the table:

- · An approval that has been granted to the development pursuant to Section 823 of the Water Act 2000 is deemed to satisfy the Performance Criteria of this section.⁴
- "Access Cover" means a removable cover to provide access for cleaning or inspection of sewers, stormwater drains and water mains.
- "Associated Structure" includes a sewer or stormwater manhole, a water meter and a fire hydrant.
- · "Building" has the meaning defined in the Building Act 1975.
- · "Connection Point" has the meaning defined in the Standard Sewerage Law.
- "Invert Level" means the bottom level of the inside of the pipe or drain.
- "Manhole" means an access chamber being a below Ground Level structure, with a cover, built in the line of a sewer or stormwater drain, through which a person may access the sewer or stormwater drain.
- "Sewer" includes sanitary drain jump-ups and capped slope junctions and manholes.
- · "Structure' includes a masonry fence, deck, pergola, satellite dish, water storage tank and a retaining wall (of greater than 1 metre in Height).
- "Zone of Influence" means the area shown on the following diagram:

Leg	<u>end</u>	WMS W.I.R	Washing Machine Space Walk-in-Robe
		SGD	Sliding Glass Door
BCA	Building Code of Australia	SW	Aluminum Sliding Window
AS	Australian Standards	DH	Aluminum Double Hung Window
DP	Downpipe	AW	Aluminum Awning Window
HWS	Hot Water System	LV	Aluminum Louvre Window
SHS	Steel Post	FG	Fixed Glass
SD	Service Duct	SL	Side Light
FW	Floor Waste	SHR	Shower
T.B.C	To Be Confirmed	TR	Towel Rail
R.L	Relative Level	TRH	Toilet Roll Holder
AFL	Above Floor Level	VSD	Vinyl Sliding Door
NGL	Natural Ground Level	MSD	Mirrored Sliding Door
FGL	Finished Ground Level	CSD	Cavity Sliding Door
OHC	Overhead Cupboard	RW	Rainwater Line
UBO	Under Bench Oven	DW	Dishwasher Provision
wo	Wall Oven	MO	Microwave Provision

Area Calculations		
Living Lower:	29.56 sqm	
Living Upper:	119.98 sqm	
Garage:	36.08 sqm	
Porch:	3.98 sqm	
Alfresco:	12.31 sqm	
Total:	201.91 sqm	

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XXX XXX
 Title:
 Plot Date: 6/07/2015
 Drawing No: 2 of 12
 Issue: Scale: N/A Designed By: MB

 Legends / Notes
 Job №: 2 of 12
 2 of 12
 Drawing By: MB


 Design Name:
 Working Drawings
 Drawing No: Drawings
 MB

 Outrigger 201
 Working Drawings
 Checked By: MB



Site Notes:

- length of all retaining walls t.b.c on site by supervisor
- retaining walls higher than 1m in height to be engineered designed
- retaining walls constructed from treated pine timber or rock as per plans
- agriculture drainage systems to be used
- retaining walls may change location at supervisor's discrection if required
- fencing in accordance with developer covenants
- landscaping in accordance with developer covenants
- driveway gradient not to exceed 1:5
- Batters to comply appropriate soil classification described in table 3.1.1.1.BCA Vol.2.
- stormwater to legal point of dishcharge

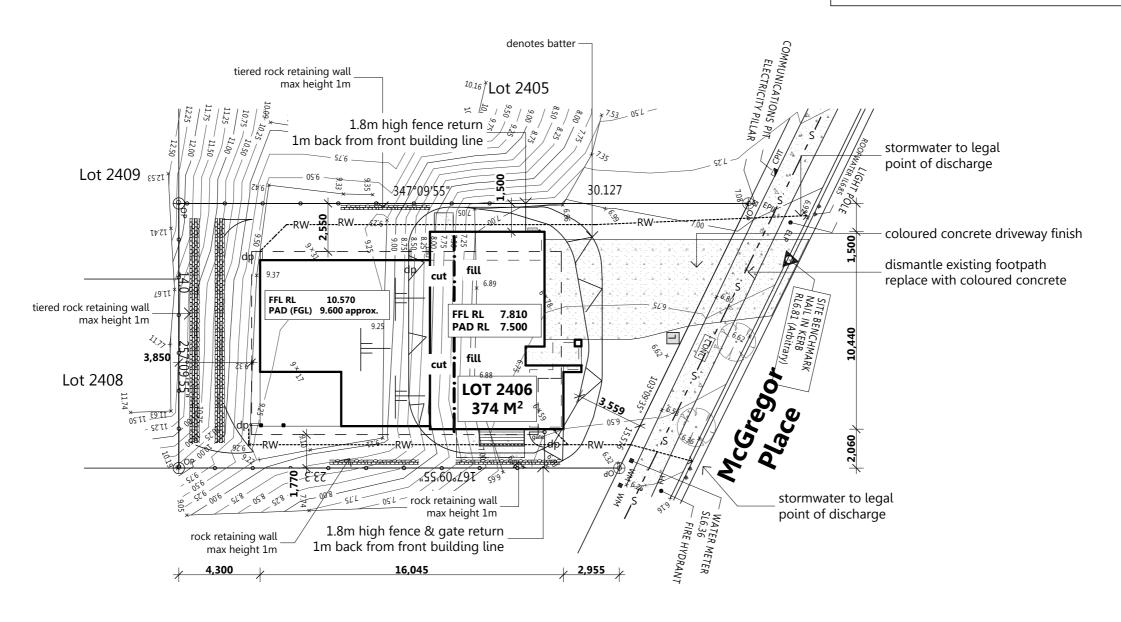

2407

Legend	
	rock retaining wall
	timber retaining wall
	direction of fall
FGL 17.500	Proposed FGL RL
+ 16.65	NGL RL
dp	Downpipe Location
RW	Roof Water Line
	Stormwater Line
— -s- —	Sewer Line
	1800mm high timber fence
О _нтв О	590X350 rendered brick piers painted horizontal timber battens
	1500mm high timber top rail & posts with pool style infill fencing
<u> </u>	Single timber gate
L R B	Rendered Leterbox Rubbish Bin Location

Real Property Description

Lot Number: 2406 Registered Plan Number: SP 230012

Parish: Stapylton County: Stanley

Local Authority: Ipswitch C.C

Site Area: 374M² Site Coverage: 40%

Grade	1:8			
Transitional	Grade	1:8	1:4	1:8
	Distance	n/a	n/a	n/a
NGL (boundary)	R.L 6.800			
FFL	R.L 7.810			
Height Gain	1.01 m			
Distance	8.3 m			

Area Calculations			
Living Lowe	er:	29.56	sqm
Living Uppe	er: 1	.19.98	sqm
Garage:		36.08	sqm
Porch:		3.98	sqm
Alfresco:		12.31	sqm
Total:	2	01.91	sqm

Checked By: MB



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XXX

 Title:
 Plot Date: 6/07/2015
 Drawing No: Is
 Is


 Site Plan
 Job N°:
 3 of 12
 Is

 Design Name:
 Working Drawings

Note:

- Lift off hinges to wc door
- Provide gpo & cold water tap provisions to d/w space
- Continuous flow hws, position to be confirmed
- Mechanically vent rooms without natural ventilation
- All shower roses to be AAA rated
- Water pressure limited to 500KPa at the meter
- All ground drains to be > 1000mm from gas bottle location
- Nogging to be positioned where indicated in bathroom at
- 1100 afl for fixing of towel rail (TR)
- Handrail to be fixed to one side of all stairways (1000mm or higher only)
- Water connection to fridge space at 1900mm afl
- Opening windows in bedrooms with fall height of 2m or greater to be restricted
- to max. 125mm opening (Sliding windows with keyed vent locks;
- awning with ratchet restriction)



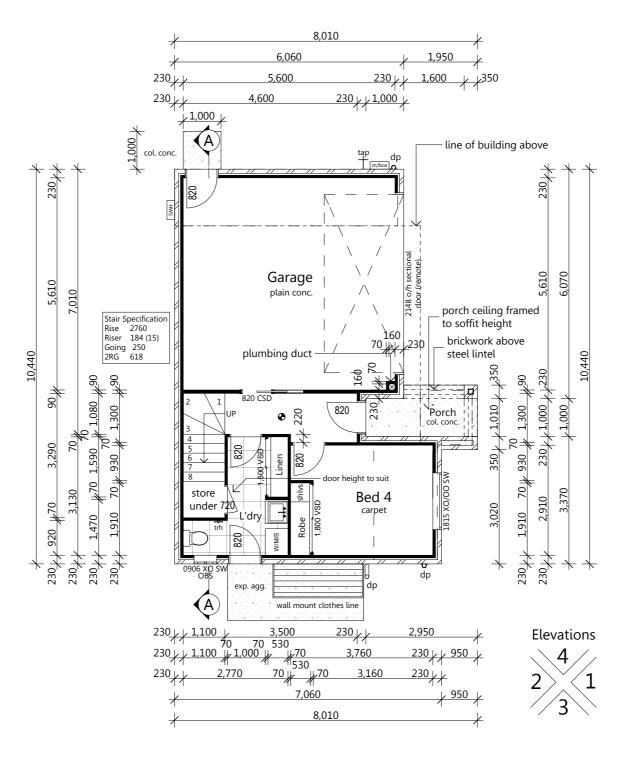

Area Calculations		
Living Lower:	29.56 sqn	
Living Upper:	119.98 sqn	
Garage:	36.08 sqn	
Porch:	3.98 sqn	
Alfresco:	12.31 sqn	
Total:	201.91 sqr	



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Client:


XXX

XXX

Note:

- Lift off hinges to wc door
- Provide gpo & cold water tap provisions to d/w space
- Continuous flow hws, position to be confirmed
- Mechanically vent rooms without natural ventilation
- All shower roses to be AAA rated
- Water pressure limited to 500KPa at the meter
- \bullet All ground drains to be > 1000mm from gas bottle location
- Nogging to be positioned where indicated in bathroom at 1100 afl for fixing of towel rail (TR)
- Handrail to be fixed to one side of all stairways (1000mm or higher only)
- Water connection to fridge space at 1900mm afl
- Opening windows in bedrooms with fall height of 2m or greater to be restricted to max. 125mm opening (Sliding windows with keyed vent locks; awning with ratchet restriction)



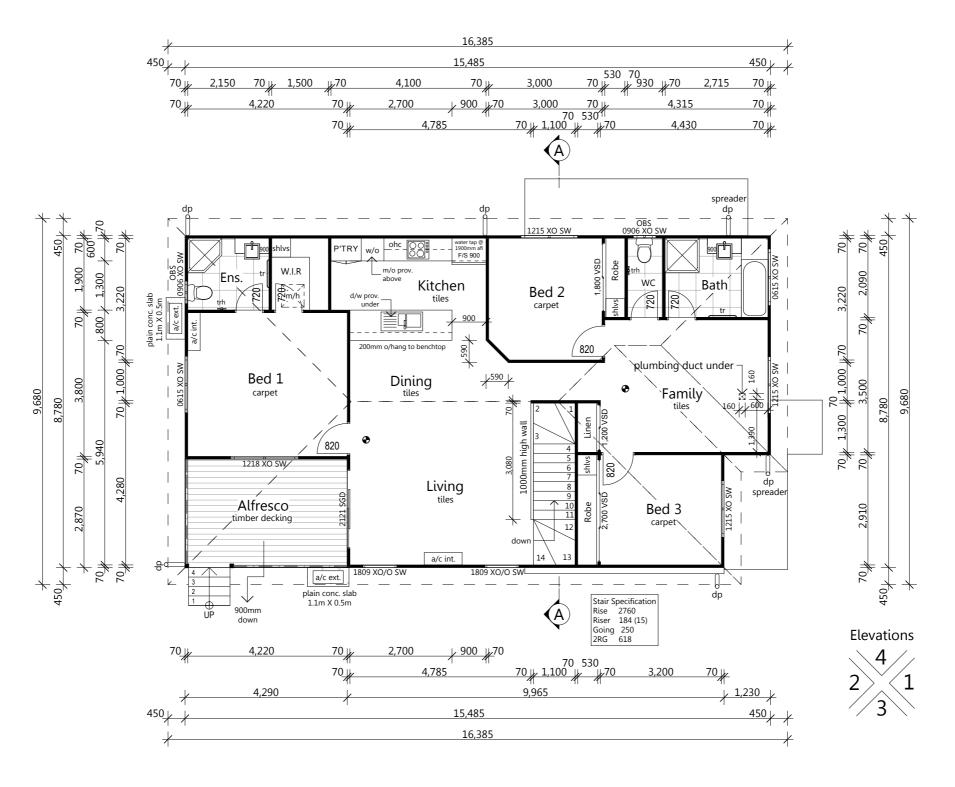


Area Calculations		
Living Lower:	29.56 sqn	
Living Upper:	119.98 sqr	
Garage:	36.08 sqr	
Porch:	3.98 sqr	
Alfresco:	12.31 sqr	
Total:	201.91 sq	




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XXX
XXX

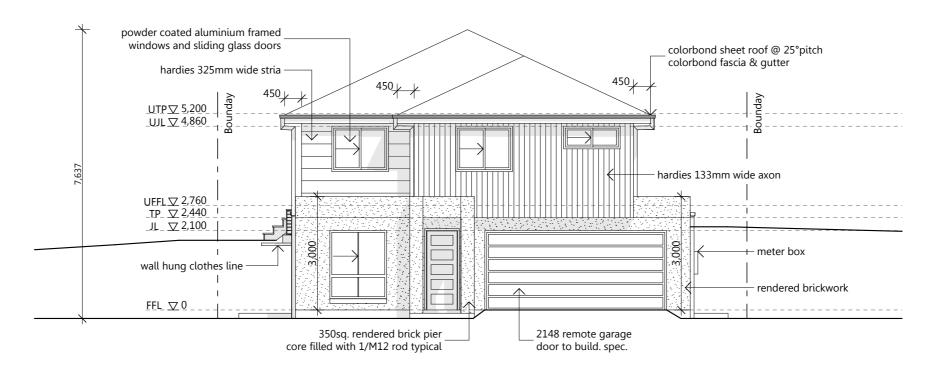

Elevation 1

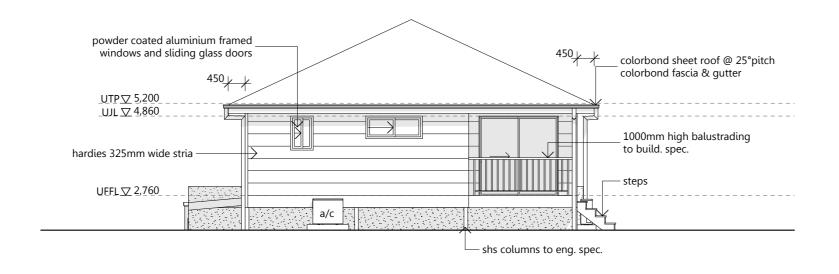

Elevation 2

Note:

- Refer to colour specifications for detailed internal and external colours / materials
- Articulation joints as per engineering details
- All opening windows with fall height of 2m or greater to be restricted to max. 125mm opening (Sliding windows with keyed vent locks; awning with ratchet restriction)

Area Calculations							
Living Lower:	29.56 sqm						
Living Upper:	119.98 sqm						
Garage:	36.08 sqm						
Porch:	3.98 sqm						
Alfresco:	12.31 sqm						
Total: 201.91 sqm							



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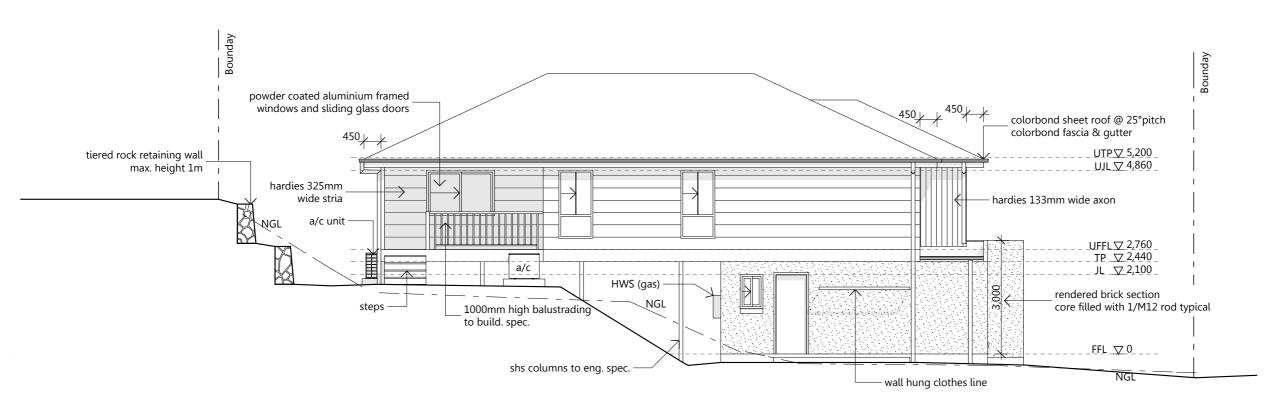
Title: Plot Date: 6/07/2015 Drawing No: Issue: Scale: 1:100 ⊚ A3

Elevations 1 of 2 Job №: 6 of 12 Drawing No: NB


Design Name: Working Drawings MB


Checked By: MB

Checked By: MB



Elevation 3

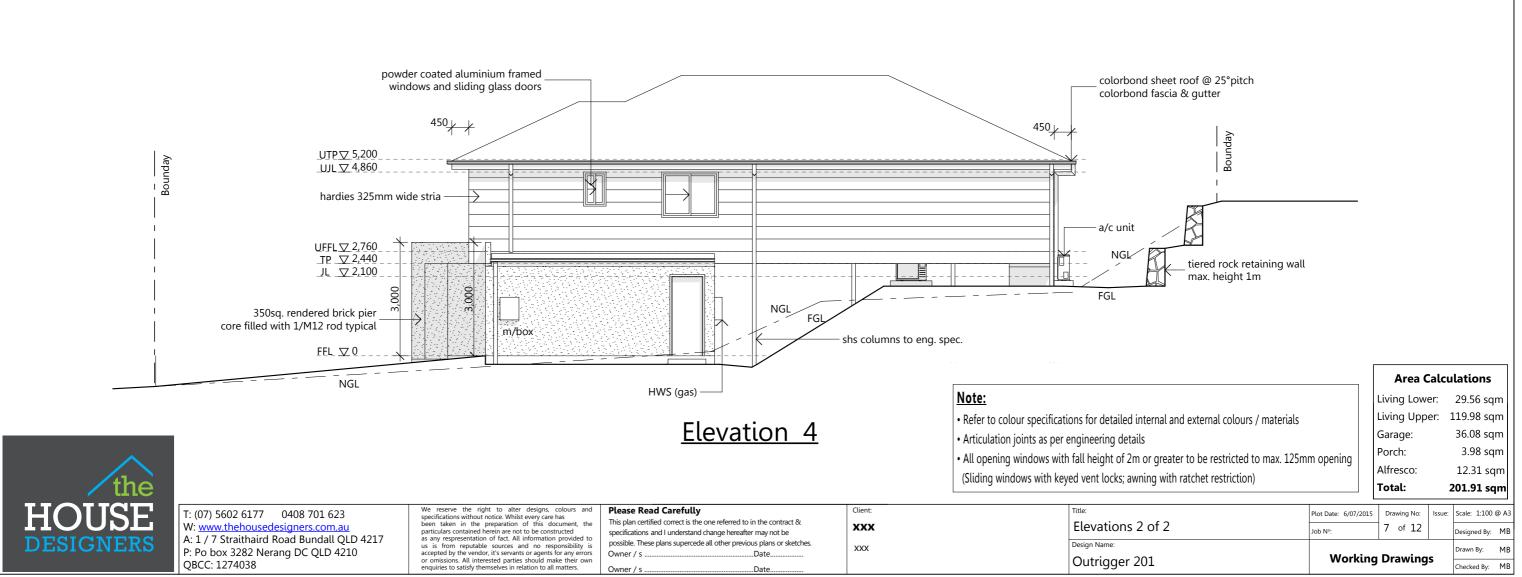

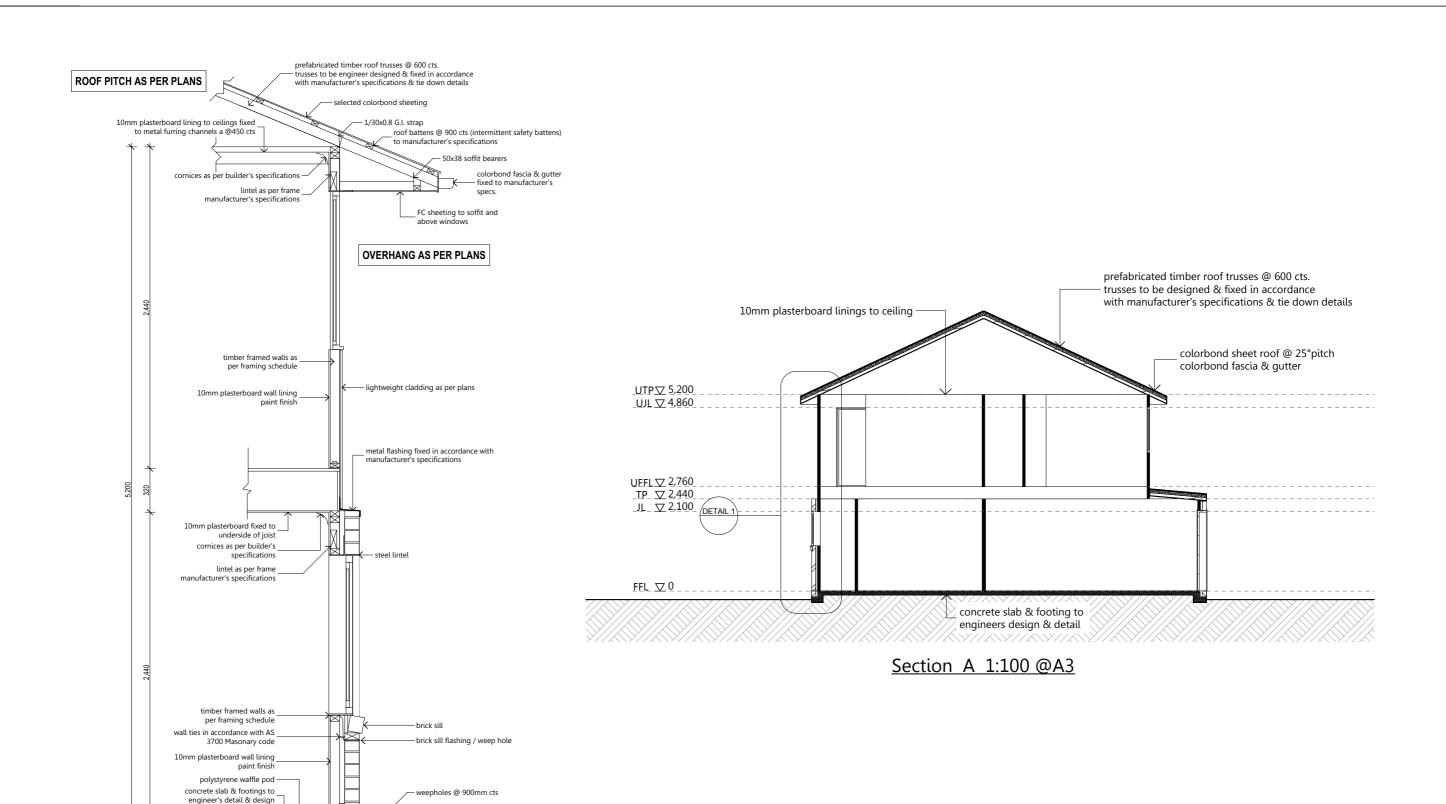

Area Calculations
Living Lower: 29.56 sqm
Living Upper: 119.98 sqm
Garage: 36.08 sqm
Porch: 3.98 sqm
Alfresco: 12.31 sqm
Total: 201.91 sqm

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Detail 1 N.T.S

penetration pipe with foam lagging installed in accordance with B.C.A.

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damp proof course installation

waffle slab & footings to engineer's specifications

as per the current B.C.A. (minimum height of 75mm above finished surface level) slab edge exposure, visual termite risk management (vertical)

minimum height of 75mm above finished surface level as per B.C.A

xxx

Title:
Sections / Details

Plot Date: 6/07/2015
Job No:

Design Name:
Outrigger 201


Plot Date: 6/07/2015
Job No:

Plot Date: 6/07/2015
Job No:

Working Drawing No:
8 of 12

Drawing No:
Drawing No:
NB
Drawing No:
Dra



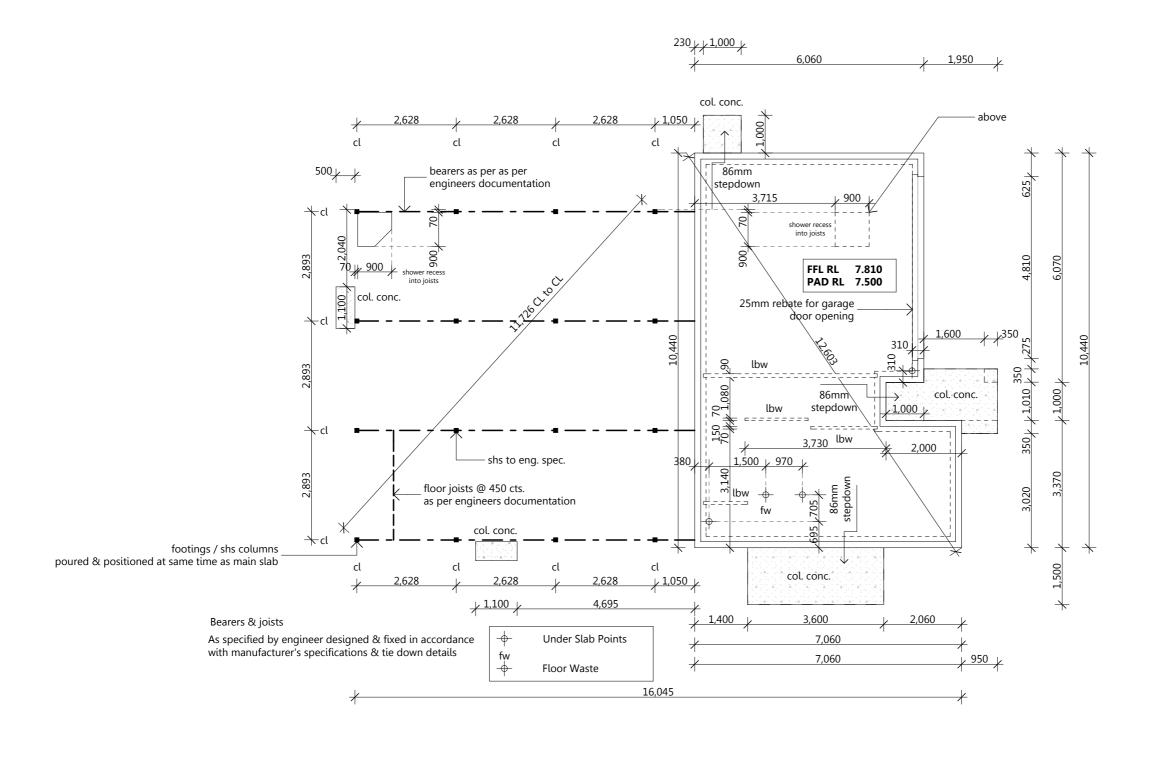

	Area Calculations							
	Living Lower:	29.56 sqm						
	Living Upper:	119.98 sqm						
	Garage:	36.08 sqm						
	Porch:	3.98 sqm						
	Alfresco:	12.31 sqm						
	Total:	201.91 sqm						
_								

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XXX

 Title:
 Plot Date: 6/07/2015
 Drawing No:
 Issue:
 Scale: 1:100 @ A3


 Slab Layout
 Job N°:
 9 of 12
 Designed By: MB

 Design Name:
 Working Drawings
 Drawin By: MB

 Outrigger 201
 MB
 Checked By: MB



Electrical Legend

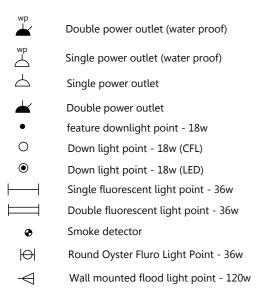

vented into ceiling space

Exhaust Fan on separate switch control

Exhaust Fan on light switch control vented externally unless stated otherwise

Electrical Notes

Light Switches	@ 1150 AFL
Wall Mounted Lights	@ 2000 AFL
Power Outlets (Standard)	@ 300 AFL
Power Outlets (Other)	
Microwave Oven (Oven Tower)	@ 1800 AFL
Microwave Oven (Under Bench)	@ 700 AFL
Kitchen Bench	@ 1050 AFL
Refrigerator	@ 1500 AFL
Rangehood	@ 1800 AFL
Dishwasher	@ 300 AFL
Vantiy Basins	@ 1050 AFL
Laundry Bench	@ 1050 AFL
Washing Machine	@ 1500 AFL

Ventilation to internal wc, bath, ensuite to be an exhaust fan in accordance with BCA F5.4 & AS - 1668.2

◀	Phone point	
₩₩	T.V Point	
N		

→ Ceiling far


Ceiling fan / light


a/c int.

Air Conditioner - Internal Unit

Air Conditioner - External Unit

Artifical lighting	total allowance (watts)	Actual Watts total used	
Class 1 building (5w/m²)	985 (watts)	696 (watts)	

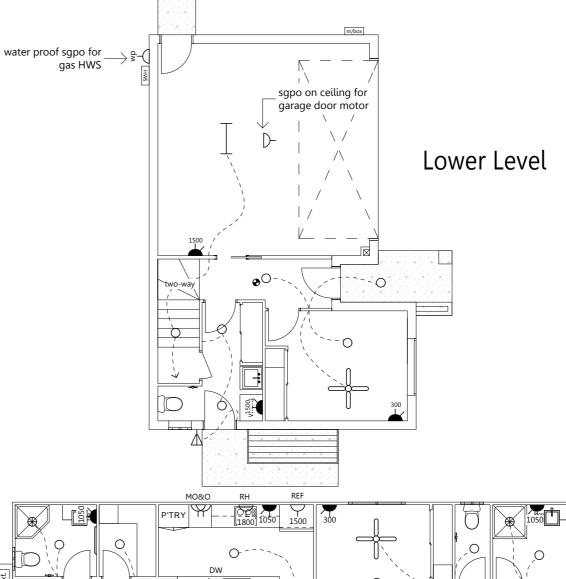

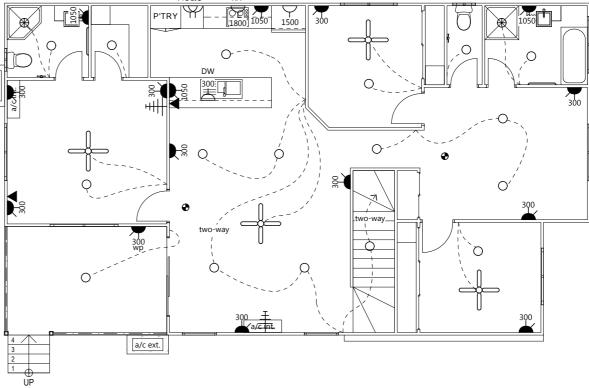

Upper Level

Area Calculations

Living Lower: 29.56 sqm Living Upper: 119.98 sqm

36.08 sqm

3.98 sqm

12.31 sqm

Garage:

Porch:

Alfresco:

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Client:

XXX

XXX

Bracing Notes

BRACING TYPES USED:

Type (h) Method B - Plywood

imum length of panels may be 600mm

-Plywood shall be fixed to frame in a/w AS1684.2 using 30 x 2.8mm diam. galvanized flathead nails or equivalent -Fastener spacing; top and bottom plate 150mm, vertical edges 150mm, intermediate studs 300mm -Bracing capacity of Type (h) Method B is 6.0kN/m

Type (d) - Metal angle brace-Maximum depth of notch shall not exceed 20mm

-Length of bracing 1800mm min. to 2700mm max.

-Bracing capacity of Type (d) is 3.0kN/m

-Metal angle of min. nominal section of 18 x 16 x 1.2mm must be fixed to frame in a/w AS1684.2

-2/30 x 2.8mm diam. nails to each stud

 -30×0.8 mm galv. strap $3/30 \times 2.8$ mm diam. galv. flathead (or equivalent) nails to each end to stud

STRUCTURAL BRACING:

-For wall heights greater than 2700mm the bracing capacity of bracing walls is reduced and must be recalculated using the values given in Table 8.1.9 of AS1684.2/AS1684.3.

-Bracing shall initially be placed in external walls and where possible at the corners of the building. Remaining bracing shall be evenly distributed throughout building.

-Bracing shall not be placed on external walls under the eaves unless suitable connections to the main ceiling diaphragms are provided.

-The maximum distance between braced walls at right angles to the building length/width shall not exceed 9000mm for wind classification N2. For wind classification greater than N2 spacing shall be in accordance with Table 8.20 and 8.21 in AS1684.2./AS1864.3.

-All internal bracing walls shall be fixed to the floor, ceiling and/or external wall frame with structural connections of equivalent shear capacity to the bracing capacity of that particular bracing

ROOF TRUSSES and ROOF BRACING:

-To be designed by truss manufacturer to comply with AS1684.2, AS1720 and AS4440.

TEMPORARY BRACING NOTES:

- -The builder is to ensure that the building is adequately braced during construction.
- -Temporary bracing shall be equivalent to at least 60% of the permanent bracing required.
- -Temporary bracing may form part of the installed permanent bracing.

NOMINAL WALL BRACING:

-Nominal bracing, wall frames lined with sheet material such as plywood, plasterboard or fibre

cement, may provide up to 50% resistance of the total racking forces. -Wall frames must be nominally fixed to the floor and roof frame.

-Nominal bracing shall be evenly distributed throughout the building.

-Minimum length of nominal bracing walls shall be 450mm.

-Sheeted one side only: Bracing capacity 0.45kN/m

-Sheeted two sides: Bracing capacity 0.75kN/m

-1/75mm masonry nail, screw or bolt @1200 crs max.

Tie-Down Schedule

-Nominal fixings to all timber members in accordance with relevant standards; AS1684.2, AS1684.3 -M12 Cyclone rods to either side of external openings over 1800mm wide for N1, N2, N3 Sheet roofing

BATTENS / TRUSSES

-1/No 14 Type 17 x 75mm screws, or as per truss manufacturer's specifications

TRUSS / TOP PLATE

-1/30 x 0.8mm G.l. strap over each truss, 4/2.8mm diam. nails each end -Girder truss to have 2/30 x 0.8mm G.l. straps, 4/2.8mm diam nails each end

LINTEL / TOP PLATE

-30 X 0.8mm looped strap @900 crs max, 4 nails each end

LINTEL / JAMB STUD

-30 x 0.8mm G.I. strap @900 crs max, 4/2.8mm diam. nails each end

BOTTOM PLATE / CONCRETE SLAB

-1/75mm masonry nail, screw or bolt @1200 crs max.

$\begin{bmatrix} \overline{\underline{\alpha}} \\ \underline{\underline{\beta}} \end{bmatrix}$ — not part of calculation not part of calculation

Lower Level

Direction - X

Upper Level - 11.92 kN Required

Direction)	(N2 :	Sheet	Roof
Туре	Length	Resistance	Qty.	Total (kN)
Ply Brace	600	6.0 kN/lm		
Ply Brace	900	6.0 kN/lm	05	27.00
Metal Strapping (double cross)	2000	3.0 kN/lm		
Total	27.00			

Lower Level - 32.68 kN Required

Direction X		N2 Sheet Roof		
Туре	Length	Resistance	Qty.	Total (kN)
Ply Brace	600	6.0 kN/lm		
Ply Brace	900	6.0 kN/lm	06	32.40
Metal Strapping (double cross)	2000	3.0 kN/lm		
Total Resistance Achieved				32.40

X - Total Required - 44.60 kN

X - Total Achieved - 59.40 kN

Direction - Y

Upper Level - 41.16 kN Required


Direction Y N2 Sheet Roof				
Type Lengt		Resistance	Qty.	Total (kN)
Ply Brace	600	6.0 kN/lm	01	3.6
Ply Brace	900	6.0 kN/lm	07	37.80
Metal Strapping (double cross)	2000	3.0 kN/lm		
Total Resistance Achieved				41.40

Lower Level - 45.20 kN Required

Direction Y		N2	Sheet Roof	
Туре	Length	Resistance	Qty.	Total (kN)
Ply Brace	600	6.0 kN/lm	02	7.20
Ply Brace	900	6.0 kN/lm	08	43.20
Metal Strapping (double cross)	2000	3.0 kN/lm		
Total	50.40			

Y - Total Required - 86.36 kN

Y - Total Achieved -97.80 kN

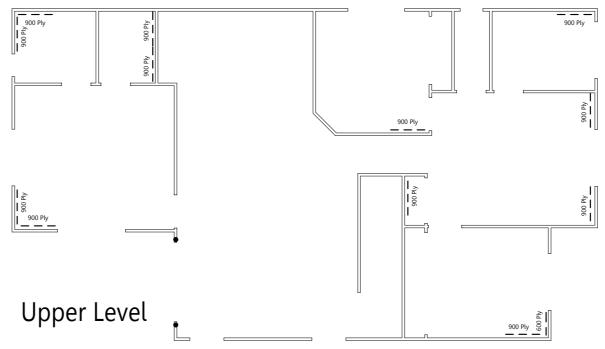

Direction - Y Bracing Achieved • Denotes Tie-Down Rod 쥬 Sheet Roof 44.60 Kn Bracing Required **59.40** Kn Bracing **Achieved**

> **Area Calculations** Living Lower: 29.56 sqm Living Upper: 119.98 sqm 36.08 sqm Garage: 3.98 sqm Porch: Alfresco: 12.31 sqm Total:




T: (07) 5602 6177 0408 701 623 W: www.thehousedesigners.com.au A: 1 / 7 Straithaird Road Bundall QLD 4217 P: Po box 3282 Nerang DC QLD 4210 QBCC: 1274038

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Please Read Carefully This plan certified correct is the one referred to in the contract & specifications and I understand change hereafter may not be possible. These plans supercede all other previous plans or sketches. Owner / s Owner / s ...Date.

XXX XXX

201.91 sqm Scale: 1:100 @ A Plot Date: 6/07/2015 Drawing No: Bracing Plan 11 of 12 Design Name: Drawn By: MB **Working Drawings** Outrigger 201 Checked By: MB

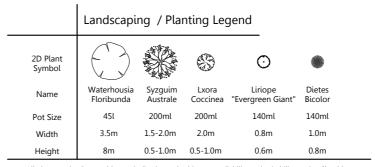

All plant species & quantities are indicative and subject to availability and suitability to site. Should a particular nominated plant not be available an equilavant replacement shall be used.

denotes batter tiered rock retaining wall max height 1m 1.8m high fence return 1m back from front building line drainage catch basins as required coloured concrete driveway finish dismantle existing footpath replace with coloured concrete FFL RL 10.570 PAD (FGL) 9.600 approx. FFL RL 7.810 PAD RL 7.500 **LOT 2406** 374 M² rock retaining wall max height 1m 1.8m high fence & gate return rock retaining wall 1m back from front building line max height 1m

Legend

coloured concrete river pebbles (20 - 40mm, weed mat under) 'A' grade turf -- paved garden edging to front / timber to rear 1800mm high timber fence 1500mm high timber top style infill fencing

rock retaining wall

timber retaining wall direction of fall

L Rendered Leterbox R B

Rubbish Bins

Area Calculations Living Lower: 29.56 sqm Living Upper: 119.98 sqm Garage: 36.08 sqm 3.98 sqm Porch: Alfresco: 12.31 sqm 201.91 sqm Total:

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XXX XXX

Plot Date: 6/07/2015 Scale: 1:200 @ A Drawing No: Landscaping Plan 12 of 12 Design Name: **Working Drawings** Outrigger 201 Checked By: MB