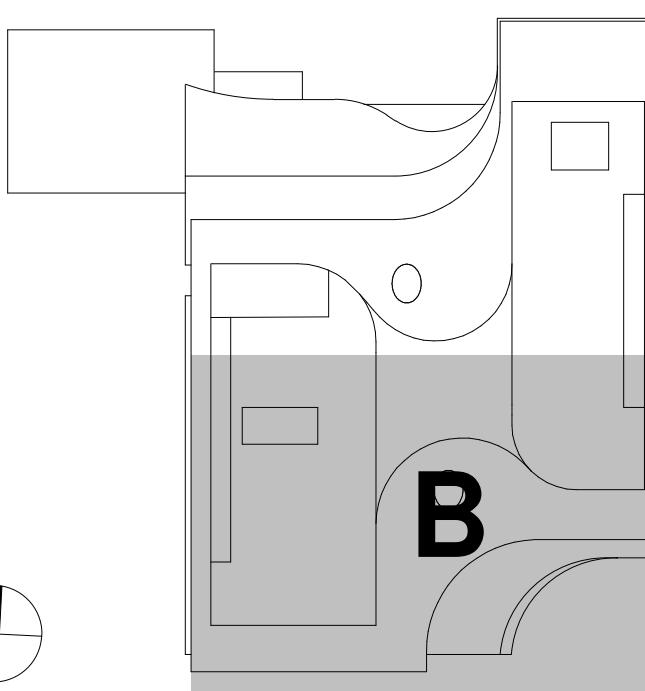


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 3. REFER TO DRAWING E8.03 SERIES FOR LIGHTING CONTROL DRAWINGS.
 4. REFER TO ARCHITECTURAL FLOOR PLANS FOR EQUIPMENT LOCATIONS.
 5. REFER TO ARCHITECTS REFLECTED CEILING PLAN FOR EXACT LOCATION OF LIGHTING FIXTURE PRIOR TO INSTALLATION (TYPICAL).
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KEY PLAN

A technical line drawing of a mechanical assembly, labeled 'B' in a large, bold, black font. The assembly consists of several components: a vertical grey rectangular block with a small horizontal slot near the top; a curved grey base; a central vertical column with a horizontal slot; and a horizontal grey plate at the top. A circular component with a vertical line through its center is positioned to the left. In the top right corner, there is a separate vertical grey block with a small square cutout.

This detailed architectural floor plan illustrates the layout of a large building section, likely a scientific or industrial facility. The plan is organized into several functional zones, each containing various rooms and technical equipment. Key features include:

- Daylighting Zones:** Indicated by red boxes and labeled "DAYLIGHTING ZONE" in multiple locations.
- IMAGING Suites:** Two suites labeled "IMAGING SUITE A" and "IMAGING SUITE B" are shown, each containing "IMAGING LAB PREP" and "IMAGING LAB TISSUE CULTURE" areas.
- Maturing Tech:** A room labeled "MATURING TECH" is located near the center.
- Food Service Areas:** Several food service-related rooms are labeled, including "FOOD SERVICE OFFICE", "FOOD SERVICE BREAKROOM", "FOOD SERVICE STORAGE", and "FOOD SERVICE OFFICE".
- Technical and Support Areas:** These include "ELEVATOR MACHINE ROOM", "IT SERVER WORKROOM", "IT SERVER ROOM", "PLUMBING CLOSET", "CUSTODIAL CLOSET", and "STAIRWELL".
- Monumental Stair:** A prominent feature in the lower right is the "MONUMENTAL STAIR STR.E-0".
- Lighting and Fixtures:** Numerous red boxes highlight specific lighting fixtures, such as "BPL5", "BL2", and "BRC24", which are distributed throughout the space.

The plan uses a grid system for room numbers and labels, with sections labeled from A to H along the top and bottom edges. A legend at the bottom right provides a key for symbols used in the plan.

| | |
|--|---|
| ARCHITECT PAYETTE ASSOCIATES, INC. 290 Congress Street, Fifth Floor Boston, MA 02210 617.895.1000 | ASSOCIATE ARCHITECT KPN ARCHITECTS 1800 Washington Blvd, Suite 414 Baltimore, MD 21230 443.682.7757 |
| CODE CODE RED CONSULTANTS 154 Turnpike Road, Suite 200 Southborough, MA 01772 617.500.7633 | CIVIL RK&K 700 East Pratt Street, Suite 500 Baltimore, MD 21202 410.728.2900 |
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| BUILDING ENCLOSURE SIMPSON GUMPERTZ & HEGER 1625 Eye St NW Suite 900 Washington, DC 20006 202.239.4199 | LEED SUSTAINABLE DESIGN CONSULTING 1432 K Street NW, 3rd Floor Washington, DC 20005 202.667.1620 |
| WIND & AIR QUALITY RWDI 650 Woodland Rd. W. Guelph, Ontario Canada N1K 1B8 519.823.1311 | VIBRATION & ACOUSTICS COLIN GORDON ASSOCIATES 1350 Old Bayshore Hwy, Suite 799 Burlingame, CA 94010 415.570.0350 |
| LIGHTING FISHER MARANTZ STONE 22 West 19th Street, 6th Floor New York, NY 10011 212.691.3020 | SITE LIGHTING TILLETT LIGHTING DESIGN ASSOCIATES 11 Hanover Square, 17th Floor New York, NY 10005 212.766.0144 |
| EMI/RFI (SHEILDING) VITATECH ELECTROMAGNETICS 115 Juliad Ct., Suite 105 Fredericksburg, VA 22406 540.286.1984 | CAMPUS UTILITIES AEI AFFILIATED ENGINEERS 200 International Circle, Suite 5888 Hunt Valley, MD 21030 |

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Baltimore, Maryland 21287

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| Seal | Date: | OCTOBER 24, 2025 |
|  | Scale: | 1/8" = 1'-0" |
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| | Client Job No.: | J.170.24.4000 |
| | Client Name: | |

"I certify that these documents were prepared or approved by me, and that I am duly licensed engineer under the laws of the State of Maryland.

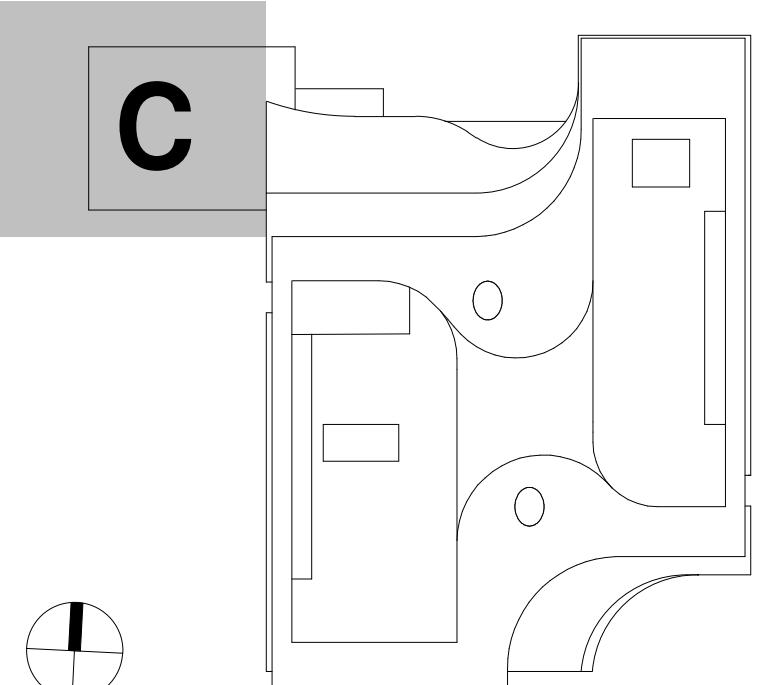
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KEY PLAN



The image is a detailed architectural key plan diagram. It features a large room layout with various furniture pieces like desks, chairs, and shelving units. There are also several circular symbols representing equipment or fixtures. A prominent feature is a large letter 'C' located in the top left corner of a room. A compass rose symbol is positioned in the bottom left corner.

KEY PLAN

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22 West 19th Street, 6th Floor
New York, NY 10011
212.691.3020

SITE LIGHTING

TILLETT LIGHTING DESIGN
ASSOCIATES
11 Hanover Square, 17th Floor
New York, NY 10005
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200 International Circle, Suite 5888

Hunt Valley, MD 21030

410.229.0090

LIFE SCIENCES BUILDING

600 N Broadway
Billings, MT 59105

Baltimore, Maryland 21287



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| Seal | Date: OCTOBER 24, 2025 |
|  | Scale: 1/8" = 1'-0" |
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| | Proj. Mgr.: |
| | Payette Job No.: 17480.00 |
| | Cadd File: |
| | Client Job No.: J.170.24.4000 |
| | Client Dwg. No.: |
| EL2.00C | |
| Professional Certification. | |
| <p>"I certify that these documents were prepared or approved by me, and that I am duly licensed engineer under the laws of the State of Maryland.</p> | |

EL2.00C

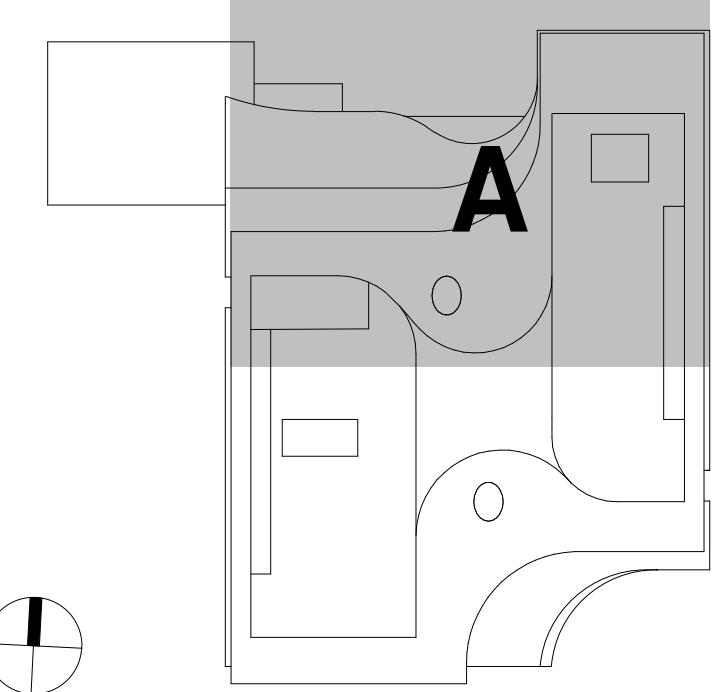
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KEY PLAN

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SCIENCES BUILDING

Baltimore, MD 21205

LIFE SCIENCES BUILDING

600 N Broadway
Baltimore, MD 21205

JOHNS HOPKINS

N I V E R S I T Y

1800 Orleans St.

| | |
|---|------------------|
| 1800 Orleans St Baltimore, Maryland 21287 | |
| LIGHTING RCP A - LEVEL 1 | |
|  <p>The seal is circular with a dotted outer border. The words "STATE OF MARYLAND" are at the top and "PROFESSIONAL ENGINEER" are at the bottom. In the center is a crest featuring a shield with a bridge, surrounded by a laurel wreath. Below the shield is the number "NO. 6552". Above the shield is the name "DANIEL F MOYNAGH". A five-pointed star is at the bottom right.</p> | |
| Date: | OCTOBER 24, 2025 |
| Scale: | 1/8" = 1'-0" |
| Drawn By: | |
| Designed By: | |
| Checked By: | |
| Proj. Mgr.: | |
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| Client Job No.: | J.170.24.4000 |
| Client Name: | |

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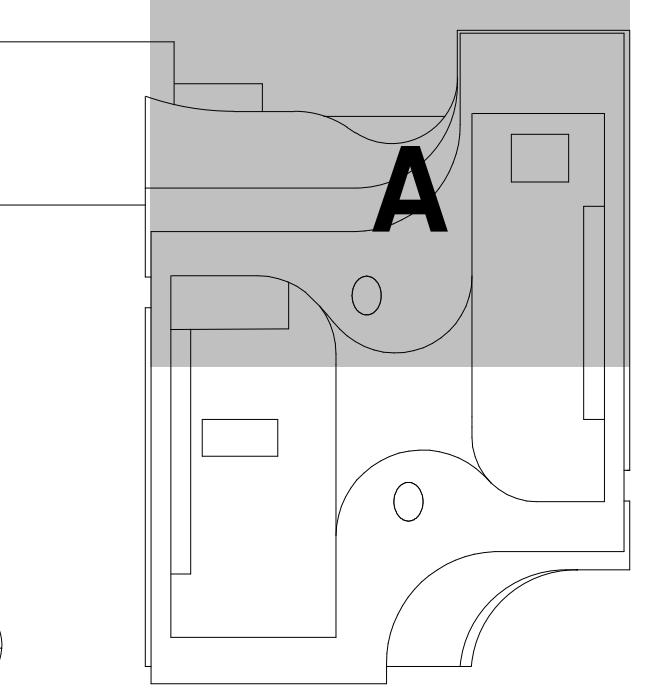
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FISHER MARANTZ STONE

SITE LIGHTING

TILLETT LIGHTING DESIGN

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200 International Circle, Suite 5888
Hunt Valley, MD 21030
410.229.0090

Baltimore, MD 21205

JOHNS HOPKINS
U N I V E R S I T Y

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| Seal | Date: | OCTOBER 24, 2025 |
|  | Scale: | 1/8" = 1'-0" |
| | Drawn By: | |
| | Designed By: | |
| | Checked By: | |
| | Proj. Mgr.: | |
| | Payette Job No.: | 17480.00 |
| | Cadd File: | |
| | Client Job No.: | J.170.24.4000 |
| | Client Job Name: | |

EL2.02A

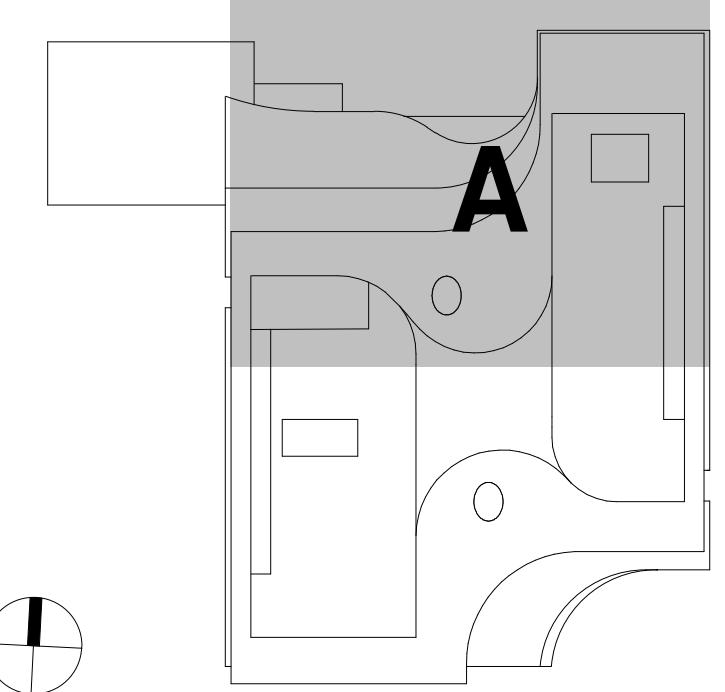
REFER TO LIGHTING CONSULTANT'S DRAWINGS AND
ARCHITECTURAL RCPS FOR PUBLIC SPACE LIGHTING

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ASSUME EGRESS LIGHTING WITH BYPASS RELAYS FOR ALL LIGHTING IN THE PATH OF EGRESS.

GENERAL LIGHTING NOTES:

1. REFER TO DRAWING E0.00 FOR LEGEND, SYMBOLS AND GENERAL NOTES.
 2. REFER TO LIGHTING FIXTURE SCHEDULE ON DRAWING E7.30 SERIES FOR SPECIFICATION OF FIXTURES.
 3. REFER TO DRAWING E8.03 SERIES FOR LIGHTING CONTROL DRAWINGS.
 4. REFER TO ARCHITECTURAL FLOOR PLANS FOR EQUIPMENT LOCATIONS.
 5. REFER TO ARCHITECTS REFLECTED CEILING PLAN FOR EXACT LOCATION OF LIGHTING FIXTURE PRIOR TO INSTALLATION (TYPICAL).
 6. REFER TO ARCHITECTURAL ELEVATIONS FOR COORDINATION OF WALL MOUNTED FIXTURE LOCATIONS.
 7. LOCATION AND GROUPING ARRANGEMENT/ORIENTATION OF ALL SWITCHES SHALL BE COORDINATED WITH THE ARCHITECT, MECHANICAL EQUIPMENT, AND OTHER WALL-MOUNTED DEVICES PRIOR TO INSTALLATION.
 8. THE ELECTRICAL CONTRACTOR SHALL VERIFY ALL CEILING TYPES AND COORDINATE FIXTURE TRIMS PRIOR TO PURCHASE OF LIGHTING FIXTURES.
 9. THE ELECTRICAL CONTRACTOR SHALL FURNISH AND INSTALL ALL LIGHTING FIXTURES COMPLETE WITH MOUNTING HARDWARE.
 10. ALL EXIT SIGNS AND EMERGENCY EGRESS LIGHTING SHALL BE CONNECTED TO THE EMERGENCY GENERATOR.
 11. EMERGENCY EGRESS LIGHTING SHALL BE PROVIDED THROUGHOUT THE BUILDING TO ILLUMINATE ALL EGRESS CORRIDORS, LOBBIES, ETC. BRANCH CIRCUITS SHALL ORIGINATE FROM THE EMERGENCY GENERATOR. AREAS REQUIRING SUCH CONTROL OF EGRESS LIGHTING SHALL BE PROVIDED WITH BYPASS RELAYS. EMERGENCY BRANCH CIRCUIT CONDUCTORS ALL BE RUN IN SEPARATE DEDICATED CONDUITS WITH NO OTHER WIRING.
 12. UNDER NORMAL CONDITIONS, EMERGENCY LIGHTING SHALL FUNCTION LIKE THE NORMAL LIGHTING IN EACH SPACE. PROVIDE UL 924 LISTED DEVICE TO TURN EMERGENCY LIGHTS TO FULL BRIGHTNESS UPON LOSS OF NORMAL POWER, REGARDLESS OF CONTROL STATE.
 13. PROVIDE ALL REQUIRED MODULES, INTERFACES, NETWORK MANAGERS, AND CONTROL INTERCONNECTIONS AS REQUIRED BY THE MANUFACTURER(S) TO MEET THE SPECIFIED CONTROL INTENT.
 14. ALL LIGHTING FIXTURE LOCATIONS WITHIN A/V, IT, ELECTRICAL, AND MECHANICAL ROOMS SHALL BE COORDINATED WITH THE RESPECTING TRADES TO AVOID CONFLICTS WITH THE EQUIPMENT AND TO PROVIDE EVEN ILLUMINATION THROUGHOUT THE SPACE.
 15. COORDINATE THE LOCATION OF ALL EXIT SIGNS WITH INTERIOR SIGNAGE. INTERIOR SIGNAGE SHALL NOT BE OBSTRUCTED.
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 17. EXIT SIGN DIRECTIONAL ARROWS SHALL BE AS INDICATED ON THE ELECTRICAL PLANS AND SHALL BE COORDINATED WITH THE ARCHITECTURAL PLANS AND REFLECTED CEILING PLANS.



KEY PLAN

ARCHITECT
AYETTE ASSOCIATES, INC.
10 Congress Street, Fifth Floor
Boston, MA 02210
617.895.1000

ASSOCIATE ARCHITECT
KPN ARCHITECTS
1800 Washington Blvd, Suite 414
Baltimore, MD 21230
443.682.7757

| | |
|--|---|
| CODE CODE RED CONSULTANTS 54 Turnpike Road, Suite 200 Southborough, MA 01772 617.500.7633 | CIVIL RK&K 700 East Pratt Street, Suite 500 Baltimore, MD 21202 410.728.2900 |
|--|---|

LANDSCAPE ARCHITECT
OLIN
7 John F. Kennedy Boulevard,
Suite 1900
Philadelphia, PA 19103
215.412.9929

STRUCTURAL
COLUMBIA ENGINEERING, INC.
6210 Old Dobbin Lane, Suite 150
Baltimore, Maryland 21045
410.992.9970

RTICAL TRANSPORTATION
ZIPF ASSOCIATES, INC.
25 Bala Avenue, Suite 201
Bala Cynwyd, PA 19004
610.667.1717

MEP
BR+A CONSULTING ENGINEERS
10 Guest Street, 4th Floor
Boston, MA 02135
617.254.0016

ALARM & FIRE PROTECTION
SETTY & ASSOCIATES
5 S. Charles Street, Suite 403
Baltimore, MD 21201
667.309.6036

AUDIO VISUAL & TELECOM
CONVERGENT TECHNOLOGIES
DESIGN GROUP
6501 York Road
Baltimore, MD 21212

SECURITY
THORNTON TOMASETTI
1330 Connecticut Ave, NW,
Suite 300
Washington, DC 20036

FOOD SERVICE
COLBURN GUYETTE
100 Ledgewood Place, Suite 104
Rockland, MA, 02370
781 826 5522

BUILDING ENCLOSURE
PSON GUMPERTZ & HEGER
1625 Eye St NW
Suite 900
Washington, DC 20006

LEED
SUSTAINABLE DESIGN
CONSULTING
1432 K Street NW, 3rd Floor
Washington, DC 20005

WIND & AIR QUALITY
RWDI
650 Woodland Rd.
W. Guelph, Ontario
Canada N1K 1B2

VIBRATION & ACOUSTICS
COLIN GORDON ASSOCIATES
1350 Old Bayshore Hwy, Suite 799
Burlingame, CA 94010

519.823.1311

LIGHTING
FISHER MARANTZ STONE

SITE LIGHTING
TILLETT LIGHTING DESIGN

New York, NY 10011 11 Hanover Square, 17th Floor
212.691.3020 New York, NY 10005
 212.766.0144

EMI/RFI (SHEILDING)
TECH ELECTROMAGNETICS
115 Julliad Ct., Suite 105

CAMPUS UTILITIES
AFI AFFILIATED ENGINEERS

Fredericksburg, VA 22406 200 International Circle, Suite 300
540.286.1984 Hunt Valley, MD 21030
 410.229.0090

600 N Broadway
Baltimore, MD 21205

N I V E R S I T Y

LIGHTING RCP A - LEVEL 3

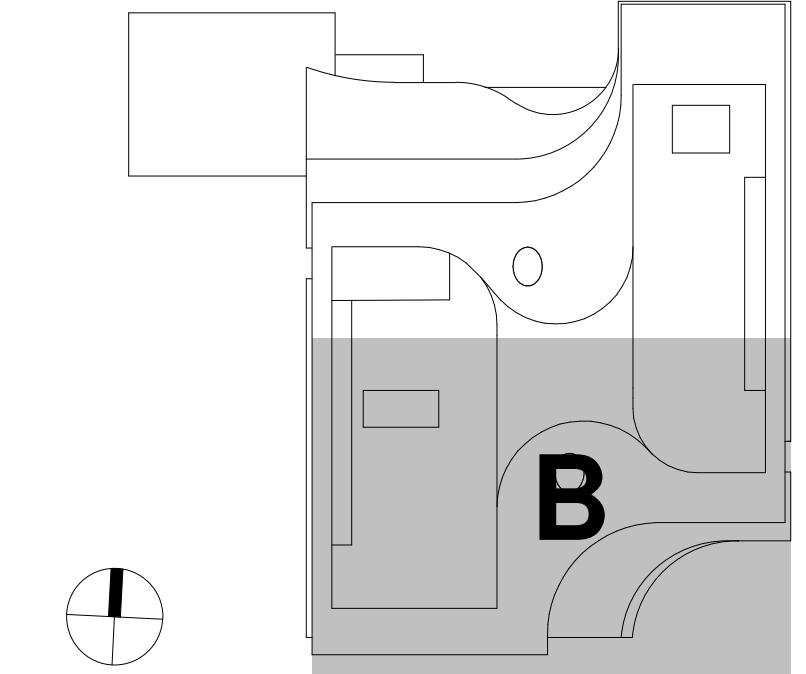
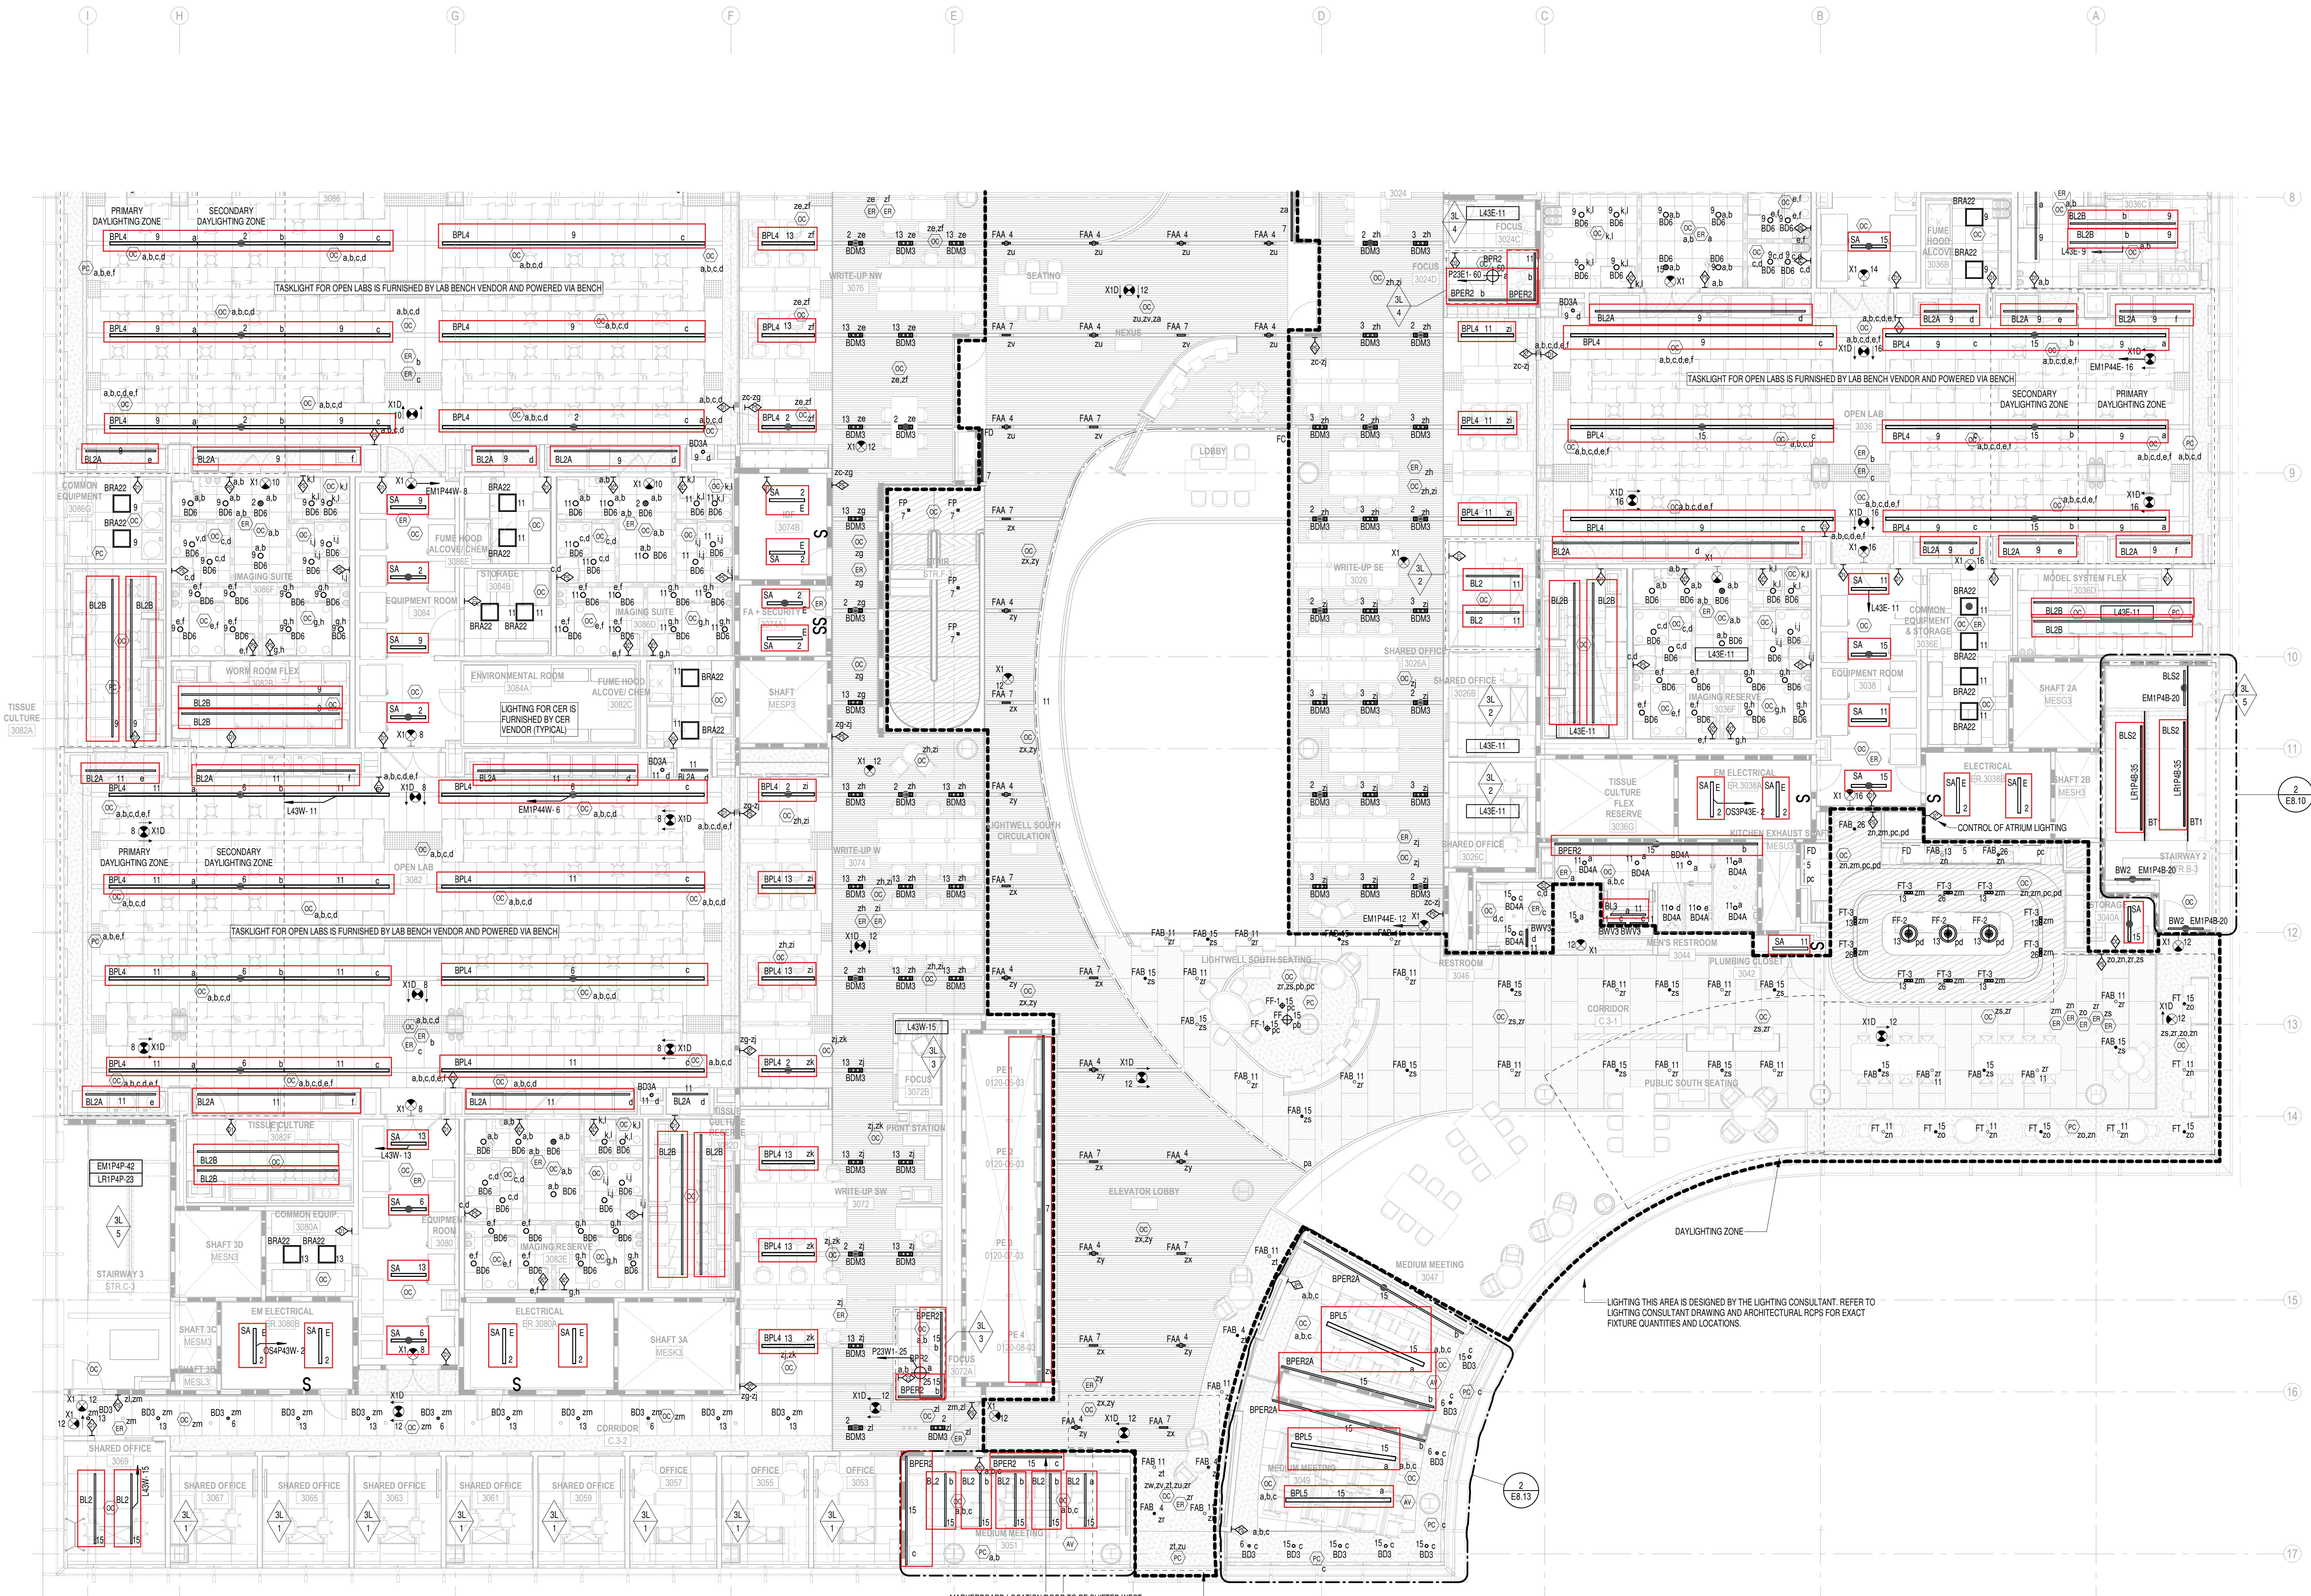
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|  | Date: | OCTOBER 24, 2025 |
| | Scale: | 1/8" = 1'-0" |
| | Drawn By: | |
| | Designed By: | |
| | Checked By: | |
| | Proj. Mgr.: | |
| | Payette Job No.: | 17480.00 |
| | Cadd File: | |
| | Client Job No.: | J.170.24.4000 |

y that these documents were prepared or
d by me, and that I am duly licensed
under the laws of the State of Maryland.

EL2.03A

1 LIGHTING RCP A - PARENT - LEVEL 3
1/8" = 1'-0"

170 180



KEY PLAN

| | |
|--|---|
| ARCHITECT PAYETTE ASSOCIATES, INC. 290 Congress Street, Fifth Floor Boston, MA 02210 617.685.1000 | ASSOCIATE ARCHITECT KPN ARCHITECTS 1800 Washington Blvd, Suite 500 Baltimore, MD 21200 443.682.7757 |
| CODE CODE RED CONSULTANTS 154 Turnpike Road, Suite 200 Southborough, MA 01772 617.500.7633 | CIVIL RK&K 700 East Pratt Street, Suite 500 Baltimore, MD 21200 410.282.2900 |
| LANDSCAPE ARCHITECT OLIN 1617 John F. Kennedy Boulevard, Suite 1900 Philadelphia, Maryland 19103 215.440.0030 | STRUCTURAL COLUMBIA ENGINEERING, INC. 6210 Old Dobbins Lane, Suite 150 Baltimore, Maryland 21045 410.992.9970 |
| VERTICAL TRANSPORTATION ZIPF ASSOCIATES, INC. 25 Bala Avenue, Suite 201 Bala Cynwyd, PA 19004 610.687.1717 | MEP BR+A CONSULTING ENGINEERS 10 Guest Street, 4th Floor Boston, MA 02135 617.254.0016 |
| FIRE ALARM & FIRE PROTECTION SETTY & ASSOCIATES 575 S. Charles Street, Suite 403 Baltimore, MD 21201 667.309.6036 | AUDIO VISUAL & TELECOM CONVERGENT TECHNOLOGIES DESIGN GROUP 6501 York Road Baltimore, MD 21212 410.532.2355 |
| SECURITY THORNTON TOMASSETTI 1330 Connecticut Ave, NW, Suite 300 Washington, DC 20036 202.580.6300 | FOOD SERVICE COLBURN GUYETTE 100 Ledgewood Place, Suite 104 Rockland, MA 02370 781.826.5522 |
| BUILDING ENCLOSURE SIMPSON GUMPERTZ & HEGER 1625 Eye St NW Suite 900 Washington, DC 20006 202.667.1620 | LEED SUSTAINABLE DESIGN CONSULTING 1432 K Street NW, 3rd Floor Washington, DC 20005 202.239.4199 |
| WIND & AIR QUALITY RWRI 650 Woodland Rd. W. Guelph, Ontario Canada N1K 1B8 519.823.1311 | VIBRATION & ACOUSTICS COLIN GORDON ASSOCIATES 1350 Old Bayshore Hwy, Suite 799 Burlingame, CA 94010 415.570.0350 |
| LIGHTING FISHER MARANTZ STONE 22 West 19th Street, 6th Floor New York, NY 10001 212.691.3020 | SITE LIGHTING TILLETT LIGHTING DESIGN ASSOCIATES 11 Hanover Square, 17th Floor New York, NY 10005 212.766.0144 |
| EMI/RFI SHIELDING VITACHEK ELECTROMAGNETICS 115 Juliad Ct., Suite 105 Fredericksburg, VA 22406 540.286.1984 | CAMPUS UTILITIES AEI AFFILIATED ENGINEERS 200 International Circle, Suite 5088 Hunt Valley, MD 21030 410.229.0090 |

LIFE SCIENCES BUILDING

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| Seal | Date: OCTOBER 24, 2025 Scale: 1/8" = 1'-0" Drawn By: Designed By: Checked By: Proj. Mgr.: Payette Job No.: 17480.00 Cadd File: Client Job No.: J.170.24.4000 Client Dwg. No.: Professional Certification |
|------|--|

I certify that these documents were prepared or approved by me, and that I am duly licensed engineer under the laws of the State of Maryland.

EL2.03B

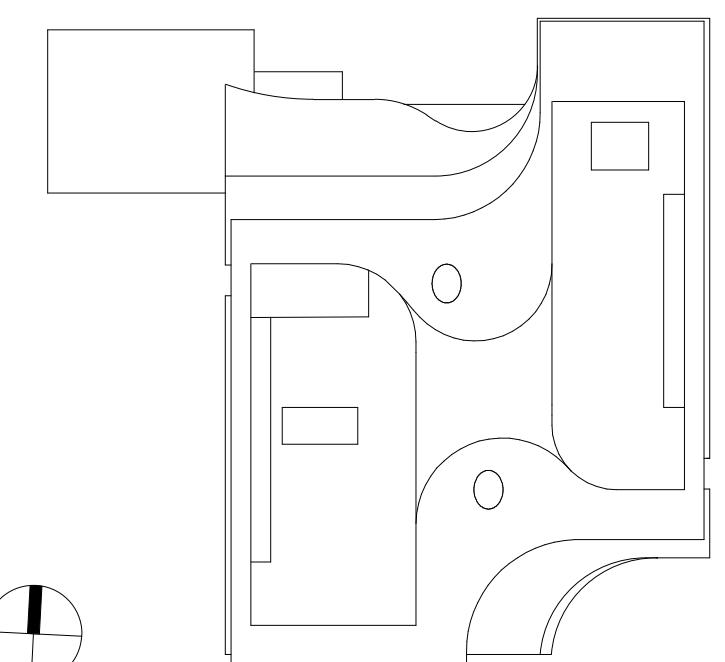
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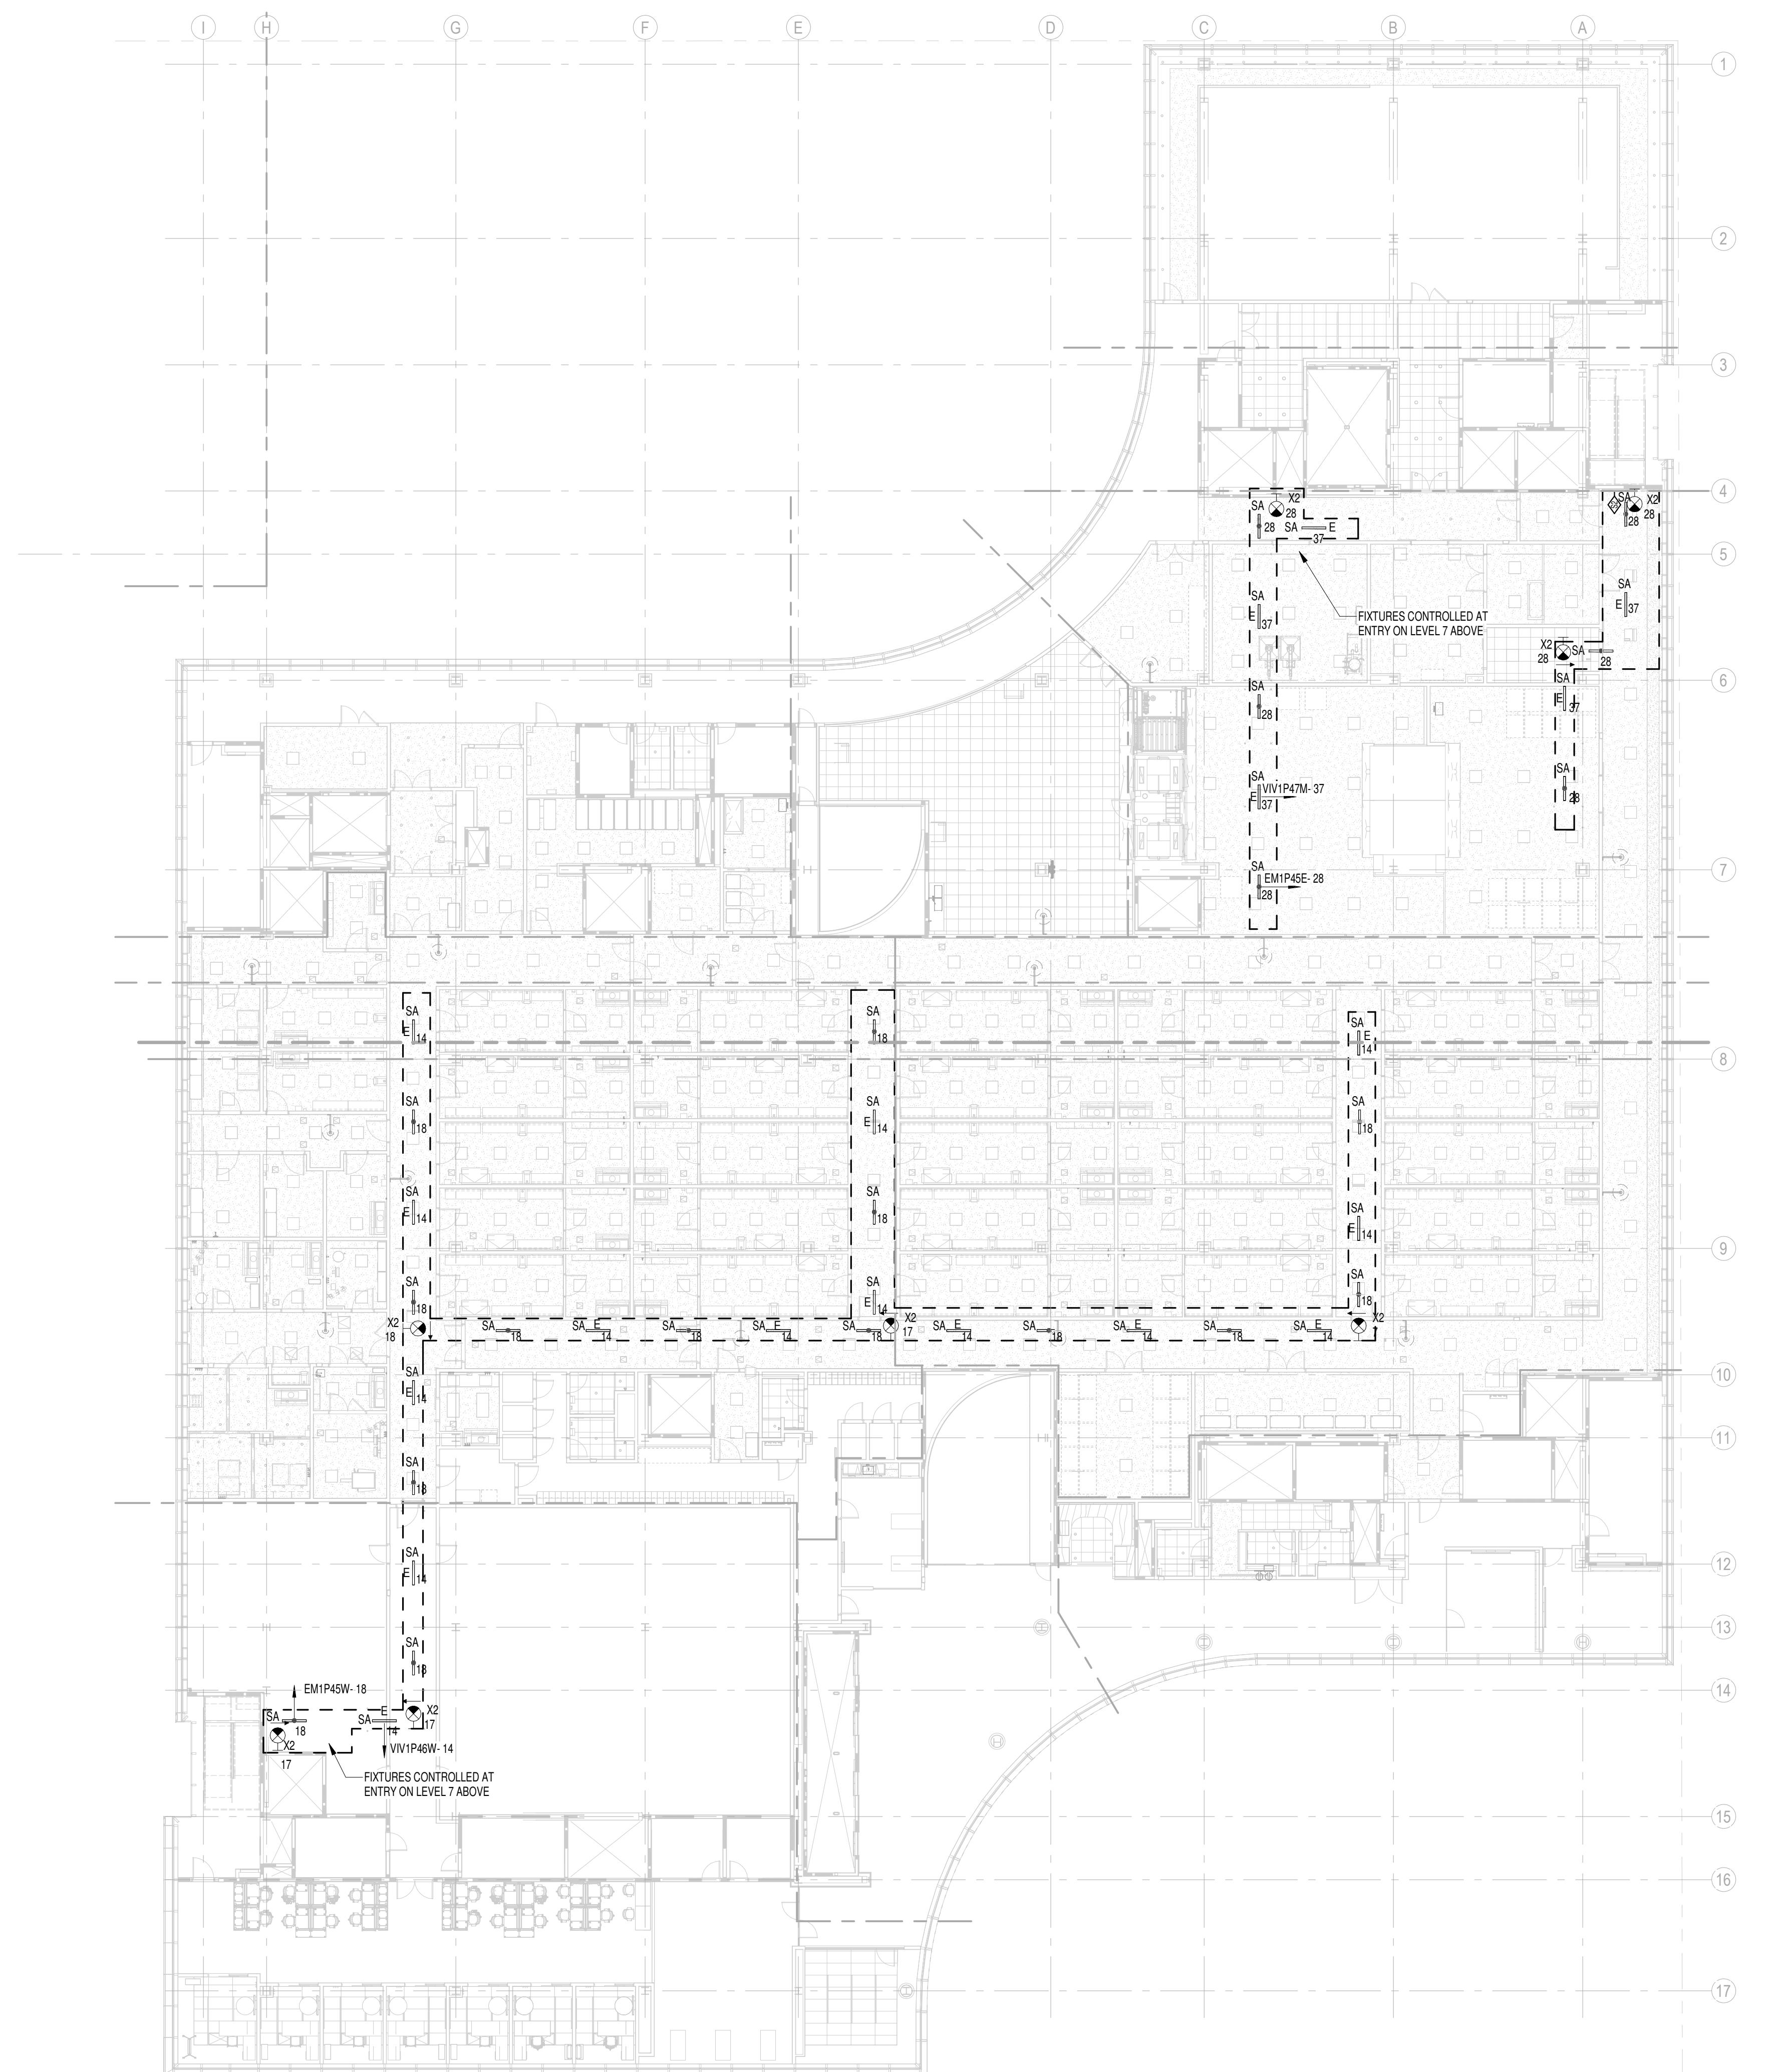
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KEY PLAN



1 LIGHTING RCP - LEVEL 6 CATWALK
1/16" = 1'-0"

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| Seal | Date: | OCTOBER 24, 2025 |
|  The seal is circular with a dotted outer ring. The words "STATE OF MARYLAND" are at the top and "PROFESSIONAL ENGINEER" are at the bottom. In the center is a shield with a bridge, flanked by two stars. Below the shield is the number "NO. 6552". A blue ink signature "DANIEL F MOYNAGH" is written over the seal. | Scale: | As indicated |
| | Drawn By: | |
| | Designed By: | |
| | Checked By: | |
| | Proj. Mgr.: | |
| | Payette Job No.: | 17480.00 |
| | Cadd File: | |
| | Client Job No.: | J.170.24.4000 |
| | Client Dwg. No.: | |
| I certify that these documents were prepared or approved by me, and that I am duly licensed engineer under the laws of the State of Maryland. | EL2.06M | |

I certify that these documents were prepared or approved by me, and that I am duly licensed engineer under the laws of the State of Maryland.

EL2.06M

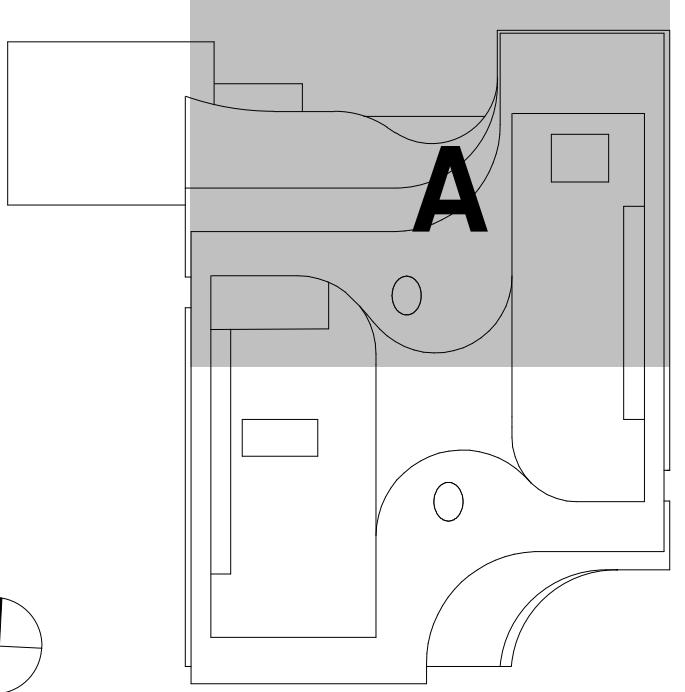
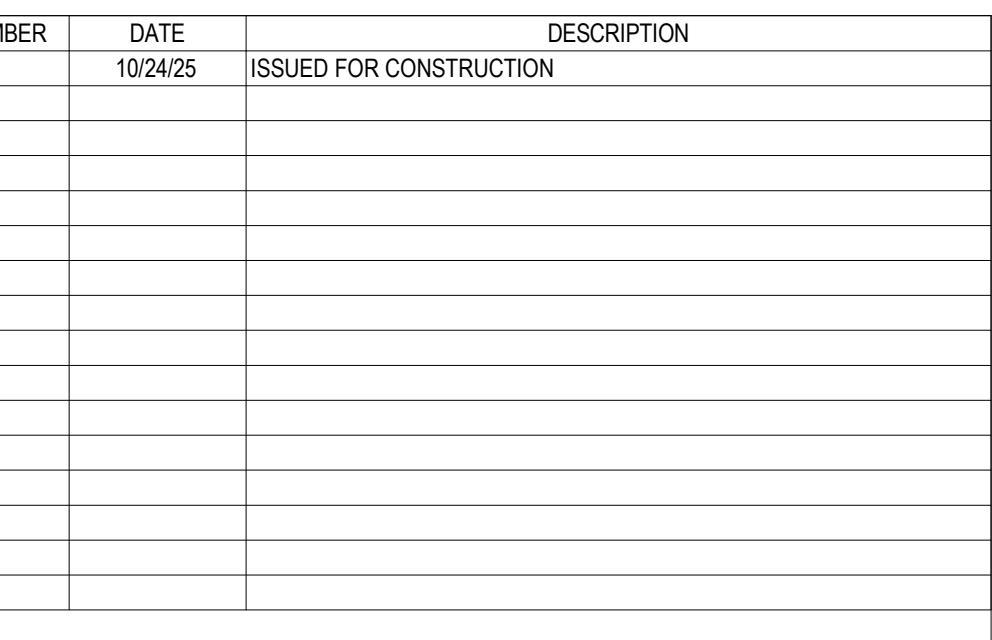
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KEY PLAN

ARCHITECT
PAYETTE ASSOCIATES, INC.
290 Congress Street, Fifth Floor
Boston, MA 02210
617.895.1000

ASSOCIATE ARCHITECT
KPN ARCHITECTS
1800 Washington Blvd, Suite 414
Baltimore, MD 21230
443.682.7757

| | |
|---|---|
| CODE CODE RED CONSULTANTS 154 Turnpike Road, Suite 200 Southborough, MA 01772 617.500.7633 | CIVIL RK&K 700 East Pratt Street, Suite 500 Baltimore, MD 21202 410.728.2900 |
|---|---|

LANDSCAPE ARCHITECT
OLIN
617 John F. Kennedy Boulevard,
Suite 1900
Philadelphia, PA 19103
215.440.0030

STRUCTURAL
COLUMBIA ENGINEERING, INC.
6210 Old Dobbin Lane, Suite 150
Baltimore, Maryland 21045
410.992.9970

VERTICAL TRANSPORTATION
ZIPF ASSOCIATES, INC.
25 Bala Avenue, Suite 201
Bala Cynwyd, PA 19004
610.667.1717

MEP
BR+A CONSULTING ENGINEERS
10 Guest Street, 4th Floor
Boston, MA 02135
617.254.0016

RE ALARM & FIRE PROTECTION
SETTY & ASSOCIATES
75 S. Charles Street, Suite 403
Baltimore, MD 21201
667.309.6036

AUDIO VISUAL & TELECOM
CONVERGENT TECHNOLOGIES
DESIGN GROUP
6501 York Road
Baltimore, MD 21212
410.532.2205

SECURITY
THORNTON TOMASETTI
1330 Connecticut Ave, NW,
Suite 300
Washington, DC 20036
202.580.6300

FOOD SERVICE
COLBURN GUYETTE
100 Ledgewood Place, Suite 104
Rockland, MA, 02370
781.826.5522

BUILDING ENCLOSURE
MPSON GUMPERTZ & HEGER
1625 Eye St NW
Suite 900
Washington, DC 20006
202.239.4199

LEED
SUSTAINABLE DESIGN
CONSULTING
1432 K Street NW, 3rd Floor
Washington, DC 20005
202.667.1620

WIND & AIR QUALITY
RWDI
650 Woodland Rd.
W. Guelph, Ontario
Canada N1K 1B8
519.823.1311

VIBRATION & ACOUSTICS
COLIN GORDON ASSOCIATES
1350 Old Bayshore Hwy, Suite 799
Burlingame, CA 94010
415.570.0350

LIGHTING FISHER MARANTZ STONE
22 W. 41st St., 10th Fl.
SITE LIGHTING TILLETT LIGHTING DESIGN
1000 GAFFEES

New York, NY 10011
212.691.3020

11 Hanover Square, 17th Floor
New York, NY 10005
212.766.0144

115 Juliad Ct., Suite 105 AEI AFFILIATED ENGINEERS
Fredericksburg, VA 22406 200 International Circle, Suite 5888
540.286.1984 Hunt Valley, MD 21030
410.339.0000

LIFE SCIENCES BUILDING

202 N.W. 1st Avenue
Miami, FL 33128

Dartmouth, NB E1E 6G

JOHNS HOPKINS

U N I V E R S I T Y

Baltimore, Maryland 21287

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|---|---------------|------------------|
|  | Date: | OCTOBER 24, 2025 |
| | Scale: | 1/8" = 1'-0" |
| Drawn By: | | |
| Designed By: | | |
| Checked By: | | |
| Proj. Mgr.: | | |
| Payette Job No.: | 17480.00 | |
| Cadd File: | | |
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| Client Job Name: | | |

I certify that these documents were prepared or
signed by me, and that I am duly licensed
and registered under the laws of the State of Maryland.

EL2.07A

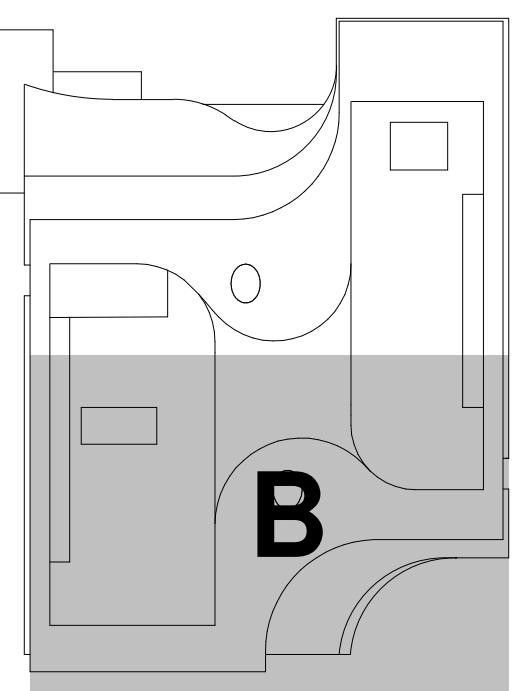
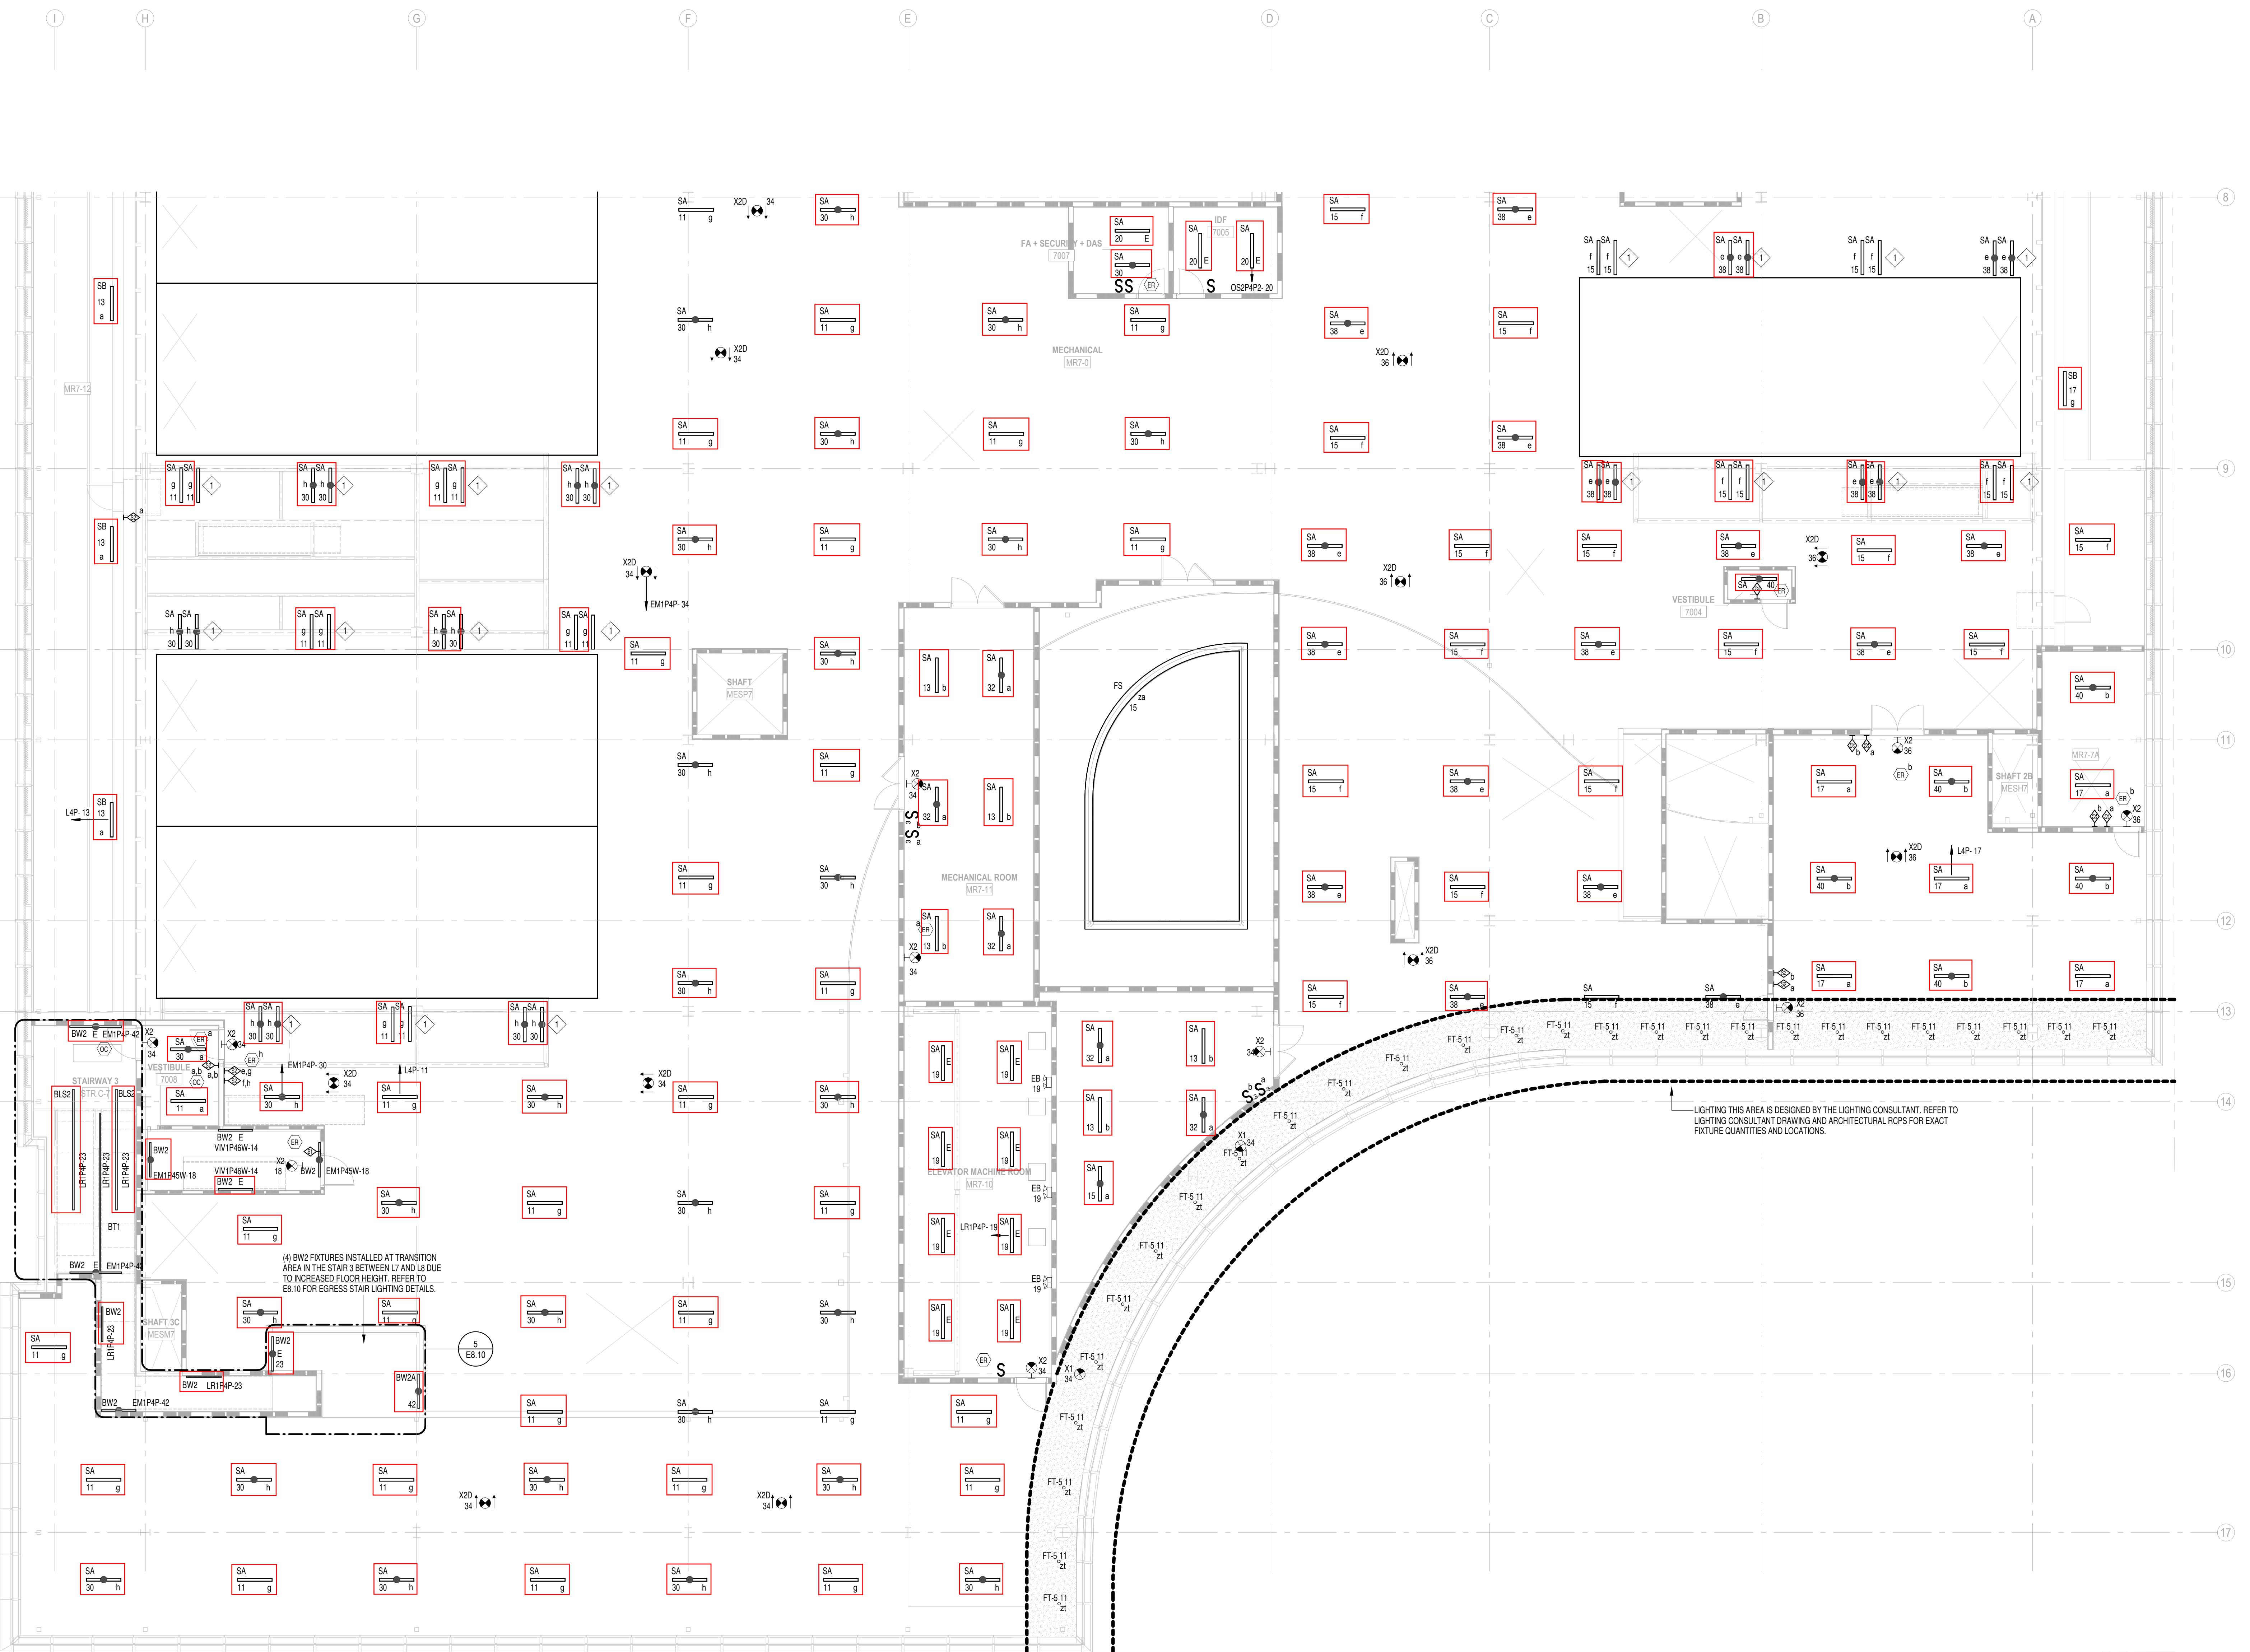
LIGHTING THIS AREA IS DESIGNED BY THE LIGHTING CONSULTANT. REFER TO LIGHTING CONSULTANT DRAWING AND ARCHITECTURAL RCPs FOR EXACT FIXTURE QUANTITIES AND LOCATIONS.

ALL PENTHOUSE LIGHT FIXTURES SHALL BE COORDINATED WITH OTHER TRADES, AND SHALL BE INSTALLED UPON THE COMPLETION OF DUCTWORK AND PIPING THROUGHOUT THE PENTHOUSE.

NO FLY ZONE FOR EQUIPMENT RIGGING

7007

1 LIGHTING RCP A - PARENT - LEVEL 7
1/8" = 1'-0"



KEY PLAN

ARCHITECT
PAYETTE ASSOCIATES, INC.
290 Congress Street, Fifth Floor
Boston, MA 02210
617.895.1000

ASSOCIATE ARCHITECT
KPN ARCHITECTS
1800 Washington Blvd, Suite 414
Baltimore, MD 21230
443.682.7757

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|---|---|

LANDSCAPE ARCHITECT
OLIN
617 John F. Kennedy Boulevard,
Suite 1900
Philadelphia, PA 19103
215.546.2000

STRUCTURAL
COLUMBIA ENGINEERING, INC.
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10 Guest Street, 4th Floor
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RE ALARM & FIRE PROTECTION
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75 S. Charles Street, Suite 403
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AUDIO VISUAL & TELECOM
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SECURITY **FOOD SERVICE**
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WIND & AIR QUALITY

VIBRATION & ACOUSTICS

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HICKERT MARENZ STONE
22 West 19th Street, 6th Floor
New York, NY 10011
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**HILLETT LIGHTING DESIGN
ASSOCIATES**
11 Hanover Square, 17th Floor
New York, NY 10005
212.766.0144

EMI/RFI (SCREENING)
STATECH ELECTROMAGNETICS
115 Juliad Ct., Suite 105
Fredericksburg, VA 22406
540.286.1984

CAMPUS UTILITIES
AEI AFFILIATED ENGINEERS
200 International Circle, Suite 5888
Hunt Valley, MD 21030
410.229.0000

LIFE SCIENCES BUILDING

600 N Broadway
Baltimore, MD 21205

JOHNS HOPKINS U N I V E R S I T Y

Baltimore, Maryland 21287

LIGHTING RCP B - LEVEL 7

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|  | Date: | OCTOBER 24, 2025 |
| | Scale: | 1/8" = 1'-0" |
| | Drawn By: | |
| | Designed By: | |
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| | Proj. Mgr.: | |
| | Payette Job No.: | 17480.00 |
| | Cadd File: | |
| | Client Job No.: | J.170.24.4000 |

I certify that these documents were prepared or
executed by me, and that I am duly licensed
to practice under the laws of the State of Maryland.

EE2.07B

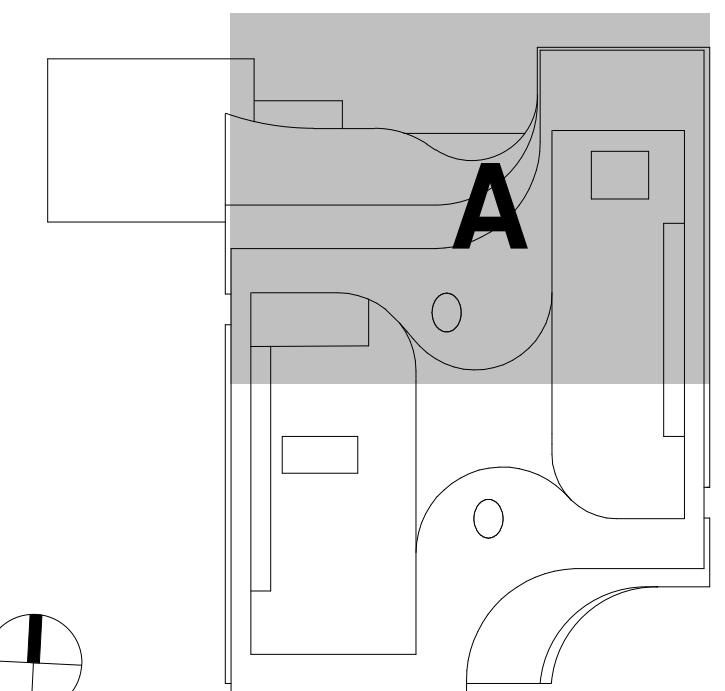
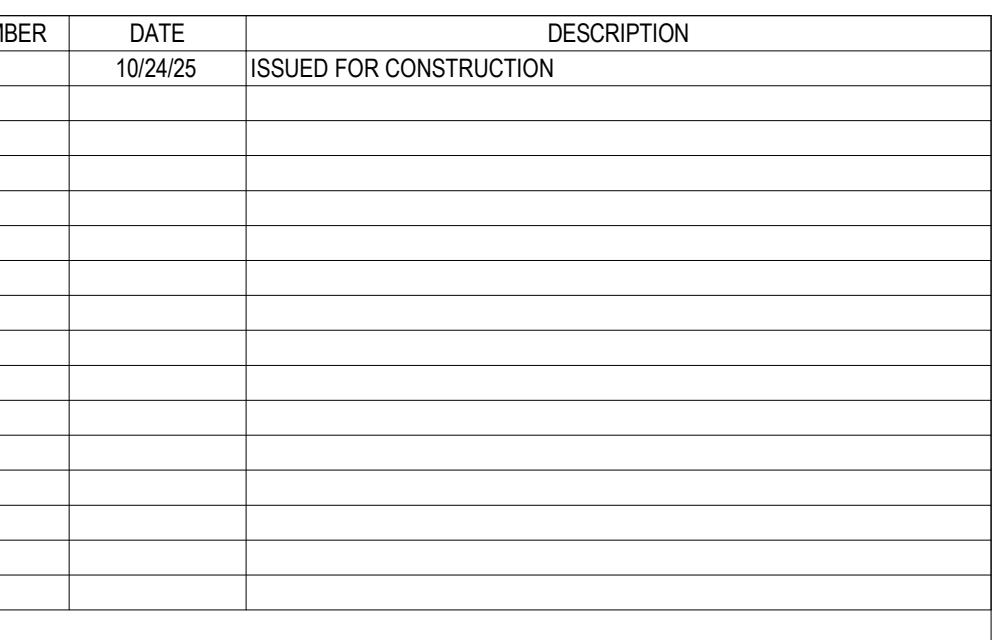
REFER TO LIGHTING CONSULTANT'S DRAWINGS AND
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FOR PRICING PURPOSES, ASSUME THAT EACH UNIQUE FIXTURE TYPE WITHIN A SPACE SHALL ON A DEDICATED CONTROL ZONE (UNLESS OTHERWISE NOTED). PLUS ADDITIONAL ZONES FOR PRIMARY AND SECONDARY DAYLIGHT ZONES.

ASSUME EGRESS LIGHTING WITH BYPASS RELAYS FOR ALL LIGHTING IN THE PATH OF EGRESS.

GENERAL LIGHTING NOTES:

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KEY PLAN

ARCHITECT
PAYETTE ASSOCIATES, INC.
290 Congress Street, Fifth Floor
Boston, MA 02210
617.895.1000

ASSOCIATE ARCHITECT
KPN ARCHITECTS
1800 Washington Blvd, Suite 414
Baltimore, MD 21230
443.682.7757

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|---|---|
| CODE CODE RED CONSULTANTS 154 Turnpike Road, Suite 200 Southborough, MA 01772 617.500.7633 | CIVIL RK&K 700 East Pratt Street, Suite 500 Baltimore, MD 21202 410.728.2900 |
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Washington, DC 20036
202.580.6300 781.826.5522

**1625 Eye St NW
Suite 900
Washington, DC 20006
202.239.4199**

**CONSULTING
1432 K Street NW, 3rd Floor
Washington, DC 20005
202.667.1620**

KWBP
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Canada N1K 1B8
519.823.1311

SCOTT GORDON ASSOCIATES
1350 Old Bayshore Hwy, Suite 799
Burlingame, CA 94010
415.570.0350

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LIFE SCIENCES BUILDING

202 N. BROAD ST.

Baltimore, MD 21205

JOHNS HOPKINS
U N I V E R S I T Y

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|---|-------------------------------|
| LIGHTING RCP A - LEVEL 8 | |
|  | Date: OCTOBER 24, 2025 |
| al | Scale: 1/8" = 1'-0" |
| | Drawn By: |
| | Designed By: |
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I certify that these documents were prepared or
reviewed by me, and that I am duly licensed
and/or certified under the laws of the State of Maryland.

EL2.08A

This architectural floor plan illustrates a cross-section of a building, likely a penthouse, showing various rooms, shafts, and equipment. The plan is organized into horizontal levels (1 through 8) and vertical columns (A through I). Key features include:

- Rooms and Shafts:** STAIR STR.J-8, SHAFT 1A, MECHANICAL [MR8.2], MECHANICAL SHAFT [MES8], and several smaller rooms labeled SA (e.g., SA 3 b, SA 18 a, SA 22 d).
- Equipment:** STAIR PRESS. FAN [MR8-1], STAIRWAY 1, and various electrical and mechanical components.
- Ductwork and Piping:** Ductwork is shown as curved and straight lines, with specific dimensions like X2D 20 and X2D 20+20. Piping is indicated by small circles and lines.
- Lighting:** Light fixtures are marked with a circle and a dot, often labeled with letters (a, b, c, d, e, f, g, h, i) and numbers (e.g., WA 18 g, SA 26 a).
- Annotations:** A note at the top right states "LOCATED ADJACENT TO DOOR ONTO ROOF". A note near the bottom center reads "FINAL LOCATION OF ALL LIGHT FIXTURES SHALL BE COORDINATED WITH OTHER TRADES IN THE PENTHOUSE, AND SHALL BE INSTALLED UPON THE COMPLETION OF THE INSTALLATION OF ALL DUCTWORK AND PIPING."
- Legend:** A legend at the bottom left identifies symbols for various components, including a circle with a dot for light fixtures, a rectangle for ductwork, and a square for equipment.

1 LIGHTING RCP A - PARENT - LEVEL 8
1/2" 1/2"

$$1/8" = 1'-0"$$

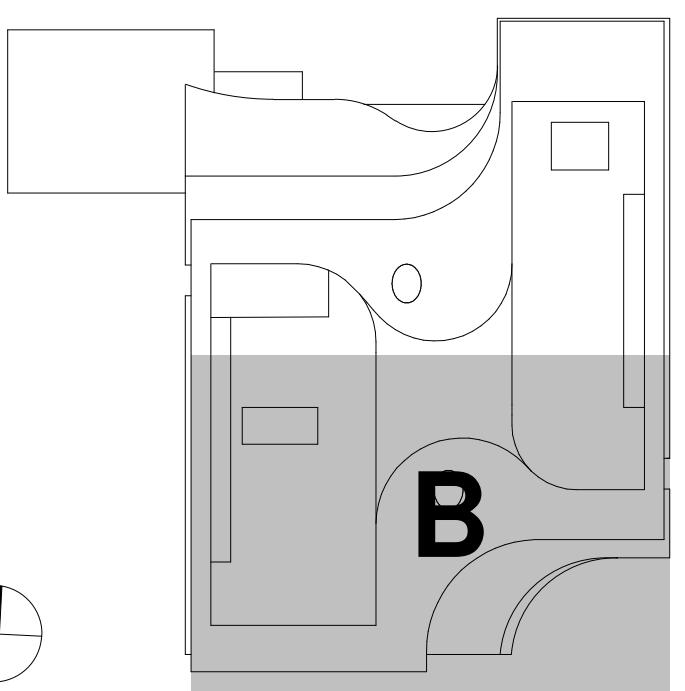
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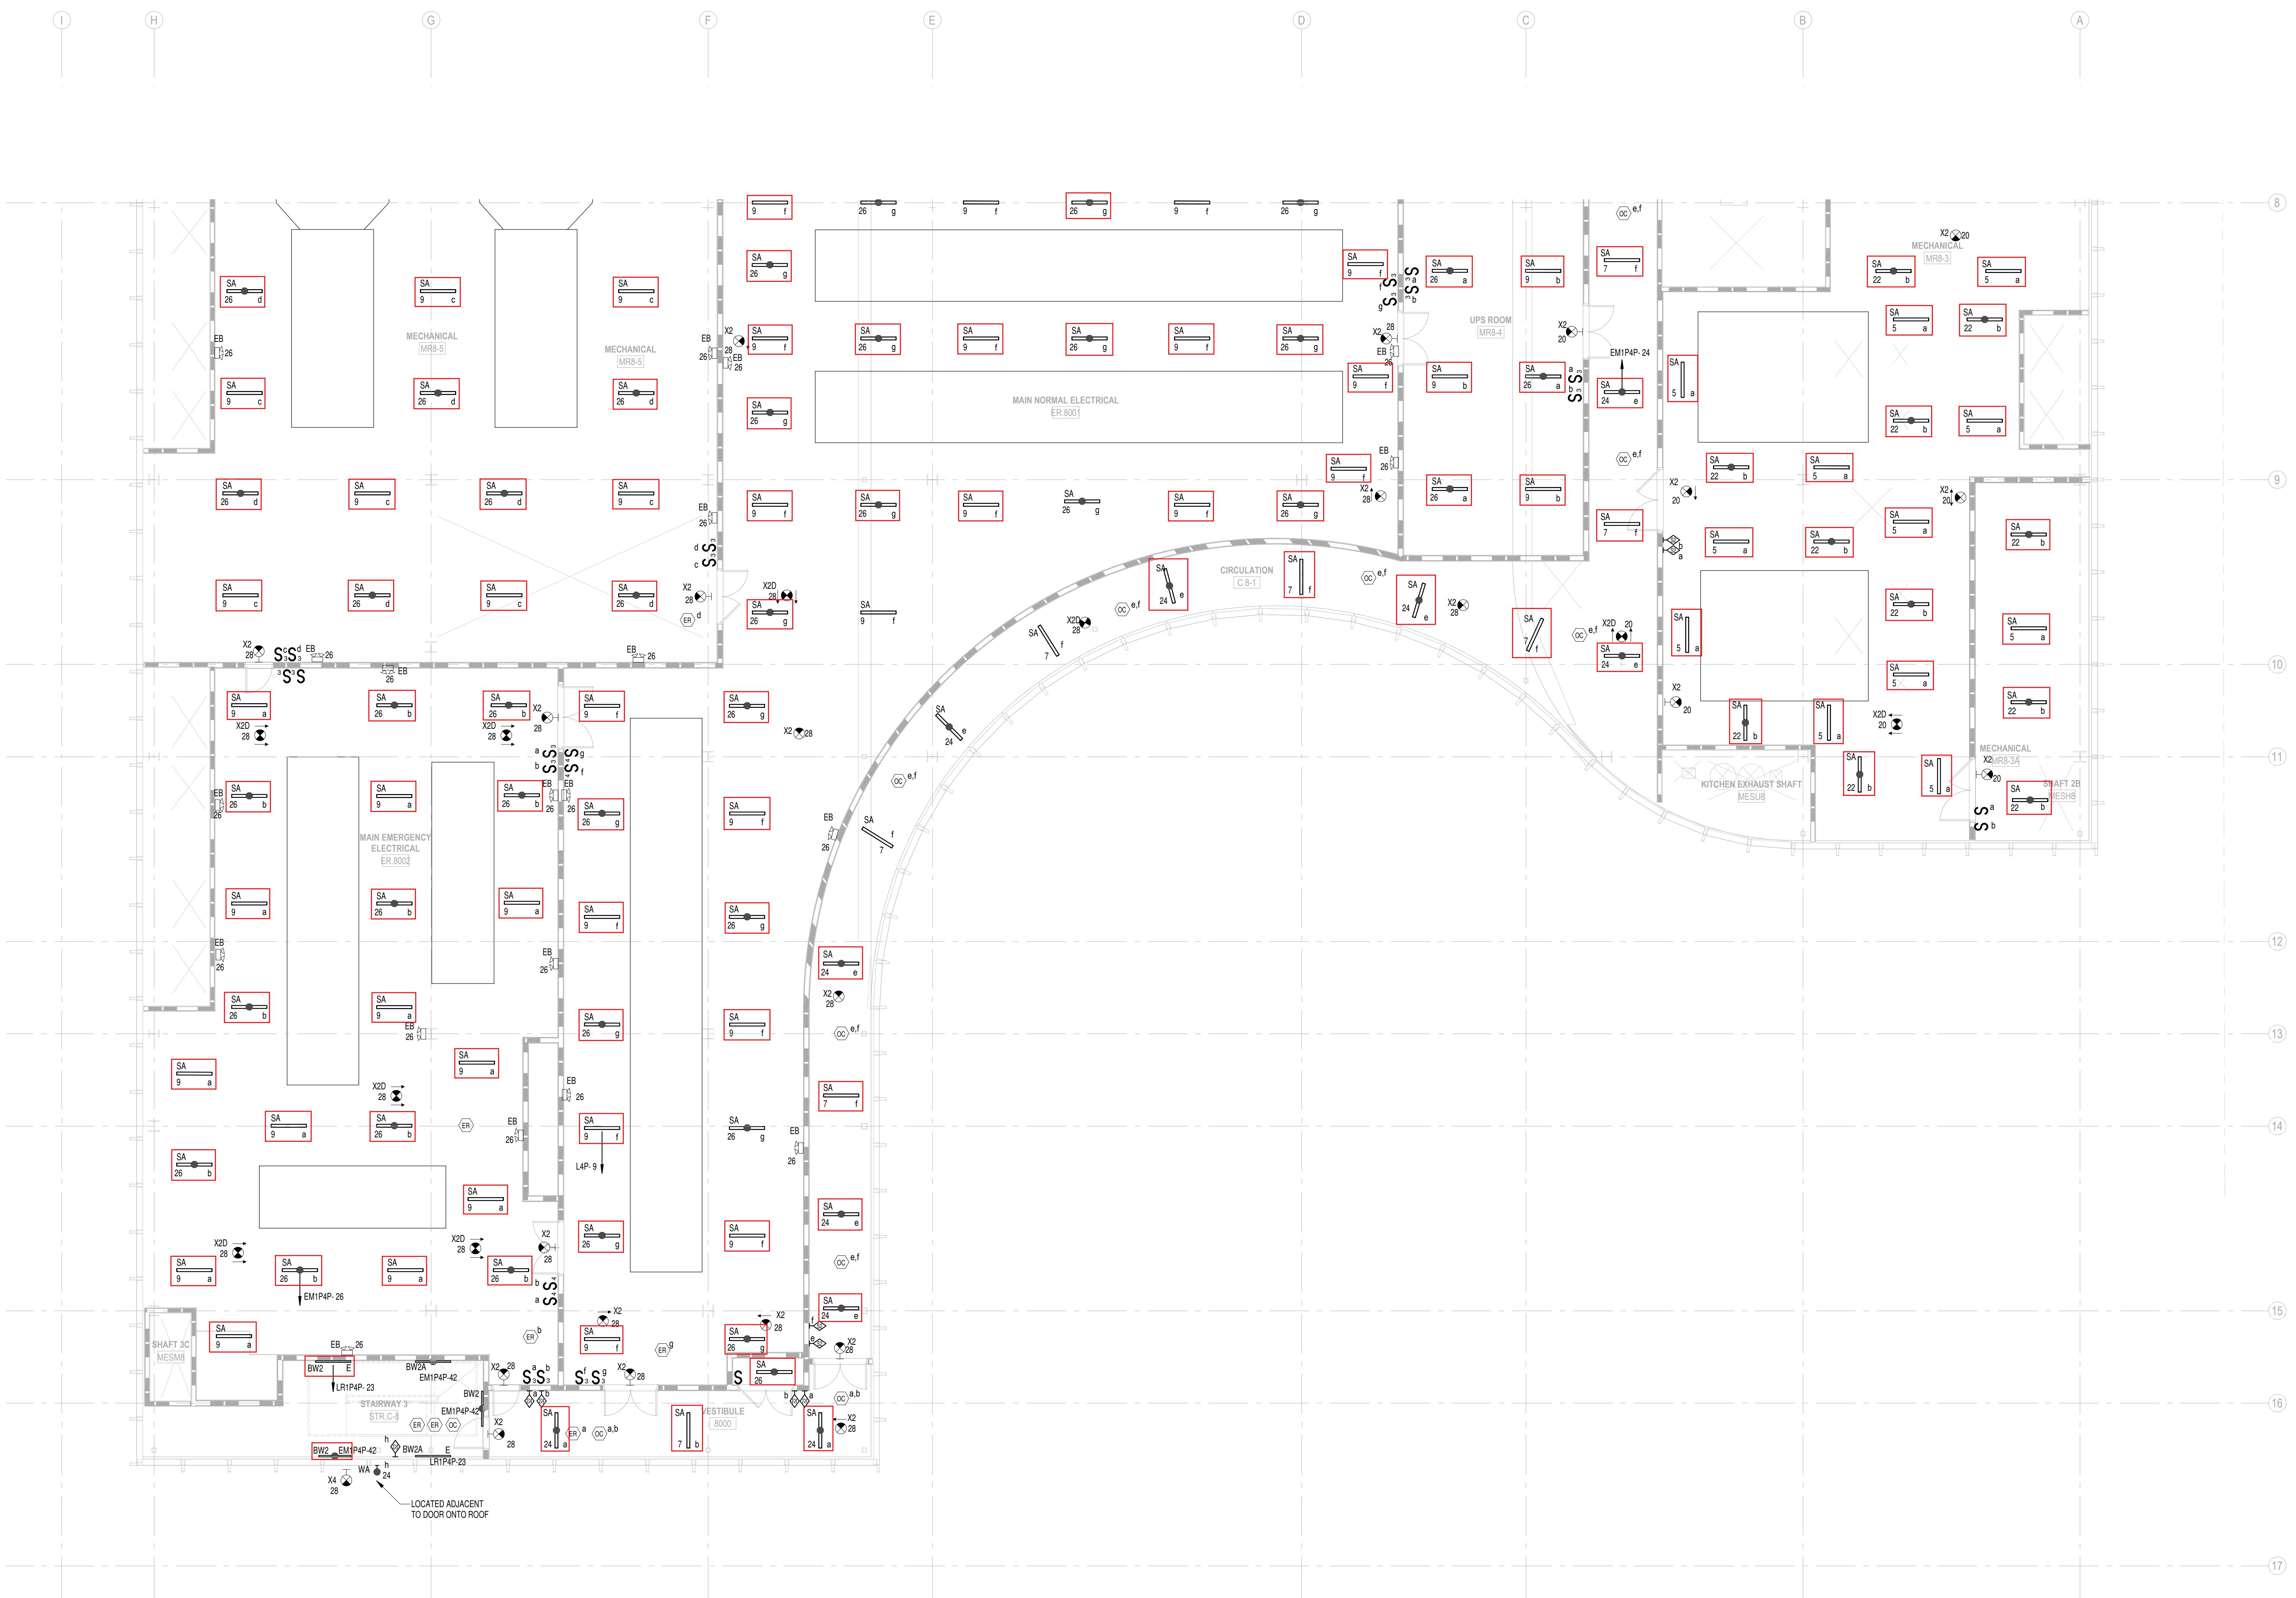
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KEY PLAN



1 LIGHTING RCP B - PARENT - LEVEL 8
4'0" - 11'0"

1/8" =

| | | |
|--|---------------|------------------|
|  The seal of the State of Maryland, featuring a central shield with a Native American figure holding a bow and arrow, surrounded by a circular border with the words "THE STATE OF MARYLAND". The border is signed "DANIEL F MOYNAHAN" and "PROFESSIONAL ENGINEER". A blue ink signature "NOV 6 2022" is overlaid on the bottom left of the seal. | Date: | OCTOBER 24, 2025 |
| | Scale: | 1/8" = 1'-0" |
| Drawn By: | | |
| Designed By: | | |
| Checked By: | | |
| Proj. Mgr.: | | |
| Payette Job No.: | 17480.00 | |
| Cadd File: | | |
| Client Job No.: | J.170.24.4000 | |
| Client Dwg. No.: | | |

certify that these documents were prepared or

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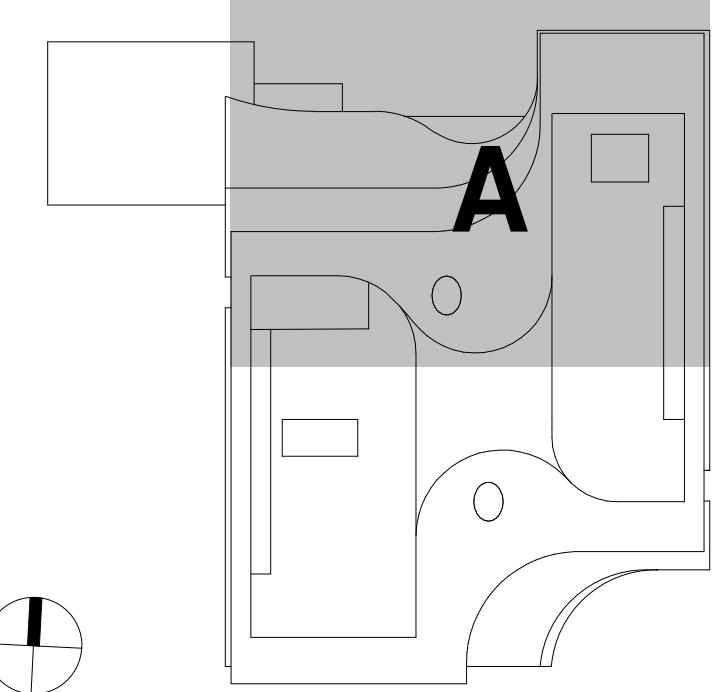
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KEY PLAN

1 LIGHTING RCP A - PARENT - ROOF
1/8" = 1'-0"

\odot $1/8^\circ = 1^\circ - 0^\circ$

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| Seal | Date: | OCTOBER 24, 2025 |
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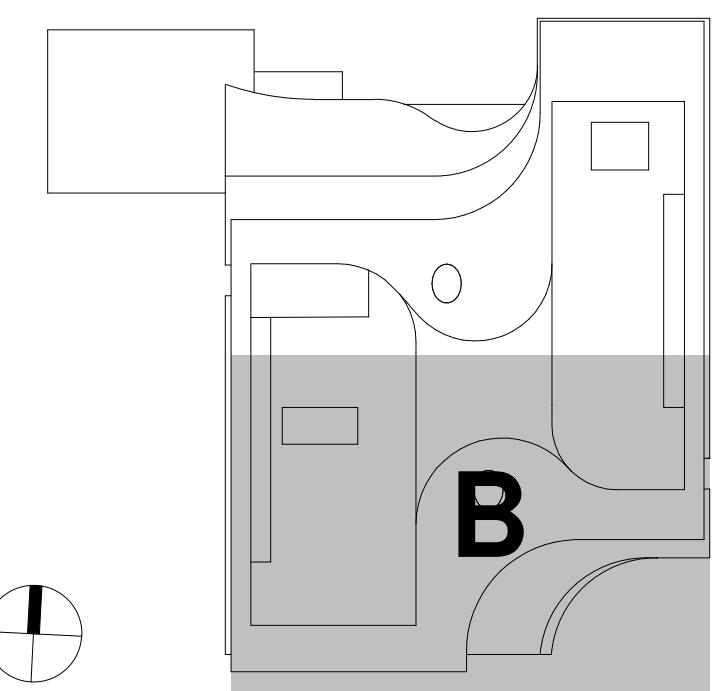
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