


LEGEND - CEILING PLAN		NUMBER	DATE	DESCRIPTION
	APC-1A	ACOUSTICAL PANEL CEILING (2X), LAB SUPPORT		
	APC-1B	ACOUSTICAL PANEL CEILING (2X), DARK ROOM (BLACK)		
	APC-2	ACOUSTICAL PANEL CEILING (2X), FOCUS ROOM (HIGH NR)		
	APC-3	ACOUSTICAL PANEL CEILING (2X), OPEN OFFICE		
	APC-4	ACOUSTICAL PANEL CEILING (2X), OFFICES, CONF.		
	APC-5	ACOUSTICAL PANEL CEILING (2X), OPEN LAB		
	APC-6	ACOUSTICAL PANEL CEILING (2X), BOH		
	APC-7	ACOUSTICAL PANEL CEILING (2X), WASHABLE, RADIOSPHERE, SERVICE		
	APC-8	ACOUSTICAL PANEL CEILING (2X), MOISTURE RESISTANT, LOADING DOCK		
	APC-9	ACOUSTICAL PANEL CEILING (2X), SEMINAR, CONFERENCE		
	FPR-1	FIBERGLASS REINFORCED CEILING PANELS		
	GWB-1	GYPSUM BOARD CEILING, PAINTED		
	GWB-2	GYPSUM BOARD CEILING WITH HPC		
	GWB-3	ACOUSTICAL PLASTER CEILING		
	EXP-1	EXPOSED TO STRUCTURE		
	EXP-2	EXPOSED TO STRUCTURE WITH PAINTED MEP, HANGERS, ACOUSTIC SPRAY COATING AT DECK		
	LWC-1	LINEAR WOOD CEILING ACOUSTIC INFILL PANEL SEE A9.73.1		
	LWC-2	LINEAR WOOD CEILING WITH ACOUSTIC SPRAY COATING ABOVE SEE A9.73.1		
	WPC-1	ACOUSTICAL WOOD PANEL CEILING		
	MPC-1	MICRO-PERFORATED METAL PANEL CEILING		
	MPC-2	PERFORATED METAL CEILING WITH NON-COMBUSTIBLE ACOUSTIC INFILL PANEL SEE A9.72		
	ST-1	LINEAR WOOD CEILING SOFFITS		
	ST-2.1	METAL PANEL SOFFIT - EXTERIOR SOFFIT POWDER COAT TO MATCH COPPER ANODIZED ALUM.		
	ST-2.2	METAL PANEL SOFFIT - EXTERIOR SOFFIT POWDER COAT TO MATCH BRONZE ANODIZED ALUM.		
	CSP-X	CEILING SERVICE PANEL SEE A10.05A FOR TYPES		
	OHR	OVERHEAD SERVICE RACK, SEE A10.07 FOR DETAILS.		
	(C)	CEILING MOUNTED SECURITY CAMERA, REFER TO SECURITY DWG		
		EXIT SIGN CEILING MOUNTED / WALL MOUNTED		
		CEILING MOUNTED SPRINKLERS, REFER TO PLUM. DWG		
		FIRE ALARM CEILING MOUNTED / WALL MOUNTED		
	H	CEILING MOUNTED HEAT DETECTOR		
	SD	CEILING MOUNTED SMOKE DETECTOR		
	WAP-1	WIRELESS ACCESS POINT MOUNTED ON CEILING		
	WAP-2	WIRELESS ACCESS POINT MOUNTED ABOVE CEILING		
	OC	CEILING MOUNTED OCCUPANCY/PHOTOCELL SENSOR		
		EXHAUST CONNECTION @ CEILING - REF. MECH. DWGS		
		LINEAR WALL WASH		
	ROLLER SHADES:			
	RS-1	MOTORIZED ROLLER SHADE WITH SINGLE ROLLERS, LIGHT-FILTERING FABRIC.		
	RS-2	MOTORIZED ROLLER SHADE WITH DOUBLE ROLLERS, MOISTURE-RESISTANT LIGHT-FILTERING FABRIC AND MOISTURE-RESISTANT OPAQUE FABRIC.		
	RS-3	MOTORIZED ROLLER SHADE WITH SINGLE ROLLERS, MOISTURE-RESISTANT OPAQUE FABRIC, WITH WINDOW FRAME LIGHT BAFFLES.		
	GENERAL NOTES:			
	1. FOR LIGHTING FIXTURE TYPES REFER TO LIGHTING SCHEDULE. 2. FOR SPRINKLER TYPES REFER TO FIRE PROTECTION DRAWINGS. 3. CENTER ALL DEVICES WITH TILES U.N.O. 4. DEVICES IN OFFICES ARE SHOWN FOR QUANTITIES, REFER TO A9.74.1 FOR TYPICAL LAYOUT			
	LEGEND - LIGHT FIXTURES			
	REFER TO MEP DRAWINGS AND SPECIFICATIONS			
		XXXXXX	LINEAR PENDANT FIXTURE	
		XXXXXX	SUSPENSION HEIGHT AFF FIXTURE LENGTH FIXTURE TYPE	
		XXXXXX	LINEAR RECESSED FIXTURE	
		XXXXXX	RECESSED DOWNLIGHT FIXTURE LENGTH FIXTURE TYPE	
		XXX	RECESSED 2X2 TROFFER FIXTURE TYPE	
		XXX	RECESSED 2X4 TROFFER FIXTURE TYPE	
		XXX	RECESSED ATRIUM DOWNLIGHT FIXTURE TYPE	
	Seal			
	Date:	OCTOBER 24, 2025		
	Scale:	As indicated		
	Drawn By:			
	Designed By:			
	Checked By:			
	Proj. Mgr.:			
	Payette Job No.:	1740.00		
	Cadd File:			
	Client Job No.:	J.170.24.4000		
	Client Dwg. No.:			
	Professional Certification.			
	I hereby certify that these documents were prepared or approved by me, and that they are duly licensed engineer under the laws of the State of Maryland.			
	License No. 9986 Expiration Date: 06/20/2026			


A6.30.A1

LEGEND - CEILING PLAN


APC-1A	ACOUSTICAL PANEL CEILING (2X2), LAB SUPPORT
APC-1B	ACOUSTICAL PANEL CEILING (2X2), DARK ROOM (BLACK)
APC-2	ACOUSTICAL PANEL CEILING (2X2), FOCUS ROOM (HIGH NRC)
APC-3	ACOUSTICAL PANEL CEILING (2X4), OPEN OFFICE
APC-4	ACOUSTICAL PANEL CEILING (2X4), OFFICES, CONF.
APC-5	ACOUSTICAL PANEL CEILING (2X4), OPEN LAB
APC-6	ACOUSTICAL PANEL CEILING (2X2), BOH
APC-7	ACOUSTICAL PANEL CEILING (2X2), WASHABLE, RADIOTSCOPE, FOOD SERVICE
APC-8	ACOUSTICAL PANEL CEILING (2X2), MOISTURE RESISTANT, LOADING DOCK
APC-9	ACOUSTICAL PANEL CEILING (2X4), SEMINAR, CONFERENCE
FPR-1	FIBERGLASS REINFORCED CEILING PANELS
GWB-1	GYPSUM BOARD CEILING, PAINTED
GWB-2	GYPSUM BOARD CEILING WITH HPC
GWB-3	GYPSUM PLASTER CEILING
EXP-1	EXPOSED TO STRUCTURE
EXP-2	EXPOSED TO STRUCTURE WITH PAINTED MEP HANGERS, ACOUSTIC SPRAY COATING AT DECK
LWC-1	LINEAR WOOD CEILING ACOUSTIC INFILL PANEL SEE A9.73.1
LWC-2	LINEAR WOOD CEILING WITH ACOUSTIC SPRAY COATING ABOVE SEE A9.73.1
WPC-1	ACOUSTICAL WOOD PANEL CEILING
MPC-1	MICRO-PERFORATED METAL PANEL CEILING
MPC-2	PERFORATED METAL CEILING WITH NON-COMBUSTIBLE ACOUSTIC INFILL PANEL SEE A9.72
ST-1	LINEAR WOOD CEILING SOFFITS
ST-2.1	METAL PANEL SOFFIT - EXTERIOR SOFFIT POWDER COAT TO MATCH COPPER ANODIZED ALUM.
ST-2.2	METAL PANEL SOFFIT - EXTERIOR SOFFIT POWDER COAT TO MATCH BRONZE ANODIZED ALUM.
CSP-X	CEILING SERVICE PANEL SEE A10.05A FOR TYPES.
OHR	OVERHEAD SERVICE RACK, SEE A10.07 FOR DETAILS.
C	CEILING MOUNTED SECURITY CAMERA, REFER TO SECURITY DWG
	EXIT SIGN CEILING MOUNTED / WALL MOUNTED
	CEILING MOUNTED SPRINKLERS, REFER TO PLUM. DWG
(F)	FIRE ALARM CEILING MOUNTED / WALL MOUNTED
H	CEILING MOUNTED HEAT DETECTOR
SD	CEILING MOUNTED SMOKE DETECTOR
WAP-1	WIRELESS ACCESS POINT MOUNTED ON CEILING
WAP-2	WIRELESS ACCESS POINT MOUNTED ABOVE CEILING
OC	CEILING MOUNTED OCCUPANCY/PHOTOCELL SENSOR
	EXHAUST CONNECTION @ CEILING - REF. MECH. DWG'S
	LINEAR WALL WASH

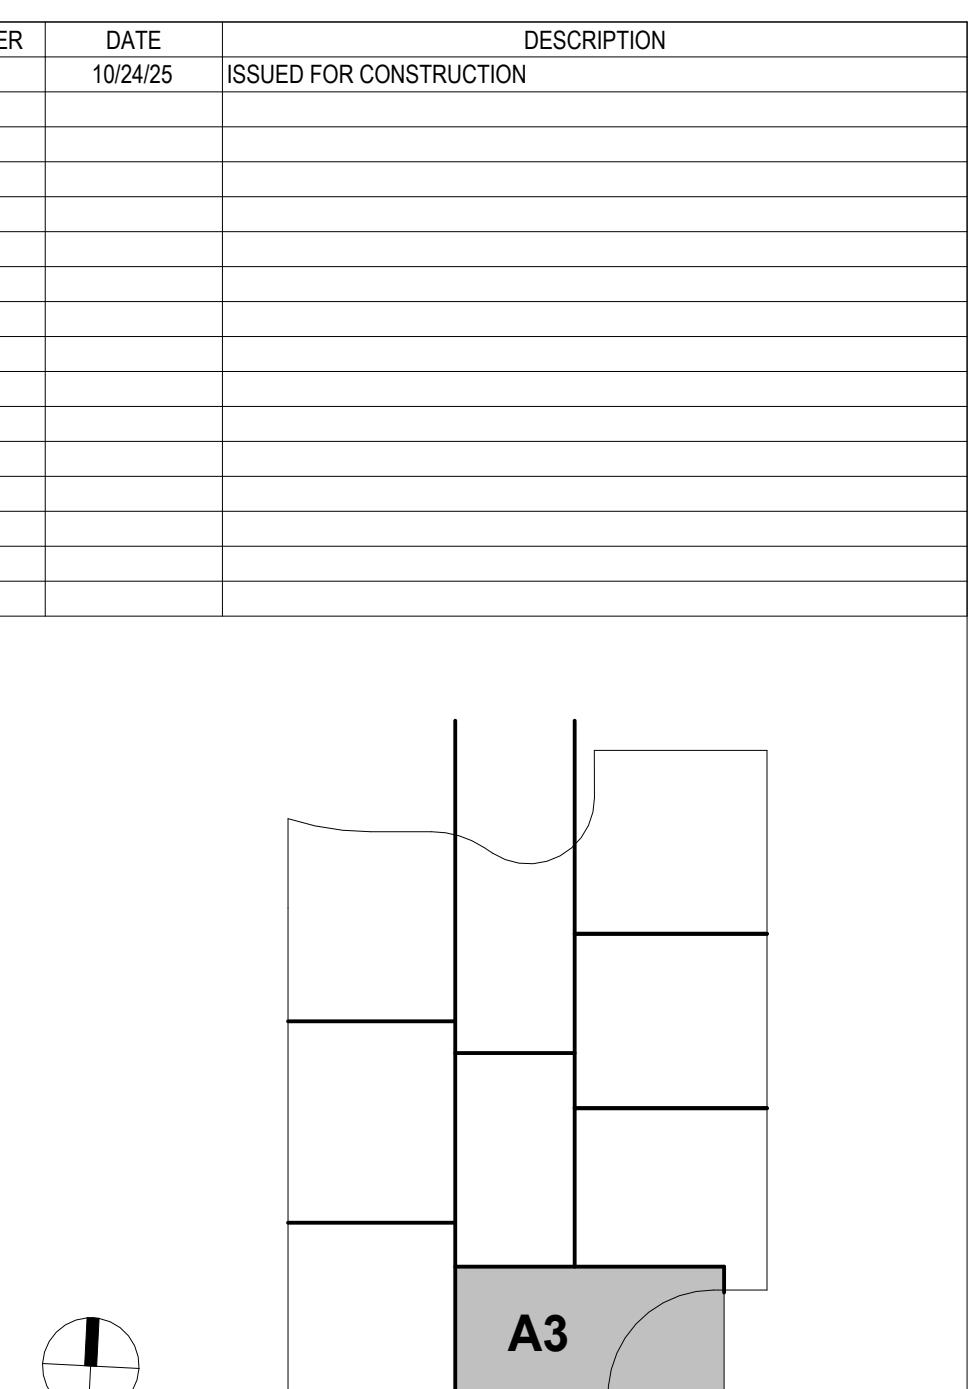

KEY PLAN

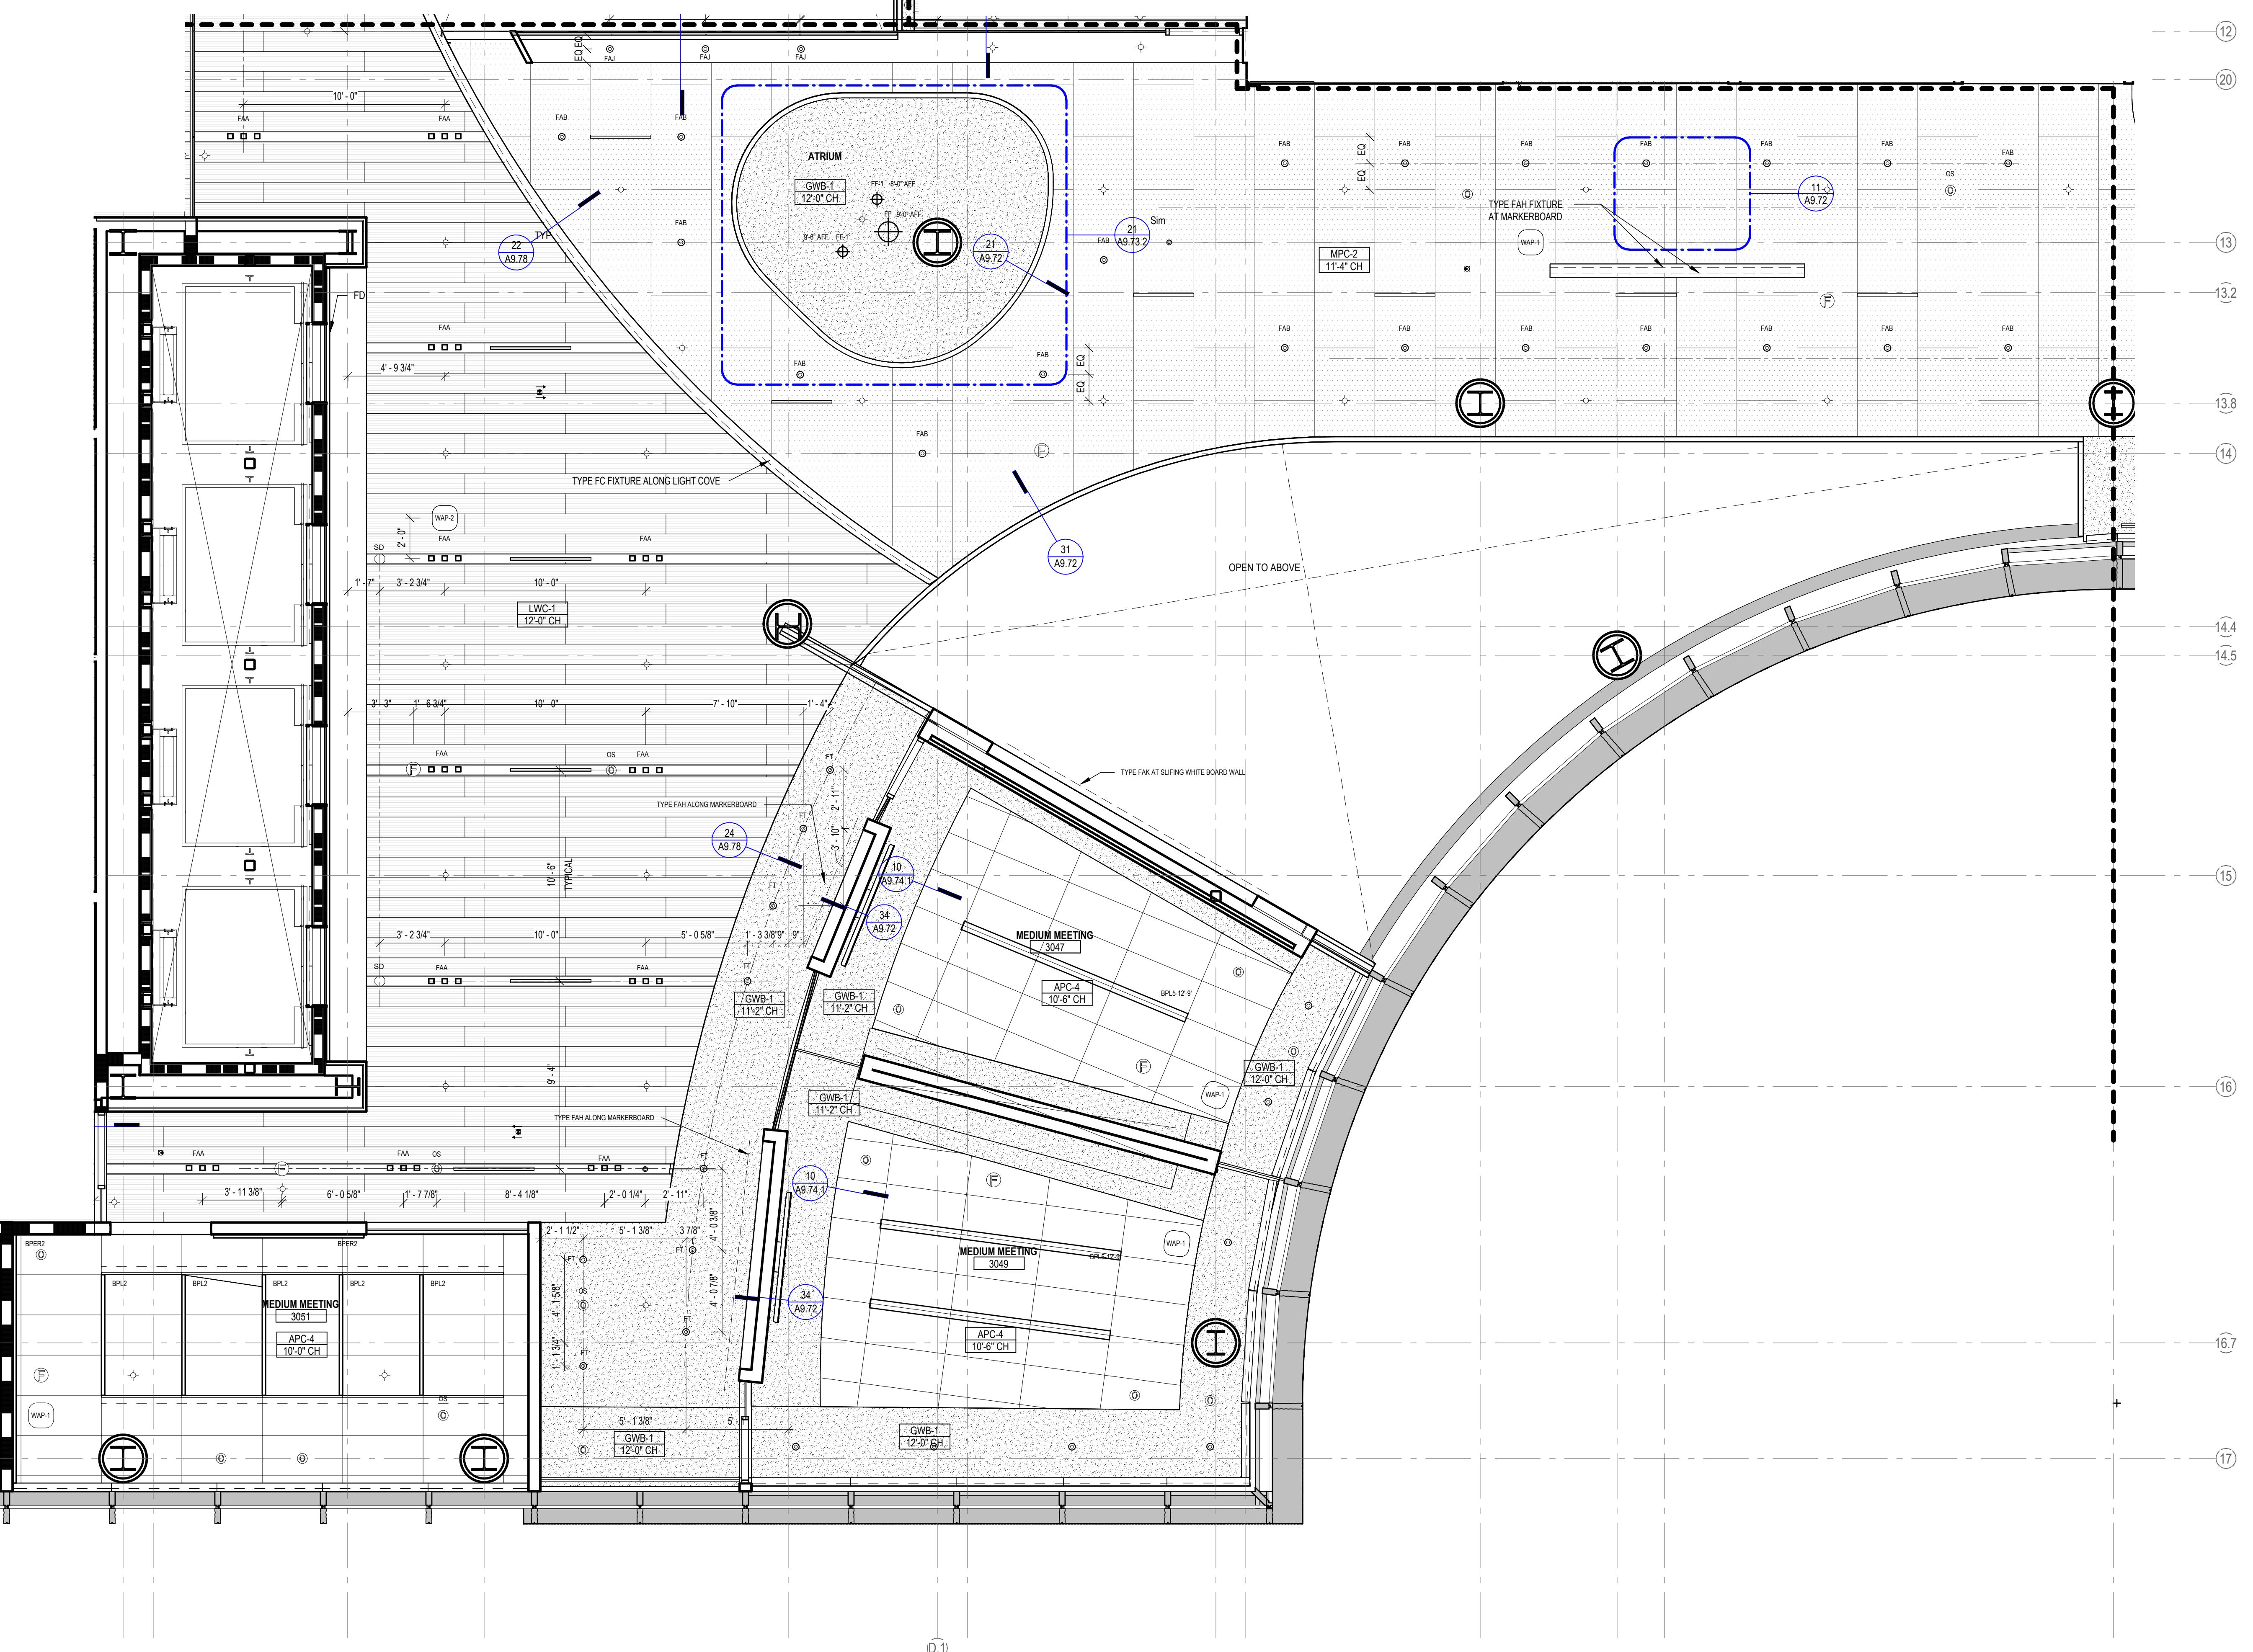

LEGEND - LIGHT FIXTURES

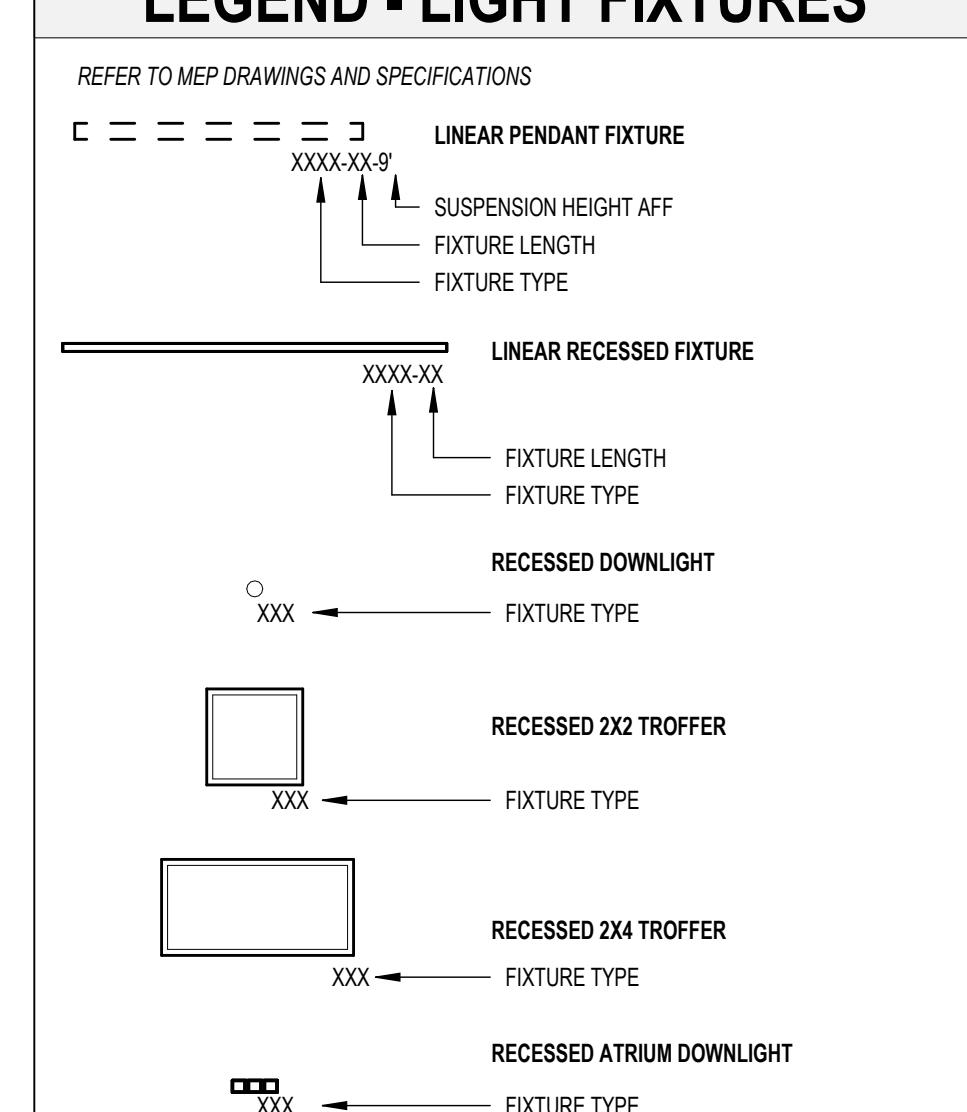

JOHNS HOPKINS
UNIVERSITY

1800 Orleans St
Baltimore, Maryland 21287

ENLARGED REFLECTED CEILING PLAN - LEVEL 3
- SECTOR A3

Seal

Date:	OCTOBER 24, 2025
Scale:	As indicated
Drawn By:	
Designed By:	
Checked By:	
Proj. Mgr.:	
Payette Job No.:	17498.00
Cadd File:	
Client Job No.:	J.170.24.4000
Client Dwg. No.:	


Professional Certification:
I hereby certify that these documents were prepared or approved by me, and that I am duly licensed engineer under the laws of the State of Maryland.
License No. 9986
Expiration Date: 06/20/2026


A6.30.A2



LEGEND - CEILING PLAN		
APC-1A	ACOUSTICAL PANEL CEILING (2X2), LAB SUPPORT	NUMBER DATE DESCRIPTION
APC-1B	ACOUSTICAL PANEL CEILING (2X2), DARK ROOM (BLACK)	10/24/25 ISSUED FOR CONSTRUCTION
APC-2	ACOUSTICAL PANEL CEILING (2X2), FOCUS ROOM (HIGH NRC)	
APC-3	ACOUSTICAL PANEL CEILING (2X4), OPEN OFFICE	
APC-4	ACOUSTICAL PANEL CEILING (2X4), OFFICES, CONF.	
APC-5	ACOUSTICAL PANEL CEILING (2X4), OPEN LAB	
APC-6	ACOUSTICAL PANEL CEILING (2X2), BOH	
APC-7	ACOUSTICAL PANEL CEILING (2X2), WASHABLE, RADIOSCOPE, FOOD SERVICE	
APC-8	ACOUSTICAL PANEL CEILING (2X2), MOISTURE RESISTANT, LOADING DOCK	
APC-9	ACOUSTICAL PANEL CEILING (2X4), SEMINAR, CONFERENCE	
FPR-1	FIBERGLASS REINFORCED CEILING PANELS	
GWB-1	GYPSUM BOARD CEILING, PAINTED	
GWB-2	GYPSUM BOARD CEILING WITH HPC	
GWB-3	ACOUSTICAL PLASTER CEILING	
EXP-1	EXPOSED TO STRUCTURE	
EXP-2	EXPOSED TO STRUCTURE WITH PAINTED MEP HANGERS, ACOUSTIC SPRAY COATING AT DECK	
LWC-1	LINEAR WOOD CEILING ACOUSTIC INFILL PANEL SEE A9.73.1	
LWC-2	LINEAR WOOD CEILING WITH ACOUSTIC SPRAY COATING ABOVE SEE A9.73.1	
WPC-1	ACOUSTICAL WOOD PANEL CEILING	
MPC-1	MICRO-PERFORATED METAL PANEL CEILING	
MPC-2	PERFORATED METAL CEILING WITH NON-COMBUSTIBLE ACOUSTIC INFILL PANEL SEE A9.72	
ST-1	LINEAR WOOD CEILING SOFFITS	
ST-2.1	METAL PANEL SOFFIT - EXTERIOR SOFFIT POWDER COAT TO MATCH BRONZE ANODIZED ALUM.	
ST-2.2	METAL PANEL SOFFIT - EXTERIOR SOFFIT POWDER COAT TO MATCH BRONZE ANODIZED ALUM.	
CSP-X	CEILING SERVICE PANEL	
OHR	OVERHEAD SERVICE RACK, SEE A10.07 FOR DETAILS.	
(C)	CEILING MOUNTED SECURITY CAMERA, REFER TO SECURITY DWG	
	EXIT SIGN CEILING MOUNTED / WALL MOUNTED	
	CEILING MOUNTED SPRINKLERS, REFER TO PLUM. DWG	
	FIRE ALARM CEILING MOUNTED / WALL MOUNTED	
H	CEILING MOUNTED HEAT DETECTOR	
SD	CEILING MOUNTED SMOKE DETECTOR	
WAP-1	WIRELESS ACCESS POINT MOUNTED ON CEILING	
WAP-2	WIRELESS ACCESS POINT MOUNTED ABOVE CEILING	
OC	CEILING MOUNTED OCCUPANCY/PHOTOCELL SENSOR	
	EXHAUST CONNECTION @ CEILING - REF. MECH. DWG'S	
	LINEAR WALL WASH	
ROLLER SHADES:		
RS-1	MOTORIZED ROLLER SHADE WITH SINGLE ROLLERS, LIGHT-FILTERING FABRIC.	
RS-2	MOTORIZED ROLLER SHADE WITH DOUBLE ROLLERS, MOISTURE-RESISTANT LIGHT-FILTERING FABRIC AND MOISTURE-RESISTANT OPAQUE FABRIC.	
RS-3	MOTORIZED ROLLER SHADE WITH SINGLE ROLLERS, MOISTURE-RESISTANT OPAQUE FABRIC, WITH WINDOW FRAME LIGHT BAFFLES.	
GENERAL NOTES:		
1.	FOR LIGHTING FIXTURE TYPES REFER TO LIGHTING SCHEDULE.	
2.	FOR SPRINKLER TYPES REFER TO FIRE PROTECTION DRAWINGS.	
3.	CENTER ALL DEVICES WITH TILES U N O	
4.	DEVICES IN OFFICES ARE SHOWN FOR QUANTITIES, REFER TO A9.74.1 FOR TYPICAL LAYOUT	
LEGEND - LIGHT FIXTURES		
REFER TO MEP DRAWINGS AND SPECIFICATIONS		
C = = = = D LINEAR PENDANT FIXTURE		
XXXXXX SUSPENSION HEIGHT AFF		
Fixture Length		
Fixture Type		
XXXXXX LINEAR RECESSED FIXTURE		
Fixture Length		
Fixture Type		
RECESSED DOWNLIGHT		
XXX		
Fixture Type		
RECESSED 2X2 TROFFER		
XXX		
Fixture Type		
RECESSED 2X4 TROFFER		
XXX		
Fixture Type		
RECESSED ATRIUM DOWNLIGHT		
XXX		
Fixture Type		
Seal		
Date:	OCTOBER 24, 2025	
Scale:	As indicated	
Drawn By:		
Designed By:		
Checked By:		
Proj. Mgr.:		
Payette Job No.:	1749.00	
Cadd File:		
Client Job No.:	J.170.24.4000	
Client Dwg. No.:		
Professional Certification.		
I hereby certify that these documents were prepared or approved by me, and that they are duly licensed engineer under the laws of the State of Maryland.		
License No. 9986 Expiration Date: 06/20/2026		


A6.31

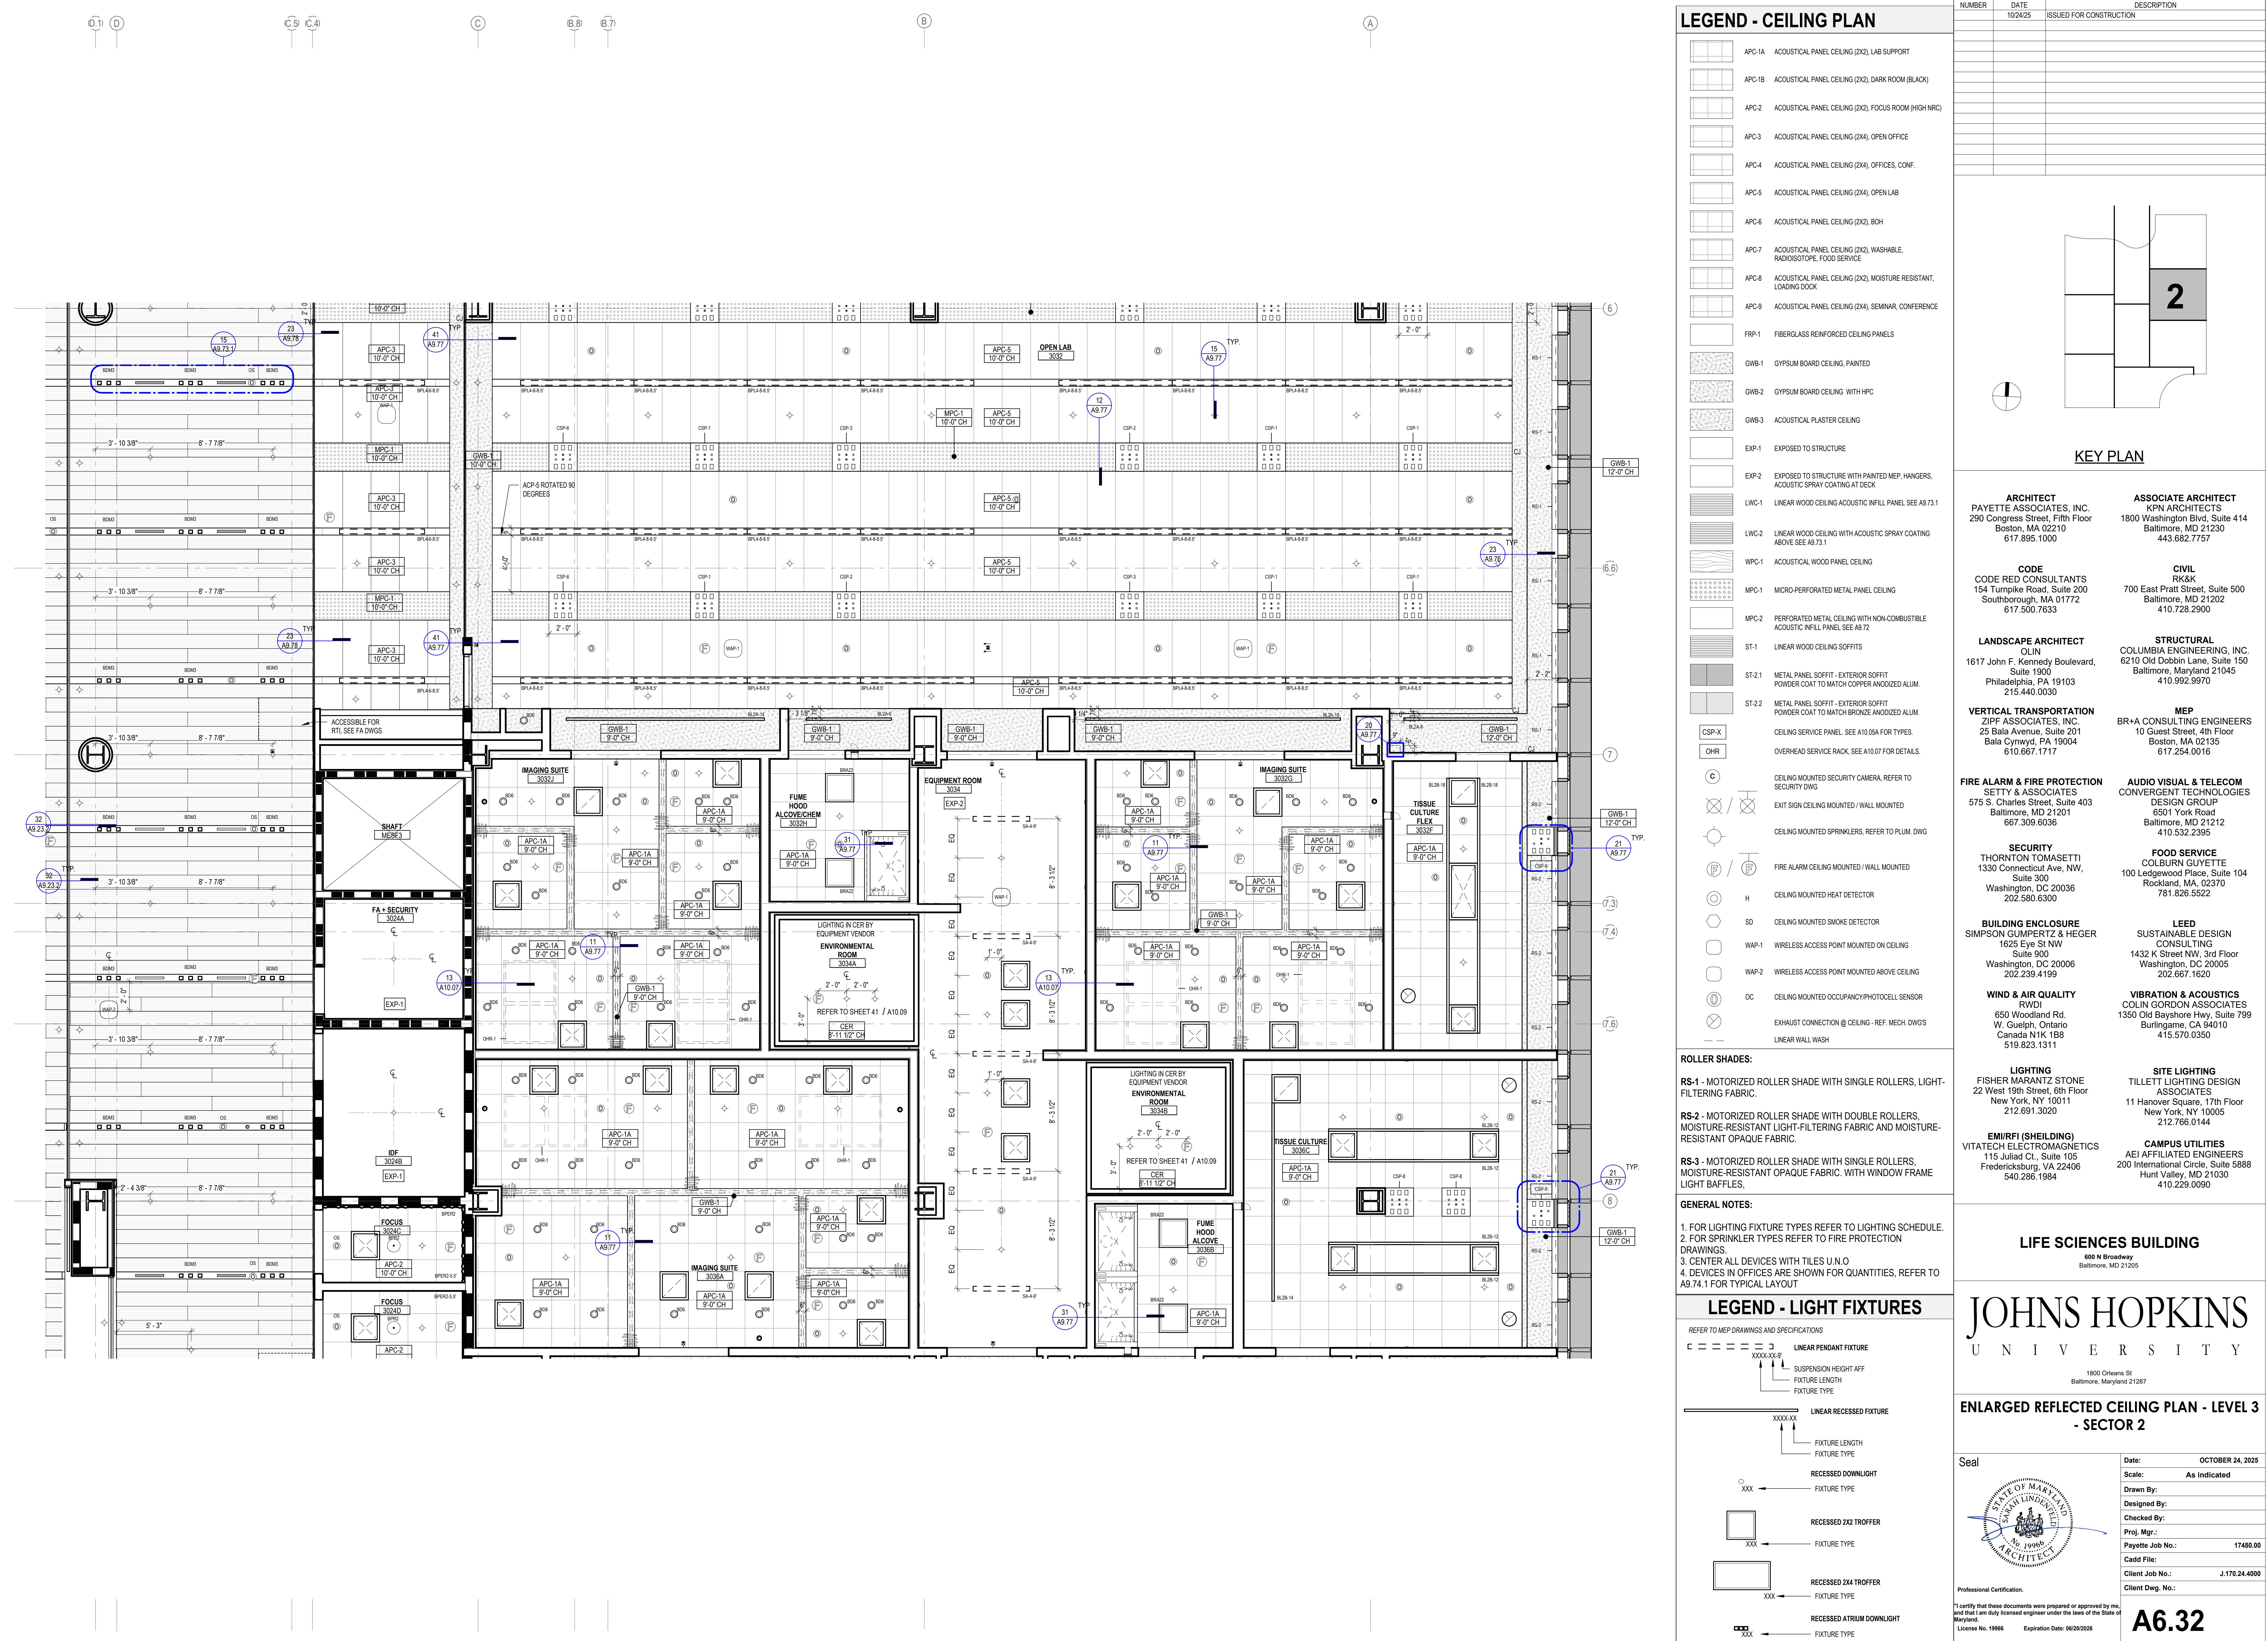

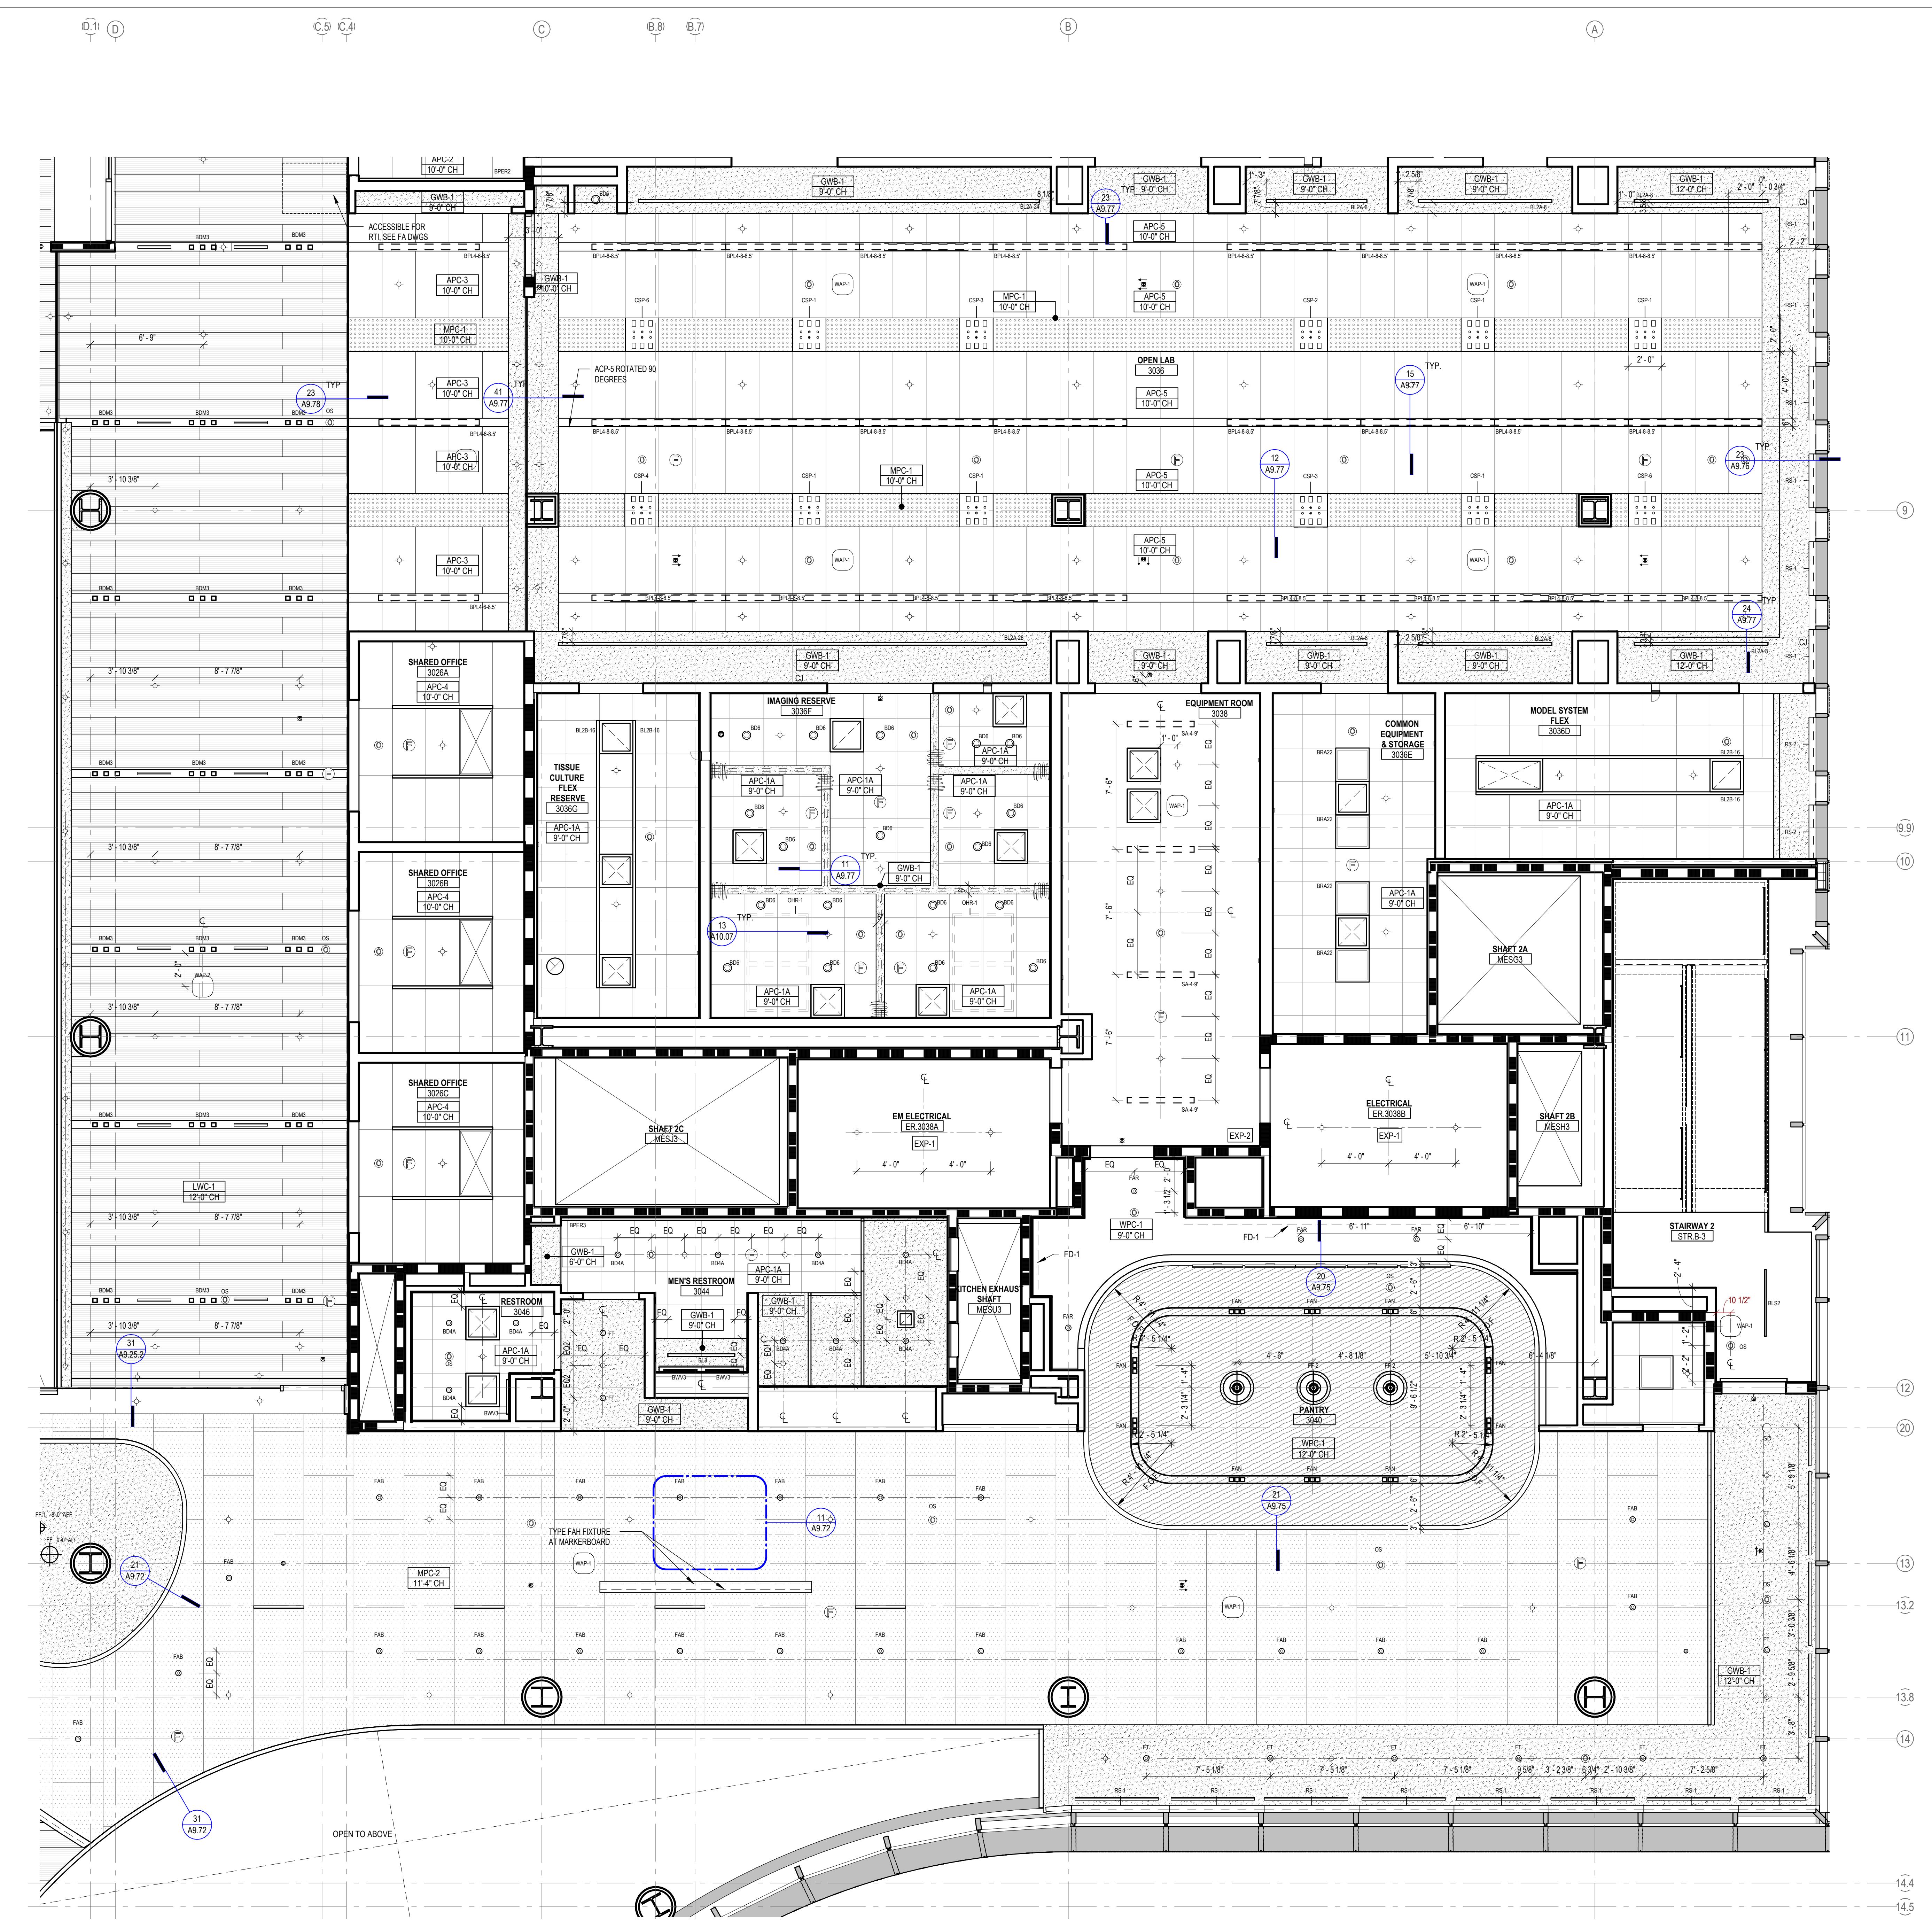

LEGEND - CEILING PLAN

[Symbol: Acoustic Panel Ceiling]	APC-1A ACOUSTICAL PANEL CEILING (2X2), LAB SUPPORT
[Symbol: Acoustic Panel Ceiling]	APC-1B ACOUSTICAL PANEL CEILING (2X2), DARK ROOM (BLACK)
[Symbol: Acoustic Panel Ceiling]	APC-2 ACOUSTICAL PANEL CEILING (2X2), FOCUS ROOM (HIGH NRC)
[Symbol: Acoustic Panel Ceiling]	APC-3 ACOUSTICAL PANEL CEILING (2X4), OPEN OFFICE
[Symbol: Acoustic Panel Ceiling]	APC-4 ACOUSTICAL PANEL CEILING (2X4), OFFICES, CONF.
[Symbol: Acoustic Panel Ceiling]	APC-5 ACOUSTICAL PANEL CEILING (2X4), OPEN LAB
[Symbol: Acoustic Panel Ceiling]	APC-6 ACOUSTICAL PANEL CEILING (2X2), BOH
[Symbol: Acoustic Panel Ceiling]	APC-7 ACOUSTICAL PANEL CEILING (2X2), WASHABLE, RADIOSCOPE, FOOD SERVICE
[Symbol: Acoustic Panel Ceiling]	APC-8 ACOUSTICAL PANEL CEILING (2X2), MOISTURE RESISTANT, LOADING DOCK
[Symbol: Acoustic Panel Ceiling]	APC-9 ACOUSTICAL PANEL CEILING (2X4), SEMINAR, CONFERENCE
[Symbol: Fiberglass Reinforced Ceiling Panels]	FRP-1 FIBERGLASS REINFORCED CEILING PANELS
[Symbol: Gypsum Board Ceiling, Painted]	GWB-1 GYPSUM BOARD CEILING, PAINTED
[Symbol: Gypsum Board Ceiling with HPC]	GWB-2 GYPSUM BOARD CEILING WITH HPC
[Symbol: Acoustic Plaster Ceiling]	GWB-3 ACOUSTICAL PLASTER CEILING
[Symbol: Exposed to Structure]	EXP-1 EXPOSED TO STRUCTURE
[Symbol: Exposed to Structure with Painted MEP Hangers, Acoustic Spray Coating at Deck]	EXP-2 EXPOSED TO STRUCTURE WITH PAINTED MEP HANGERS, ACOUSTIC SPRAY COATING AT DECK
[Symbol: Linear Wood Ceiling Acoustic Infill Panel]	LWC-1 LINEAR WOOD CEILING ACOUSTIC INFILL PANEL SEE A9.73.1
[Symbol: Linear Wood Ceiling with Acoustic Spray Coating Above]	LWC-2 LINEAR WOOD CEILING WITH ACOUSTIC SPRAY COATING ABOVE SEE A9.73.1
[Symbol: Acoustic Wood Panel Ceiling]	WPC-1 ACOUSTICAL WOOD PANEL CEILING
[Symbol: Micro Perforated Metal Panel Ceiling]	MPC-1 MICRO-PERFORATED METAL PANEL CEILING
[Symbol: Perfected Metal Ceiling with Non-Combustible Acoustic Infill Panel See A7.2]	MPC-2 PERFORATED METAL CEILING WITH NON-COMBUSTIBLE ACOUSTIC INFILL PANEL SEE A7.2
[Symbol: Linear Wood Ceiling Softit]	ST-1 LINEAR WOOD CEILING SOFFIT
[Symbol: Metal Panel Soffit - Exterior Soffit Powder Coat to Match Copper Anodized Alum.]	ST-2.1 METAL PANEL SOFFIT - EXTERIOR SOFFIT POWDER COAT TO MATCH COPPER ANODIZED ALUM.
[Symbol: Metal Panel Soffit - Exterior Soffit Powder Coat to Match Bronze Anodized Alum.]	ST-2.2 METAL PANEL SOFFIT - EXTERIOR SOFFIT POWDER COAT TO MATCH BRONZE ANODIZED ALUM.
[Symbol: Service Panel]	CSP-X
[Symbol: Overhead Service Rack]	OHR
[Symbol: Security Camera]	C
[Symbol: Exit Sign]	CEILING MOUNTED SECURITY CAMERA, REFER TO SECURITY DWG
[Symbol: Exit Sign]	EXIT SIGN CEILING MOUNTED / WALL MOUNTED
[Symbol: Sprinkler]	CEILING MOUNTED SPRINKLERS, REFER TO PLUM. DWG
[Symbol: Fire Alarm Ceiling Mount]	FIRE ALARM CEILING MOUNTED / WALL MOUNTED
[Symbol: Heat Detector]	H CEILING MOUNTED HEAT DETECTOR
[Symbol: Smoke Detector]	SD CEILING MOUNTED SMOKE DETECTOR
[Symbol: Wireless Access Point]	WAP-1 WIRELESS ACCESS POINT MOUNTED ON CEILING
[Symbol: Wireless Access Point Above Ceiling]	WAP-2 WIRELESS ACCESS POINT MOUNTED ABOVE CEILING
[Symbol: Occupancy Sensor]	OC CEILING MOUNTED OCCUPANCY/PHOTOCELLS SENSOR
[Symbol: Exhaust Connection]	EXHAUST CONNECTION @ CEILING - REF. MECH. DWG'S
[Symbol: Linear Wall Wash]	LINEAR WALL WASH
[Symbol: Motorized Roller Shade]	ROLLER SHADES:
[Symbol: Single Rollers, Light Filtering Fabric]	RS-1 MOTORIZED ROLLER SHADE WITH SINGLE ROLLERS, LIGHT-FILTERING FABRIC.
[Symbol: Double Rollers, Light Filtering Fabric and Moisture Resistant Opaque Fabric]	RS-2 MOTORIZED ROLLER SHADE WITH DOUBLE ROLLERS, MOISTURE-RESISTANT LIGHT-FILTERING FABRIC AND MOISTURE-RESISTANT OPAQUE FABRIC.
[Symbol: Single Rollers, Moisture Resistant Opaque Fabric, with Window Frame Light Baffles]	RS-3 MOTORIZED ROLLER SHADE WITH SINGLE ROLLERS, MOISTURE-RESISTANT OPAQUE FABRIC, WITH WINDOW FRAME LIGHT BAFFLES.
[Symbol: General Notes]	GENERAL NOTES:
[Symbol: Lighting Fixture Types]	1. FOR LIGHTING FIXTURE TYPES REFER TO LIGHTING SCHEDULE. 2. FOR SPRINKLER TYPES REFER TO FIRE PROTECTION DRAWINGS. 3. CENTER ALL DEVICES WITH TILES U.N.O. 4. DEVICES IN OFFICES ARE SHOWN FOR QUANTITIES. REFER TO A9.74.1 FOR TYPICAL LAYOUT.

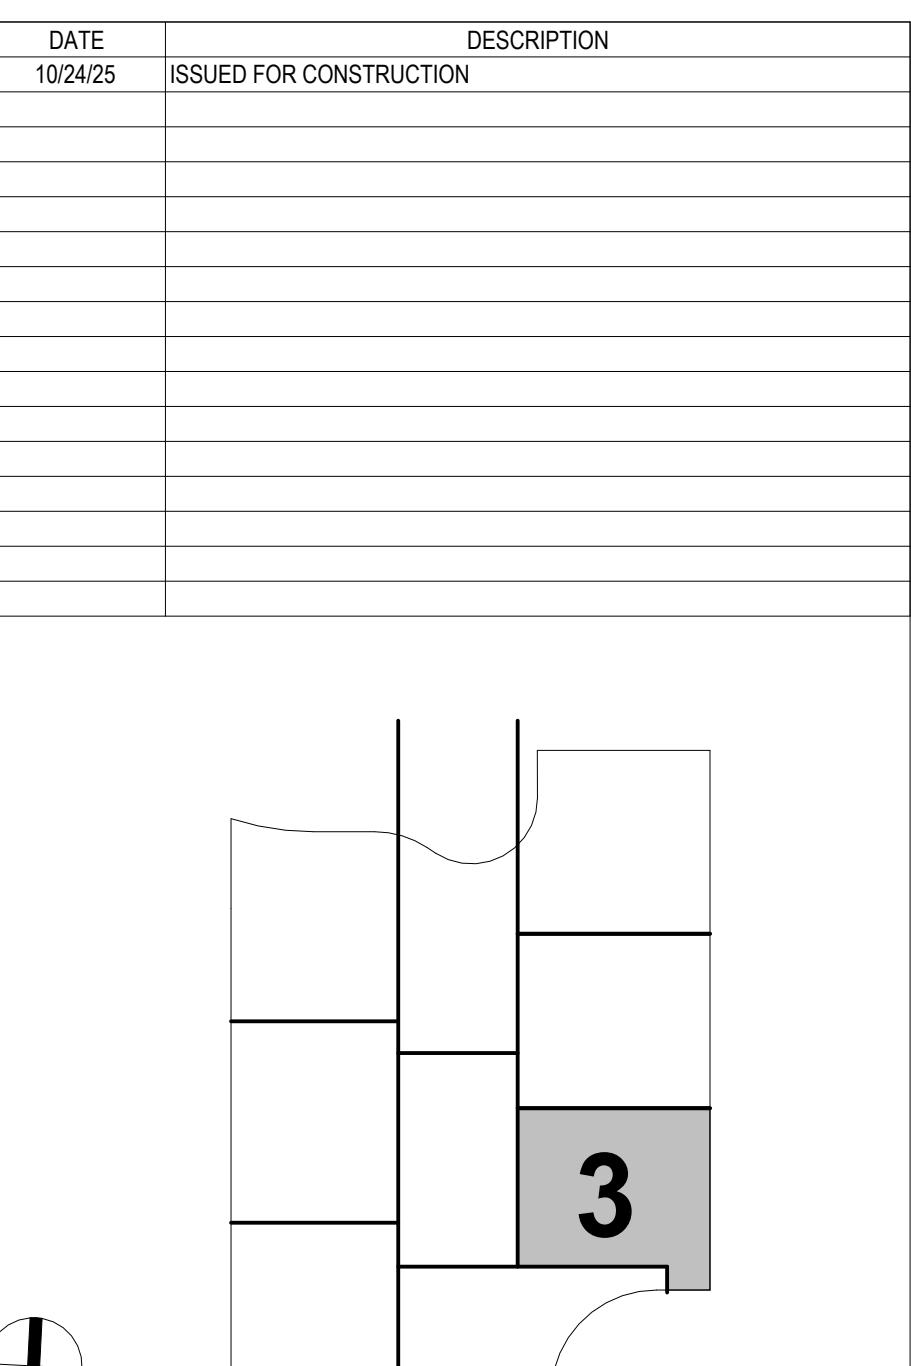

KEY PLAN


ARCHITECT	PAYETTE ASSOCIATES, INC.	ASSOCIATE ARCHITECT	KPN ARCHITECTS
	290 Congress Street, Fifth Floor		1800 Washington Blvd, Suite 500
	Boston, MA 02210		Baltimore, MD 21230
	617.985.1000		443.662.7757
CODE	CODE RED CONSULTANTS	CIVIL	RK&K
	154 Turnpike Road, Suite 200		700 East Pratt Street, Suite 500
	Southborough, MA 01772		Baltimore, MD 21202
	617.500.7633		410.728.2900
LANDSCAPE ARCHITECT	OLIN	STRUCTURAL	COLUMBIA ENGINEERING, INC.
	1617 John F. Kennedy Boulevard,		6210 Old Dobbins Lane, Suite 150
	Suite 1900		Baltimore, Maryland 21045
	Philadelphia, PA 19103		410.992.9970
VERTICAL TRANSPORTATION	ZIPIF ASSOCIATES, INC.	MEP	BR+A CONSULTING ENGINEERS
	25 Bala Avenue, Suite 201		10 Guest Street, 4th Floor
	Bala Cynwyd, PA 19004		Boston, MA 02135
	610.687.1717		617.254.0016
FIRE ALARM & FIRE PROTECTION	SETTY & ASSOCIATES	AUDIO VISUAL & TELECOM	CONVERGE TECHNOLOGIES
	575 S. Charles Street, Suite 403		DESIGN GROUP
	Baltimore, MD 21201		6501 York Road
	667.309.6036		Baltimore, MD 21212
			410.532.2355
SECURITY	THORNHILL TOMASSETTI	FOOD SERVICE	COLBURN GUYETTE
	1330 Connecticut Ave, NW,		100 Ledgewood Place, Suite 104
	Suite 300		Rockland, MA 02370
	Washington, DC 20036		781.826.5522
BUILDING ENCLOSURE	SIMPSON GUMPERTZ & HEGER	LEED	SUSTAINABLE DESIGN
	1625 Eye St NW		CONSULTING
	Suite 900		1432 K Street NW, 3rd Floor
	Washington, DC 20006		Washington, DC 20005
	202.667.4199		202.667.1620
WIND & AIR QUALITY	RWDI	VIBRATION & ACOUSTICS	COLIN GORDON ASSOCIATES
	650 Woodland Rd.		1350 Old Bayshore Hwy, Suite 799
	W. Guelph, Ontario		Burlingame, CA 94010
	Canada N1K 1B8		415.570.0350
LIGHTING	FISHER MARANTZ STONE	SITE LIGHTING	TILLETT LIGHTING DESIGN
	22 West 19th Street, 6th Floor		ASSOCIATES
	New York, NY 10011		11 Hanover Square, 17th Floor
	212.691.3020		New York, NY 10005
EMI/RFI SHIELDING	VITACHEM ELECTROMAGNETICS		212.766.0144
	115 Julian Ct., Suite 105		EMI/RFI SHIELDING
	Fredericksburg, VA 22406		VITACHEM ELECTROMAGNETICS
	540.286.1984		115 Julian Ct., Suite 105
CAMPUS UTILITIES	AEI AFFILIATED ENGINEERS		200 International Circle, Suite 5888
	200 International Circle, Suite 5888		Hunt Valley, MD 21030
			410.229.0050

LIFE SCIENCES BUILDING


JOHNS HOPKINS
UNIVERSITY
1800 Orleans St
Baltimore, Maryland 21287

ENLARGED REFLECTED CEILING PLAN - LEVEL 3 - SECTOR 3


Seal	Date: OCTOBER 24, 2025
	Scale: As indicated
	Drawn By:
	Designed By:
	Checked By:
	Proj. Mgr.: Payette Job No.: 17480.00
	Cadd File: J.170.24.4000
	Client Job No.: J.170.24.4000
	Client Dwg. No.: A6.33
	Professional Certification:
	State of Maryland Seal
	Architect
	Expiration Date: 06/20/2026

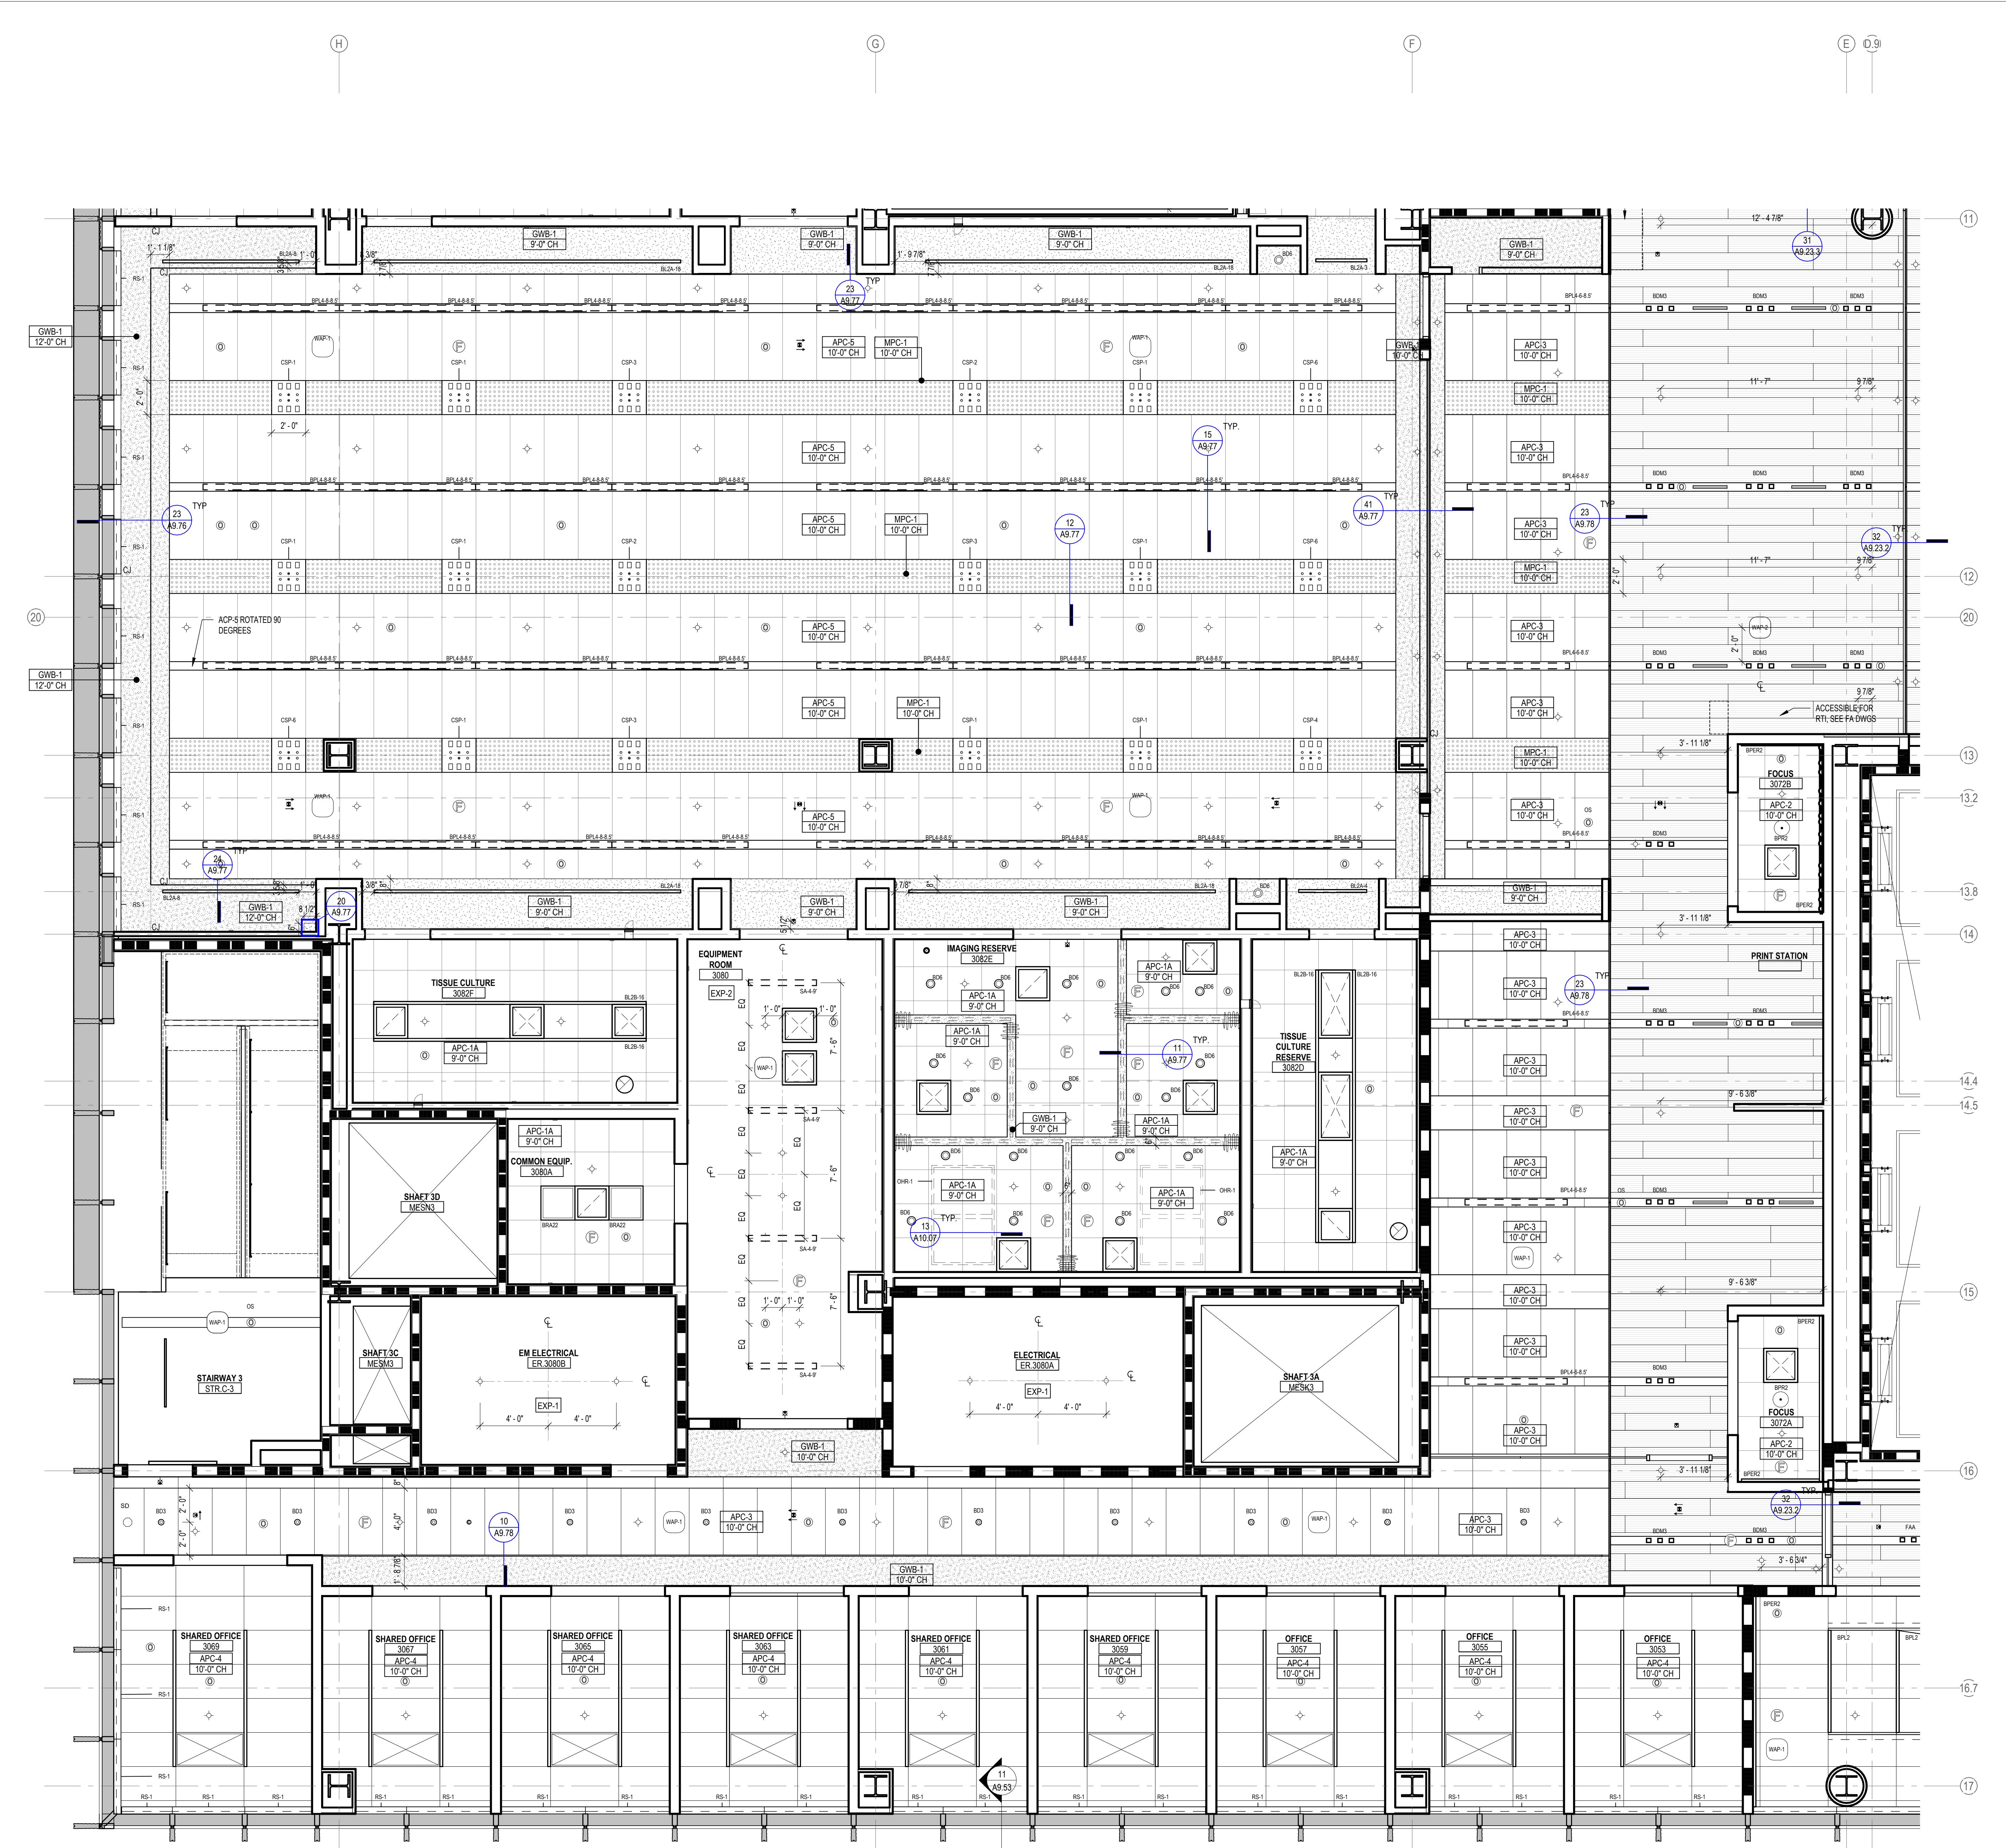

LEGEND - CEILING PLAN				
APC-1A	ACOUSTICAL PANEL CEILING (2X2), LAB SUPPORT	NUMBER DATE DESCRIPTION		
APC-1B	ACOUSTICAL PANEL CEILING (2X2), DARK ROOM (BLACK)	10/24/25 ISSUED FOR CONSTRUCTION		
APC-2	ACOUSTICAL PANEL CEILING (2X2), FOCUS ROOM (HIGH NRC)			
APC-3	ACOUSTICAL PANEL CEILING (2X4), OPEN OFFICE			
APC-4	ACOUSTICAL PANEL CEILING (2X4), OFFICES, CONF.			
APC-5	ACOUSTICAL PANEL CEILING (2X4), OPEN LAB			
APC-6	ACOUSTICAL PANEL CEILING (2X2), BOH			
APC-7	ACOUSTICAL PANEL CEILING (2X2), WASHABLE, RADIOSCOPE, SERVICE			
APC-8	ACOUSTICAL PANEL CEILING (2X2), MOISTURE RESISTANT, LOADING DOCK			
APC-9	ACOUSTICAL PANEL CEILING (2X4), SEMINAR, CONFERENCE			
FRP-1	FIBERGLASS REINFORCED CEILING PANELS			
GWB-1	GYPSUM BOARD CEILING, PAINTED			
GWB-2	GYPSUM BOARD CEILING WITH HPC			
GWB-3	ACOUSTICAL PLASTER CEILING			
EXP-1	EXPOSED TO STRUCTURE			
EXP-2	EXPOSED TO STRUCTURE WITH PAINTED MEP HANGERS, ACOUSTIC SPRAY COATING AT DECK			
LWC-1	LINEAR WOOD CEILING ACOUSTIC INFILL PANEL SEE A9.73.1			
LWC-2	LINEAR WOOD CEILING WITH ACOUSTIC SPRAY COATING ABOVE SEE A9.73.1			
WPC-1	ACOUSTICAL WOOD PANEL CEILING			
MPC-1	MICRO-PERFORATED METAL PANEL CEILING			
MPC-2	PERFORATED METAL CEILING WITH NON-COMBUSTIBLE ACOUSTIC INFILL PANEL SEE A8.72			
ST-1	LINEAR WOOD CEILING SOFFIT			
ST-2.1	METAL PANEL SOFFIT - EXTERIOR SOFFIT POWDER COAT TO MATCH COPPER ANODIZED ALUM.	CIVIL RK&K		
ST-2.2	METAL PANEL SOFFIT - EXTERIOR SOFFIT POWDER COAT TO MATCH BRONZE ANODIZED ALUM.	700 East Pratt Street, Suite 200 Baltimore, MD 21202 410.728.2900		
CEILING MOUNTED SECURITY CAMERA, REFER TO SECURITY DWG		STRUCTURAL COLUMBIA ENGINEERING, INC. 6210 Old Dobbins Lane, Suite 150 Baltimore, Maryland 21045 410.992.9970		
EXIT SIGN CEILING MOUNTED / WALL MOUNTED		VERTICAL TRANSPORTATION ZIPF ASSOCIATES, INC. 25 Bala Avenue, Suite 201 Bala Cynwyd, PA 19004 610.667.1717		
CEILING MOUNTED SPRINKLERS, REFER TO PLUM. DWG		MEP BR+A CONSULTING ENGINEERS 10 Guest Street, 4th Floor Boston, MA 02135 617.254.0016		
FIRE ALARM CEILING MOUNTED / WALL MOUNTED		AUDIO VISUAL & TELECOM CONVERGE TECHNOLOGIES DESIGN GROUP 575 S. Charles Street, Suite 403 Baltimore, MD 21212 410.532.2355		
H CEILING MOUNTED HEAT DETECTOR		SECURITY THORNHILL TOMASETTI 1330 Connecticut Ave, NW, Suite 300 Washington, DC 20036 202.580.6300		
SD CEILING MOUNTED SMOKE DETECTOR		FOOD SERVICE COLBURN GUYETTE 100 Ledgewood Place, Suite 104 Rockland, MA 02370 781.826.5522		
WAP-1 WIRELESS ACCESS POINT MOUNTED ON CEILING		BUILDING ENCLOSURE SIMPSON GUMPERTZ & HEGER 1625 Eye St NW Suite 900 Washington, DC 20006 202.239.4199		
WAP-2 WIRELESS ACCESS POINT MOUNTED ABOVE CEILING		LEED SUSTAINABLE DESIGN CONSULTING 1432 K Street, 3rd Floor Washington, DC 20006 202.667.1620		
OC CEILING MOUNTED OCCUPANCY/PHOTOCELLS SENSOR		VIBRATION & ACOUSTICS COLIN MARANTZ ASSOCIATES 1350 Old Bayshore Hwy, Suite 799 Burlingame, CA 94010 415.570.0350		
EXHAUST CONNECTION @ CEILING - REF MECH. DWGS		LIGHTING FISHER MARANTZ STONE 22 West 19th Street, 6th Floor New York, NY 10001 212.691.3020		
LINEAR WALL WASHER		SITE LIGHTING TILLET LIGHTING DESIGN ASSOCIATES 11 Hanover Square, 17th Floor New York, NY 10005 212.766.0144		
RS-1 MOTORIZED ROLLER SHADE WITH SINGLE ROLLERS, LIGHT-FILTERING FABRIC		EMI/RFI SHIELDING VITACHEM ELECTROMAGNETICS 115 Julian Ct., Suite 105 Fredericksburg, VA 22406 540.286.1984		
RS-2 MOTORIZED ROLLER SHADE WITH DOUBLE ROLLERS, MOISTURE-RESISTANT LIGHT-FILTERING FABRIC AND MOISTURE-RESISTANT OPAQUE FABRIC		CAMPUS UTILITIES AEI AFFILIATED ENGINEERS 200 International Circle, Suite 5888 Hunt Valley, MD 21030 410.229.0090		
RS-3 MOTORIZED ROLLER SHADE WITH SINGLE ROLLERS, MOISTURE-RESISTANT OPAQUE FABRIC. WITH WINDOW FRAME LIGHT BAFFLES				
GENERAL NOTES:	<p>1. FOR LIGHTING FIXTURE TYPES REFER TO LIGHTING SCHEDULE. 2. FOR SPRINKLER TYPES REFER TO FIRE PROTECTION DRAWINGS. 3. CENTER ALL DEVICES WITH TILES U.N.O. 4. DEVICES IN OFFICES ARE SHOWN FOR QUANTITIES. REFER TO A9.74.1 FOR TYPICAL LAYOUT.</p>			
LEGEND - LIGHT FIXTURES				
REFER TO MEP DRAWINGS AND SPECIFICATIONS				
	LINEAR PENDANT FIXTURE			
	SUSPENSION HEIGHT AFFIX			
	Fixture Length			
	Fixture Type			
	LINEAR RECESSED FIXTURE			
	Fixture Length			
	Fixture Type			
	RECESSED DOWNLIGHT			
	Fixture Length			
	Fixture Type			
	RECESSED 2X2 TROFFER			
	Fixture Length			
	Fixture Type			
	RECESSED 2X4 TROFFER			
	Fixture Length			
	Fixture Type			
	RECESSED ATRIUM DOWNLIGHT			
	Fixture Length			
	Fixture Type			
Professional Certification				
I certify that these documents were prepared or approved by me, and that they are duly licensed engineer under the laws of the State of Maryland.				
License No. 9986 Expiration Date: 06/20/2026				
Seal				
Date: OCTOBER 24, 2025	Scale: As indicated			
Drawn By:	Designed By:			
Checked By:	Proj. Mgr.:			
Client Job No.: 1740.00	Cadd File:			
Client Dwg. No.: J.170.24.4000	Client Job No.:			
Client Dwg. No.:	Client Job No.:			
JOHNS HOPKINS UNIVERSITY				
600 N Broadway Baltimore, MD 21205				
STATE OF MARYLAND SACRED HEART LINDSEY ARCHITECT				
A6.34				

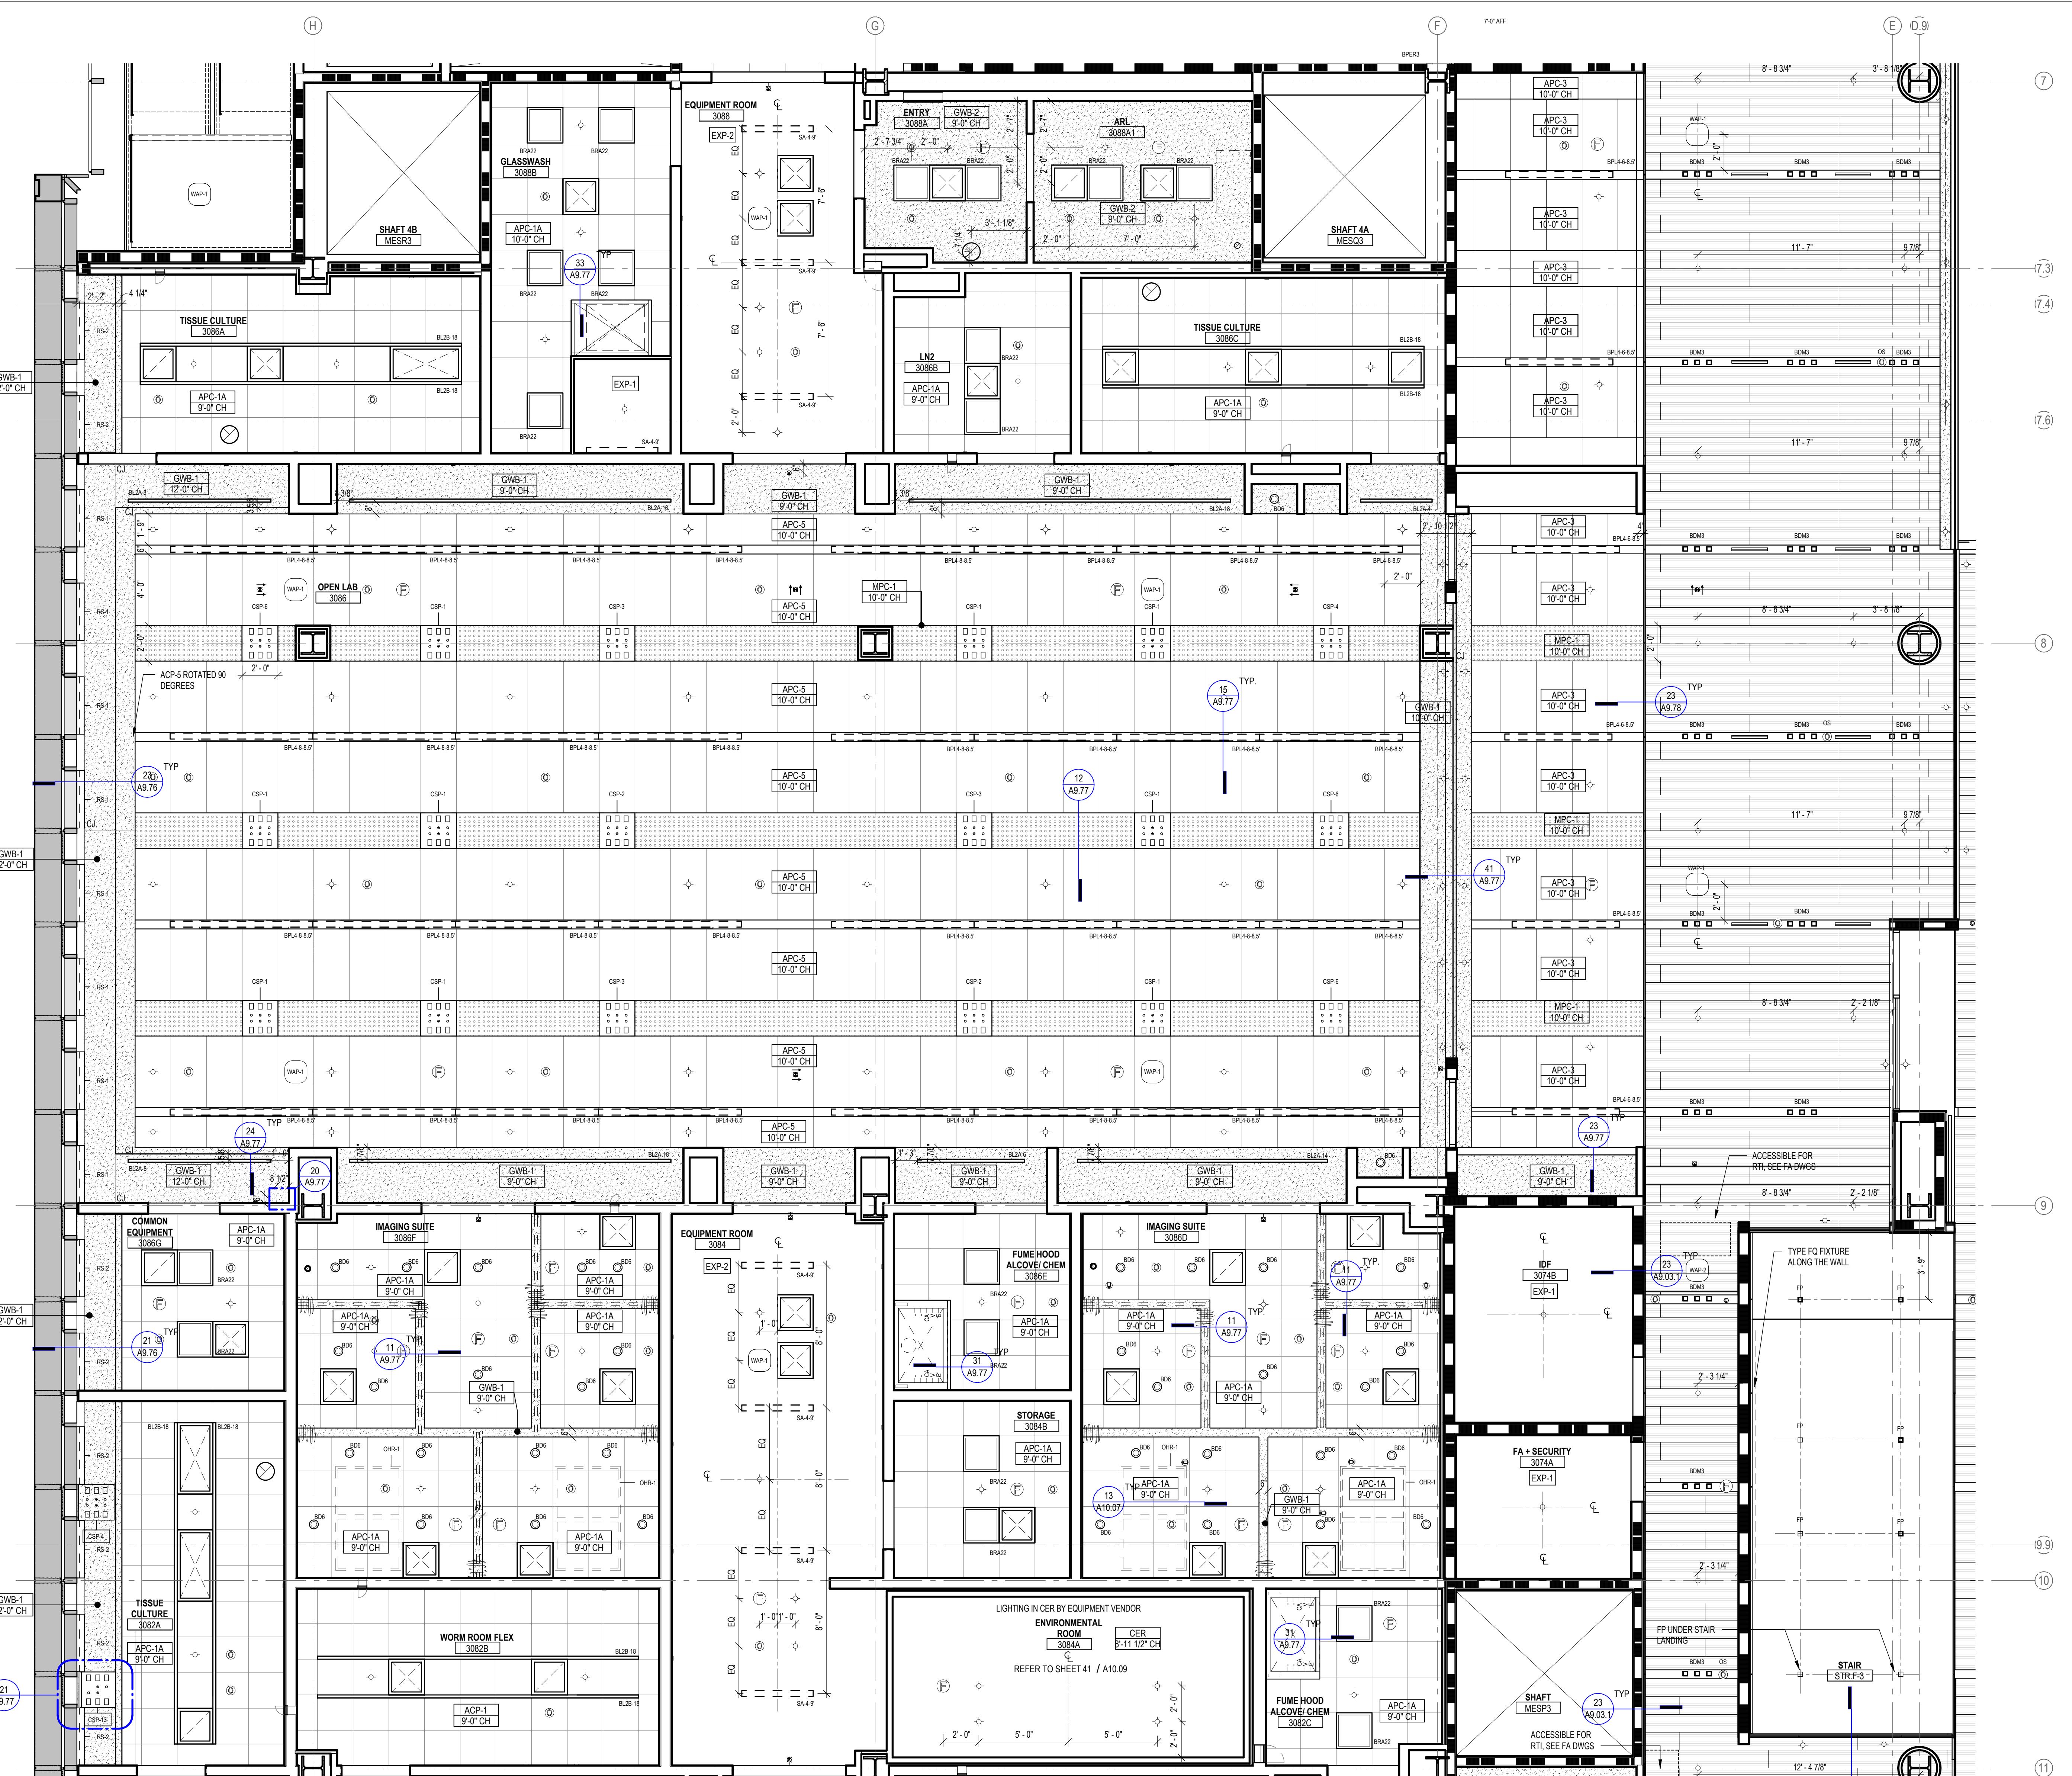

LEGEND - CEILING PLAN		
APC-1A	ACOUSTICAL PANEL CEILING (2X2), LAB SUPPORT	NUMBER DATE DESCRIPTION
APC-1B	ACOUSTICAL PANEL CEILING (2X2), DARK ROOM (BLACK)	10/24/25 ISSUED FOR CONSTRUCTION
APC-2	ACOUSTICAL PANEL CEILING (2X2), FOCUS ROOM (HIGH NRC)	
APC-3	ACOUSTICAL PANEL CEILING (2X4), OPEN OFFICE	
APC-4	ACOUSTICAL PANEL CEILING (2X4), OFFICES, CONF.	
APC-5	ACOUSTICAL PANEL CEILING (2X4), OPEN LAB	
APC-6	ACOUSTICAL PANEL CEILING (2X2), BOH	
APC-7	ACOUSTICAL PANEL CEILING (2X2), WASHABLE, RADIOSCOPE, FOOD SERVICE	
APC-8	ACOUSTICAL PANEL CEILING (2X2), MOISTURE RESISTANT, LOADING DOCK	
APC-9	ACOUSTICAL PANEL CEILING (2X4), SEMINAR, CONFERENCE	
FRP-1	FIBERGLASS REINFORCED CEILING PANELS	
GWB-1	GYPSUM BOARD CEILING, PAINTED	
GWB-2	GYPSUM BOARD CEILING WITH HPC	
GWB-3	ACOUSTICAL PLASTER CEILING	
EXP-1	EXPOSED TO STRUCTURE	
EXP-2	EXPOSED TO STRUCTURE WITH PAINTED MEP HANGERS, ACOUSTIC SPRAY COATING AT DECK	
LWC-1	LINEAR WOOD CEILING ACOUSTIC INFILL PANEL SEE A9.73.1	
LWC-2	LINEAR WOOD CEILING WITH ACOUSTIC SPRAY COATING ABOVE SEE A9.73.1	
WPC-1	ACOUSTICAL WOOD PANEL CEILING	
MPC-1	MICRO-PERFORATED METAL PANEL CEILING	
MPC-2	PERFORATED METAL CEILING WITH NON-COMBUSTIBLE ACOUSTIC INFILL PANEL SEE A9.72	
ST-1	LINEAR WOOD CEILING SOFFITS	
ST-2.1	METAL PANEL SOFFIT - EXTERIOR SOFFIT POWDER COAT TO MATCH COPPER ANODIZED ALUM.	
ST-2.2	METAL PANEL SOFFIT - EXTERIOR SOFFIT POWDER COAT TO MATCH BRONZE ANODIZED ALUM.	
CSP-X	CEILING SERVICE PANEL SEE A10.05A FOR TYPES	
OHR	OVERHEAD SERVICE RACK, SEE A10.07 FOR DETAILS	
(C)	CEILING MOUNTED SECURITY CAMERA, REFER TO SECURITY DWG	
	EXIT SIGN CEILING MOUNTED / WALL MOUNTED	
	CEILING MOUNTED SPRINKLERS, REFER TO PLUM. DWG	
	FIRE ALARM CEILING MOUNTED / WALL MOUNTED	
H	CEILING MOUNTED HEAT DETECTOR	
SD	CEILING MOUNTED SMOKE DETECTOR	
WAP-1	WIRELESS ACCESS POINT MOUNTED ON CEILING	
WAP-2	WIRELESS ACCESS POINT MOUNTED ABOVE CEILING	
OC	CEILING MOUNTED OCCUPANCY/PHOTOCELL SENSOR	
	EXHAUST CONNECTION @ CEILING - REF. MECH. DWGS	
	LINEAR WALL WASH	
ROLLER SHADES:		
RS-1	MOTORIZED ROLLER SHADE WITH SINGLE ROLLERS, LIGHT-FILTERING FABRIC.	
RS-2	MOTORIZED ROLLER SHADE WITH DOUBLE ROLLERS, MOISTURE-RESISTANT LIGHT-FILTERING FABRIC AND MOISTURE-RESISTANT OPAQUE FABRIC.	
RS-3	MOTORIZED ROLLER SHADE WITH SINGLE ROLLERS, MOISTURE-RESISTANT OPAQUE FABRIC, WITH WINDOW FRAME LIGHT BAFFLES.	
GENERAL NOTES:		
1.	FOR LIGHTING FIXTURE TYPES REFER TO LIGHTING SCHEDULE.	
2.	FOR SPRINKLER TYPES REFER TO FIRE PROTECTION DRAWINGS.	
3.	CENTER ALL DEVICES WITH TILES U.N.O.	
4.	DEVICES IN OFFICES ARE SHOWN FOR QUANTITIES. REFER TO A9.74.1 FOR TYPICAL LAYOUT	
LEGEND - LIGHT FIXTURES		
REFER TO MEP DRAWINGS AND SPECIFICATIONS		
	LINEAR PENDANT FIXTURE	
	SUSPENSION HEIGHT AFF.	
	Fixture Length	
	Fixture Type	
	LINEAR RECESSED FIXTURE	
	Fixture Length	
	Fixture Type	
	RECESSED DOWNLIGHT	
	Fixture Length	
	Fixture Type	
	RECESSED 2X2 TROFFER	
	Fixture Length	
	Fixture Type	
	RECESSED 2X4 TROFFER	
	Fixture Length	
	Fixture Type	
	RECESSED ATRIUM DOWNLIGHT	
	Fixture Length	
	Fixture Type	
Professional Certification:		
I hereby certify that these documents were prepared or approved by me, and that they are duly licensed engineer under the laws of the State of Maryland.		
License No. 99866 Expiration Date: 06/20/2026		
Seal		
Date:	OCTOBER 24, 2025	
Scale:	As indicated	
Drawn By:		
Designed By:		
Checked By:		
Proj. Mgr.:		
Payette Job No.:	17480.00	
Cadd File:		
Client Job No.:	J.170.24.4000	
Client Dwg. No.:		
A6.35		

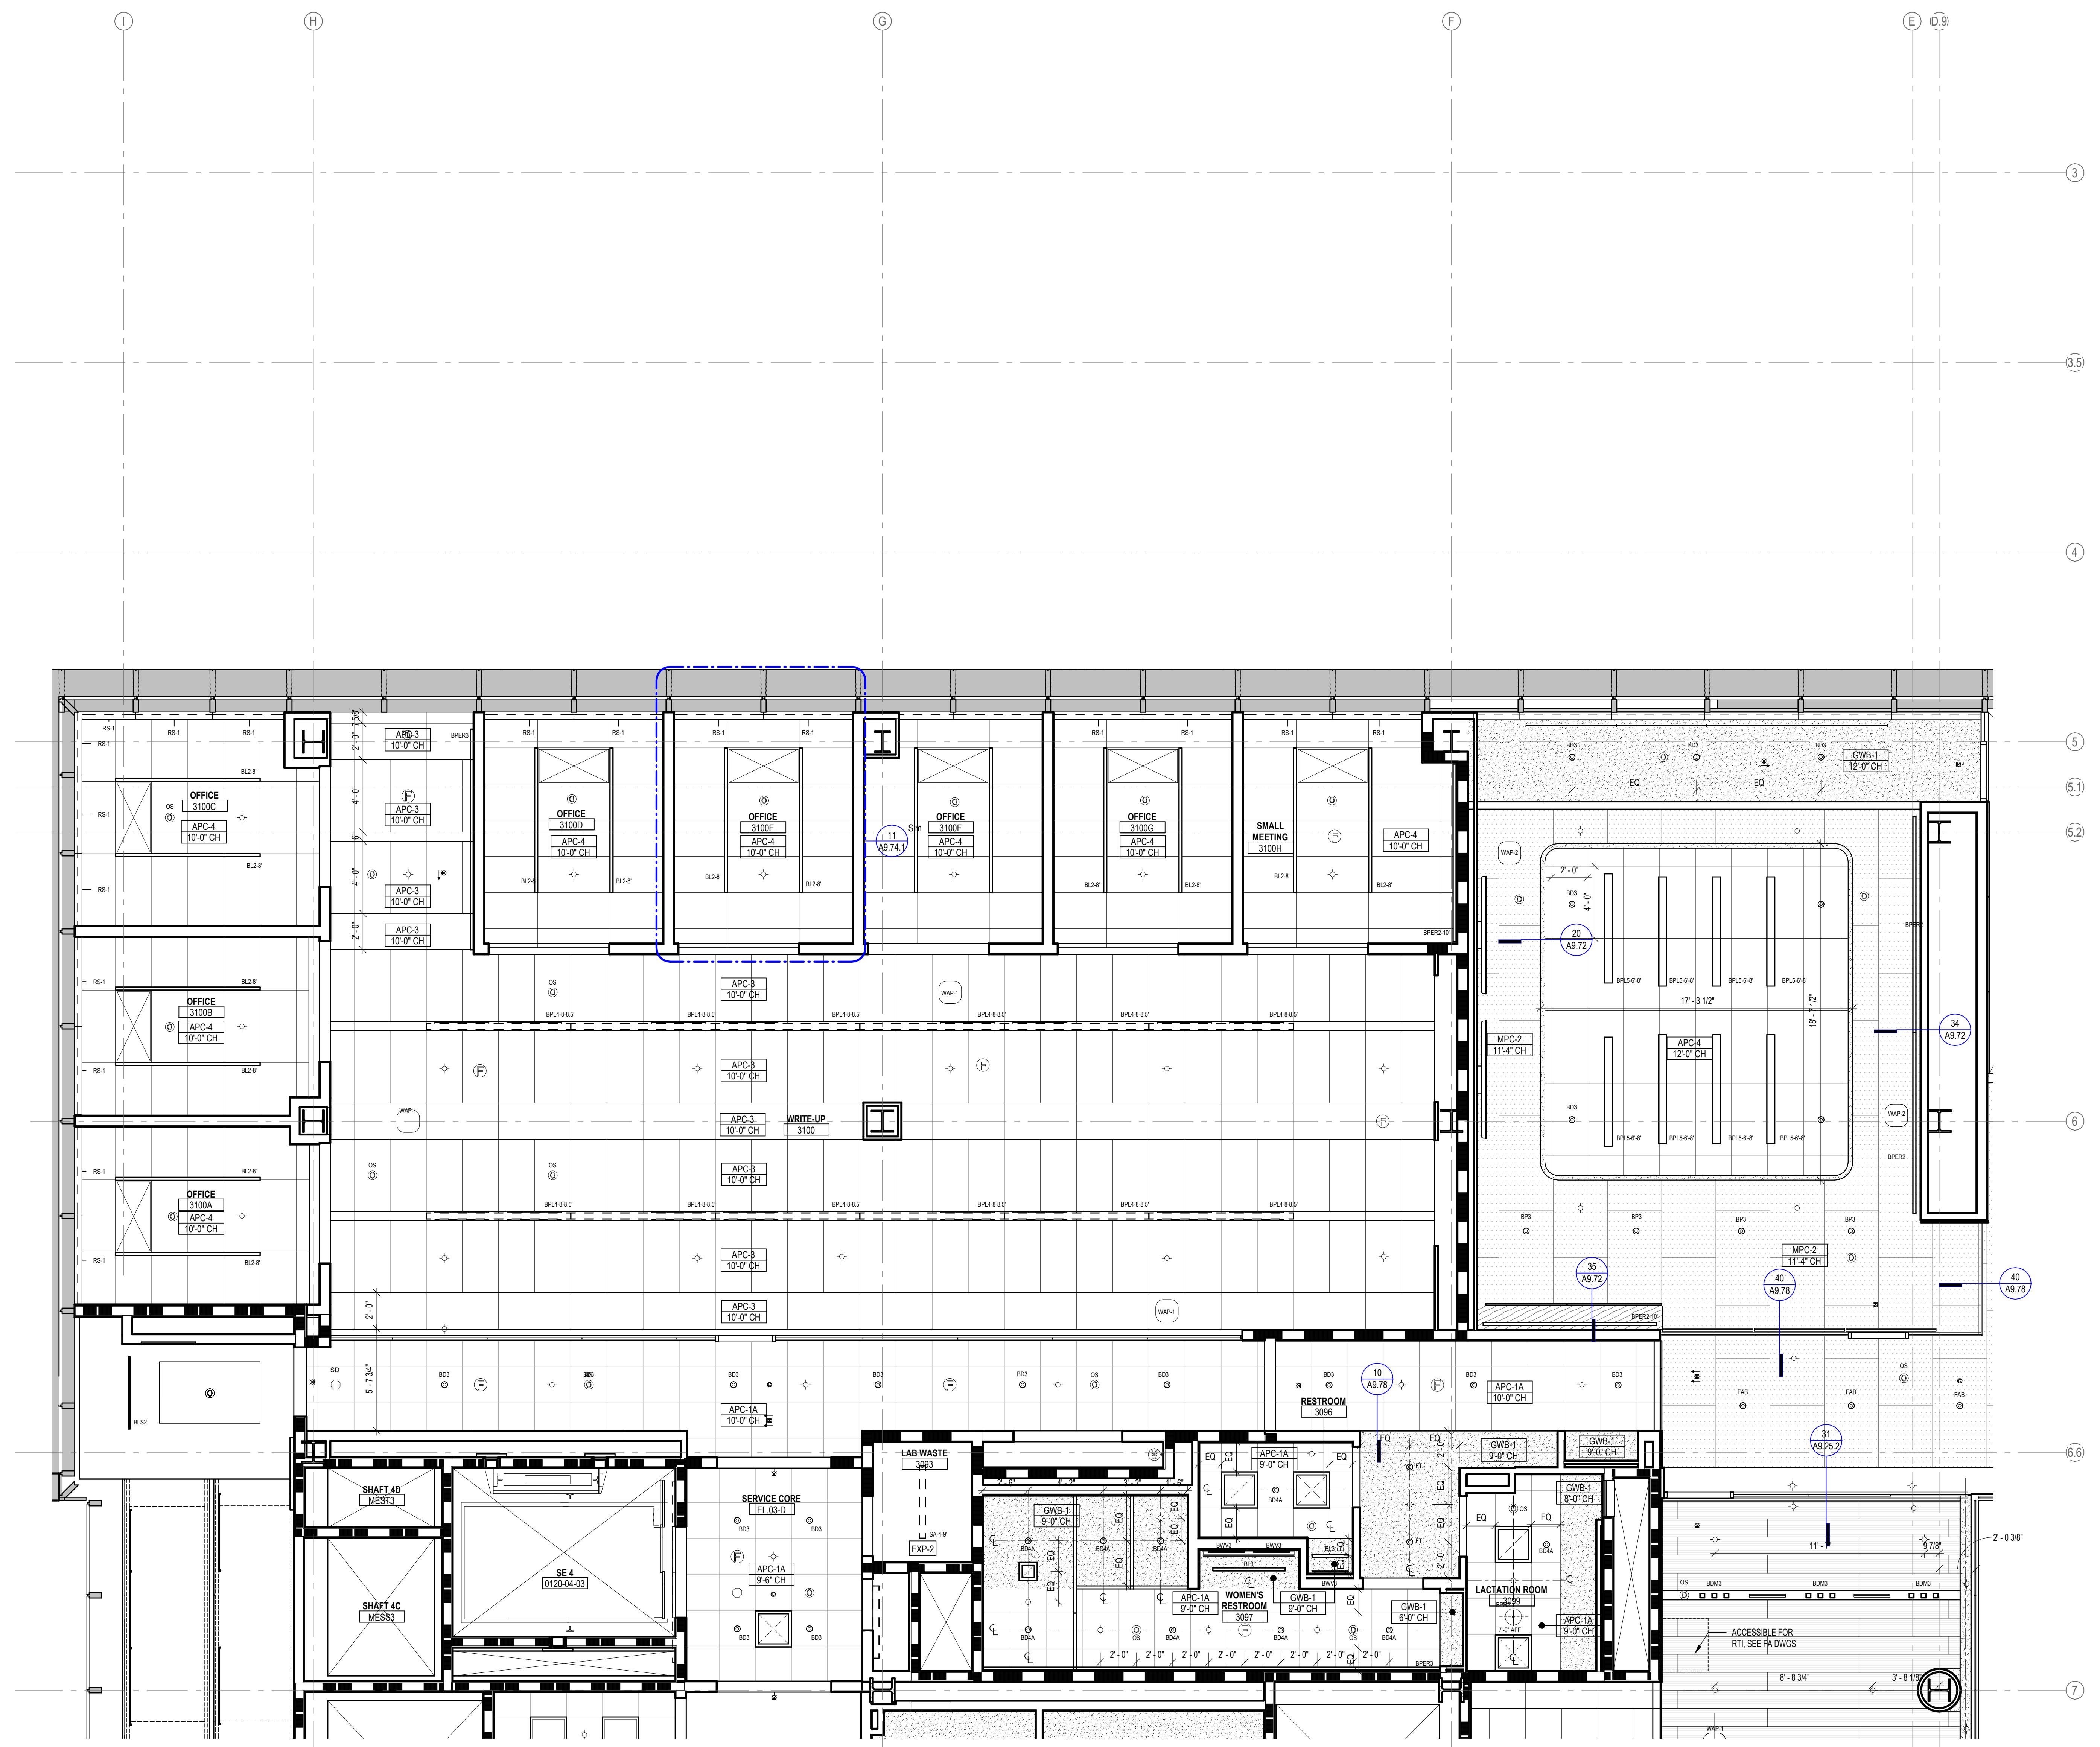

LEGEND - CEILING PLAN		
	APC-1A	ACOUSTICAL PANEL CEILING (2X2), LAB SUPPORT
	APC-1B	ACOUSTICAL PANEL CEILING (2X2), DARK ROOM (BLACK)
	APC-2	ACOUSTICAL PANEL CEILING (2X2), FOCUS ROOM (HIGH NRC)
	APC-3	ACOUSTICAL PANEL CEILING (2X4), OPEN OFFICE
	APC-4	ACOUSTICAL PANEL CEILING (2X4), OFFICES, CONF.
	APC-5	ACOUSTICAL PANEL CEILING (2X4), OPEN LAB
	APC-6	ACOUSTICAL PANEL CEILING (2X2), BOH
	APC-7	ACOUSTICAL PANEL CEILING (2X2), WASHABLE, RADIOSTOPE, FOOD SERVICE
	APC-8	ACOUSTICAL PANEL CEILING (2X2), MOISTURE RESISTANT, LOADING DOCK
	APC-9	ACOUSTICAL PANEL CEILING (2X4), SEMINAR, CONFERENCE
	FRP-1	FIBERGLASS REINFORCED CEILING PANELS
	GWB-1	GYPSUM BOARD CEILING, PAINTED
	GWB-2	GYPSUM BOARD CEILING WITH HPC
	GWB-3	GYPSUM BOARD CEILING
	EXP-1	EXPOSED TO STRUCTURE
	EXP-2	EXPOSED TO STRUCTURE WITH PAINTED MEP HANGERS, ACOUSTIC SPRAY COATING AT DECK
	LWC-1	LINEAR WOOD CEILING ACOUSTIC INFILL PANEL SEE A9.73.1
	LWC-2	LINEAR WOOD CEILING WITH ACOUSTIC SPRAY COATING ABOVE SEE A9.73.1
	WPC-1	ACOUSTICAL WOOD PANEL CEILING
	MPC-1	MICRO-PERFORATED METAL PANEL CEILING
	MPC-2	PERFORATED METAL CEILING WITH NON-COMBUSTIBLE ACOUSTIC INFILL PANEL SEE A9.72
	ST-1	LINEAR WOOD CEILING SOFFITS
	ST-2.1	METAL PANEL SOFFIT - EXTERIOR SOFFIT POWDER COAT TO MATCH COPPER ANODIZED ALUM.
	ST-2.2	METAL PANEL SOFFIT - EXTERIOR SOFFIT POWDER COAT TO MATCH BRONZE ANODIZED ALUM.
	CSP-X	CEILING SERVICE PANEL SEE A10.05A FOR TYPES.
	OHR	OVERHEAD SERVICE RACK, SEE A10.07 FOR DETAILS.
	C	CEILING MOUNTED SECURITY CAMERA, REFER TO SECURITY.DWG
		EXIT SIGN CEILING MOUNTED / WALL MOUNTED
		CEILING MOUNTED SPRINKLERS, REFER TO PLUM.DWG
		FIRE ALARM CEILING MOUNTED / WALL MOUNTED
	H	CEILING MOUNTED HEAT DETECTOR
	SD	CEILING MOUNTED SMOKE DETECTOR
	WAP-1	WIRELESS ACCESS POINT MOUNTED ON CEILING
	WAP-2	WIRELESS ACCESS POINT MOUNTED ABOVE CEILING
	OC	CEILING MOUNTED OCCUPANCY/PHOTOCELL SENSOR
		EXHAUST CONNECTION @ CEILING - REF. MECH. DWGS
		LINEAR WALL WASH
	RS-1	ROLLER SHADES: RS-1 - MOTORIZED ROLLER SHADE WITH SINGLE ROLLERS, LIGHT-FILTERING FABRIC.
	RS-2	RS-2 - MOTORIZED ROLLER SHADE WITH DOUBLE ROLLERS, MOISTURE-RESISTANT LIGHT-FILTERING FABRIC AND MOISTURE-RESISTANT OPAQUE FABRIC.
	RS-3	RS-3 - MOTORIZED ROLLER SHADE WITH SINGLE ROLLERS, MOISTURE-RESISTANT OPAQUE FABRIC, WITH WINDOW FRAME LIGHT BAFFLES.
		GENERAL NOTES: 1. FOR LIGHTING FIXTURE TYPES REFER TO LIGHTING SCHEDULE. 2. FOR SPRINKLER TYPES REFER TO FIRE PROTECTION DRAWINGS. 3. CENTER ALL DEVICES WITH TILES U.N.O 4. DEVICES IN OFFICES ARE SHOWN FOR QUANTITIES. REFER TO A9.74.1 FOR TYPICAL LAYOUT
		REFERR TO MEP DRAWINGS AND SPECIFICATIONS C = - - - - - LINEAR PENDANT FIXTURE XXX-XXX-XXX SUSPENSION HEIGHT AFF XXX-XXX-XXX FIXTURE LENGTH FIXTURE TYPE
		XXX-XXX-XXX FIXTURE LENGTH FIXTURE TYPE
		RECESSED DOWNLIGHT XXX-XXX-XXX FIXTURE LENGTH FIXTURE TYPE
		RECESSED 2X2 TROFFER XXX-XXX-XXX FIXTURE LENGTH FIXTURE TYPE
		RECESSED 4X4 TROFFER XXX-XXX-XXX FIXTURE LENGTH FIXTURE TYPE
		RECESSED ATRIUM DOWNLIGHT XXX-XXX-XXX FIXTURE LENGTH FIXTURE TYPE
	Seal	STATE OF MARYLAND THE GREAT SEAL 1968 ARCHITECT Date: OCTOBER 24, 2025 Scale: As indicated Drawn By: Designed By: Checked By: Proj. Mgr.: Payette Job No.: 17480.00 Cadd File: J.170.24.4000 Client Job No.: J.170.24.4000 Client Dwg. No.: Client Dwg. No.: Professional Certification. I hereby certify that these documents were prepared or approved by me, and that they are duly licensed engineer under the laws of the State of Maryland. License No. 9986 Expiration Date: 06/20/2026

A6.36