

ASSUME EGRESS LIGHTING WITH BYPASS RELAYS FOR ALL LIGHTING IN THE PATH OF EGRESS.

1 REFER TO DRAWING E8.10 EGRESS STAIRWAY 2 AS TYPICAL.

REFER TO DRAWING 60.00 FOR LEGEND, SYMBOLS AND GENERAL NOTES.

REFER TO LIGHTING FIXTURE SCHEDULE ON DRAWING 97.00 SERIES FOR SPECIFICATION OF FIXTURES.

REFER TO DRAWING 60.00 SERIES FOR LIGHTING CONTROL AND FIXTURE SCHEDULE LOCATIONS.

REFER TO ARCHITECTURAL FLOOR PLANS FOR EQUIPMENT LOCATIONS.

REFER TO ARCHITECTS REFLECTED CEILING PLAN FOR EXACT LOCATION OF LIGHTING FIXTURE PRIOR TO INSTALLATION (TYPICAL).

REFER TO ARCHITECTURAL ELEVATIONS FOR COORDINATION OF ALL MOUNTED FIXTURE LOCATIONS.

LOCATION AND GROUPING ARRANGEMENT/LOCATION OF ALL SWITCHES SHALL BE COORDINATED WITH THE ARCHITECT, MECHANICAL EQUIPMENT, AND OTHER WALL MOUNTED DEVICES PRIOR TO INSTALLATION.

THE ELECTRICAL CONTRACTOR SHALL PROVIDE LINES AND COORDINATE FIXTURE TRANS PRIOR TO PURCHASE OF LIGHTING FIXTURES.

THE ELECTRICAL CONTRACTOR SHALL FURNISH AND INSTALL ALL LIGHTING FIXTURES COMPLETE WITH MOUNTING HARDWARE.

ALL EXIT SIGNS AND EMERGENCY LIGHTING SHALL BE CONNECTED TO THE EMERGENCY GENERATOR.

EMERGENCY LIGHTING SHALL BE PROVIDED IN ALL AREAS TO ILLUMINATE ALL EGRESS CORRIDORS, LOBBIES, ETC. BRANCH CIRCUITS SHALL ORIGINATE FROM THE EMERGENCY GENERATOR. AREAS REQUIRING SUCH CIRCUIT OF EGRESS LIGHTING SHALL BE PROVIDED WITH SIGNALS, EMERGENCY LIGHTING, AND EMERGENCY EXIT SIGNS. EMERGENCY LIGHTING SHALL BE DEPENDENT ON THE OTHER WAYS AND SHALL BE PROVIDED WITH EMERGENCY LIGHTING TO FULL BRING UPON LOSS OF NORMAL POWER, REGARDLESS OF CONTROL STATE.



EMERGENCY LIGHTING SHALL BE PROVIDED IN ALL AREAS WHERE THE EMERGENCY LIGHTING IS REQUIRED BY THE MANUFACTURER(S) TO MEET THE SPECIFIED CONTROL INTENT.

ALL LIGHTING FIXTURE LOCATIONS WITHIN A V, ELECTRICAL, AND MECHANICAL ROOMS SHALL BE COORDINATED WITH THE RESPECTED TRADES TO COORDINATE WITH THE VENTILATION AND TO PROVIDE EVEN ILLUMINATION OF THE ROOM.

COORDINATE THE LOCATION OF ALL EXIT SIGNS WITH INTERIOR SIGNAGE. EXTERIOR SIGNAGE SHALL NOT BE OBSTRUCTED.

FOR ELECTRICAL PANEL LOCATIONS, REFER TO SPECIFIED POWER FLOOR PLAN.

EXIT SIGNS AND SIGNAL ARROWS SHALL BE AS NOTICED ON THE ELECTRICAL PLANS AND SHALL BE COORDINATED WITH THE ARCHITECTURAL PLANS AND REFLECTED CEILING PLANS.

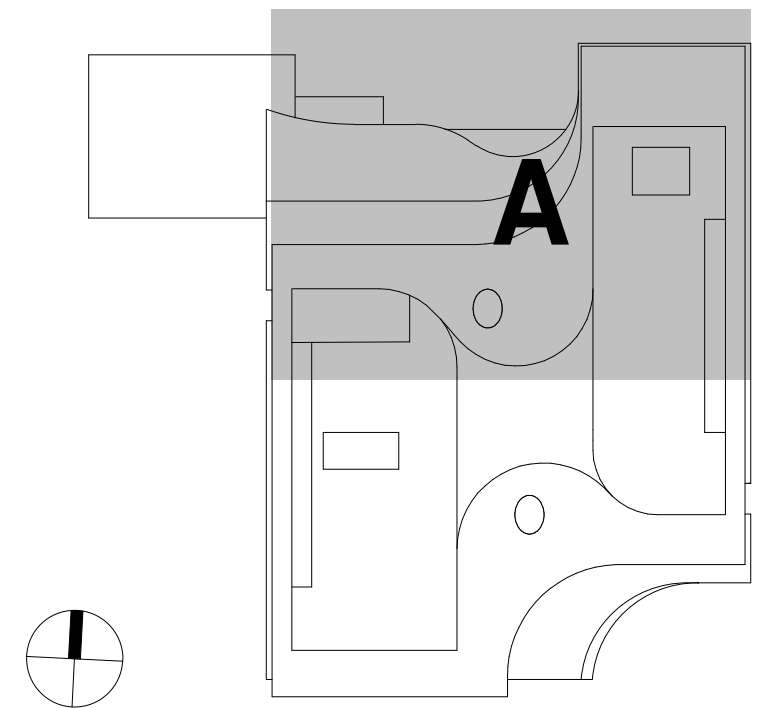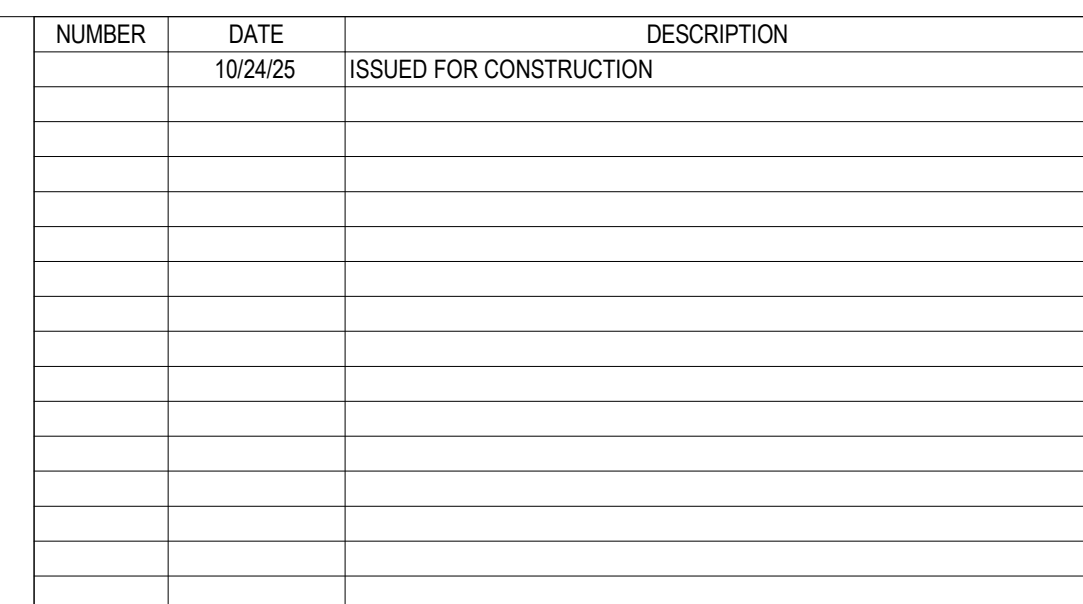

## KEY PLAN

<b>ARCHITECT</b> <b>PAYETTE ASSOCIATES, INC.</b> 290 Congress Street, Fifth Floor Boston, MA 02210 617.895.1000	<b>ASSOCIATE ARCHITECT</b> <b>KPN ARCHITECTS</b> 1800 Washington Blvd., Suite 414 Baltimore, MD 21230 443.667.7572
<b>CODE</b> <b>CODE RED CONSULTANTS</b> 154 Turnpike Road, Suite 200 Southborough, MA 01772 617.500.7633	<b>CIVIL</b> <b>RK&amp;K</b> 700 East Pratt Street, Suite 500 Baltimore, MD 21202 410.728.2900
<b>LANDSCAPE ARCHITECT</b> <b>OLIN</b> 1617 John F. Kennedy Boulevard, Suite 1900 Philadelphia, PA 19103 215.440.0030	<b>STRUCTURAL</b> <b>COLUMBIA ENGINEERING, INC.</b> 6210 Old Dobbin Lane, Suite 150 Baltimore, Maryland 21045 410.992.9970
<b>VERTICAL TRANSPORTATION</b> <b>ZIPP ASSOCIATES, INC.</b> 25 Bala Avenue, Suite 201 Bala Cynwyd, PA 19004 610.667.1717	<b>MEP</b> <b>CONSULTING ENGINEERS</b> Brookline, MA Guest Street, 4th Floor Boston, MA 02135 617.254.0016
<b>FIRE ALARM &amp; FIRE PROTECTION</b> <b>SETTY &amp; ASSOCIATES</b> 575 S. Charles Street, Suite 403 Baltimore, MD 21201 667.309.6036	<b>AUDIO VISUAL &amp; TELECOM</b> <b>CONVERGENT TECHNOLOGIES</b> DESIGN GROUP 6501 York Road Baltimore, MD 21212 410.532.2395
<b>SECURITY</b> <b>THORNTON TOMASETTI</b> 1330 Connecticut Ave., NW, Suite 300 Washington, DC 20036 202.580.6300	<b>FOOD SERVICE</b> <b>COLBURN GUYETTE</b> 100 Edgewood Place, Suite 104 Rockland, MA, 02370 781.826.5522
<b>BUILDING ENCLASURES</b> <b>SIMPSON GUMPERTZ &amp; HEGER</b> 1625 Ely St NW Suite 900 Washington, DC 20005 202.239.4919	<b>LEED</b> <b>SUSTAINABLE DESIGN</b> CONSULTING 1432 K Street NW, 3rd Floor Washington, DC 20005 202.667.1620
<b>WIND &amp; AIR QUALITY</b> <b>RWDI</b> 650 Woodland Rd. W. Guelph, Ontario Canada N1K 1B8 519.823.1311	<b>VIBRATION &amp; ACOUSTICS</b> <b>COLIN GORDON ASSOCIATES</b> 1350 Old Bayshore Hwy, Suite 799 Burlington, CA 94010 415.570.0350
<b>LIGHTING</b> <b>FISHER MARANTZ STONE</b> 22 West 19th Street, 6th Floor New York, NY 10011 212.691.3020	<b>SITE LIGHTING</b> <b>TILLET LIGHTING DESIGN</b> ASSOCIATES 11 Hanover Square, 17th Floor New York, NY 10005 212.766.0144
<b>EM/RFI (SHIELDING)</b> <b>VITATECH ELECTROMAGNETICS</b> 115 Judd Ct., Suite 105 Fredericksburg, VA 22406 540.286.1984	<b>CAMPUS UTILITIES</b> <b>AEI AFFILIATED ENGINEERS</b> 200 International Circle, Suite 5888 Hunt Valley, MD 21030 410.229.9999

**LIFE SCIENCES BUILDING**

JOHNS HOPKINS  
UNIVERSITY

## LIGHTING RCP A - LEVEL 0

	Date: OCTOBER 24, 2025 Scale: 1/8" = 1'-0" Drawn By: Designed By: Checked By: Proj. Mgr.: Payette Job No.: 17480.00 Cadd File: Client Job No.: J.170.24-0000 Client Dwg. No.:
	Professional Certification.

**EL2.00A**

1 LIGHTING RCP A - PARENT - LEVEL 0  
1/8" = 1'-0"