



2 LEVEL 2 - ENLARGED OVERALL RCP - SECTOR A2
SCALE: 1/4" = 1'-0"

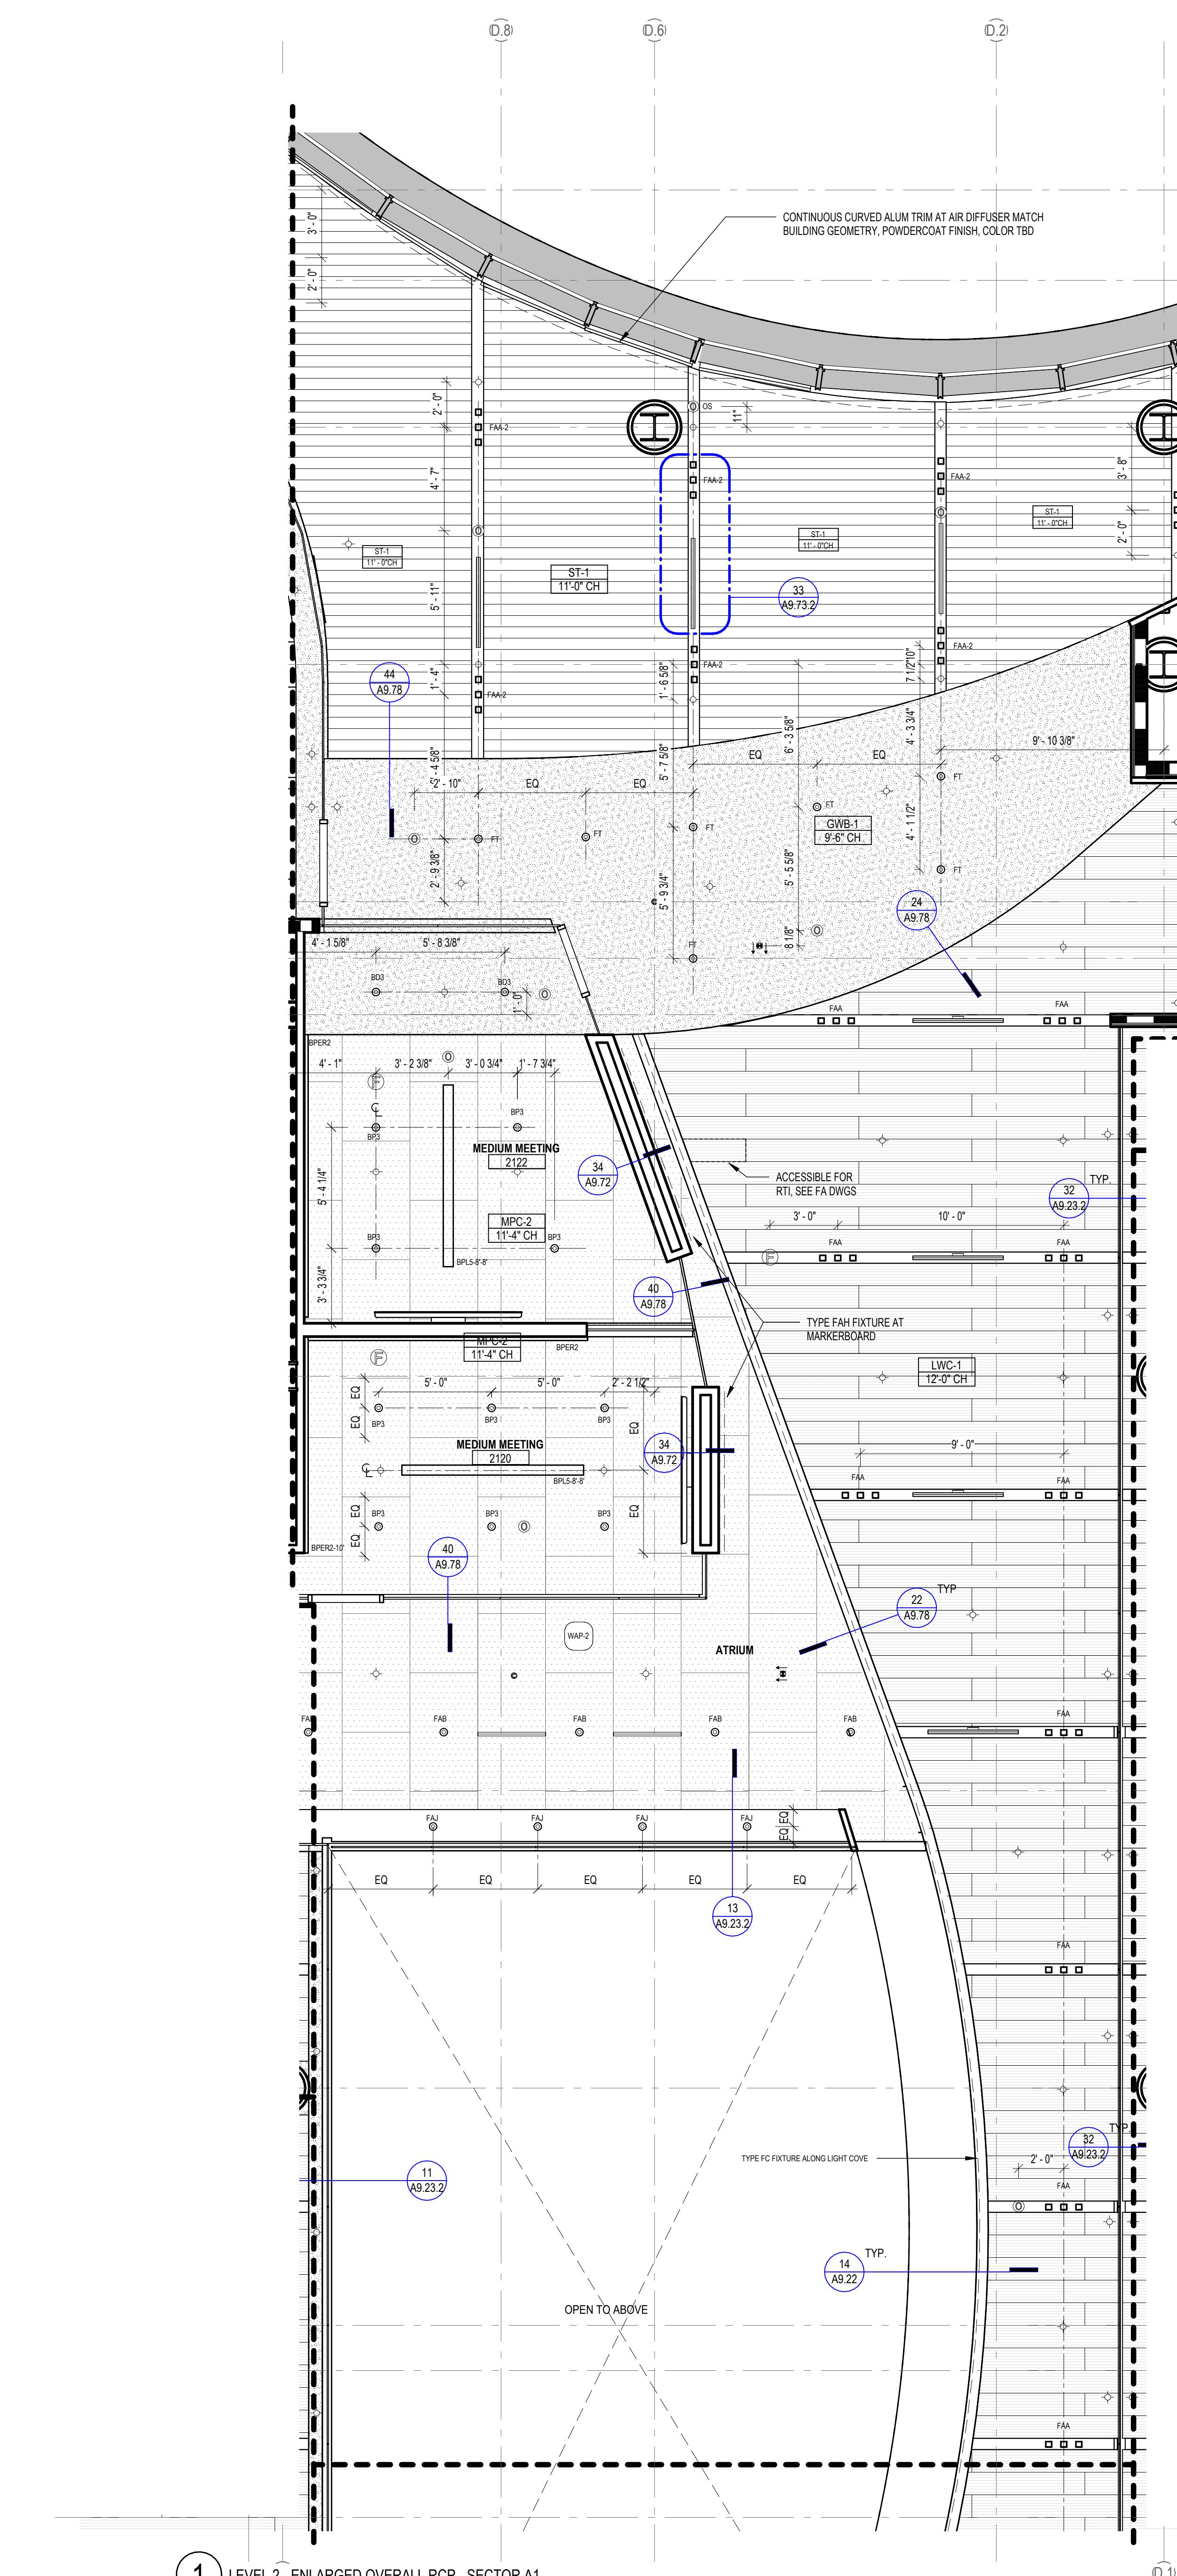


1 LEVEL 2 - ENLARGED OVERALL RCP - SECTOR A1
SCALE: 1/4" = 1'-0"

| LEGEND - CEILING PLAN | | NUMBER | DATE | DESCRIPTION |
|---|---|------------------|---------------------------|-------------------------|
| APC-1A | ACOUSTICAL PANEL CEILING (2X), LAB SUPPORT | | 10/24/25 | ISSUED FOR CONSTRUCTION |
| APC-1B | ACOUSTICAL PANEL CEILING (2X), DARK ROOM (BLACK) | | | |
| APC-2 | ACOUSTICAL PANEL CEILING (2X), FOCUS ROOM (HIGH NRC) | | | |
| APC-3 | ACOUSTICAL PANEL CEILING (2X), OPEN OFFICE | | | |
| APC-4 | ACOUSTICAL PANEL CEILING (2X), OFFICES, CONF. | | | |
| APC-5 | ACOUSTICAL PANEL CEILING (2X), OPEN LAB | | | |
| APC-6 | ACOUSTICAL PANEL CEILING (2X), BOH | | | |
| APC-7 | ACOUSTICAL PANEL CEILING (2X), WASHABLE, RADIOSPOT, FOOD SERVICE | | | |
| APC-8 | ACOUSTICAL PANEL CEILING (2X), MOISTURE RESISTANT, LOADING DOCK | | | |
| APC-9 | ACOUSTICAL PANEL CEILING (2X), SEMINAR, CONFERENCE | | | |
| FRP-1 | FIBERGLASS REINFORCED CEILING PANELS | | | |
| GWB-1 | GYPSUM BOARD CEILING, PAINTED | | | |
| GWB-2 | GYPSUM BOARD CEILING WITH HPC | | | |
| GWB-3 | GYPSUM PLASTER CEILING | | | |
| EXP-1 | EXPOSED TO STRUCTURE | | | |
| EXP-2 | EXPOSED TO STRUCTURE WITH PAINTED MEP, HANGERS, ACOUSTIC SPRAY COATING AT DECK | | | |
| LWC-1 | LINEAR WOOD CEILING ACOUSTIC INFILL PANEL SEE A9.73.1 | | | |
| LWC-2 | LINEAR WOOD CEILING WITH ACOUSTIC SPRAY COATING ABOVE SEE A9.73.1 | | | |
| WPC-1 | ACOUSTICAL WOOD PANEL CEILING | | | |
| MPC-1 | MICRO-PERFORATED METAL PANEL CEILING | | | |
| MPC-2 | PERFORATED METAL CEILING WITH NON-COMBUSTIBLE ACOUSTIC INFILL PANEL SEE A9.72 | | | |
| ST-1 | LINEAR WOOD CEILING SOFFITS | | | |
| ST-2.1 | METAL PANEL SOFFIT - EXTERIOR SOFFIT POWDER COAT TO MATCH COPPER ANODIZED ALUM. | | | |
| ST-2.2 | METAL PANEL SOFFIT - EXTERIOR SOFFIT POWDER COAT TO MATCH BRONZE ANODIZED ALUM. | | | |
| CSP-X | CEILING SERVICE PANEL SEE A10.05A FOR TYPES | | | |
| OHR | OVERHEAD SERVICE RACK, SEE A10.07 FOR DETAILS. | | | |
| (C) | CEILING MOUNTED SECURITY CAMERA, REFER TO SECURITY DWG | | | |
| | EXIT SIGN CEILING MOUNTED / WALL MOUNTED | | | |
| | CEILING MOUNTED SPRINKLERS, REFER TO PLUM. DWG | | | |
| | FIRE ALARM CEILING MOUNTED / WALL MOUNTED | | | |
| H | CEILING MOUNTED HEAT DETECTOR | | | |
| SD | CEILING MOUNTED SMOKE DETECTOR | | | |
| WAP-1 | WIRELESS ACCESS POINT MOUNTED ON CEILING | | | |
| WAP-2 | WIRELESS ACCESS POINT MOUNTED ABOVE CEILING | | | |
| OC | CEILING MOUNTED OCCUPANCY/PHOTOCELL SENSOR | | | |
| | EXHAUST CONNECTION @ CEILING - REF. MECH. DWGS | | | |
| | LINEAR WALL WASH | | | |
| ROLLER SHADES: | | | | |
| RS-1 | MOTORIZED ROLLER SHADE WITH SINGLE ROLLERS, LIGHT-FILTERING FABRIC. | | | |
| RS-2 | MOTORIZED ROLLER SHADE WITH DOUBLE ROLLERS, MOISTURE-RESISTANT LIGHT-FILTERING FABRIC AND MOISTURE-RESISTANT OPAQUE FABRIC. | | | |
| RS-3 | MOTORIZED ROLLER SHADE WITH SINGLE ROLLERS, MOISTURE-RESISTANT OPAQUE FABRIC, WITH WINDOW FRAME LIGHT BAFFLES. | | | |
| GENERAL NOTES: | | | | |
| 1. | FOR LIGHTING FIXTURE TYPES REFER TO LIGHTING SCHEDULE. | | | |
| 2. | FOR SPRINKLER TYPES REFER TO FIRE PROTECTION DRAWINGS. | | | |
| 3. | CENTER ALL DEVICES WITH TILES U.N.O. | | | |
| 4. | DEVICES IN OFFICES ARE SHOWN FOR QUANTITIES, REFER TO A9.74.1 FOR TYPICAL LAYOUT. | | | |
| LEGEND - LIGHT FIXTURES | | | | |
| REFER TO MEP DRAWINGS AND SPECIFICATIONS | | | | |
| | XXXXXX | L | LINEAR PENDANT FIXTURE | |
| | | S | SUSPENSION HEIGHT AFF | |
| | | F | Fixture Length | |
| | | T | Fixture Type | |
| | | | | |
| | XXXXXX | L | LINEAR RECESSED FIXTURE | |
| | | F | Fixture Length | |
| | | T | Fixture Type | |
| | | | | |
| | XXX | R | RECESSED DOWNLIGHT | |
| | | F | Fixture Type | |
| | | | | |
| | XXX | R | RECESSED 2X2 TROFFER | |
| | | F | Fixture Type | |
| | | | | |
| | XXX | R | RECESSED 2X4 TROFFER | |
| | | F | Fixture Type | |
| | | | | |
| | XXX | R | RECESSED ATRIUM DOWNLIGHT | |
| | | F | Fixture Type | |
| JOHNS HOPKINS UNIVERSITY | | | | |
| 1800 Orleans St Baltimore, Maryland 21287 | | | | |
| LIFE SCIENCES BUILDING | | | | |
| 600 N Broadway Baltimore, MD 21205 | | | | |
| ENLARGED REFLECTED CEILING PLAN - LEVEL 2 - SECTOR A1 + A2 | | | | |
| Seal | Date: | OCTOBER 24, 2025 | | |
| | Scale: | As indicated | | |
| | Drawn By: | | | |
| | Designed By: | | | |
| | Checked By: | | | |
| | Proj. Mgr.: | | | |
| | Payette Job No.: | 17480.00 | | |
| | Cadd File: | | | |
| | Client Job No.: | J.170.24.4000 | | |
| | Client Dwg. No.: | | | |
| | Professional Certification: | | | |
| I hereby certify that these documents were prepared or approved by me, or that they are duly licensed engineer under the laws of the State of Maryland. License No. 19966 Expiration Date: 06/20/2026 | | | | |
| A6.20.A1 | | | | |

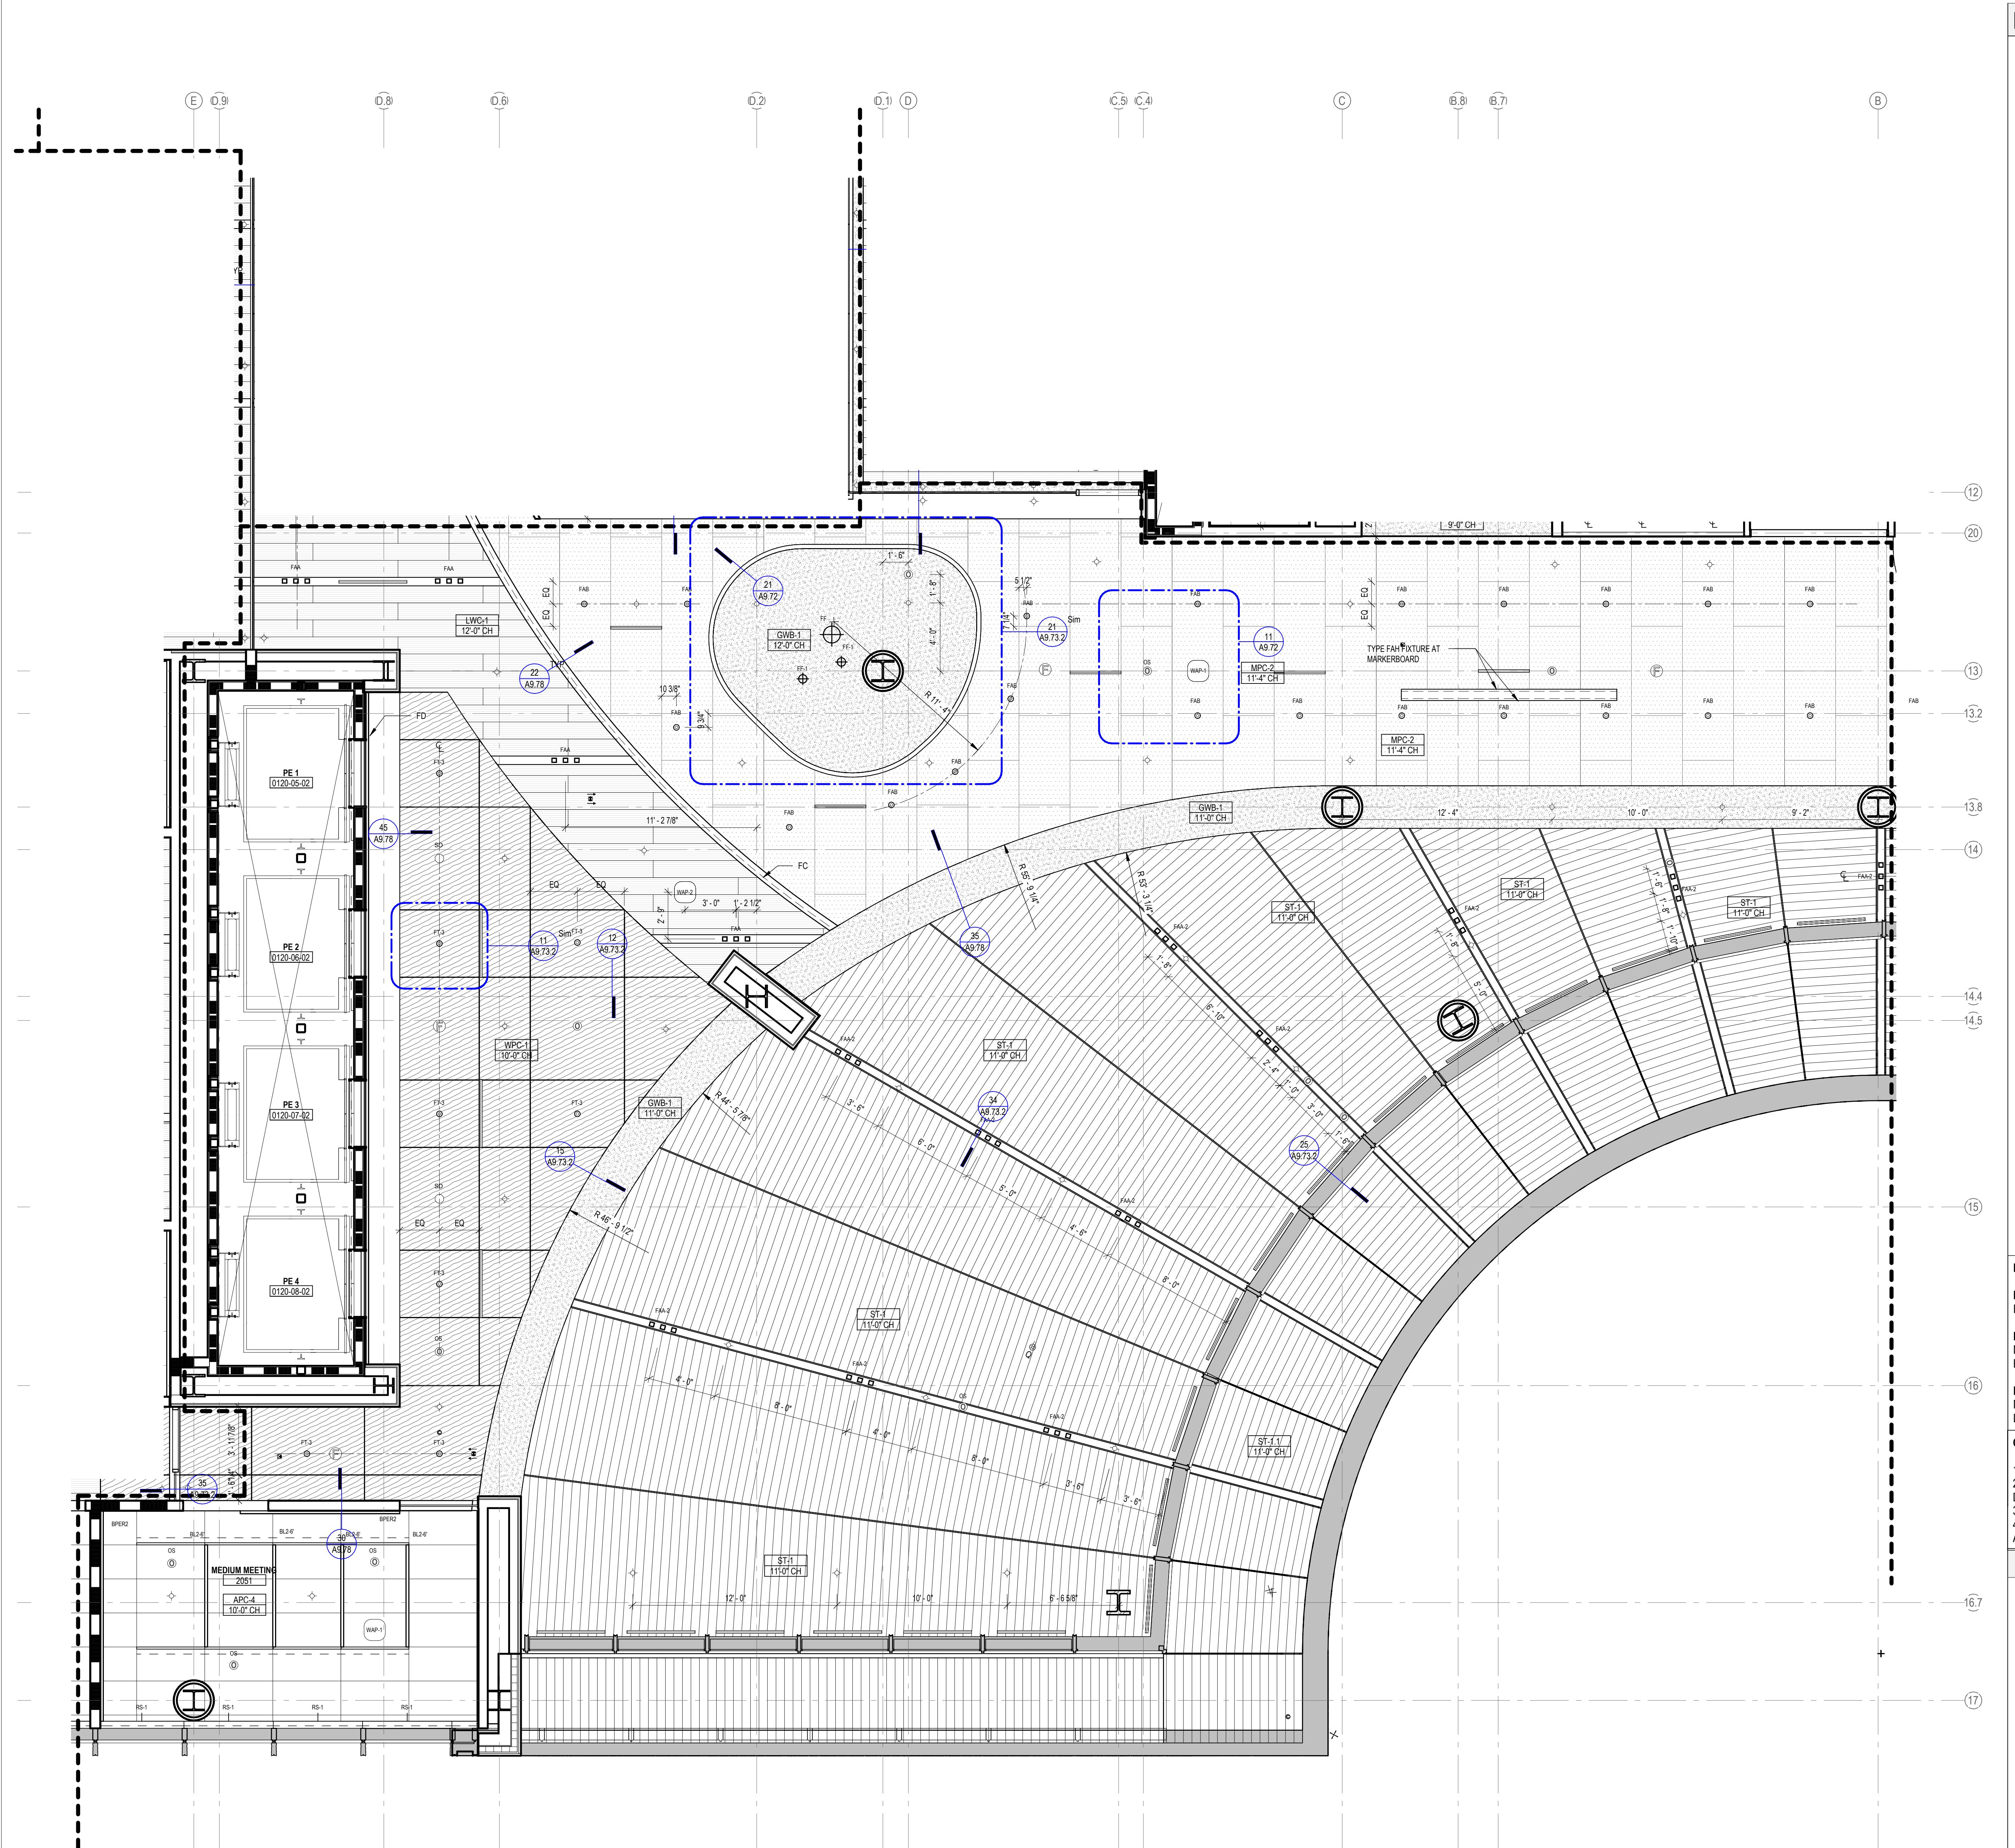

LEGEND - CEILING PLAN

| | | |
|---|--------|---|
|  | APC-1A | ACOUSTICAL PANEL CEILING (2X2), LAB SUPPORT |
|  | APC-1B | ACOUSTICAL PANEL CEILING (2X2), DARK ROOM (BLACK) |
|  | APC-2 | ACOUSTICAL PANEL CEILING (2X2), FOCUS ROOM (HIGH NRC) |
|  | APC-3 | ACOUSTICAL PANEL CEILING (2X4), OPEN OFFICE |
|  | APC-4 | ACOUSTICAL PANEL CEILING (2X4), OFFICES, CONF. |
|  | APC-5 | ACOUSTICAL PANEL CEILING (2X4), OPEN LAB |
|  | APC-6 | ACOUSTICAL PANEL CEILING (2X2), BOH |
|  | APC-7 | ACOUSTICAL PANEL CEILING (2X2), WASHABLE, RADIOISOTOPE, FOOD SERVICE |
|  | APC-8 | ACOUSTICAL PANEL CEILING (2X2), MOISTURE RESISTANT, LOADING DOCK |
|  | APC-9 | ACOUSTICAL PANEL CEILING (2X4), SEMINAR, CONFERENCE |
|  | FRP-1 | FIBERGLASS REINFORCED CEILING PANELS |
|  | GWB-1 | GYPSUM BOARD CEILING, PAINTED |
|  | GWB-2 | GYPSUM BOARD CEILING WITH HPC |
|  | GWB-3 | ACOUSTICAL PLASTER CEILING |

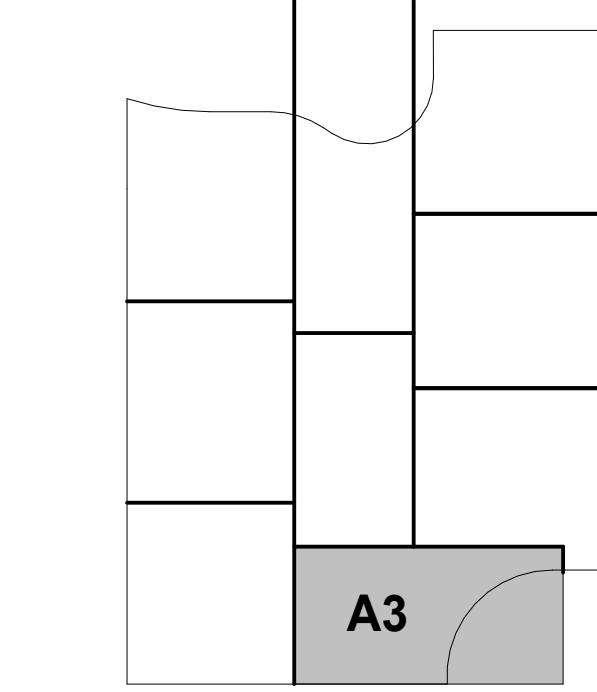


KEY PLAN

| | |
|---|---|
| ARCHITECT PAYETTE ASSOCIATES, INC. 290 Congress Street, Fifth Floor Boston, MA 02210 617.895.1000 | ASSOCIATE ARCHITECT KPN ARCHITECTS 1800 Washington Blvd, Suite 414 Baltimore, MD 21230 443.682.7757 |
| CODE CODE RED CONSULTANTS 154 Turnpike Road, Suite 200 Southborough, MA 01772 617.500.7633 | CIVIL RK&K 700 East Pratt Street, Suite 500 Baltimore, MD 21202 410.728.2900 |
| LANDSCAPE ARCHITECT OLIN 617 John F. Kennedy Boulevard, Suite 1900 Philadelphia, PA 19103 215.440.0030 | STRUCTURAL COLUMBIA ENGINEERING, INC. 6210 Old Dobbin Lane, Suite 150 Baltimore, Maryland 21045 410.992.9970 |
| VERTICAL TRANSPORTATION ZIPF ASSOCIATES, INC. 25 Bala Avenue, Suite 201 Bala Cynwyd, PA 19004 610.667.1717 | MEP BR+A CONSULTING ENGINEERS 10 Guest Street, 4th Floor Boston, MA 02135 617.254.0016 |
| RE ALARM & FIRE PROTECTION SETTY & ASSOCIATES 75 S. Charles Street, Suite 403 Baltimore, MD 21201 667.309.6036 | AUDIO VISUAL & TELECOM CONVERGENT TECHNOLOGIES DESIGN GROUP 6501 York Road Baltimore, MD 21212 410.532.2395 |
| SECURITY THORNTON TOMASETTI 1330 Connecticut Ave, NW, Suite 300 Washington, DC 20036 202.580.6300 | FOOD SERVICE COLBURN GUYETTE 100 Ledgewood Place, Suite 104 Rockland, MA, 02370 781.826.5522 |
| BUILDING ENCLOSURE MPSON GUMPERTZ & HEGER 1625 Eye St NW Suite 900 Washington, DC 20006 202.239.4199 | LEED SUSTAINABLE DESIGN CONSULTING 1432 K Street NW, 3rd Floor Washington, DC 20005 202.667.1620 |
| WIND & AIR QUALITY RWDI 650 Woodland Rd. W. Guelph, Ontario Canada N1K 1B8 519.823.1311 | VIBRATION & ACOUSTICS COLIN GORDON ASSOCIATES 1350 Old Bayshore Hwy, Suite 799 Burlingame, CA 94010 415.570.0350 |
| LIGHTING FISHER MARANTZ STONE 22 West 19th Street, 6th Floor New York, NY 10011 212.691.3020 | SITE LIGHTING TILLETT LIGHTING DESIGN ASSOCIATES 11 Hanover Square, 17th Floor New York, NY 10005 212.766.0144 |
| EMI/RFI (SHEILDING) TATECH ELECTROMAGNETICS 115 Juliad Ct., Suite 105 | CAMPUS UTILITIES AEI AFFILIATED ENGINEERS 2001 University City Drive, Suite 1000 |

LIFE SCIENCES BUILDING

600 N Broadway
Pittsburgh, PA 15222

LEGEND - LIGHT FIXTURES

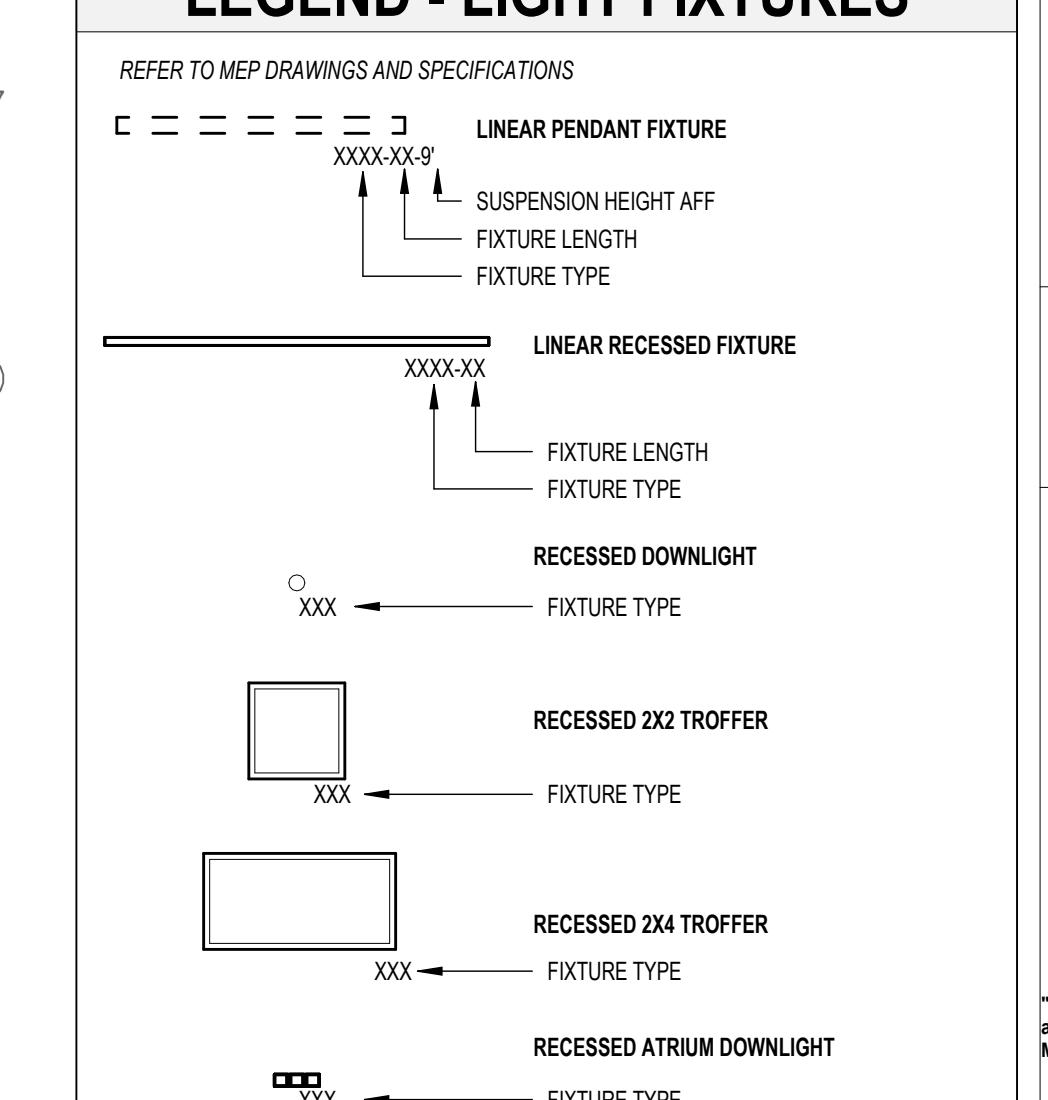

Baltimore, Maryland 21207


- SECTOR A8

Date: OCTOBER 24, 2025
Scale: As indicated
Drawn By:
Designed By:
Checked By:
Proj. Mgr.:
Payette Job No.: 17480.00
Cadd File:
Client Job No.: J.170.24.4000

Client Dwg. No.:



LEGEND - CEILING PLAN
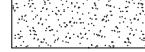
| | | |
|---|--------|---|
|  | APC-1A | ACOUSTICAL PANEL CEILING (2X2), LAB SUPPORT |
|  | APC-1B | ACOUSTICAL PANEL CEILING (2X2), DARK ROOM (BLACK) |
|  | APC-2 | ACOUSTICAL PANEL CEILING (2X2), FOCUS ROOM (HIGH NRC) |
|  | APC-3 | ACOUSTICAL PANEL CEILING (2X4), OPEN OFFICE |
|  | APC-4 | ACOUSTICAL PANEL CEILING (2X4), OFFICES, CONF. |
|  | APC-5 | ACOUSTICAL PANEL CEILING (2X4), OPEN LAB |
|  | APC-6 | ACOUSTICAL PANEL CEILING (2X2), BOH |
|  | APC-7 | ACOUSTICAL PANEL CEILING (2X2), WASHABLE, RADIOISOTOPE, FOOD SERVICE |
|  | APC-8 | ACOUSTICAL PANEL CEILING (2X2), MOISTURE RESISTANT, LOADING DOCK |
|  | APC-9 | ACOUSTICAL PANEL CEILING (2X4), SEMINAR, CONFERENCE |
|  | FRP-1 | FIBERGLASS REINFORCED CEILING PANELS |
|  | GWB-1 | GYPSUM BOARD CEILING, PAINTED |
|  | GWB-2 | GYPSUM BOARD CEILING WITH HPC |
|  | GWB-3 | ACOUSTICAL PLASTER CEILING |

1

KEY PLAN

| | |
|---|---|
| ARCHITECT PAYETTE ASSOCIATES, INC. 290 Congress Street, Fifth Floor Boston, MA 02210 617.895.1000 | ASSOCIATE ARCHITECT KPN ARCHITECTS 1800 Washington Blvd, Suite 414 Baltimore, MD 21230 443.682.7757 |
| CODE CODE RED CONSULTANTS 154 Turnpike Road, Suite 200 Southborough, MA 01772 617.500.7633 | CIVIL RK&K 700 East Pratt Street, Suite 500 Baltimore, MD 21202 410.728.2900 |
| LANDSCAPE ARCHITECT OLIN 617 John F. Kennedy Boulevard, Suite 1900 Philadelphia, PA 19103 215.440.0030 | STRUCTURAL COLUMBIA ENGINEERING, INC. 6210 Old Dobbin Lane, Suite 150 Baltimore, Maryland 21045 410.992.9970 |
| VERTICAL TRANSPORTATION ZIPF ASSOCIATES, INC. 25 Bala Avenue, Suite 201 Bala Cynwyd, PA 19004 610.667.1717 | MEP BR+A CONSULTING ENGINEERS 10 Guest Street, 4th Floor Boston, MA 02135 617.254.0016 |
| fire alarm & fire protection SETTY & ASSOCIATES 75 S. Charles Street, Suite 403 Baltimore, MD 21201 667.309.6036 | AUDIO VISUAL & TELECOM CONVERGENT TECHNOLOGIES DESIGN GROUP 6501 York Road Baltimore, MD 21212 410.532.2395 |
| SECURITY THORNTON TOMASETTI 1330 Connecticut Ave, NW, Suite 300 Washington, DC 20036 202.580.6300 | FOOD SERVICE COLBURN GUYETTE 100 Ledgewood Place, Suite 104 Rockland, MA, 02370 781.826.5522 |
| BUILDING ENCLOSURE MPSON GUMPERTZ & HEGER 1625 Eye St NW Suite 900 Washington, DC 20006 202.239.4199 | LEED SUSTAINABLE DESIGN CONSULTING 1432 K Street NW, 3rd Floor Washington, DC 20005 202.667.1620 |
| WIND & AIR QUALITY RWDI 650 Woodland Rd. W. Guelph, Ontario Canada N1K 1B8 519.823.1311 | VIBRATION & ACOUSTICS COLIN GORDON ASSOCIATES 1350 Old Bayshore Hwy, Suite 799 Burlingame, CA 94010 415.570.0350 |
| LIGHTING FISHER MARANTZ STONE 22 West 19th Street, 6th Floor New York, NY 10011 212.691.3020 | SITE LIGHTING TILLETT LIGHTING DESIGN ASSOCIATES 11 Hanover Square, 17th Floor New York, NY 10005 212.766.0144 |
| EMI/RFI (SHEILDING) TATECH ELECTROMAGNETICS 115 Juliad Ct., Suite 105 Fredericksburg, VA 22406 540.286.1984 | CAMPUS UTILITIES AEI AFFILIATED ENGINEERS 200 International Circle, Suite 5888 Hunt Valley, MD 21030 410.229.0090 |

LIFE SCIENCES BUILDING

600 N Broadway
Baltimore, MD 21205

A9.74.1 FOR TYPICAL LAYOUT

REFER TO MEP DRAWINGS AND SPECIFICATIONS

LINEAR PENDANT FIXTURE
XXXX-XX-9'
SUSPENSION HEIGHT AFF
FIXTURE LENGTH
FIXTURE TYPE

LINEAR RECESSED FIXTURE
XXXX-XX
FIXTURE LENGTH
FIXTURE TYPE

RECESSED DOWNLIGHT
○
XXX ← FIXTURE TYPE

RECESSED 2X2 TROFFER
XXX ← FIXTURE TYPE

RECESSED 2X4 TROFFER
XXX ← FIXTURE TYPE


RECESSED ATRIUM DOWNLIGHT
XXXX ← FIXTURE TYPE

Baltimore, Maryland 21287

| | | |
|---|------------------|------------------|
|  | Date: | OCTOBER 24, 2025 |
| | Scale: | As indicated |
| | Drawn By: | |
| | Designed By: | |
| | Checked By: | |
| | Proj. Mgr.: | |
| | Payette Job No.: | 17480.00 |
| | Cadd File: | |
| | Client Job No.: | J.170.24.4000 |
| Client Dwg. No.: | | |


A6.21

A6.21

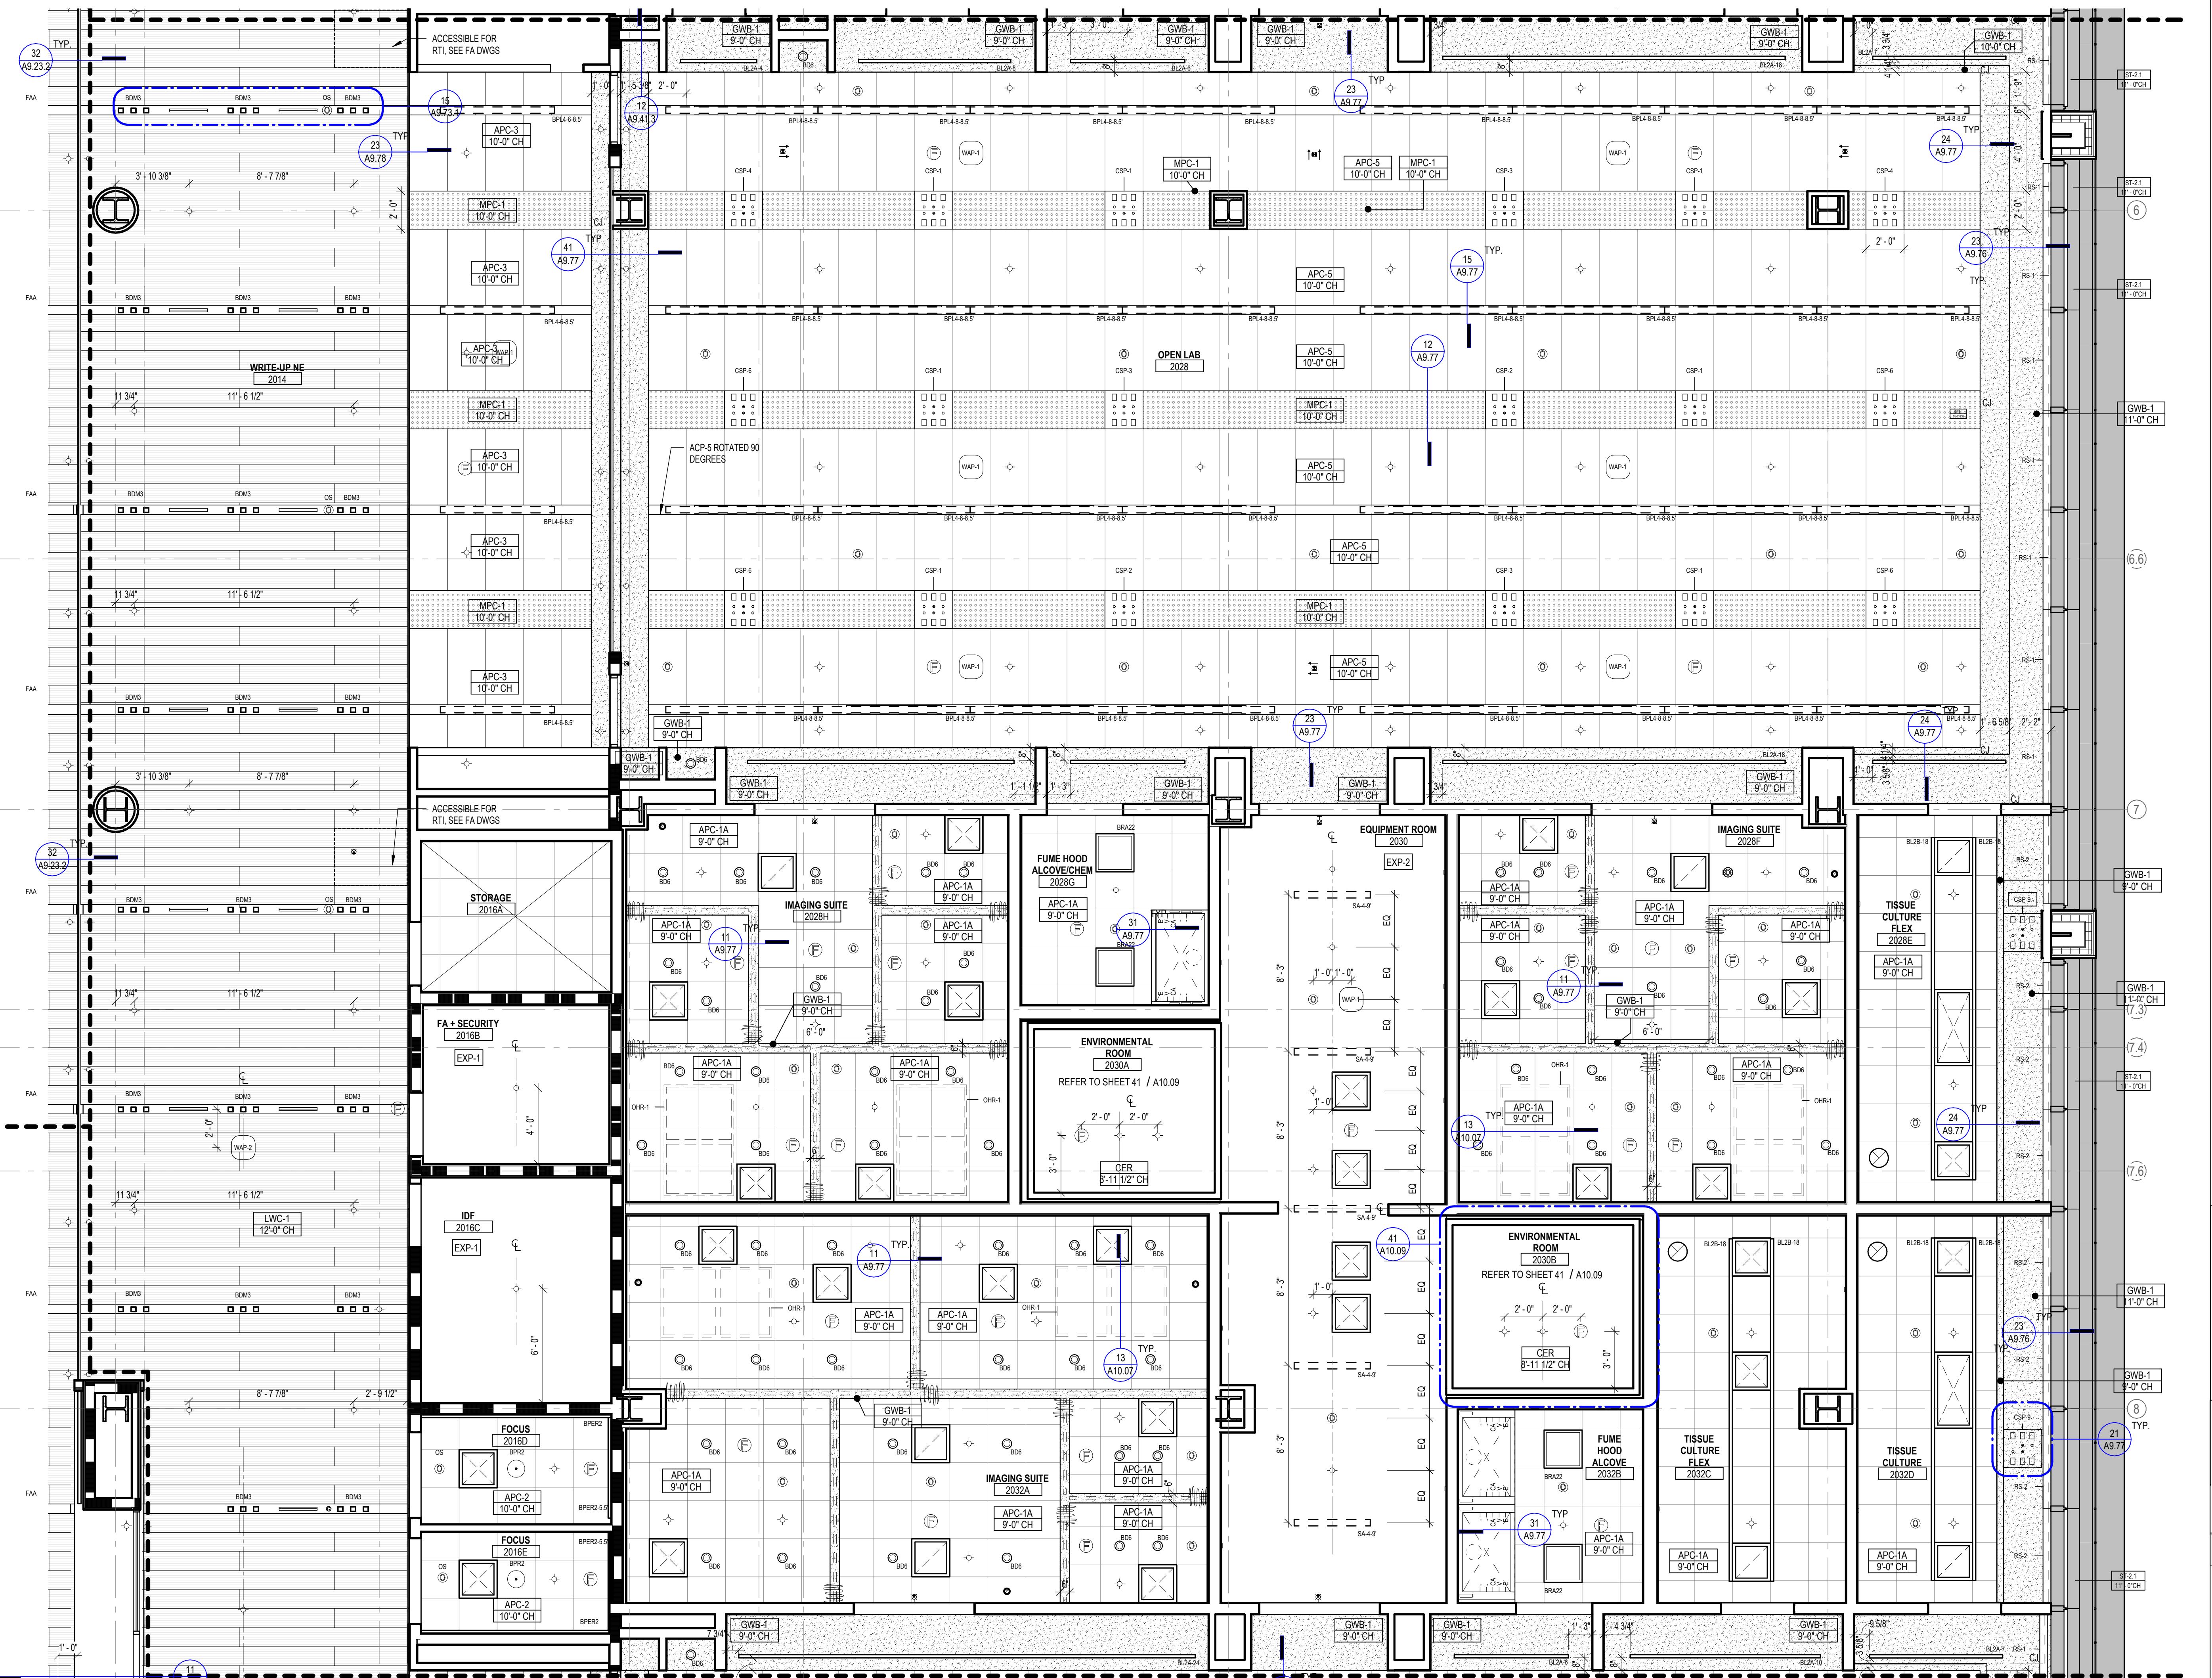

LEGEND - CEILING PLAN

| | |
|---------|--|
| APC-1A | ACOUSTICAL PANEL CEILING (2X2), LAB SUPPORT |
| APC-1B | ACOUSTICAL PANEL CEILING (2X2), DARK ROOM (BLACK) |
| APC-2 | ACOUSTICAL PANEL CEILING (2X2), FOCUS ROOM (HIGH NRC) |
| APC-3 | ACOUSTICAL PANEL CEILING (2X4), OPEN OFFICE |
| APC-4 | ACOUSTICAL PANEL CEILING (2X4), OFFICES, CONF. |
| APC-5 | ACOUSTICAL PANEL CEILING (2X4), OPEN LAB |
| APC-6 | ACOUSTICAL PANEL CEILING (2X2), BOH |
| APC-7 | ACOUSTICAL PANEL CEILING (2X2), WASHABLE, RADIOISOTOPE, FOOD SERVICE |
| APC-8 | ACOUSTICAL PANEL CEILING (2X2), MOISTURE RESISTANT, LOADING DOCK |
| APC-9 | ACOUSTICAL PANEL CEILING (2X4), SEMINAR, CONFERENCE |
| FRP-1 | FIBERGLASS REINFORCED CEILING PANELS |
| GWB-1 | GYPSUM BOARD CEILING, PAINTED |
| GWB-2 | GYPSUM BOARD CEILING WITH HPC |
| GWB-3 | ACOUSTICAL PLASTER CEILING |
| EXP-1 | EXPOSED TO STRUCTURE |
| EXP-2 | EXPOSED TO STRUCTURE WITH PAINTED MEP, HANGERS, ACOUSTIC SPRAY COATING AT DECK |
| LWC-1 | LINEAR WOOD CEILING ACOUSTIC INFILL PANEL SEE A7.3.1 |
| LWC-2 | LINEAR WOOD CEILING WITH ACOUSTIC SPRAY COATING ABOVE SEE A7.3.1 |
| WPC-1 | ACOUSTICAL WOOD PANEL CEILING |
| MPC-1 | MICRO-PERFORATED METAL PANEL CEILING |
| MPC-2 | PERFORATED METAL CEILING WITH NON-COMBUSTIBLE ACOUSTIC INFILL PANEL SEE A9.72 |
| ST-1 | LINEAR WOOD CEILING SOFTITS |
| ST-2 | METAL PANEL SOFFIT - EXTERIOR SOFFIT POWDER COAT TO MATCH COPPER ANODIZED ALUM. |
| ST-22 | METAL PANEL SOFFIT - EXTERIOR SOFFIT POWDER COAT TO MATCH BRONZE ANODIZED ALUM. |
| CSP-X | CEILING MOUNTED SECURITY CAMERA, REFER TO SECURITY DWG |
| OHR | EXIT SIGN CEILING MOUNTED / WALL MOUNTED |
| (C) | CEILING MOUNTED SPRINKLERS, REFER TO PLUM. DWG |
| (P) | FIRE ALARM CEILING MOUNTED / WALL MOUNTED |
| (H) | CEILING MOUNTED HEAT DETECTOR |
| (SD) | CEILING MOUNTED SMOKE DETECTOR |
| (WAP-1) | WIRELESS ACCESS POINT MOUNTED ON CEILING |
| (WAP-2) | WIRELESS ACCESS POINT MOUNTED ABOVE CEILING |
| (OC) | CEILING MOUNTED OCCUPANCY/PHOTOCELL SENSOR |
| (EX) | EXHAUST CONNECTION @ CEILING - REF. MECH. DWG'S |
| (LW) | LINEAR WALL WASH |

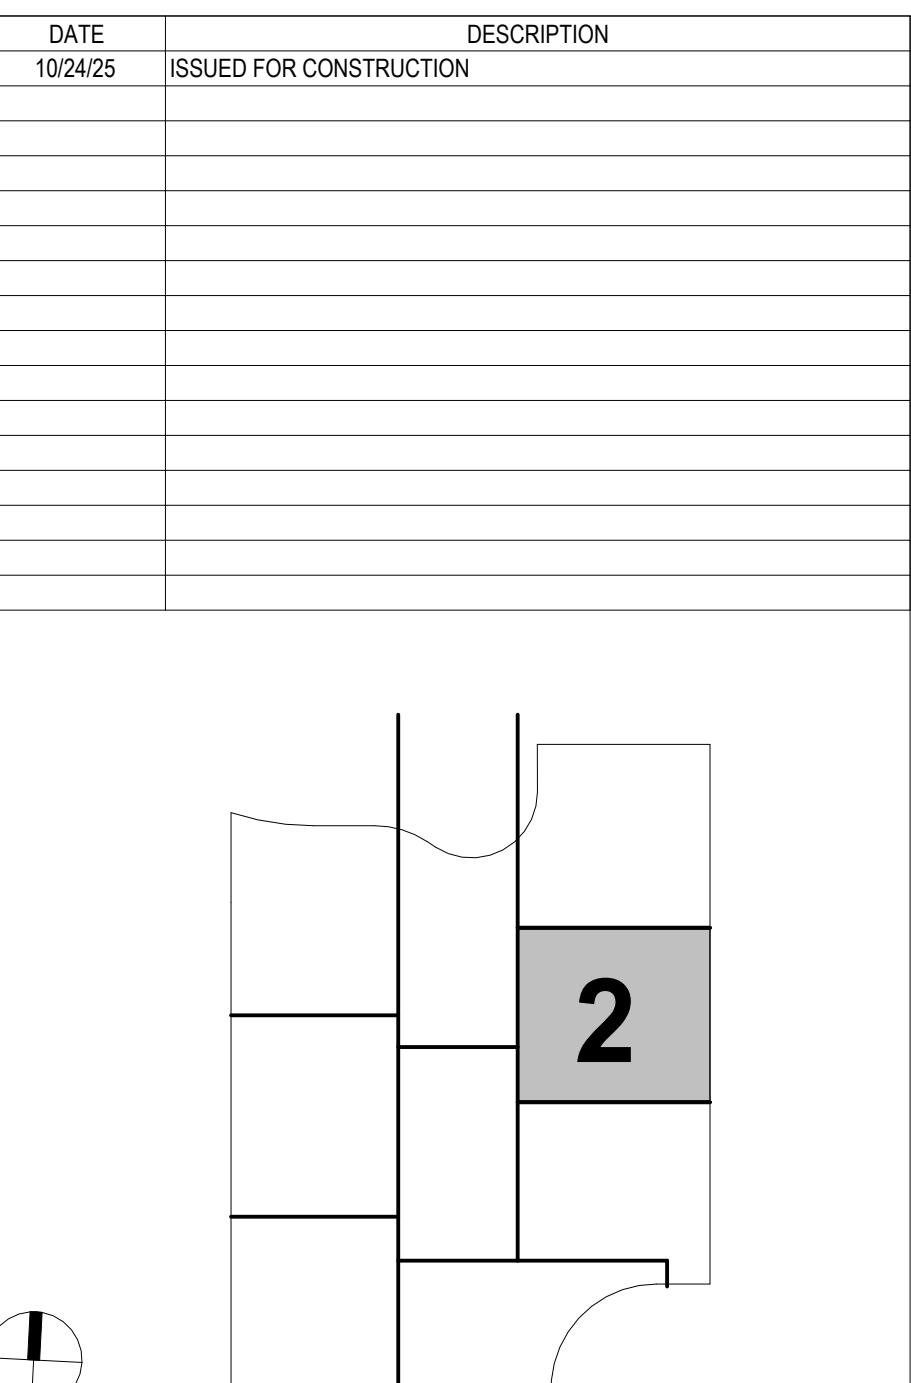

KEY PLAN

| | |
|--|--|
| ARCHITECT PAYETTE ASSOCIATES, INC. 290 Congress Street, Fifth Floor Boston, MA 02210 | ASSOCIATE ARCHITECT KPN ARCHITECTS 1800 Washington Blvd, Suite 414 Baltimore, MD 21230 |
| CODE CODE RED CONSULTANTS 154 Turnpike Road, Suite 200 Southborough, MA 01772 | CIVIL RK&K 700 East Pratt Street, Suite 500 Baltimore, MD 21202 |
| LANDSCAPE ARCHITECT OLIN 1617 John F. Kennedy Boulevard, Suite 1900 Philadelphia, PA 19103 | STRUCTURAL COLUMBIA ENGINEERING, INC. 6210 Old Dobbin Lane, Suite 150 Baltimore, Maryland 21045 |
| MEP BR+A CONSULTING ENGINEERS 10 Guest Street, 4th Floor Boston, MA 02135 | MEP ZPPF ASSOCIATES, INC. 25 Baba Avenue, Suite 201 Bala Cynwyd, PA 19004 |
| FIRE ALARM & FIRE PROTECTION SETTY & ASSOCIATES 575 S. Charles Street, Suite 403 Baltimore, MD 21212 | AUDIO VISUAL & TELECOM CONVERGE TECHNOLOGIES DESIGN GROUP 6501 York Road Baltimore, MD 21205 |
| SECURITY THORN TAN TOMASSETTI 1330 Connecticut Ave, NW, Suite 300 Washington, DC 20036 | FOOD SERVICE COLURN GUYETTE 100 Ledgewood Place, Suite 104 Rockland, MA 02370 |
| BUILDING ENCLOSURE SIMPSON GUMPERTZ & HEGER 1625 Eye St NW Suite 900 Washington, DC 20006 | LEED SUSTAINABLE DESIGN CONSULTING 1432 K Street, 3rd Floor Washington, DC 20006 |
| VIBRATION & ACOUSTICS RWRI 650 Woodland Rd. W. Guelph, Ontario Canada N1K 1B8 | WIND & AIR QUALITY RWRI 1350 Old Bayshore Hwy, Suite 799 Burlingame, CA 94010 |
| LIGHTING FISHER MARANTZ STONE 22 West 19th Street, 6th Floor New York, NY 10001 | SITE LIGHTING TILLETT LIGHTING DESIGN ASSOCIATES 11 Hanover Square, 17th Floor New York, NY 10005 |
| EMI/RFI SHIELDING VITACHEK ELECTROMAGNETICS 115 Julian Ct., Suite 105 Fredericksburg, VA 22406 | GENERAL NOTES: 1. FOR LIGHTING FIXTURE TYPES REFER TO LIGHTING SCHEDULE. 2. FOR SPRINKLER TYPES REFER TO FIRE PROTECTION DRAWINGS. 3. CENTER ALL DEVICES WITH TILES U.N.O. 4. DEVICES IN OFFICES ARE SHOWN FOR QUANTITIES, REFER TO A9.71 FOR TYPICAL LAYOUT. |

LIFE SCIENCES BUILDING


JOHNS HOPKINS
UNIVERSITY

1800 Orleans St
Baltimore, Maryland 21287

ENLARGED REFLECTED CEILING PLAN - LEVEL 2 - SECTOR 2

| | |
|------|--|
| Seal | Date: OCTOBER 24, 2025 |
| | Scale: As indicated |
| | Drawn By: |
| | Designed By: |
| | Checked By: |
| | Proj. Mgr.: Payette Job No.: 17480.00 |
| | Cadd File: Client Job No.: J.170.24.4000 |
| | Client Dwg. No.: Client Dwg. No. |

Professional Certification:
I hereby certify that these documents were prepared or approved by me, and that they are duly licensed engineer under the laws of the State of Maryland.
License No. 9986 Expiration Date: 06/20/2026

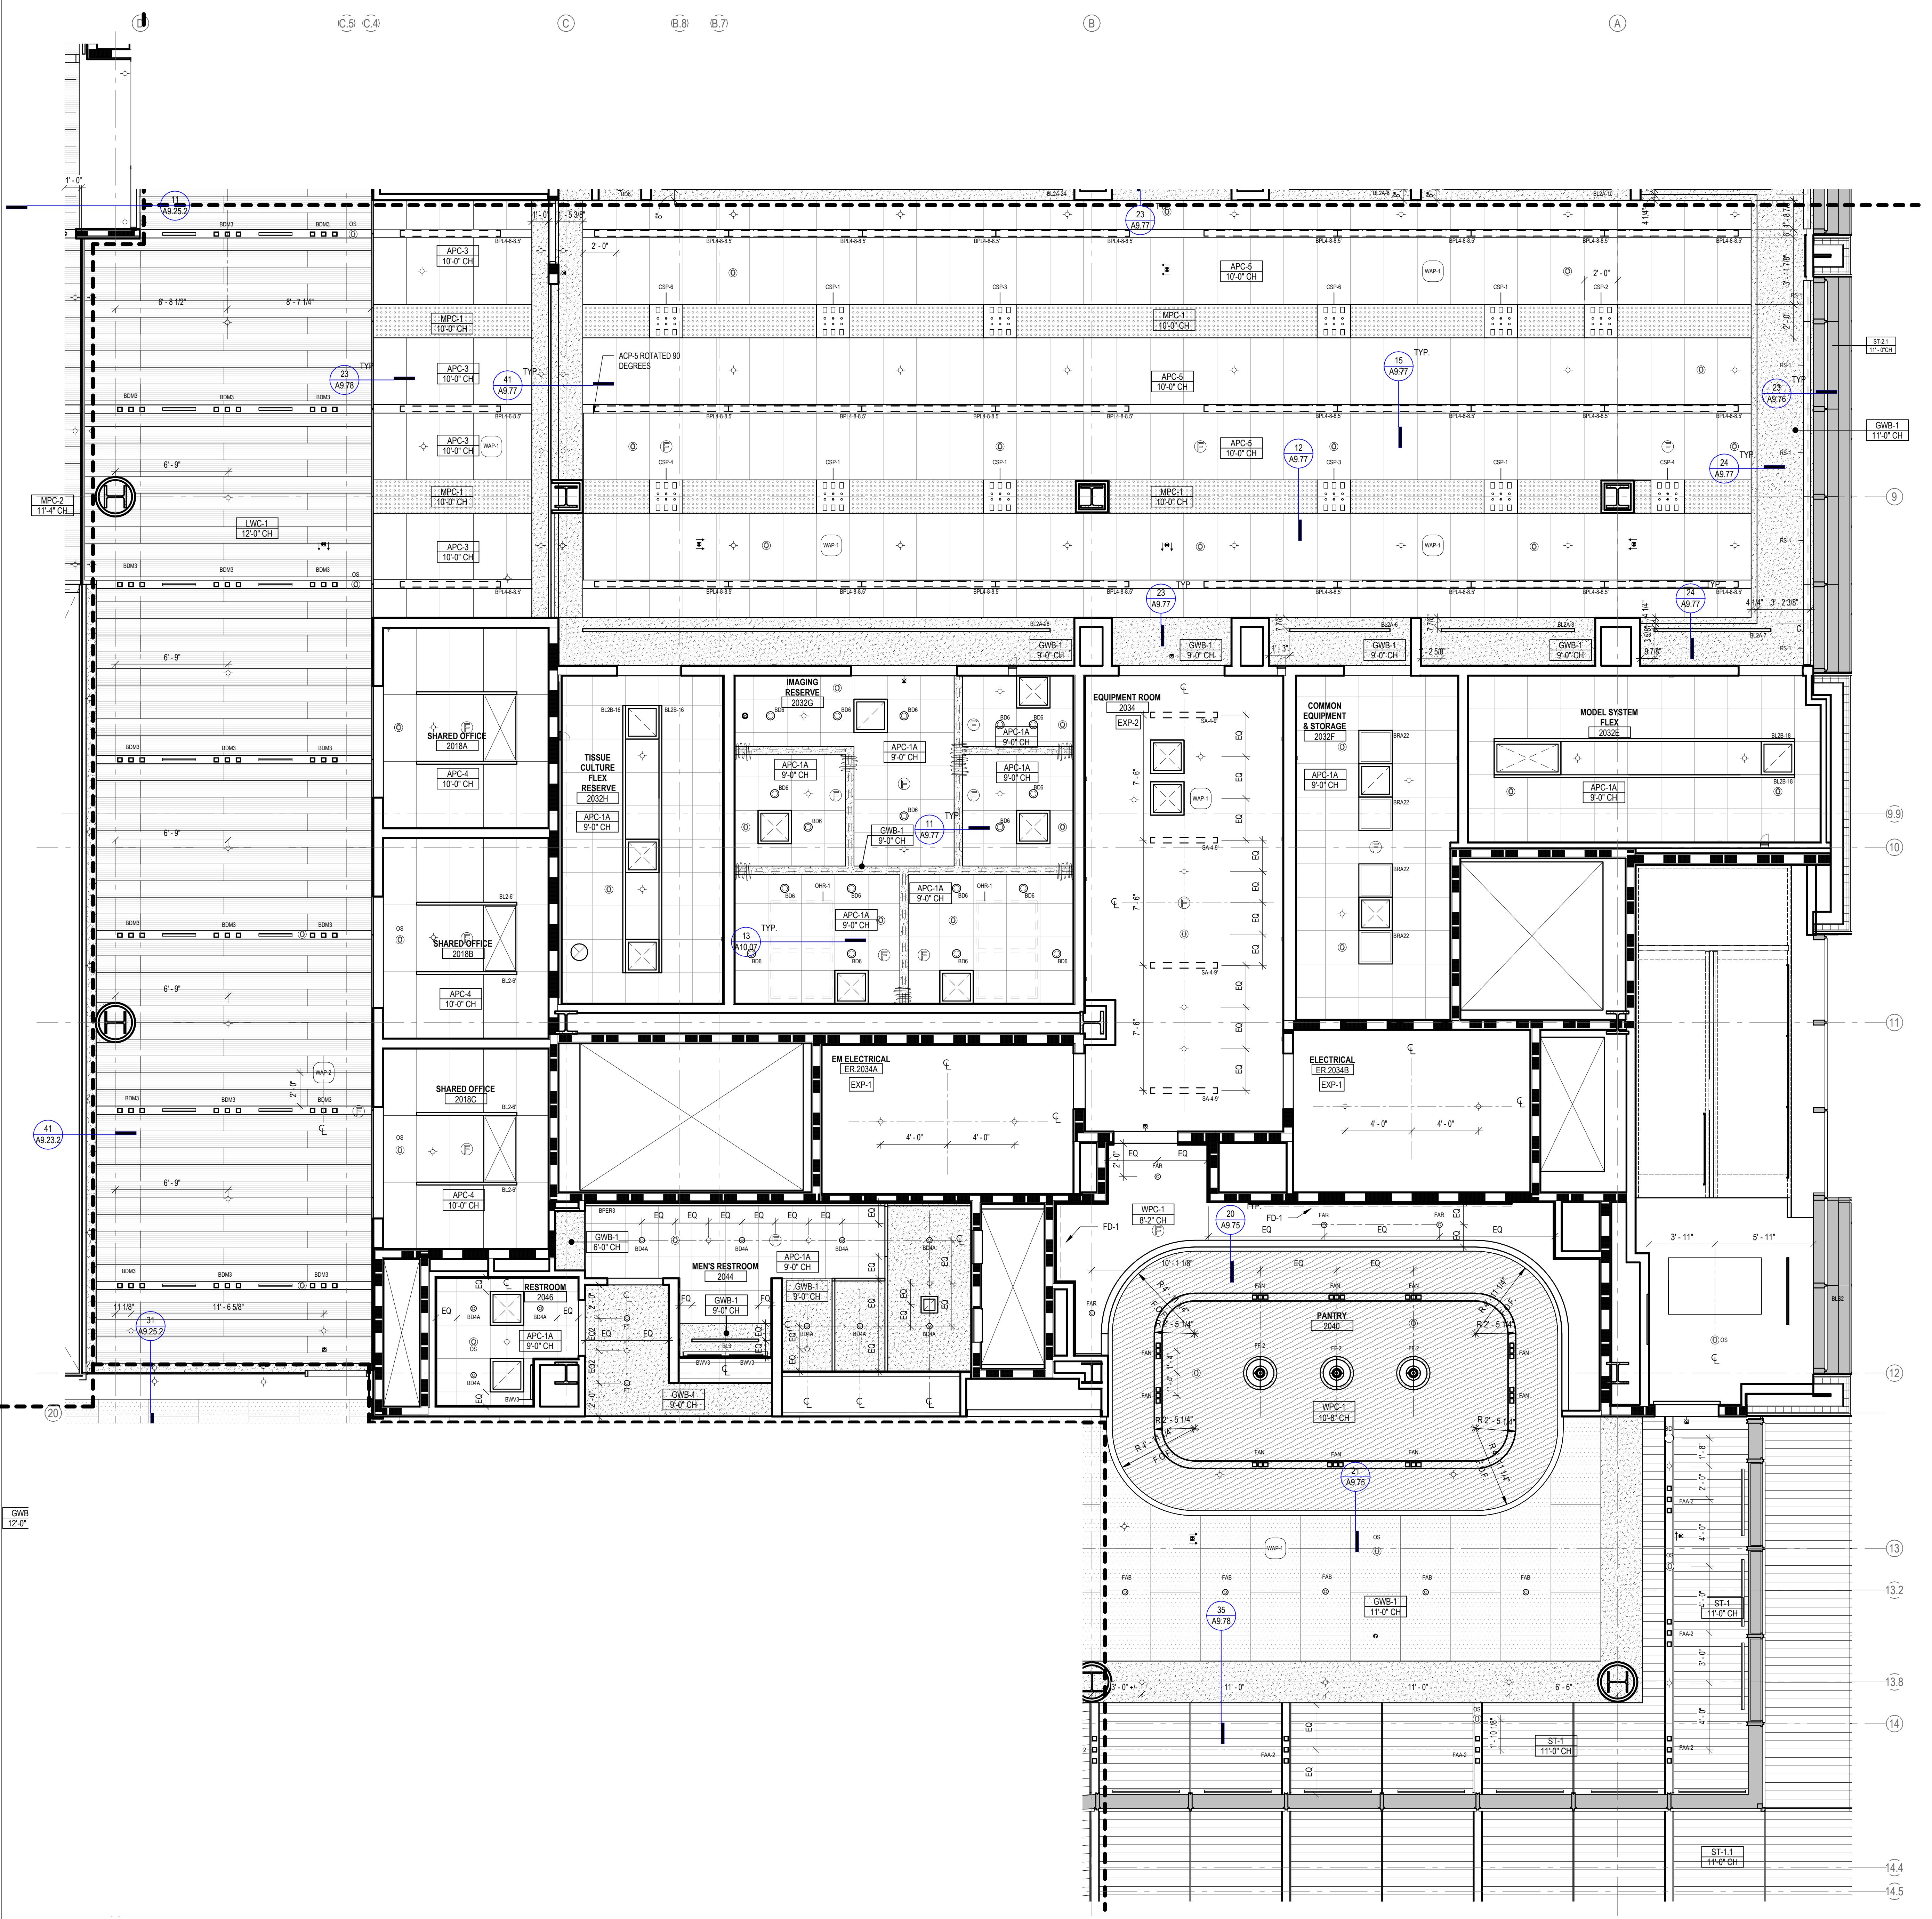

LEGEND - CEILING PLAN

| | | |
|--|--------|---|
| | APC-1A | ACOUSTICAL PANEL CEILING (2X2), LAB SUPPORT |
| | APC-1B | ACOUSTICAL PANEL CEILING (2X2), DARK ROOM (BLACK) |
| | APC-2 | ACOUSTICAL PANEL CEILING (2X2), FOCUS ROOM (HIGH NRC) |
| | APC-3 | ACOUSTICAL PANEL CEILING (2X4), OPEN OFFICE |
| | APC-4 | ACOUSTICAL PANEL CEILING (2X4), OFFICES, CONF. |
| | APC-5 | ACOUSTICAL PANEL CEILING (2X4), OPEN LAB |
| | APC-6 | ACOUSTICAL PANEL CEILING (2X2), BOH |
| | APC-7 | ACOUSTICAL PANEL CEILING (2X2), WASHABLE, RADIOISOTOPE, FOOD SERVICE |
| | APC-8 | ACOUSTICAL PANEL CEILING (2X2), MOISTURE RESISTANT, LOADING DOCK |
| | APC-9 | ACOUSTICAL PANEL CEILING (2X4), SEMINAR, CONFERENCE |
| | FRP-1 | FIBERGLASS REINFORCED CEILING PANELS |
| | GWB-1 | GYPSUM BOARD CEILING, PAINTED |
| | GWB-2 | GYPSUM BOARD CEILING WITH HPC |
| | GWB-3 | ACOUSTICAL PLASTER CEILING |
| | EXP-1 | EXPOSED TO STRUCTURE |
| | EXP-2 | EXPOSED TO STRUCTURE WITH PAINTED MEP, HANGERS, ACOUSTIC SPRAY COATING AT DECK |
| | LWC-1 | LINEAR WOOD CEILING ACOUSTIC INFILL PANEL SEE A9.73.1 |
| | LWC-2 | LINEAR WOOD CEILING WITH ACOUSTIC SPRAY COATING ABOVE SEE A9.73.1 |
| | WPC-1 | ACOUSTICAL WOOD PANEL CEILING |
| | MPC-1 | MICRO-PERFORATED METAL PANEL CEILING |
| | MPC-2 | PERFORATED METAL CEILING WITH NON-COMBUSTIBLE ACOUSTIC INFILL PANEL SEE A9.72 |
| | ST-1 | LINEAR WOOD CEILING SOFFITS |
| | ST-2.1 | METAL PANEL SOFFIT - EXTERIOR SOFFIT POWDER COAT TO MATCH COPPER ANODIZED ALUM. |
| | ST-2.2 | METAL PANEL SOFFIT - EXTERIOR SOFFIT POWDER COAT TO MATCH BRONZE ANODIZED ALUM. |
| | CSP-X | CEILING SERVICE PANEL. SEE A10.05A FOR TYPES. |
| | OHR | OVERHEAD SERVICE RACK, SEE A10.07 FOR DETAILS. |
| | C | CEILING MOUNTED SECURITY CAMERA, REFER TO SECURITY DWG |
| | / | EXIT SIGN CEILING MOUNTED / WALL MOUNTED |
| | | CEILING MOUNTED SPRINKLERS, REFER TO PLUM. DWG |
| | / | FIRE ALARM CEILING MOUNTED / WALL MOUNTED |
| | H | CEILING MOUNTED HEAT DETECTOR |
| | SD | CEILING MOUNTED SMOKE DETECTOR |
| | WAP-1 | WIRELESS ACCESS POINT MOUNTED ON CEILING |
| | WAP-2 | WIRELESS ACCESS POINT MOUNTED ABOVE CEILING |
| | OC | CEILING MOUNTED OCCUPANCY/PHOTOCELL SENSOR |
| | | EXHAUST CONNECTION @ CEILING - REF. MECH. DWG'S |
| | | LINEAR WALL WASH |

The image is a black and white abstract graphic. It features a large, bold number '3' in black, centered within a solid gray square. This gray square is positioned in the lower right quadrant of the composition. To the left of the gray square, there is a large, light-colored rectangular area with a thin black border. Above this, a horizontal line segment extends across the width of the page. Below the gray square, another horizontal line segment is located at the bottom edge. In the upper left quadrant, there is a large, light-colored rectangular area with a thin black border, containing a thin, wavy black line that curves across its surface. The overall style is minimalist and geometric.

KEY PLAN

| | |
|---|---|
| ARCHITECT TTE ASSOCIATES, INC. ngress Street, Fifth Floor oston, MA 02210 617.895.1000 | ASSOCIATE ARCHITECT KPN ARCHITECTS 1800 Washington Blvd, Suite 414 Baltimore, MD 21230 443.682.7757 |
| CODE E RED CONSULTANTS urnpike Road, Suite 200 thborough, MA 01772 617.500.7633 | CIVIL RK&K 700 East Pratt Street, Suite 500 Baltimore, MD 21202 410.728.2900 |
| SCAPE ARCHITECT OLIN hn F. Kennedy Boulevard, Suite 1900 iladelphia, PA 19103 215.440.0030 | STRUCTURAL COLUMBIA ENGINEERING, INC. 6210 Old Dobbin Lane, Suite 150 Baltimore, Maryland 21045 410.992.9970 |
| CAL TRANSPORTATION F ASSOCIATES, INC. ala Avenue, Suite 201 a Cynwyd, PA 19004 610.667.1717 | MEP BR+A CONSULTING ENGINEERS 10 Guest Street, 4th Floor Boston, MA 02135 617.254.0016 |
| ARM & FIRE PROTECTION TTY & ASSOCIATES Charles Street, Suite 403 altimore, MD 21201 667.309.6036 | AUDIO VISUAL & TELECOM CONVERGENT TECHNOLOGIES DESIGN GROUP 6501 York Road Baltimore, MD 21212 410.532.2395 |
| SECURITY RNTON TOMASETTI Connecticut Ave, NW, Suite 300 ashington, DC 20036 202.580.6300 | FOOD SERVICE COLBURN GUYETTE 100 Ledgewood Place, Suite 104 Rockland, MA, 02370 781.826.5522 |
| LIDING ENCLOSURE ON GUMPERTZ & HEGER 1625 Eye St NW Suite 900 ashington, DC 20006 202.239.4199 | LEED SUSTAINABLE DESIGN CONSULTING 1432 K Street NW, 3rd Floor Washington, DC 20005 202.667.1620 |
| ND & AIR QUALITY RWDI 650 Woodland Rd. W. Guelph, Ontario Canada N1K 1B8 519.823.1311 | VIBRATION & ACOUSTICS COLIN GORDON ASSOCIATES 1350 Old Bayshore Hwy, Suite 799 Burlingame, CA 94010 415.570.0350 |
| LIGHTING ER MARANTZ STONE est 19th Street, 6th Floor ew York, NY 10011 212.691.3020 | SITE LIGHTING TILLETT LIGHTING DESIGN ASSOCIATES 11 Hanover Square, 17th Floor New York, NY 10005 212.766.0144 |
| M/RFI (SHEILDING) CH ELECTROMAGNETICS 5 Juliad Ct., Suite 105 ericksburg, VA 22406 540.286.1984 | CAMPUS UTILITIES AEI AFFILIATED ENGINEERS 200 International Circle, Suite 5888 Hunt Valley, MD 21030 410.229.0090 |

LIFE SCIENCES BUILDING

600 N Broadway
Baltimore, MD 21205

74.1 FOR TYPICAL LAYOUT

REFER TO MEP DRAWINGS AND SPECIFICATIONS

LINEAR PENDANT FIXTURE
XXXX-XX-9'
SUSPENSION HEIGHT AFF
Fixture Length
Fixture Type

LINEAR RECESSED FIXTURE
XXXX-XX
Fixture Length
Fixture Type

RECESSED DOWNLIGHT
XXX
Fixture Type

RECESSED 2X2 TROFFER
XXX
Fixture Type

RECESSED 2X4 TROFFER
XXX
Fixture Type

RECESSED ATRIUM DOWNLIGHT


CHARGED REFLECTED CEILING PLAN - LEVEL 2 SECTOR 3




| | |
|--|-----------------------|
| Architect 1998 Certification. | Payette Job No |
| | Cadd File: |
| | Client Job No |
| | Client Dwg. No |
| A6 | |

These documents were prepared or approved by me,
a licensed engineer under the laws of the State of

A6.23

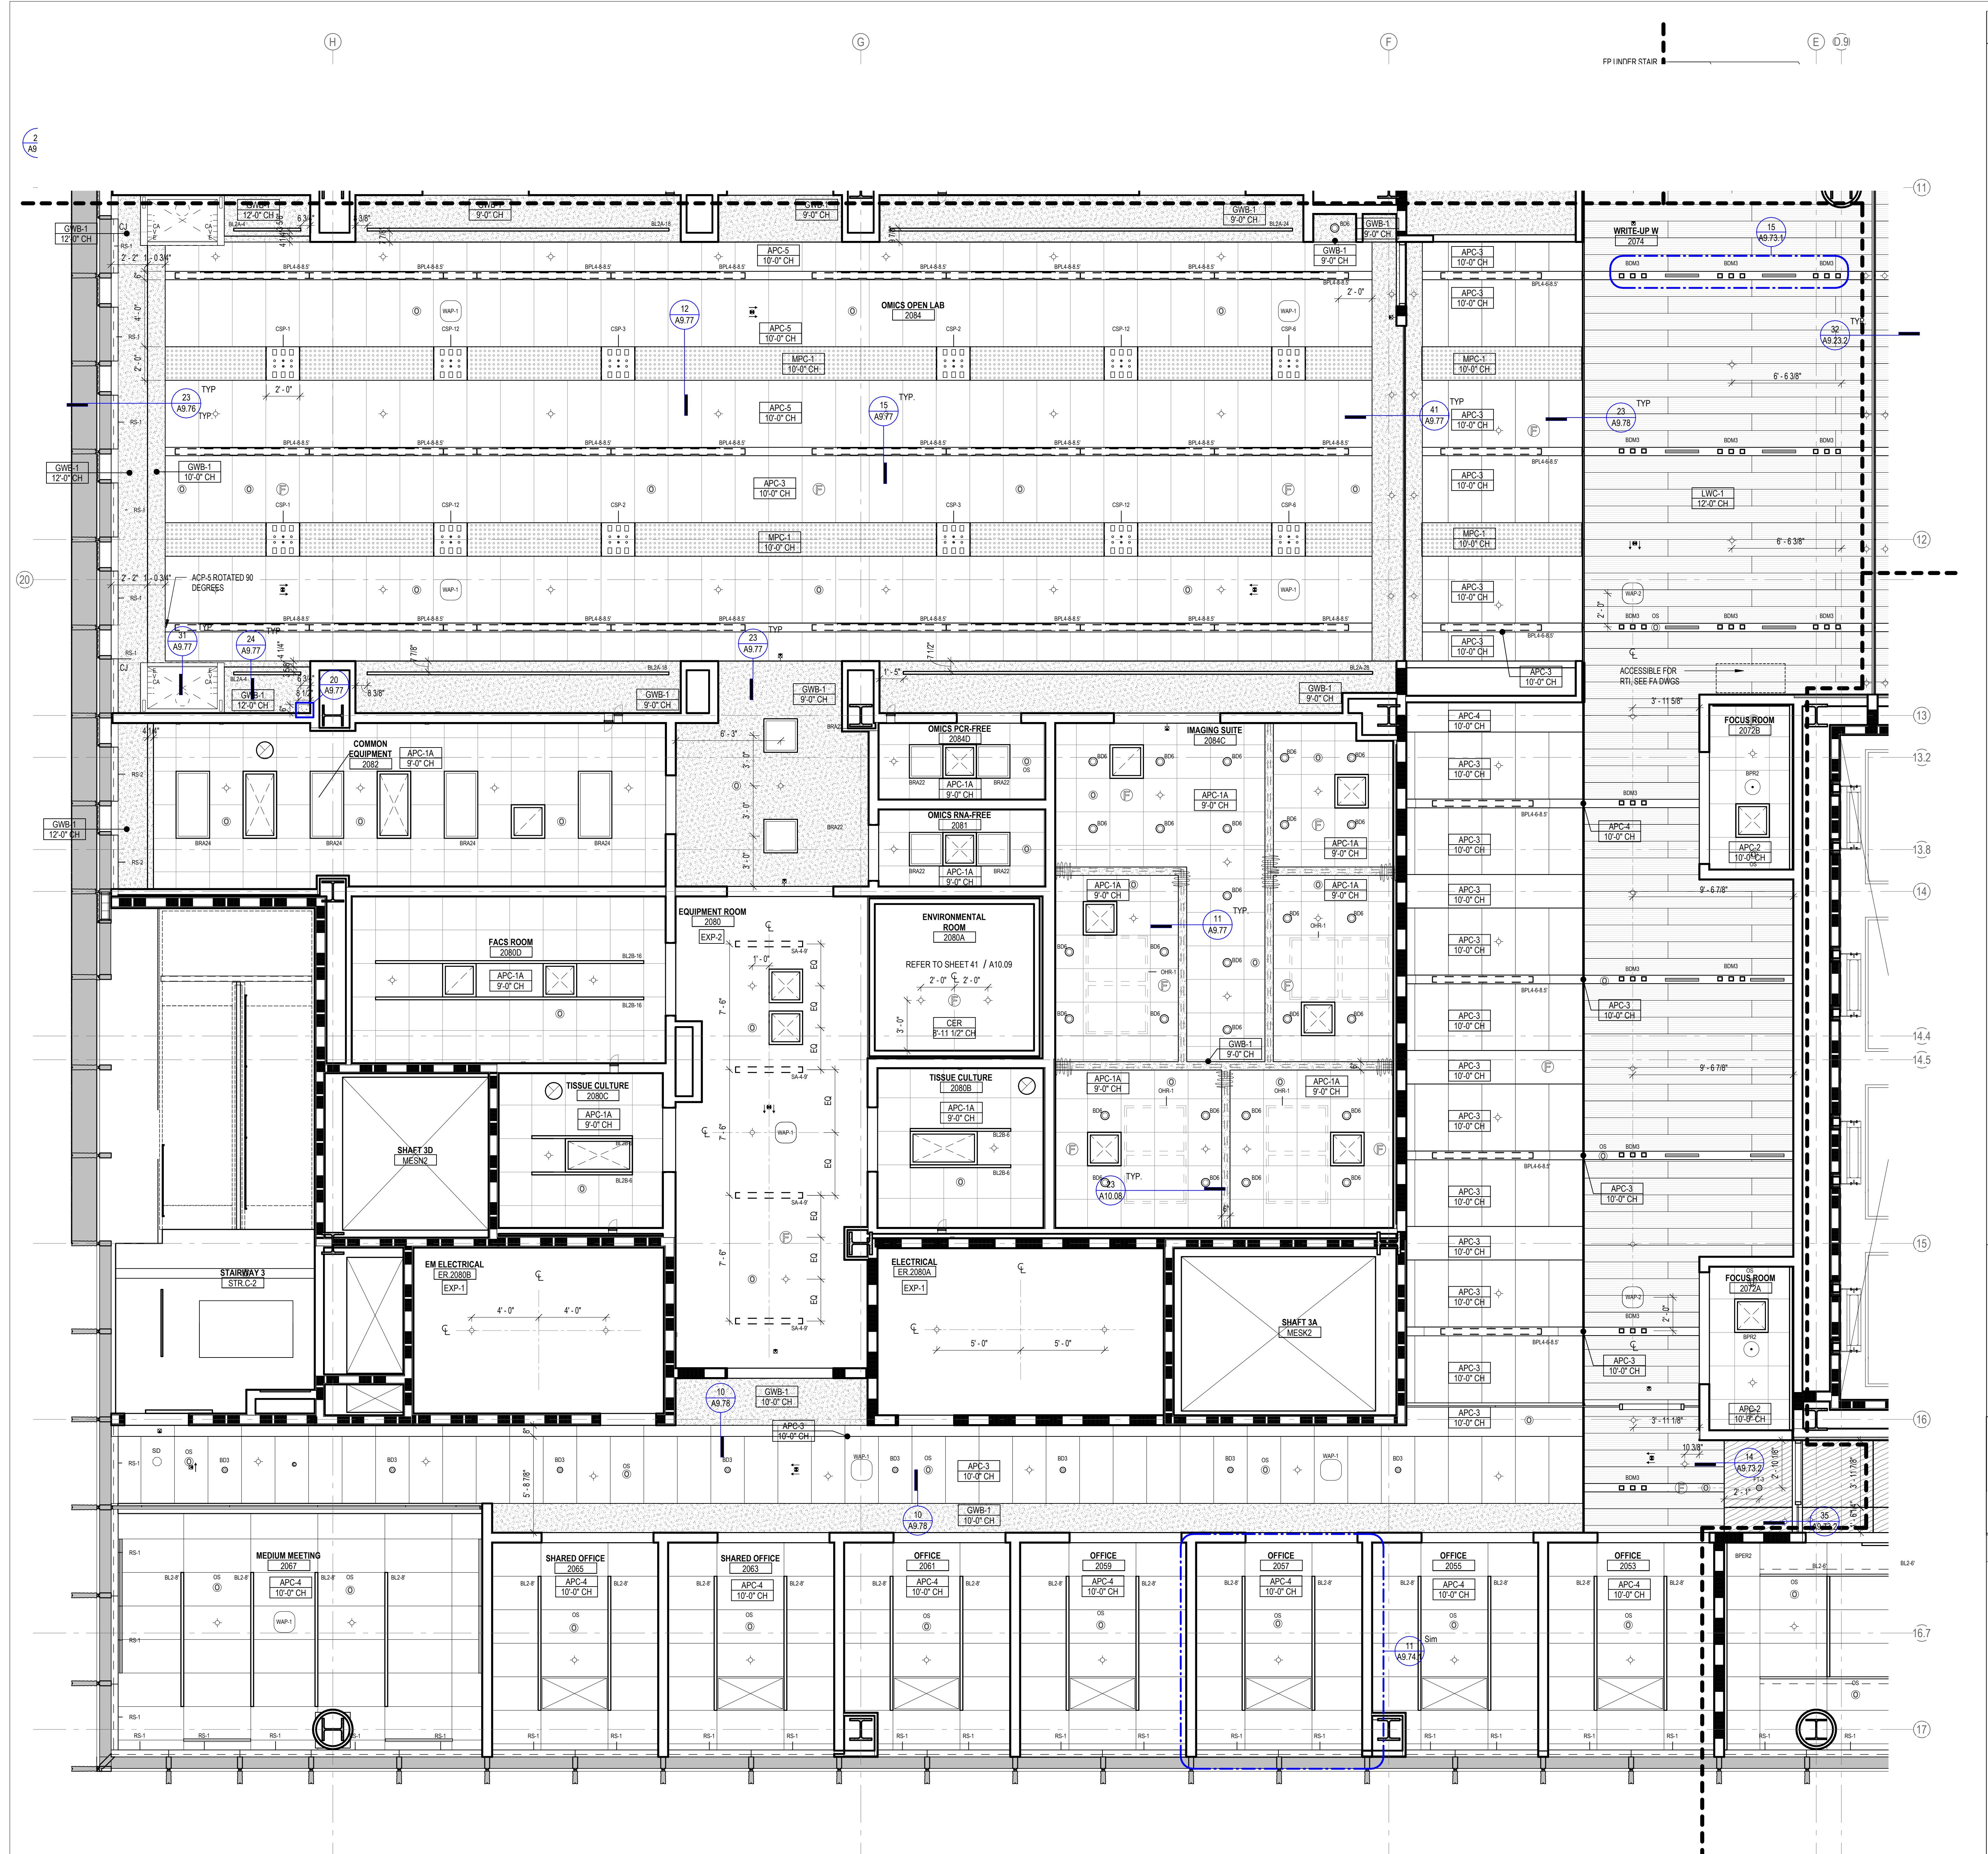


| NUMBER | DATE | DESCRIPTION | |
|---|---|-----------------------------------|--|
| | | 10/24/25 ISSUED FOR CONSTRUCTION | |
| LEGEND - CEILING PLAN | | | |
| APC-1A | ACOUSTICAL PANEL CEILING (2X2), LAB SUPPORT | | |
| APC-1B | ACOUSTICAL PANEL CEILING (2X2), DARK ROOM (BLACK) | | |
| APC-2 | ACOUSTICAL PANEL CEILING (2X2), FOCUS ROOM (HIGH NRC) | | |
| APC-3 | ACOUSTICAL PANEL CEILING (2X4), OPEN OFFICE | | |
| APC-4 | ACOUSTICAL PANEL CEILING (2X4), OFFICES, CONF. | | |
| APC-5 | ACOUSTICAL PANEL CEILING (2X4), OPEN LAB | | |
| APC-6 | ACOUSTICAL PANEL CEILING (2X2), BOH | | |
| APC-7 | ACOUSTICAL PANEL CEILING (2X2), WASHABLE, RADIOISOTYPE, FOOD SERVICE | | |
| APC-8 | ACOUSTICAL PANEL CEILING (2X2), MOISTURE RESISTANT, LOADING DOCK | | |
| APC-9 | ACOUSTICAL PANEL CEILING (2X4), SEMINAR, CONFERENCE | | |
| FRP-1 | FIBERGLASS REINFORCED CEILING PANELS | | |
| GWB-1 | GYPSUM BOARD CEILING, PAINTED | | |
| GWB-2 | GYPSUM BOARD CEILING WITH HPC | | |
| GWB-3 | GYPSUM PLASTER CEILING | | |
| EXP-1 | EXPOSED TO STRUCTURE | | |
| EXP-2 | EXPOSED TO STRUCTURE WITH PAINTED MEP, HANGERS, ACOUSTIC SPRAY COATING AT DECK | | |
| LWC-1 | LINEAR WOOD CEILING ACOUSTIC INFILL PANEL SEE A9.73.1 | | |
| LWC-2 | LINEAR WOOD CEILING WITH ACOUSTIC SPRAY COATING ABOVE SEE A9.73.1 | | |
| WPC-1 | ACOUSTICAL WOOD PANEL CEILING | | |
| MPC-1 | MICRO-PERFORATED METAL PANEL CEILING | | |
| MPC-2 | PERFORATED METAL CEILING WITH NON-COMBUSTIBLE ACOUSTIC INFILL PANEL SEE A9.72 | | |
| ST-1 | LINEAR WOOD CEILING SOFTITS | | |
| ST-2.1 | METAL PANEL SOFFIT - EXTERIOR SOFFIT POWDER COAT TO MATCH COPPER ANODIZED ALUM. | | |
| ST-2.2 | METAL PANEL SOFFIT - EXTERIOR SOFFIT POWDER COAT TO MATCH BRONZE ANODIZED ALUM. | | |
| CSP-X | CEILING MOUNTED SECURITY CAMERA, REFER TO SECURITY DWG | | |
| OHR | EXIT SIGN CEILING MOUNTED / WALL MOUNTED | | |
| (C) | CEILING MOUNTED SPRINKLERS, REFER TO PLUM. DWG | | |
| (P) / (F) | FIRE ALARM CEILING MOUNTED / WALL MOUNTED | | |
| (H) | CEILING MOUNTED HEAT DETECTOR | | |
| (SD) | CEILING MOUNTED SMOKE DETECTOR | | |
| WAP-1 | WIRELESS ACCESS POINT MOUNTED ON CEILING | | |
| WAP-2 | WIRELESS ACCESS POINT MOUNTED ABOVE CEILING | | |
| (OC) | CEILING MOUNTED OCCUPANCY/PHOTOCELL SENSOR | | |
| (X) | EXHAUST CONNECTION @ CEILING - REF. MECH. DWG'S | | |
| | LINEAR WALL WASH | | |
| KEY PLAN | | | |
| ARCHITECT | PAYETTE ASSOCIATES, INC. 290 Congress Street, Fifth Floor Boston, MA 02210 | ASSOCIATE ARCHITECT | KPN ARCHITECTS 1800 Washington Blvd, Suite 414 Baltimore, MD 21230 |
| | 617.985.1000 | | 443.662.7757 |
| CODE | CODE RED CONSULTANTS 154 Turnpike Road, Suite 200 Southborough, MA 01772 | CIVIL | RK&K 700 East Pratt Street, Suite 500 Baltimore, MD 21202 |
| | 617.500.7633 | | 410.282.2900 |
| LANDSCAPE ARCHITECT | OLIN 1617 John F. Kennedy Boulevard, Suite 1900 Philadelphia, PA 19103 | STRUCTURAL | COLUMBIA ENGINEERING, INC. 6210 Old Dobbins Lane, Suite 150 Baltimore, Maryland 21045 |
| | 215.440.0030 | | 410.992.9970 |
| VERTICAL TRANSPORTATION | ZIPIF ASSOCIATES, INC. 25 Bala Avenue, Suite 201 Bala Cynwyd, PA 19004 | MEP | BR+A CONSULTING ENGINEERS 10 Guest Street, 4th Floor Boston, MA 02135 |
| | 610.687.1717 | | 617.254.0016 |
| FIRE ALARM & FIRE PROTECTION | SETTY & ASSOCIATES 575 S. Charles Street, Suite 403 Baltimore, MD 21212 | AUDIO VISUAL & TELECOM | CONVERGE TECHNOLOGIES DESIGN GROUP 6501 York Road Baltimore, MD 21212 |
| | 667.309.6036 | | 410.532.2355 |
| SECURITY | THORNHILL TOMASETTI 1330 Connecticut Ave, NW, Suite 300 Washington, DC 20036 | FOOD SERVICE | COLBURN GUYETTE 100 Ledgewood Place, Suite 104 Rockland, MA 02370 |
| | 202.580.6300 | | 781.826.5522 |
| BUILDING ENCLOSURE | SIMPSON GUMPERTZ & HEGER 1625 Eye St NW Suite 900 Washington, DC 20006 | LEED | SUSTAINABLE DESIGN CONSULTING 1432 K Street NW, 3rd Floor Washington, DC 20005 |
| | 202.667.1620 | | 202.667.4199 |
| WIND & AIR QUALITY | RWDI 650 Woodland Rd. W. Guelph, Ontario Canada N1K 1B8 519.823.1311 | VIBRATION & ACOUSTICS | COLIN GORDON ASSOCIATES 1350 Old Bayshore Hwy, Suite 799 Burlingame, CA 94010 |
| | 415.570.0350 | | |
| LIGHTING | FISHER MARANTZ STONE 22 West 19th Street, 6th Floor New York, NY 10011 | SITE LIGHTING | TILLETT LIGHTING DESIGN ASSOCIATES 11 Hanover Square, 17th Floor New York, NY 10005 |
| | 212.691.3020 | | 212.766.0144 |
| EMI/RFI SHIELDING | VITACHEK ELECTROMAGNETICS 115 Julliad Ct., Suite 105 Fredericksburg, VA 22406 | CAMPUS UTILITIES | AEI AFFILIATED ENGINEERS 200 International Circle, Suite 5888 Hunt Valley, MD 21030 |
| | 540.286.1984 | | 410.229.0090 |
| LIFE SCIENCES BUILDING | | | |
| JOHNS HOPKINS | | | |
| UNIVERSITY | | | |
| 1800 Orleans St Baltimore, Maryland 21287 | | | |
| ENLARGED REFLECTED CEILING PLAN - LEVEL 2 - SECTOR 4 | | | |
| Seal | Date: OCTOBER 24, 2025 | Scale: As indicated | |
| | Drawn By: | Designed By: | |
| | Checked By: | Proj. Mgr.: | |
| | Payette Job No.: 17490.00 | Cadd File: | |
| | Client Job No.: J.170.24.4000 | Client Dwg. No.: | |
| | Professional Certification: | Expiration Date: 06/20/2026 | |

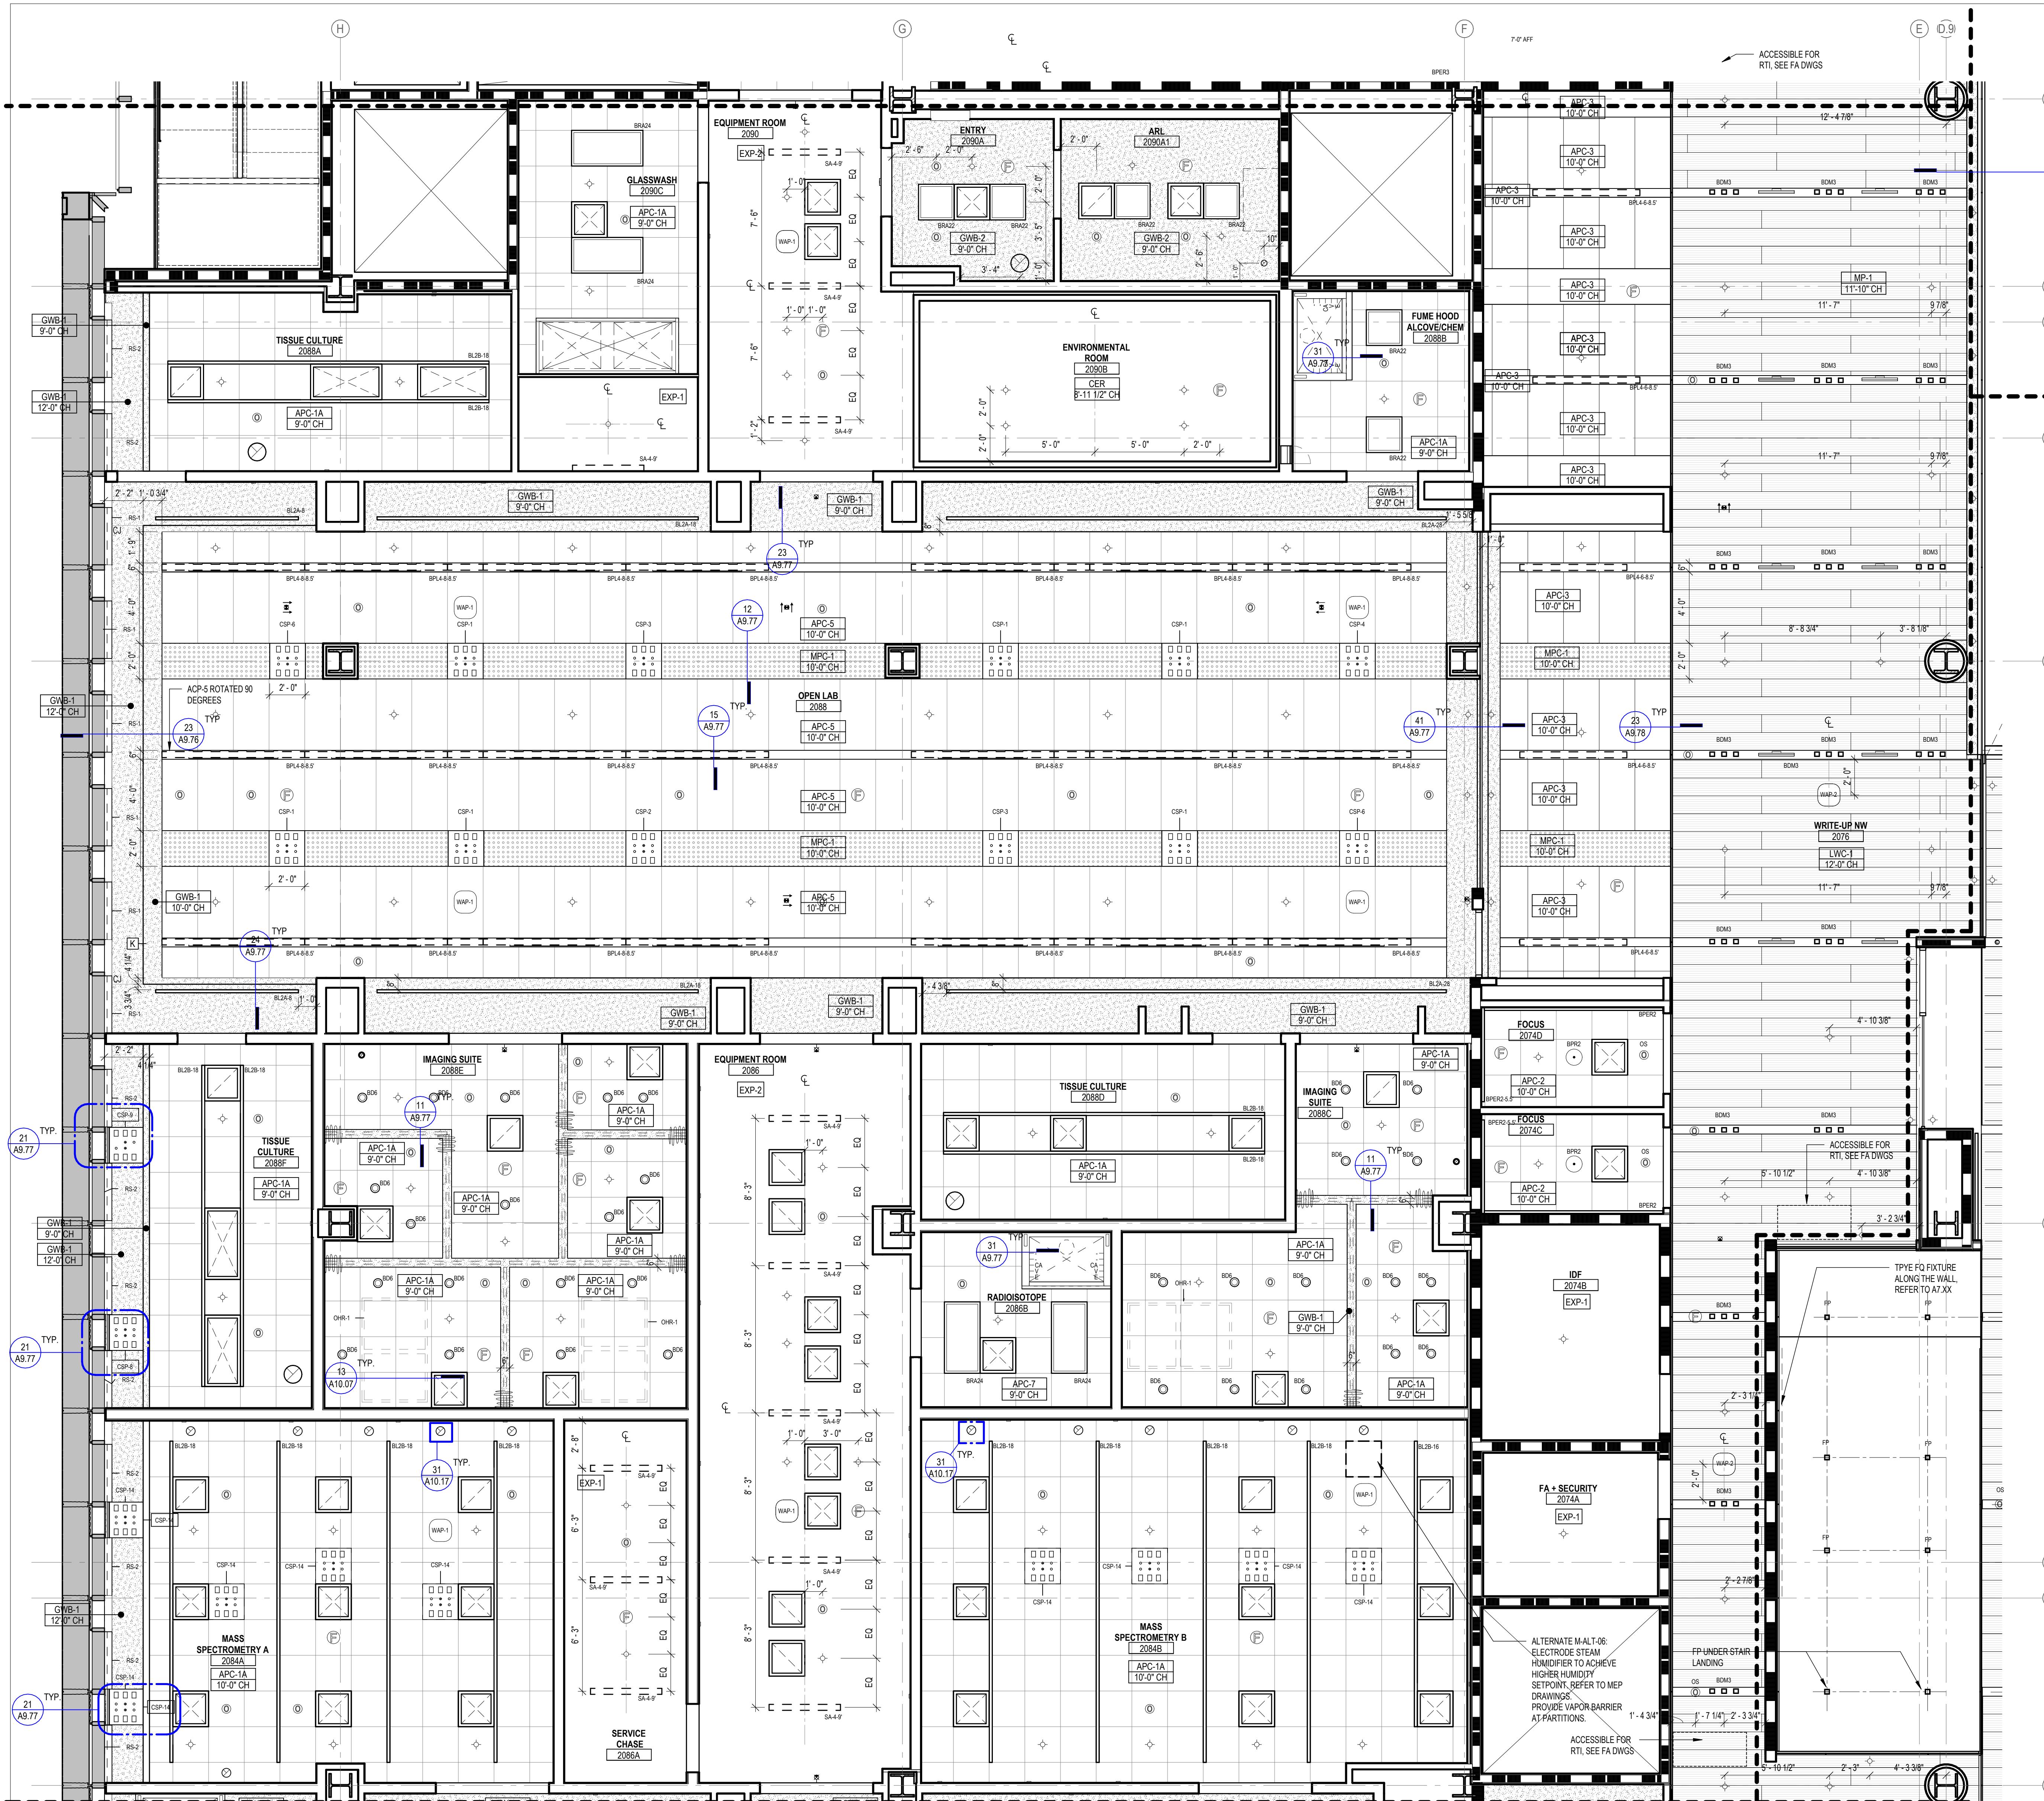

LEGEND - CEILING PLAN

| | |
|---|---|
| APC-1A | ACOUSTICAL PANEL CEILING (2X2), LAB SUPPORT |
| APC-1B | ACOUSTICAL PANEL CEILING (2X2), DARK ROOM (BLACK) |
| APC-2 | ACOUSTICAL PANEL CEILING (2X2), FOCUS ROOM (HIGH NRC) |
| APC-3 | ACOUSTICAL PANEL CEILING (2X4), OPEN OFFICE |
| APC-4 | ACOUSTICAL PANEL CEILING (2X4), OFFICES, CONF. |
| APC-5 | ACOUSTICAL PANEL CEILING (2X4), OPEN LAB |
| APC-6 | ACOUSTICAL PANEL CEILING (2X2), BOH |
| APC-7 | ACOUSTICAL PANEL CEILING (2X2), WASHABLE, RADIOSIPOSE, FOOD SERVICE |
| APC-8 | ACOUSTICAL PANEL CEILING (2X2), MOISTURE RESISTANT, LOADING DOCK |
| APC-9 | ACOUSTICAL PANEL CEILING (2X4), SEMINAR, CONFERENCE |
| FRP-1 | FIBERGLASS REINFORCED CEILING PANELS |
| GWB-1 | GYPSUM BOARD CEILING, PAINTED |
| GWB-2 | GYPSUM BOARD CEILING WITH HPC |
| GWB-3 | ACOUSTICAL PLASTER CEILING |
| EXP-1 | EXPOSED TO STRUCTURE |
| EXP-2 | EXPOSED TO STRUCTURE WITH PAINTED MEP, HANGERS, ACOUSTIC SPRAY COATING AT DECK |
| LWC-1 | LINEAR WOOD CEILING ACOUSTIC INFILL PANEL SEE A9.73.1 |
| LWC-2 | LINEAR WOOD CEILING WITH ACOUSTIC SPRAY COATING ABOVE SEE A9.73.1 |
| WPC-1 | ACOUSTICAL WOOD PANEL CEILING |
| MPC-1 | MICRO-PERFORATED METAL PANEL CEILING |
| MPC-2 | PERFORATED METAL CEILING WITH NON-COMBUSTIBLE ACOUSTIC INFILL PANEL SEE A9.72 |
| ST-1 | LINEAR WOOD CEILING SOFFITS |
| ST-2.1 | METAL PANEL SOFFIT - EXTERIOR SOFFIT POWDER COAT TO MATCH COPPER ANODIZED ALUM. |
| ST-2.2 | METAL PANEL SOFFIT - EXTERIOR SOFFIT POWDER COAT TO MATCH BRONZE ANODIZED ALUM. |
| CSP-X | CEILING SERVICE PANEL. SEE A10.05A FOR TYPES. |
| OHR | OVERHEAD SERVICE RACK, SEE A10.07 FOR DETAILS. |
| (C) | CEILING MOUNTED SECURITY CAMERA, REFER TO SECURITY DWG |
| (X) / (X) | EXIT SIGN CEILING MOUNTED / WALL MOUNTED |
| (○) | CEILING MOUNTED SPRINKLERS, REFER TO PLUM. DWG |
| (F) / (F) | FIRE ALARM CEILING MOUNTED / WALL MOUNTED |
| (○) | CEILING MOUNTED HEAT DETECTOR |
| (○) | CEILING MOUNTED SMOKE DETECTOR |
| (□) | WAP-1 WIRELESS ACCESS POINT MOUNTED ON CEILING |
| (□) | WAP-2 WIRELESS ACCESS POINT MOUNTED ABOVE CEILING |
| (○) | OC CEILING MOUNTED OCCUPANCY/PHOTOCELL SENSOR |
| (X) | EXHAUST CONNECTION @ CEILING - REF. MECH. DWG'S |
| — — | LINEAR WALL WASH |
| ROLLER SHADES: | |
| RS-1 - MOTORIZED ROLLER SHADE WITH SINGLE ROLLERS, LIGHT-FILTERING FABRIC. | |
| RS-2 - MOTORIZED ROLLER SHADE WITH DOUBLE ROLLERS, MOISTURE-RESISTANT LIGHT-FILTERING FABRIC AND MOISTURE-RESISTANT OPAQUE FABRIC. | |
| RS-3 - MOTORIZED ROLLER SHADE WITH SINGLE ROLLERS, MOISTURE-RESISTANT OPAQUE FABRIC. WITH WINDOW FRAME LIGHT BAFFLES, | |
| GENERAL NOTES: | |
| 1. FOR LIGHTING FIXTURE TYPES REFER TO LIGHTING SCHEDULE. 2. FOR SPRINKLER TYPES REFER TO FIRE PROTECTION DRAWINGS. 3. CENTER ALL DEVICES WITH TILES U.N.O 4. DEVICES IN OFFICES ARE SHOWN FOR QUANTITIES, REFER TO A9.74.1 FOR TYPICAL LAYOUT | |
| LEGEND - LIGHT FIXTURES | |
| REFER TO MEP DRAWINGS AND SPECIFICATIONS | |
| XXXX-XX-9 | LINEAR PENDANT FIXTURE SUSPENSION HEIGHT AFF Fixture Length Fixture Type |
| XXXX-XX | LINEAR RECESSED FIXTURE Fixture Length Fixture Type |
| XXX | RECESSED DOWNLIGHT Fixture Type |
| XXX | RECESSED 2X2 TROFFER Fixture Type |
| XXX | RECESSED 2X4 TROFFER Fixture Type |
| XXX | RECESSED ATRIUM DOWNLIGHT Fixture Type |
| JOHNS HOPKINS U N I V E R S I T Y 1800 Orleans St Baltimore, Maryland 21287 | |
| ENLARGED REFLECTED CEILING PLAN - LEVEL 2 - SECTOR 5 | |
| Seal | |
| Professional Certification. | |
| I certify that these documents were prepared or approved by me, and that I am duly licensed engineer under the laws of the State of Maryland. | |
| License No. 19966 Expiration Date: 06/20/2026 | |
| Date: OCTOBER 24, 2025 | |
| Scale: As indicated | |
| Drawn By: | |
| Designed By: | |
| Checked By: | |
| Proj. Mgr.: | |
| Payette Job No.: 17480.00 | |
| Cadd File: | |
| Client Job No.: J.170.24.4000 | |
| Client Dwg. No.: | |

6.25

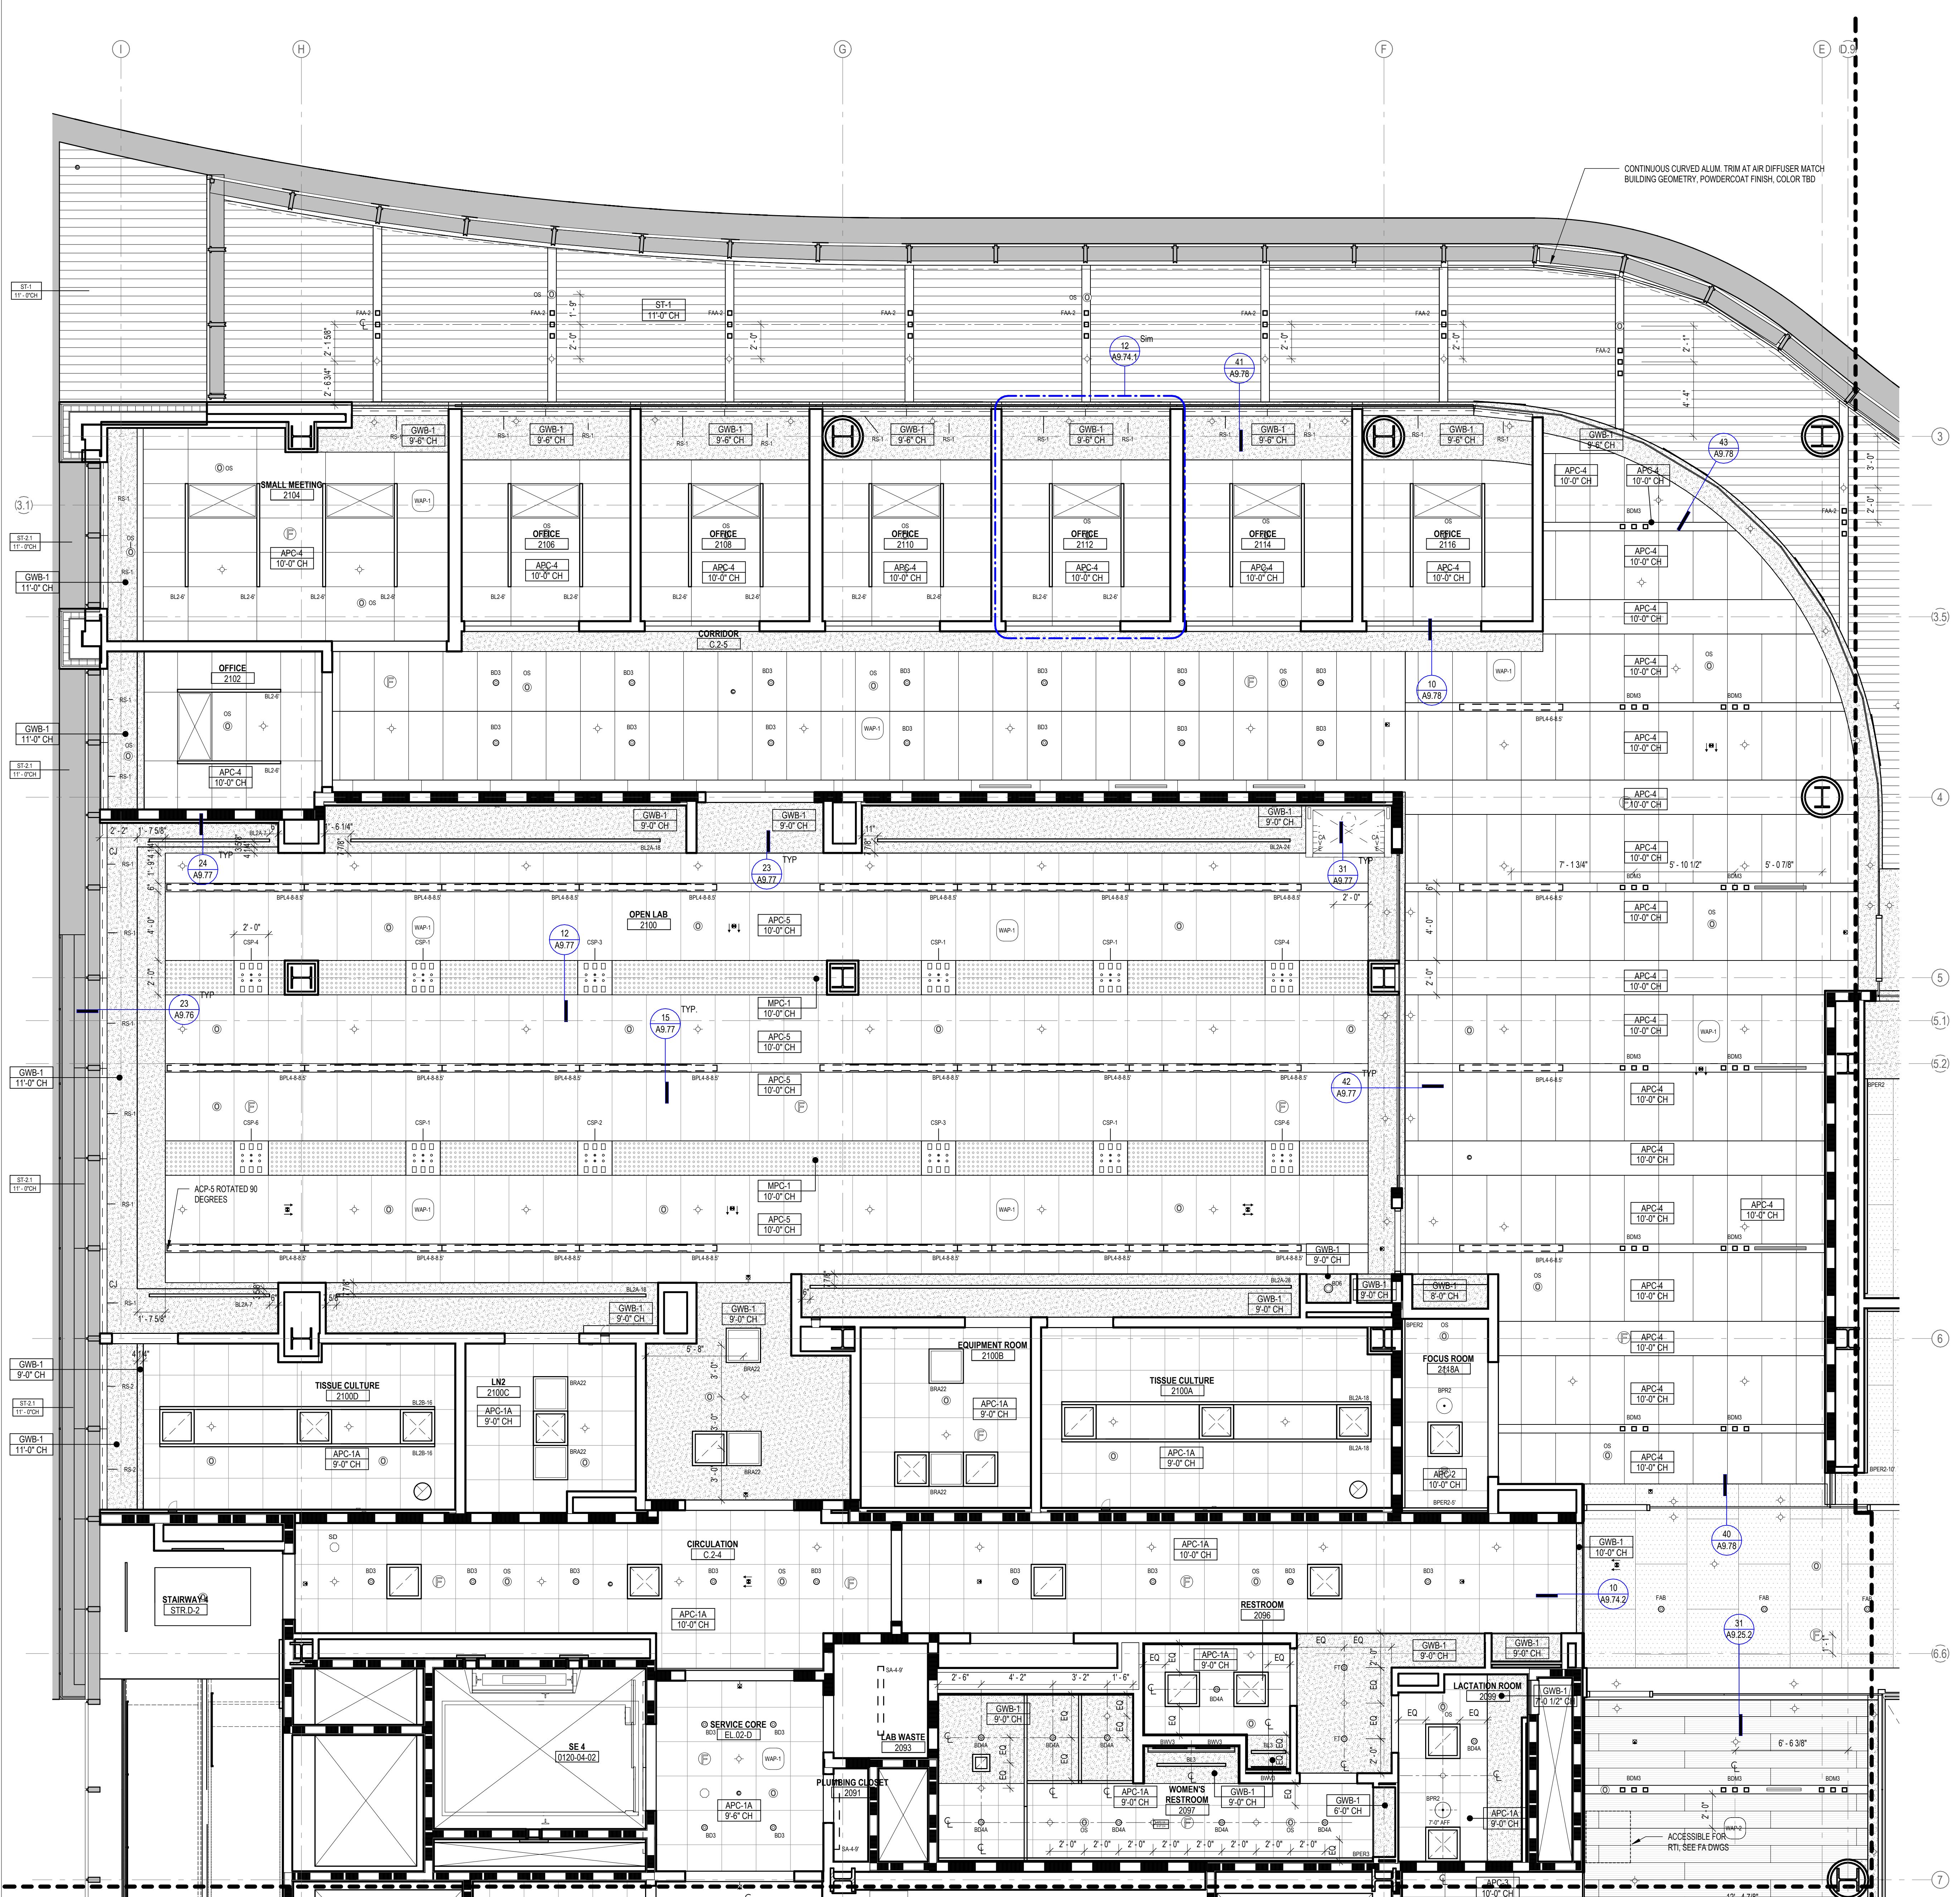

LEGEND - CEILING PLAN

| | | |
|--|--------|---|
| | APC-1A | ACOUSTICAL PANEL CEILING (2X2), LAB SUPPORT |
| | APC-1B | ACOUSTICAL PANEL CEILING (2X2), DARK ROOM (BLACK) |
| | APC-2 | ACOUSTICAL PANEL CEILING (2X2), FOCUS ROOM (HIGH NRC) |
| | APC-3 | ACOUSTICAL PANEL CEILING (2X4), OPEN OFFICE |
| | APC-4 | ACOUSTICAL PANEL CEILING (2X4), OFFICES, CONF. |
| | APC-5 | ACOUSTICAL PANEL CEILING (2X4), OPEN LAB |
| | APC-6 | ACOUSTICAL PANEL CEILING (2X2), BOH |
| | APC-7 | ACOUSTICAL PANEL CEILING (2X2), WASHABLE, RADIOISOTOPE, FOOD SERVICE |
| | APC-8 | ACOUSTICAL PANEL CEILING (2X2), MOISTURE RESISTANT, LOADING DOCK |
| | APC-9 | ACOUSTICAL PANEL CEILING (2X4), SEMINAR, CONFERENCE |
| | FRP-1 | FIBERGLASS REINFORCED CEILING PANELS |
| | GWB-1 | GYPSUM BOARD CEILING, PAINTED |
| | GWB-2 | GYPSUM BOARD CEILING WITH HPC |
| | GWB-3 | ACOUSTICAL PLASTER CEILING |
| | EXP-1 | EXPOSED TO STRUCTURE |
| | EXP-2 | EXPOSED TO STRUCTURE WITH PAINTED MEP, HANGERS, ACOUSTIC SPRAY COATING AT DECK |
| | LWC-1 | LINEAR WOOD CEILING ACOUSTIC INFILL PANEL SEE A9.73.1 |
| | LWC-2 | LINEAR WOOD CEILING WITH ACOUSTIC SPRAY COATING ABOVE SEE A9.73.1 |
| | WPC-1 | ACOUSTICAL WOOD PANEL CEILING |
| | MPC-1 | MICRO-PERFORATED METAL PANEL CEILING |
| | MPC-2 | PERFORATED METAL CEILING WITH NON-COMBUSTIBLE ACOUSTIC INFILL PANEL SEE A9.72 |
| | ST-1 | LINEAR WOOD CEILING SOFFITS |
| | ST-2.1 | METAL PANEL SOFFIT - EXTERIOR SOFFIT POWDER COAT TO MATCH COPPER ANODIZED ALUM. |
| | ST-2.2 | METAL PANEL SOFFIT - EXTERIOR SOFFIT POWDER COAT TO MATCH BRONZE ANODIZED ALUM. |
| | CSP-X | CEILING SERVICE PANEL. SEE A10.05A FOR TYPES. |
| | OHR | OVERHEAD SERVICE RACK, SEE A10.07 FOR DETAILS. |
| | C | CEILING MOUNTED SECURITY CAMERA, REFER TO SECURITY DWG |
| | | EXIT SIGN CEILING MOUNTED / WALL MOUNTED |
| | | CEILING MOUNTED SPRINKLERS, REFER TO PLUM. DWG |
| | F | FIRE ALARM CEILING MOUNTED / WALL MOUNTED |
| | H | CEILING MOUNTED HEAT DETECTOR |
| | SD | CEILING MOUNTED SMOKE DETECTOR |
| | WAP-1 | WIRELESS ACCESS POINT MOUNTED ON CEILING |
| | WAP-2 | WIRELESS ACCESS POINT MOUNTED ABOVE CEILING |
| | OC | CEILING MOUNTED OCCUPANCY/PHOTOCELL SENSOR |
| | | EXHAUST CONNECTION @ CEILING - REF. MECH. DWG'S |
| | | LINEAR WALL WASH |

A6.26