

LEGEND - CEILING PLAN		NUMBER	DATE	DESCRIPTION
	APC-1A	ACOUSTICAL PANEL CEILING (2X2), LAB SUPPORT		10/24/25 ISSUED FOR CONSTRUCTION
	APC-1B	ACOUSTICAL PANEL CEILING (2X2), DARK ROOM (BLACK)		
	APC-2	ACOUSTICAL PANEL CEILING (2X2), FOCUS ROOM (HIGH NRC)		
	APC-3	ACOUSTICAL PANEL CEILING (2X4), OPEN OFFICE		
	APC-4	ACOUSTICAL PANEL CEILING (2X4), OFFICES, CONF.		
	APC-5	ACOUSTICAL PANEL CEILING (2X4), OPEN LAB		
	APC-6	ACOUSTICAL PANEL CEILING (2X2), BOH		
	APC-7	ACOUSTICAL PANEL CEILING (2X2), WASHABLE, RADIOISOTOPE, FOOD SERVICE		
	APC-8	ACOUSTICAL PANEL CEILING (2X2), MOISTURE RESISTANT, LOADING DOCK		
	APC-9	ACOUSTICAL PANEL CEILING (2X4), SEMINAR, CONFERENCE		
	FRP-1	FIBERGLASS REINFORCED CEILING PANELS		
	GWB-1	GYPSUM BOARD CEILING, PAINTED		
	GWB-2	GYPSUM BOARD CEILING WITH HPC		
	GWB-3	ACOUSTICAL PLASTER CEILING		
	EXP-1	EXPOSED TO STRUCTURE		
	EXP-2	EXPOSED TO STRUCTURE WITH PAINTED MEP, HANGERS, ACOUSTIC SPRAY COATING AT DECK		
	LWC-1	LINEAR WOOD CEILING ACOUSTIC INFILL PANEL SEE A9.73.1		
	LWC-2	LINEAR WOOD CEILING WITH ACOUSTIC SPRAY COATING ABOVE SEE A9.73.1		
	WPC-1	ACOUSTICAL WOOD PANEL CEILING		
	MPC-1	MICRO-PERFORATED METAL PANEL CEILING		
	MPC-2	PERFORATED METAL CEILING WITH NON-COMBUSTIBLE ACOUSTIC INFILL PANEL SEE A9.72		
	ST-1	LINEAR WOOD CEILING SOFFITS		
	ST-2.1	METAL PANEL SOFFIT - EXTERIOR SOFFIT POWDER COAT TO MATCH COPPER ANODIZED ALUM.		
	ST-2.2	METAL PANEL SOFFIT - EXTERIOR SOFFIT POWDER COAT TO MATCH BRONZE ANODIZED ALUM.		
	CSP-X	CEILING SERVICE PANEL. SEE A10.05A FOR TYPES.		
	OHR	OVERHEAD SERVICE RACK, SEE A10.07 FOR DETAILS.		
	C	CEILING MOUNTED SECURITY CAMERA, REFER TO SECURITY DWG		
		EXIT SIGN CEILING MOUNTED / WALL MOUNTED		
		CEILING MOUNTED SPRINKLERS, REFER TO PLUM. DWG		
	F	FIRE ALARM CEILING MOUNTED / WALL MOUNTED		
	H	CEILING MOUNTED HEAT DETECTOR		
	SD	CEILING MOUNTED SMOKE DETECTOR		
	WAP-1	WIRELESS ACCESS POINT MOUNTED ON CEILING		
	WAP-2	WIRELESS ACCESS POINT MOUNTED ABOVE CEILING		
	OC	CEILING MOUNTED OCCUPANCY/PHOTOCELL SENSOR		
		EXHAUST CONNECTION @ CEILING - REF. MECH. DWG'S		
		LINEAR WALL WASH		
<b>ROLLER SHADES:</b>				
RS-1 - MOTORIZED ROLLER SHADE WITH SINGLE ROLLERS, LIGHT-FILTERING FABRIC.				
RS-2 - MOTORIZED ROLLER SHADE WITH DOUBLE ROLLERS, MOISTURE-RESISTANT LIGHT-FILTERING FABRIC AND MOISTURE-RESISTANT OPAQUE FABRIC.				
RS-3 - MOTORIZED ROLLER SHADE WITH SINGLE ROLLERS, MOISTURE-RESISTANT OPAQUE FABRIC. WITH WINDOW FRAME LIGHT BAFFLES,				
<b>GENERAL NOTES:</b>				
1. FOR LIGHTING FIXTURE TYPES REFER TO LIGHTING SCHEDULE. 2. FOR SPRINKLER TYPES REFER TO FIRE PROTECTION DRAWINGS. 3. CENTER ALL DEVICES WITH TILES U.N.O 4. DEVICES IN OFFICES ARE SHOWN FOR QUANTITIES, REFER TO A9.74.1 FOR TYPICAL LAYOUT				
<b>LEGEND - LIGHT FIXTURES</b>				
REFER TO MEP DRAWINGS AND SPECIFICATIONS				
	LINEAR PENDANT FIXTURE			
	LINEAR RECESSED FIXTURE			
	RECESSED DOWNLIGHT			
	RECESSED 2X2 TROFFER			
	RECESSED 2X4 TROFFER			
	RECESSED ATRIUM DOWNLIGHT			
<b>LIFE SCIENCES BUILDING</b> 600 N Broadway Baltimore, MD 21205				
<b>JOHNS HOPKINS</b> UNIVERSITY 1800 Orleans St Baltimore, Maryland 21287				
<b>ENLARGED REFLECTED CEILING PLAN - LEVEL 7 - SECTOR 1</b>				
Seal		Date: OCTOBER 24, 2025		
		Scale: As indicated		
		Drawn By:		
		Designed By:		
		Checked By:		
		Proj. Mgr.:		
		Payette Job No.: 17480.00		
		Cadd File:		
		Client Job No.: J.170.24.4000		
		Client Dwg. No.:		
<b>A6.71</b>				

A6.71

LEGEND - CEILING PLAN			NUMBER	DATE	DESCRIPTION
			10/24/25	ISSUED FOR CONSTRUCTION	
APC-1A	ACOUSTICAL PANEL CEILING (2X), LAB SUPPORT				
APC-1B	ACOUSTICAL PANEL CEILING (2X), DARK ROOM (BLACK)				
APC-2	ACOUSTICAL PANEL CEILING (2X), FOCUS ROOM (HIGH NRC)				
APC-3	ACOUSTICAL PANEL CEILING (2X), OPEN OFFICE				
APC-4	ACOUSTICAL PANEL CEILING (2X), OFFICES, CONF.				
APC-5	ACOUSTICAL PANEL CEILING (2X), OPEN LAB				
APC-6	ACOUSTICAL PANEL CEILING (2X), BOH				
APC-7	ACOUSTICAL PANEL CEILING (2X), WASHABLE, RADIOSPOTCE, FOOD SERVICE				
APC-8	ACOUSTICAL PANEL CEILING (2X), MOISTURE RESISTANT, LOADING DOCK				
APC-9	ACOUSTICAL PANEL CEILING (2X), SEMINAR, CONFERENCE				
FRP-1	FIBERGLASS REINFORCED CEILING PANELS				
GWB-1	GYPSUM BOARD CEILING, PAINTED				
GWB-2	GYPSUM BOARD CEILING WITH HPC				
GWB-3	ACOUSTICAL PLASTER CEILING				
EXP-1	EXPOSED TO STRUCTURE				
EXP-2	EXPOSED TO STRUCTURE WITH PAINTED MEP, HANGERS, ACOUSTIC SPRAY COATING AT DECK				
LWC-1	LINEAR WOOD CEILING ACOUSTIC INFILL PANEL SEE A9.7.1				
LWC-2	LINEAR WOOD CEILING WITH ACOUSTIC SPRAY COATING ABOVE SEE A9.7.1				
WPC-1	ACOUSTICAL WOOD PANEL CEILING				
MPC-1	MICRO-PERFORATED METAL PANEL CEILING				
MPC-2	PERFORATED METAL CEILING WITH NON-COMBUSTIBLE ACOUSTIC INFILL PANEL SEE A9.7.2				
ST-1	LINEAR WOOD CEILING SOFFITS				
ST-2.1	METAL PANEL SOFFIT - EXTERIOR SOFFIT POWDER COAT TO MATCH COPPER ANODIZED ALUM.				
ST-2.2	METAL PANEL SOFFIT - EXTERIOR SOFFIT POWDER COAT TO MATCH BRONZE ANODIZED ALUM.				
CSP-X	CEILING SERVICE PANEL SEE A10.05A FOR TYPES				
OHR	OVERHEAD SERVICE RACK, SEE A10.07 FOR DETAILS.				
(C)	CEILING MOUNTED SECURITY CAMERA, REFER TO SECURITY DWG				
	EXIT SIGN CEILING MOUNTED / WALL MOUNTED				
	CEILING MOUNTED SPRINKLERS, REFER TO PLUM. DWG				
	FIRE ALARM CEILING MOUNTED / WALL MOUNTED				
H	CEILING MOUNTED HEAT DETECTOR				
SD	CEILING MOUNTED SMOKE DETECTOR				
WAP-1	WIRELESS ACCESS POINT MOUNTED ON CEILING				
WAP-2	WIRELESS ACCESS POINT MOUNTED ABOVE CEILING				
OC	CEILING MOUNTED OCCUPANCY/PHOTOCELL SENSOR				
	EXHAUST CONNECTION @ CEILING - REF. MECH. DWGS				
	LINEAR WALL WASH				
<b>ROLLER SHADES:</b>					
RS-1	MOTORIZED ROLLER SHADE WITH SINGLE ROLLERS, LIGHT-FILTERING FABRIC.				
RS-2	MOTORIZED ROLLER SHADE WITH DOUBLE ROLLERS, MOISTURE-RESISTANT LIGHT-FILTERING FABRIC AND MOISTURE-RESISTANT OPAQUE FABRIC.				
RS-3	MOTORIZED ROLLER SHADE WITH SINGLE ROLLERS, MOISTURE-RESISTANT OPAQUE FABRIC, WITH WINDOW FRAME LIGHT BAFFLES.				
<b>GENERAL NOTES:</b>					
1.	FOR LIGHTING FIXTURE TYPES REFER TO LIGHTING SCHEDULE.				
2.	FOR SPRINKLER TYPES REFER TO FIRE PROTECTION DRAWINGS.				
3.	CENTER ALL DEVICES WITH TILES U.N.O.				
4.	DEVICES IN OFFICES ARE SHOWN FOR QUANTITIES, REFER TO A9.7.1 FOR TYPICAL LAYOUT.				
<b>LEGEND - LIGHT FIXTURES</b>					
REFER TO MEP DRAWINGS AND SPECIFICATIONS					
XXXXXX	LINEAR PENDANT FIXTURE				
XXX	SUSPENSION HEIGHT AFF				
XXX	Fixture Length				
XXX	Fixture Type				
XXXXXX	LINEAR RECESSED FIXTURE				
XXX	Fixture Length				
XXX	Fixture Type				
XXX	RECESSED DOWNLIGHT				
XXX	Fixture Type				
XXX	RECESSED 2X2 TROFFER				
XXX	Fixture Type				
XXX	RECESSED 2X4 TROFFER				
XXX	Fixture Type				
XXX	RECESSED ATRIUM DOWNLIGHT				
XXX	Fixture Type				
<b>JOHNS HOPKINS UNIVERSITY</b>					
1800 Orleans St Baltimore, Maryland 21287					
<b>ENLARGED REFLECTED CEILING PLAN - LEVEL 7 - SECTOR 2</b>					
Seal	Date: OCTOBER 24, 2025				
	Scale: As indicated				
	Drawn By:				
	Designed By:				
	Checked By:				
	Proj. Mgr.:				
	Payette Job No.: 1748.00				
	Cadd File:				
	Client Job No.: J.170.24.4000				
	Client Dwg. No.:				
	Professional Certification:				
	I certify that these documents were prepared or approved by me, and that I am duly licensed engineer under the laws of the State of Maryland.				
	License No. 9986 Expiration Date: 06/20/2026				

2

## KEY PLAN

**ARCHITECT**  
PAYETTE ASSOCIATES, INC.  
290 Congress Street, Fifth Floor  
Boston, MA 02210  
617.695.1000

**CODE**  
CODE RED CONSULTANTS  
154 Turnpike Road, Suite 200  
Southborough, MA 01772  
617.500.7633

**CIVIL**  
RK&K  
700 East Pratt Street, Suite 500  
Baltimore, MD 21202  
410.288.2900

**LANDSCAPE ARCHITECT**  
OLIN  
1617 John F. Kennedy Boulevard,  
Suite 1900  
Philadelphia, PA 19103  
215.440.0030

**STRUCTURAL**

COLUMBIA ENGINEERING, INC.

6210 Old Dobbin Lane, Suite 150  
Baltimore, Maryland 21045  
410.992.9970

**VERTICAL TRANSPORTATION**

ZIPIF ASSOCIATES, INC.

25 Bala Avenue, Suite 201  
Bala Cynwyd, PA 19004  
610.687.1717

**MEP**

BR+A CONSULTING ENGINEERS

10 Guest Street, 4th Floor  
Boston, MA 02135  
617.254.0016

**FIRE ALARM & FIRE PROTECTION**

SETTY & ASSOCIATES

575 S. Charles Street, Suite 403  
Baltimore, MD 21201  
667.309.6036

**AUDIO VISUAL & TELECOM**

CONVERGENT TECHNOLOGIES

DESIGN GROUP

6501 York Road

Baltimore, MD 21212  
410.539.2355

**SECURITY**

THORNITAN TOMASETTI

1330 Connecticut Ave, NW,  
Suite 300

Washington, DC 20036  
202.580.6300

**FOOD SERVICE**

COLBURN GUYETTE

100 Ledgewood Place, Suite 104

Rockland, MA 02370  
781.826.5522

**LEED**

SUSTAINABLE DESIGN

CONSULTING

1432 K Street NW, 3rd Floor

Washington, DC 20006  
202.667.1620

**VIBRATION & ACOUSTICS**

COLIN GORDON ASSOCIATES

1350 Old Bayshore Hwy, Suite 799

Burlingame, CA 94010  
415.570.0350

**LIGHTING**

FISHER MARANTZ STONE

22 West 19th Street, 6th Floor

New York, NY 10011  
212.691.3020

**EMI/RFI SHIELDING**

VITACHEK ELECTROMAGNETICS

115 Julian Ct., Suite 105

Fredericksburg, VA 22406  
540.286.1984

**CAMPUS UTILITIES**

AEI AFFILIATED ENGINEERS

200 International Circle, Suite 588

Hunt Valley, MD 21030  
410.229.0090

## LIFE SCIENCES BUILDING

600 N Broadway  
Baltimore, MD 21205

**JOHNS HOPKINS**  
U N I V E R S I T Y

1800 Orleans St  
Baltimore, Maryland 21287

**ENLARGED REFLECTED CEILING PLAN - LEVEL 7 - SECTOR 2**

Seal

Date: OCTOBER 24, 2025

Scale: As indicated

Drawn By:

Designed By:

Checked By:

Proj. Mgr.:

Payette Job No.: 1748.00

Cadd File:

Client Job No.: J.170.24.4000


Client Dwg. No.:

Professional Certification:

I certify that these documents were prepared or approved by me, and that I am duly licensed engineer under the laws of the State of Maryland.

License No. 9986 Expiration Date: 06/20/2026

A6.72

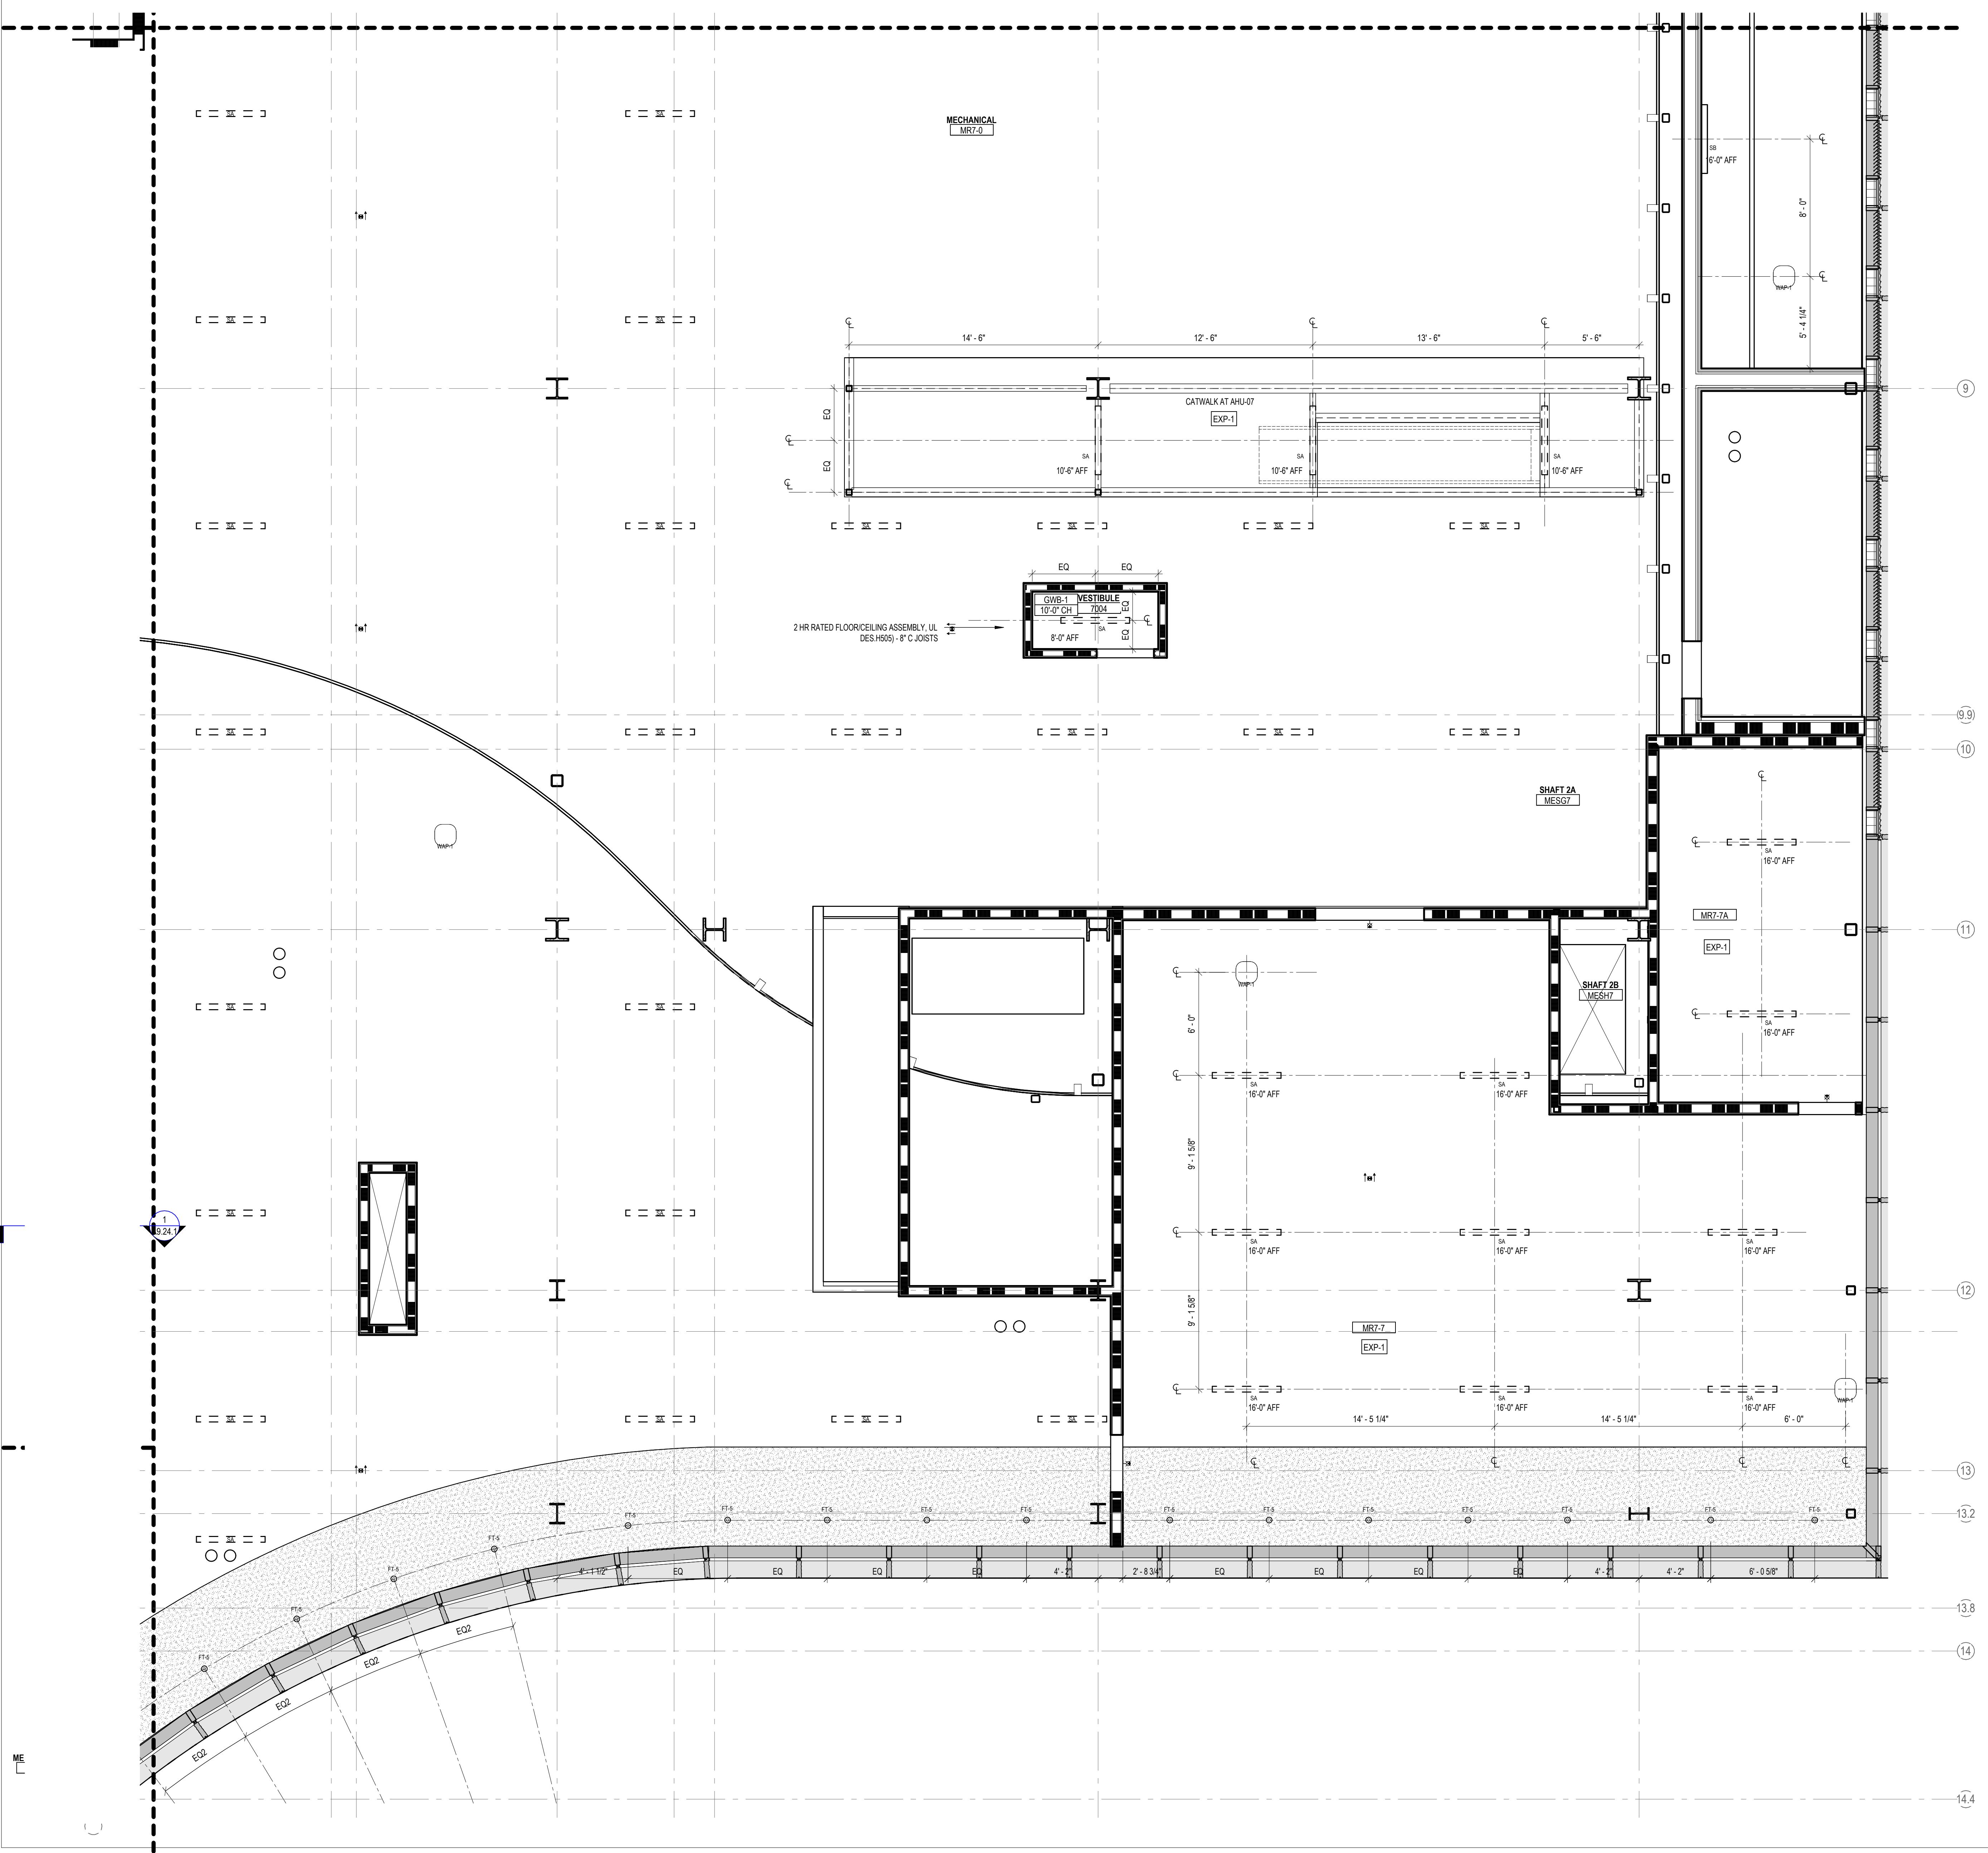

## **LEGEND - CEILING PLAN**

	APC-1A	ACOUSTICAL PANEL CEILING (2X2), LAB SUPPORT
	APC-1B	ACOUSTICAL PANEL CEILING (2X2), DARK ROOM (BLACK)
	APC-2	ACOUSTICAL PANEL CEILING (2X2), FOCUS ROOM (HIGH NRC)
	APC-3	ACOUSTICAL PANEL CEILING (2X4), OPEN OFFICE
	APC-4	ACOUSTICAL PANEL CEILING (2X4), OFFICES, CONF.
	APC-5	ACOUSTICAL PANEL CEILING (2X4), OPEN LAB
	APC-6	ACOUSTICAL PANEL CEILING (2X2), BOH
	APC-7	ACOUSTICAL PANEL CEILING (2X2), WASHABLE, RADIOISOTOPE, FOOD SERVICE
	APC-8	ACOUSTICAL PANEL CEILING (2X2), MOISTURE RESISTANT, LOADING DOCK
	APC-9	ACOUSTICAL PANEL CEILING (2X4), SEMINAR, CONFERENCE
	FRP-1	FIBERGLASS REINFORCED CEILING PANELS
	GWB-1	GYPSUM BOARD CEILING, PAINTED
	GWB-2	GYPSUM BOARD CEILING WITH HPC
	GWB-3	ACOUSTICAL PLASTER CEILING
	EXP-1	EXPOSED TO STRUCTURE
	EXP-2	EXPOSED TO STRUCTURE WITH PAINTED MEP, HANGERS, ACOUSTIC SPRAY COATING AT DECK
	LWC-1	LINEAR WOOD CEILING ACOUSTIC INFILL PANEL SEE A9.73.1
	LWC-2	LINEAR WOOD CEILING WITH ACOUSTIC SPRAY COATING ABOVE SEE A9.73.1
	WPC-1	ACOUSTICAL WOOD PANEL CEILING
	MPC-1	MICRO-PERFORATED METAL PANEL CEILING
	MPC-2	PERFORATED METAL CEILING WITH NON-COMBUSTIBLE ACOUSTIC INFILL PANEL SEE A9.72
	ST-1	LINEAR WOOD CEILING SOFFITS
	ST-2.1	METAL PANEL SOFFIT - EXTERIOR SOFFIT POWDER COAT TO MATCH COPPER ANODIZED ALUM.
	ST-2.2	METAL PANEL SOFFIT - EXTERIOR SOFFIT POWDER COAT TO MATCH BRONZE ANODIZED ALUM.
	CSP-X	CEILING SERVICE PANEL. SEE A10.05A FOR TYPES.
	OHR	OVERHEAD SERVICE RACK, SEE A10.07 FOR DETAILS.
	C	CEILING MOUNTED SECURITY CAMERA, REFER TO SECURITY DWG
		EXIT SIGN CEILING MOUNTED / WALL MOUNTED

**ARCHITECT** AS

**ARCHITECT**  
AYETTE ASSOCIATES, INC.  
10 Congress Street, Fifth Floor  
Boston, MA 02210  
617.895.1000

**ASSOCIATE ARCHITECT**  
KPN ARCHITECTS  
1800 Washington Blvd, Suite 414  
Baltimore, MD 21230  
443.682.7757

<b>CODE</b> CODE RED CONSULTANTS 54 Turnpike Road, Suite 200 Southborough, MA 01772 617.500.7633	<b>CIVIL</b> RK&K 700 East Pratt Street, Suite 500 Baltimore, MD 21202 410.728.2900
--	---

**LANDSCAPE ARCHITECT**  
OLIN  
7 John F. Kennedy Boulevard,  
Suite 1900  
Philadelphia, PA 19103  
215.442.0020

**STRUCTURAL**  
COLUMBIA ENGINEERING, INC.  
6210 Old Dobbin Lane, Suite 150  
Baltimore, Maryland 21045  
410.992.9970

**RTICAL TRANSPORTATION**  
ZIPF ASSOCIATES, INC.  
25 Bala Avenue, Suite 201  
Bala Cynwyd, PA 19004  
610.667.1717

**MEP**  
BR+A CONSULTING ENGINEERS  
10 Guest Street, 4th Floor  
Boston, MA 02135  
617.254.0016

**ALARM & FIRE PROTECTION**  
SETTY & ASSOCIATES  
5 S. Charles Street, Suite 403  
Baltimore, MD 21201  
667.309.6036

**AUDIO VISUAL & TELECOM**  
CONVERGENT TECHNOLOGIES  
DESIGN GROUP  
6501 York Road  
Baltimore, MD 21212  
410.532.2395

<b>SECURITY</b> THORNTON TOMASETTI 1330 Connecticut Ave, NW,	<b>FOOD SERVICE</b> COLBURN GUYETTE 100 Lodgewood Place, Suite 104
--	--

Suite 300  
Washington, DC 20036  
202.580.6300

Rockland, MA 02370  
781.826.5522

**BUILDING ENCLOSURE**  
PSON GUMPERTZ & HEGER  
1625 Eye St NW  
Suite 900  
Washington, DC 20006

**LEED**  
**SUSTAINABLE DESIGN**  
**CONSULTING**  
1432 K Street NW, 3rd Floor  
Washington, DC 20005

**WIND & AIR QUALITY**  
RWDI  
650 Woodland Rd.  
W. Guelph, Ontario  
Canada N1K 1B8

**VIBRATION & ACOUSTICS**  
COLIN GORDON ASSOCIATES  
1350 Old Bayshore Hwy, Suite 799  
Burlingame, CA 94010  
415.570.0350

**LIGHTING**  
FISHER MARANTZ STONE  
2 West 19th Street, 6th Floor  
New York, NY 10011  
212.691.3020

**SITE LIGHTING**  
TILLETT LIGHTING DESIGN  
ASSOCIATES  
11 Hanover Square, 17th Floor  
New York, NY 10005

**EMI/RFI (SHEILDING)**  
ATECH ELECTROMAGNETICS  
115 Juliad Ct., Suite 105  
Fredericksburg, VA 22406  
540.286.1984

**CAMPUS UTILITIES**  
AEI AFFILIATED ENGINEERS  
200 International Circle, Suite 5888  
Hunt Valley, MD 21030  
410.329.2222

# LIFE SCIENCES BUILDING

Baltimore, MD 21205


---

OTIS HOPKINS  
N I V E R S I T Y


# LARGED REFLECTED CEILING PLAN - LEVEL 7 - SECTOR 3







	Date:	OCTOBER 24, 2025
	Scale:	As indicated
	Drawn By:	
	Designed By:	
	Checked By:	
	Proj. Mgr.:	
	Payette Job No.:	17480.00
	Cadd File:	
Client Job No.:	J.170.24.4000	
Client Dwg. No.:		
<b>A6.73</b>		

# A6.73

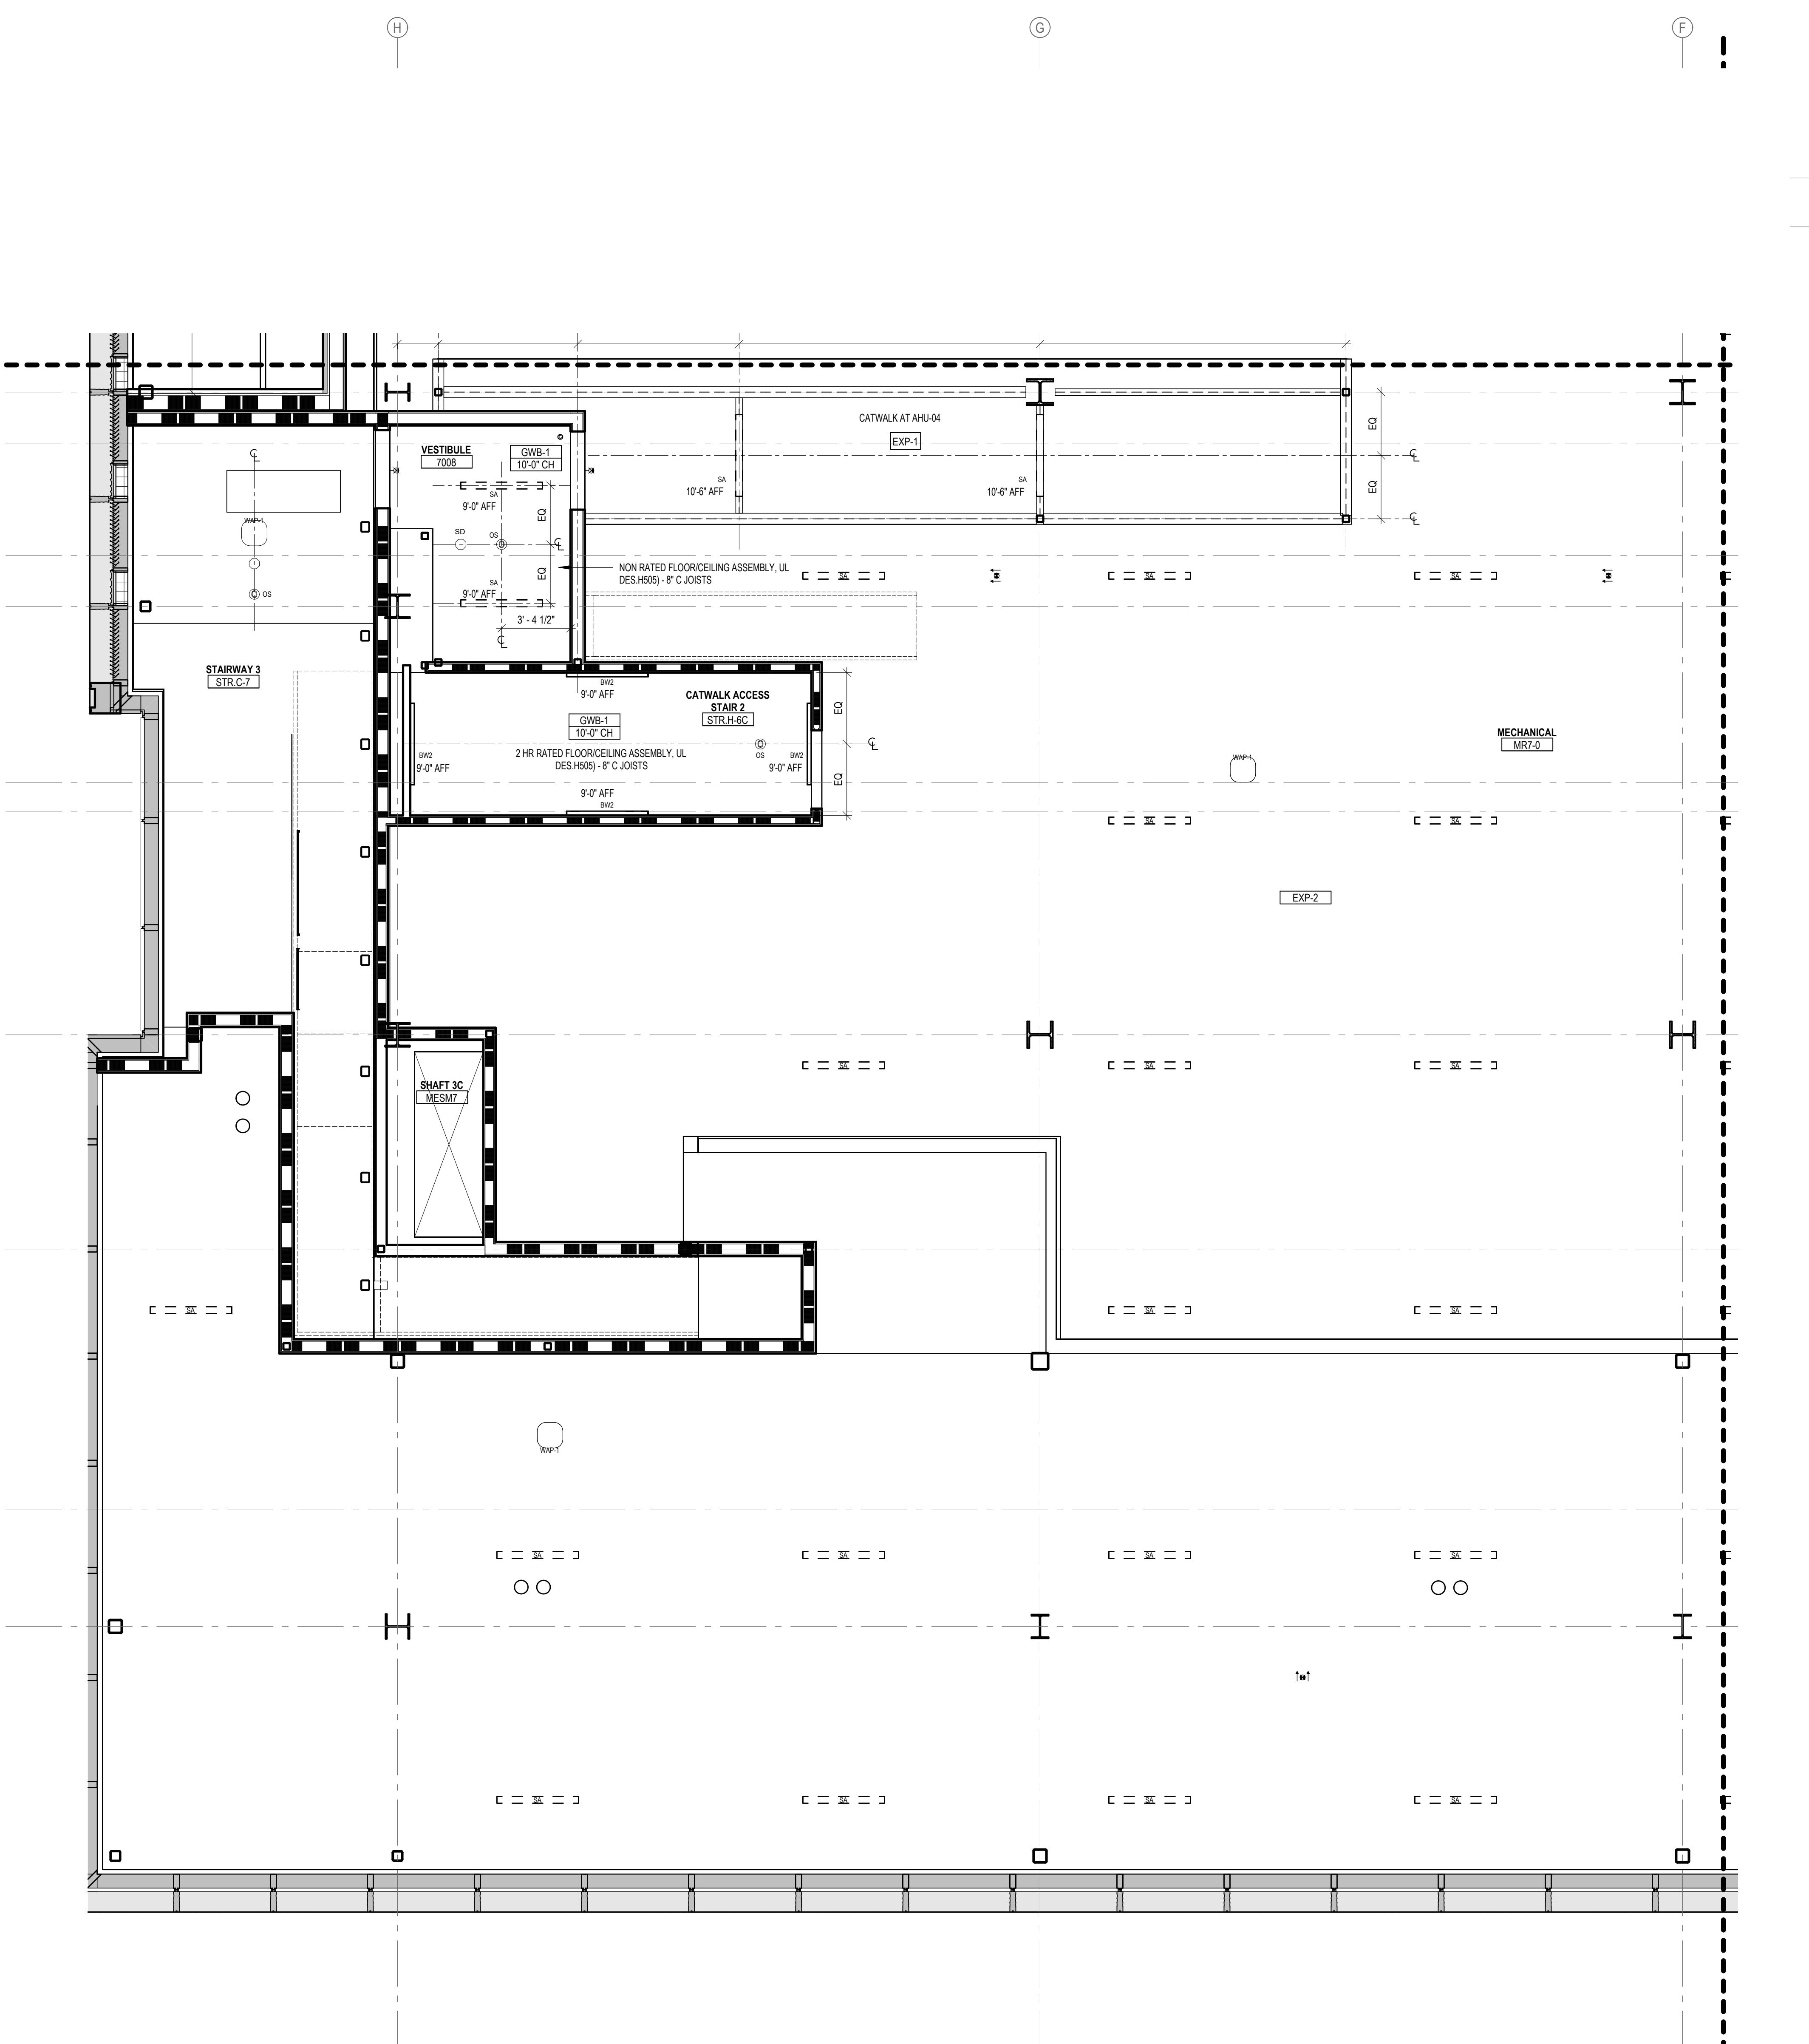


LEGEND - CEILING PLAN			NUMBER	DATE	DESCRIPTION
APC-1A	ACOUSTICAL PANEL CEILING (2X), LAB SUPPORT			10/24/25	ISSUED FOR CONSTRUCTION
APC-1B	ACOUSTICAL PANEL CEILING (2X), DARK ROOM (BLACK)				
APC-2	ACOUSTICAL PANEL CEILING (2X), FOCUS ROOM (HIGH NRC)				
APC-3	ACOUSTICAL PANEL CEILING (2X), OPEN OFFICE				
APC-4	ACOUSTICAL PANEL CEILING (2X), OFFICES, CONF.				
APC-5	ACOUSTICAL PANEL CEILING (2X), OPEN LAB				
APC-6	ACOUSTICAL PANEL CEILING (2X), BOH				
APC-7	ACOUSTICAL PANEL CEILING (2X), WASHABLE, RADIOSPOT, FOOD SERVICE				
APC-8	ACOUSTICAL PANEL CEILING (2X), MOISTURE RESISTANT, LOADING DOCK				
APC-9	ACOUSTICAL PANEL CEILING (2X), SEMINAR, CONFERENCE				
FRP-1	FIBERGLASS REINFORCED CEILING PANELS				
GWB-1	GYPSUM BOARD CEILING, PAINTED				
GWB-2	GYPSUM BOARD CEILING WITH HPC				
GWB-3	ACOUSTICAL PLASTER CEILING				
EXP-1	EXPOSED TO STRUCTURE				
EXP-2	EXPOSED TO STRUCTURE WITH PAINTED MEP, HANGERS, ACOUSTIC SPRAY COATING AT DECK				
LWC-1	LINEAR WOOD CEILING ACOUSTIC INFILL PANEL SEE A9.73.1				
LWC-2	LINEAR WOOD CEILING WITH ACOUSTIC SPRAY COATING ABOVE SEE A9.73.1				
WPC-1	ACOUSTICAL WOOD PANEL CEILING				
MPC-1	MICRO-PERFORATED METAL PANEL CEILING				
MPC-2	PERFORATED METAL CEILING WITH NON-COMBUSTIBLE ACOUSTIC INFILL PANEL SEE A9.72				
ST-1	LINEAR WOOD CEILING SOFFITS				
ST-2.1	METAL PANEL SOFFIT - EXTERIOR SOFFIT POWDER COAT TO MATCH COPPER ANODIZED ALUM.				
ST-2.2	METAL PANEL SOFFIT - EXTERIOR SOFFIT POWDER COAT TO MATCH BRONZE ANODIZED ALUM.				
CSP-X	CEILING SERVICE PANEL SEE A10.05A FOR TYPES				
OHR	OVERHEAD SERVICE RACK, SEE A10.07 FOR DETAILS.				
(C)	CEILING MOUNTED SECURITY CAMERA, REFER TO SECURITY DWG				
	EXIT SIGN CEILING MOUNTED / WALL MOUNTED				
	CEILING MOUNTED SPRINKLERS, REFER TO PLUM. DWG				
	FIRE ALARM CEILING MOUNTED / WALL MOUNTED				
H	CEILING MOUNTED HEAT DETECTOR				
SD	CEILING MOUNTED SMOKE DETECTOR				
WAP-1	WIRELESS ACCESS POINT MOUNTED ON CEILING				
WAP-2	WIRELESS ACCESS POINT MOUNTED ABOVE CEILING				
OC	CEILING MOUNTED OCCUPANCY/PHOTOCELL SENSOR				
	EXHAUST CONNECTION @ CEILING - REF. MECH. DWGS				
	LINEAR WALL WASH				
<b>ROLLER SHADES:</b>					
RS-1	MOTORIZED ROLLER SHADE WITH SINGLE ROLLERS, LIGHT-FILTERING FABRIC.				
RS-2	MOTORIZED ROLLER SHADE WITH DOUBLE ROLLERS, MOISTURE-RESISTANT LIGHT-FILTERING FABRIC AND MOISTURE-RESISTANT OPAQUE FABRIC.				
RS-3	MOTORIZED ROLLER SHADE WITH SINGLE ROLLERS, MOISTURE-RESISTANT OPAQUE FABRIC, WITH WINDOW FRAME LIGHT BAFFLES.				
<b>GENERAL NOTES:</b>					
1.	FOR LIGHTING FIXTURE TYPES REFER TO LIGHTING SCHEDULE.				
2.	FOR SPRINKLER TYPES REFER TO FIRE PROTECTION DRAWINGS.				
3.	CENTER ALL DEVICES WITH TILES U.N.O				
4.	DEVICES IN OFFICES ARE SHOWN FOR QUANTITIES, REFER TO A9.74.1 FOR TYPICAL LAYOUT				
<b>LEGEND - LIGHT FIXTURES</b>					
REFER TO MEP DRAWINGS AND SPECIFICATIONS					
XXXXXX	LINEAR PENDANT FIXTURE				
XXXXXX	SUSPENSION HEIGHT AFF				
XXXXXX	Fixture Length				
XXXXXX	Fixture Type				
XXXXXX	LINEAR RECESSED FIXTURE				
XXXXXX	Fixture Length				
XXX	Fixture Type				
XXX	RECESSED DOWNLIGHT				
XXX	Fixture Type				
XXX	RECESSED 2X2 TROFFER				
XXX	Fixture Type				
XXX	RECESSED 2X4 TROFFER				
XXX	Fixture Type				
XXX	RECESSED ATRIUM DOWNLIGHT				
XXX	Fixture Type				
<b>JOHNS HOPKINS UNIVERSITY</b>					
1800 Orleans St Baltimore, Maryland 21287					
<b>ENLARGED REFLECTED CEILING PLAN - LEVEL 7 - SECTOR 4</b>					
Seal	Date: OCTOBER 24, 2025				
	Scale: As indicated				
	Drawn By:				
	Designed By:				
	Checked By:				
	Proj. Mgr.:				
	Payette Job No.: 17480.00				
	Cadd File:				
	Client Job No.: J.170.24.4000				
	Client Dwg. No.:				
	Professional Certification:				
	State of Maryland Seal				
	Architect				
	KPN ARCHITECTS				
	1800 Washington Blvd, Suite 500				
	Baltimore, MD 21230				
	443.682.7757				
	CODE				
	CODE RED CONSULTANTS				
	154 Turnpike Road, Suite 200				
	Southborough, MA 01772				
	617.500.7633				
	CIVIL				
	RK&K				
	700 East Pratt Street, Suite 500				
	Baltimore, MD 21202				
	410.282.2900				
	LANDSCAPE ARCHITECT				
	OLIN				
	1617 John F. Kennedy Boulevard,				
	Suite 1900				
	Philadelphia, PA 19103				
	410.992.9970				
	STRUCTURAL				
	COLUMBIA ENGINEERING, INC.				
	6210 Old Dobbin Lane, Suite 150				
	Baltimore, Maryland 21045				
	410.532.2355				
	VERTICAL TRANSPORTATION				
	ZIPIF ASSOCIATES, INC.				
	25 Baba Avenue, Suite 201				
	Bala Cynwyd, PA 19004				
	610.687.1717				
	FIRE ALARM & FIRE PROTECTION				
	SETTY & ASSOCIATES				
	575 S. Charles Street, Suite 403				
	Baltimore, MD 21201				
	667.309.6036				
	AUDIO VISUAL & TELECOM				
	CONVERGENT TECHNOLOGIES				
	DESIGN GROUP				
	6501 York Road				
	Baltimore, MD 21212				
	410.532.2355				
	SECURITY				
	THORNTHWAITE TOMASSETTI				
	1330 Connecticut Ave, NW,				
	Suite 300				
	Washington, DC 20036				
	202.580.6300				
	FOOD SERVICE				
	COLBURN GUYETTE				
	100 Ledgewood Place, Suite 104				
	Rockland, MA 02370				
	781.826.5522				
	BUILDING ENCLOSURE				
	SIMPSON GUMPERTZ & HEGER				
	1625 Eye St NW				
	Suite 900				
	Washington, DC 20006				
	202.239.4199				
	LEED				
	SUSTAINABLE DESIGN CONSULTING				
	1432 K Street NW, 3rd Floor				
	Washington, DC 20005				
	202.667.1620				
	WIND & AIR QUALITY				
	RWDI				
	650 Woodland Rd.				
	W. Guelph, Ontario				
	Canada N1K 1B8				
	519.823.1311				
	LIGHTING				
	FISHER MARANTZ STONE				
	22 West 19th Street, 6th Floor				
	New York, NY 10011				
	212.691.3020				
	SITE LIGHTING				
	TILLETT LIGHTING DESIGN ASSOCIATES				
	11 Hanover Square, 17th Floor				
	New York, NY 10005				
	212.766.0144				
	EMI/RFI SHIELDING				
	VITACHEK ELECTROMAGNETICS				
	115 Julian Ct., Suite 105				
	Fredericksburg, VA 22406				
	540.286.1984				
	CAMPUS UTILITIES				
	AEI AFFILIATED ENGINEERS				
	200 International Circle, Suite 5888				
	Hunt Valley, MD 21030				
	410.229.0090				
<b>LIFE SCIENCES BUILDING</b>					
600 N Broadway Baltimore, MD 21205					
<b>JOHNS HOPKINS UNIVERSITY</b>					
1800 Orleans St Baltimore, Maryland 21287					
<b>ENLARGED REFLECTED CEILING PLAN - LEVEL 7 - SECTOR 4</b>					

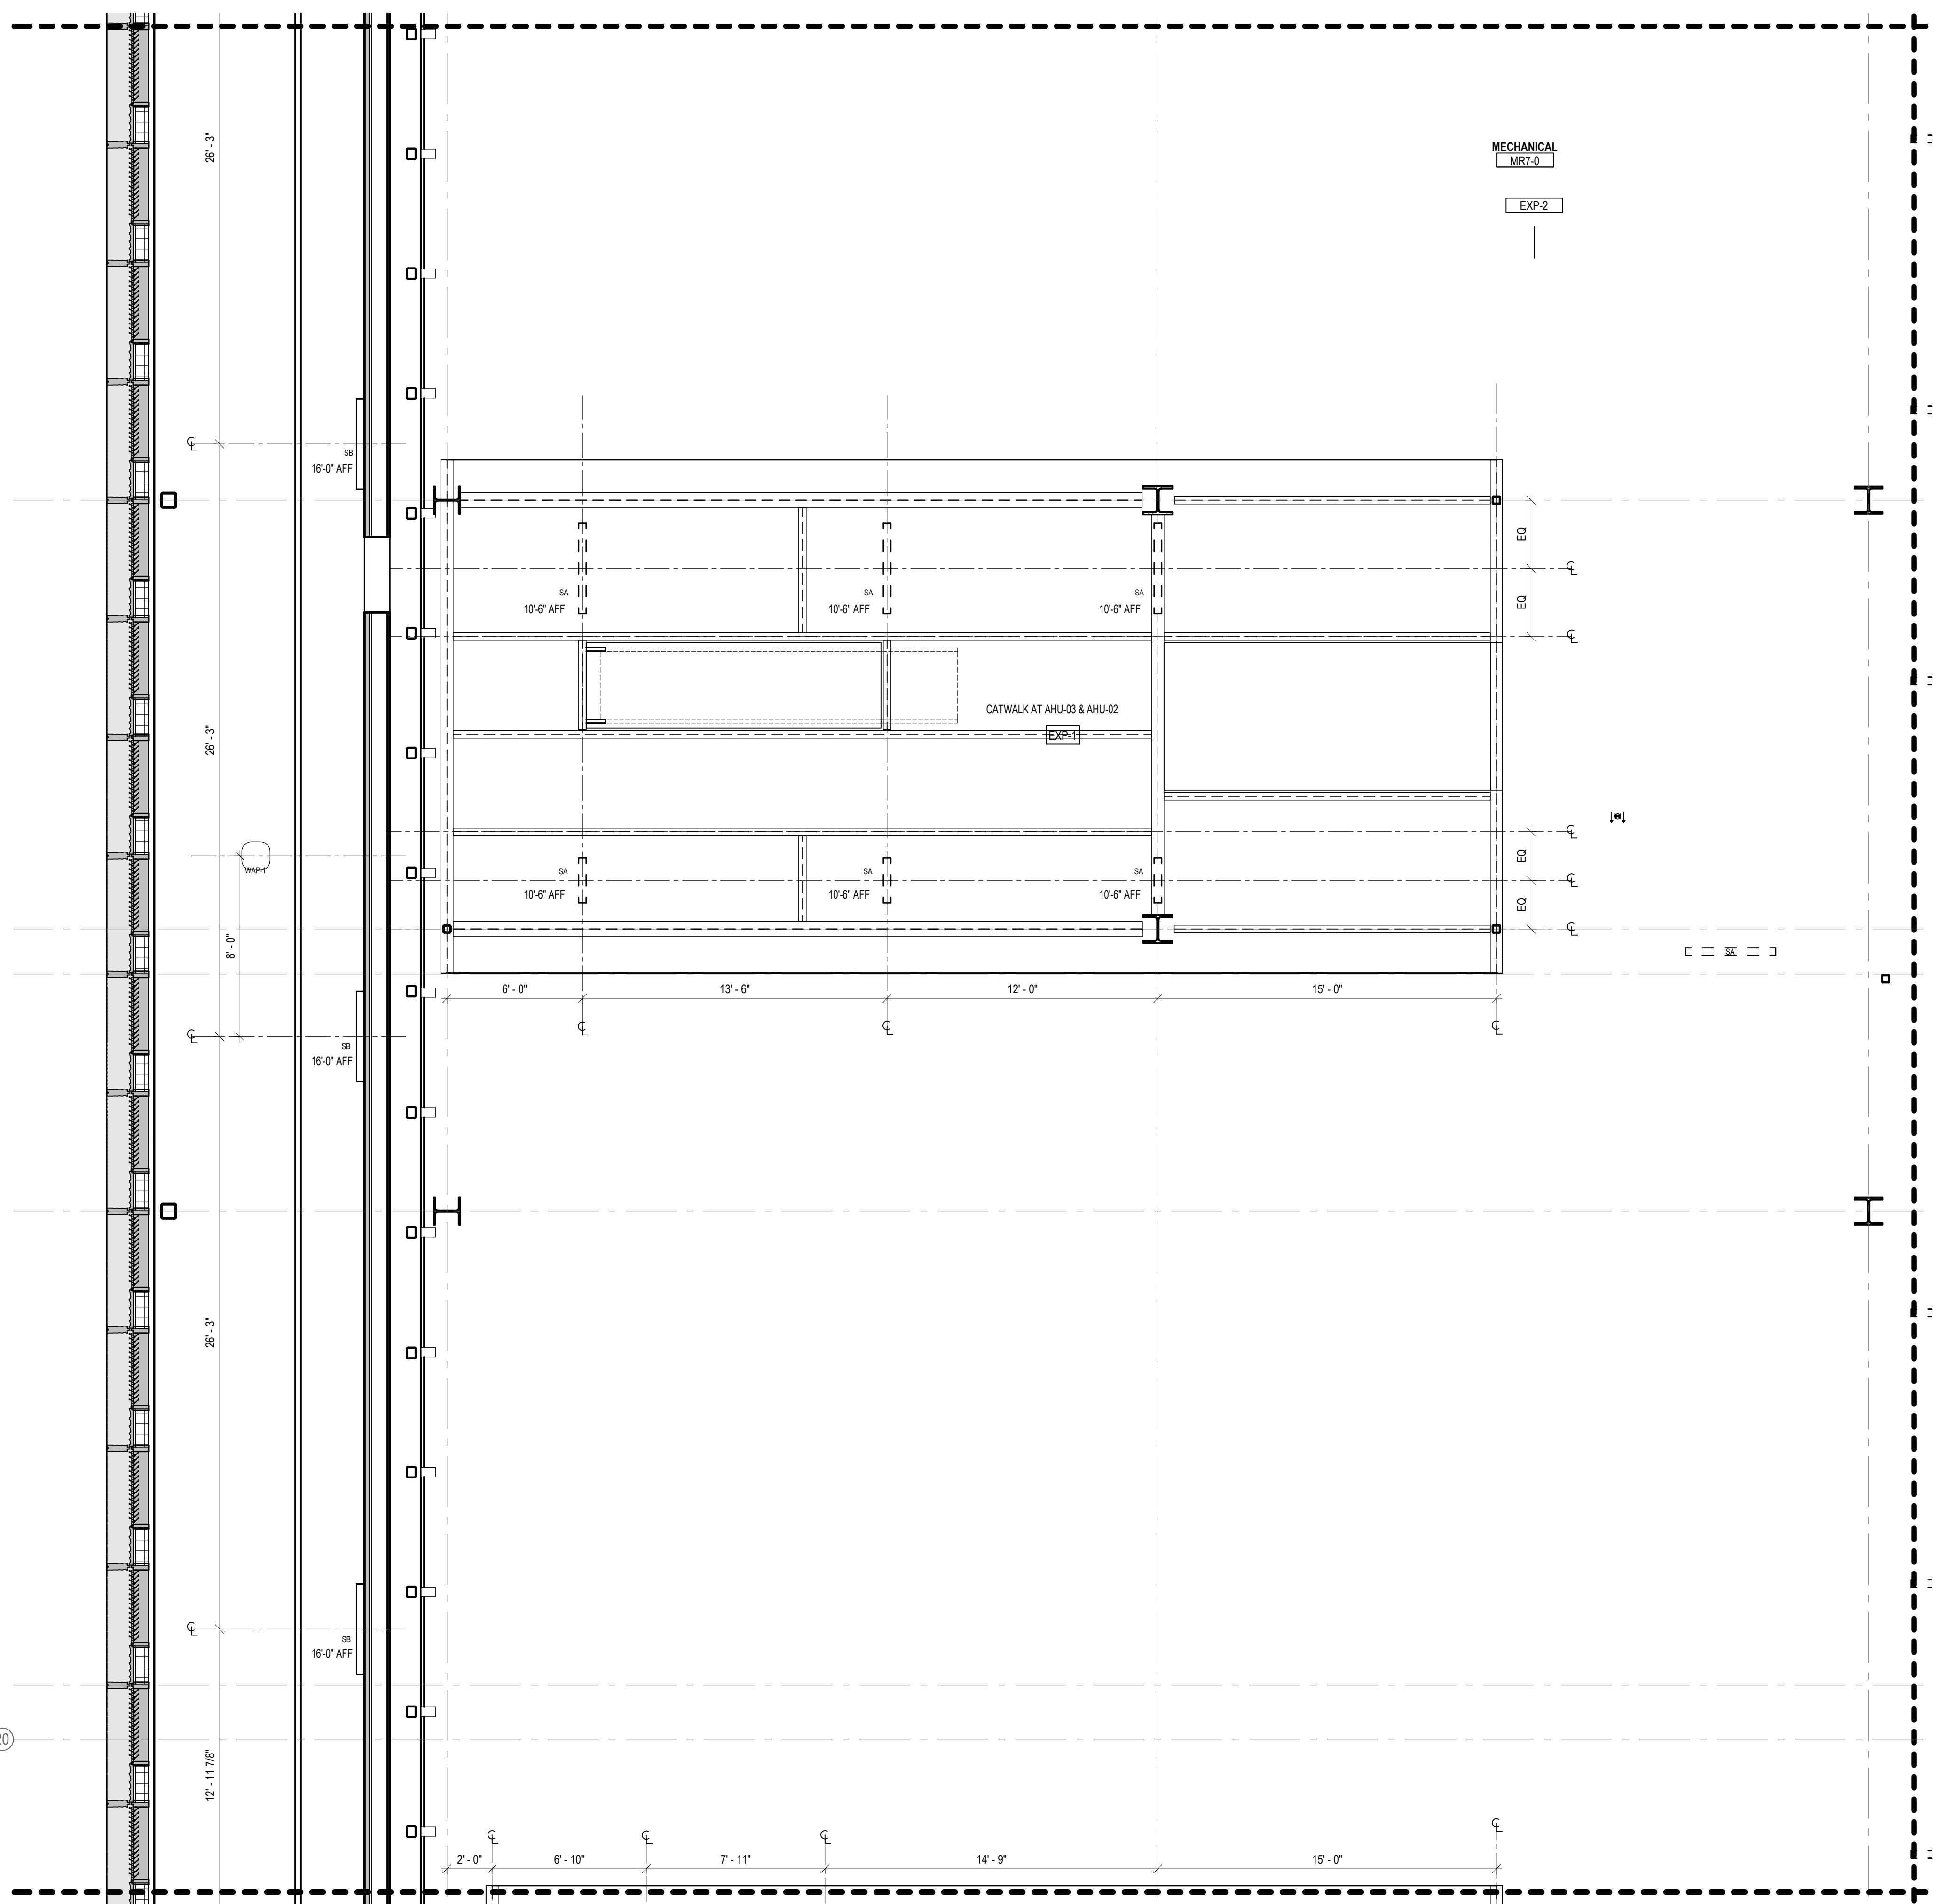


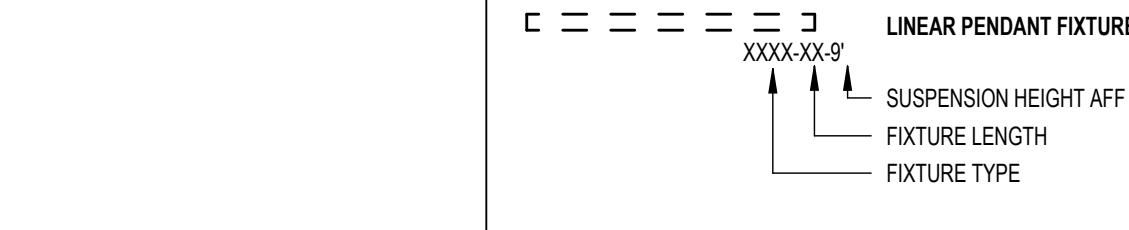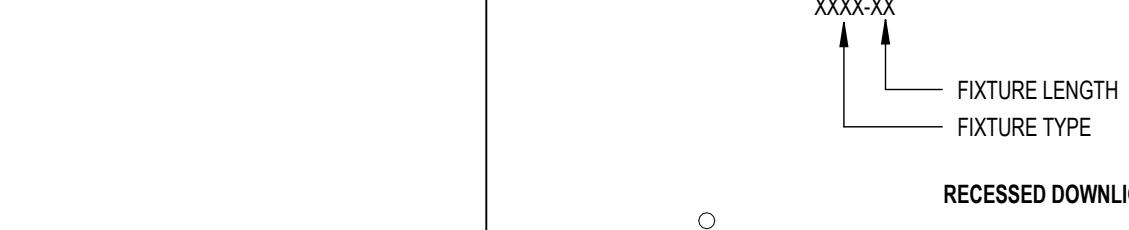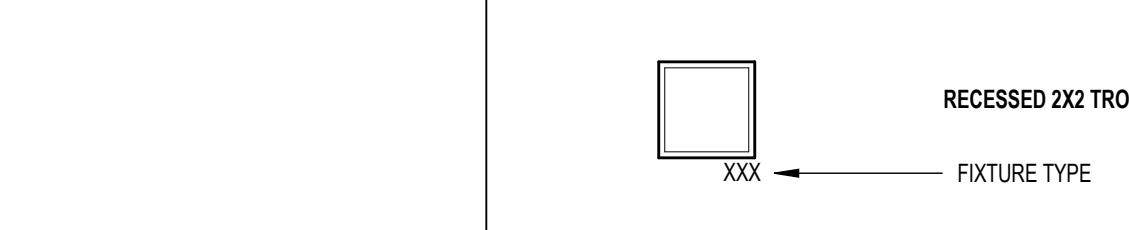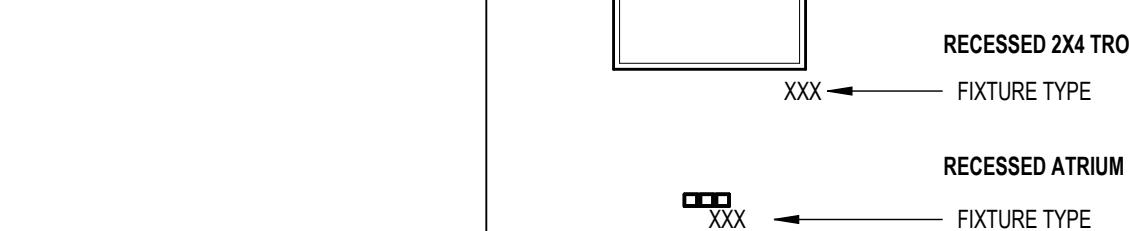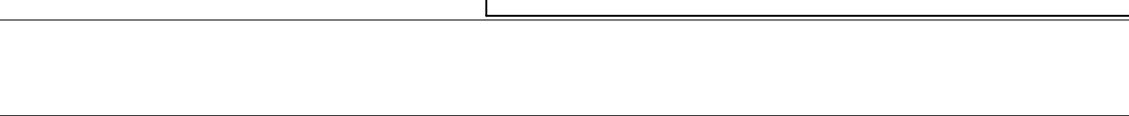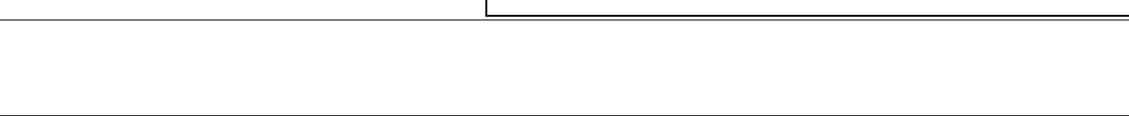LEGEND - CEILING PLAN			NUMBER	DATE	DESCRIPTION
[Symbol: APC-1A]	APC-1A	ACOUSTICAL PANEL CEILING (2X), LAB SUPPORT		10/24/25	ISSUED FOR CONSTRUCTION
[Symbol: APC-1B]	APC-1B	ACOUSTICAL PANEL CEILING (2X), DARK ROOM (BLACK)			
[Symbol: APC-2]	APC-2	ACOUSTICAL PANEL CEILING (2X), FOCUS ROOM (HIGH NRC)			
[Symbol: APC-3]	APC-3	ACOUSTICAL PANEL CEILING (2X), OPEN OFFICE			
[Symbol: APC-4]	APC-4	ACOUSTICAL PANEL CEILING (2X), OFFICES, CONF.			
[Symbol: APC-5]	APC-5	ACOUSTICAL PANEL CEILING (2X), OPEN LAB			
[Symbol: APC-6]	APC-6	ACOUSTICAL PANEL CEILING (2X), BOH			
[Symbol: APC-7]	APC-7	ACOUSTICAL PANEL CEILING (2X), WASHABLE, RADIOSPOT, FOOD SERVICE			
[Symbol: APC-8]	APC-8	ACOUSTICAL PANEL CEILING (2X), MOISTURE RESISTANT, LOADING DOCK			
[Symbol: APC-9]	APC-9	ACOUSTICAL PANEL CEILING (2X), SEMINAR, CONFERENCE			
[Symbol: FRP-1]	FRP-1	FIBERGLASS REINFORCED CEILING PANELS			
[Symbol: GWB-1]	GWB-1	GYPSUM BOARD CEILING, PAINTED			
[Symbol: GWB-2]	GWB-2	GYPSUM BOARD CEILING WITH HPC			
[Symbol: GWB-3]	GWB-3	ACOUSTICAL PLASTER CEILING			
[Symbol: EXP-1]	EXP-1	EXPOSED TO STRUCTURE			
[Symbol: EXP-2]	EXP-2	EXPOSED TO STRUCTURE WITH PAINTED MEP, HANGERS, ACOUSTIC SPRAY COATING AT DECK			
[Symbol: LWC-1]	LWC-1	LINEAR WOOD CEILING ACOUSTIC INFILL PANEL SEE A9.7.1			
[Symbol: LWC-2]	LWC-2	LINEAR WOOD CEILING WITH ACOUSTIC SPRAY COATING ABOVE SEE A9.7.1			
[Symbol: WPC-1]	WPC-1	ACOUSTICAL WOOD PANEL CEILING			
[Symbol: MPC-1]	MPC-1	MICRO-PERFORATED METAL PANEL CEILING			
[Symbol: MPC-2]	MPC-2	PERFORATED METAL CEILING WITH NON-COMBUSTIBLE ACOUSTIC INFILL PANEL SEE A9.7.2			
[Symbol: ST-1]	ST-1	LINEAR WOOD CEILING SOFFITS			
[Symbol: ST-2.1]	ST-2.1	METAL PANEL SOFFIT - EXTERIOR SOFFIT POWDER COAT TO MATCH COPPER ANODIZED ALUM.			
[Symbol: ST-2.2]	ST-2.2	METAL PANEL SOFFIT - EXTERIOR SOFFIT POWDER COAT TO MATCH BRONZE ANODIZED ALUM.			
[Symbol: CSP-X]	CSP-X	CEILING SERVICE PANEL SEE A10.05A FOR TYPES			
[Symbol: OHR]	OHR	OVERHEAD SERVICE RACK, SEE A10.07 FOR DETAILS.			
[Symbol: C]	C	CEILING MOUNTED SECURITY CAMERA, REFER TO SECURITY DWG			
[Symbol: X / X]	X / X	EXIT SIGN CEILING MOUNTED / WALL MOUNTED			
[Symbol: C]	C	CEILING MOUNTED SPRINKLERS, REFER TO PLUM. DWG			
[Symbol: F / F]	F / F	FIRE ALARM CEILING MOUNTED / WALL MOUNTED			
[Symbol: H]	H	CEILING MOUNTED HEAT DETECTOR			
[Symbol: SD]	SD	CEILING MOUNTED SMOKE DETECTOR			
[Symbol: WAP-1]	WAP-1	WIRELESS ACCESS POINT MOUNTED ON CEILING			
[Symbol: WAP-2]	WAP-2	WIRELESS ACCESS POINT MOUNTED ABOVE CEILING			
[Symbol: OC]	OC	CEILING MOUNTED OCCUPANCY/PHOTOCELL SENSOR			
[Symbol: C]	C	EXHAUST CONNECTION @ CEILING - REF. MECH. DWGS			
[Symbol: C]	C	LINEAR WALL WASH			
<b>ROLLER SHADES:</b>					
RS-1 - MOTORIZED ROLLER SHADE WITH SINGLE ROLLERS, LIGHT-FILTERING FABRIC.					
RS-2 - MOTORIZED ROLLER SHADE WITH DOUBLE ROLLERS, MOISTURE-RESISTANT LIGHT-FILTERING FABRIC AND MOISTURE-RESISTANT OPAQUE FABRIC.					
RS-3 - MOTORIZED ROLLER SHADE WITH SINGLE ROLLERS, MOISTURE-RESISTANT OPAQUE FABRIC, WITH WINDOW FRAME LIGHT BAFFLES.					
<b>GENERAL NOTES:</b>					
1. FOR LIGHTING FIXTURE TYPES REFER TO LIGHTING SCHEDULE.					
2. FOR SPRINKLER TYPES REFER TO FIRE PROTECTION DRAWINGS.					
3. CENTER ALL DEVICES WITH TILES U.N.O.					
4. DEVICES IN OFFICES ARE SHOWN FOR QUANTITIES, REFER TO A9.7.1 FOR TYPICAL LAYOUT					
<b>LEGEND - LIGHT FIXTURES</b>					
REFER TO MEP DRAWINGS AND SPECIFICATIONS					
 XXXXXX / LINEAR PENDANT FIXTURE XXXXXX / SUSPENSION HEIGHT AFF XXXXXX / FIXTURE LENGTH XXXXXX / FIXTURE TYPE					
 XXXXXX / LINEAR RECESSED FIXTURE XXXXXX / FIXTURE LENGTH XXXXXX / FIXTURE TYPE					
 XXX / RECESSED DOWNLIGHT XXX / FIXTURE TYPE					
 XXX / RECESSED 2X2 TROFFER XXX / FIXTURE TYPE					
 XXX / RECESSED 2X4 TROFFER XXX / FIXTURE TYPE					
 XXX / RECESSED ATRIUM DOWNLIGHT XXX / FIXTURE TYPE					
<b>JOHNS HOPKINS</b> UNIVERSITY 1600 Orleans St Baltimore, Maryland 21287					
<b>ENLARGED REFLECTED CEILING PLAN - LEVEL 7 - SECTOR 5</b>					
Seal  Date: OCTOBER 24, 2025 Scale: As indicated Drawn By: Designed By: Checked By: Proj. Mgr.: Payette Job No.: 17480.00 Cadd File: Client Job No.: J.170.24.4000 Client Dwg. No.: Professional Certification: I certify that these documents were prepared or approved by me, and that I am a duly licensed engineer under the laws of the State of Maryland. License No. 9986 Expiration Date: 06/20/2026					

A6.75

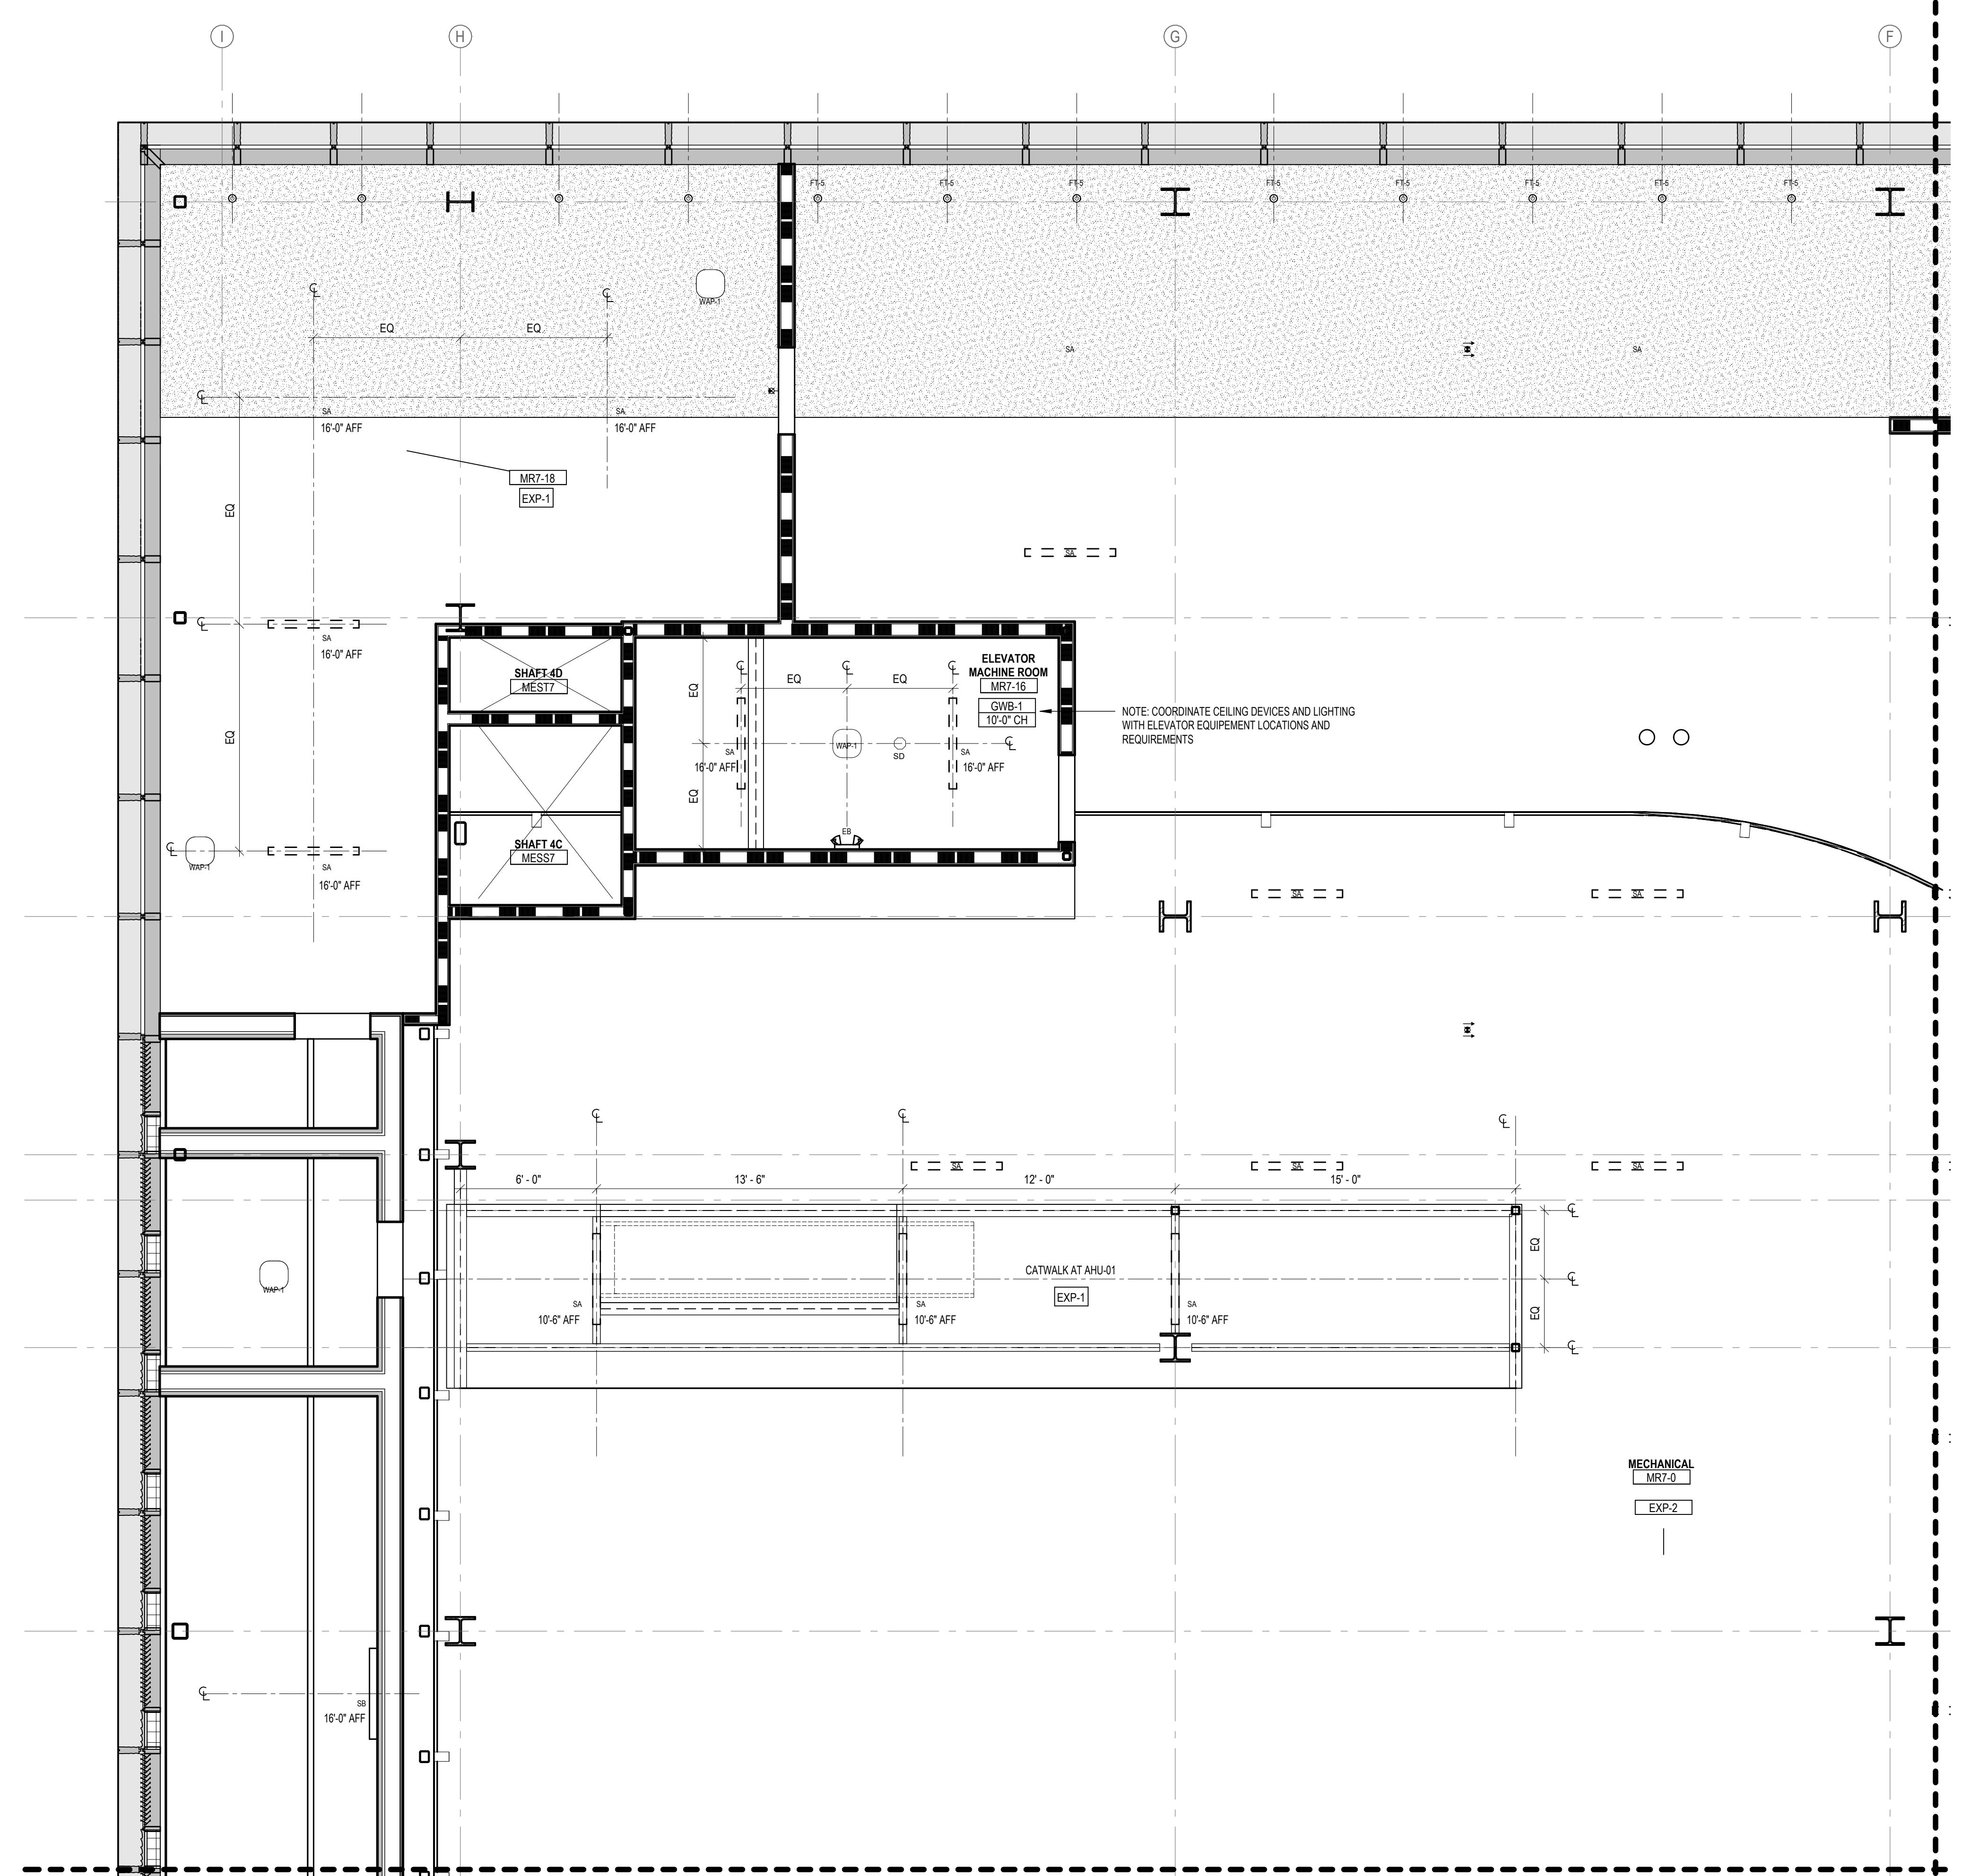

## **LEGEND - CEILING PLAN**




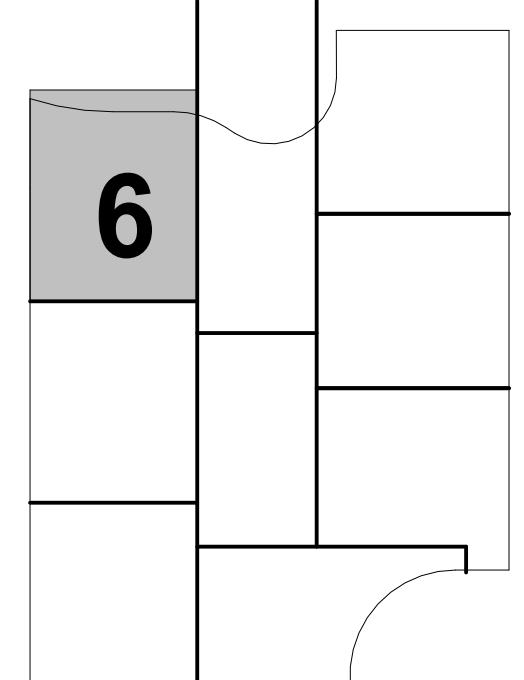


## KEY PLAN

<b>ARCHITECT</b> PAYETTE ASSOCIATES, INC. 290 Congress Street, Fifth Floor Boston, MA 02210 617.895.1000	<b>ASSOCIATE ARCHITECT</b> KPN ARCHITECTS 1800 Washington Blvd, Suite 414 Baltimore, MD 21230 443.682.7757
<b>CODE</b> CODE RED CONSULTANTS 154 Turnpike Road, Suite 200 Southborough, MA 01772 617.500.7633	<b>CIVIL</b> RK&K 700 East Pratt Street, Suite 500 Baltimore, MD 21202 410.728.2900
<b>LANDSCAPE ARCHITECT</b> OLIN 1617 John F. Kennedy Boulevard, Suite 1900 Philadelphia, PA 19103 215.440.0030	<b>STRUCTURAL</b> COLUMBIA ENGINEERING, INC. 6210 Old Dobbin Lane, Suite 150 Baltimore, Maryland 21045 410.992.9970
<b>VERTICAL TRANSPORTATION</b> ZIPF ASSOCIATES, INC. 25 Bala Avenue, Suite 201 Bala Cynwyd, PA 19004 610.667.1717	<b>MEP</b> BR+A CONSULTING ENGINEERS 10 Guest Street, 4th Floor Boston, MA 02135 617.254.0016
<b>FIRE ALARM &amp; FIRE PROTECTION</b> SETTY & ASSOCIATES 575 S. Charles Street, Suite 403 Baltimore, MD 21201 667.309.6036	<b>AUDIO VISUAL &amp; TELECOM</b> CONVERGENT TECHNOLOGIES DESIGN GROUP 6501 York Road Baltimore, MD 21212 410.532.2395
<b>SECURITY</b> THORNTON TOMASETTI 1330 Connecticut Ave, NW, Suite 300 Washington, DC 20036 202.580.6300	<b>FOOD SERVICE</b> COLBURN GUYETTE 100 Ledgewood Place, Suite 104 Rockland, MA, 02370 781.826.5522
<b>BUILDING ENCLOSURE</b> SIMPSON GUMPERTZ & HEGER 1625 Eye St NW Suite 900 Washington, DC 20006 202.239.4199	<b>LEED</b> SUSTAINABLE DESIGN CONSULTING 1432 K Street NW, 3rd Floor Washington, DC 20005 202.667.1620
<b>WIND &amp; AIR QUALITY</b> RWDI 650 Woodland Rd. W. Guelph, Ontario Canada N1K 1B8 519.823.1311	<b>VIBRATION &amp; ACOUSTICS</b> COLIN GORDON ASSOCIATES 1350 Old Bayshore Hwy, Suite 799 Burlingame, CA 94010 415.570.0350
<b>LIGHTING</b> FISHER MARANTZ STONE 22 West 19th Street, 6th Floor New York, NY 10011 212.691.3020	<b>SITE LIGHTING</b> TILLETT LIGHTING DESIGN ASSOCIATES 11 Hanover Square, 17th Floor New York, NY 10005 212.766.0144
<b>EMI/RFI (SHEILDING)</b> VITATECH ELECTROMAGNETICS 115 Juliad Ct., Suite 105	<b>CAMPUS UTILITIES</b> AEI AFFILIATED ENGINEERS 300 University City Center, Suite 5000

## **LEGEND - LIGHT FIXTURES**

**REFER TO MFR DRAWINGS AND SPECIFICATIONS**

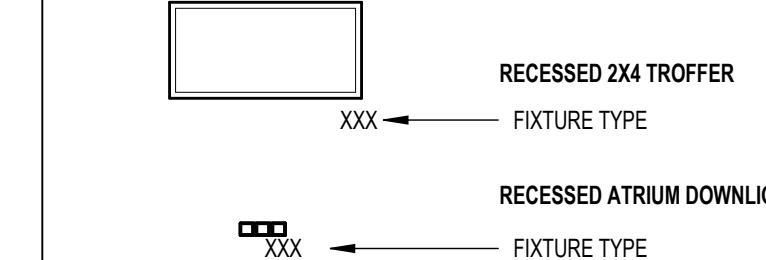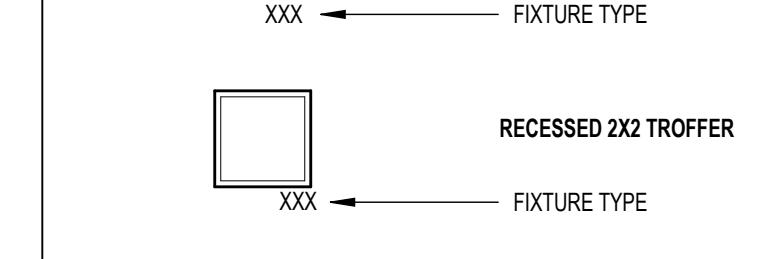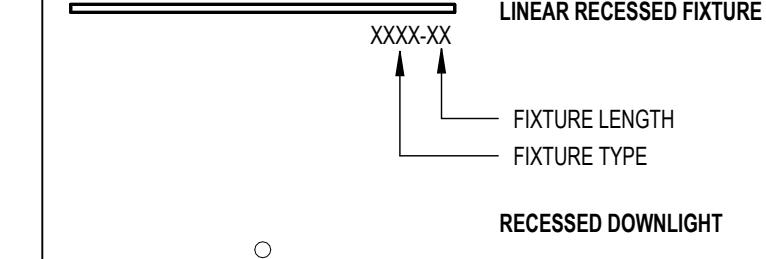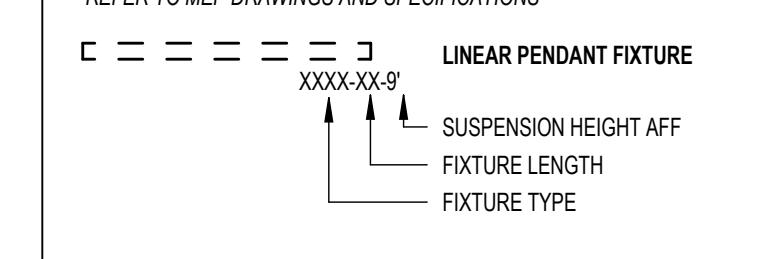


## **ENLARGED REFLECTED CEILING PLAN - LEVEL 7 SECTOR 4**


## - SECTOR 6

 The seal is circular with a dotted outer border. The words "STATE OF MARYLAND" are at the top and "ARCHITECT" are at the bottom. In the center is a crest featuring two figures under a canopy, with the name "SARAH LINDENFELD" below it. A blue signature line "No. 19966" is drawn across the seal.	
Date:	OCTOBER 24, 2025
Scale:	As indicated
Drawn By:	
Designed By:	
Checked By:	
Proj. Mgr.:	
Payette Job No.:	17480.00
Cadd File:	
Client Job No.:	J.170.24.4000
Client Dwg. No.:	
A6.76	

e,  
of  
**A6.76**

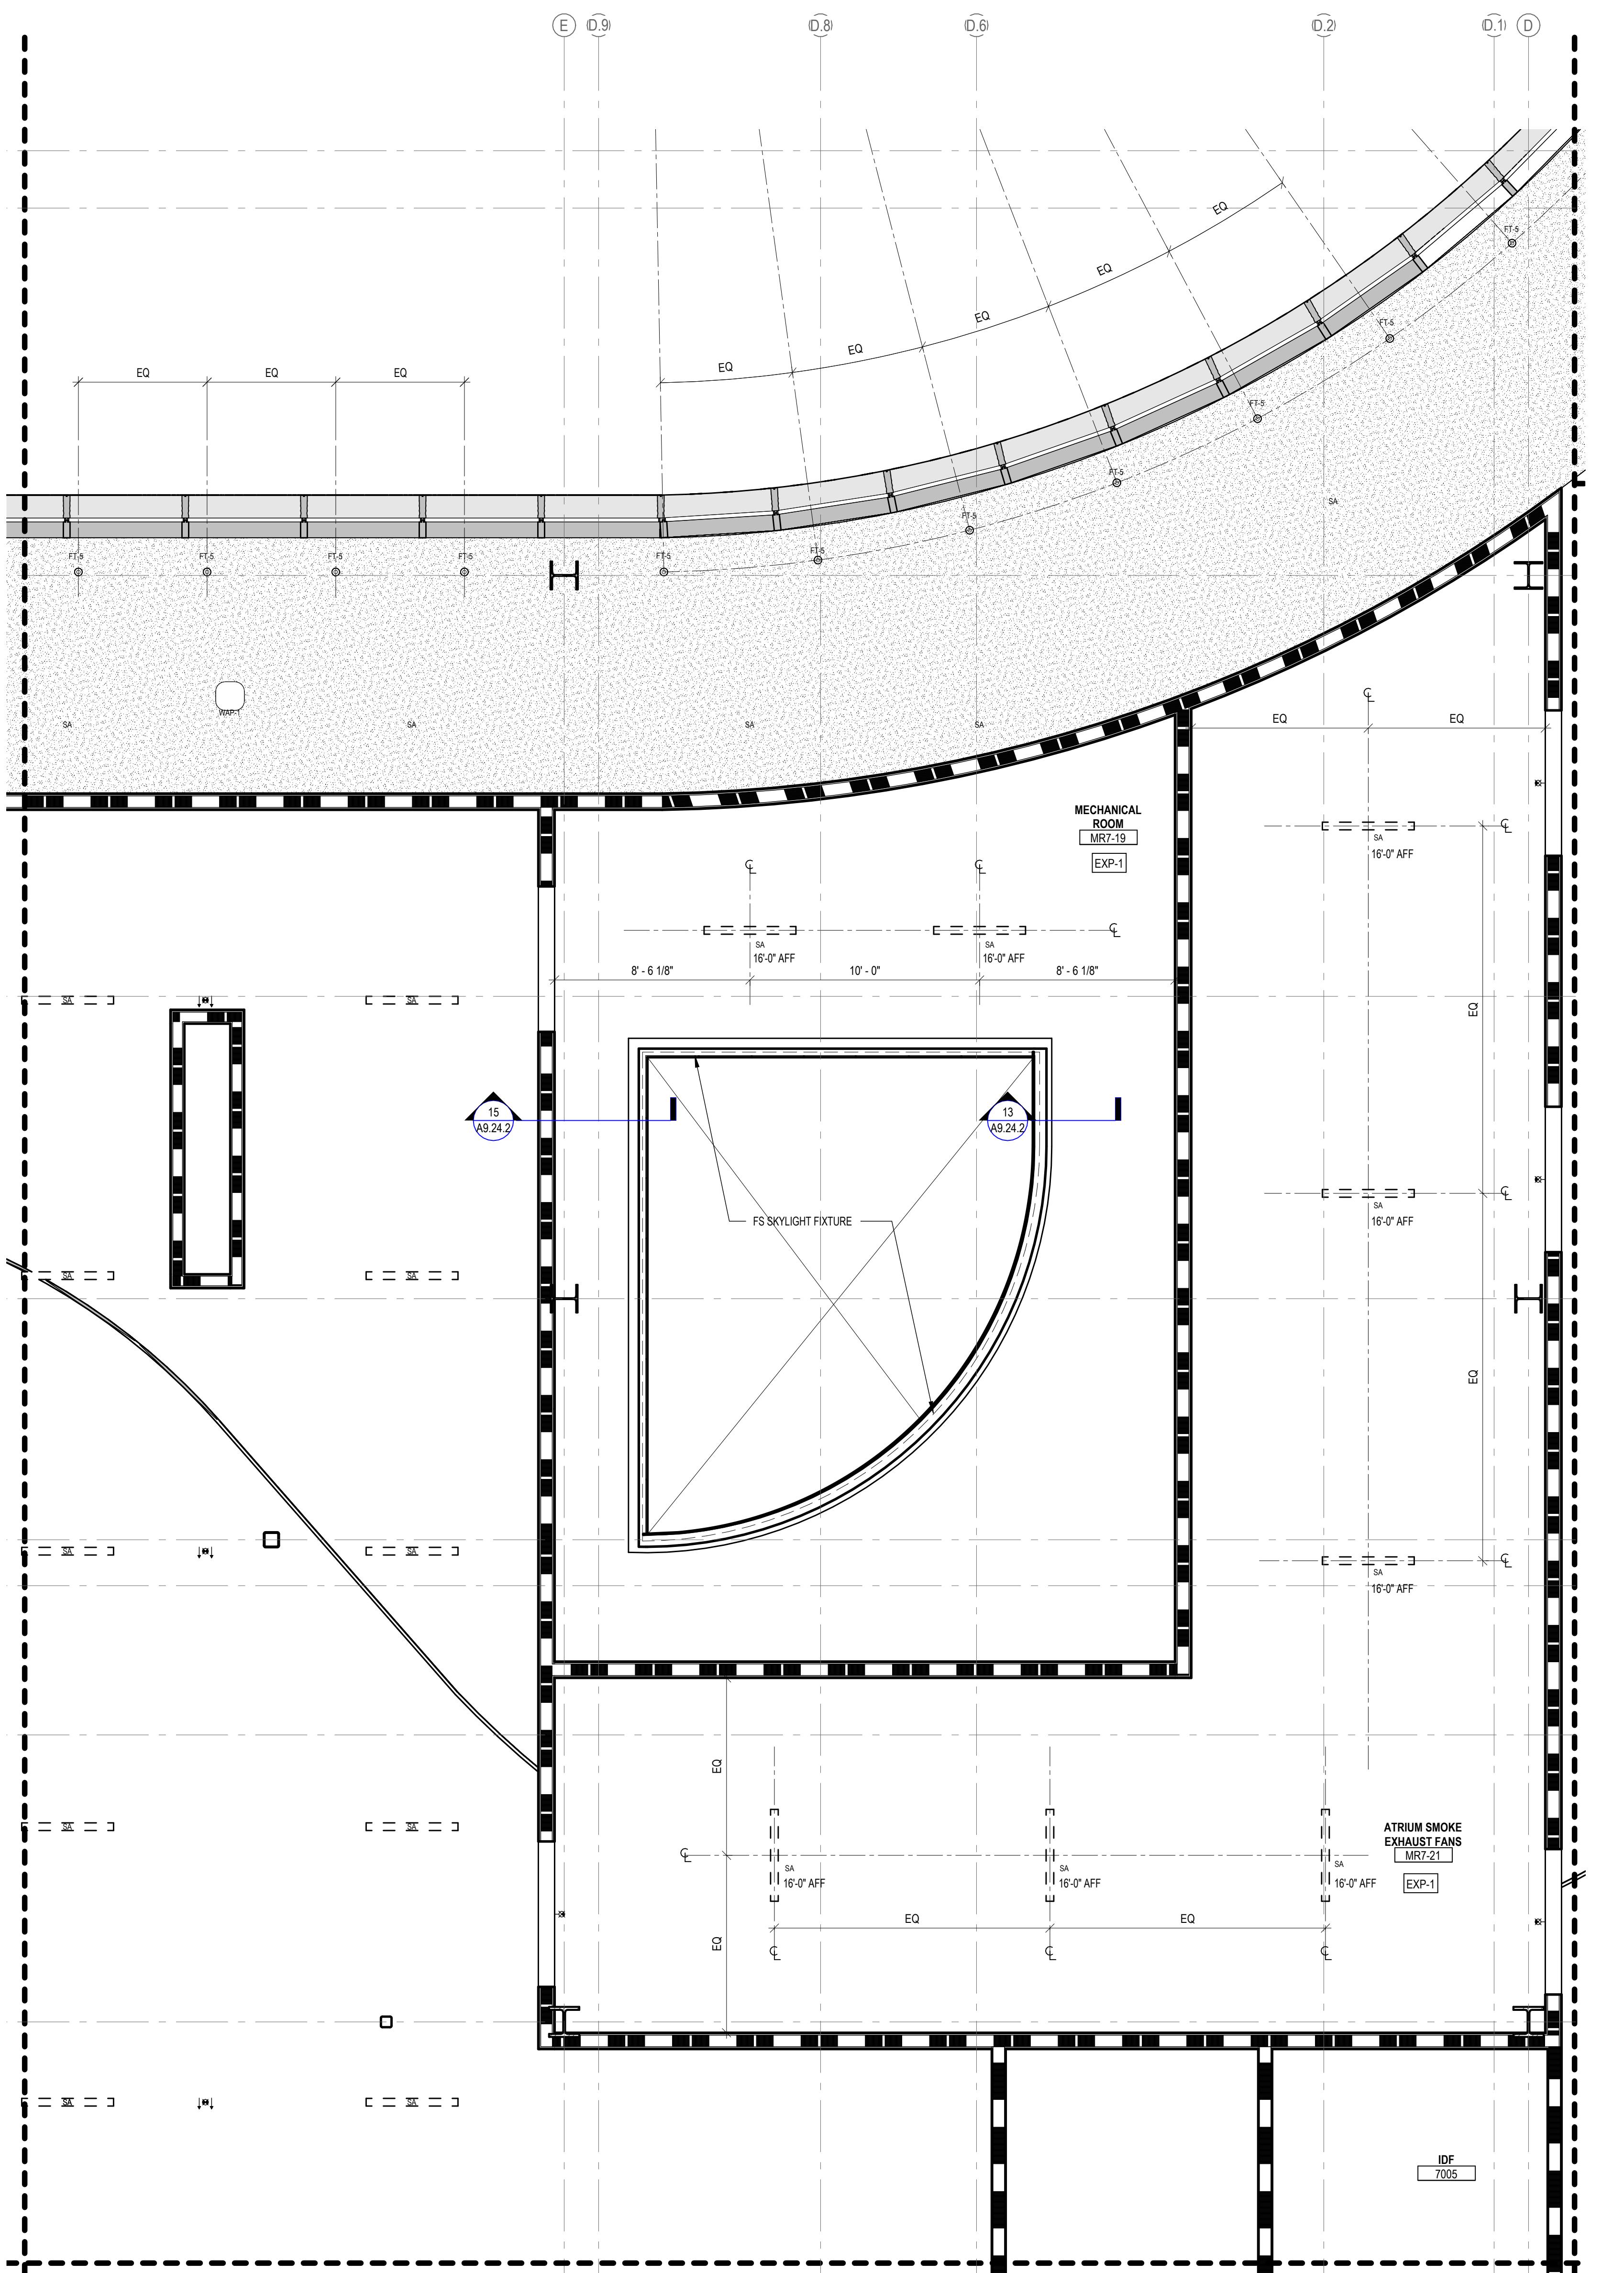

LEGEND - CEILING PLAN			NUMBER	DATE	DESCRIPTION	
APC-1A	ACOUSTICAL PANEL CEILING (2X), LAB SUPPORT		10/24/25		ISSUED FOR CONSTRUCTION	
APC-1B	ACOUSTICAL PANEL CEILING (2X), DARK ROOM (BLACK)					
APC-2	ACOUSTICAL PANEL CEILING (2X), FOCUS ROOM (HIGH NRC)					
APC-3	ACOUSTICAL PANEL CEILING (2X), OPEN OFFICE					
APC-4	ACOUSTICAL PANEL CEILING (2X), OFFICES, CONF.					
APC-5	ACOUSTICAL PANEL CEILING (2X), OPEN LAB					
APC-6	ACOUSTICAL PANEL CEILING (2X), BOH					
APC-7	ACOUSTICAL PANEL CEILING (2X), WASHABLE, RADIOSPOT, FOOD SERVICE					
APC-8	ACOUSTICAL PANEL CEILING (2X), MOISTURE RESISTANT, LOADING DOCK					
APC-9	ACOUSTICAL PANEL CEILING (2X), SEMINAR, CONFERENCE					
FRP-1	FIBERGLASS REINFORCED CEILING PANELS					
GWB-1	GYPSUM BOARD CEILING, PAINTED					
GWB-2	GYPSUM BOARD CEILING WITH HPC					
GWB-3	ACOUSTICAL PLASTER CEILING					
EXP-1	EXPOSED TO STRUCTURE					
EXP-2	EXPOSED TO STRUCTURE WITH PAINTED MEP, HANGERS, ACOUSTIC SPRAY COATING AT DECK					
LWC-1	LINEAR WOOD CEILING ACOUSTIC INFILL PANEL SEE A9.73.1					
LWC-2	LINEAR WOOD CEILING WITH ACOUSTIC SPRAY COATING ABOVE SEE A9.73.1					
WPC-1	ACOUSTICAL WOOD PANEL CEILING					
MPC-1	MICRO-PERFORATED METAL PANEL CEILING					
MPC-2	PERFORATED METAL CEILING WITH NON-COMBUSTIBLE ACOUSTIC INFILL PANEL SEE A9.72					
ST-1	LINEAR WOOD CEILING SOFFITS					
ST-2.1	METAL PANEL SOFFIT - EXTERIOR SOFFIT POWDER COAT TO MATCH COPPER ANODIZED ALUM.					
ST-2.2	METAL PANEL SOFFIT - EXTERIOR SOFFIT POWDER COAT TO MATCH BRONZE ANODIZED ALUM.					
CSP-X	CEILING SERVICE PANEL SEE A10.05A FOR TYPES					
OHR	OVERHEAD SERVICE RACK, SEE A10.07 FOR DETAILS.					
(C)	CEILING MOUNTED SECURITY CAMERA, REFER TO SECURITY DWG					
	EXIT SIGN CEILING MOUNTED / WALL MOUNTED					
	CEILING MOUNTED SPRINKLERS, REFER TO PLUM. DWG					
(F)	FIRE ALARM CEILING MOUNTED / WALL MOUNTED					
H	CEILING MOUNTED HEAT DETECTOR					
SD	CEILING MOUNTED SMOKE DETECTOR					
WAP-1	WIRELESS ACCESS POINT MOUNTED ON CEILING					
WAP-2	WIRELESS ACCESS POINT MOUNTED ABOVE CEILING					
OC	CEILING MOUNTED OCCUPANCY/PHOTOCELL SENSOR					
	EXHAUST CONNECTION @ CEILING - REF. MECH. DWGS					
	LINEAR WALL WASH					
<b>ROLLER SHADES:</b>						
RS-1	MOTORIZED ROLLER SHADE WITH SINGLE ROLLERS, LIGHT-FILTERING FABRIC.					
RS-2	MOTORIZED ROLLER SHADE WITH DOUBLE ROLLERS, MOISTURE-RESISTANT LIGHT-FILTERING FABRIC AND MOISTURE-RESISTANT OPAQUE FABRIC.					
RS-3	MOTORIZED ROLLER SHADE WITH SINGLE ROLLERS, MOISTURE-RESISTANT OPAQUE FABRIC, WITH WINDOW FRAME LIGHT BAFFLES.					
<b>GENERAL NOTES:</b>						
1.	FOR LIGHTING FIXTURE TYPES REFER TO LIGHTING SCHEDULE.					
2.	FOR SPRINKLER TYPES REFER TO FIRE PROTECTION DRAWINGS.					
3.	CENTER ALL DEVICES WITH TILES U.N.O					
4.	DEVICES IN OFFICES ARE SHOWN FOR QUANTITIES, REFER TO A9.74.1 FOR TYPICAL LAYOUT					
<b>LEGEND - LIGHT FIXTURES</b>						
REFER TO MEP DRAWINGS AND SPECIFICATIONS						
<b>JOHNS HOPKINS</b> UNIVERSITY 1800 Orleans St Baltimore, Maryland 21287						
<b>ENLARGED REFLECTED CEILING PLAN - LEVEL 7 - SECTOR 7</b>						
Seal	Date:	OCTOBER 24, 2025				
	Scale:	As indicated				
	Drawn By:					
	Designed By:					
	Checked By:					
	Proj. Mgr.:					
	Payette Job No.:	17480.00				
	Cadd File:					
	Client Job No.:	J.170.24.4000				
	Client Dwg. No.:					
	Professional Certification:					
	I certify that these documents were prepared or approved by me, and that I am duly licensed engineer under the laws of the State of Maryland. License No. 9986 Expiration Date: 06/20/2026					
	A6.77					

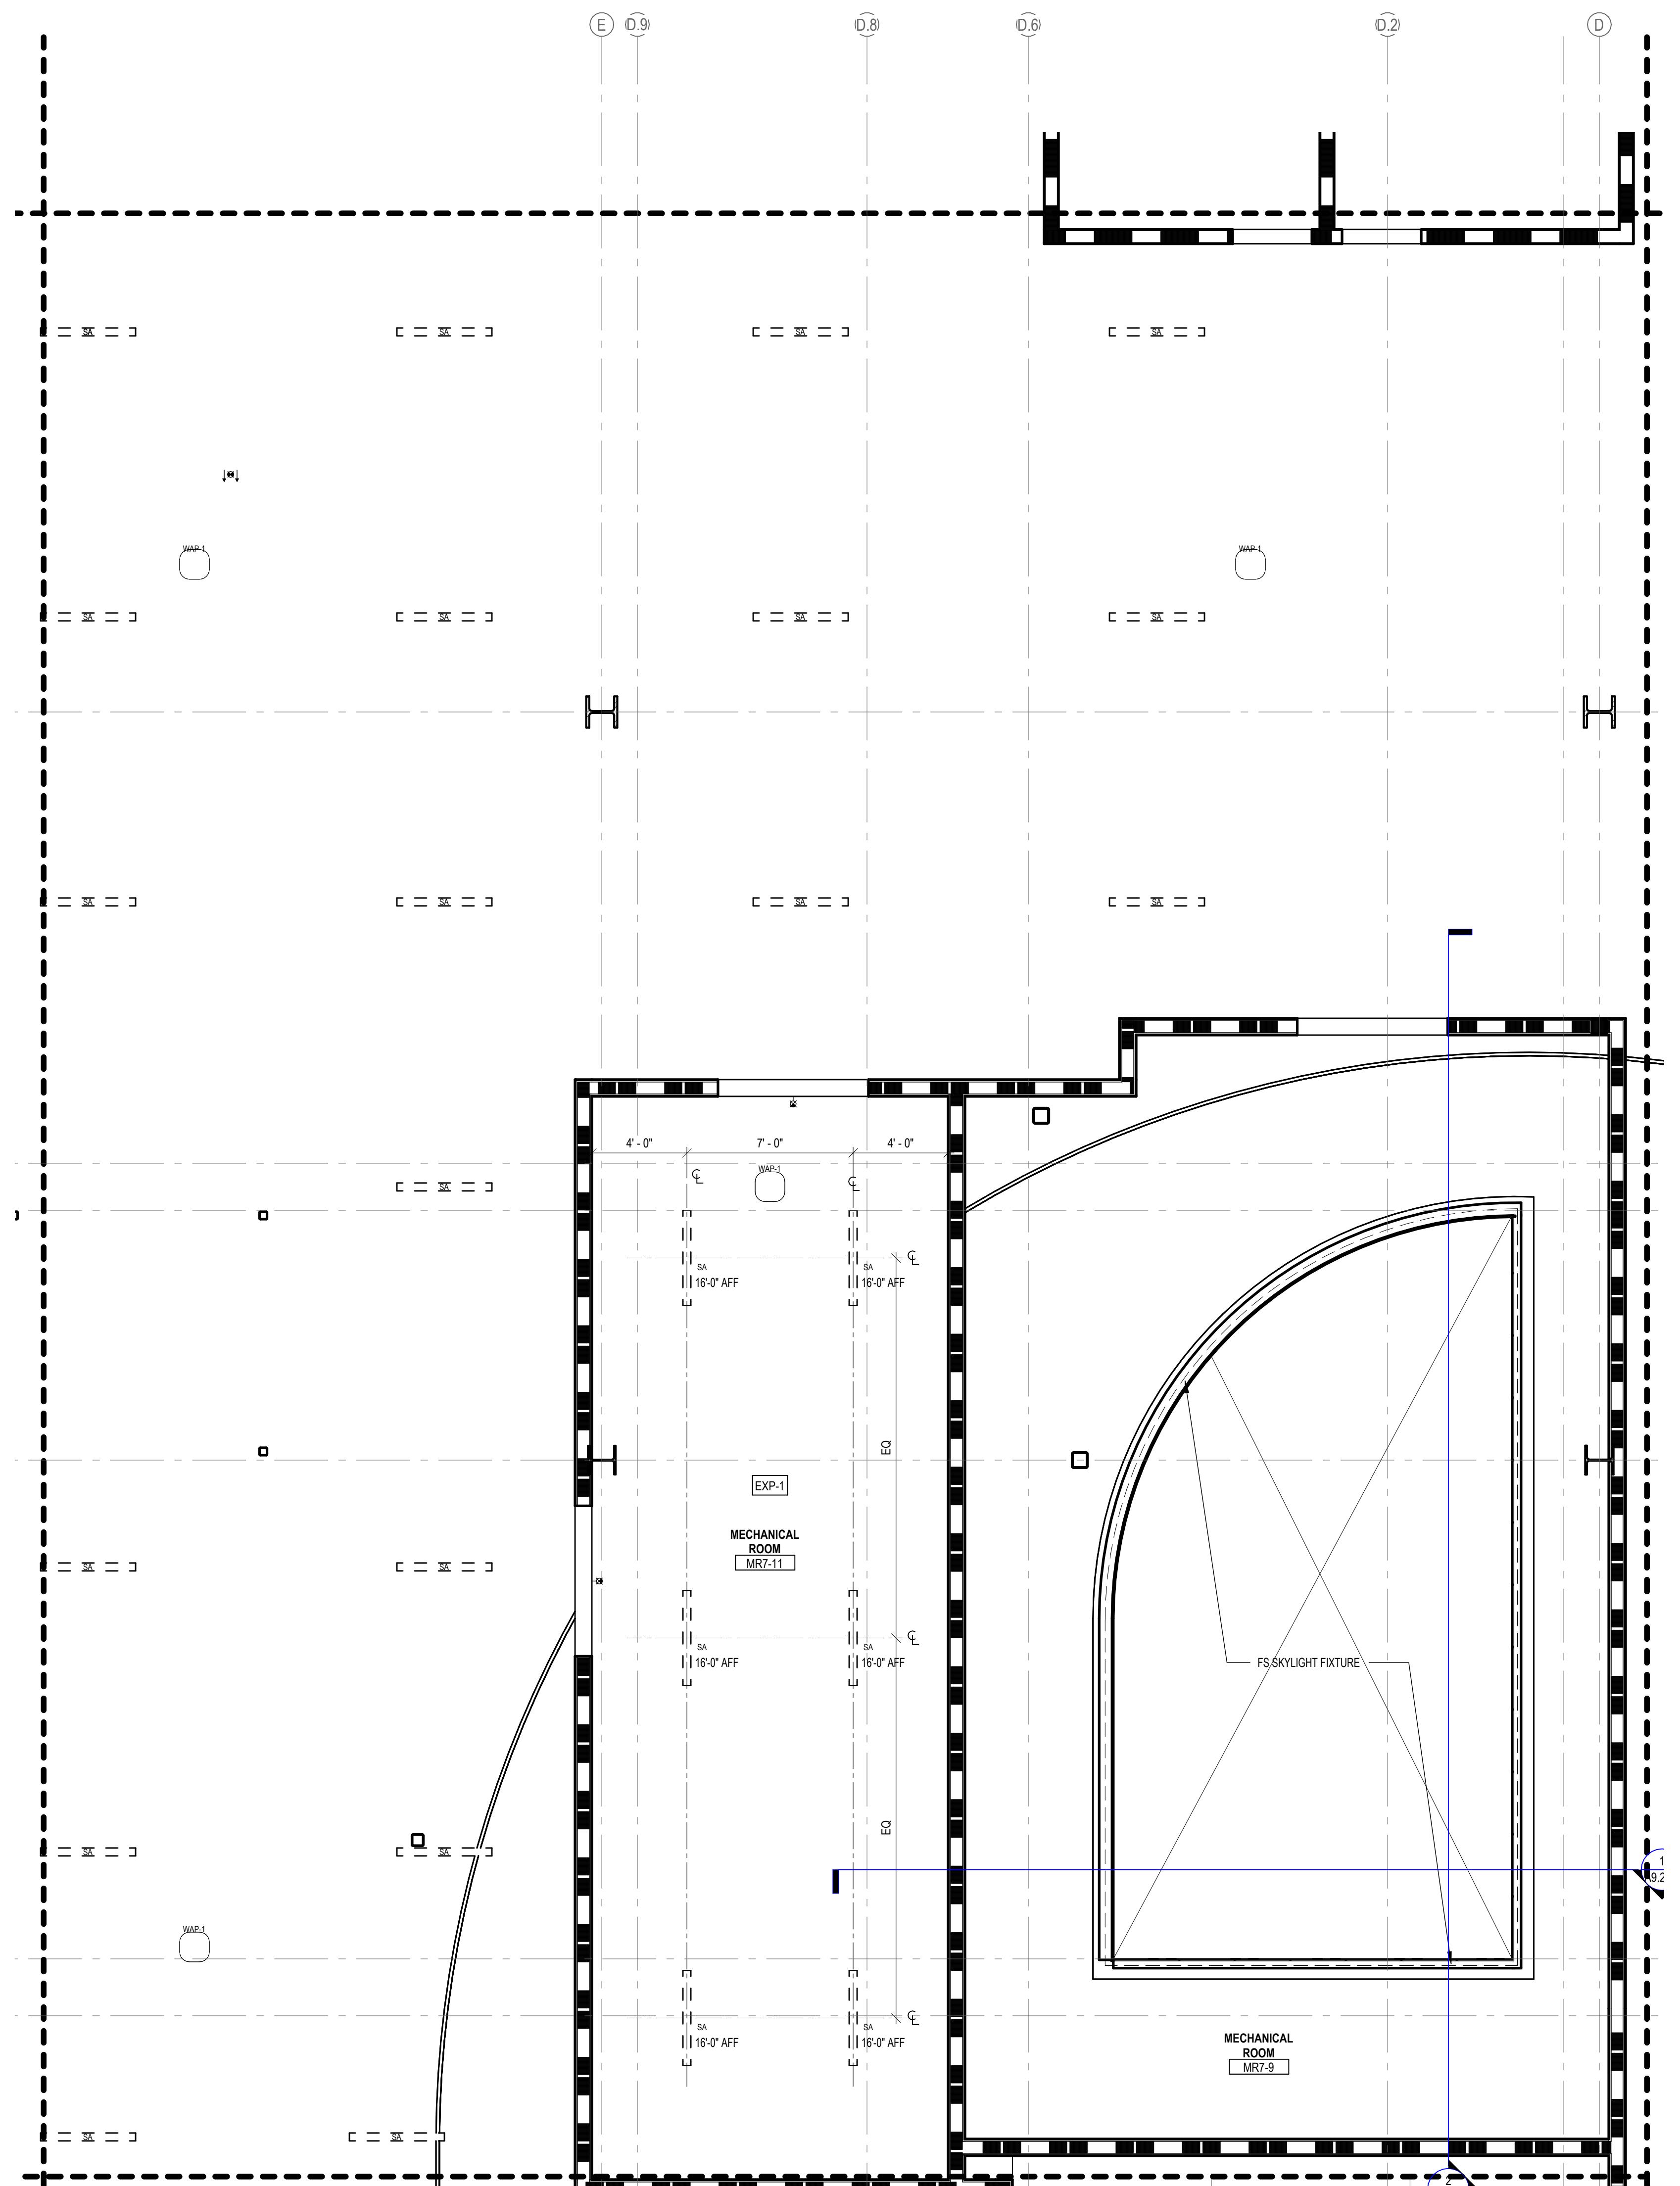

LEGEND - CEILING PLAN			NUMBER	DATE	DESCRIPTION
			10/24/25	ISSUED FOR CONSTRUCTION	
APC-1A	ACOUSTICAL PANEL CEILING (2X), LAB SUPPORT				
APC-1B	ACOUSTICAL PANEL CEILING (2X), DARK ROOM (BLACK)				
APC-2	ACOUSTICAL PANEL CEILING (2X), FOCUS ROOM (HIGH NRC)				
APC-3	ACOUSTICAL PANEL CEILING (2X), OPEN OFFICE				
APC-4	ACOUSTICAL PANEL CEILING (2X), OFFICES, CONF.				
APC-5	ACOUSTICAL PANEL CEILING (2X), OPEN LAB				
APC-6	ACOUSTICAL PANEL CEILING (2X), BOH				
APC-7	ACOUSTICAL PANEL CEILING (2X), WASHABLE, RADIOSPOT, FOOD SERVICE				
APC-8	ACOUSTICAL PANEL CEILING (2X), MOISTURE RESISTANT, LOADING DOCK				
APC-9	ACOUSTICAL PANEL CEILING (2X), SEMINAR, CONFERENCE				
FRP-1	FIBERGLASS REINFORCED CEILING PANELS				
GWB-1	GYPSUM BOARD CEILING, PAINTED				
GWB-2	GYPSUM BOARD CEILING WITH HPC				
GWB-3	ACOUSTICAL PLASTER CEILING				
EXP-1	EXPOSED TO STRUCTURE				
EXP-2	EXPOSED TO STRUCTURE WITH PAINTED MEP, HANGERS, ACOUSTIC SPRAY COATING AT DECK				
LWC-1	LINEAR WOOD CEILING ACOUSTIC INFILL PANEL SEE A9.73.1				
LWC-2	LINEAR WOOD CEILING WITH ACOUSTIC SPRAY COATING ABOVE SEE A9.73.1				
WPC-1	ACOUSTICAL WOOD PANEL CEILING				
MPC-1	MICRO-PERFORATED METAL PANEL CEILING				
MPC-2	PERFORATED METAL CEILING WITH NON-COMBUSTIBLE ACOUSTIC INFILL PANEL SEE A9.72				
ST-1	LINEAR WOOD CEILING SOFFITS				
ST-2.1	METAL PANEL SOFFIT - EXTERIOR SOFFIT POWDER COAT TO MATCH COPPER ANODIZED ALUM.				
ST-2.2	METAL PANEL SOFFIT - EXTERIOR SOFFIT POWDER COAT TO MATCH BRONZE ANODIZED ALUM.				
CSP-X	CEILING SERVICE PANEL SEE A10.05A FOR TYPES				
OHR	OVERHEAD SERVICE RACK, SEE A10.07 FOR DETAILS.				
(C)	CEILING MOUNTED SECURITY CAMERA, REFER TO SECURITY DWG				
	EXIT SIGN CEILING MOUNTED / WALL MOUNTED				
	CEILING MOUNTED SPRINKLERS, REFER TO PLUM. DWG				
	FIRE ALARM CEILING MOUNTED / WALL MOUNTED				
H	CEILING MOUNTED HEAT DETECTOR				
SD	CEILING MOUNTED SMOKE DETECTOR				
WAP-1	WIRELESS ACCESS POINT MOUNTED ON CEILING				
WAP-2	WIRELESS ACCESS POINT MOUNTED ABOVE CEILING				
OC	CEILING MOUNTED OCCUPANCY/PHOTOCELL SENSOR				
	EXHAUST CONNECTION @ CEILING - REF. MECH. DWGS				
	LINEAR WALL WASH				
<b>ROLLER SHADES:</b>					
RS-1	MOTORIZED ROLLER SHADE WITH SINGLE ROLLERS, LIGHT-FILTERING FABRIC.				
RS-2	MOTORIZED ROLLER SHADE WITH DOUBLE ROLLERS, MOISTURE-RESISTANT LIGHT-FILTERING FABRIC AND MOISTURE-RESISTANT OPAQUE FABRIC.				
RS-3	MOTORIZED ROLLER SHADE WITH SINGLE ROLLERS, MOISTURE-RESISTANT OPAQUE FABRIC, WITH WINDOW FRAME LIGHT BAFFLES.				
<b>GENERAL NOTES:</b>					
1.	FOR LIGHTING FIXTURE TYPES REFER TO LIGHTING SCHEDULE.				
2.	FOR SPRINKLER TYPES REFER TO FIRE PROTECTION DRAWINGS.				
3.	CENTER ALL DEVICES WITH TILES U.N.O.				
4.	DEVICES IN OFFICES ARE SHOWN FOR QUANTITIES, REFER TO A9.74.1 FOR TYPICAL LAYOUT				
<b>LEGEND - LIGHT FIXTURES</b>					
REFER TO MEP DRAWINGS AND SPECIFICATIONS					
XXXXXX	LINEAR PENDANT FIXTURE				
XXXXXX	SUSPENSION HEIGHT AFF				
XXXXXX	Fixture Length				
XXXXXX	Fixture Type				
XXXXXX	LINEAR RECESSED FIXTURE				
XXX	Fixture Length				
XXX	Fixture Type				
XXX	RECESSED DOWNLIGHT				
XXX	Fixture Type				
XXX	RECESSED 2X2 TROFFER				
XXX	Fixture Type				
XXX	RECESSED 2X4 TROFFER				
XXX	Fixture Type				
XXX	RECESSED ATRIUM DOWNLIGHT				
XXX	Fixture Type				
<b>JOHNS HOPKINS UNIVERSITY</b>					
1800 Orleans St Baltimore, Maryland 21287					
<b>ENLARGED REFLECTED CEILING PLAN - LEVEL 7 - SECTOR 8</b>					
Seal	Date: OCTOBER 24, 2025				
	Scale: As indicated				
	Drawn By:				
	Designed By:				
	Checked By:				
	Proj. Mgr.:				
	Payette Job No.: 17480.00				
	Cadd File:				
	Client Job No.: J.170.24.4000				
	Client Dwg. No.:				
	Professional Certification:				
	I certify that these documents were prepared or approved by me, and that they are duly licensed engineer under the laws of the State of Maryland.				
	License No. 9986 Expiration Date: 06/20/2026				
<b>A6.78</b>					

