


1 LEVEL 5 - ENLARGED OVERALL RCP - SECTOR A1
SCALE: 1/4" = 1'-0"

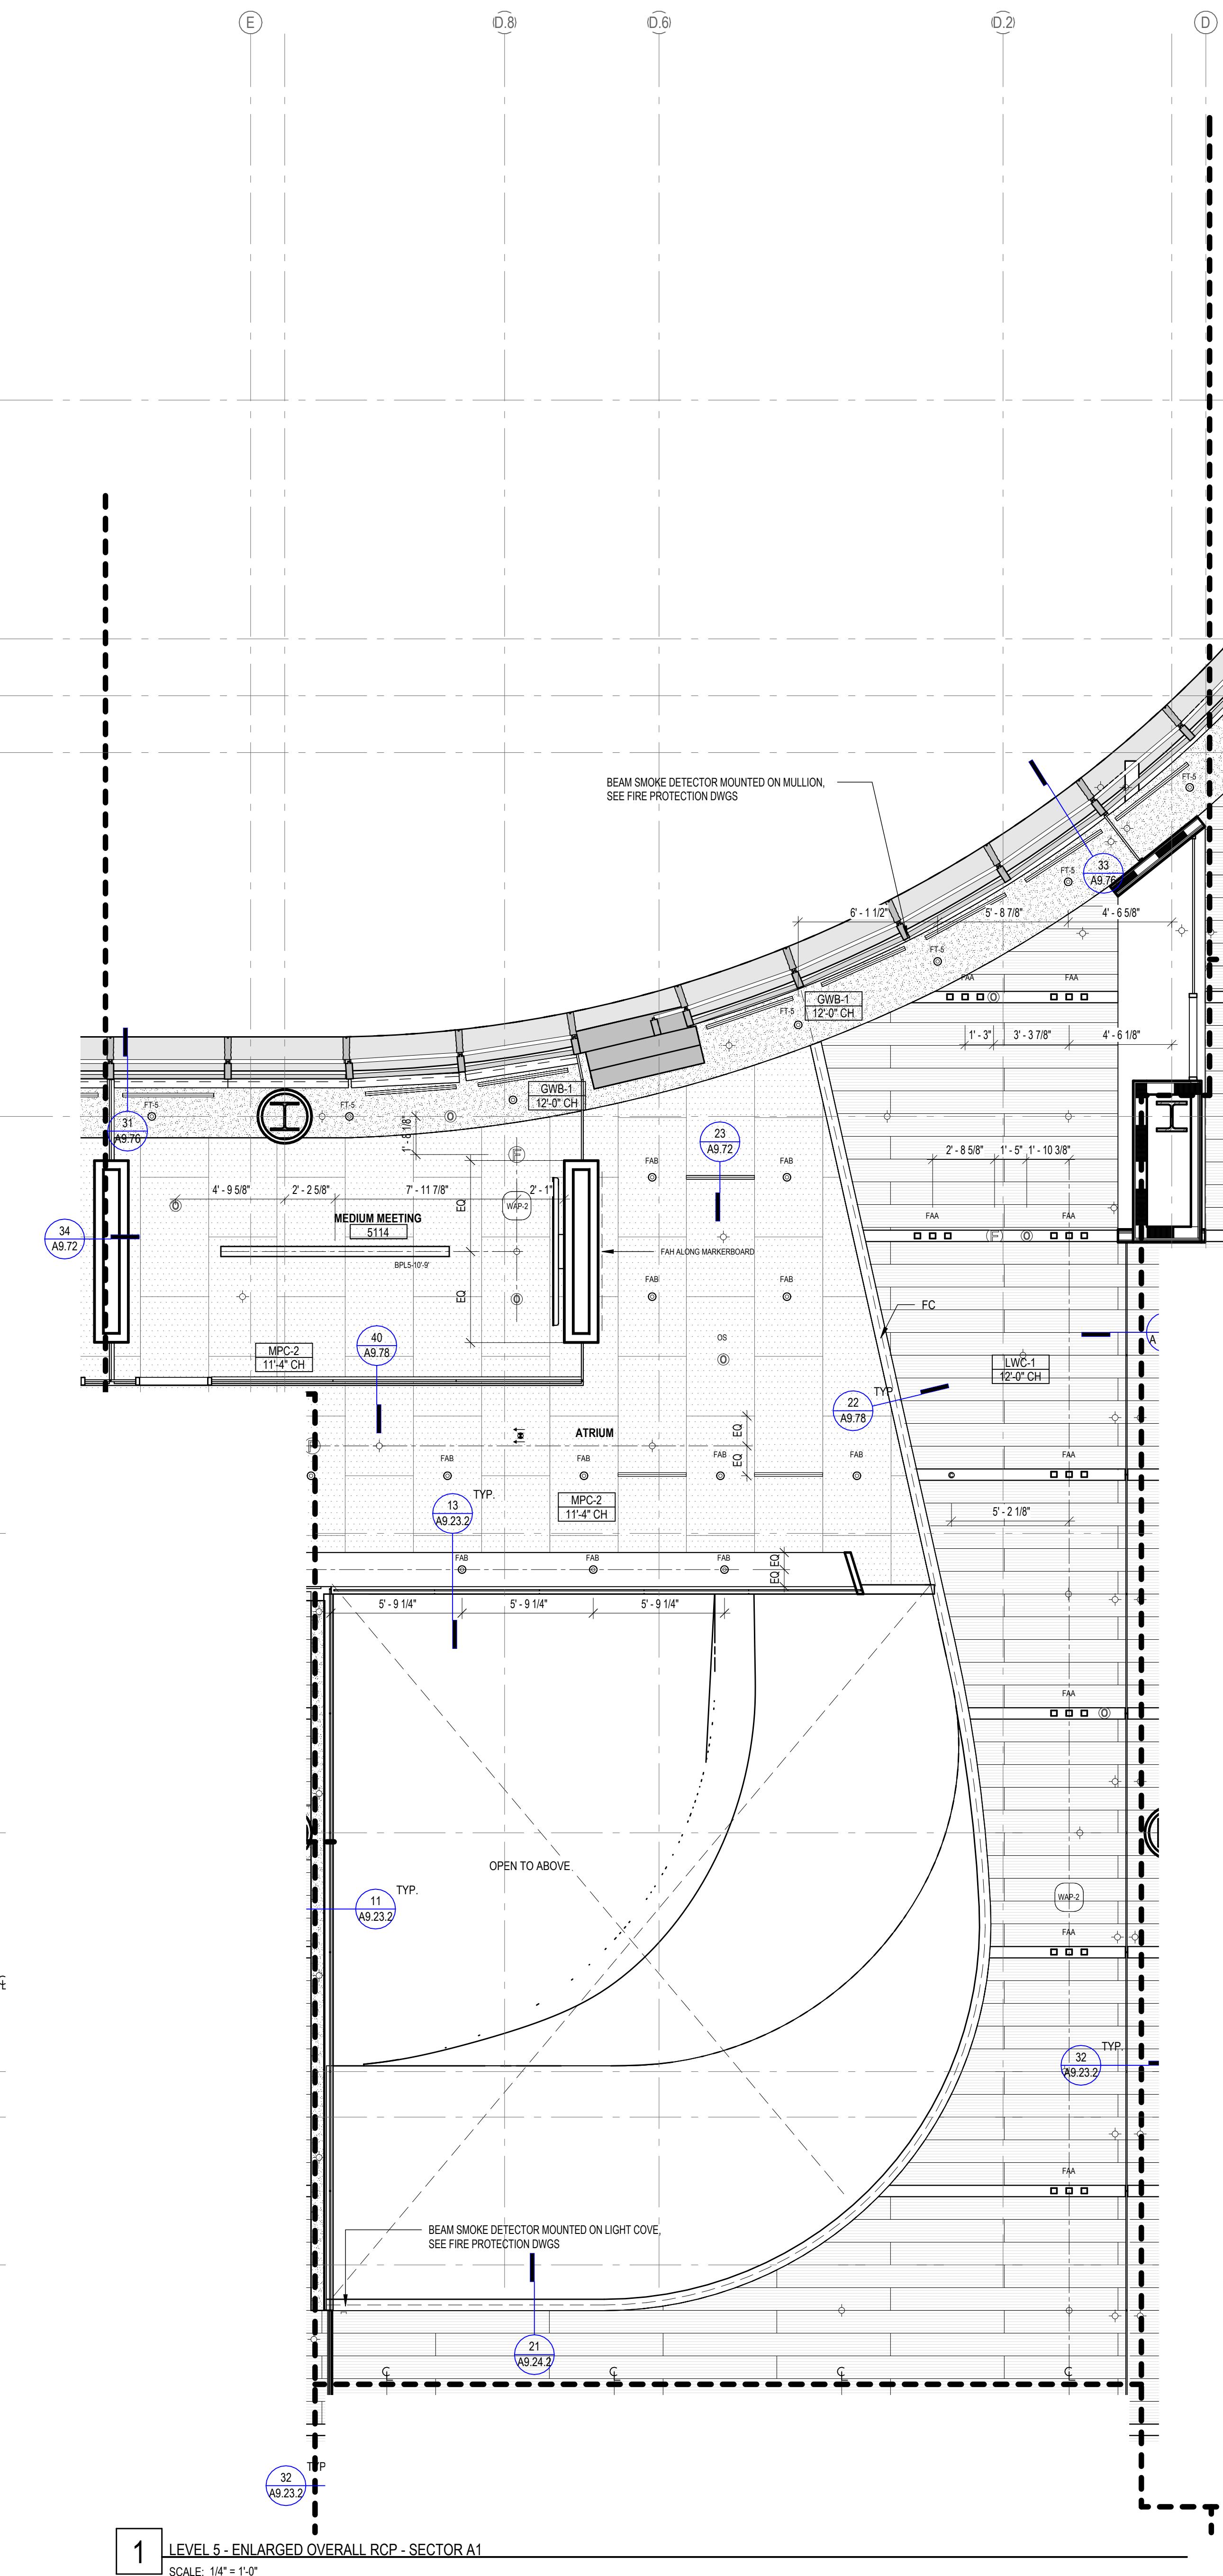

LEGEND - CEILING PLAN		NUMBER	DATE	DESCRIPTION
[Symbol]	APC-1A	ACOUSTICAL PANEL CEILING (2X), LAB SUPPORT		
[Symbol]	APC-1B	ACOUSTICAL PANEL CEILING (2X), DARK ROOM (BLACK)		
[Symbol]	APC-2	ACOUSTICAL PANEL CEILING (2X), FOCUS ROOM (HIGH NRC)		
[Symbol]	APC-3	ACOUSTICAL PANEL CEILING (2X), OPEN OFFICE		
[Symbol]	APC-4	ACOUSTICAL PANEL CEILING (2X), OFFICES, CONF.		
[Symbol]	APC-5	ACOUSTICAL PANEL CEILING (2X), OPEN LAB		
[Symbol]	APC-6	ACOUSTICAL PANEL CEILING (2X), BOH		
[Symbol]	APC-7	ACOUSTICAL PANEL CEILING (2X), WASHABLE, RADIOSPOT, FOOD SERVICE		
[Symbol]	APC-8	ACOUSTICAL PANEL CEILING (2X), MOISTURE RESISTANT, LOADING DOCK		
[Symbol]	APC-9	ACOUSTICAL PANEL CEILING (2X), SEMINAR, CONFERENCE		
[Symbol]	FRP-1	FIBERGLASS REINFORCED CEILING PANELS		
[Symbol]	GWB-1	GYPSUM BOARD CEILING, PAINTED		
[Symbol]	GWB-2	GYPSUM BOARD CEILING WITH HPC		
[Symbol]	GWB-3	ACOUSTICAL PLASTER CEILING		
[Symbol]	EXP-1	EXPOSED TO STRUCTURE		
[Symbol]	EXP-2	EXPOSED TO STRUCTURE WITH PAINTED MEP, HANGERS, ACOUSTIC SPRAY COATING AT DECK		
[Symbol]	LWC-1	LINEAR WOOD CEILING ACOUSTIC INFILL PANEL SEE A9.73.1		
[Symbol]	LWC-2	LINEAR WOOD CEILING WITH ACOUSTIC SPRAY COATING ABOVE SEE A9.73.1		
[Symbol]	WPC-1	ACOUSTICAL WOOD PANEL CEILING		
[Symbol]	MPC-1	MICRO-PERFORATED METAL PANEL CEILING		
[Symbol]	MPC-2	PERFORATED METAL CEILING WITH NON-COMBUSTIBLE ACOUSTIC INFILL PANEL SEE A9.72		
[Symbol]	ST-1	LINEAR WOOD CEILING SOFFITS		
[Symbol]	ST-2.1	METAL PANEL SOFFIT - EXTERIOR SOFFIT POWDER COAT TO MATCH COPPER ANODIZED ALUM.		
[Symbol]	ST-2.2	METAL PANEL SOFFIT - EXTERIOR SOFFIT POWDER COAT TO MATCH BRONZE ANODIZED ALUM.		
[Symbol]	CSP-X	CEILING SERVICE PANEL SEE A10.05A FOR TYPES		
[Symbol]	OHR	OVERHEAD SERVICE RACK, SEE A10.07 FOR DETAILS.		
[Symbol]	(C)	CEILING MOUNTED SECURITY CAMERA, REFER TO SECURITY DWG		
[Symbol]		EXIT SIGN CEILING MOUNTED / WALL MOUNTED		
[Symbol]		CEILING MOUNTED SPRINKLERS, REFER TO PLUM. DWG		
[Symbol]		FIRE ALARM CEILING MOUNTED / WALL MOUNTED		
[Symbol]	H	CEILING MOUNTED HEAT DETECTOR		
[Symbol]	SD	CEILING MOUNTED SMOKE DETECTOR		
[Symbol]	WAP-1	WIRELESS ACCESS POINT MOUNTED ON CEILING		
[Symbol]	WAP-2	WIRELESS ACCESS POINT MOUNTED ABOVE CEILING		
[Symbol]	OC	CEILING MOUNTED OCCUPANCY/PHOTOCELL SENSOR		
[Symbol]		EXHAUST CONNECTION @ CEILING - REF. MECH. DWGS		
[Symbol]		LINEAR WALL WASH		
ROLLER SHADES:				
[Symbol]	RS-1	MOTORIZED ROLLER SHADE WITH SINGLE ROLLERS, LIGHT-FILTERING FABRIC.		
[Symbol]	RS-2	MOTORIZED ROLLER SHADE WITH DOUBLE ROLLERS, MOISTURE-RESISTANT LIGHT-FILTERING FABRIC AND MOISTURE-RESISTANT OPAQUE FABRIC.		
[Symbol]	RS-3	MOTORIZED ROLLER SHADE WITH SINGLE ROLLERS, MOISTURE-RESISTANT OPAQUE FABRIC, WITH WINDOW FRAME LIGHT BAFFLES.		
GENERAL NOTES:				
1. FOR LIGHTING FIXTURE TYPES REFER TO LIGHTING SCHEDULE. 2. FOR SPRINKLER TYPES REFER TO FIRE PROTECTION DRAWINGS. 3. CENTER ALL DEVICES WITH TILES U.N.O. 4. DEVICES IN OFFICES ARE SHOWN FOR QUANTITIES, REFER TO A9.74.1 FOR TYPICAL LAYOUT				
LEGEND - LIGHT FIXTURES		REFER TO MEP DRAWINGS AND SPECIFICATIONS		
[Symbol]		— — — — —	LINEAR PENDANT FIXTURE	
		XXXXXX	SUSPENSION HEIGHT AFF	
			FIXTURE LENGTH	
			FIXTURE TYPE	
		XXXXXX	LINEAR RECESSED FIXTURE	
			FIXTURE LENGTH	
			FIXTURE TYPE	
		XXX	RECESSED DOWNLIGHT	
			FIXTURE TYPE	
		XXX	RECESSED 2X2 TROFFER	
			FIXTURE TYPE	
		XXX	RECESSED 2X4 TROFFER	
			FIXTURE TYPE	
		XXX	RECESSED ATRIUM DOWNLIGHT	
			FIXTURE TYPE	

JOHNS HOPKINS

UNIVERSITY


1800 Orleans St
Baltimore, Maryland 21287

ENLARGED REFLECTED CEILING PLAN - LEVEL 5 - SECTOR A1 + A2

Seal	Date: OCTOBER 24, 2025
	Scale: As indicated
	Drawn By:
	Designed By:
	Checked By:
	Proj. Mgr.: Payette Job No.: 17480.00
	Cadd File: Client Job No.: J.170.24.4000
	Client Dwg. No.: Client Dwg. No.


Professional Certification:
I hereby certify that these documents were prepared or approved by me, and that they are duly licensed engineer under the laws of the State of Maryland.
License No. 9986 Expiration Date: 06/20/2026

A6.50.A1

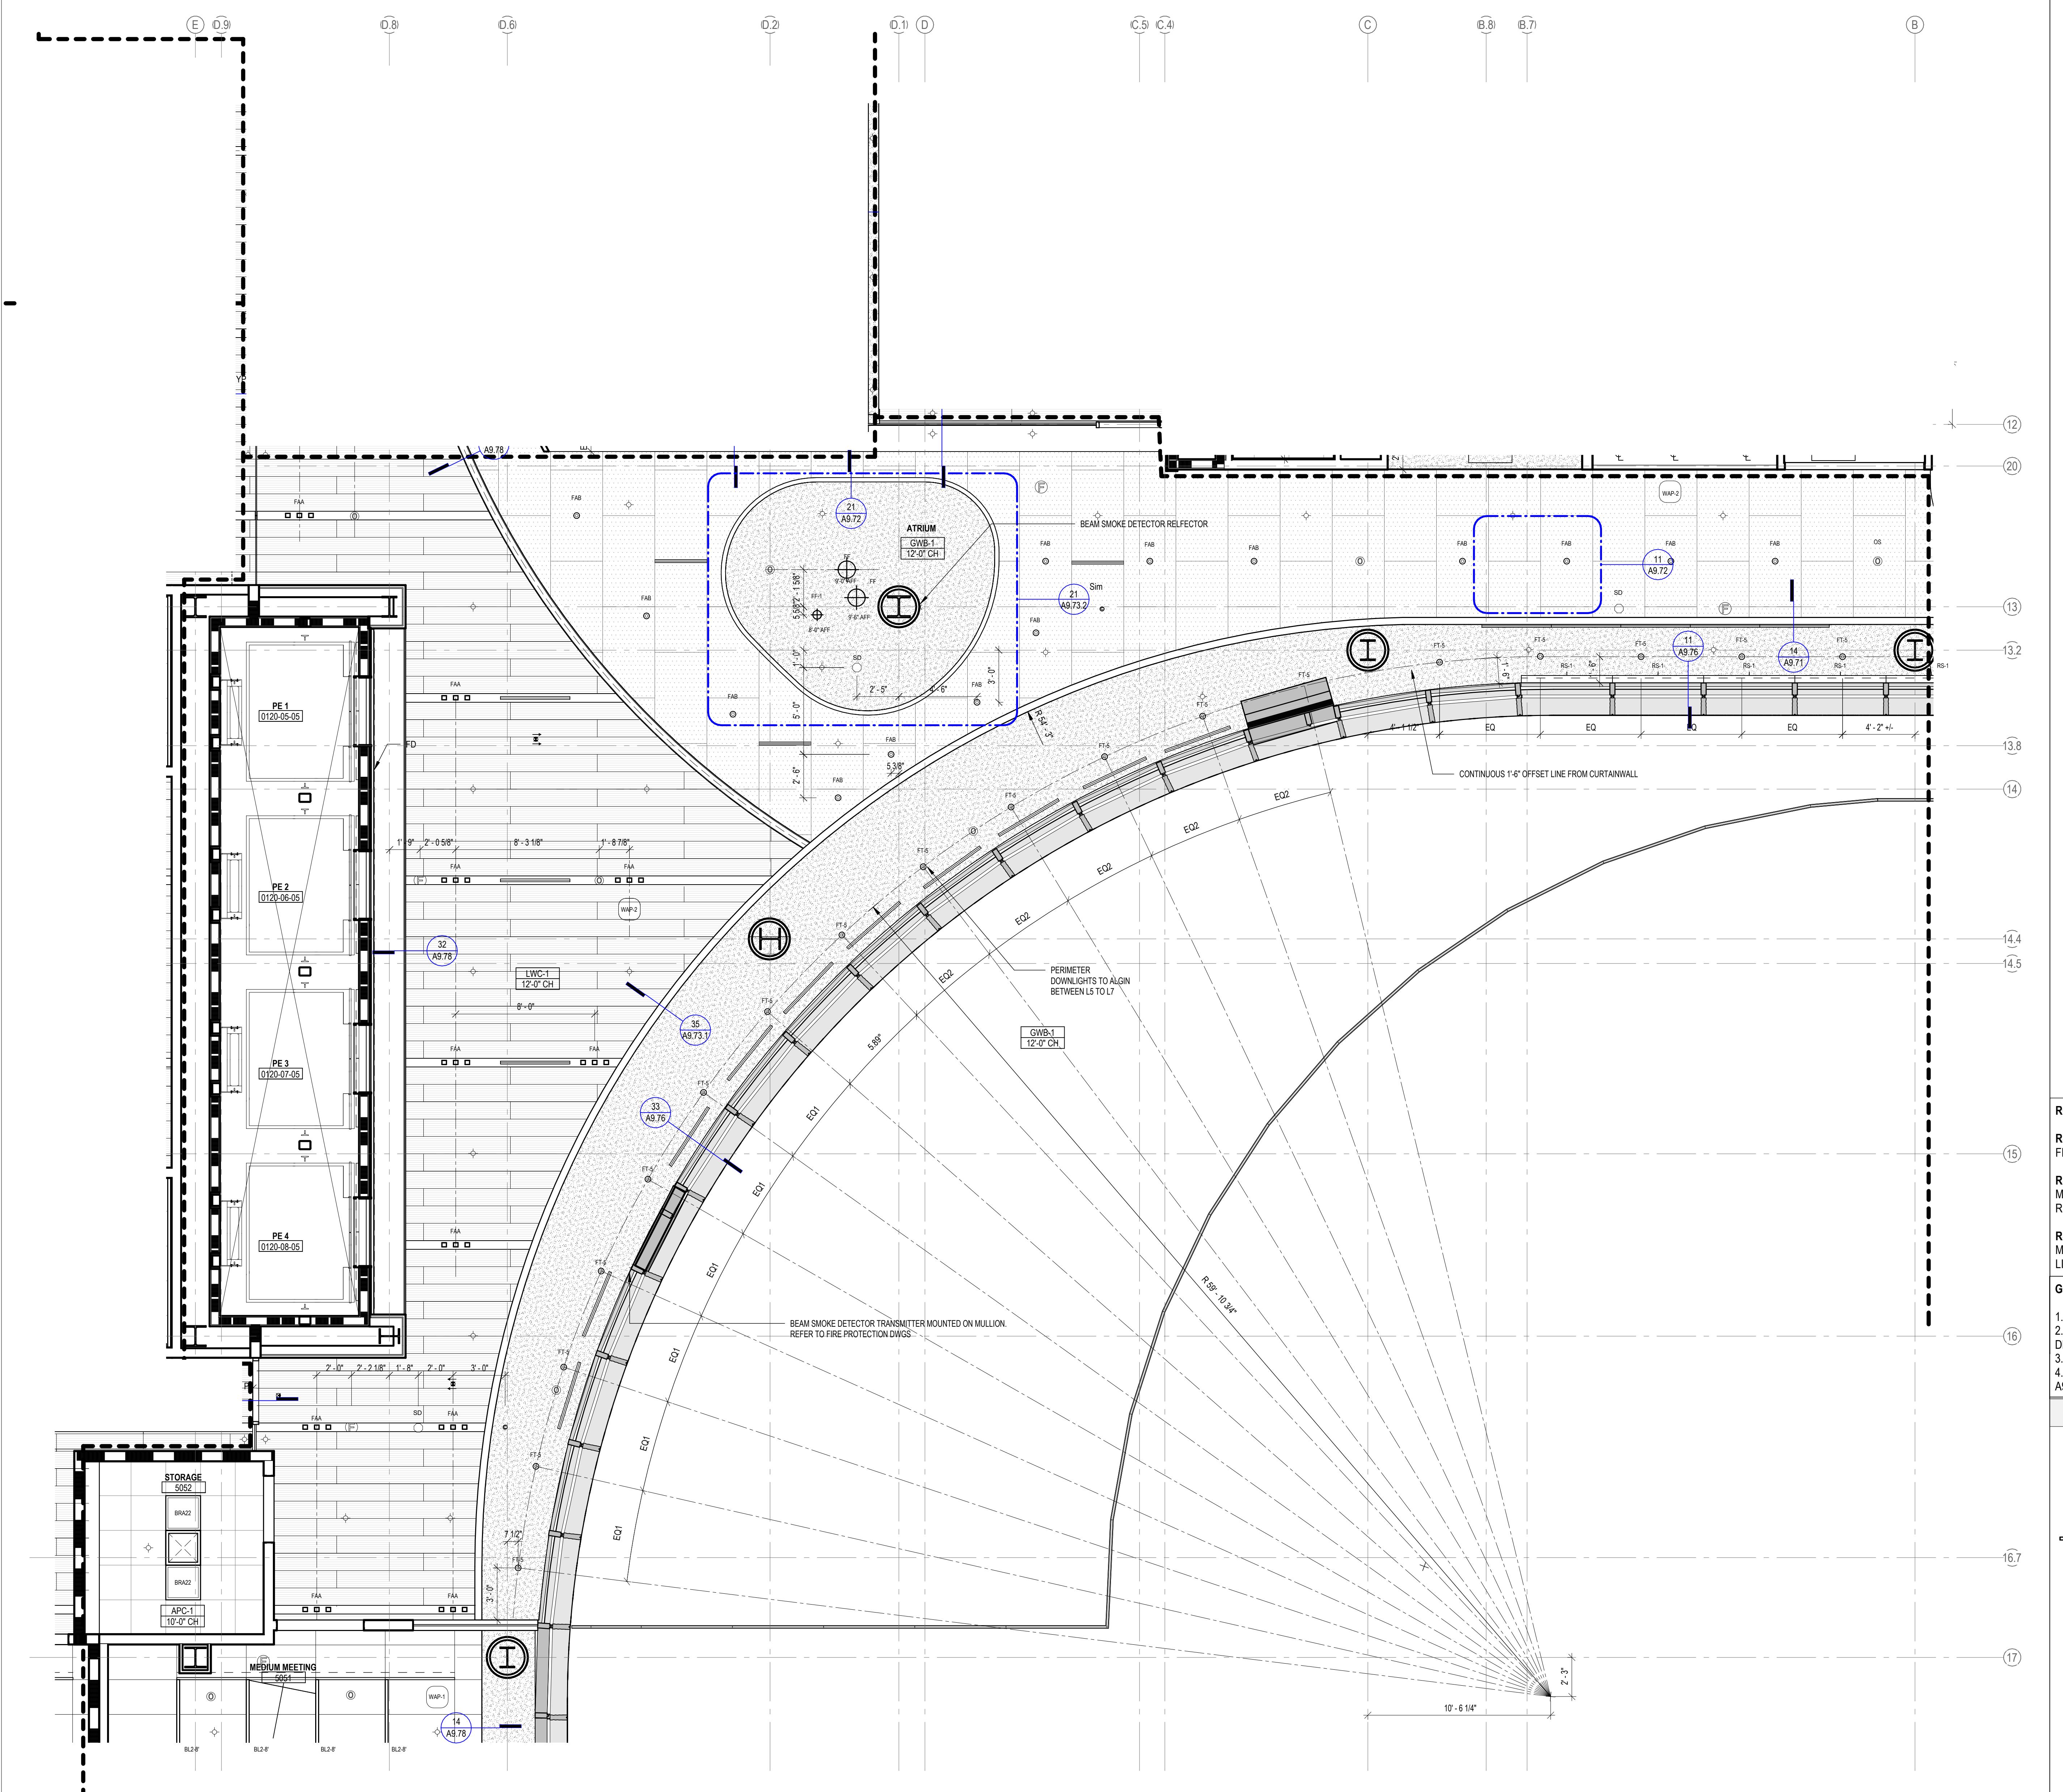


LEGEND - CEILING PLAN																						
	APC-1A	ACOUSTICAL PANEL CEILING (2X2), LAB SUPPORT																				
	APC-1B	ACOUSTICAL PANEL CEILING (2X2), DARK ROOM (BLACK)																				
	APC-2	ACOUSTICAL PANEL CEILING (2X2), FOCUS ROOM (HIGH NRC)																				
	APC-3	ACOUSTICAL PANEL CEILING (2X4), OPEN OFFICE																				
	APC-4	ACOUSTICAL PANEL CEILING (2X4), OFFICES, CONF.																				
	APC-5	ACOUSTICAL PANEL CEILING (2X4), OPEN LAB																				
	APC-6	ACOUSTICAL PANEL CEILING (2X2), BOH																				
	APC-7	ACOUSTICAL PANEL CEILING (2X2), WASHABLE, RADIOISOTOPE, FOOD SERVICE																				
	APC-8	ACOUSTICAL PANEL CEILING (2X2), MOISTURE RESISTANT, LOADING DOCK																				
	APC-9	ACOUSTICAL PANEL CEILING (2X4), SEMINAR, CONFERENCE																				
	FRP-1	FIBERGLASS REINFORCED CEILING PANELS																				
	GWB-1	GYPSUM BOARD CEILING, PAINTED																				
	GWB-2	GYPSUM BOARD CEILING WITH HPC																				
	GWB-3	ACOUSTICAL PLASTER CEILING																				
	EXP-1	EXPOSED TO STRUCTURE																				
	EXP-2	EXPOSED TO STRUCTURE WITH PAINTED MEP, HANGERS, ACOUSTIC SPRAY COATING AT DECK																				
	LWC-1	LINEAR WOOD CEILING ACOUSTIC INFILL PANEL SEE A9.73.1																				
	LWC-2	LINEAR WOOD CEILING WITH ACOUSTIC SPRAY COATING ABOVE SEE A9.73.1																				
	WPC-1	ACOUSTICAL WOOD PANEL CEILING																				
	MPC-1	MICRO-PERFORATED METAL PANEL CEILING																				
	MPC-2	PERFORATED METAL CEILING WITH NON-COMBUSTIBLE ACOUSTIC INFILL PANEL SEE A9.72																				
	ST-1	LINEAR WOOD CEILING SOFFITS																				
	ST-2.1	METAL PANEL SOFFIT - EXTERIOR SOFFIT POWDER COAT TO MATCH COPPER ANODIZED ALUM.																				
	ST-2.2	METAL PANEL SOFFIT - EXTERIOR SOFFIT POWDER COAT TO MATCH BRONZE ANODIZED ALUM.																				
	CSP-X	CEILING SERVICE PANEL. SEE A10.05A FOR TYPES.																				
	OHR	OVERHEAD SERVICE RACK, SEE A10.07 FOR DETAILS.																				
	C	CEILING MOUNTED SECURITY CAMERA, REFER TO SECURITY DWG																				
		EXIT SIGN CEILING MOUNTED / WALL MOUNTED																				
		CEILING MOUNTED SPRINKLERS, REFER TO PLUM. DWG																				
	F	FIRE ALARM CEILING MOUNTED / WALL MOUNTED																				
	H	CEILING MOUNTED HEAT DETECTOR																				
	SD	CEILING MOUNTED SMOKE DETECTOR																				
	WAP-1	WIRELESS ACCESS POINT MOUNTED ON CEILING																				
	WAP-2	WIRELESS ACCESS POINT MOUNTED ABOVE CEILING																				
	OC	CEILING MOUNTED OCCUPANCY/PHOTOCELL SENSOR																				
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RS-1 - MOTORIZED ROLLER SHADE WITH SINGLE ROLLERS, LIGHT-FILTERING FABRIC.																						
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RS-3 - MOTORIZED ROLLER SHADE WITH SINGLE ROLLERS, MOISTURE-RESISTANT OPAQUE FABRIC. WITH WINDOW FRAME LIGHT BAFFLES,																						
GENERAL NOTES:																						
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LEGEND - LIGHT FIXTURES																						
REFER TO MEP DRAWINGS AND SPECIFICATIONS																						
	XXXX-XX-9	LINEAR PENDANT FIXTURE SUSPENSION HEIGHT AFF Fixture Length Fixture Type																				
	XXXX-XX	LINEAR RECESSED FIXTURE Fixture Length Fixture Type																				
	XXX	RECESSED DOWNLIGHT Fixture Type																				
	XXX	RECESSED 2X2 TROFFER Fixture Type																				
	XXX	RECESSED 2X4 TROFFER Fixture Type																				
	XXX	RECESSED ATRIUM DOWNLIGHT Fixture Type																				
LIFE SCIENCES BUILDING 600 N Broadway Baltimore, MD 21205																						
JOHNS HOPKINS UNIVERSITY 1800 Orleans St Baltimore, Maryland 21287																						
ENLARGED REFLECTED CEILING PLAN - LEVEL 5 - SECTOR A3																						
<table border="1"> <tr> <td>Seal</td> <td>Date: OCTOBER 24, 2025</td> </tr> <tr> <td></td> <td>Scale: As indicated</td> </tr> <tr> <td></td> <td>Drawn By:</td> </tr> <tr> <td></td> <td>Designed By:</td> </tr> <tr> <td></td> <td>Checked By:</td> </tr> <tr> <td></td> <td>Proj. Mgr.:</td> </tr> <tr> <td></td> <td>Payette Job No.: 17480.00</td> </tr> <tr> <td></td> <td>Cadd File:</td> </tr> <tr> <td></td> <td>Client Job No.: J.170.24.4000</td> </tr> <tr> <td></td> <td>Client Dwg. No.:</td> </tr> </table> <p>Professional Certification.</p> <p>"I certify that these documents were prepared or approved by me, and that I am duly licensed engineer under the laws of the State of Maryland."</p> <p>License No. 19966 Expiration Date: 06/20/2026</p>			Seal	Date: OCTOBER 24, 2025		Scale: As indicated		Drawn By:		Designed By:		Checked By:		Proj. Mgr.:		Payette Job No.: 17480.00		Cadd File:		Client Job No.: J.170.24.4000		Client Dwg. No.:
Seal	Date: OCTOBER 24, 2025																					
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	Cadd File:																					
	Client Job No.: J.170.24.4000																					
	Client Dwg. No.:																					
A6.50.A2																						

A6.50.A2

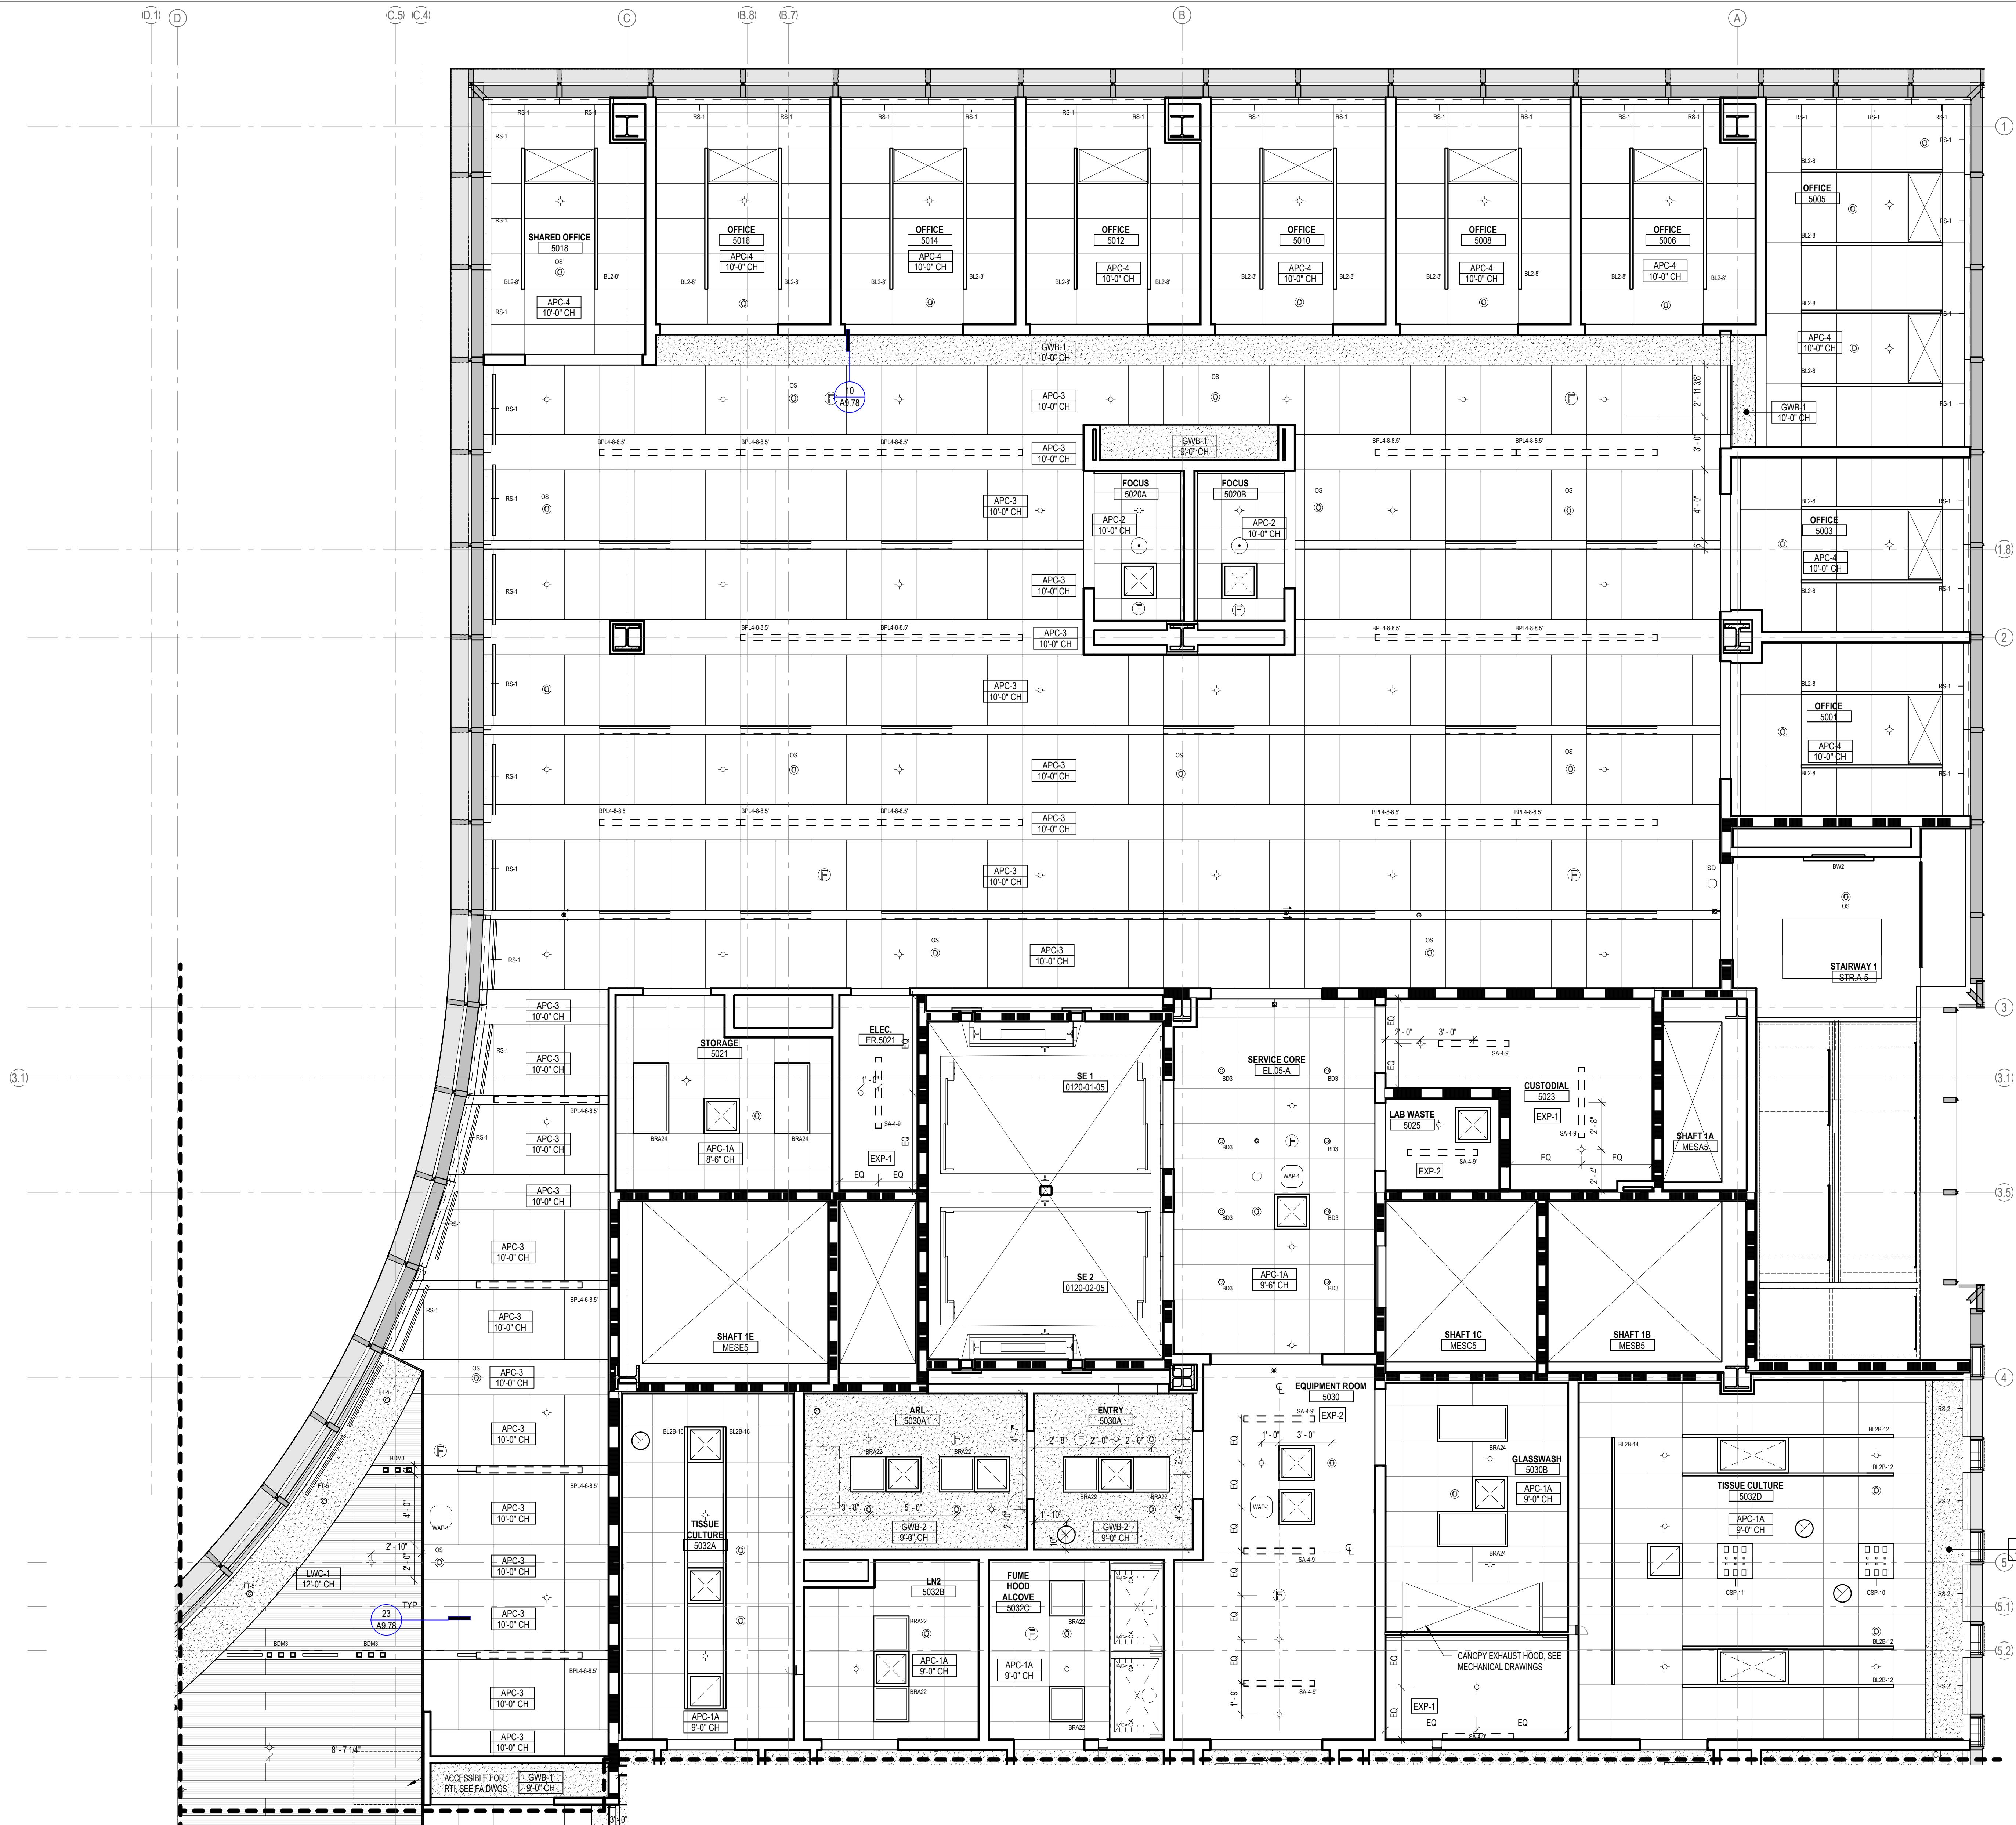

LEGEND - CEILING PLAN

APC-1A	ACOUSTICAL PANEL CEILING (2X2), LAB SUPPORT
APC-1B	ACOUSTICAL PANEL CEILING (2X2), DARK ROOM (BLACK)
APC-2	ACOUSTICAL PANEL CEILING (2X2), FOCUS ROOM (HIGH NRC)
APC-3	ACOUSTICAL PANEL CEILING (2X4), OPEN OFFICE
APC-4	ACOUSTICAL PANEL CEILING (2X4), OFFICES, CONF.
APC-5	ACOUSTICAL PANEL CEILING (2X4), OPEN LAB
APC-6	ACOUSTICAL PANEL CEILING (2X2), BOH
APC-7	ACOUSTICAL PANEL CEILING (2X2), WASHABLE, RADIOISOTOPE, FOOD SERVICE
APC-8	ACOUSTICAL PANEL CEILING (2X2), MOISTURE RESISTANT, LOADING DOCK
APC-9	ACOUSTICAL PANEL CEILING (2X4), SEMINAR, CONFERENCE
FRP-1	FIBERGLASS REINFORCED CEILING PANELS
GWB-1	GYPSUM BOARD CEILING, PAINTED
GWB-2	GYPSUM BOARD CEILING WITH HPC
GWB-3	ACOUSTICAL PLASTER CEILING
EXP-1	EXPOSED TO STRUCTURE
EXP-2	EXPOSED TO STRUCTURE WITH PAINTED MEP, HANGERS, ACOUSTIC SPRAY COATING AT DECK
LWC-1	LINEAR WOOD CEILING ACOUSTIC INFILL PANEL SEE A9.73.1
LWC-2	LINEAR WOOD CEILING WITH ACOUSTIC SPRAY COATING ABOVE SEE A9.73.1
WPC-1	ACOUSTICAL WOOD PANEL CEILING
MPC-1	MICRO-PERFORATED METAL PANEL CEILING
MPC-2	PERFORATED METAL CEILING WITH NON-COMBUSTIBLE ACOUSTIC INFILL PANEL SEE A9.72
ST-1	LINEAR WOOD CEILING SOFTITS
ST-2	METAL PANEL SOFFIT - EXTERIOR SOFFIT POWDER COAT TO MATCH COPPER ANODIZED ALUM.
ST-22	METAL PANEL SOFFIT - EXTERIOR SOFFIT POWDER COAT TO MATCH BRONZE ANODIZED ALUM. CEILING SERVICE PANEL SEE A1.05A FOR TYPES.
CSP-X	OVERHEAD SERVICE RACK, SEE A1.07 FOR DETAILS.
OHR	
(C)	CEILING MOUNTED SECURITY CAMERA, REFER TO SECURITY DWG.
(X) / (Y)	EXIT SIGN CEILING MOUNTED / WALL MOUNTED
(S)	CEILING MOUNTED SPRINKLERS, REFER TO PLUM. DWG.
(P) / (P)	FIRE ALARM CEILING MOUNTED / WALL MOUNTED
(H)	CEILING MOUNTED HEAT DETECTOR
(SD)	CEILING MOUNTED SMOKE DETECTOR
(WAP-1)	WIRELESS ACCESS POINT MOUNTED ON CEILING
(WAP-2)	WIRELESS ACCESS POINT MOUNTED ABOVE CEILING
(OC)	CEILING MOUNTED OCCUPANCY/PHOTOCELL SENSOR
(X)	EXHAUST CONNECTION @ CEILING - REF. MECH. DWG'S
(LW)	LINEAR WALL WASH

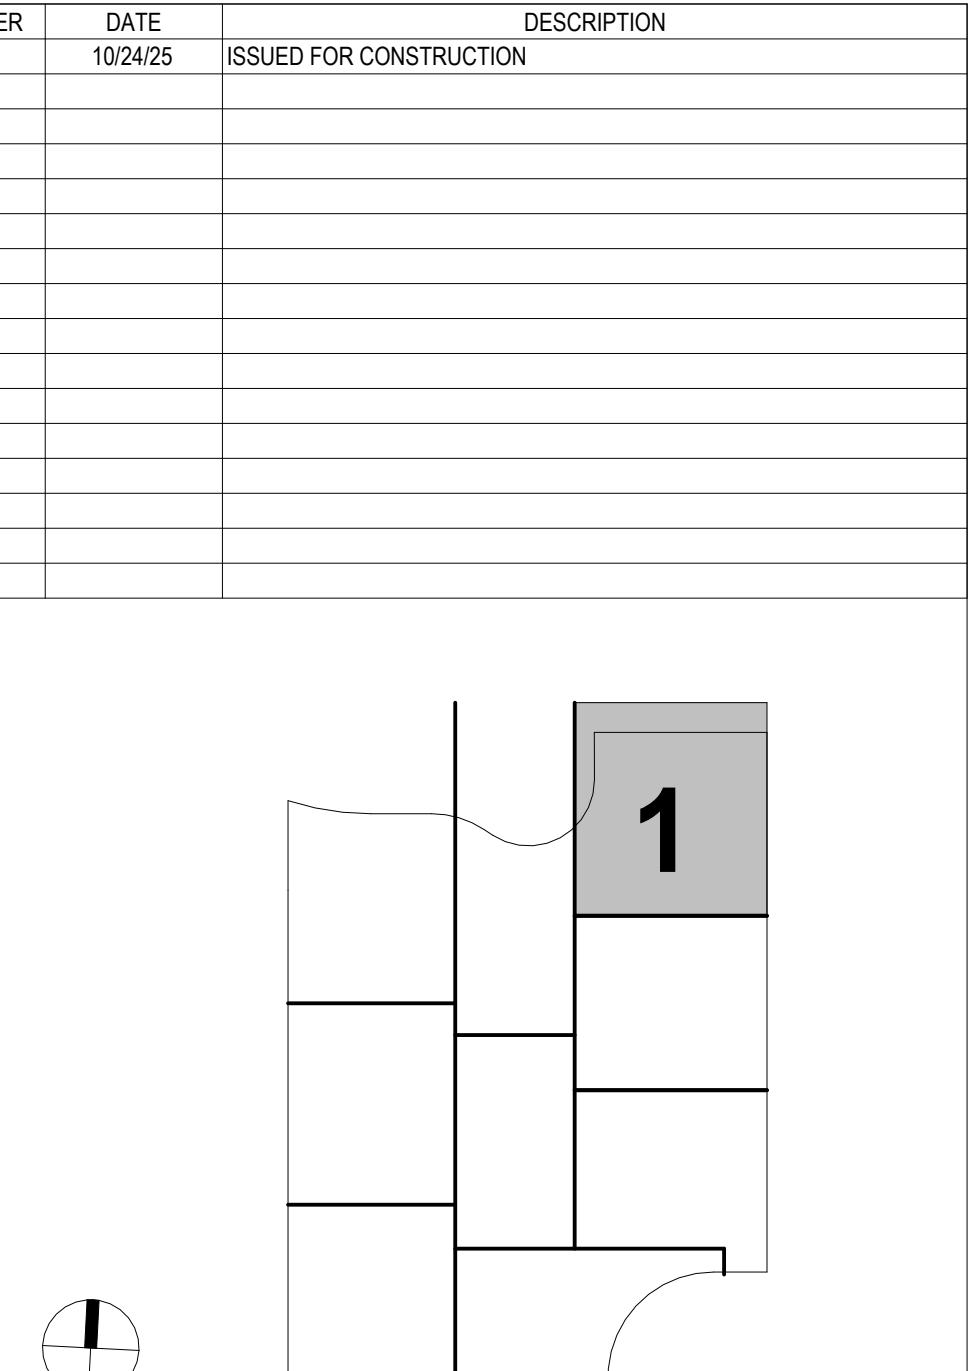

KEY PLAN

ARCHITECT PAYETTE ASSOCIATES, INC. 290 Congress Street, Fifth Floor Boston, MA 02210 617.695.1000	ASSOCIATE ARCHITECT KPN ARCHITECTS 1800 Washington Blvd, Suite 414 Baltimore, MD 21230 443.662.7757
CODE CODE RED CONSULTANTS 154 Tumpike Road, Suite 200 Southborough, MA 01772 617.720.7633	CIVIL RK&K 700 East Pratt Street, Suite 500 Baltimore, MD 21202 410.728.2900
LANDSCAPE ARCHITECT OLIN 1617 John F. Kennedy Boulevard, Suite 1900 Philadelphia, PA 19103 215.440.0030	STRUCTURAL COLUMBIA ENGINEERING, INC. 6210 Old Dobbins Lane, Suite 150 Baltimore, Maryland 21045 410.992.9970
VERTICAL TRANSPORTATION ZIPF ASSOCIATES, INC. 25 Bala Avenue, Suite 201 Bala Cynwyd, PA 19004 610.667.1717	MEP BR+A CONSULTING ENGINEERS 10 Guest Street, 4th Floor Boston, MA 02135 617.254.0016
FIRE ALARM & FIRE PROTECTION SETTY & ASSOCIATES 575 S. Charles Street, Suite 403 Baltimore, MD 21201 667.309.6036	AUDIO VISUAL & TELECOM CONVERGE TECHNOLOGIES DESIGN GROUP 6501 York Road Baltimore, MD 21212 410.532.2355
SECURITY THORNHILL TOMASSETTI 1330 Connecticut Ave, NW, Suite 300 Washington, DC 20036 202.580.6300	FOOD SERVICE COLURN GUYETTE 100 Ledgewood Place, Suite 104 Rockland, MA 02370 781.826.5522
BUILDING ENCLOSURE SIMPSON GUMPERTZ & HEGER 1625 Eye St NW Suite 900 Washington, DC 20006 202.667.4199	LEED SUSTAINABLE DESIGN CONSULTING 1432 K Street NW, 3rd Floor Washington, DC 20005 202.667.1620
WIND & AIR QUALITY RWRI 650 Woodland Rd. W. Guelph, Ontario Canada N1K 1B8 519.823.1311	VIBRATION & ACOUSTICS COLIN GORDON ASSOCIATES 1350 Old Bayshore Hwy, Suite 799 Burlingame, CA 94010 415.570.0350
LIGHTING FISHER MARANTZ STONE 22 West 19th Street, 6th Floor New York, NY 10011 212.691.3020	SITE LIGHTING TILLETT LIGHTING DESIGN ASSOCIATES 11 Hanover Square, 17th Floor New York, NY 10005 212.766.0144
EMI/RFI SHIELDING VITACHEK ELECTROMAGNETICS 115 Julliad Ct., Suite 105 Fredericksburg, VA 22406 540.286.1984	CAMPUS UTILITIES AEI AFFILIATED ENGINEERS 200 International Circle, Suite 5888 Hunt Valley, MD 21030 410.229.0090

LIFE SCIENCES BUILDING

600 N Broadway
Baltimore, MD 21205
1800 Orleans St
Baltimore, Maryland 21287

JOHNS HOPKINS UNIVERSITY


LEGEND - LIGHT FIXTURES

REFERS TO MEP DRAWINGS AND SPECIFICATIONS	
C = = = = =	LINEAR PENDANT FIXTURE
XXXXXX	SUSPENSION HEIGHT AFF
XXX	Fixture Length
XXX	Fixture Type
XXX	RECESSED DOWNLIGHT
XXX	RECESSED 2X2 TROFFER
XXX	RECESSED 2X4 TROFFER
XXX	RECESSED ATRIUM DOWNLIGHT
XXX	Fixture Type

Seal

Date:	OCTOBER 24, 2025
Scale:	As indicated
Drawn By:	
Designed By:	
Checked By:	
Proj. Mgr.:	
Payette Job No.:	17480.00
Cadd File:	
Client Job No.:	J.170.24.4000
Client Dwg. No.:	
Professional Certification:	
I hereby certify that these documents were prepared or approved by me, and that they are duly licensed engineer under the laws of the State of Maryland.	
License No. 99866 Expiration Date: 06/20/2026	

A6.51

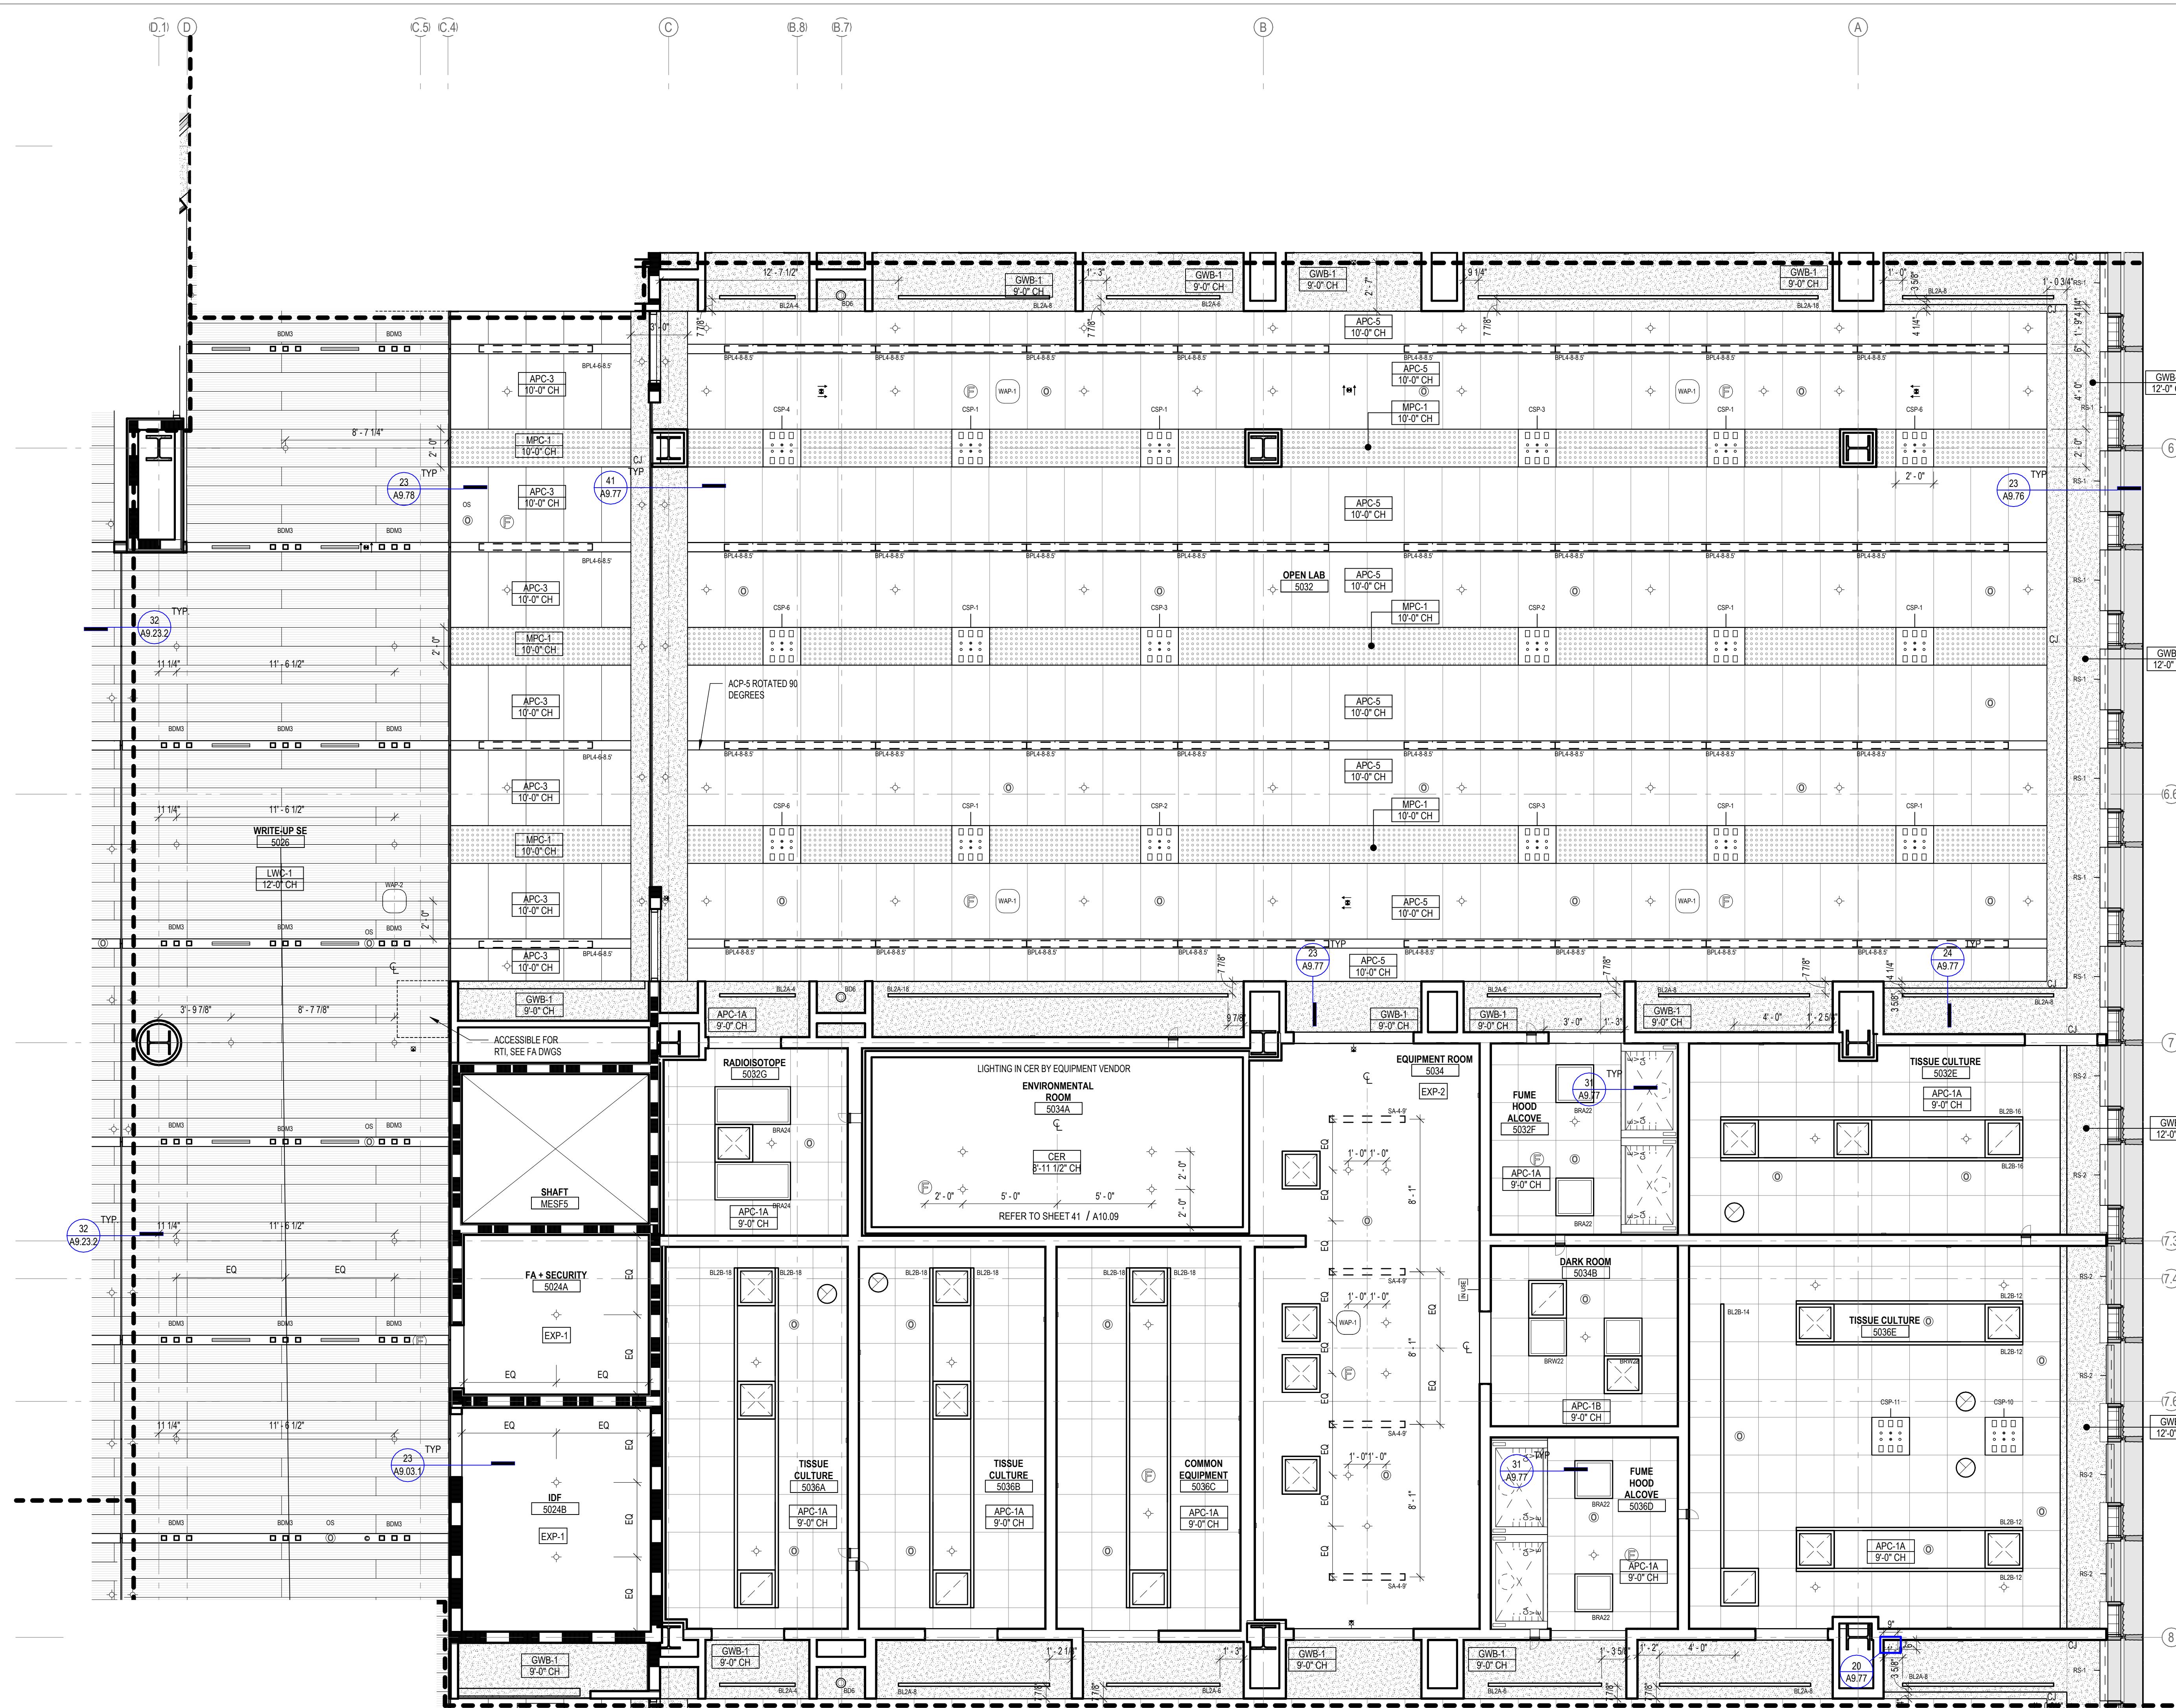

LEGEND - CEILING PLAN

	APC-1A	ACOUSTICAL PANEL CEILING (2X2), LAB SUPPORT
	APC-1B	ACOUSTICAL PANEL CEILING (2X2), DARK ROOM (BLACK)
	APC-2	ACOUSTICAL PANEL CEILING (2X2), FOCUS ROOM (HIGH NRC)
	APC-3	ACOUSTICAL PANEL CEILING (2X4), OPEN OFFICE
	APC-4	ACOUSTICAL PANEL CEILING (2X4), OFFICES, CONF.
	APC-5	ACOUSTICAL PANEL CEILING (2X4), OPEN LAB
	APC-6	ACOUSTICAL PANEL CEILING (2X2), BOH
	APC-7	ACOUSTICAL PANEL CEILING (2X2), WASHABLE, RADIOISOTOPE, FOOD SERVICE
	APC-8	ACOUSTICAL PANEL CEILING (2X2), MOISTURE RESISTANT, LOADING DOCK
	APC-9	ACOUSTICAL PANEL CEILING (2X4), SEMINAR, CONFERENCE
	FRP-1	FIBERGLASS REINFORCED CEILING PANELS
	GWB-1	GYPSUM BOARD CEILING, PAINTED
	GWB-2	GYPSUM BOARD CEILING WITH HPC
	GWB-3	ACOUSTICAL PLASTER CEILING
	EXP-1	EXPOSED TO STRUCTURE
	EXP-2	EXPOSED TO STRUCTURE WITH PAINTED MEP, HANGERS, ACOUSTIC SPRAY COATING AT DECK
	LWC-1	LINEAR WOOD CEILING ACOUSTIC INFILL PANEL SEE A9.73.1
	LWC-2	LINEAR WOOD CEILING WITH ACOUSTIC SPRAY COATING ABOVE SEE A9.73.1
	WPC-1	ACOUSTICAL WOOD PANEL CEILING
	MPC-1	MICRO-PERFORATED METAL PANEL CEILING
	MPC-2	PERFORATED METAL CEILING WITH NON-COMBUSTIBLE ACOUSTIC INFILL PANEL SEE A9.72
	ST-1	LINEAR WOOD CEILING SOFFITS
	ST-2.1	METAL PANEL SOFFIT - EXTERIOR SOFFIT POWDER COAT TO MATCH COPPER ANODIZED ALUM.
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	CSP-X	CEILING SERVICE PANEL. SEE A10.05A FOR TYPES.
	OHR	OVERHEAD SERVICE RACK, SEE A10.07 FOR DETAILS.
	C	CEILING MOUNTED SECURITY CAMERA, REFER TO SECURITY DWG
	/	EXIT SIGN CEILING MOUNTED / WALL MOUNTED
		CEILING MOUNTED SPRINKLERS, REFER TO PLUM. DWG
	/	FIRE ALARM CEILING MOUNTED / WALL MOUNTED
	H	CEILING MOUNTED HEAT DETECTOR
	SD	CEILING MOUNTED SMOKE DETECTOR
	WAP-1	WIRELESS ACCESS POINT MOUNTED ON CEILING
	WAP-2	WIRELESS ACCESS POINT MOUNTED ABOVE CEILING
	OC	CEILING MOUNTED OCCUPANCY/PHOTOCELL SENSOR
		EXHAUST CONNECTION @ CEILING - REF. MECH. DWG'S

ROLLER SHADES:

RS-1 - MOTORIZED ROLLER SHADE WITH SINGLE ROLLERS, LIGHT-FILTERING FABRIC.

**RS-2 - MOTORIZED ROLLER SHADE WITH DOUBLE ROLLERS,
MOISTURE-RESISTANT LIGHT-FILTERING FABRIC AND MOISTURE-**

RS-3 - MOTORIZED ROLLER SHADE WITH SINGLE ROLLERS,


MOISTURE-RESISTANT OPAQUE FABRIC. WITH WINDOW FRAME
LIGHT BAFFLES,

GENERAL NOTES:

1. FOR LIGHTING FIXTURE TYPES REFER TO LIGHTING SCHEDULE.
2. FOR SPRINKLER TYPES REFER TO FIRE PROTECTION DRAWINGS.
3. CENTER ALL DEVICES WITH TILES U.N.O
4. DEVICES IN OFFICES ARE SHOWN FOR QUANTITIES, REFER TO

A9.74.1 FOR TYPICAL LAYOUT

REFER TO MEP DRAWINGS AND SPECIFICATIONS

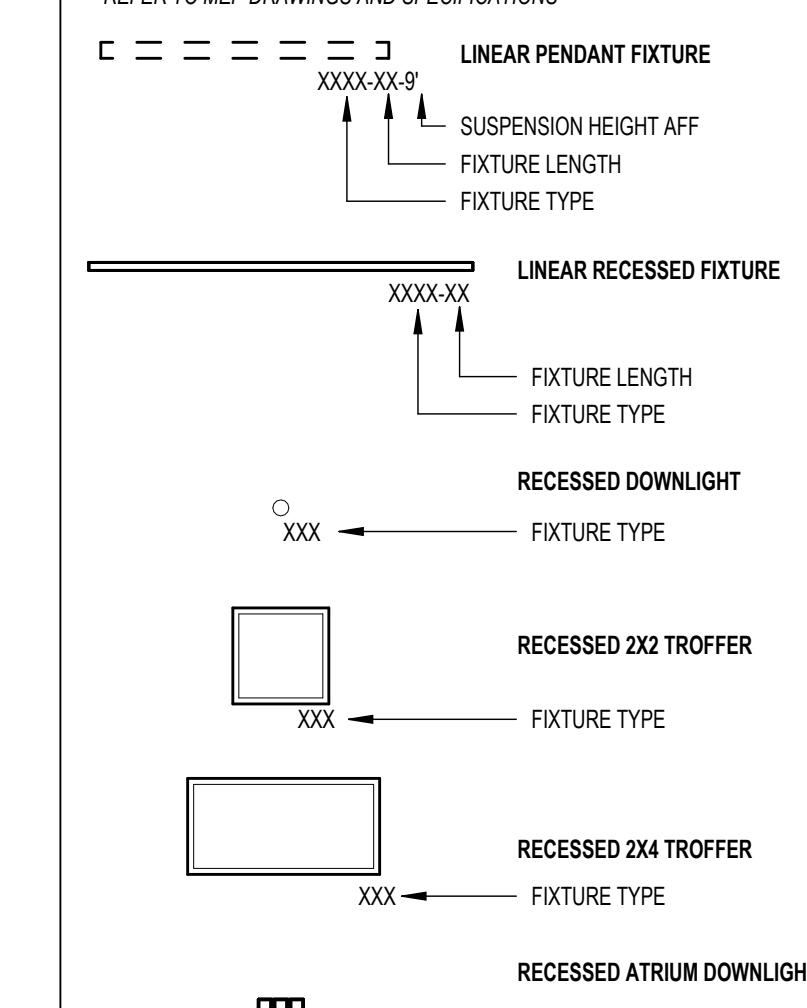

The diagram consists of a vertical stack of six rectangles. From top to bottom: 1) A tall rectangle with a wavy top edge. 2) A short rectangle. 3) A medium rectangle. 4) A short rectangle. 5) A medium rectangle. 6) A short rectangle at the base. A thick vertical line runs through the center of the stack. To the right of the stack, the fourth rectangle from the top is filled with a solid gray color and contains a large, bold black number '2'. To the left of the stack is a small circle containing a crosshair symbol, similar to a compass rose.

KEY PLAN

ARCHITECT
PAYETTE ASSOCIATES, INC.
290 Congress Street, Fifth Floor
Boston, MA 02210
617.895.1000

ASSOCIATE ARCHITECT
KPN ARCHITECTS
1800 Washington Blvd, Suite 414
Baltimore, MD 21230
443.682.7757

CODE CODE RED CONSULTANTS 154 Turnpike Road, Suite 200 Southborough, MA 01772 617.500.7633	CIVIL RK&K 700 East Pratt Street, Suite 500 Baltimore, MD 21202 410.728.2900
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LANDSCAPE ARCHITECT
OLIN
1617 John F. Kennedy Boulevard,
Suite 1900
Philadelphia, PA 19103
215.419.0030

STRUCTURAL
COLUMBIA ENGINEERING, INC.
6210 Old Dobbin Lane, Suite 150
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410.992.9970

VERTICAL TRANSPORTATION
ZIPF ASSOCIATES, INC.
25 Bala Avenue, Suite 201
Bala Cynwyd, PA 19004
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MEP
BR+A CONSULTING ENGINEERS
10 Guest Street, 4th Floor
Boston, MA 02135
617.254.0016

FIRE ALARM & FIRE PROTECTION **AUDIO VISUAL & TELECOM**

575 S. Charles Street, Suite 403
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Baltimore, MD 21212
410.532.2395

SECURITY
THORNTON TOMASETTI

FOOD SERVICE
GOLDBURN GUYETTE

1550 Connecticut Ave., NW,
Suite 300
Washington, DC 20036
202.580.6300

100 Ledgewood Place, Suite 104
Rockland, MA, 02370
781.826.5522

**1625 Eye St NW
Suite 900
Washington, DC 20006
202.239.4199**

**CONSULTING
1432 K Street NW, 3rd Floor
Washington, DC 20005
202.667.1620**

650 Woodland Rd.
W. Guelph, Ontario
Canada N1K 1B8
519.823.1311

1350 Old Bayshore Hwy, Suite 799
Burlingame, CA 94010
415.570.0350

**THEATRICAL LIGHTING DESIGN
ASSOCIATES**
11 Hanover Square, 17th Floor
New York, NY 10005
212.766.0144

VITATECH ELECTROMAGNETICS
115 Juliad Ct., Suite 105
Fredericksburg, VA 22406
540.286.1984

CAMPUS UTILITIES
AEI AFFILIATED ENGINEERS
200 International Circle, Suite 5888
Hunt Valley, MD 21030
410.339.0000

LIFE SCIENCES BUILDING


600 N Broadway
Baltimore, MD 21205


Baltimore, MD 21205

JOHNS HOPKINS





Baltimore, Maryland 21207

Seal	
	
Date:	OCTOBER 24, 2025
Scale:	As indicated
Drawn By:	
Designed By:	
Checked By:	
Proj. Mgr.:	
Payette Job No.:	17480.00
Cadd File:	
Client Job No.:	J.170.24.4000
Client Dwg. No.:	
<p>professional Certification.</p> <p>I certify that these documents were prepared or approved by me, and that I am duly licensed engineer under the laws of the State of Maryland.</p> <p>License No. 19966 Expiration Date: 06/20/2026</p>	
A6.52	

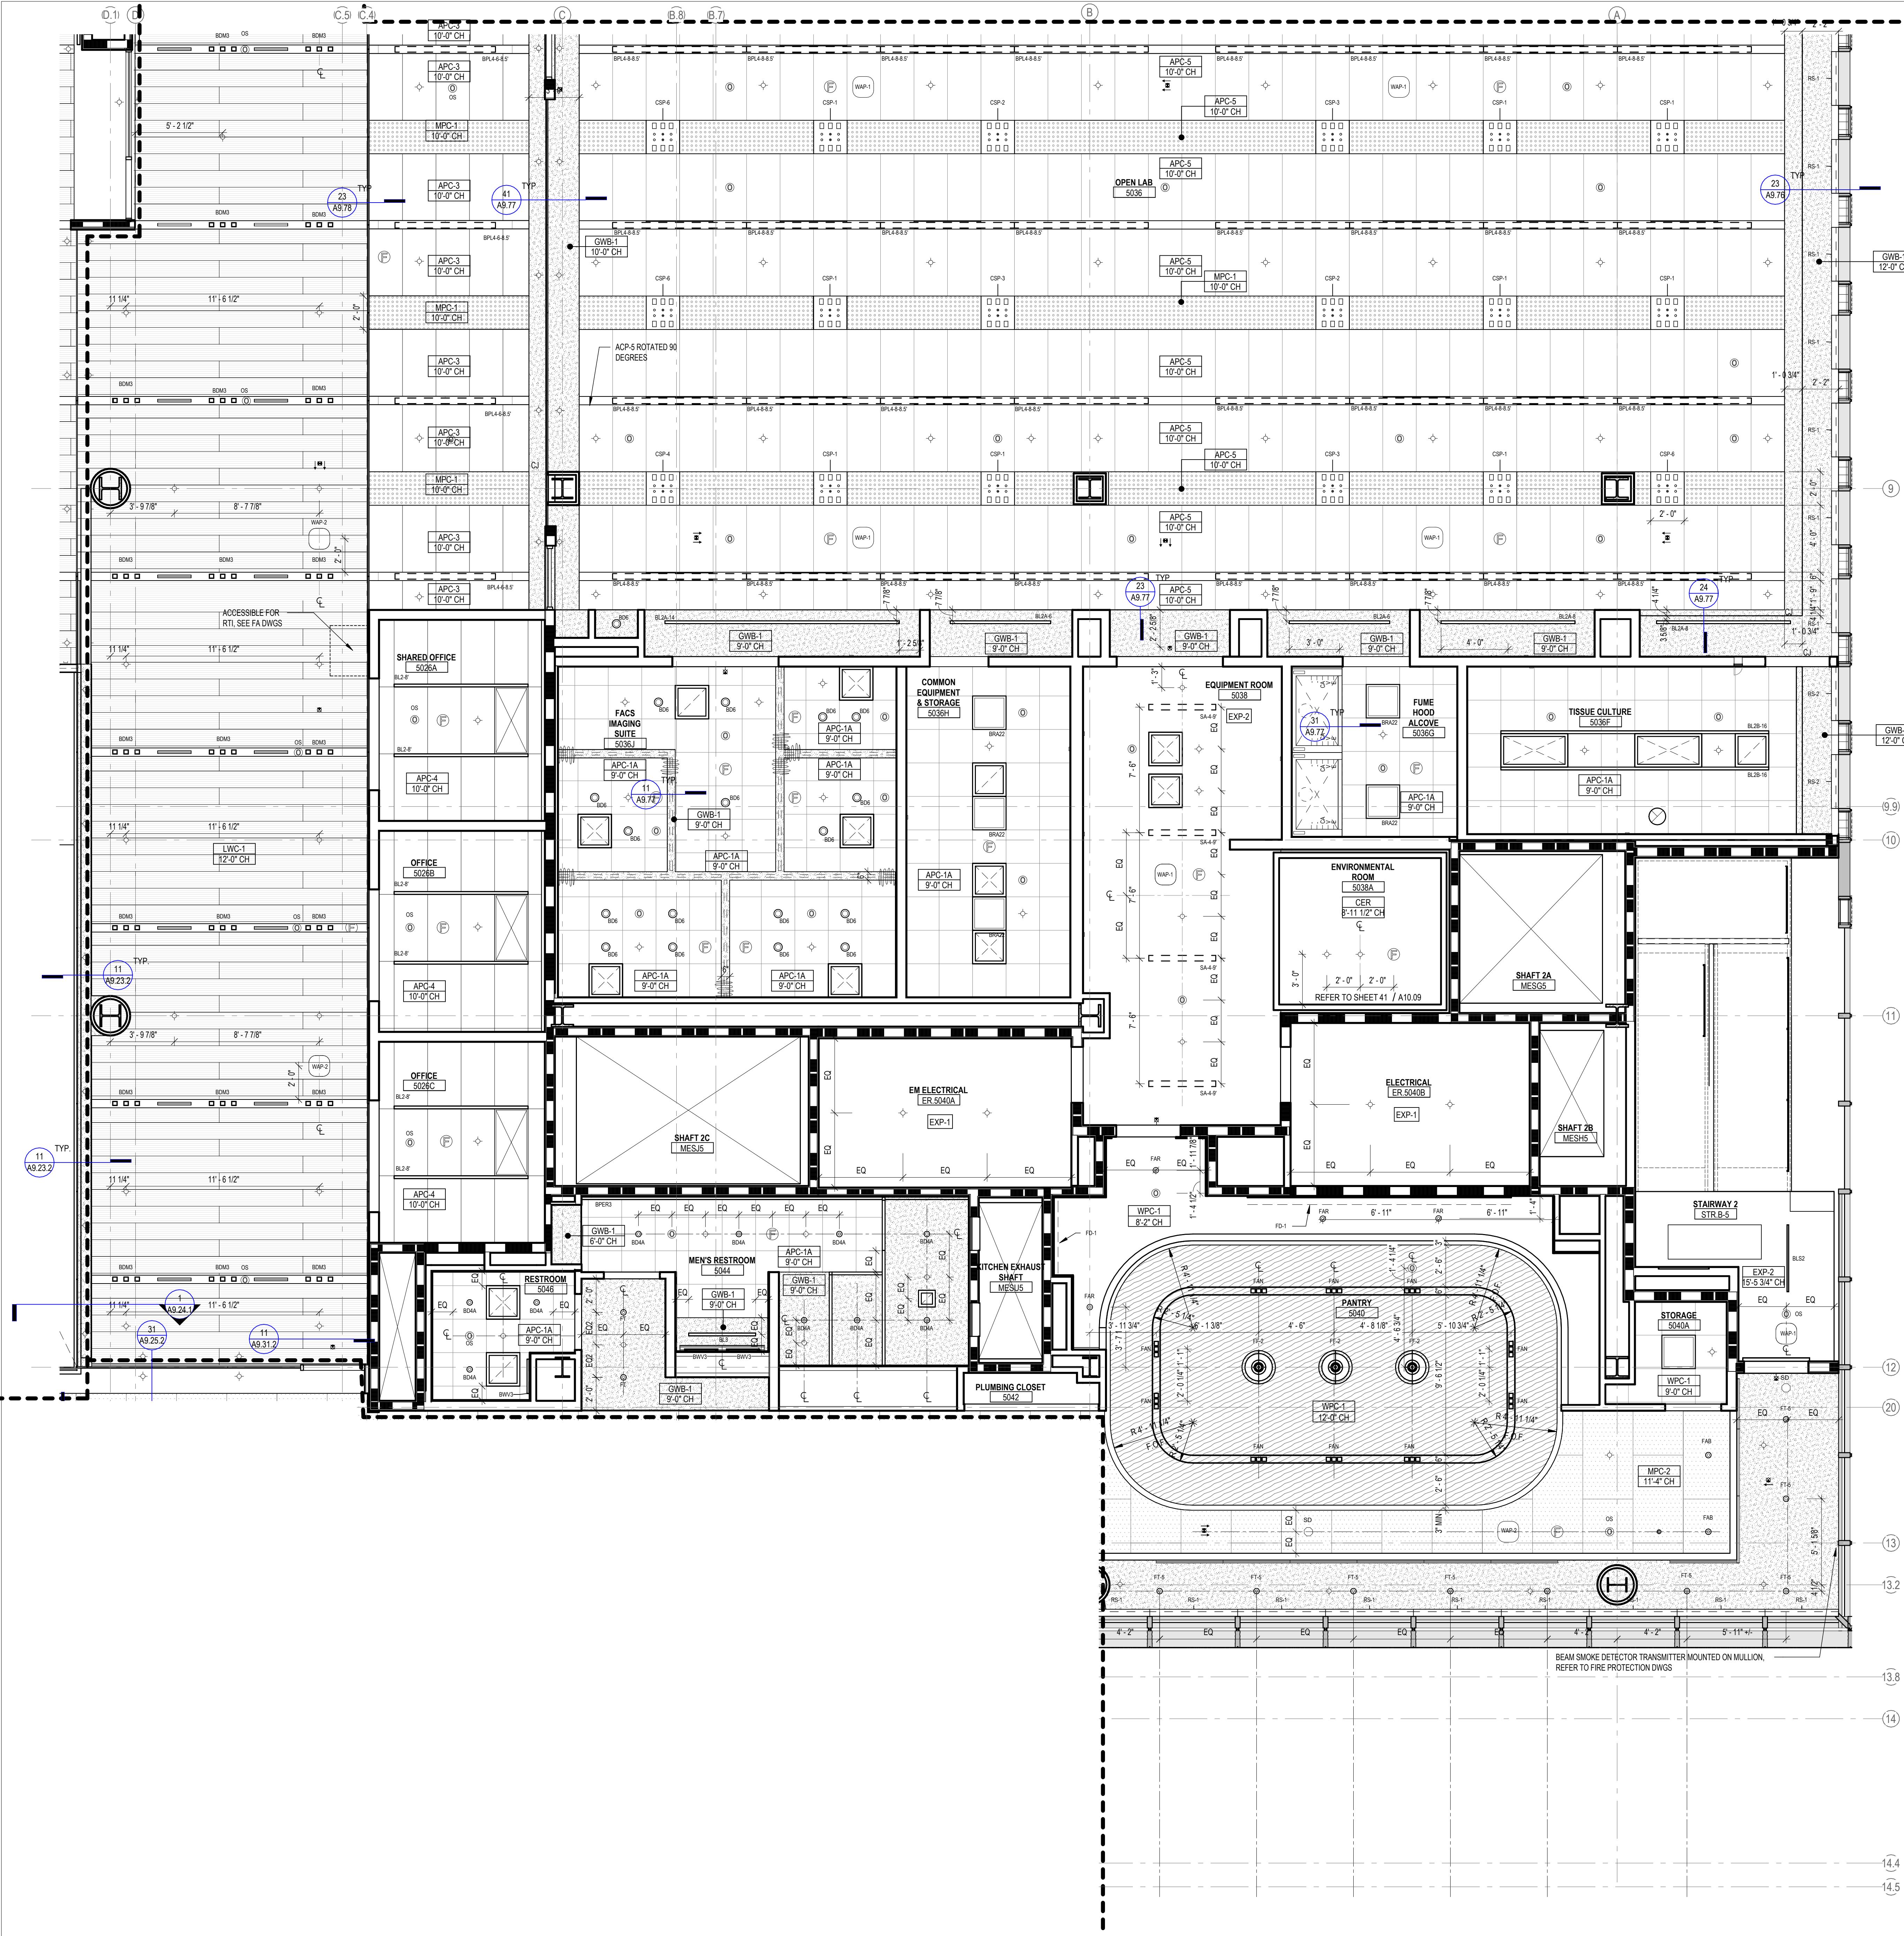

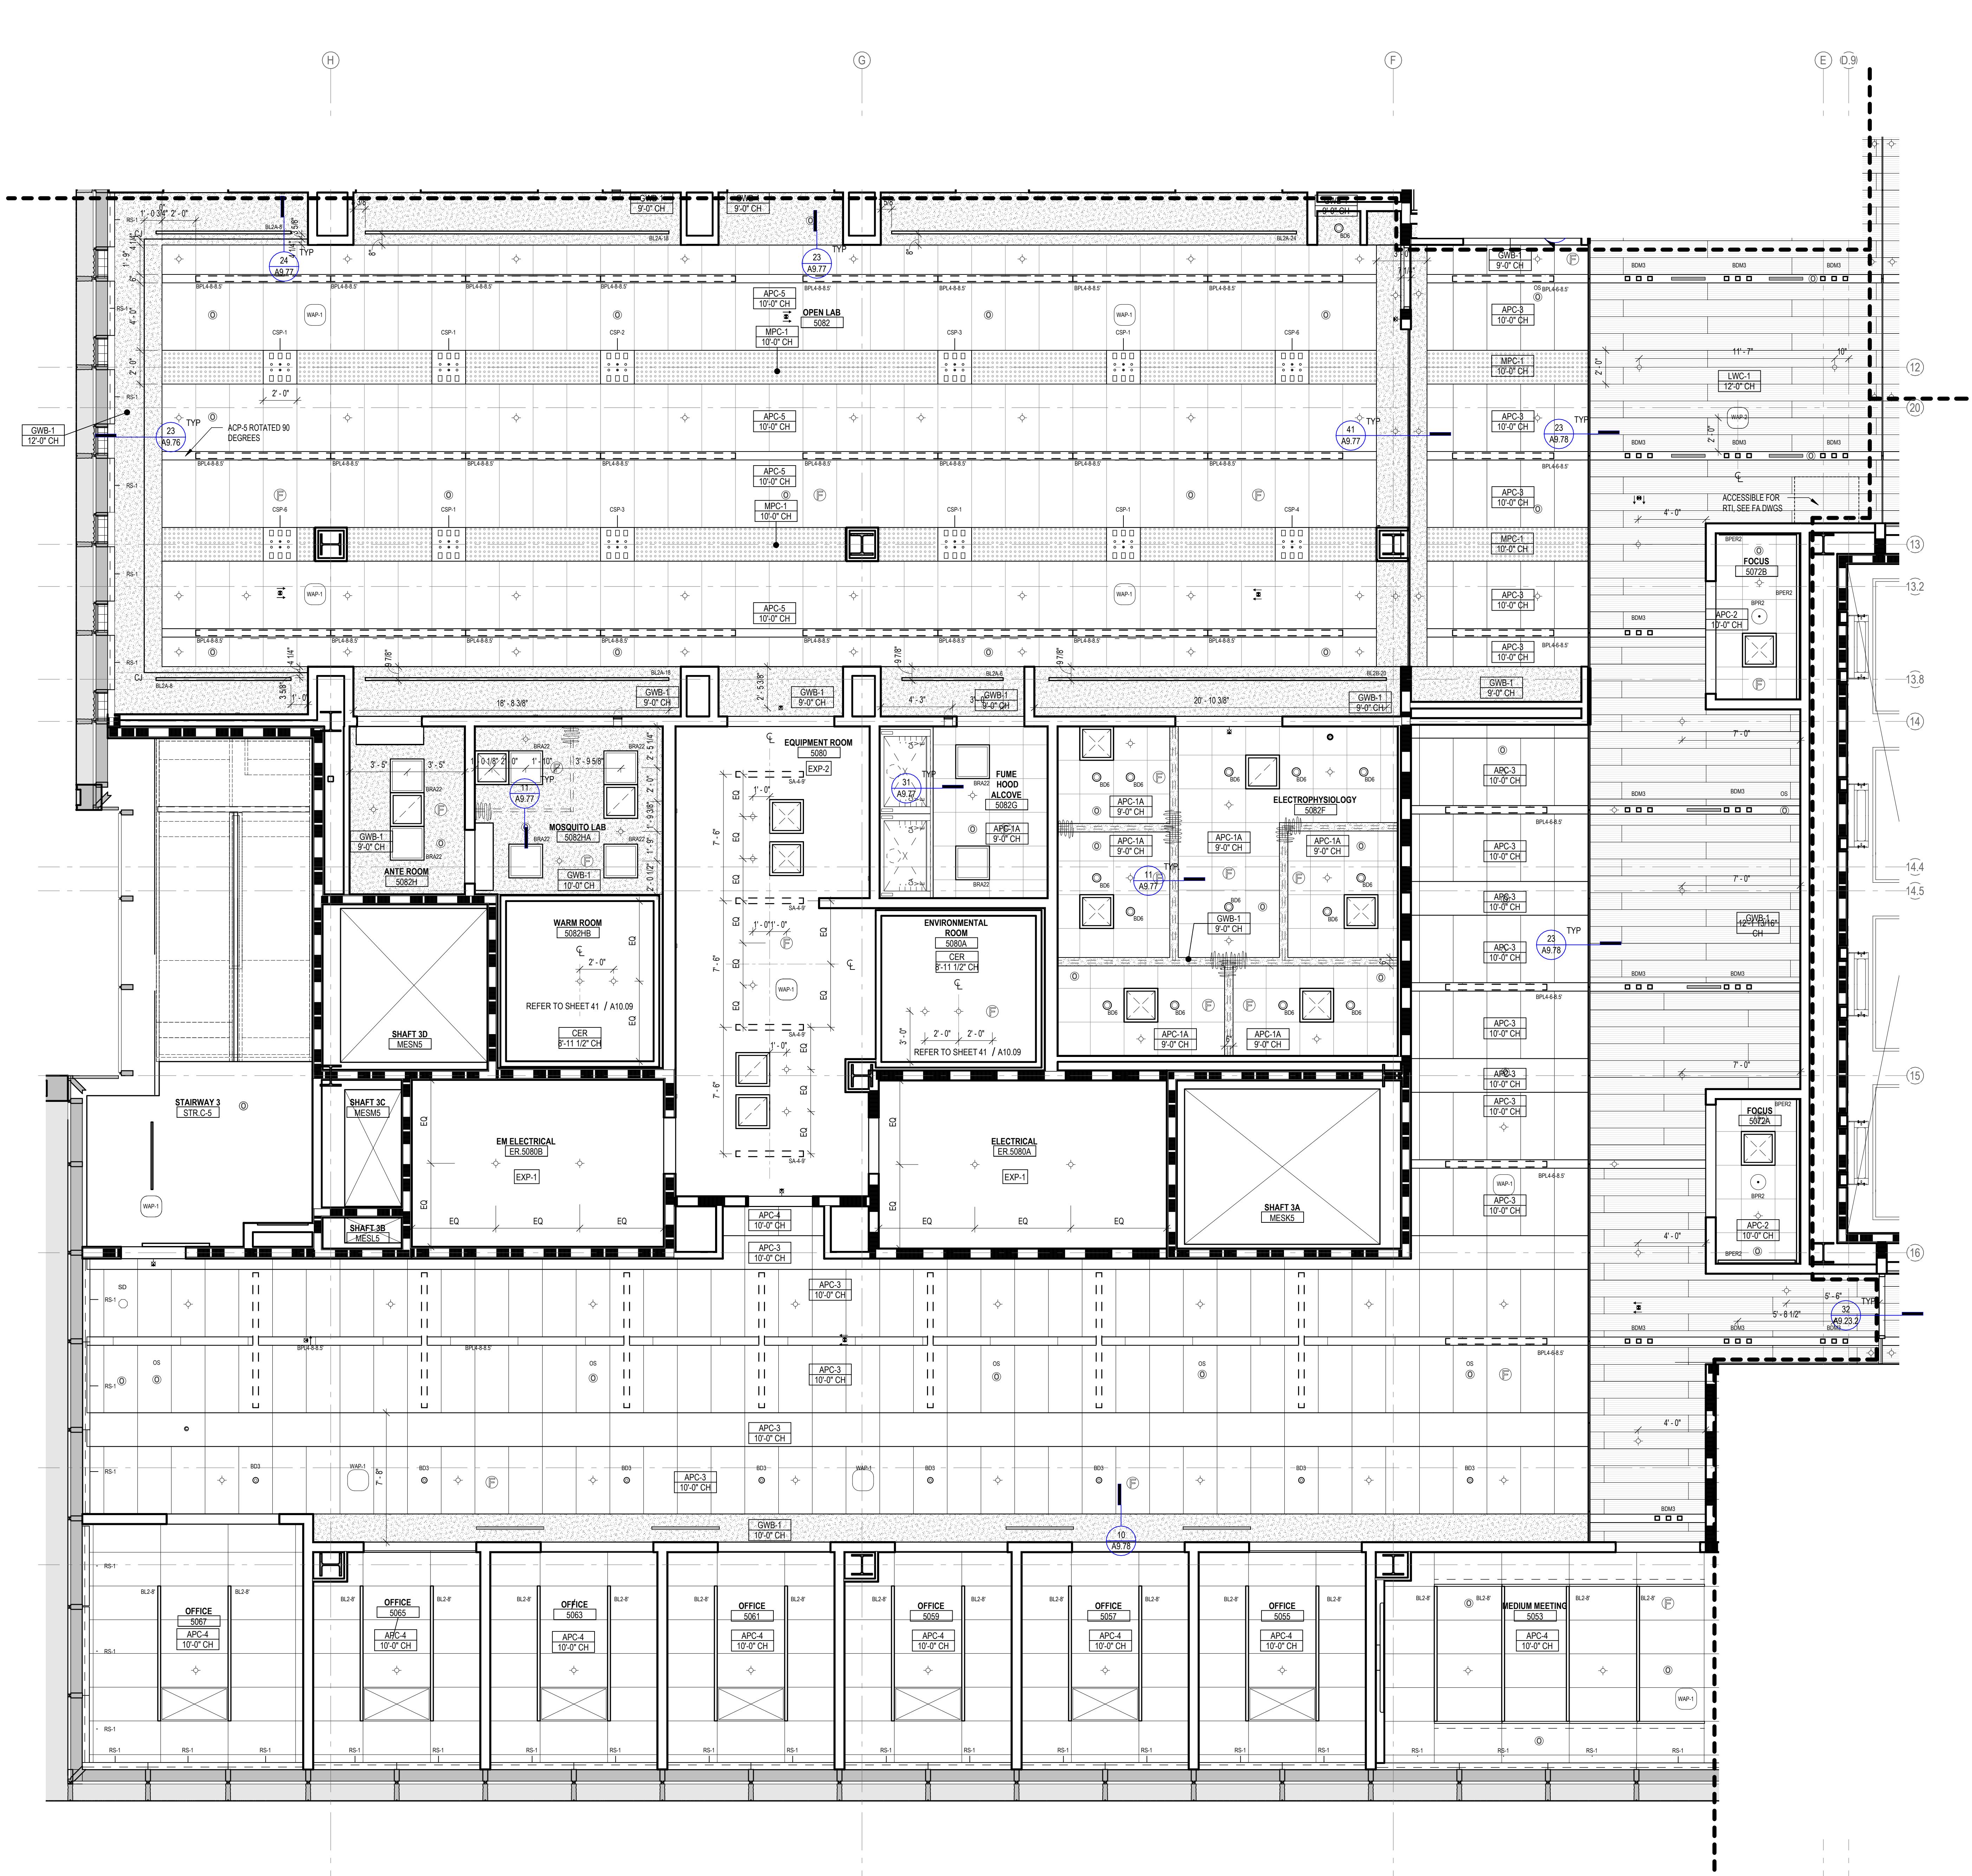

LEGEND - CEILING PLAN

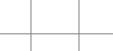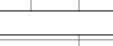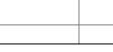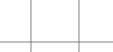	APC-1A	ACOUSTICAL PANEL CEILING (2X2), LAB SUPPORT
	APC-1B	ACOUSTICAL PANEL CEILING (2X2), DARK ROOM (BLACK)
	APC-2	ACOUSTICAL PANEL CEILING (2X2), FOCUS ROOM (HIGH NRC)
	APC-3	ACOUSTICAL PANEL CEILING (2X4), OPEN OFFICE
	APC-4	ACOUSTICAL PANEL CEILING (2X4), OFFICES, CONF.
	APC-5	ACOUSTICAL PANEL CEILING (2X4), OPEN LAB
	APC-6	ACOUSTICAL PANEL CEILING (2X2), BOH
	APC-7	ACOUSTICAL PANEL CEILING (2X2), WASHABLE, RADIOISOTOPE, FOOD SERVICE
	APC-8	ACOUSTICAL PANEL CEILING (2X2), MOISTURE RESISTANT, LOADING DOCK
	APC-9	ACOUSTICAL PANEL CEILING (2X4), SEMINAR, CONFERENCE
	FRP-1	FIBERGLASS REINFORCED CEILING PANELS
	GWB-1	GYPSUM BOARD CEILING, PAINTED
	GWB-2	GYPSUM BOARD CEILING WITH HPC
	GWB-3	ACOUSTICAL PLASTER CEILING


KEY PLAN

ARCHITECT PAYETTE ASSOCIATES, INC. 290 Congress Street, Fifth Floor Boston, MA 02210 617.895.1000	ASSOCIATE ARCHITECT KPN ARCHITECTS 1800 Washington Blvd, Suite 414 Baltimore, MD 21230 443.682.7757
CODE CODE RED CONSULTANTS 154 Turnpike Road, Suite 200 Southborough, MA 01772 617.500.7633	CIVIL RK&K 700 East Pratt Street, Suite 500 Baltimore, MD 21202 410.728.2900
LANDSCAPE ARCHITECT OLIN 1617 John F. Kennedy Boulevard, Suite 1900 Philadelphia, PA 19103 215.440.0030	STRUCTURAL COLUMBIA ENGINEERING, INC. 6210 Old Dobbin Lane, Suite 150 Baltimore, Maryland 21045 410.992.9970
VERTICAL TRANSPORTATION ZIPF ASSOCIATES, INC. 25 Bala Avenue, Suite 201 Bala Cynwyd, PA 19004 610.667.1717	MEP BR+A CONSULTING ENGINEERS 10 Guest Street, 4th Floor Boston, MA 02135 617.254.0016
FIRE ALARM & FIRE PROTECTION SETTY & ASSOCIATES 575 S. Charles Street, Suite 403 Baltimore, MD 21201 667.309.6036	AUDIO VISUAL & TELECOM CONVERGENT TECHNOLOGIES DESIGN GROUP 6501 York Road Baltimore, MD 21212 410.532.2395
SECURITY THORNTON TOMASETTI 1330 Connecticut Ave, NW, Suite 300 Washington, DC 20036 202.580.6300	FOOD SERVICE COLBURN GUYETTE 100 Ledgewood Place, Suite 104 Rockland, MA, 02370 781.826.5522
BUILDING ENCLOSURE SIMPSON GUMPERTZ & HEGER 1625 Eye St NW Suite 900 Washington, DC 20006 202.239.4199	LEED SUSTAINABLE DESIGN CONSULTING 1432 K Street NW, 3rd Floor Washington, DC 20005 202.667.1620
WIND & AIR QUALITY RWTDI 650 Woodland Rd. W. Guelph, Ontario Canada N1K 1B8 519.823.1311	VIBRATION & ACOUSTICS COLIN GORDON ASSOCIATES 1350 Old Bayshore Hwy, Suite 799 Burlingame, CA 94010 415.570.0350
LIGHTING FISHER MARANTZ STONE 22 West 19th Street, 6th Floor New York, NY 10011 212.691.3020	SITE LIGHTING TILLETT LIGHTING DESIGN ASSOCIATES 11 Hanover Square, 17th Floor New York, NY 10005 212.766.0144
EMI/RFI (SHEILDING) VITATECH ELECTROMAGNETICS 115 Juliad Ct., Suite 105 Fredericksburg, VA 22406 540.286.1984	CAMPUS UTILITIES AEI AFFILIATED ENGINEERS 200 International Circle, Suite 5888 Hunt Valley, MD 21030 410.229.0090

LIFE SCIENCES BUILDING


600 N Broadway
Baltimore, MD 21205

74.1 FOR TYPICAL LAYOUT



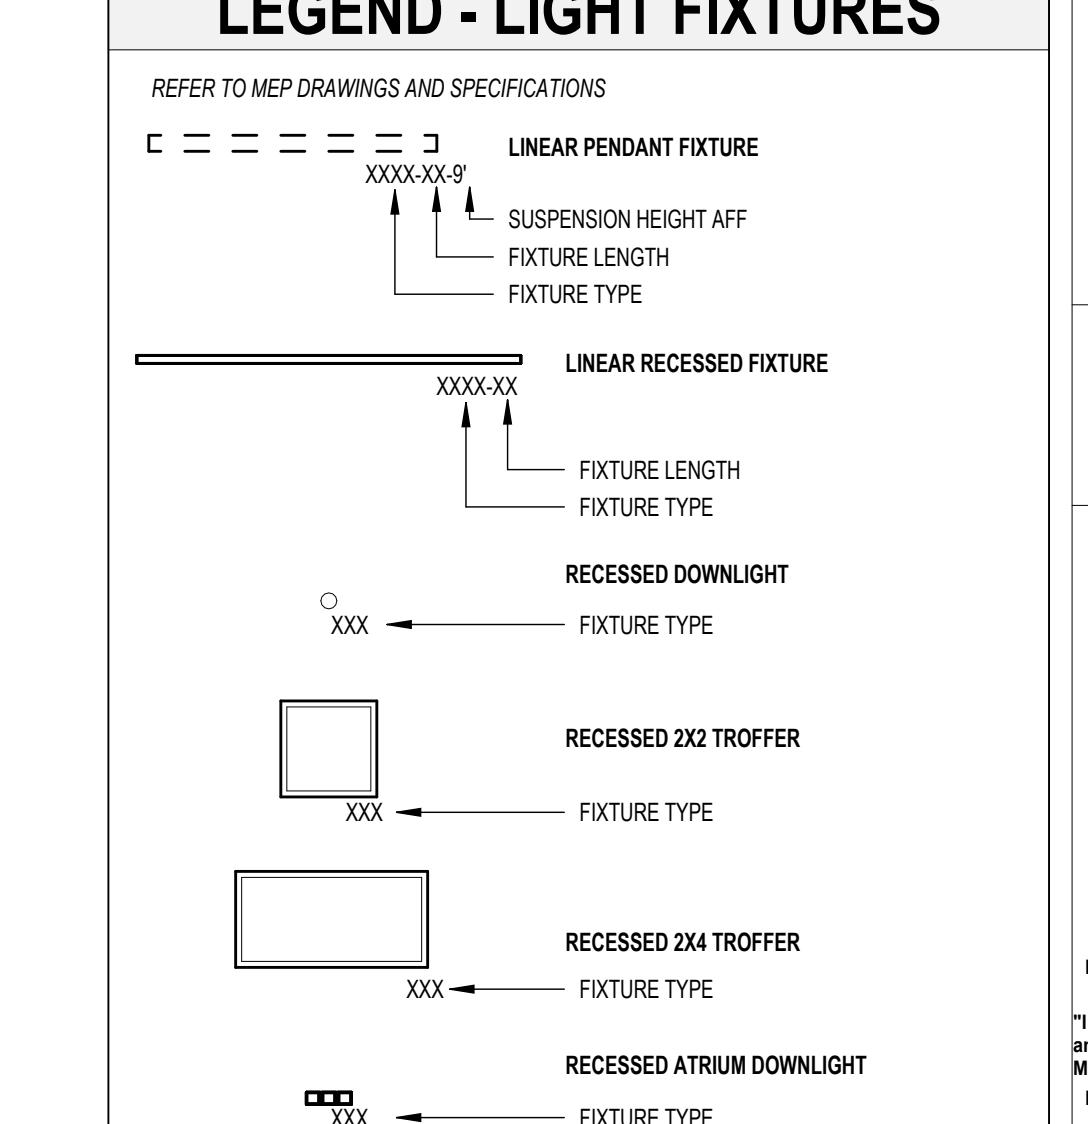


Baltimore, Maryland 21287

Seal	Date:	OCTOBER 24,
 The seal is circular with a dotted outer border. The words "STATE OF MARYLAND" are at the top and "ARCHITECT" are at the bottom. In the center is a building with two figures standing in front. Below the building is the text "No. 19966". A blue signature line crosses the seal from the bottom left to the top right. SARAH LINDENFELD	Scale:	As indicated
	Drawn By:	
	Designed By:	
	Checked By:	
	Proj. Mgr.:	
	Payette Job No.:	174
	Cadd File:	
	Client Job No.:	J.170.24
	Client Dwg. No.:	
professional Certification.		
I certify that these documents were prepared or approved by me, and that I am duly licensed engineer under the laws of the State of Maryland.		
license No. 19966	Expiration Date: 06/20/2026	
A6.54		

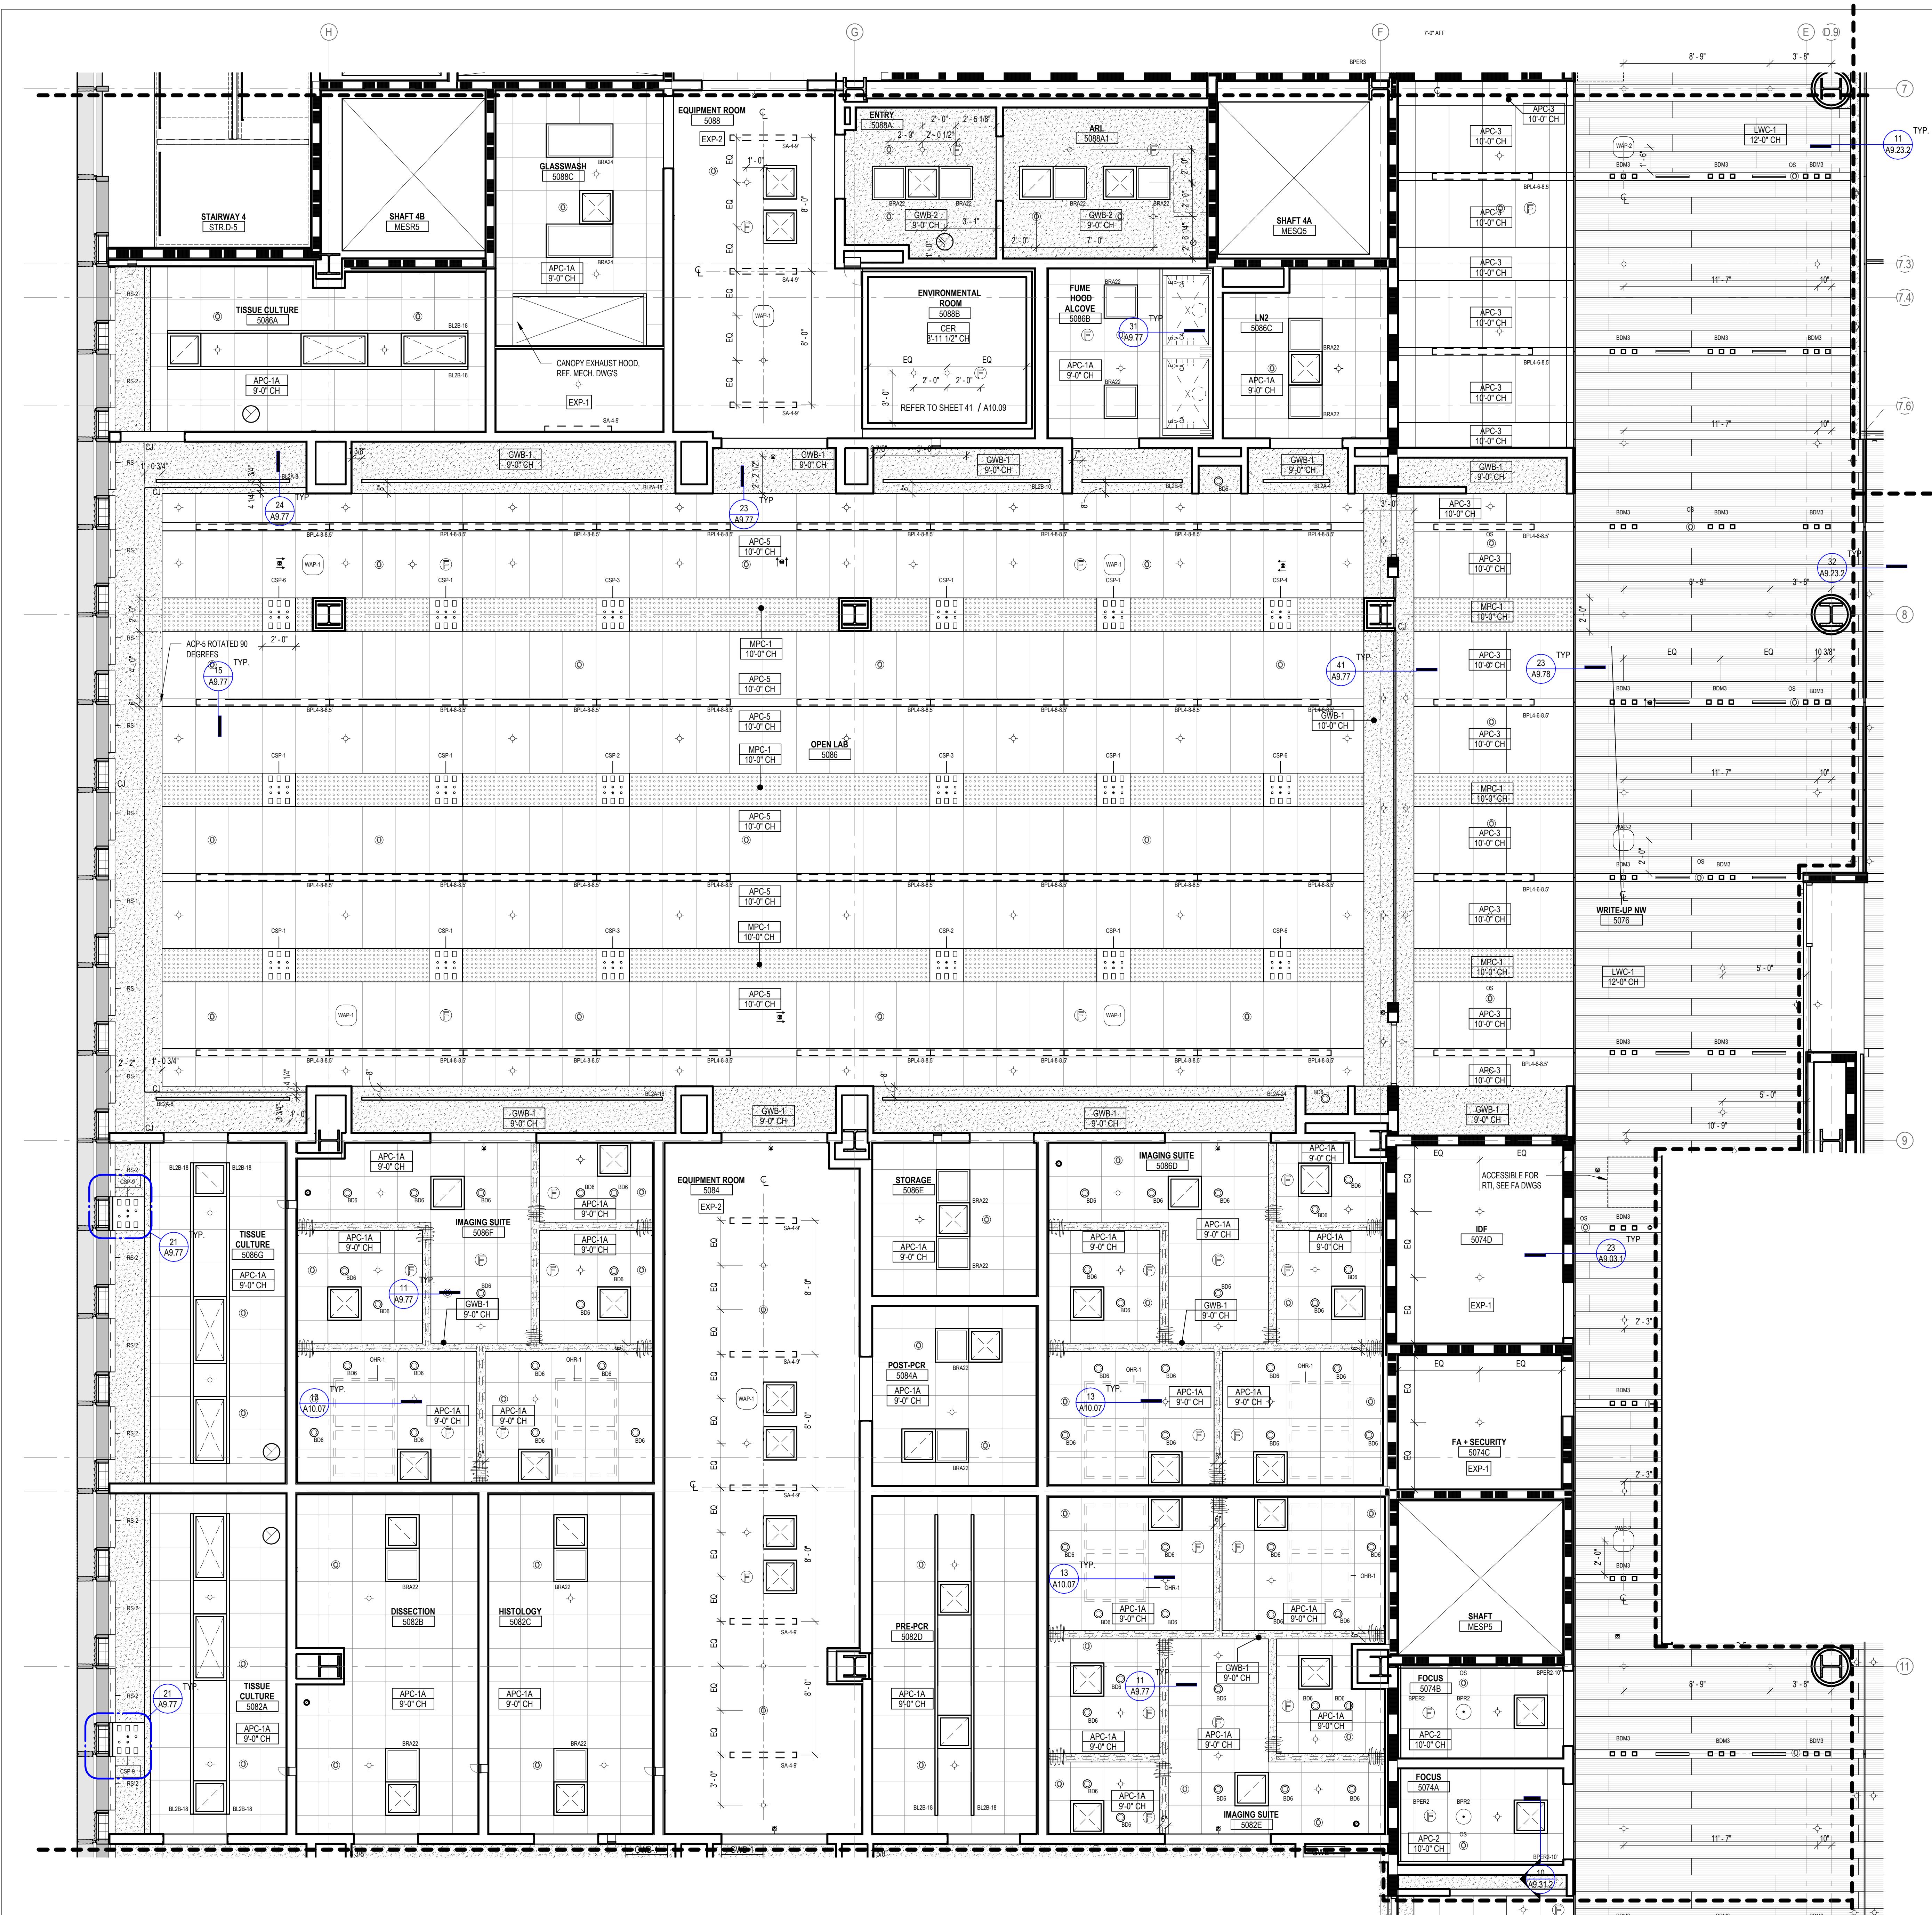

LEGEND - CEILING PLAN

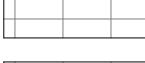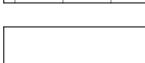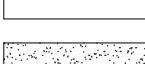	APC-1A	ACOUSTICAL PANEL CEILING (2X2), LAB SUPPORT
	APC-1B	ACOUSTICAL PANEL CEILING (2X2), DARK ROOM (BLACK)
	APC-2	ACOUSTICAL PANEL CEILING (2X2), FOCUS ROOM (HIGH NRC)
	APC-3	ACOUSTICAL PANEL CEILING (2X4), OPEN OFFICE
	APC-4	ACOUSTICAL PANEL CEILING (2X4), OFFICES, CONF.
	APC-5	ACOUSTICAL PANEL CEILING (2X4), OPEN LAB
	APC-6	ACOUSTICAL PANEL CEILING (2X2), BOH
	APC-7	ACOUSTICAL PANEL CEILING (2X2), WASHABLE, RADIOISOTOPE, FOOD SERVICE
	APC-8	ACOUSTICAL PANEL CEILING (2X2), MOISTURE RESISTANT, LOADING DOCK
	APC-9	ACOUSTICAL PANEL CEILING (2X4), SEMINAR, CONFERENCE
	FRP-1	FIBERGLASS REINFORCED CEILING PANELS
	GWB-1	GYPSUM BOARD CEILING, PAINTED
	GWB-2	GYPSUM BOARD CEILING WITH HPC
	GWB-3	ACOUSTICAL PLASTER CEILING

The image features a large, bold black number '5' centered on a solid grey rectangular background. To the right of this block is a vertical column of abstract, minimalist shapes. The column consists of several thin black lines forming various geometric and organic forms, such as rectangles, semi-circles, and irregular curves. The overall aesthetic is clean and modern, with a focus on geometric abstraction.

KEY PLAN

ARCHITECT PAYETTE ASSOCIATES, INC. 290 Congress Street, Fifth Floor Boston, MA 02210 617.895.1000	ASSOCIATE ARCHITECT KPN ARCHITECTS 1800 Washington Blvd, Suite 414 Baltimore, MD 21230 443.682.7757
CODE CODE RED CONSULTANTS 154 Turnpike Road, Suite 200 Southborough, MA 01772 617.500.7633	CIVIL RK&K 700 East Pratt Street, Suite 500 Baltimore, MD 21202 410.728.2900
LANDSCAPE ARCHITECT OLIN 617 John F. Kennedy Boulevard, Suite 1900 Philadelphia, PA 19103 215.440.0030	STRUCTURAL COLUMBIA ENGINEERING, INC. 6210 Old Dobbin Lane, Suite 150 Baltimore, Maryland 21045 410.992.9970
VERTICAL TRANSPORTATION ZIPF ASSOCIATES, INC. 25 Bala Avenue, Suite 201 Bala Cynwyd, PA 19004 610.667.1717	MEP BR+A CONSULTING ENGINEERS 10 Guest Street, 4th Floor Boston, MA 02135 617.254.0016
fire alarm & fire protection SETTY & ASSOCIATES 75 S. Charles Street, Suite 403 Baltimore, MD 21201 667.309.6036	AUDIO VISUAL & TELECOM CONVERGENT TECHNOLOGIES DESIGN GROUP 6501 York Road Baltimore, MD 21212 410.532.2395
SECURITY THORNTON TOMASETTI 1330 Connecticut Ave, NW, Suite 300 Washington, DC 20036 202.580.6300	FOOD SERVICE COLBURN GUYETTE 100 Ledgewood Place, Suite 104 Rockland, MA, 02370 781.826.5522
BUILDING ENCLOSURE MPSON GUMPERTZ & HEGER 1625 Eye St NW Suite 900 Washington, DC 20006 202.239.4199	LEED SUSTAINABLE DESIGN CONSULTING 1432 K Street NW, 3rd Floor Washington, DC 20005 202.667.1620
WIND & AIR QUALITY RWDI 650 Woodland Rd. W. Guelph, Ontario Canada N1K 1B8 519.823.1311	VIBRATION & ACOUSTICS COLIN GORDON ASSOCIATES 1350 Old Bayshore Hwy, Suite 799 Burlingame, CA 94010 415.570.0350
LIGHTING FISHER MARANTZ STONE 22 West 19th Street, 6th Floor New York, NY 10011 212.691.3020	SITE LIGHTING TILLETT LIGHTING DESIGN ASSOCIATES 11 Hanover Square, 17th Floor New York, NY 10005 212.766.0144
EMI/RFI (SHEILDING) TATECH ELECTROMAGNETICS 115 Juliad Ct., Suite 105 Fredericksburg, VA 22406 540.286.1984	CAMPUS UTILITIES AEI AFFILIATED ENGINEERS 200 International Circle, Suite 5888 Hunt Valley, MD 21030 410.229.0090

LIFE SCIENCES BUILDING

600 N Broadway
Baltimore, MD 21205

A9.74.1 FOR TYPICAL LAYOUT

REFER TO MEP DRAWINGS AND SPECIFICATIONS

LINEAR PENDANT FIXTURE
XXXX-XX-9'
SUSPENSION HEIGHT AFF
FIXTURE LENGTH
FIXTURE TYPE

LINEAR RECESSED FIXTURE
XXXX-XX
FIXTURE LENGTH
FIXTURE TYPE

RECESSED DOWNLIGHT
○
XXX ← FIXTURE TYPE

RECESSED 2X2 TROFFER
XXX ← FIXTURE TYPE

RECESSED 2X4 TROFFER
XXX ← FIXTURE TYPE

RECESSED ATRIUM DOWNLIGHT
VVV
XXX ← FIXTURE TYPE

Baltimore, Maryland 21287

Date: OCTOBER 24, 2025


 The seal is circular with a dotted outer border. The words "STATE OF MARYLAND" are at the top, "SARAH LINDENFELD" are in the middle, and "No. 19966" and "ARCHITECT" are at the bottom. In the center is a drawing of three figures standing around a building.	
Scale:	As indicated
Drawn By:	
Designed By:	
Checked By:	
Proj. Mgr.:	
Payette Job No.:	17480.00
Cadd File:	
Client Job No.:	J.170.24.4000
Client Dwg. No.:	

Professional Certification.

I certify that these documents were prepared or approved by me,
and I am duly licensed engineer under the laws of the State of

AC EEE

A6.55

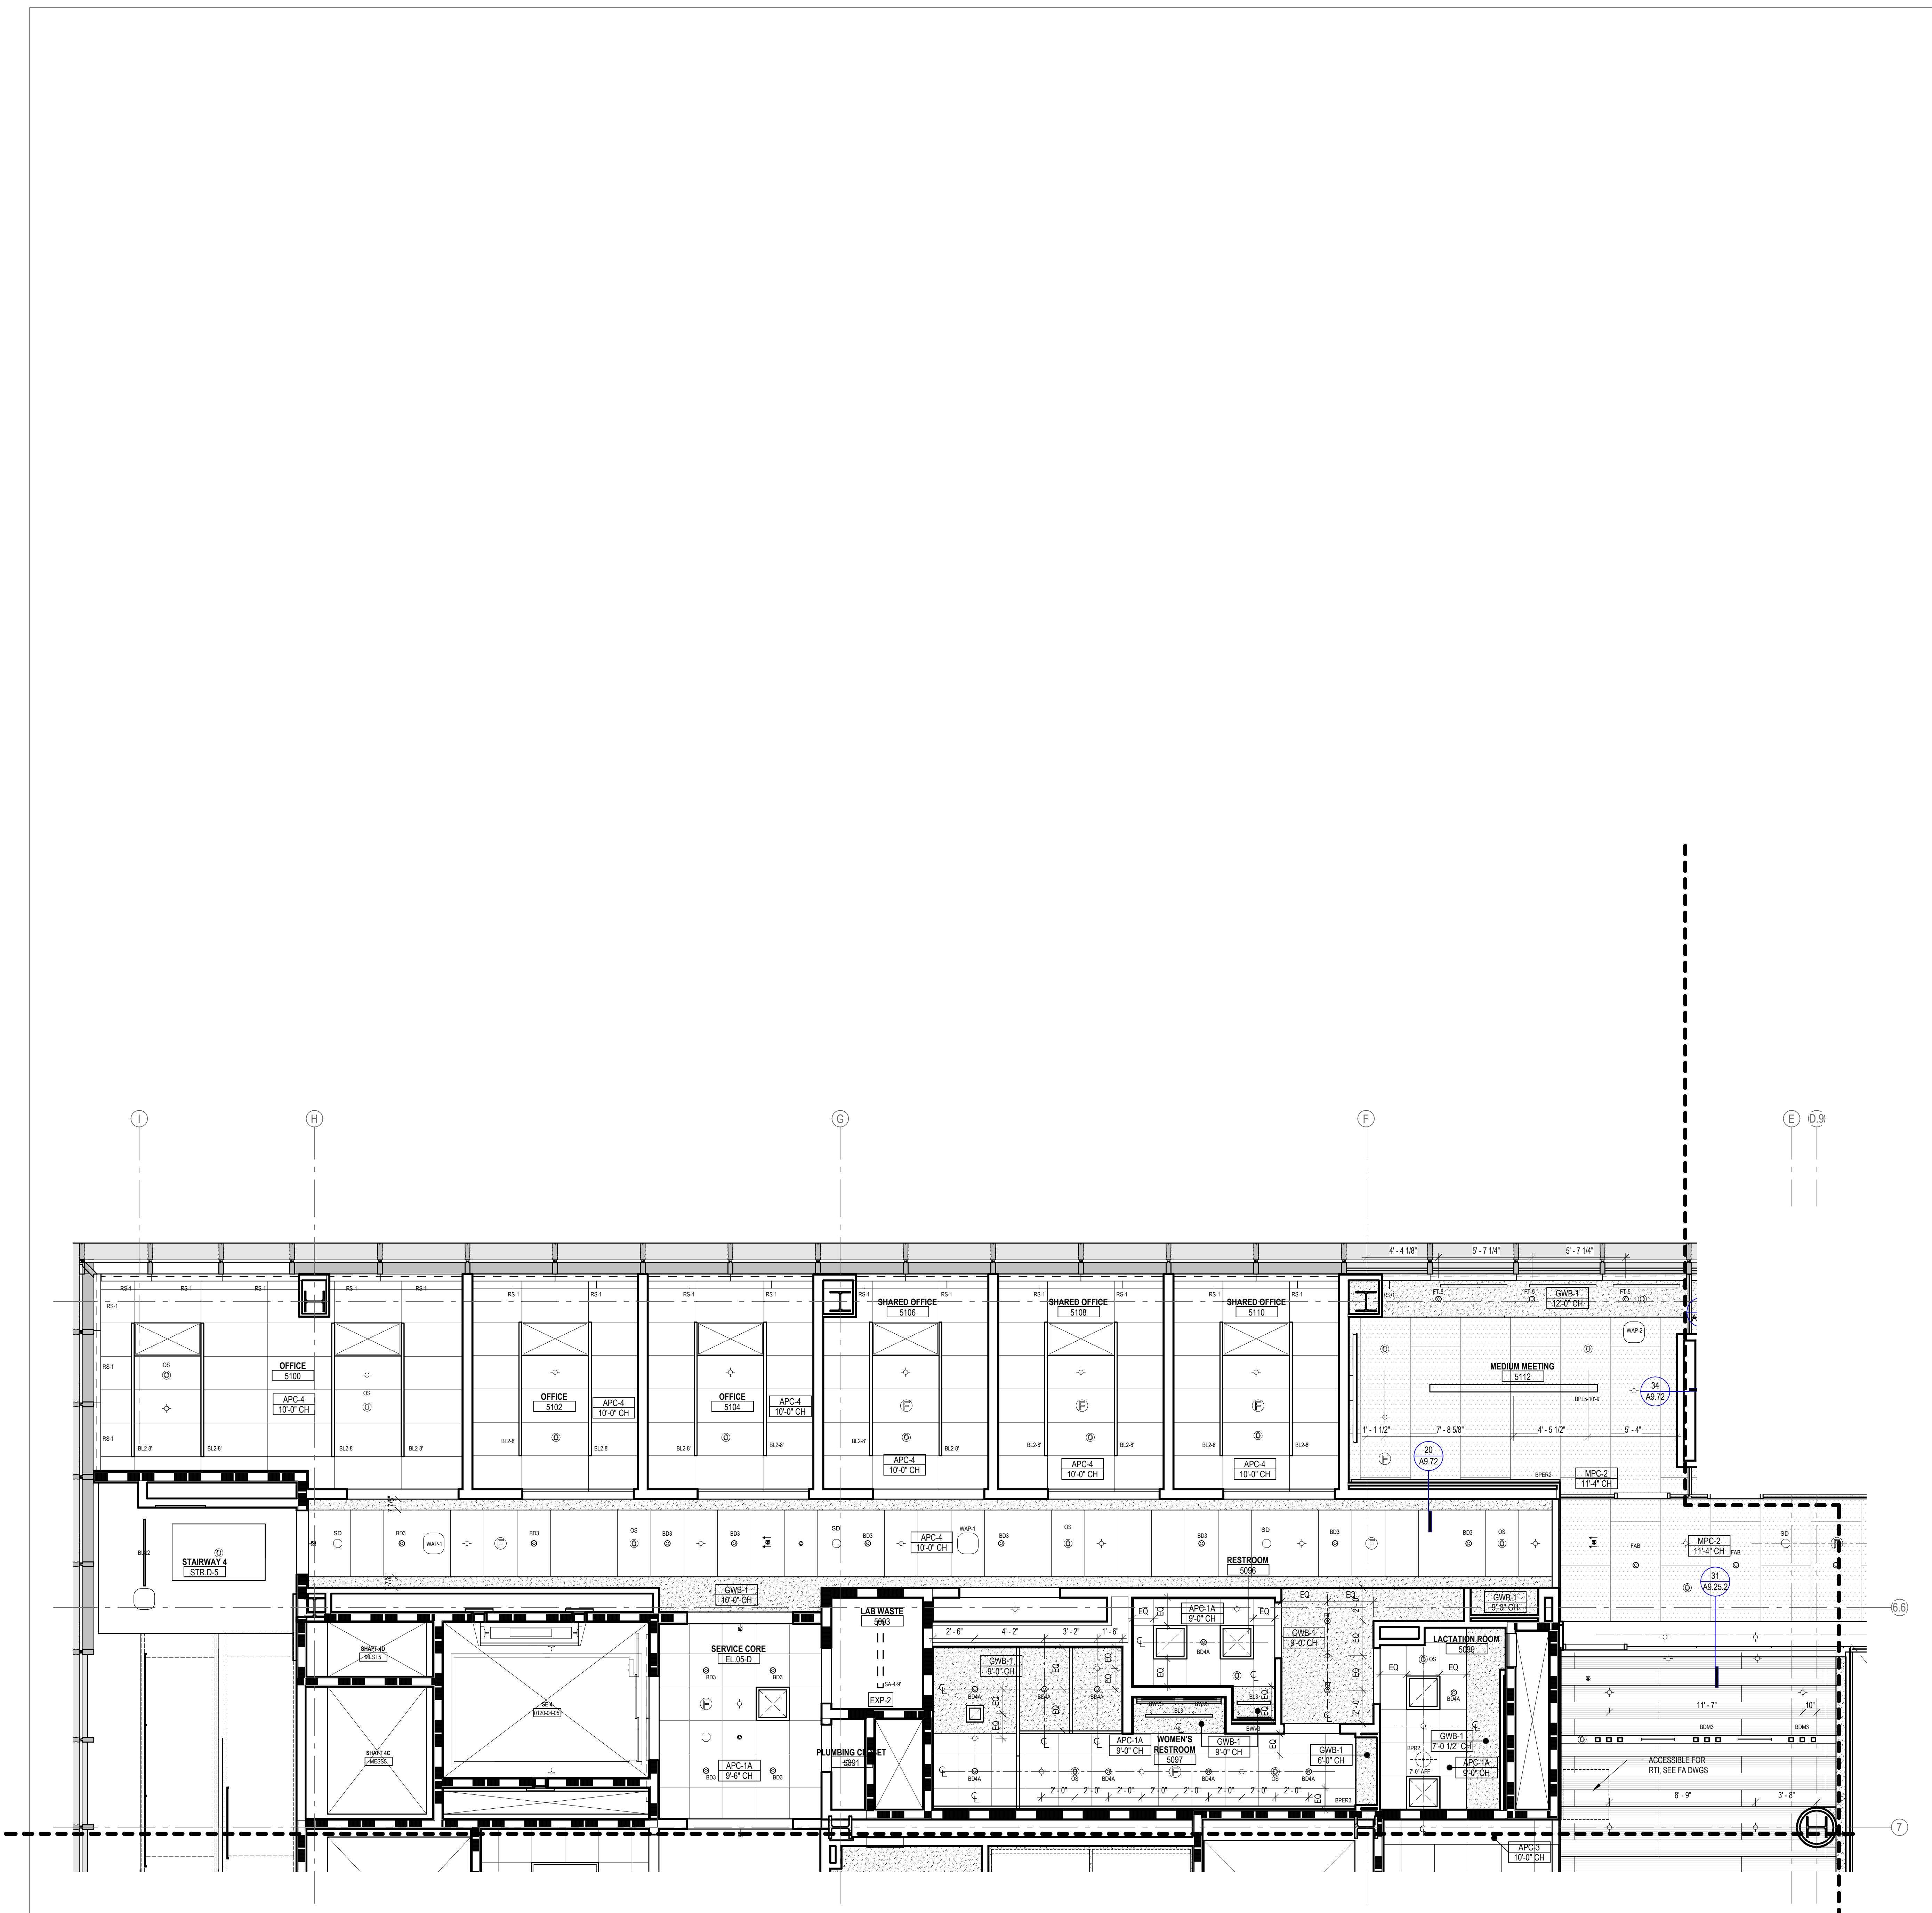

LEGEND - CEILING PLAN

	APC-1A	ACOUSTICAL PANEL CEILING (2X2), LAB SUPPORT
	APC-1B	ACOUSTICAL PANEL CEILING (2X2), DARK ROOM (BLACK)
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	FRP-1	FIBERGLASS REINFORCED CEILING PANELS
	GWB-1	GYPSUM BOARD CEILING, PAINTED
	GWB-2	GYPSUM BOARD CEILING WITH HPC
	GWB-3	ACOUSTICAL PLASTER CEILING
	EXP-1	EXPOSED TO STRUCTURE
	EXP-2	EXPOSED TO STRUCTURE WITH PAINTED MEP, HANGERS, ACOUSTIC SPRAY COATING AT DECK
	LWC-1	LINEAR WOOD CEILING ACOUSTIC INFILL PANEL SEE A9.73.1
	LWC-2	LINEAR WOOD CEILING WITH ACOUSTIC SPRAY COATING ABOVE SEE A9.73.1
	WPC-1	ACOUSTICAL WOOD PANEL CEILING
	MPC-1	MICRO-PERFORATED METAL PANEL CEILING
	MPC-2	PERFORATED METAL CEILING WITH NON-COMBUSTIBLE ACOUSTIC INFILL PANEL SEE A9.72
	ST-1	LINEAR WOOD CEILING SOFFITS
	ST-2.1	METAL PANEL SOFFIT - EXTERIOR SOFFIT POWDER COAT TO MATCH COPPER ANODIZED ALUM.
	ST-2.2	METAL PANEL SOFFIT - EXTERIOR SOFFIT POWDER COAT TO MATCH BRONZE ANODIZED ALUM.
	CSP-X	CEILING SERVICE PANEL. SEE A10.05A FOR TYPES.
	OHR	OVERHEAD SERVICE RACK, SEE A10.07 FOR DETAILS.
	C	CEILING MOUNTED SECURITY CAMERA, REFER TO SECURITY DWG

KEY PLAN

ARCHITECT TTE ASSOCIATES, INC. ngress Street, Fifth Floor oston, MA 02210 617.895.1000	ASSOCIATE ARCHITECT KPN ARCHITECTS 1800 Washington Blvd, Suite 414 Baltimore, MD 21230 443.682.7757
CODE E RED CONSULTANTS urnpike Road, Suite 200 thborough, MA 01772 617.500.7633	CIVIL RK&K 700 East Pratt Street, Suite 500 Baltimore, MD 21202 410.728.2900
DSCAPE ARCHITECT OLIN hn F. Kennedy Boulevard, Suite 1900 iladelphia, PA 19103 215.440.0030	STRUCTURAL COLUMBIA ENGINEERING, INC. 6210 Old Dobbin Lane, Suite 150 Baltimore, Maryland 21045 410.992.9970
CAL TRANSPORTATION F ASSOCIATES, INC. ala Avenue, Suite 201 a Cynwyd, PA 19004 610.667.1717	MEP BR+A CONSULTING ENGINEERS 10 Guest Street, 4th Floor Boston, MA 02135 617.254.0016
ARM & FIRE PROTECTION TTY & ASSOCIATES Charles Street, Suite 403 altimore, MD 21201 667.309.6036	AUDIO VISUAL & TELECOM CONVERGENT TECHNOLOGIES DESIGN GROUP 6501 York Road Baltimore, MD 21212 410.532.2395
SECURITY RNTON TOMASETTI Connecticut Ave, NW, Suite 300 ashington, DC 20036 202.580.6300	FOOD SERVICE COLBURN GUYETTE 100 Ledgewood Place, Suite 104 Rockland, MA, 02370 781.826.5522
LIDING ENCLOSURE ON GUMPERTZ & HEGER 1625 Eye St NW Suite 900 ashington, DC 20006 202.239.4199	LEED SUSTAINABLE DESIGN CONSULTING 1432 K Street NW, 3rd Floor Washington, DC 20005 202.667.1620
ND & AIR QUALITY RWDI 650 Woodland Rd. W. Guelph, Ontario Canada N1K 1B8 519.823.1311	VIBRATION & ACOUSTICS COLIN GORDON ASSOCIATES 1350 Old Bayshore Hwy, Suite 799 Burlingame, CA 94010 415.570.0350
LIGHTING ER MARANTZ STONE est 19th Street, 6th Floor ew York, NY 10011 212.691.3020	SITE LIGHTING TILLETT LIGHTING DESIGN ASSOCIATES 11 Hanover Square, 17th Floor New York, NY 10005 212.766.0144
M/RFI (SHEILDING) CH ELECTROMAGNETICS 5 Juliad Ct., Suite 105	CAMPUS UTILITIES AEI AFFILIATED ENGINEERS 200 University City Center, Suite 5000

LIFE SCIENCES BUILDING

JOHNS HOPKINS

N I V E R S I T Y

LEGEND - LIGHT FIXTURES

<h1 style="text-align: center;">CHARGED REFLECTED CEILING PLAN - LEVEL 5</h1> <h2 style="text-align: center;">- SECTOR 6</h2>		
 <p>ertification.</p> <p>se documents were prepared or approved by me, y licensed engineer under the laws of the State of</p> <p>66 Expiration Date: 06/20/2026</p>	<p>Date: OCTOBER 24, 2022</p> <p>Scale: As indicated</p> <p>Drawn By:</p> <p>Designed By:</p> <p>Checked By:</p> <p>Proj. Mgr.:</p> <p>Payette Job No.: 17480.</p> <p>Cadd File:</p> <p>Client Job No.: J.170.24.40</p> <p>Client Dwg. No.:</p>	
	A6.56	

A6.56