

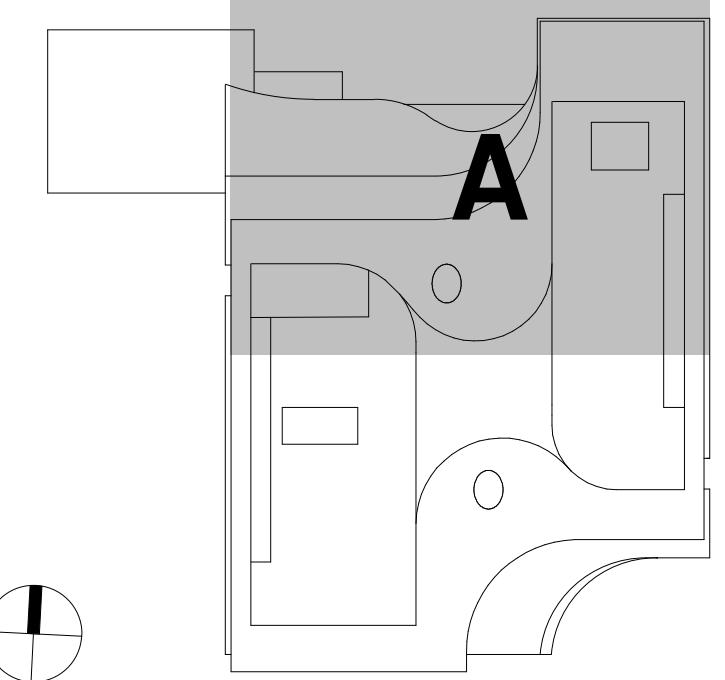
REFER TO LIGHTING CONSULTANT'S DRAWINGS AND ARCHITECTURAL RCPS FOR PUBLIC SPACE LIGHTING LAYOUTS.

GENERAL LIGHTING NOTES:

- ED NOTES:**

0 DRAWING E8.10 EGRESS
AY 2 AS TYPICAL.

 1. REFER TO DRAWING E0.00 FOR LEGEND, SYMBOLS AND GENERAL NOTES.
 2. REFER TO LIGHTING FIXTURE SCHEDULE ON DRAWING E7.30 SERIES FOR SPECIFICATION OF FIXTURES.
 3. REFER TO DRAWING E8.03 SERIES FOR LIGHTING CONTROL DRAWINGS.
 4. REFER TO ARCHITECTURAL FLOOR PLANS FOR EQUIPMENT LOCATIONS.
 5. REFER TO ARCHITECTS REFLECTED CEILING PLAN FOR EXACT LOCATION OF LIGHTING FIXTURE PRIOR TO INSTALLATION (TYPICAL).
 6. REFER TO ARCHITECTURAL ELEVATIONS FOR COORDINATION OF WALL MOUNTED FIXTURE LOCATIONS.
 7. LOCATION AND GROUPING ARRANGEMENT/ORIENTATION OF ALL SWITCHES SHALL BE COORDINATED WITH THE ARCHITECT, MECHANICAL EQUIPMENT, AND OTHER WALL-MOUNTED DEVICES PRIOR TO INSTALLATION.
 8. THE ELECTRICAL CONTRACTOR SHALL VERIFY ALL CEILING TYPES AND COORDINATE FIXTURE TRIMS PRIOR TO PURCHASE OF LIGHTING FIXTURES.
 9. THE ELECTRICAL CONTRACTOR SHALL FURNISH AND INSTALL ALL LIGHTING FIXTURES COMPLETE WITH MOUNTING HARDWARE.
 10. ALL EXIT SIGNS AND EMERGENCY EGRESS LIGHTING SHALL BE CONNECTED TO THE EMERGENCY GENERATOR.
 11. EMERGENCY EGRESS LIGHTING SHALL BE PROVIDED THROUGHOUT THE BUILDING TO ILLUMINATE ALL EGRESS CORRIDORS, LOBBIES, ETC. BRANCH CIRCUITS SHALL ORIGINATE FROM THE EMERGENCY GENERATOR. AREAS REQUIRING SUCH CONTROL OF EGRESS LIGHTING SHALL BE PROVIDED WITH BYPASS RELAYS. EMERGENCY BRANCH CIRCUIT CONDUCTORS ALL BE RUN IN SEPARATE DEDICATED CONDUITS WITH NO OTHER WIRING.
 12. UNDER NORMAL CONDITIONS, EMERGENCY LIGHTING SHALL FUNCTION LIKE THE NORMAL LIGHTING IN EACH SPACE. PROVIDE UL 924 LISTED DEVICE TO TURN EMERGENCY LIGHTS TO FULL BRIGHTNESS UPON LOSS OF NORMAL POWER, REGARDLESS OF CONTROL STATE.
 13. PROVIDE ALL REQUIRED MODULES, INTERFACES, NETWORK MANAGERS, AND CONTROL INTERCONNECTIONS AS REQUIRED BY THE MANUFACTURER(S) TO MEET THE SPECIFIED CONTROL INTENT.
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KEY PLAN

A technical line drawing of a mechanical assembly, likely a pump or motor housing. The drawing uses gray shading to represent different parts of the component. A large bold letter 'A' is positioned in the upper right area. In the bottom left corner, there is a circular callout feature containing a smaller circle divided into four quadrants, with a thick black line extending from its center to a point on the main drawing's outline.

ARCHITECT PAYETTE ASSOCIATES, INC. 290 Congress Street, Fifth Floor Boston, MA 02210 617.895.1000	ASSOCIATE ARCHITECT KPN ARCHITECTS 1800 Washington Blvd, Suite 414 Baltimore, MD 21230 443.682.7757
CODE CODE RED CONSULTANTS 154 Turnpike Road, Suite 200 Southborough, MA 01772 617.500.7633	CIVIL RK&K 700 East Pratt Street, Suite 500 Baltimore, MD 21202 410.728.2900
LANDSCAPE ARCHITECT OLIN 1617 John F. Kennedy Boulevard, Suite 1900 Philadelphia, PA 19103 215.440.0030	STRUCTURAL COLUMBIA ENGINEERING, INC. 6210 Old Dobbin Lane, Suite 150 Baltimore, Maryland 21045 410.992.9970
VERTICAL TRANSPORTATION ZIPF ASSOCIATES, INC. 25 Bala Avenue, Suite 201 Bala Cynwyd, PA 19004 610.667.1717	MEP BR+A CONSULTING ENGINEERS 10 Guest Street, 4th Floor Boston, MA 02135 617.254.0016
FIRE ALARM & FIRE PROTECTION SETTY & ASSOCIATES 575 S. Charles Street, Suite 403 Baltimore, MD 21201 667.309.6036	AUDIO VISUAL & TELECOM CONVERGENT TECHNOLOGIES DESIGN GROUP 6501 York Road Baltimore, MD 21212 410.532.2395
SECURITY THORNTON TOMASETTI 1330 Connecticut Ave, NW, Suite 300 Washington, DC 20036 202.580.6300	FOOD SERVICE COLBURN GUYETTE 100 Ledgewood Place, Suite 104 Rockland, MA, 02370 781.826.5522
BUILDING ENCLOSURE SIMPSON GUMPERTZ & HEGER 1625 Eye St NW Suite 900 Washington, DC 20006 202.239.4199	LEED SUSTAINABLE DESIGN CONSULTING 1432 K Street NW, 3rd Floor Washington, DC 20005 202.667.1620
WIND & AIR QUALITY RWDI 650 Woodland Rd. W. Guelph, Ontario Canada N1K 1B8 519.823.1311	VIBRATION & ACOUSTICS COLIN GORDON ASSOCIATES 1350 Old Bayshore Hwy, Suite 799 Burlingame, CA 94010 415.570.0350
LIGHTING FISHER MARANTZ STONE 22 West 19th Street, 6th Floor New York, NY 10011 212.691.3020	SITE LIGHTING TILLETT LIGHTING DESIGN ASSOCIATES 11 Hanover Square, 17th Floor New York, NY 10005 212.766.0144
EMI/RFI (SHEILDING) VITATECH ELECTROMAGNETICS 115 Juliad Ct., Suite 105 Fredericksburg, VA 22406 540 286 1984	CAMPUS UTILITIES AEI AFFILIATED ENGINEERS 200 International Circle, Suite 5888 Hunt Valley, MD 21030

LIFE SCIENCES BUILDING

600 N Broadway
Baltimore, MD 21205

1800 Orleans St
Baltimore, Maryland 21287

	Date: OCTOBER 24, 2025
	Scale: 1/8" = 1'-0"
	Drawn By:
	Designed By:
	Checked By:
	Proj. Mgr.:
	Payette Job No.: 17480.00
	Cadd File:
	Client Job No.: J.170.24.4000
	Other: _____

I certify that these documents were prepared or approved by me, and that I am duly licensed engineer under the laws of the State of Maryland.

EL2.00A

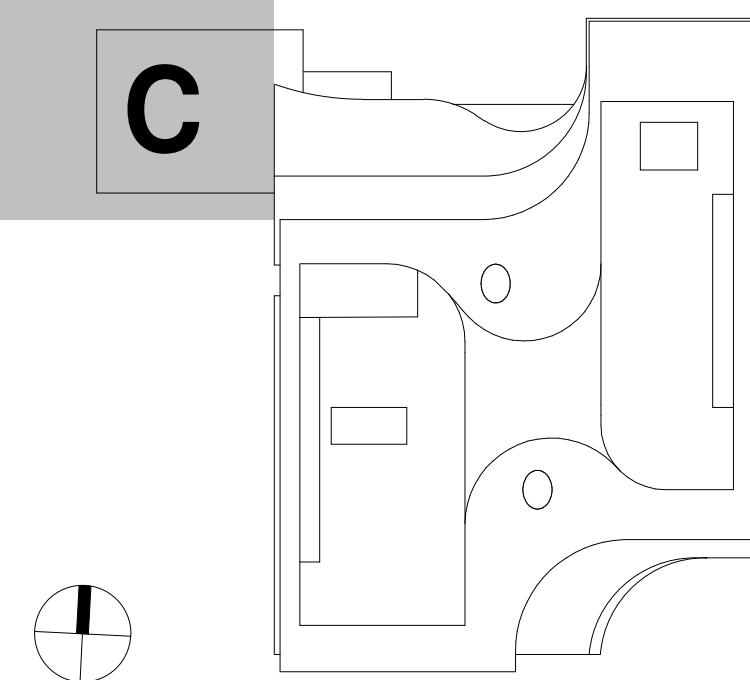
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KEY PLAN



1 LIGHTING RCP C - PARENT - LEVEL 0

1 1/8" = 1'-0"

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EMI/RFI (SHIELDING) VITATECH ELECTROMAGNETICS 115 Juliad Ct., Suite 105 Fredericksburg, VA 22406 540 286 1984	CAMPUS UTILITIES AEI AFFILIATED ENGINEERS 200 International Circle, Suite 5888 Hunt Valley, MD 21030

LIFE SCIENCES BUILDING

600 N Broadway
Baltimore, MD 21205

Baltimore, Maryland 21203

LIGHTING RCP C - LEVEL 0



Seal	Date: OCTOBER 24, 2025
 The seal is circular with a double-lined outer ring containing the words "STATE OF MARYLAND". Inside this is another ring containing "PROFESSIONAL ENGINEER". The center features a detailed drawing of a bridge or dam. Below the drawing, the number "NO 6552" is visible. A blue ink signature "DANIEL F MOYNAGH" is overlaid across the center of the seal.	Scale: 1/8" = 1'-0"
	Drawn By:
	Designed By:
	Checked By:
	Proj. Mgr.:
	Payette Job No.: 17480.00
	Cadd File:
	Client Job No.: J.170.24.4000
	Client Dwg. No.:
	EL2.00C

EL2.00C

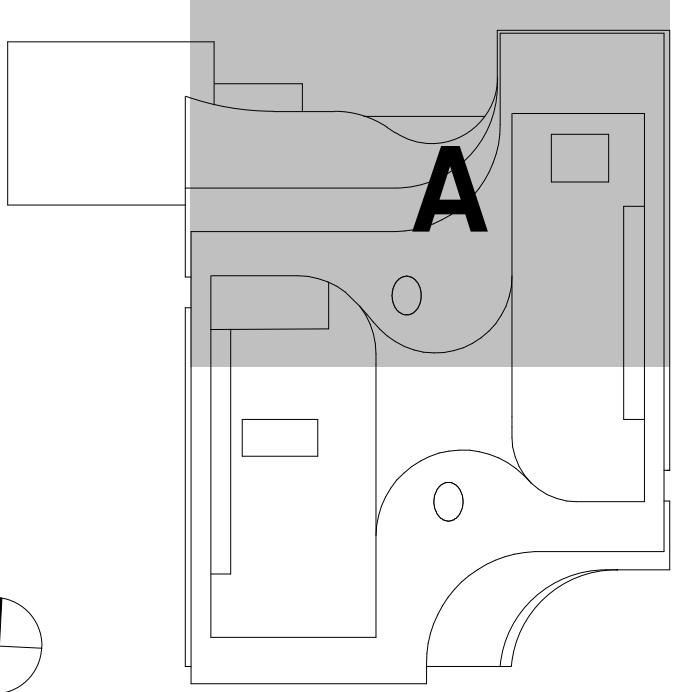
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KEY PLAN

ARCHITECT
AYETTE ASSOCIATES, INC.
10 Congress Street, Fifth Floor
Boston, MA 02210
617.895.1000

ASSOCIATE ARCHITECT
KPN ARCHITECTS
1800 Washington Blvd, Suite 414
Baltimore, MD 21230
443.682.7757

CODE
CODE RED CONSULTANTS
54 Turnpike Road, Suite 200
Southborough, MA 01772
617.500.7633

CIVIL
RK&K
700 East Pratt Street, Suite 500
Baltimore, MD 21202
410.728.2900

LANDSCAPE ARCHITECT
OLIN
7 John F. Kennedy Boulevard,
Suite 1900
Philadelphia, PA 19103


STRUCTURAL
COLUMBIA ENGINEERING, INC.
6210 Old Dobbin Lane, Suite 150
Baltimore, Maryland 21045
410.992.9970

RTICAL TRANSPORTATION
ZIPF ASSOCIATES, INC.
25 Bala Avenue, Suite 201
Bala Cynwyd, PA 19004
610.667.1717

MEP
BR+A CONSULTING ENGINEERS
10 Guest Street, 4th Floor
Boston, MA 02135
617.254.0016

ALARM & FIRE PROTECTION
SETTY & ASSOCIATES
5 S. Charles Street, Suite 403
Baltimore, MD 21201

AUDIO VISUAL & TELECOM
CONVERGENT TECHNOLOGIES
DESIGN GROUP
6501 York Road

SECURITY
THORNTON TOMASETTI
1330 Connecticut Ave, NW,
Suite 300
Washington, DC 20036

FOOD SERVICE
COLBURN GUYETTE
100 Ledgewood Place, Suite 104
Rockland, MA, 02370

BUILDING ENCLOSURE
PSON GUMPERTZ & HEGER
1625 Eye St NW
Suite 900

LEED
SUSTAINABLE DESIGN
CONSULTING
1432 K Street NW, 3rd Floor

WIND & AIR QUALITY
RWDI
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Canada N1K 1B8

VIBRATION & ACOUSTICS
COLIN GORDON ASSOCIATES
1350 Old Bayshore Hwy, Suite 799
Burlingame, CA 94010
415.570.0350

2 West 19th Street, 6th Floor
New York, NY 10011
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ASSOCIATES
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New York, NY 10005
212.766.0144

115 Juliad Ct., Suite 105
Fredericksburg, VA 22406
540.286.1984

AEI AFFILIATED ENGINEERS
200 International Circle, Suite 5888
Hunt Valley, MD 21030
410.229.0090

LIFE SCIENCES BUILDING

600 N Broadway

QUINS JIORKINS

CHINATOWN

N I V E R S I T Y

LIGHTING RGB A - LEVEL 1

	Date:	OCTOBER 24, 2025
	Scale:	1/8" = 1'-0"
	Drawn By:	
	Designed By:	
	Checked By:	
	Proj. Mgr.:	
	Payette Job No.:	17480.00
Cadd File:		

ional Certification.

Client Dwg. No.:
EL2.01A

I declare under penalty of perjury that these documents were prepared or
and by me, and that I am duly licensed
under the laws of the State of Maryland.

EL2.01A

LIGHTING THIS AREA IS DESIGNED BY THE LIGHTING CONSULTANT. REFER TO LIGHTING CONSULTANT DRAWING AND ARCHITECTURAL RCPs FOR EXACT FIXTURE QUANTITIES AND LOCATIONS.

DAYLIGHTING ZONE

N. ENTRY VESTIBULE

W. ENTRY VESTIBULE

OPEN LAB

EQUIPMENT LAB

TASKLIGHT FOR OPEN LABS IS FURNISHED BY LAB BENCH VENDOR AND POWERED VIA BENCH

LAB WASTE

ENVIRONMENTAL ROOM

STAIRWELL VESTIBULE

SHAFT 4C MESS1

STAIRWAY 4

RESTROOM

VESTIBULE

SHARED OFFICE

LARGE MEETING

MEDIUM MEETING

DINING

TOUCH SCREEN CONTROLLER

FIRE COMMAND CENTER

SERVICE CORE

TOUCH SCREEN CONTROLLER, TYP

PH

PT

PR

AV

W

1 LIGHTING RCP A - PARENT - LEVEL 1
1/8" = 1'-0"

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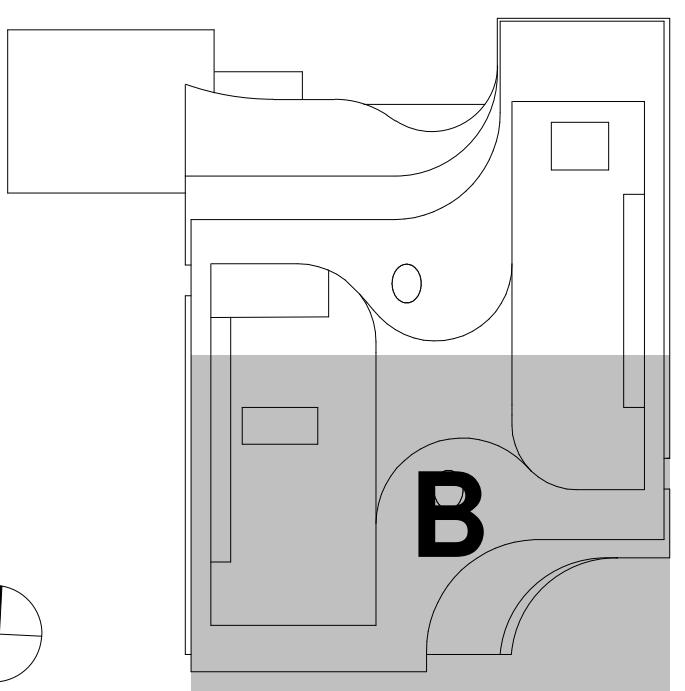
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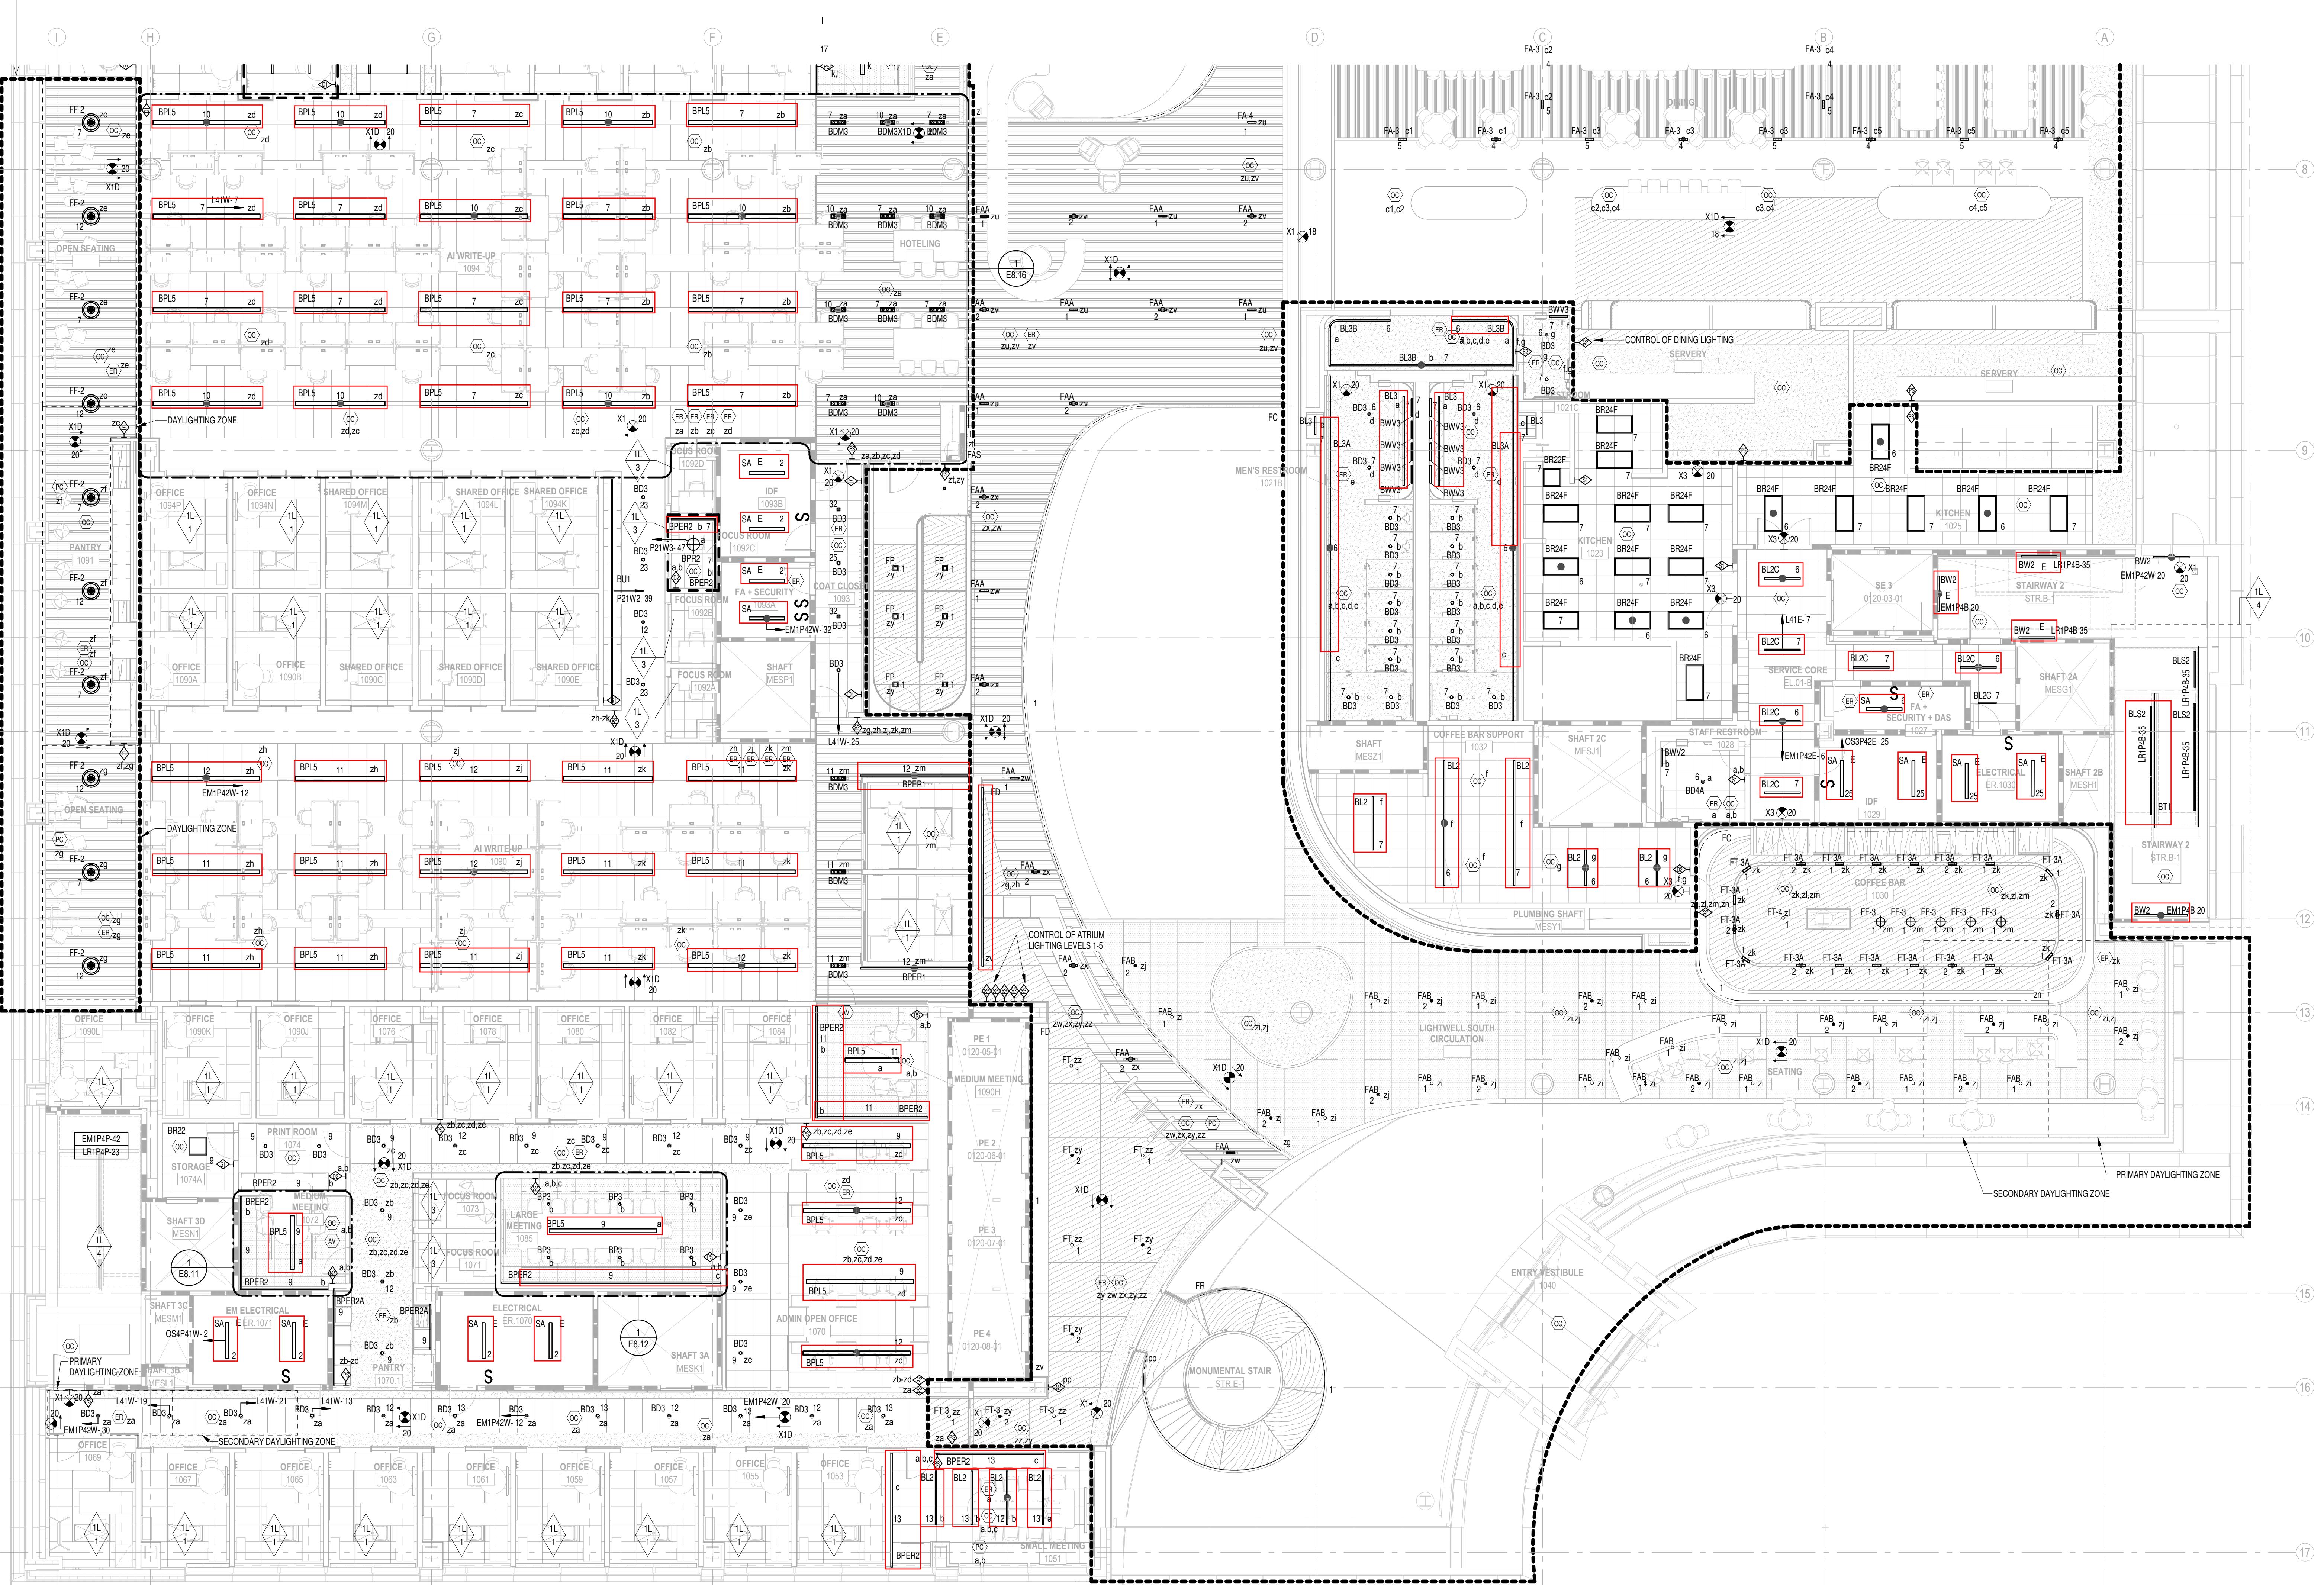
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1 LIGHTING RCP B - PARENT - LEVEL 1
1/2" 1L 0"

$$1/8" = 1'-0"$$

Seal	Date:	OCTOBER 24, 2025
	Scale:	1/8" = 1'-0"
	Drawn By:	
	Designed By:	
	Checked By:	
	Proj. Mgr.:	
	Payette Job No.:	17480.00
	Cadd File:	
	Client Job No.:	J.170.24.4000
	Client Name:	

LIGHTING RCP B - LEVEL 1

LIFE SCIENCES BUILDING
600 N Broadway
Pittsburgh, PA 15222

JOHNS HOPKINS

U N I V E R S I T

1800 Orleans St.
Baltimore, Maryland 21287

LIGHTING RCP B - LEVEL 1

Page 1 of 1 | Date: OCTOBER 2018

Scale: $1/8"$ = 1

Designed By:
Checked By:

PPC
PRO
NEER
Payette Job No.:

Client Job No.: J.17

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er under the laws of the State of Maryland.

EL2.01B

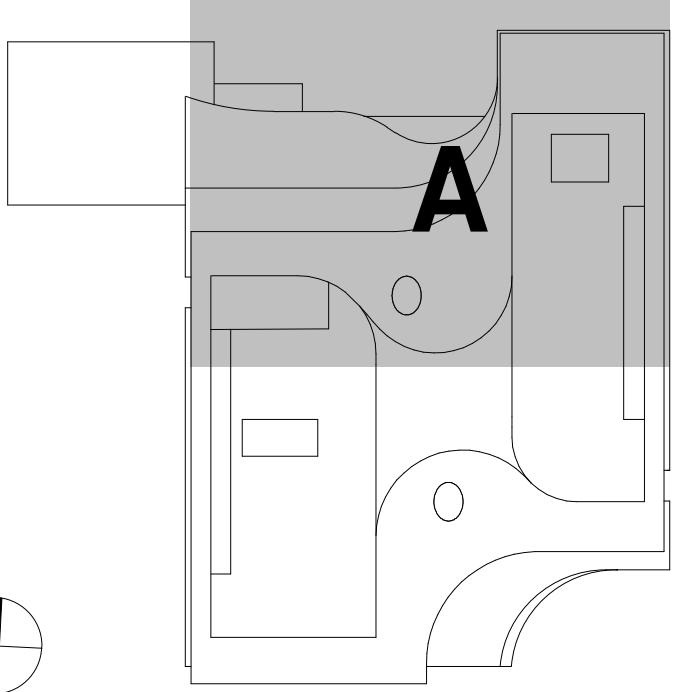
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 3. REFER TO DRAWING E8.03 SERIES FOR LIGHTING CONTROL DRAWINGS.
 4. REFER TO ARCHITECTURAL FLOOR PLANS FOR EQUIPMENT LOCATIONS.
 5. REFER TO ARCHITECTS REFLECTED CEILING PLAN FOR EXACT LOCATION OF LIGHTING FIXTURE PRIOR TO INSTALLATION (TYPICAL).
 6. REFER TO ARCHITECTURAL ELEVATIONS FOR COORDINATION OF WALL MOUNTED FIXTURE LOCATIONS.
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 13. PROVIDE ALL REQUIRED MODULES, INTERFACES, NETWORK MANAGERS, AND CONTROL INTERCONNECTIONS AS REQUIRED BY THE MANUFACTURER(S) TO MEET THE SPECIFIED CONTROL INTENT.
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KEY PLAN

This architectural floor plan illustrates the layout of a building section, likely a laboratory or research facility, with a focus on lighting and fixture placement. The plan includes numerous rooms such as Offices, Corridors, Equipment Rooms, and various types of Laboratories (Open, Fume, Glasswash). Key features include:

- Lighting Fixtures:** The plan shows numerous lighting fixtures, primarily FA-1 (High Bay) and FA-1 (Low Bay) types, distributed throughout the space. Some fixtures are highlighted with red boxes.
- Tasklights:** Tasklights are indicated by red boxes labeled "BL2A", "BL2B", and "BL2C" in several open laboratories.
- Control Systems:** A note specifies that lighting in certain areas is designed by a lighting consultant and refers to "LIGHTING CONSULTANT DRAWING AND ARCHITECTURAL RCPs FOR EXACT FIXTURE QUANTITIES AND LOCATIONS".
- Shafts and Stairways:** The plan shows multiple shafts (e.g., SHAFT 1D, MESE2, SHAFT 1B, MES2) and stairways (e.g., STAIRWAY 1, STRA2).
- Equipment:** Various pieces of equipment are shown, including Environmental Rooms, Fume Hoods, and Glasswash units.
- Rooms:** Specific rooms labeled include OFFICE 2012, OFFICE 2010, OFFICE 2008, OFFICE 2006, OFFICE 2004, OFFICE 2002, LAB WASTE, SERVICE CORE, and several types of LABORATORIES.

The plan is highly detailed, showing room numbers, fixture types, and specific fixture locations (e.g., "10 zy", "10 zx"). Red boxes highlight specific fixtures or areas of interest, such as BL2A, BL2B, and BL2C tasklights in various laboratories.

A technical line drawing of a mechanical assembly, likely a pump or valve component. The drawing is composed of various geometric shapes: rectangles, circles, and arcs. A large, bold letter 'A' is positioned in the upper right quadrant of the assembly. The assembly features a central vertical column with a flange at the top. To the left of this column is a horizontal rectangular component. On the right side, there is a vertical rectangular housing with a small square cutout. The bottom section of the assembly includes several curved and straight lines representing internal parts like shafts or seals. In the bottom left corner of the image, there is a separate circular icon containing a smaller 'A' symbol, which appears to be a magnified view or a detail of a part.

KEY PLAN

ARCHITECT PAYETTE ASSOCIATES, INC. 290 Congress Street, Fifth Floor Boston, MA 02210 617.895.1000	ASSOCIATE ARCHITECT KPN ARCHITECTS 1800 Washington Blvd, Suite 414 Baltimore, MD 21230 443.682.7757
CODE CODE RED CONSULTANTS 154 Turnpike Road, Suite 200 Southborough, MA 01772 617.500.7633	CIVIL RK&K 700 East Pratt Street, Suite 500 Baltimore, MD 21202 410.728.2900
LANDSCAPE ARCHITECT OLIN 1617 John F. Kennedy Boulevard, Suite 1900 Philadelphia, PA 19103 215.440.0030	STRUCTURAL COLUMBIA ENGINEERING, INC. 6210 Old Dobbin Lane, Suite 150 Baltimore, Maryland 21045 410.992.9970
VERTICAL TRANSPORTATION ZIPF ASSOCIATES, INC. 25 Bala Avenue, Suite 201 Bala Cynwyd, PA 19004 610.667.1717	MEP BR+A CONSULTING ENGINEERS 10 Guest Street, 4th Floor Boston, MA 02135 617.254.0016
FIRE ALARM & FIRE PROTECTION SETTY & ASSOCIATES 575 S. Charles Street, Suite 403 Baltimore, MD 21201 667.309.6036	AUDIO VISUAL & TELECOM CONVERGENT TECHNOLOGIES DESIGN GROUP 6501 York Road Baltimore, MD 21212 410.532.2395
SECURITY THORNTON TOMASETTI 1330 Connecticut Ave, NW, Suite 300 Washington, DC 20036 202.580.6300	FOOD SERVICE COLBURN GUYETTE 100 Ledgewood Place, Suite 104 Rockland, MA, 02370 781.826.5522
BUILDING ENCLOSURE SIMPSON GUMPERTZ & HEGER 1625 Eye St NW Suite 900 Washington, DC 20006 202.239.4199	LEED SUSTAINABLE DESIGN CONSULTING 1432 K Street NW, 3rd Floor Washington, DC 20005 202.667.1620
WIND & AIR QUALITY RWDI 650 Woodland Rd. W. Guelph, Ontario Canada N1K 1B8 519.823.1311	VIBRATION & ACOUSTICS COLIN GORDON ASSOCIATES 1350 Old Bayshore Hwy, Suite 799 Burlingame, CA 94010 415.570.0350
LIGHTING FISHER MARANTZ STONE 22 West 19th Street, 6th Floor New York, NY 10011 212.691.3020	SITE LIGHTING TILLETT LIGHTING DESIGN ASSOCIATES 11 Hanover Square, 17th Floor New York, NY 10005 212.766.0144
EMI/RFI (SHEILDING) VITATECH ELECTROMAGNETICS 115 Juliad Ct., Suite 105 Fredericksburg, VA 22406 540.286.1984	CAMPUS UTILITIES AEI AFFILIATED ENGINEERS 200 International Circle, Suite 5888 Hunt Valley, MD 21030 410.229.0090

LIFE SCIENCES BUILDING

JOHNS HOPKINS

U N I V E R S I T Y

Seal	Date:	OCTOBER 24, 2025
	Scale:	1/8" = 1'-0"
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	Designed By:	
	Checked By:	
	Proj. Mgr.:	
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	Client Dwg. No.:	

"I certify that these documents were prepared or approved by me, and that I am duly licensed engineer under the laws of the State of Maryland.

EL2.02A

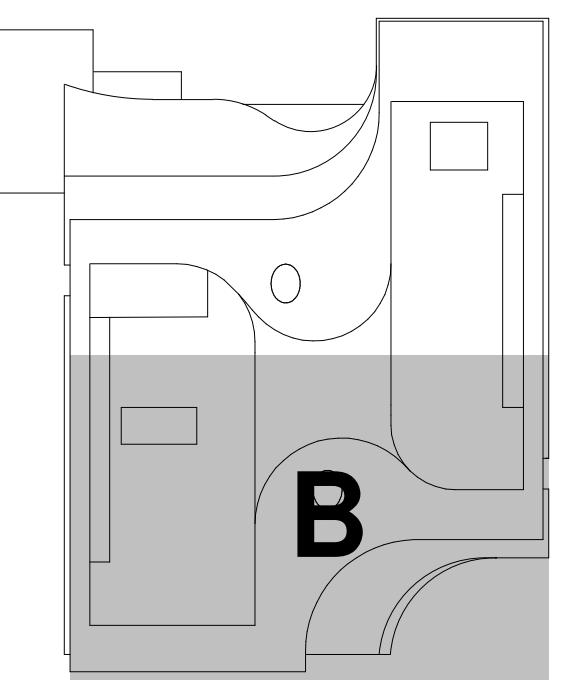
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LAYOUTS.**

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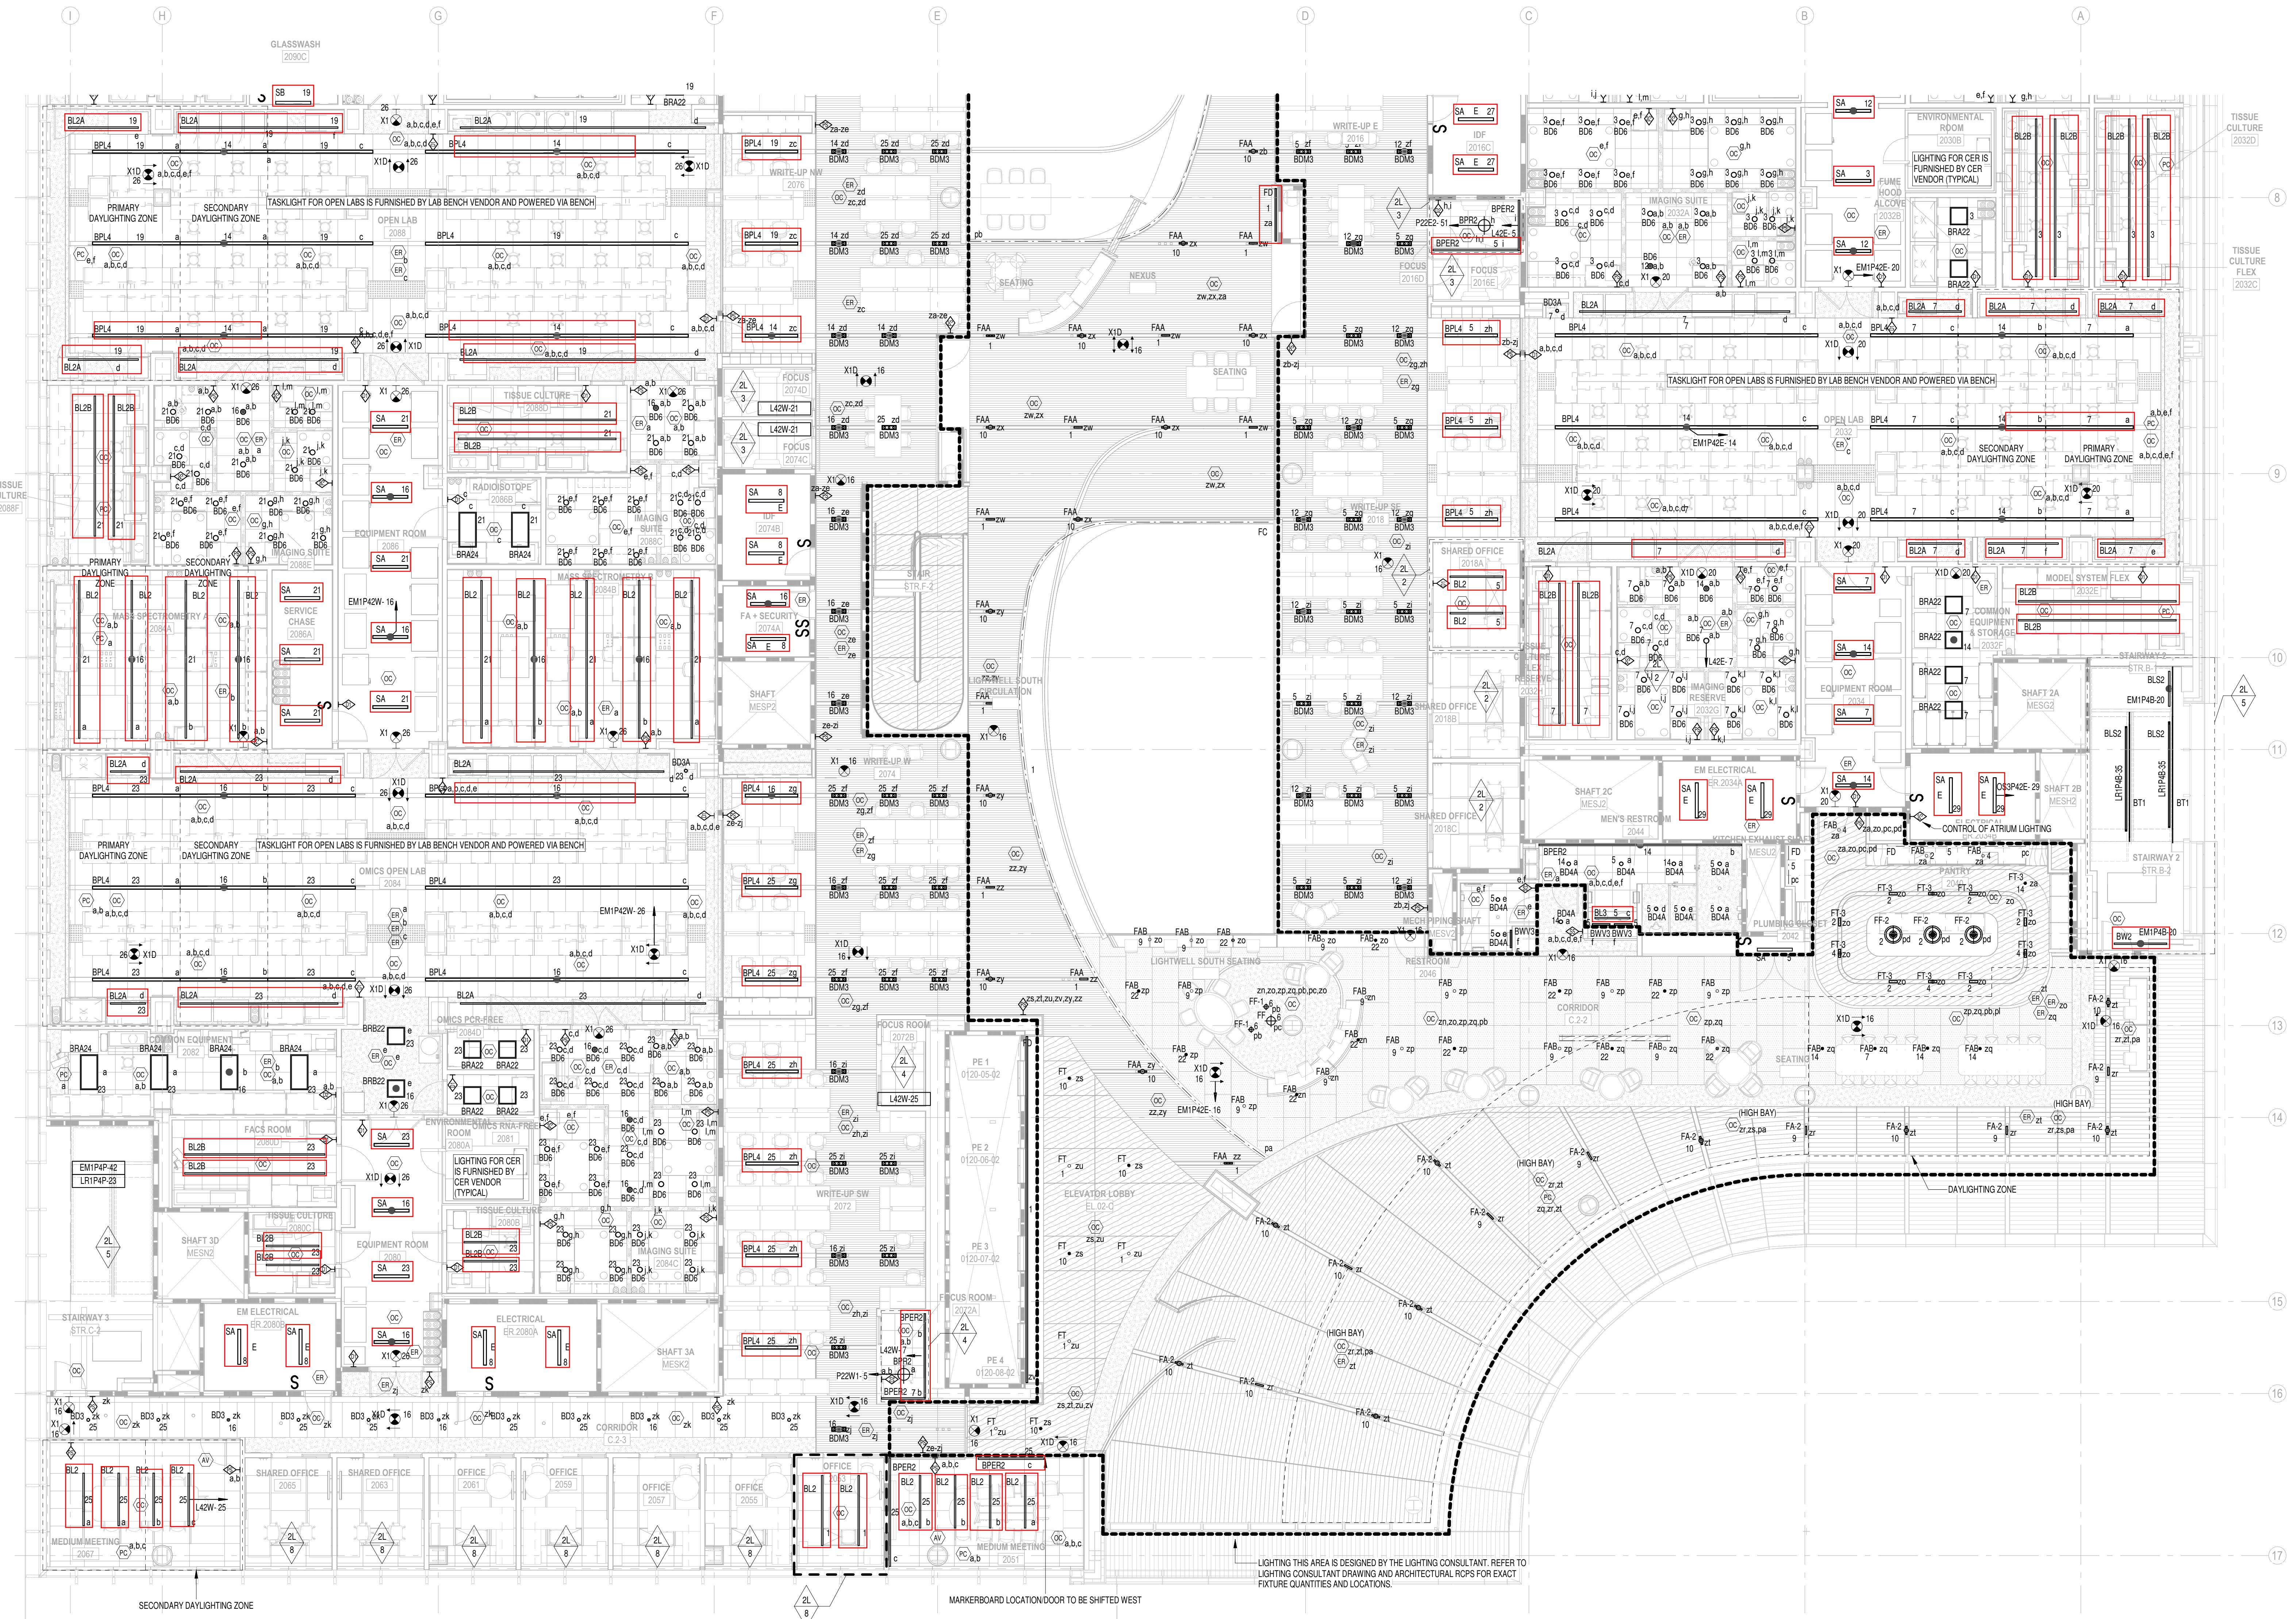
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KEY PLAN



1 LIGHTING RCP B - PARENT - LEVEL 2

$\ominus 1/8 =$

This technical drawing illustrates a complex mechanical assembly, possibly a pump or valve. It features a central vertical shaft supported by two bearings. The housing is composed of various machined components, including a top cover with a ribbed base and a side panel with a small square cutout. A prominent feature is a curved, ribbed duct or pipe section. A large, bold letter 'B' is printed in the lower right quadrant of the drawing. In the bottom left corner, there is a small circular detail view showing a cross-section of a part, with a thick vertical line indicating the plane of the cut.

KEY PLAN

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**CONSULTING
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202.667.1620**

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1350 Old Bayshore Hwy, Suite 799
Burlingame, CA 94010
415.570.0350

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22 West 19th Street, 6th Floor
New York, NY 10011
212.691.3020

SITE LIGHTING
TILLETT LIGHTING DESIGN
ASSOCIATES
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New York, NY 10005
212.766.0144

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Fredericksburg, VA 22406

CAMPUS UTILITIES
AEI AFFILIATED ENGINEERS
200 International Circle, Suite 5888

410.229.0090

600 N Broadway
Baltimore, MD 21205

JOHNS HOPKINS

1800 Orleans St
Baltimore, Maryland 21287

LIGHTING RCP B - LEVEL 2

Seal	Date:	OCTOBER 24, 2025
	Scale:	1/8" = 1'-0"
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	Checked By:	
	Proj. Mgr.:	
	Payette Job No.:	17480.00
	Cadd File:	
	Client Job No.:	J.170.24.4000
	Client Name:	

I certify that these documents were prepared or
proved by me, and that I am duly licensed
engineer under the laws of the State of Maryland.

EL2.02B

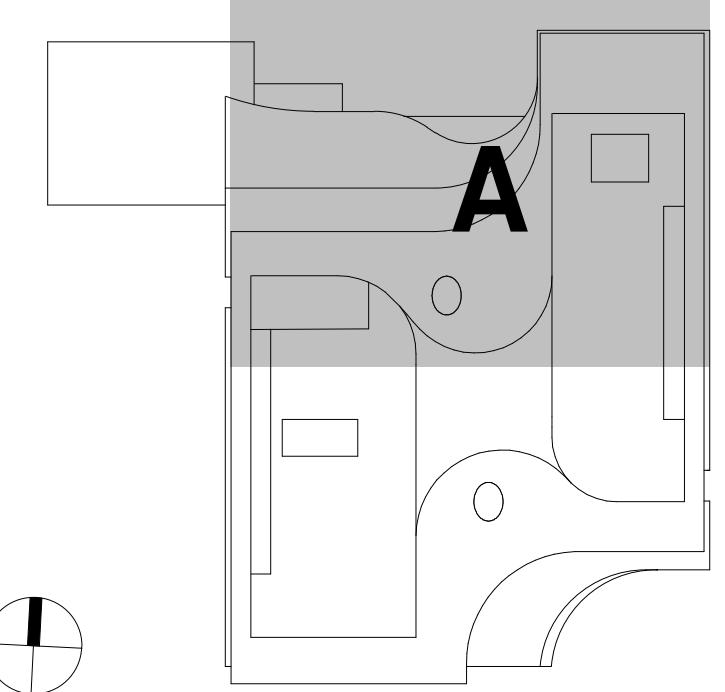
REFER TO LIGHTING CONSULTANT'S DRAWINGS AND
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KEY PLAN

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1625 Eye St NW
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SUSTAINABLE DESIGN
CONSULTING
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WIND & AIR QUALITY
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650 Woodland Rd.
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1350 Old Bayshore Hwy, Suite 799
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LIGHTING
FISHER MARANTZ STONE

SITE LIGHTING
TILLETT LIGHTING DESIGN

EMI/RFI (SHEILDING)
ATECH ELECTROMAGNETICS
115 Lincoln St., Suite 105

CAMPUS UTILITIES
AEI AFFILIATED ENGINEERS

Fredericksburg, VA 22400 100 International Circle, Suite 300
540.286.1984 Hunt Valley, MD 21030
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LIFE SCIENCES BUILDING

600 N Broadway
Baltimore, MD 21205

JOHNS HOPKINS

U N I V E R S I T Y

1800 Orleans St
Baltimore, Maryland 21287

 <p>The seal is circular with a double-lined outer ring containing the words "STATE OF MARYLAND" at the top and "PROFESSIONAL ENGINEER" at the bottom. The center features a detailed drawing of a ship on waves, surrounded by a wreath.</p>	Date:	OCTOBER 24, 2025
	Scale:	1/8" = 1'-0"
Drawn By:		
Designed By:		
Checked By:		
Proj. Mgr.:		
Payette Job No.:	17480.00	
Cadd File:		
Client Job No.:	J.170.24.4000	
Client Name:		

I certify that these documents were prepared or
executed by me, and that I am duly licensed
to practice law under the laws of the State of Maryland.

EL2.03A

1 LIGHTING RCP A - PARENT - LEVEL 3
1/8" = 1'-0"

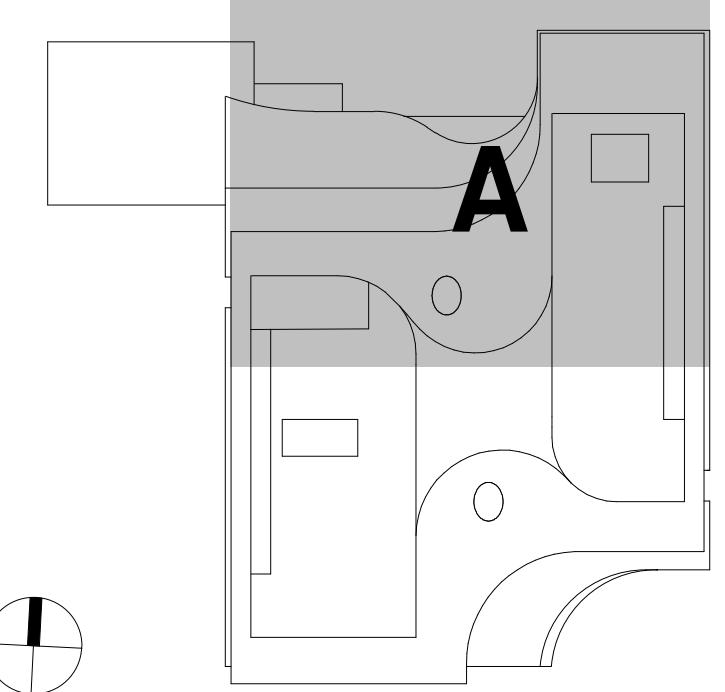
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895.1000

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SITE LIGHTING
TILLETT LIGHTING DESIGN
ASSOCIATES
11 Hanover Square, 17th Floor
New York, NY 10005
212 766 0144

CAMPUS UTILITIES
AEI AFFILIATED ENGINEERS
200 Loma Street, Suite 5000

Hunt Valley, MD 21030
410.229.0090

SCIENCES BUILDING

600 N Broadway
Boulder, CO 80302

LIFE SCIENCES BUILDING

600 N Broadway
Baltimore, MD 21205

JHNS HOPKINS

1800 Orleans St
Baltimore, Maryland 21287



	Date:	OCTOBER 24, 2025
	Scale:	1/8" = 1'-0"
Drawn By:		
Designed By:		
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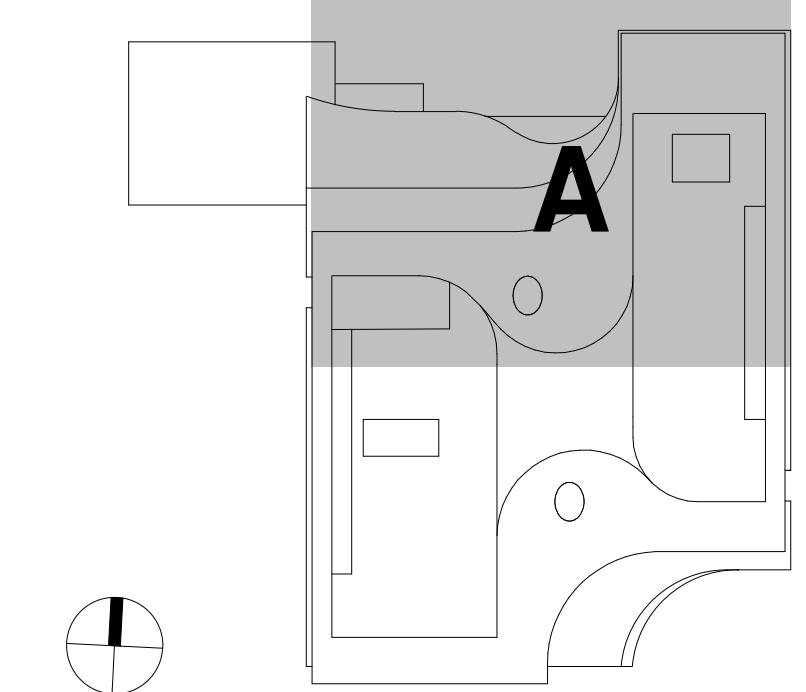
**REFER TO LIGHTING CONSULTANT'S DRAWINGS AND
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LAYOUTS.**

FOR PRICING PURPOSES, ASSUME THAT EACH UNIQUE FIXTURE TYPE WITHIN A SPACE SHALL ON A DEDICATED CONTROL ZONE (UNLESS OTHERWISE NOTED). PLUS ADDITIONAL ZONES FOR PRIMARY AND SECONDARY DAYLIGHT ZONES.

ASSUME EGRESS LIGHTING WITH BYPASS RELAYS FOR ALL LIGHTING IN THE PATH OF EGRESS.

GENERAL LIGHTING NOTES:

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 2. REFER TO LIGHTING FIXTURE SCHEDULE ON DRAWING E7.30 SERIES FOR SPECIFICATION OF FIXTURES.
 3. REFER TO DRAWING E8.03 SERIES FOR LIGHTING CONTROL DRAWINGS.
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 5. REFER TO ARCHITECTS REFLECTED CEILING PLAN FOR EXACT LOCATION OF LIGHTING FIXTURE PRIOR TO INSTALLATION (TYPICAL).
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KEY PLAN

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TS
200
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CIVIL
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Washington, DC 20005
202.667.1620

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Baltimore, MD 21205

JHNS HOPKINS

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Baltimore, Maryland 21287

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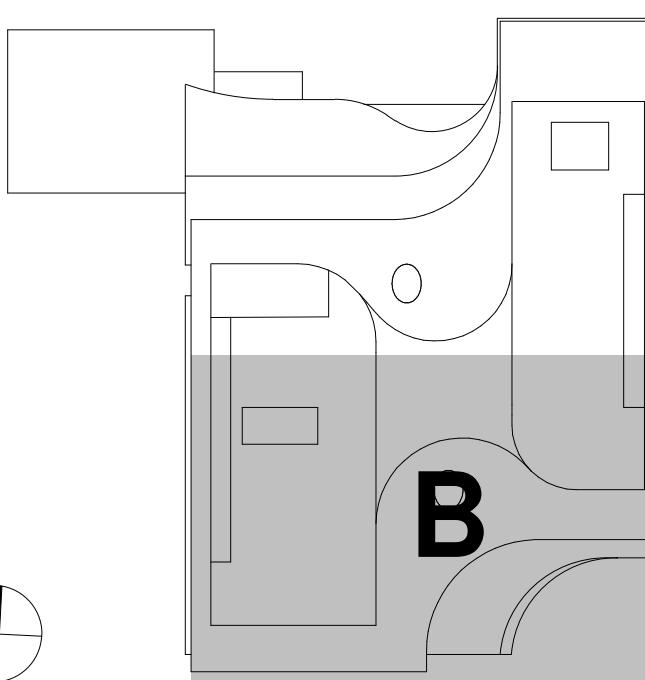
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KEY PLAN

SEE DRAWING E0.04
FOR TERRACE SITE
LIGHTING

**SEE DRAWING E0.04
FOR TERRACE SITE
LIGHTING**

LIFE SCIENCES BUILDING

600 N Broadway
Baltimore, MD 21205

JOHNS HOPKINS

Baltimore, Maryland 21287



Certification.

EL2.05B

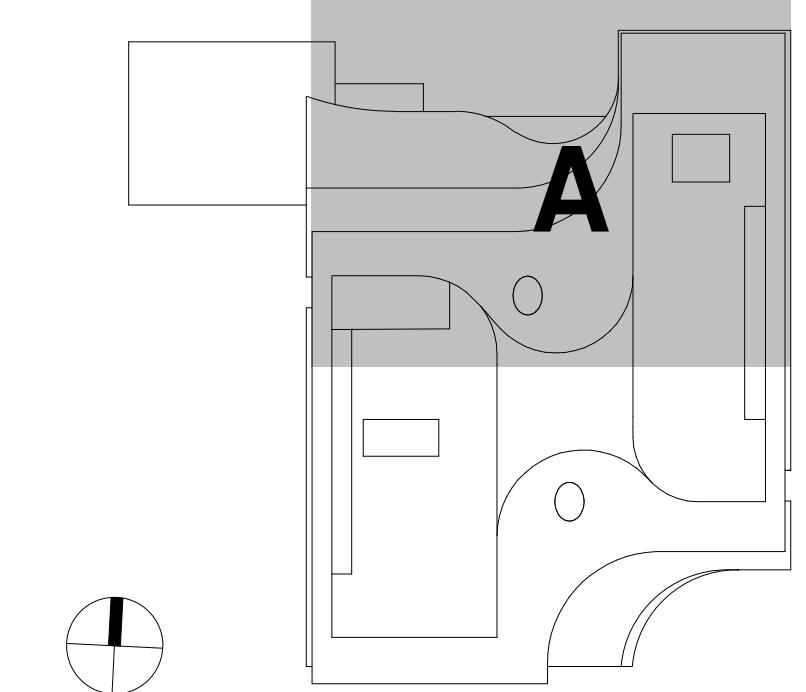
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KEY PLAN

ARCHITECT
AYETTE ASSOCIATES, INC.
0 Congress Street, Fifth Floor
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KPN ARCHITECTS
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CODE CODE RED CONSULTANTS 54 Turnpike Road, Suite 200 Southborough, MA 01772 617.500.7633	CIVIL RK&K 700 East Pratt Street, Suite 500 Baltimore, MD 21202 410.728.2900
--	---

LANDSCAPE ARCHITECT
OLIN
7 John F. Kennedy Boulevard,
Suite 1900
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215.412.9929

STRUCTURAL
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ALARM & FIRE PROTECTION
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5 S. Charles Street, Suite 403
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667.309.6036

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CONVERGENT TECHNOLOGIES
DESIGN GROUP
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Baltimore, MD 21212

SECURITY
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FOOD SERVICE
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Rockland, MA, 02370
781.826.5522

BUILDING ENCLOSURE
PSON GUMPERTZ & HEGER
1625 Eye St NW
Suite 900
Washington, DC 20006

LEED
SUSTAINABLE DESIGN
CONSULTING
1432 K Street NW, 3rd Floor
Washington, DC 20005

WIND & AIR QUALITY
RWDI **VIBRATION & ACOUSTICS**
COLIN GORDON ASSOCIATES

W. Guelph, Ontario
Canada N1K 1B8
519.823.1311

Burlingame, CA 94010
415.570.0350

LIGHTING
FISHER MARANTZ STONE
2 West 19th Street, 6th Floor
New York, NY 10011

SITE LIGHTING
TILLETT LIGHTING DESIGN
ASSOCIATES
11 Hanover Square, 17th Floor

EMI/RFI (SHEILDING)
TECH ELECTROMAGNETICS
115 Juliad Ct., Suite 105
Fredericksburg, VA 22406

CAMPUS UTILITIES
AEI AFFILIATED ENGINEERS
200 International Circle, Suite 5888

410.229.0090

Baltimore, MD 21203

JOHNS HOPKINS

N I V E R S I T Y

1800 Orleans St
Baltimore, Maryland 21287

LIGHTING RCP A - LEVEL 6	Date: OCTOBER 24, 2025
	Scale: 1/8" = 1'-0"
	Drawn By:
	Designed By:
	Checked By:
	Proj. Mgr.:
	Payette Job No.: 17480.00
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	Client Name:

y that these documents were prepared or
d by me, and that I am duly licensed
under the laws of the State of Maryland.

EL2.06A

This architectural floor plan illustrates the layout of a facility across eight levels (1-8). The plan includes detailed room descriptions, equipment locations, and specific requirements for lighting and electrical devices.

Key Features and Annotations:

- Rooms and Areas:** PLUMBING ROOM (6000), SERVICE CORE (EL.06-A), VESTIBULE (6003), CIRCULATION (C.6-2), BED & VAC (6005), PRE-DECON (6007), POST-DECON (6010), STERILE CAGE WASH (6012), DIRTY CAGE WASH (6018), CLEAN CAGE WASH (6016), HYBRID CORRIDOR (S.6-4E), BEHAVIORAL SUITE 1 (6098), BEHAVIORAL ARL (6098B), BEHAVIORAL ARL (6098C), BEHAVIORAL TEST STORAGE (6104), LAB WASTE HOLDING (6102), CYLINDER CLOSET (6125), RESTROOM (6127, 6129), SHAFT 4D (MEST6), SHAFT 4C (MESS6), SHAFT 4B (MESR6), SHAFT 4A (MESQ6), IRRADIATOR (6106), PERFUSION (6108), HYBRID (S.6-4E), and various PROCEDURE rooms (e.g., 6097A, 6097B, 6098A, 6098B, 6098C, 6099A, 6099B, 6099C, 6099D, 6099E, 6099F, 6099G, 6099H, 6099I, 6099J, 6099K, 6099L, 6099M, 6099N, 6099O, 6099P, 6099Q, 6099R, 6099S, 6099T, 6099U, 6099V, 6099W, 6099X, 6099Y, 6099Z).
- Lighting and Fixtures:** Numerous lighting fixtures (FT 16, FT 9, FT 18, etc.) and switches (SA 1, SA 16) are indicated throughout the plan. Specific fixture locations include VIV1P46W-1 through VIV1P46W-18, EM1P45W-1 through EM1P45W-9, and EM1P45E-1 through EM1P45E-17.
- Electrical Requirements:** A dashed boundary highlights areas where "ALL ELECTRICAL DEVICES SHALL BE SEALED, GASKETED, AND HAVE NEMA 4X WASH DOWN RATED COVERS WITHIN THIS BOUNDARY." Another boundary indicates "COORDINATE LOCATION OF LIGHTING AND SWITCHES WITHIN SERVICE CHASES WITH EQUIPMENT VENDOR."
- Shafts and Stairways:** Shafts labeled 1A through 1D are shown, along with Stairway 4 (STRD-6).
- Control and Safety:** Labels like "CONTROL OF RED LIGHT IN CORRIDOR" and "TESTING" are present in several areas.
- Annotations:** A note in the center states: "LIGHTING THIS AREA IS DESIGNED BY THE LIGHTING CONSULTANT. REFER TO LIGHTING CONSULTANT DRAWING AND ARCHITECTURAL RCS FOR EXACT FIXTURE QUANTITIES AND LOCATIONS."

1 LIGHTING RCP A - PARENT - LEVEL 6
1/8" = 1'-0"

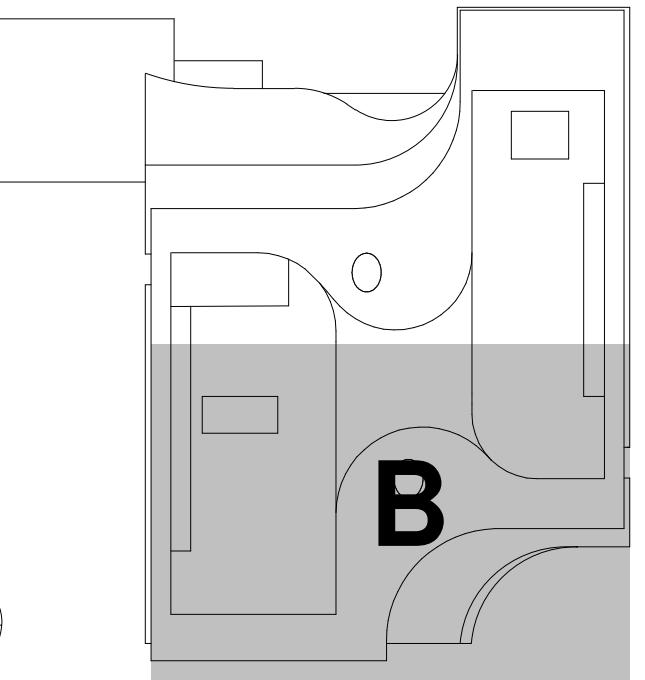


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KEY PLAN

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SECURITY THORNTON TOMASETTI 1330 Connecticut Ave, NW, Suite 300 Washington, DC 20036 202.580.6300	FOOD SERVICE COLBURN GUYETTE 100 Ledgewood Place, Suite 104 Rockland, MA, 02370 781.826.5522
BUILDING ENCLOSURE SIMPSON GUMPERTZ & HEGER 1625 Eye St NW Suite 900 Washington, DC 20006 202.239.4199	LEED SUSTAINABLE DESIGN CONSULTING 1432 K Street NW, 3rd Floor Washington, DC 20005 202.667.1620
WIND & AIR QUALITY RWDI 650 Woodland Rd. W. Guelph, Ontario Canada N1K 1B8 519.823.1311	VIBRATION & ACOUSTICS COLIN GORDON ASSOCIATES 1350 Old Bayshore Hwy, Suite 799 Burlingame, CA 94010 415.570.0350
LIGHTING FISHER MARANTZ STONE 22 West 19th Street, 6th Floor New York, NY 10011 212.691.3020	SITE LIGHTING TILLETT LIGHTING DESIGN ASSOCIATES 11 Hanover Square, 17th Floor New York, NY 10005 212.766.0144
EMI/RFI (SHEILDING) VITATECH ELECTROMAGNETICS 115 Juliad Ct., Suite 105 Fredericksburg, VA 22406 540.286.1984	CAMPUS UTILITIES AEI AFFILIATED ENGINEERS 200 International Circle, Suite 5888 Hunt Valley, MD 21030

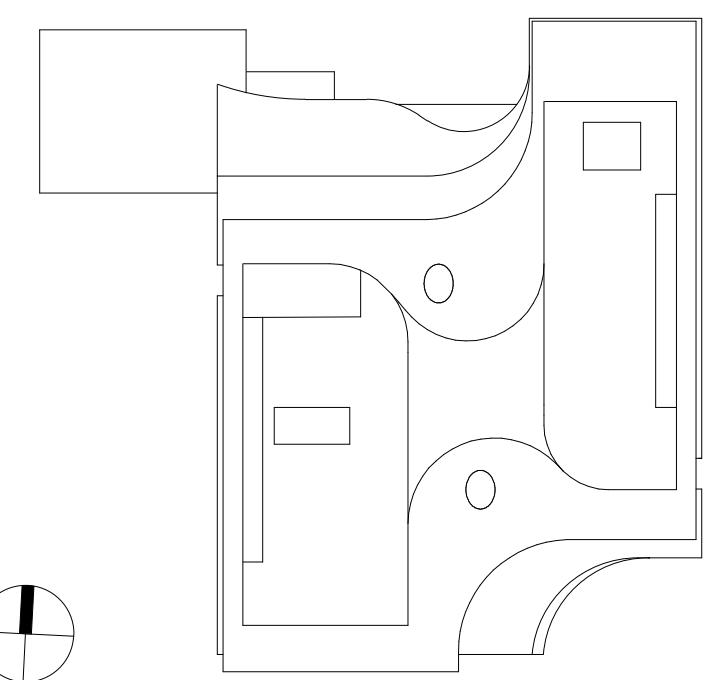
LIFE SCIENCES BUILDING

600 N Broadway
Baltimore, MD 21205

Baltimore, Maryland 21207

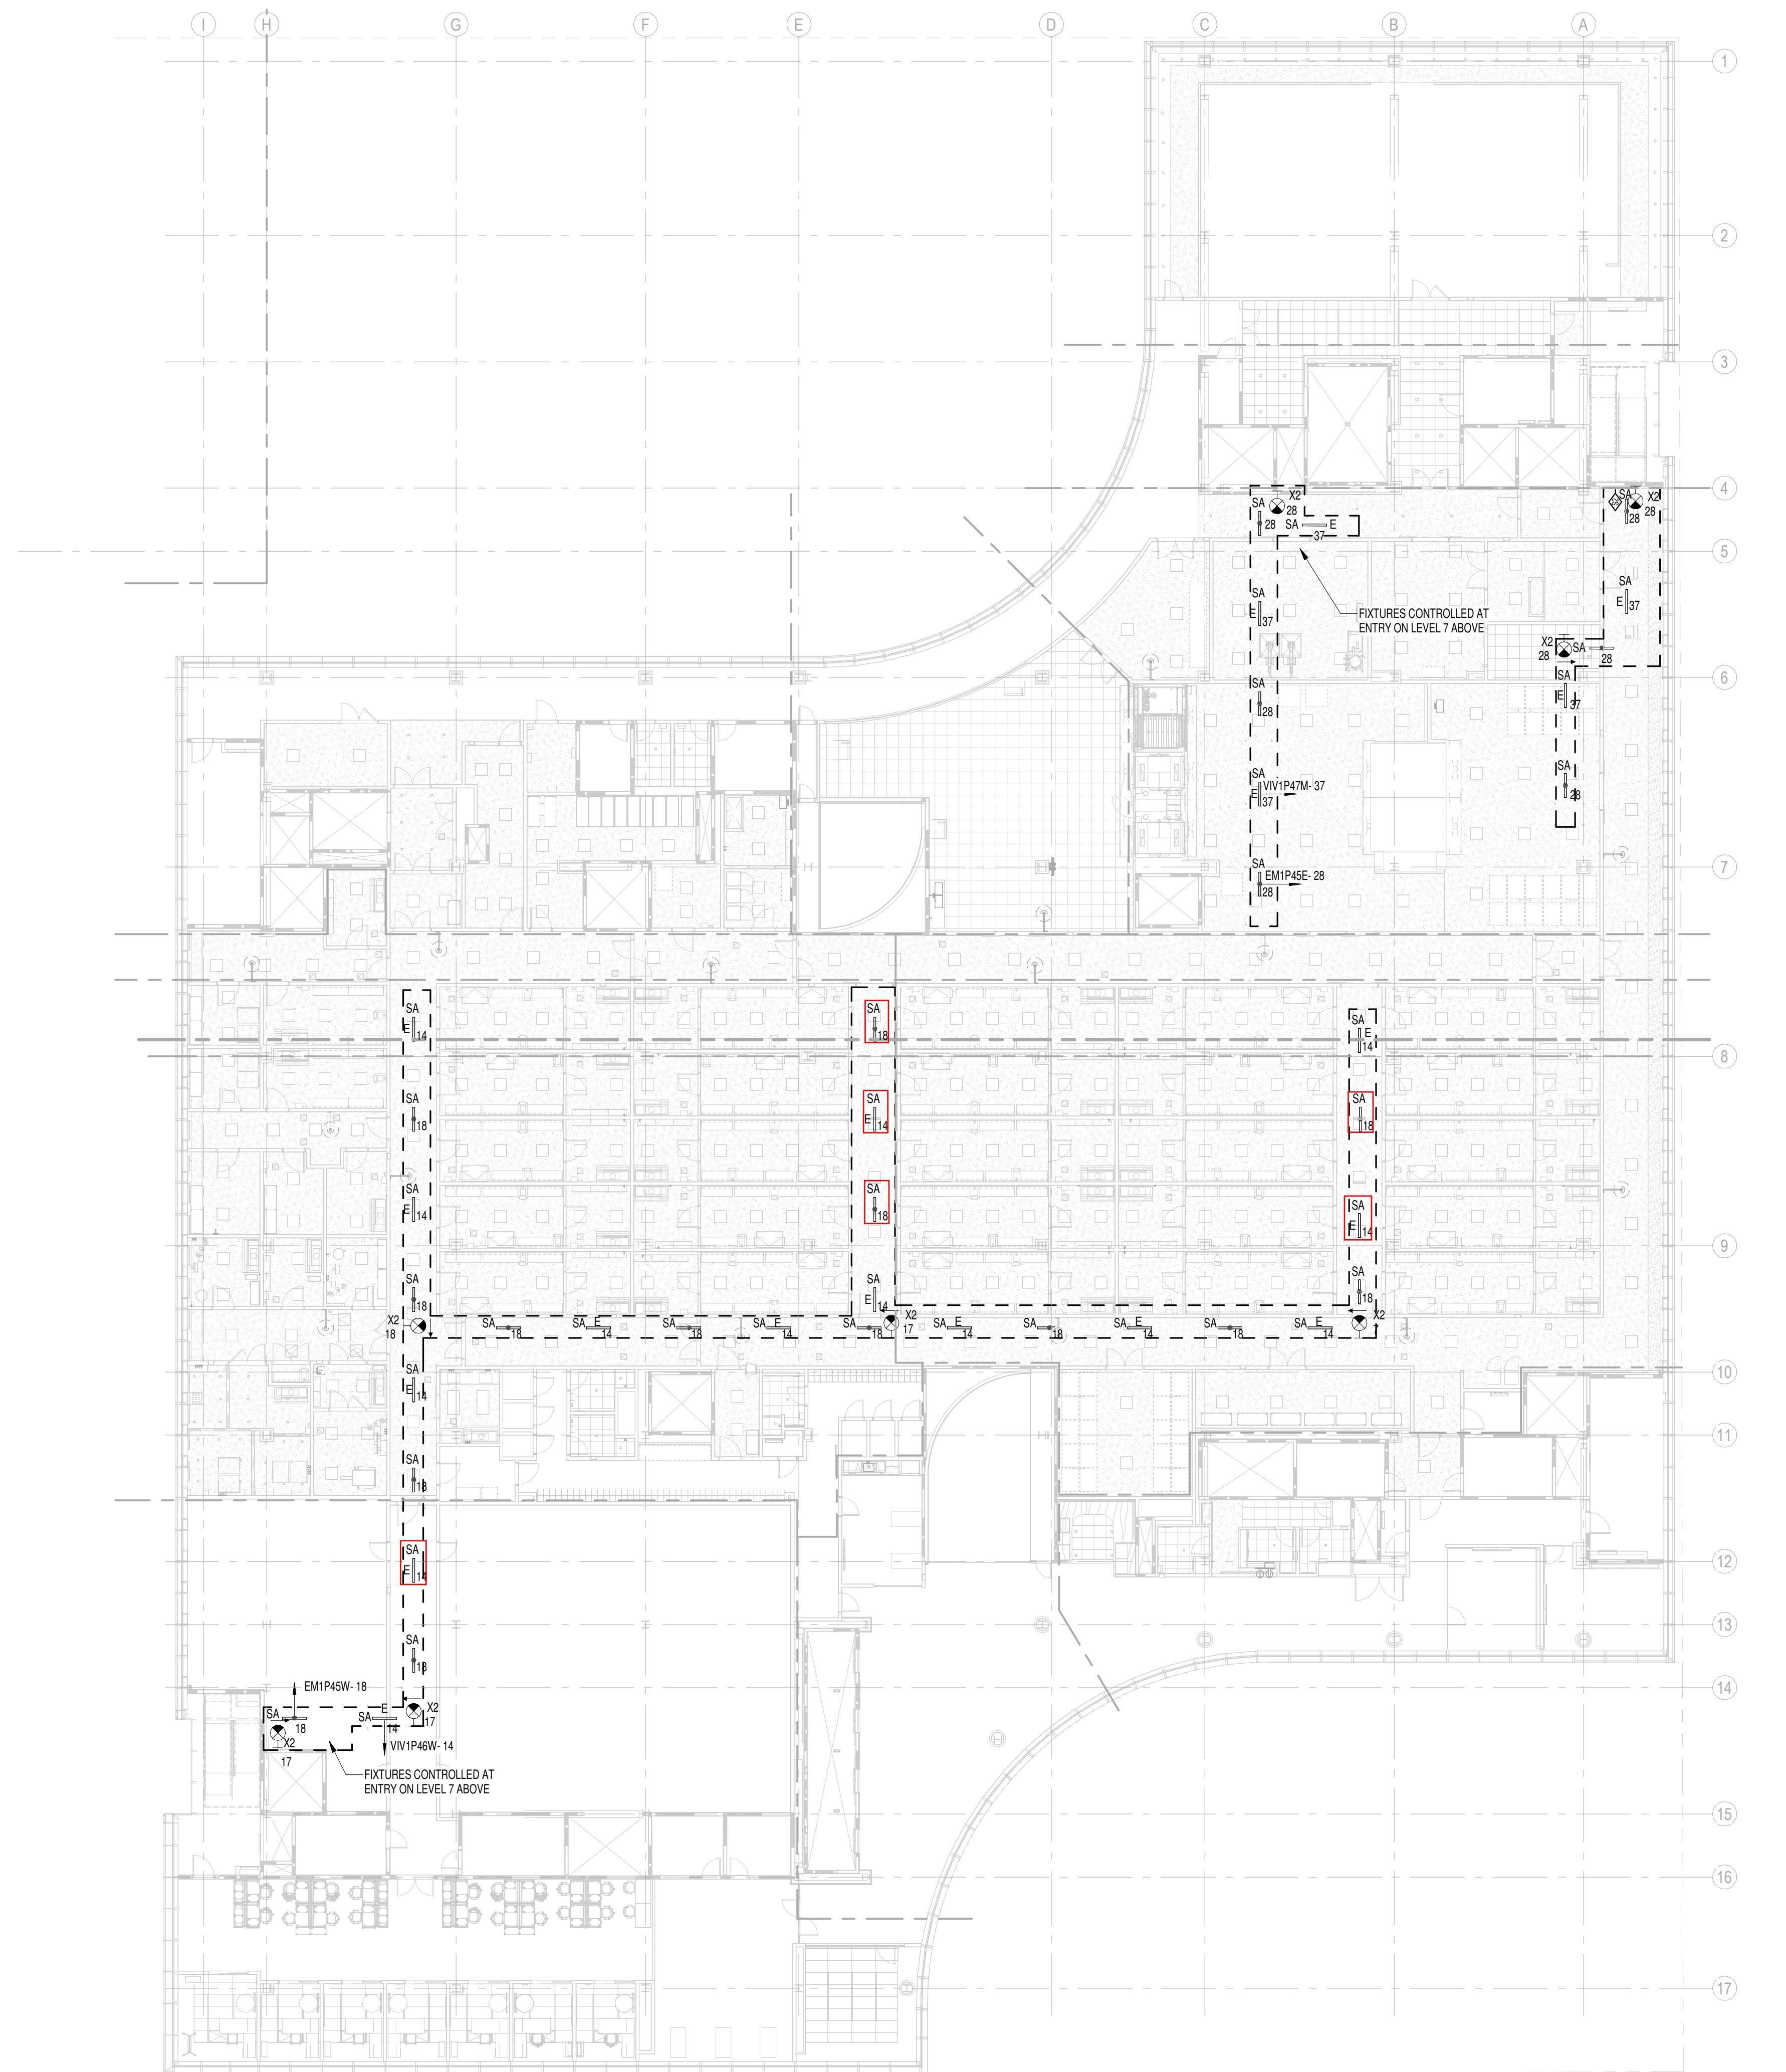
LIGHTING RCP B - LEVEL 6

EL2.06B



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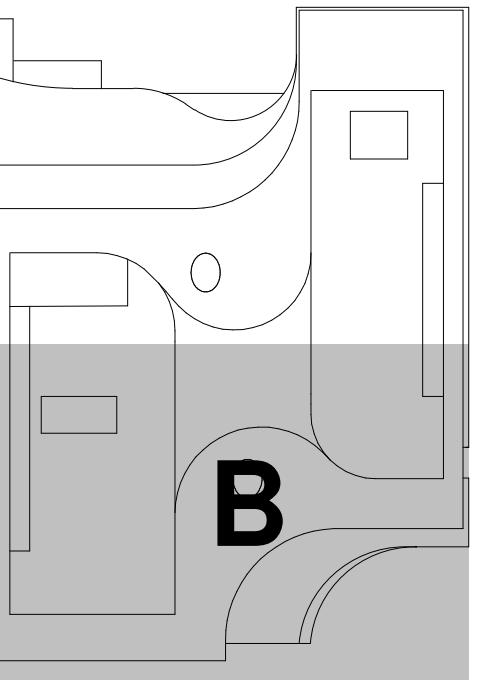
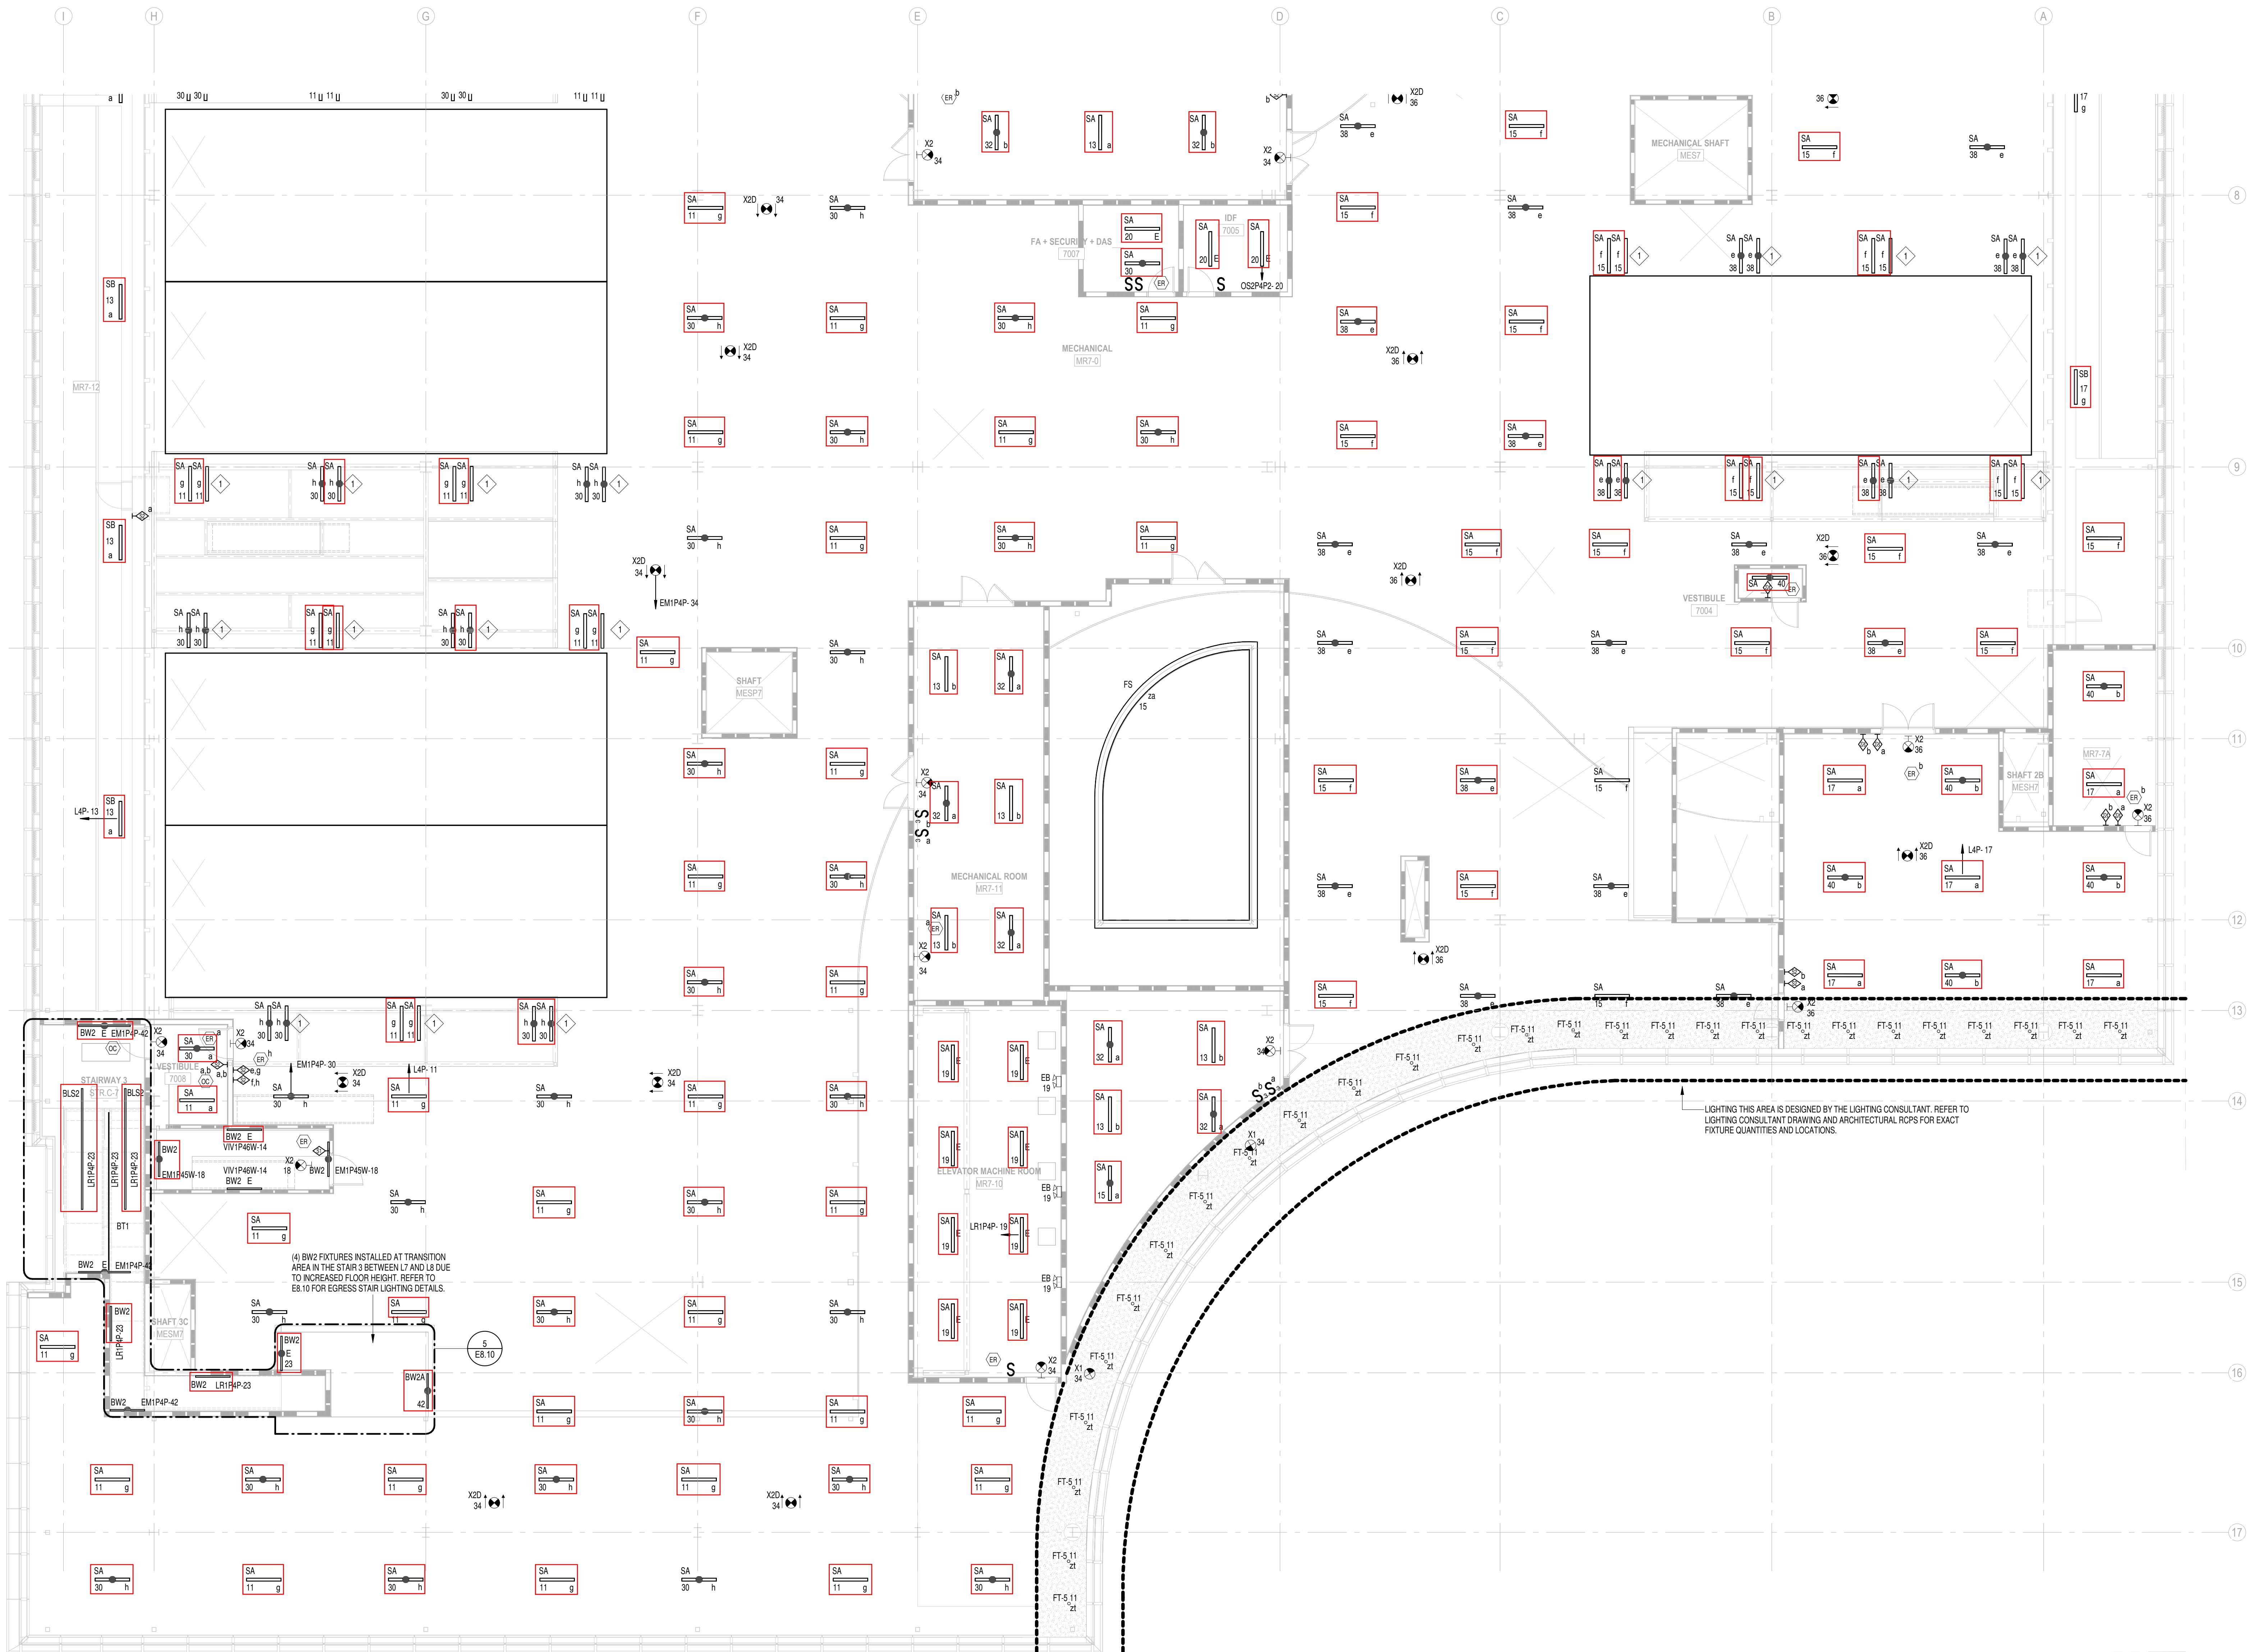
1 LIGHTING RCP - LEVEL 6 CATWALK
1/16" = 1'-0"

Seal	Date:	OCTOBER 24, 2025
 The seal is circular with a double-lined outer border. The top half of the inner border contains the words "STATE OF MARYLAND" and the bottom half contains "PROFESSIONAL ENGINEER". The center features a detailed crest with a shield, a sword, and a compass, surrounded by a laurel wreath.	Scale:	As indicated
	Drawn By:	
	Designed By:	
	Checked By:	
	Proj. Mgr.:	
	Payette Job No.:	17480.00
	Cadd File:	
Professional Certification.	Client Job No.:	J.170.24.4000
I certify that these documents were prepared or approved by me, and that I am duly licensed engineer under the laws of the State of Maryland.	Client Dwg. No.:	
EL2.06M		

Professional Certification.

I certify that these documents were prepared or
approved by me, and that I am duly licensed
engineer under the laws of the State of Maryland.

EL2.06M



KEY PLAN

ARCHITECT PAYETTE ASSOCIATES, INC. 290 Congress Street, Fifth Floor Boston, MA 02210 617.895.1000	ASSOCIATE ARCHITECT KPN ARCHITECTS 1800 Washington Blvd, Suite 414 Baltimore, MD 21230 443.682.7757
CODE CODE RED CONSULTANTS 154 Turnpike Road, Suite 200 Southborough, MA 01772 617.500.7633	CIVIL RK&K 700 East Pratt Street, Suite 500 Baltimore, MD 21202 410.728.2900
LANDSCAPE ARCHITECT OLIN 617 John F. Kennedy Boulevard, Suite 1900 Philadelphia, PA 19103 215.440.0030	STRUCTURAL COLUMBIA ENGINEERING, INC. 6210 Old Dobbin Lane, Suite 150 Baltimore, Maryland 21045 410.992.9970
VERTICAL TRANSPORTATION ZIPF ASSOCIATES, INC. 25 Bala Avenue, Suite 201 Bala Cynwyd, PA 19004 610.667.1717	MEP BR+A CONSULTING ENGINEERS 10 Guest Street, 4th Floor Boston, MA 02135 617.254.0016
FE ALARM & FIRE PROTECTION SETTY & ASSOCIATES 75 S. Charles Street, Suite 403 Baltimore, MD 21201 667.309.6036	AUDIO VISUAL & TELECOM CONVERGENT TECHNOLOGIES DESIGN GROUP 6501 York Road Baltimore, MD 21212 410.532.2395
SECURITY THORNTON TOMASETTI 1330 Connecticut Ave, NW, Suite 300 Washington, DC 20036 202.580.6300	FOOD SERVICE COLBURN GUYETTE 100 Ledgewood Place, Suite 104 Rockland, MA, 02370 781.826.5522
BUILDING ENCLOSURE MPSON GUMPERTZ & HEGER 1625 Eye St NW Suite 900 Washington, DC 20006 202.239.4199	LEED SUSTAINABLE DESIGN CONSULTING 1432 K Street NW, 3rd Floor Washington, DC 20005 202.667.1620
WIND & AIR QUALITY RWDI 650 Woodland Rd. W. Guelph, Ontario Canada N1K 1B8 519.823.1311	VIBRATION & ACOUSTICS COLIN GORDON ASSOCIATES 1350 Old Bayshore Hwy, Suite 799 Burlingame, CA 94010 415.570.0350
LIGHTING FISHER MARANTZ STONE 22 West 19th Street, 6th Floor New York, NY 10011 212.691.3020	SITE LIGHTING TILLETT LIGHTING DESIGN ASSOCIATES 11 Hanover Square, 17th Floor New York, NY 10005 212.766.0144
EMI/RFI (SHEILDING) TATECH ELECTROMAGNETICS 115 Juliad Ct., Suite 105 Fredericksburg, VA 22406 540.286.1984	CAMPUS UTILITIES AEI AFFILIATED ENGINEERS 200 International Circle, Suite 5888 Hunt Valley, MD 21030

LIFE SCIENCES BUILDING

600 N Broadway
Baltimore, MD 21205

Baltimore, Maryland 21207

	Date:	OCTOBER 24, 2025
	Scale:	1/8" = 1'-0"
Drawn By:		
Designed By:		
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Cadd File:		
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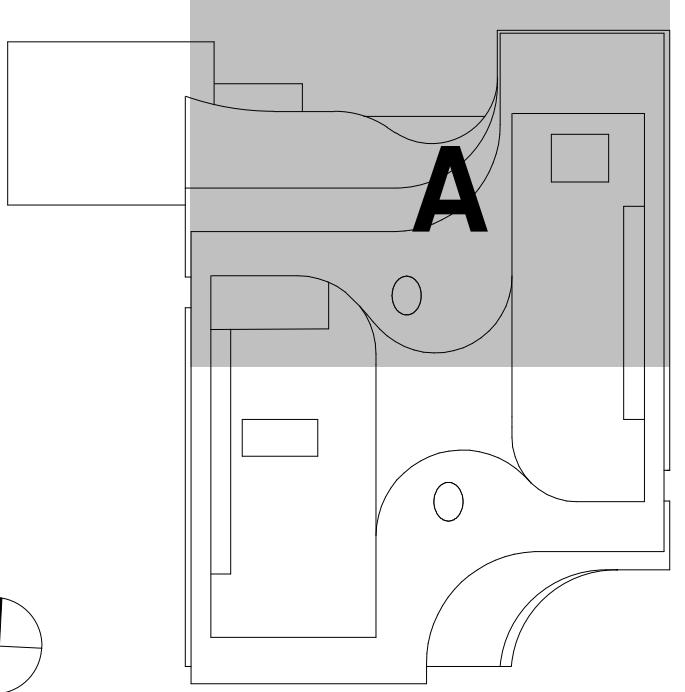
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OLIN
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W. Guelph, Ontario
Canada N1K 1B8
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COLIN GORDON ASSOCIATES
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Burlingame, CA 94010
415.570.0350

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New York, NY 10011
212.691.3020

SITE LIGHTING
TILLETT LIGHTING DESIGN
ASSOCIATES
11 Hanover Square, 17th Floor
New York, NY 10005
212.766.0144

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CAMPUS UTILITIES
AEI AFFILIATED ENGINEERS
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Hunt Valley, MD 21030

410.229.0090

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600 N Broadway
Baltimore, MD 21205

JOHNS HOPKINS
U N I V E R S I T Y

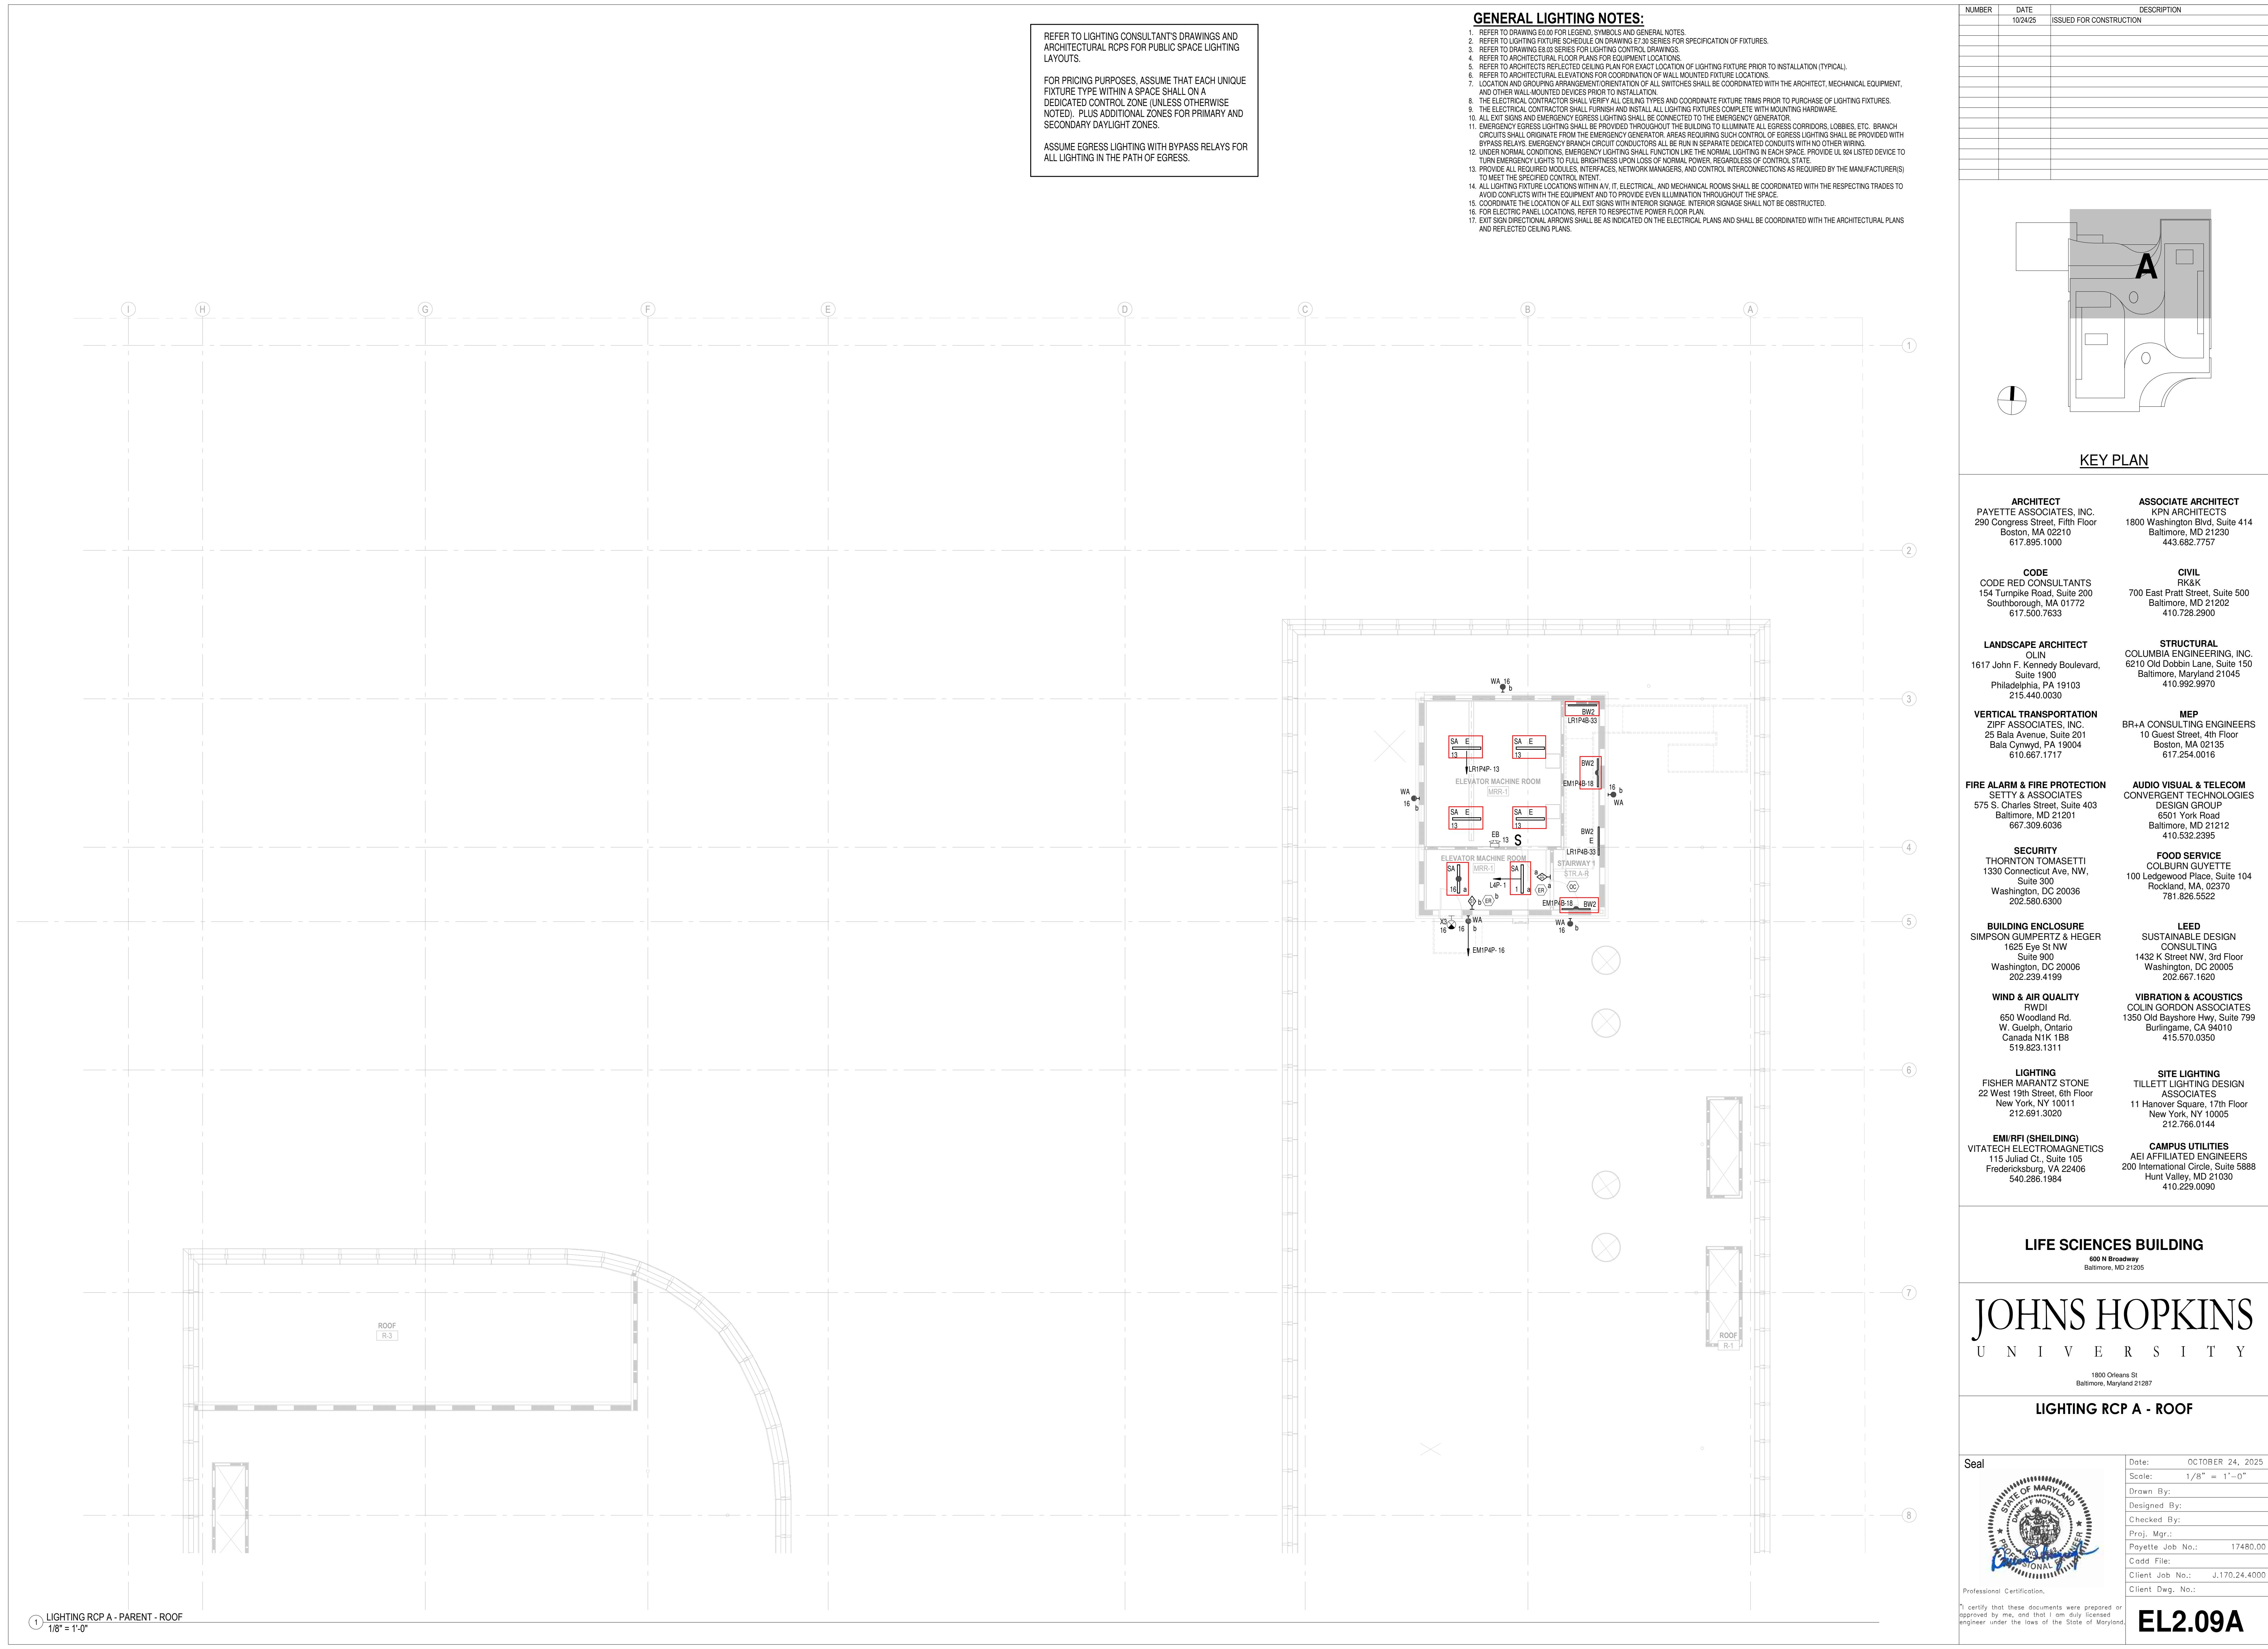
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	Cadd File:	
	Client Job No.:	J.170.24.4000
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EL2.08A

1 LIGHTING RCP A - PARENT - LEVEL 8
1/2" - 1/2"

$$\odot \quad 1/8" = 1'-0"$$



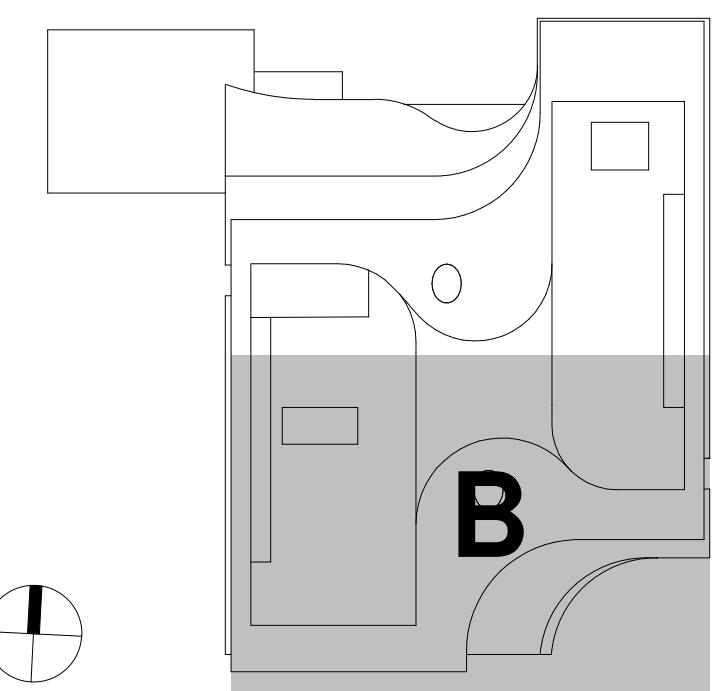
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LIGHTING

SITE LIGHTING

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*300 N Broadway,
Baltimore, MD 21205*

JOHNS HOPKINS

U N I V E R S I T Y

1800 Orleans St

LIGHTING RCP B - ROOF

Seal | Date: OCTOBER 24, 2025

	Scale:	1/8" = 1'-0"
	Drawn By:	Designed By:

Checked By: _____
Proj. Mgr.: _____
Payette Job No.: 17480.00

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£22.00 D

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