



Existing Front Elevation

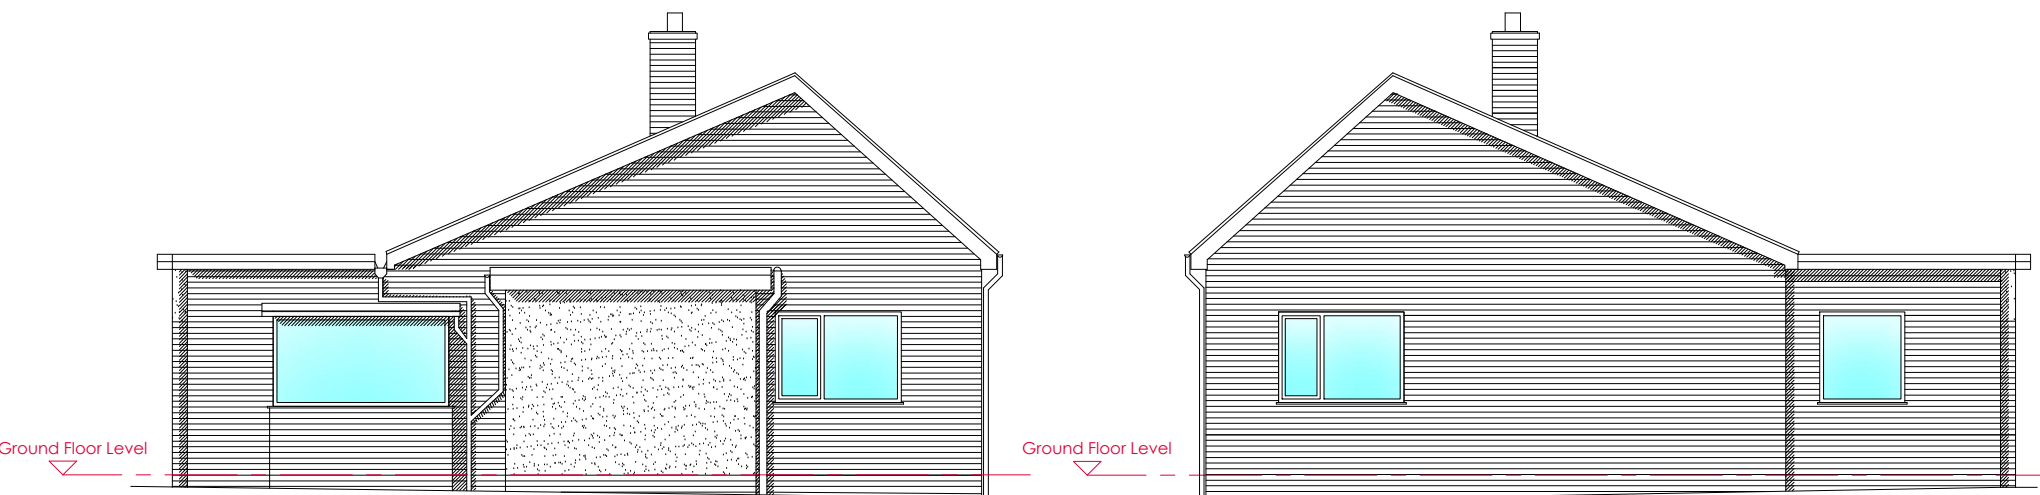

Existing Side Elevation

Existing Side Elevation

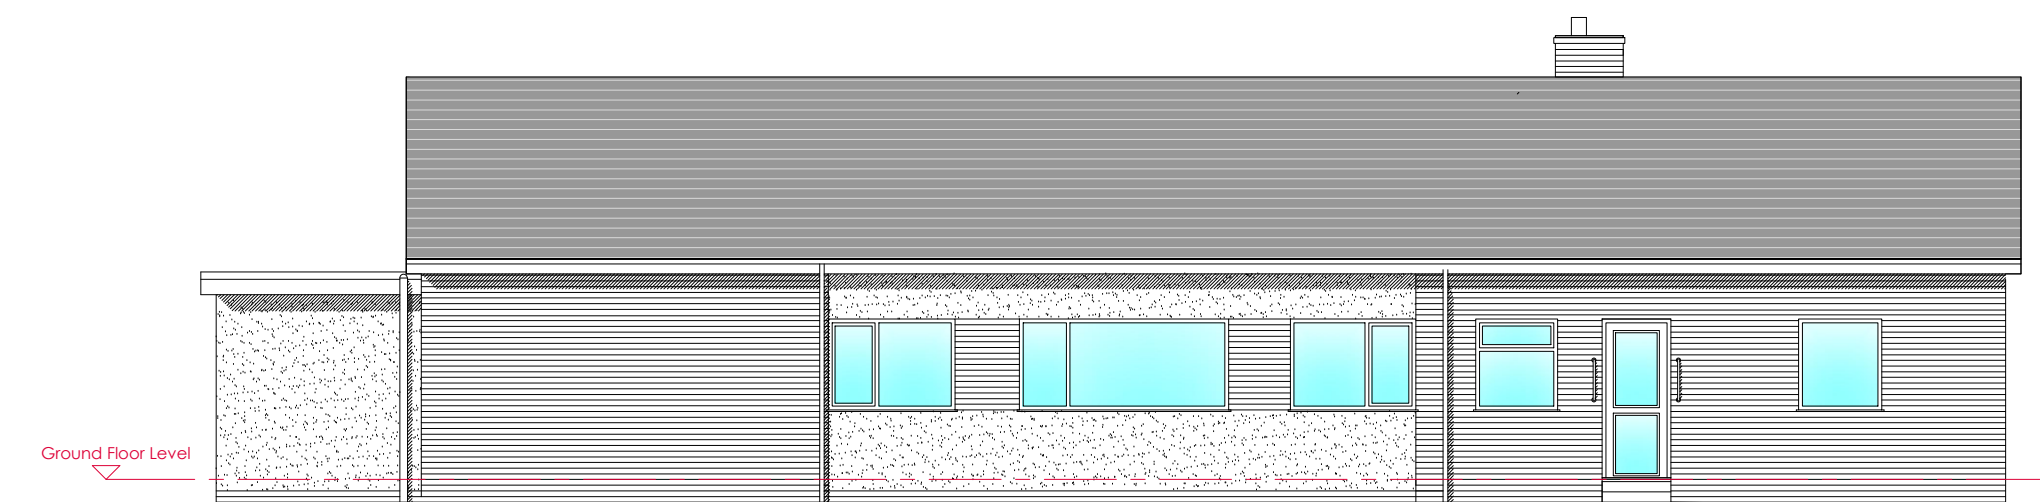

Existing Rear Elevation

- NOTES:
- DO NOT SCALE FROM THIS DRAWING.
1. This drawing is copyright of Wardman Brown.
  2. All dimensions to be verified on site prior to any shop or site works being commenced.
  3. Any discrepancies to be reported to the Designer BEFORE any work is put in hand.
  4. This drawing must be read in conjunction with relevant consultants and specialists drawings.
  5. This drawing must be read in conjunction with the drawings specified.

- HAZARDS:
- CDM2015
1. Live services adjacent/on site.
  2. Excavations - Ground Collapse
  3. Handling major components
  4. Working at height - Falling
  5. Machinery & Equipment
  6. Ensure all blockwork has a minimum crushing strength of 3.5N/mm<sup>2</sup>
  7. The weight of each block must not exceed 20Kg

REV	DATE	DETAILS

REVISIONS:



Wardman Brown

113 Stanhope Road South  
Darlington, DL3 7SF  
Tel: 01325 460227  
info@wardmanbrown.com  
www.wardmanbrown.com



Chartered Institute of  
Architectural Technicians  
Registered Practice

CLIENT:  
Mr & Mrs Ferguson

PROJECT:  
Long Ridge, Seamer

DRAWING TITLE:  
Existing Elevations - Bungalow

PURPOSE OF ISSUE:  
**PLANNING DRAWING**

SCALE: 1:100 @ A3

DATE: JUNE 2017 DRAWN: JMC DRG REVISION:

DRAWING NO: L017004 - 003 -