
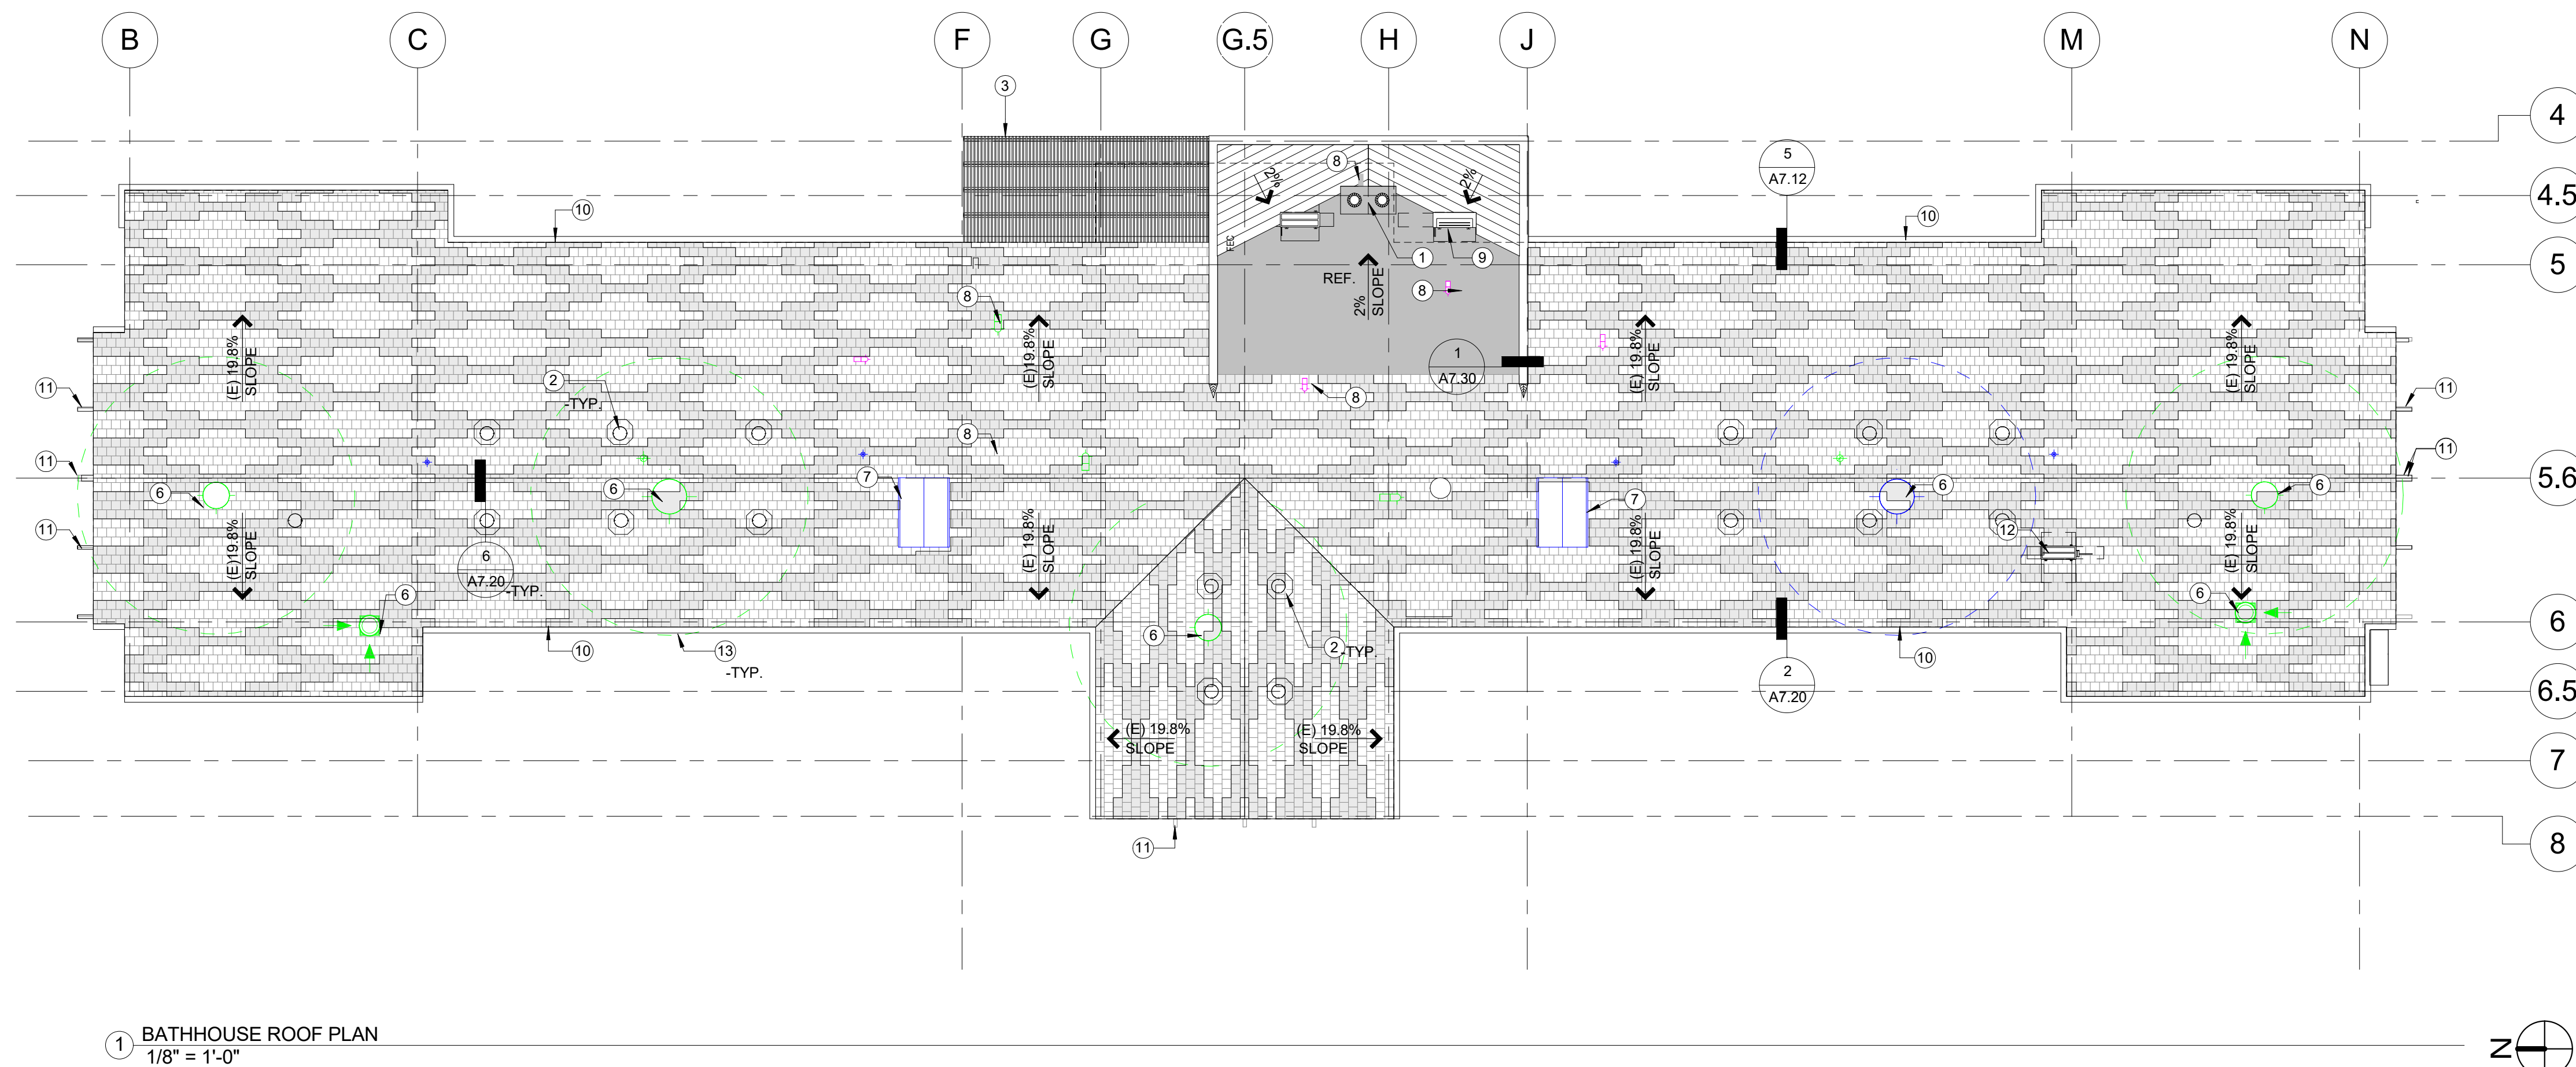


REVISION DATES
(DESIGN STAGE ONLY)

REVISION DATES
(DESIGN STAGE ONLY)

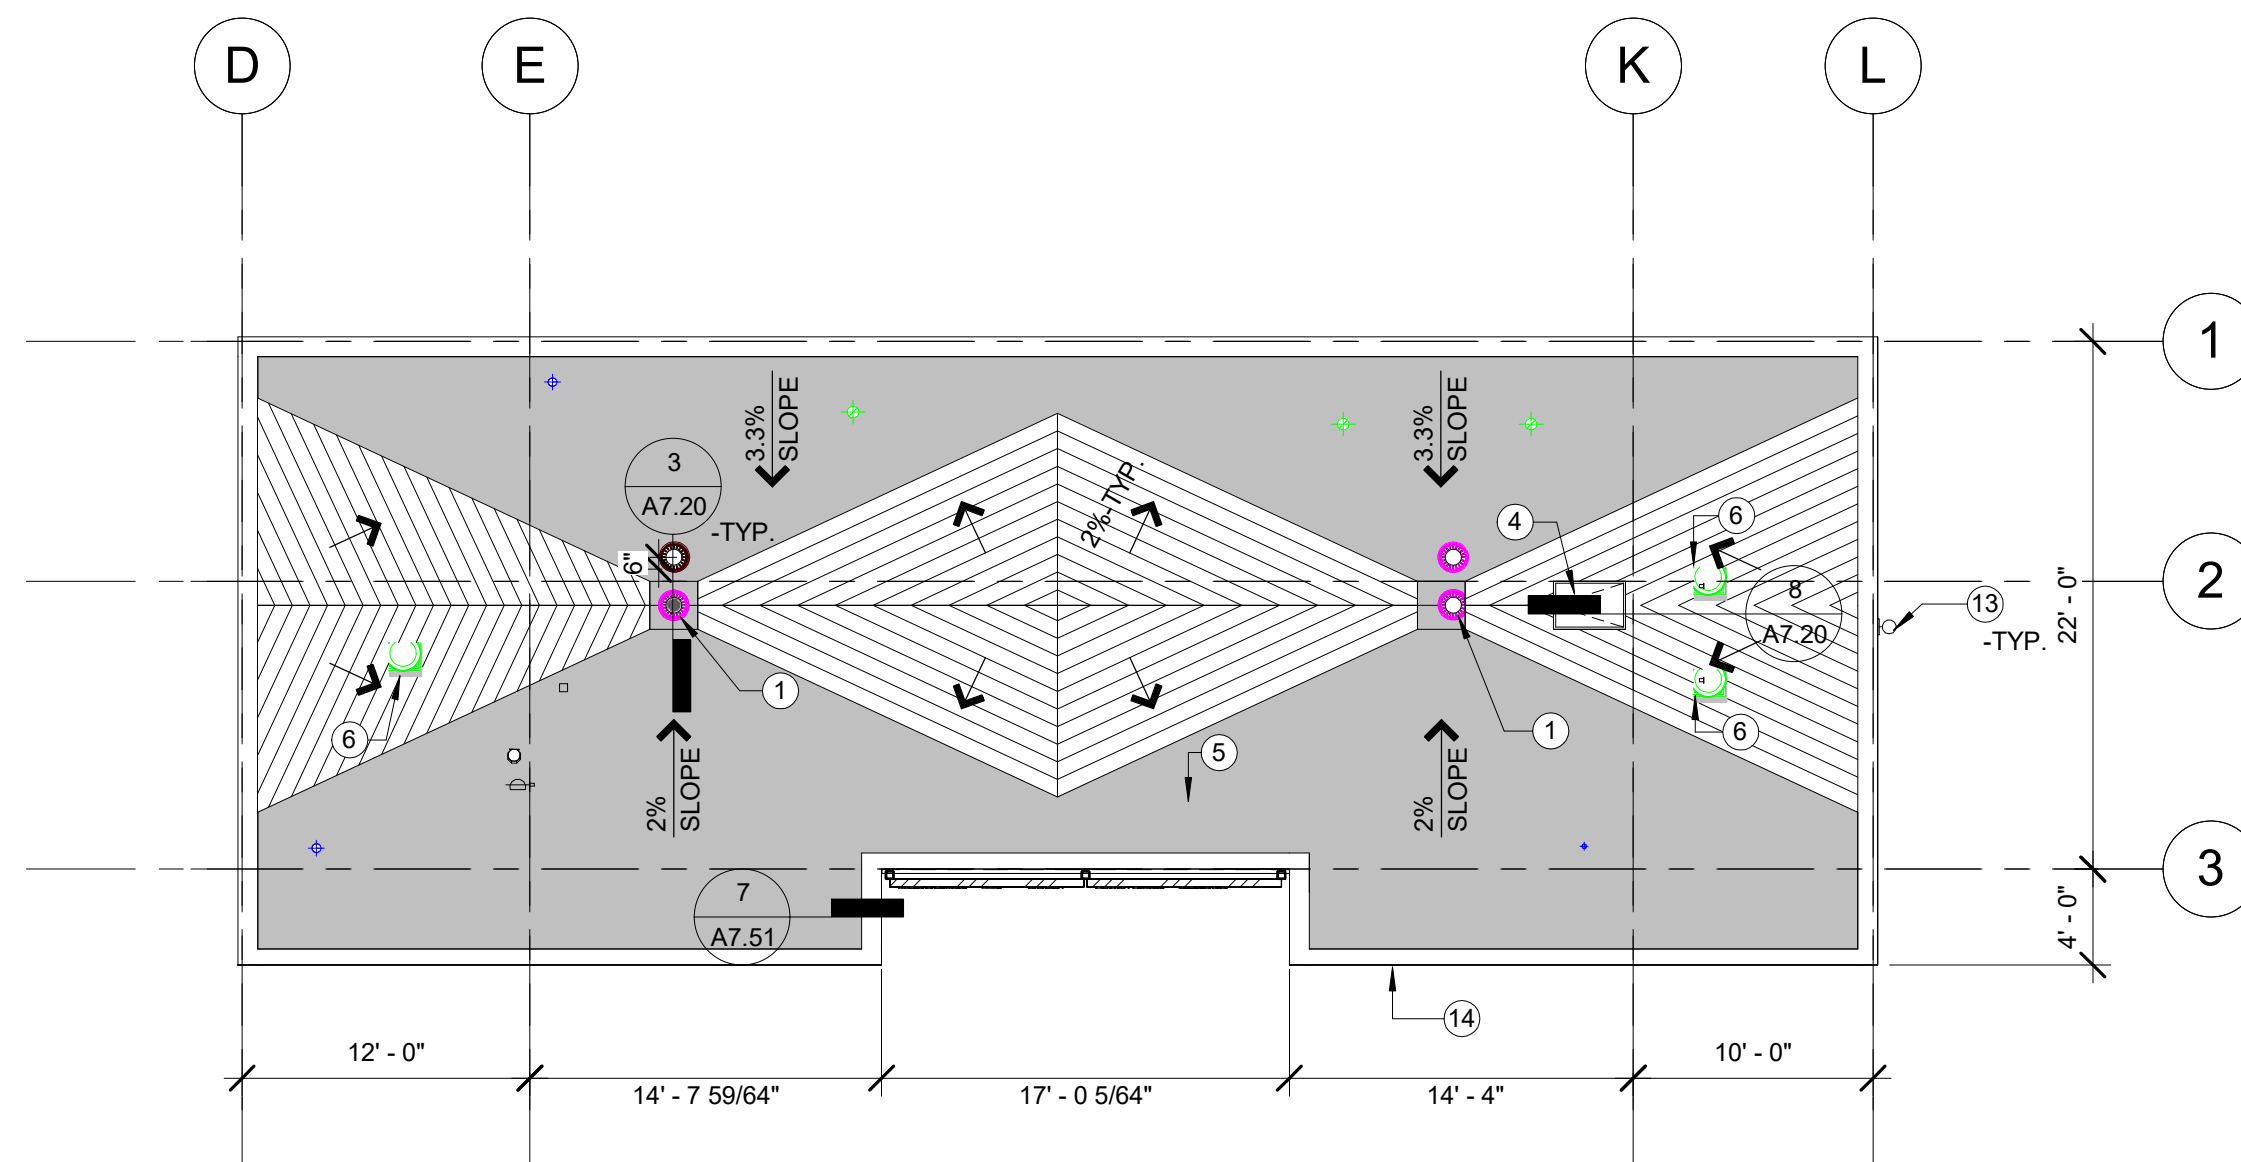

1 BATHHOUSE ROOF PLAN
1/8" = 1'-0"


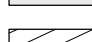
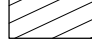

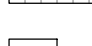



2 POOL EQUIP BLDG ROOF PLAN
1/8" = 1'-0"

GENERAL NOTES


1. ROOF TYPES ARE AS FOLLOWS:
 - ROOF TYPE 1: SINGLE-PLY SYSTEM "CLASS-A" TPO UL-790
 - ROOF TYPE 2: ASPHALT SHINGLE SYSTEM "CLASS-A" ASTM E1081UL 790
2. ALL SINGLE-PLY ROOFING TO SLOPE 1/4" VERTICAL PER 1'-0" HORIZONTAL
3. ALL SLOPES UNLESS NOTED OTHERWISE
4. TOP OF INSULATION HEIGHTS, HIGH POINTS AND LOW POINT, ARE INDICATED AS THE TOP OF ROOF SURFACE ABOVE ROOF DRAIN(S).
5. REFER TO SHEET A7.20 FOR TYPICAL ROOF DETAILS.
6. ALL ROOF TOP MECHANICAL, ELECTRICAL, AND/OR PLUMBING EQUIPMENT SHOWN FOR INFORMATION ONLY. REFERENCE MECHANICAL, ELECTRICAL, AND PLUMBING DOCUMENTS FOR SPECIFICATIONS FOR SPECIFIC DESIGN INFORMATION. REFERENCE ROOF DETAILS FOR ROOF PENETRATIONS DETAILS AND OTHER SYSTEMS INFORMATION.
7. PROVIDE WALKWAY PROTECTION TO MAJOR MECHANICAL, ELECTRICAL AND PLUMBING EQUIPMENT AS REQUIRED TO PROVIDE SERVICE ACCESS. WALKWAY PROTECTION UNITS IS LOCATED ON GENERAL LAYOUT AND MAY NOT SHOW ALL PLUMBING LOCATIONS OF ALL EQUIPMENT.
8. FOR PIPING PENETRATION THROUGH RATED WALLS SEE DETAIL 10/A7.50.
9. S.P.D. FOR VENT THRU ROOF PIPING INFORMATION.
10. ALL NEW ROOF TO BE CLASS A.
11. UNIT SKYLIGHTS SHALL BE LABELED BY AN LA CITY APPROVED LABELING AGENCY. (THIS INFORMATION SHALL STATE THE APPROVED LABELING AGENCY NAME, PRODUCT DESIGNATION AND PERFORMANCE GRADE RATING (RESEARCH REPORT NOT REQUIRED) 2405.5

GRAPHIC LEGEND

- | | |
|---|--|
|  | INDICATES ROOF AREA WHERE SLOPE IS ACHIEVED BY
TAPERED INSULATION |
|  | INDICATES CRICKET AREA (HATCH PERPENDICULAR
TO SLOPE DIRECTION) 2% MIN. SLOPE |
|  | (N) ASPHALT SHINGLE ROOF ON (N) PLYWOOD ROOF
DECK |
|  | ROOF DRAIN (WITH OVERFLOW DRAIN) |
|  | SLOPE DIRECTION ARROW |
|  | WALKWAY PROTECTION |


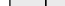
KEYNOTE LEGEND

- 1 (N) ROOF DRAIN AND OVERFLOW SYSTEM.
- 2 (N) SKYLIGHT, TYP.
- 3 (N) STEEL SHADE STRUCTURE. PAINT PER SCHEDULE.
- 4 (N) ROOF HATCH PERMANENT FIXED ACCESS LADDER.
- 5 (N) THERMOPLASTIC TPO WALKWAY PAD.
- 6 (N) ROOF EXHAUST FAN. S.M.D. FOR MORE INFO.
- 7 (N) MAKE-UP AIR INTAKE ROOF VENTILATOR. S.M.D. FOR MORE INFO.
- 8 (N) 4" DIAMETER GOOSENECK OUTSIDE AIR INTAKE. S.M.D. FOR MORE INFO.
- 9 (N) SPLIT USYSTEM OUTDOOR HEAT PUMP UNIT. S.M.D. FOR MORE INFO.
- 10 (N) MTL. GUTTER.
- 11 (E) BEAM TO BE REPAIRED AND OR PARTIALLY REPLACED. SEE WOOD FRAMING
INSPECTION REPORT INCLUDED IN SPECS FOR MORE INFO.
- 12 (N) CONDENSING UNIT. S.M.D. FOR MORE INFO.
- 13 (N) LIGHT FIXTURE. S.E.D.
- 14 (N) MECHANICAL BUILDING ROOF OVERHANG. SEE WALL SECTION A6.10 SHEET
FOR MORE INFO.

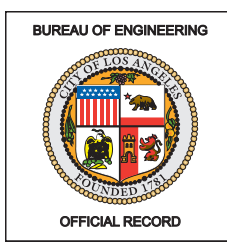

ROOFING NOTES

1. (N) ASPHALT SHINGLES TO ALTERNATE COLOR IN A DIAMOND PATTERN USING COLORS SIMILAR TO ONES PROVIDED BY OWENS CORNING.
2. G.C. TO PROVIDE SAMPLES FOR APPROVAL.
3. ASPHALT SHINGLES TO COMPLY WITH U.L. CLASS 'A' RATING.
4. SEE FIN. LEGEND FOR MORE INFO.

- | | |
|---|--------------------------------------|
|  | RF-01 "SAND CASTLE" OR APPROVED EQ. |
|  | RF-02 "SHASTA WHITE" OR APPROVED EQ. |

CITY OF LOS ANGELES

BID SET
PROJECT ISSUE DATE: 06/22/21

VERTICAL CONTROL:		HORIZONTAL CONTROL:	
SHEET TITLE: ROOF PLANS		PROJECT: GRANADA HILLS POOL AND BATHHOUSE REPLACEMENT PROJECT	
ADDRESS: 16730 CHATSWORTH STREET GRANADA HILLS, CA 91344		ADDRESS: 16730 CHATSWORTH STREET GRANADA HILLS, CA 91344	
WORK ORDER NO. #E170517		WORK ORDER NO. #E170517	
PLAN FILE NO. #308		PLAN FILE NO. #308	
DRAWING NO. A2.11		DRAWING NO. A2.11	
SHEET 0		SHEETS 20	
GARY LEE MOORE, PE, ENV SP		CITY ENGINEER	
ARCHITECTURAL DIVISION		DATE: 03/03/20	
ARCHITECT/ENGINEER: JOHN SPARANO LIC. NO.: C-26244		03/03/20	
DESIGNED BY: SPARANO + MOONEY ARCHITECTURE		03/03/20	
DRAWN BY: JORGE BELTRAN		03/03/20	
CHECKED BY: LUDWIG JUAREZ		03/03/20	
APPROVED BY:		03/03/20	
INDEX NO. RP-300118		BUILDING NO. -	
REVISION DESCRIPTION		DATE	
NO.		BY	
ENGINEERING CITY OF LOS ANGELES		ENGINEERING CITY OF LOS ANGELES	

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