



TTLB TEMPLATE REVISION DATE: 02/2013
FILE PATH: BM 360/Granada Hills Pool Renovation/A Granada-Hills_2017.rvt
SHEET ISSUE DATE: 01/25/18

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REVISION DATES
(DESIGN STAGE ONLY)

2 SLAB & CURB CONTROL PLAN
MECHANICAL BLDG.
1/4" = 1'-0"

1 SLAB AND CURB CONTROL PLAN
1/8" = 1'-0"

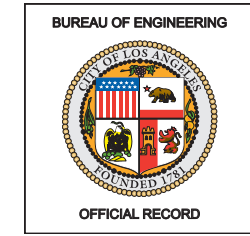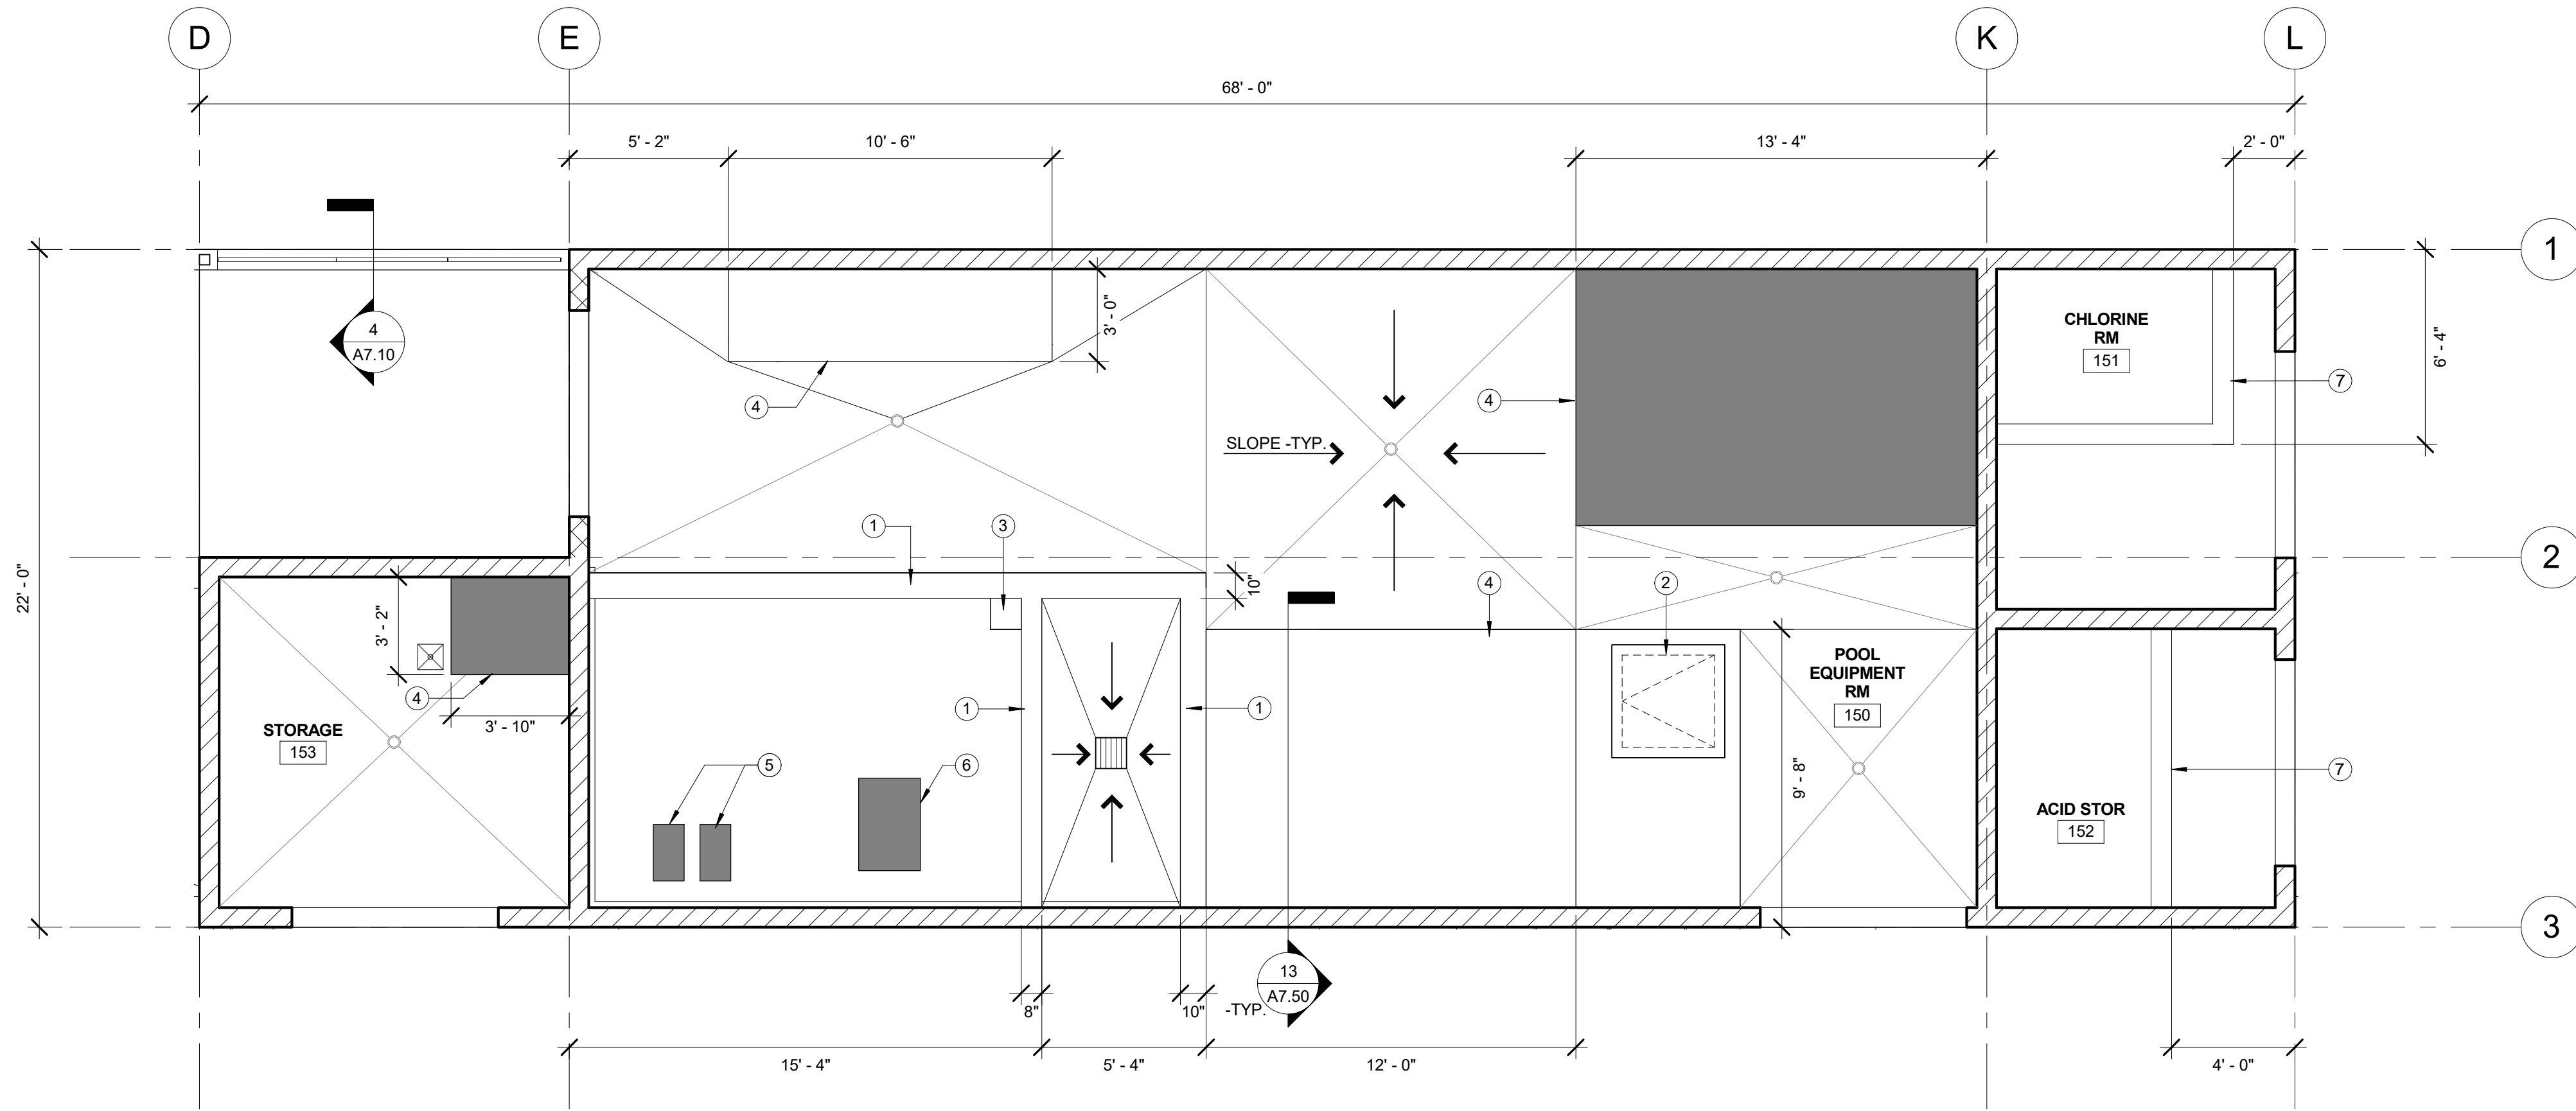

GENERAL NOTES

1. ALL DIMENSIONS TO BE VERIFIED IN FIELD.
2. SEE SHEET A7.00 FOR WALL TYPE INFO.
3. S.S.D. FOR ADDITIONAL NEW WALL INFO.
4. ALL NEW INTERIOR CONCRETE SLABS TO BE SEALED AND RECEIVE NEW COLOR TREATMENT U.N.O. FINISH TO BE MEDIUM BROOM FINISH. CONTRACTOR TO PROVIDE MOCK-UPS OF MEDIUM AND HEAVY FINISH
5. ALL FLOOR SLOPES TO DRAIN TO BE MINIMUM 1% SLOPE AND NOT TO EXCEED 2% IN ANY DIRECTION-TYP.
6. ALL CABINETS TO BE SOLID PHENOLIC WITH STAINLESS STEEL HARDWARE.
7. FOR PIPING PENETRATION THROUGH RATED WALLS SEE DETAILXXXX
8. ALL WALLS INSIDE CHEMICAL ROOMS TO RECEIVE EPOXY SEALER FLOOR TO CEILING.
9. S.A.Q.D. FOR ADDITIONAL MECHANICAL BUILDING INFO.

GRAPHIC LEGEND

- (E) STUD WALL TO REMAIN
- (E) MASONRY WALL TO REMAIN
- (N) CONC CURB/EQUIP PAD
- (N) WALL ABOVE CURB SHOWN DASHED
- (N) SLAB RECESS
- (N) FLOOR DRAIN, S.P.D.
- (N) AREA FLOOR DRAIN, S.A.Q.D. AND S.P.D.
- 1% MIN. TO 2% MAX. SLOPE-TYP.

KEYNOTE LEGEND

- 1 (N) PIT CONCRETE CURB. S.A.Q.D. AND S.S.D. FOR MORE INFO
- 2 (N) SURGE CHAMBER ACCES HATCH. S.A.Q.D. FOR MORE INFO.
- 3 (N) 12"x12"x12"D SUMP PIT. S.S.D. AND S.A.Q.D. FOR MORE INFO. VERIFY LOCATION IN FIELD.
- 4 (N) 6" CONC. EQUIPMENT PAD. S.S.D. AND S.A.Q.D. FOR MORE INFO.
- 5 (N) 22"x12"x16"H CONC. EQUIPMENT PAD. S.S.D. AND S.A.Q.D. FOR MORE INFO. VERIFY LOCATION IN FIELD.
- 6 (N) 38"x24"x16"H CONC. EQUIPMENT PAD. S.S.D. AND S.A.Q.D. FOR MORE INFO. VERIFY LOCATION IN FIELD.
- 7 (N) 8" THK. CONC. CONTAINMENT WALL W/ EPOXY PAINT SEALER FIN., S.A.Q.D.

CONCRETE CURB SCHEDULE

FLOOR PLAN TAG	CURB WIDTH	MIN. CURB HEIGHT
W4	4"	6"
W5	5"	6"
W7	7"	6"
W8	8"	6"

CURB TYPE GENERAL NOTES

1. CURBS ARE TAGGED ON SLAB & CURB FLOOR PLANS. REFER TO FLOOR PLANS FOR CURB TYPE IDENTIFICATION.
2. CURB TYPE TAGS ARE USED TO IDENTIFY CONTIGUOUS PARTITION SEGMENTS. IF A CONTIGUOUS CURB SEGMENT IS TAGGED WITH MORE THAN ONE TAG, G.C. TO IDENTIFY TRANSITION POINT AND SUBMIT FOR APPROVAL.
3. PARTITION TAGS USE A TWO-PART, ALPHA-NUMERIC DESIGNATION: THE FIRST CHARACTER IS A LETTER INDICATING THE CURB TYPE, THE SECOND CHARACTER IS A NUMBER INDICATING THE WIDTH OF THE CURB.
4. REFERENCE STRUCTURAL DRAWINGS FOR ADDITIONAL INFORMATION FOR CURB REINFORCEMENT AND SLAB CONNECTION.
5. COORDINATE CURB WITH PLUMBING FIXTURE CARRIERS AND SUPPORTS PRIOR TO CONSTRUCTION

ENGINEERING

CITY OF LOS ANGELES

NO.

DATE

REVISION DESCRIPTION

BUILDING NO.

INDEX NO.

RP-300118

LICENSED ARCHITECT

JOHN P. SPARANO

STATE OF CALIFORNIA

EXP. 1-30-21

CITY ENGINEER

GARY LEE MOORE, PE, ENV SP

ARCHITECTURAL DIVISION

DATE: 03/03/20

03/03/20

03/03/20

03/03/20

03/03/20

03/03/20

DESIGNED BY: SPARANO • MOONEY ARCHITECTURE

DRAWN BY: JORGE BELTRAN

CHECKED BY: LUDWING JUAREZ

APPROVED BY:

CITY OF LOS ANGELES

DEPARTMENT OF PUBLIC WORKS

BUREAU OF ENGINEERING

VERTICAL CONTROL:

HORIZONTAL CONTROL:

SHEET TITLE: SLAB AND CURB CONTROL PLAN

PROJECT: GRANADA HILLS POOL AND BATHHOUSE REPLACEMENT PROJECT

ADDRESS: 16730 CHATSWORTH STREET GRANADA HILLS, CA 91344

BID SET

PROJECT ISSUE DATE: 06/22/21

WORK ORDER NO. #E170517

PLAN FILE NO. #308

DRAWING NO. A2.16

SHEET 0 F SHEETS

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