


1

THRUST BLOCK DETAILS

SCALE: NOT TO SCALE

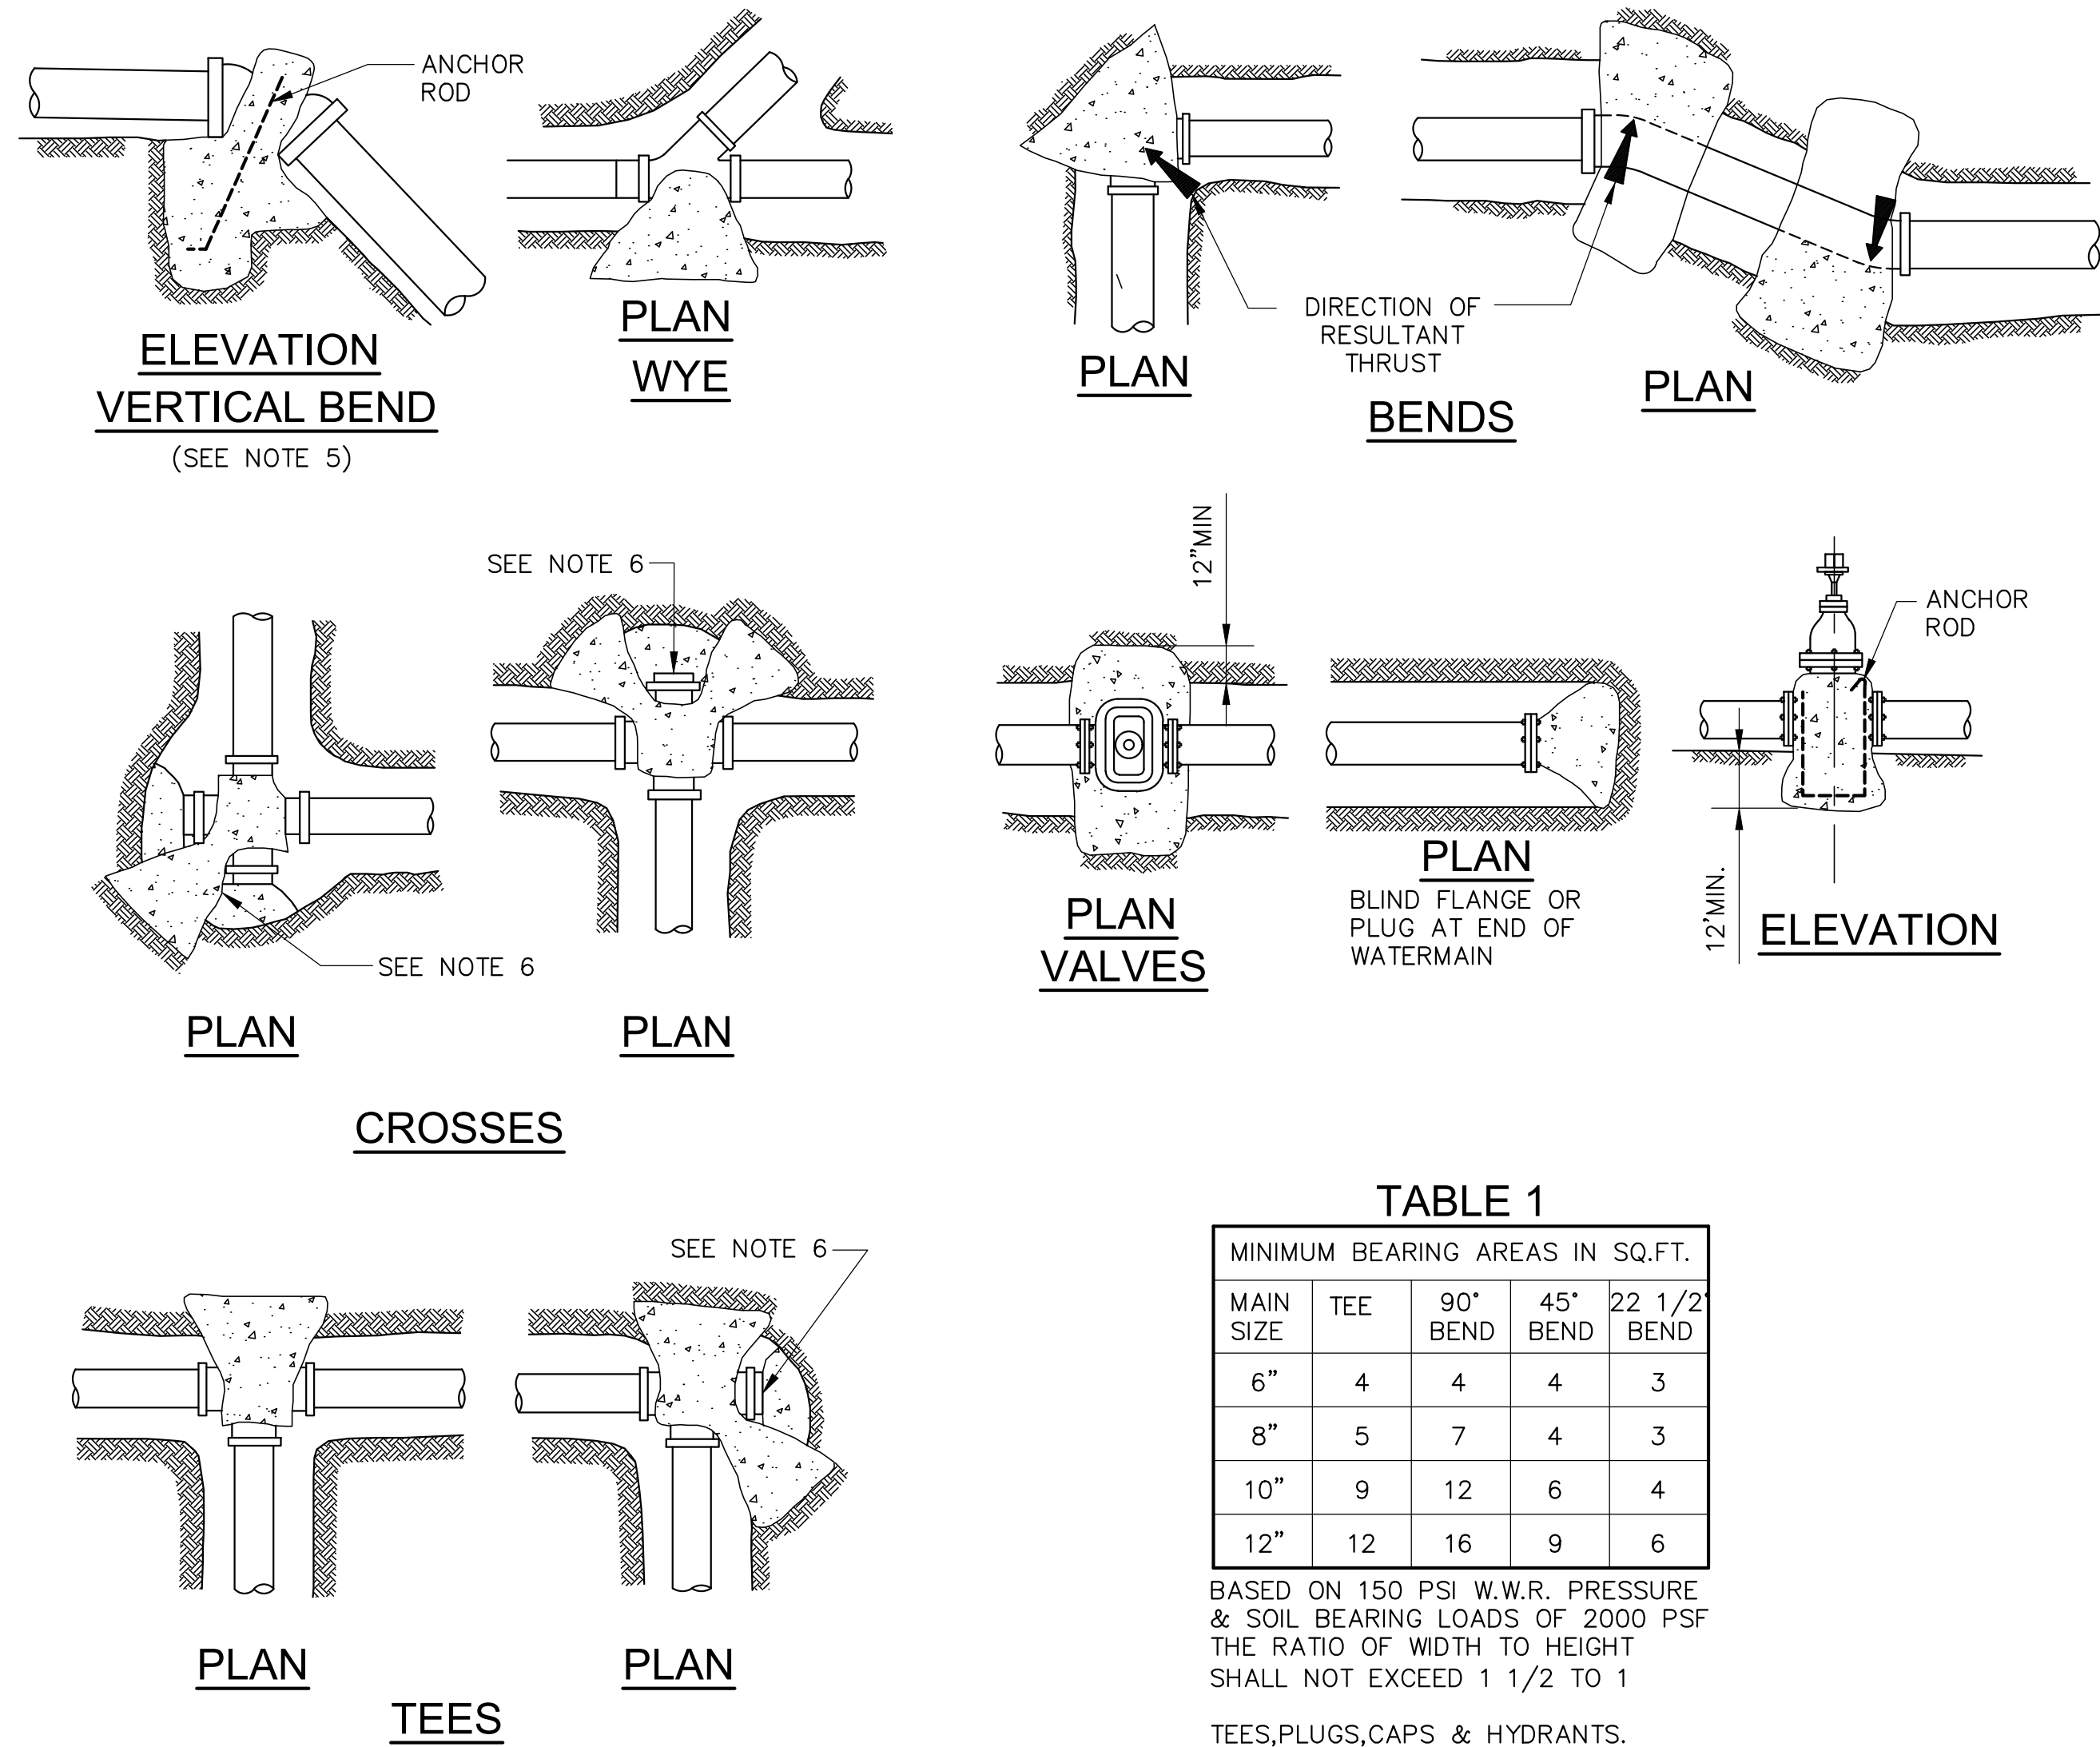

NOTES:

- ALL ANCHOR AND THRUST BLOCKS SHALL BEAR AGAINST UNDISTURBED SOIL.
- MINIMUM ALLOWABLE WATER PRESSURE FOR DESIGN OF THRUST BLOCKS IS 150 PSI. BEARING AREA INCREASE IN PRESSURE.
- ALL CONCRETE USED IN THRUST BLOCKS SHALL ATTAIN 2000 PSI STRENGTH.
- ALL ANCHOR RODS SHALL BE REINFORCING STEEL AND A MINIMUM OF 1/2-INCH IN DIAMETER.
- USE ANCHOR BLOCKS AT VERTICAL BENDS WHEN PIPE IS ABOVE OR BELOW GROUND. SIZE OF BLOCK AND ROD SHALL BE AS SHOWN ON THE PLANS OR AS DETERMINED BY THE ENGINEER IN THE FIELD.
- USE 30 POUND FELT TO INSURE COLD JOINT.
- CONCRETE SHALL NOT COME INTO DIRECT WITH ASBESTOS CEMENT PIPE.
- FOR PIPE 14" IN DIAMETER OR LARGER ENGINEER IS TO SUBMIT CALCULATIONS.



3

ASPHALT PAVEMENT DETAIL

SCALE: NOT TO SCALE

NOTES:

- FOR PAVEMENT TRANSITION DETAILS REFER TO DETAIL 4 ON SHEET C-5.00.
- FOR PAVEMENT THICKNESS REFER TO SITE PLAN OR MATCH THICKNESS OF EXISTING PAVEMENT.

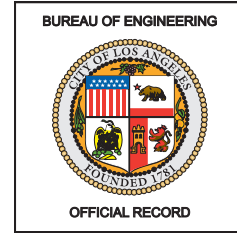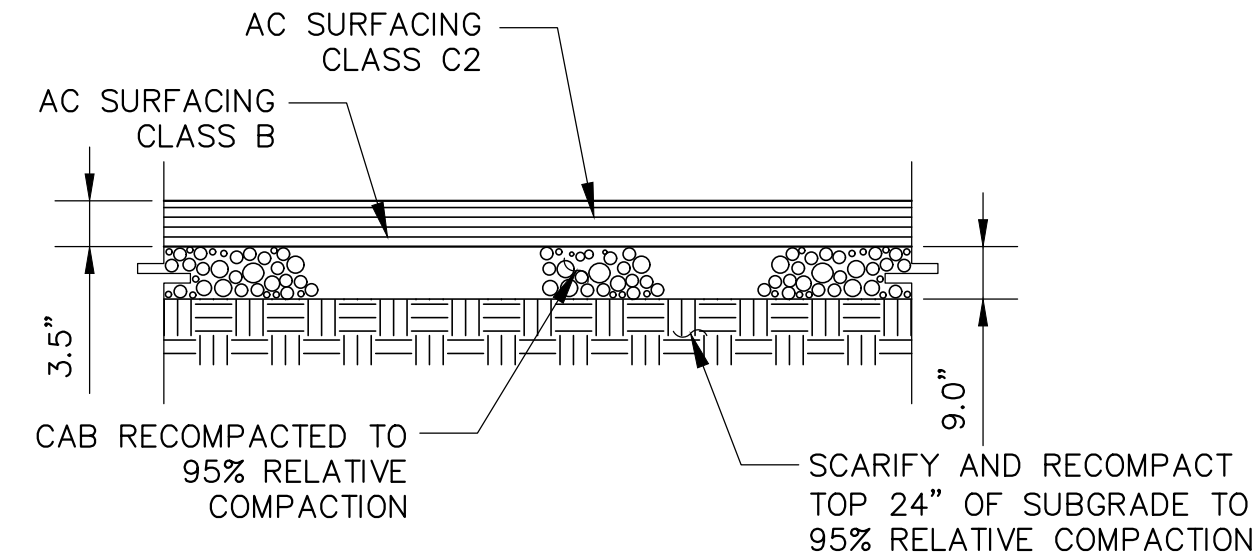


NOTES:

- FOR STORM DRAINAGE CLEAN OUT COVER, PROVIDE COVER WITH INSCRIPTION "D" TO DENOTE STORM DRAINAGE.
- FOR SANITARY SEWER CLEAN OUT COVER, PROVIDE COVER WITH INSCRIPTION "S" TO DENOTE SANITARY SEWER.

2

CLEANOUT DETAIL

SCALE: NOT TO SCALE

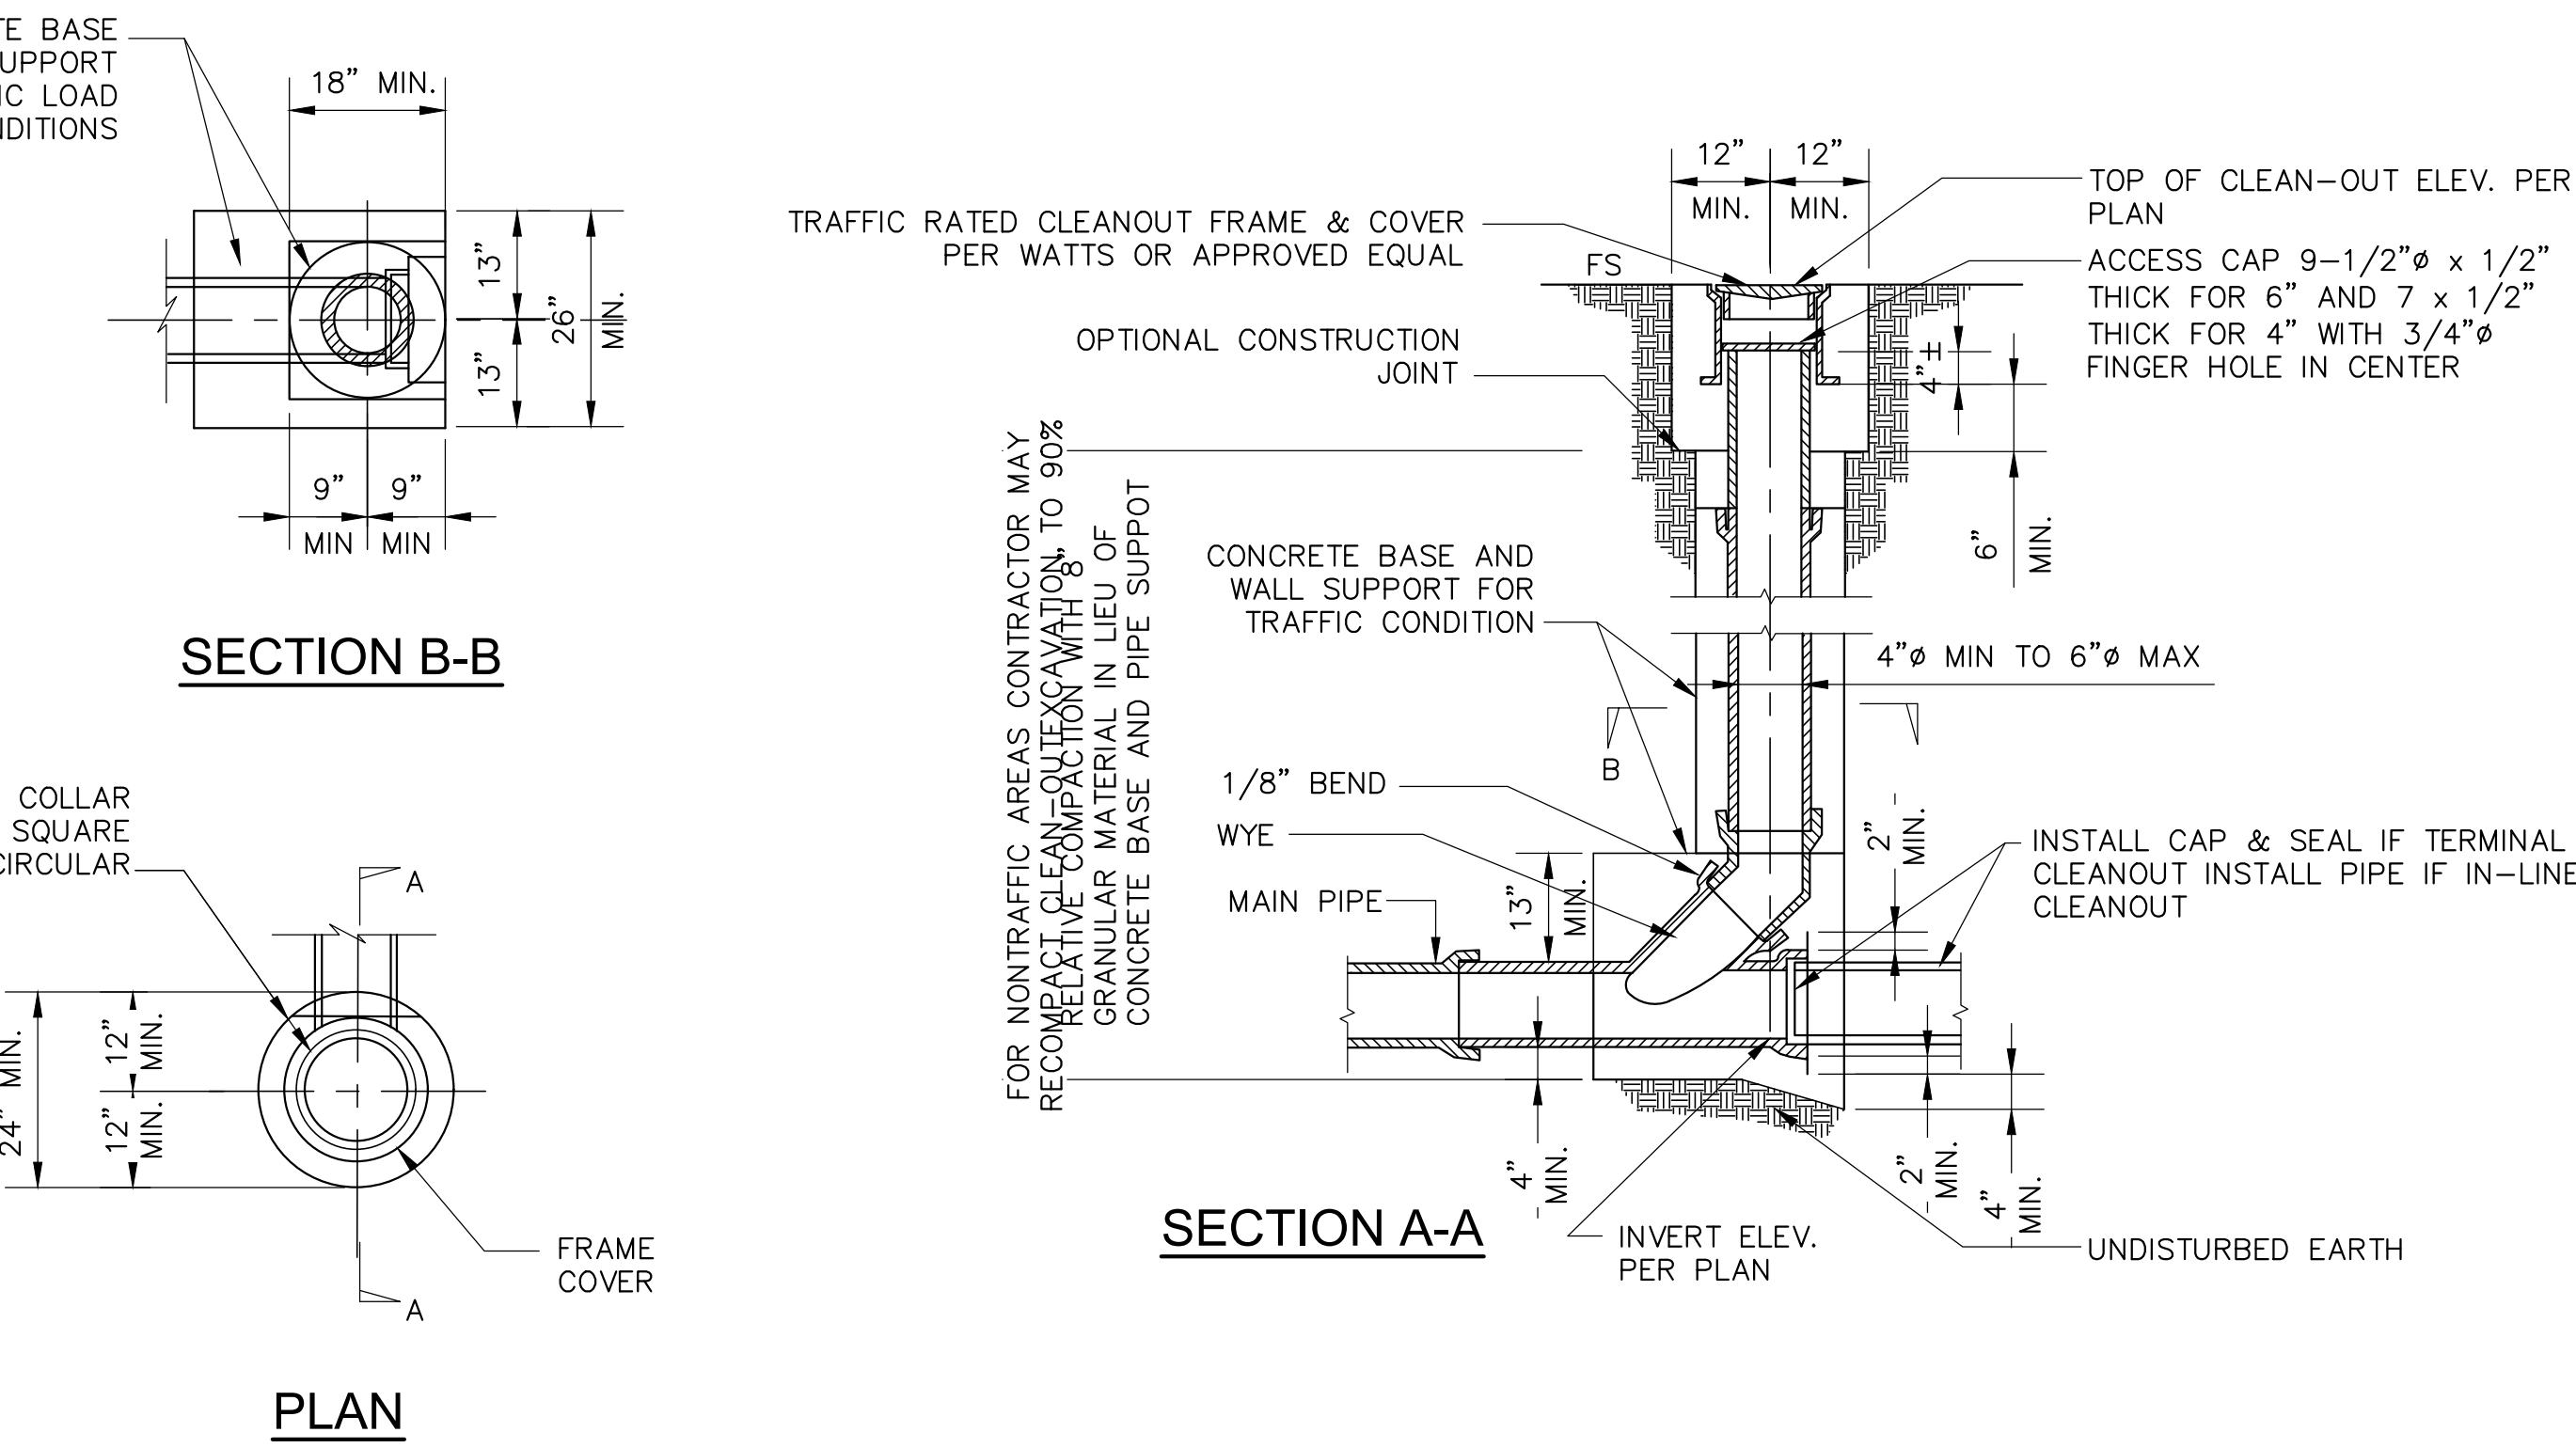

BID SET
PROJECT ISSUE DATE: 06/22/21

CITY OF LOS ANGELES

VERTICAL CONTROL:
HORIZONTAL CONTROL:

SHEET TITLE: MISCELLANEOUS DETAILS
PROJECT: GRANADA HILLS POOL AND BATHHOUSE REPLACEMENT PROJECT
ADDRESS: 16730 CHATSWORTH STREET
GRANADA HILLS, CA 91344

WORK ORDER NO.
#E170517
PLAN FILE NO.
#308
DRAWING NO.


SHEET 12 OF 19
C501

PLOTTED: 09/18/2019 1:00:00 PM

DEPARTMENT OF PUBLIC WORKS

GARY LEE MOORE, PE, ENV SP

CITY ENGINEER
ARCHITECTURAL DIVISION
ARCHITECT/ENGINEER: VIRGILIO AOANAN LIC NO.: C36079
DESIGNED BY: VIRGILIO AOANAN
DRAWN BY: AUTUMN WAGGONER
CHECKED BY: VIRGILIO AOANAN
APPROVED BY: VIRGILIO AOANAN

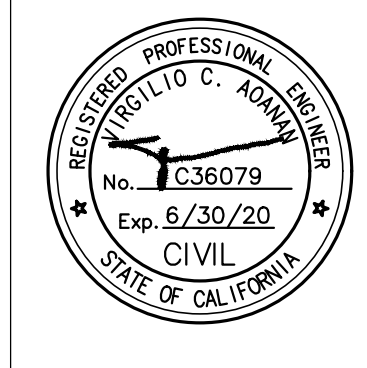

BUREAU OF ENGINEERING

ENGINEERING
CITY OF LOS ANGELES

NO. DATE BY
REVISION DESCRIPTION
BUILDING NO.
INDEX NO.
RP-300118