



OAKS

20

101

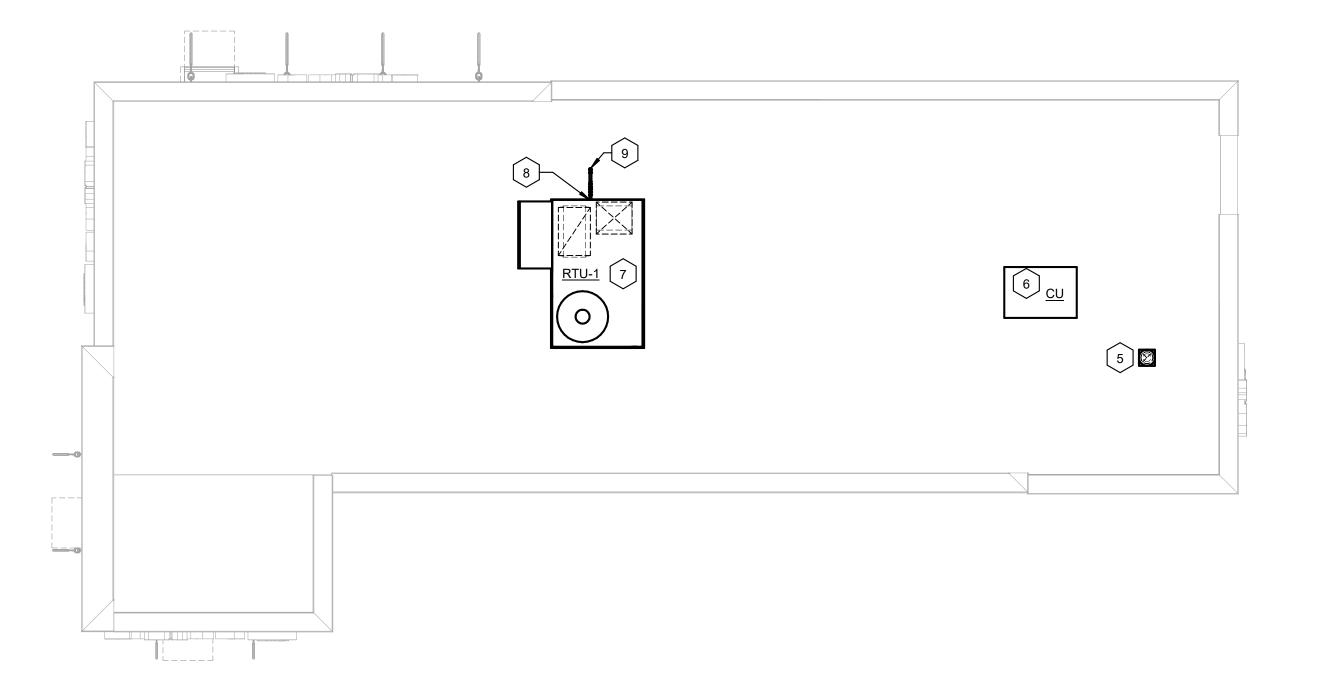

2 MECHANICAL ROOF PLAN

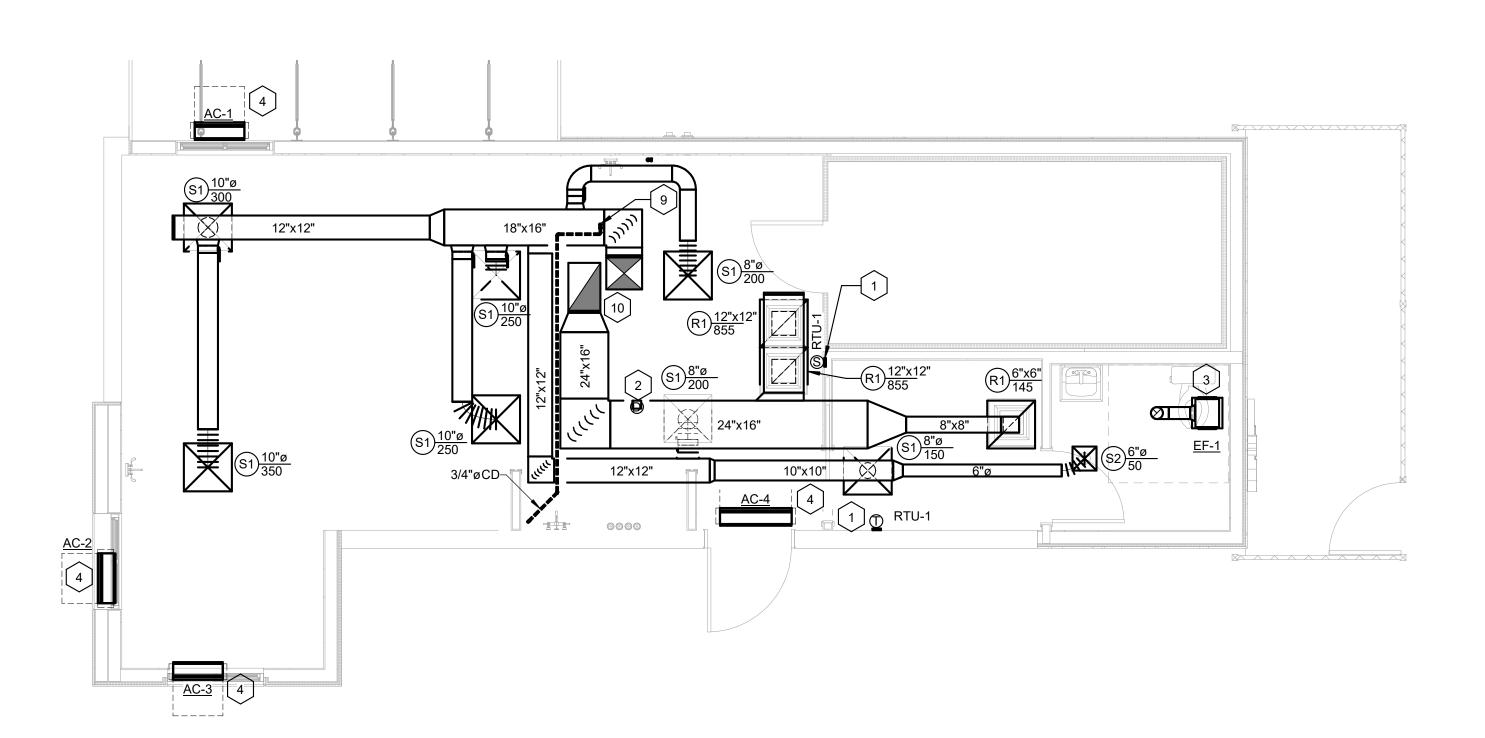

1 MECHANICAL FLOOR PLAN


M103 1/4" = 1'-0"

NOTES BY SYMBOL

- ON PLAN. MOUNT THERMOSTAT AT 48" A.F.F. AND SENSOR AT 60" A.F.F. VERIFY LOCATION WITH ARCHITECT PRIOR TO ROUGH-IN. NOTIFY EOR IF LOCATION IS CHANGED PRIOR TO INSTALL.
- 3 PROVIDE NEW EXHAUST FAN PER SCHEDULE ON SHEET M102. SUSPEND FROM STRUCTURE. EXTEND EXHAUST DUCT UP THROUGH ROOF AND TERMINATE WITH GRAVITY VENT WITH BIRD SCREEN. ENSURE MINIMUM 10'-0" FROM ALL FRESH AIR INTAKES.
- 4 PROVIDE AND INSTALL NEW AIR CURTAIN PER MANUFACTURER'S RECOMMENDATIONS. PROVIDE ALL REQUIRED ACCESSORIES FOR MOUNTING. COORDINATE EXACT LOCATION AND HEIGHT IN FIELD WITH OTHER TRADES.
- 5 EXHAUST DUCT THROUGH ROOF. PROVIDE WEATHERPROOF CAP AND BIRD
- 6 CONDENSING UNIT FOR WALK-IN COOLER SHOWN FOR REFERENCE ONLY. COMPLETE SYSTEM TO BE PROVIDED AND INSTALLED BY OWNER'S DESIGNATED CONTRACTOR.
- 7 PROVIDE AND INSTALL ROOFTOP UNIT AT LOCATION SHOWN PER SCHEDULE ON SHEET M102. LOCATION IS APPROXIMATE. VERIFY EXACT LOCATION WITH
- ROUTING.
- 10 SUPPLY AND RETURN DUCTS UP TO RTU. TRANSITION TO FULL SIZE DUCT OPENING AT UNIT AS REQUIRED. ALL CONDITIONS AND CLEARANCES MUST BE VERIFIED IN FIELD PRIOR TO FABRICATING ANY DUCTWORK.

- 1 PROVIDE NEW THERMOSTAT AND REMOTE TEMPERATURE SENSOR AS INDICATED
- 2 PROVIDE 120V SMOKE DETECTOR IN RETURN AIR DUCT FOR AUTOMATIC SHUTDOWN OF UNIT.
- MAINTAIN MANUFACTURER'S RECOMMENDED SERVICE CLEARANCES.
- SCREEN. MAINTAIN MINIMUM 10'-0" FROM FRESH AIR INTAKES.
- STRUCTURAL DRAWINGS.
- 8 3/4-INCH CONDENSATE CONNECTION TO RTU. REFER TO DETAIL 1/M104 FOR ADDITIONAL INFORMATION.
- 9 CONDENSATE PIPE DOWN THROUGH ROOF TO MOP SINK. DISCHARGE CONDENSATE AT MOP SINK VIA AIR GAP. SEE MECHANICAL FLOOR PLAN FOR

FT. WORTH, TX 76102 817.820.0433

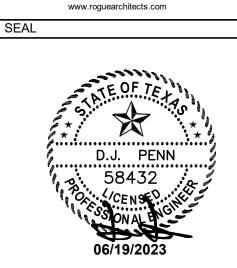

PERMIT SET: 6//192023

CONTRACTOR SHALL VERIFY ALL CONDITIONS AND DIMENSIONS AT THE JOB SITE AND NOTIFY THE ARCHITECT OF ANY DIMENSIONAL ERRORS, OMISSIONS OR DISCREPANCIES BEFORE

BEGINNING OR FABRICATING ANY WORK.
DO NOT SCALE DRAWINGS. ISSUE DATE DESCRIPTION

PROJECT INFORMATION PROJECT NO: 22-0444 ORIGINAL ISSUE: 09/06/2022 AS NOTED SCALE: DRAWN BY:

SHEET TITLE

CHECKED BY:

MECHANICAL FLOOR **PLANS**

SHEET NUMBER

M103

1301 Solana Blvd. Bldg. 1, Suite 1420

Westlake, TX 76262

TEXAS REGISTERED

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