

Window
Replacement
'92


NORTH WARD ELEMENTARY SCHOOL

WINDOW REPLACEMENT

900 N. FT. HARRISON CLEARWATER, FL.



VICINITY MAP

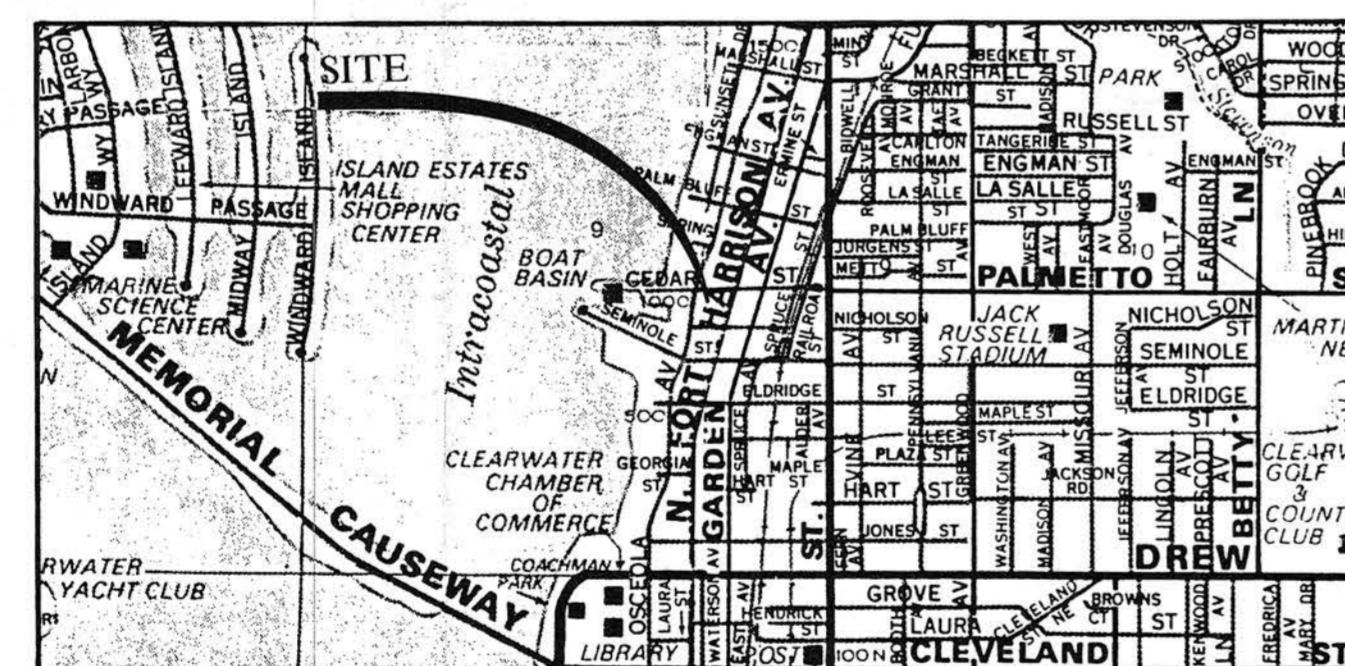


SCHOOL BOARD

Chairman	Lee Benjamin
Vice Chairman	Corinne Freeman
	Lucile O. Casey
	Barbara J. Crockett
	Linda S. Lerner
	John Sanguineti
	Ron Walker
Superintendent	J. Howard Hinesley, Ed. D.

DRAWING INDEX

- | | |
|----------|--|
| A1 | BUILDING 1A PLAN, ELEVATIONS, DETAILS |
| A2 | BUILDING 1B PLAN, ELEVATIONS, DETAILS |
| A3 | BUILDING 1B DETAILS |
| A4 | BUILDING 1C PLAN, ELEVATIONS, DETAILS |
| A5 | BUILDINGS 2 & 4 PLANS, ELEVATIONS, DETAILS |



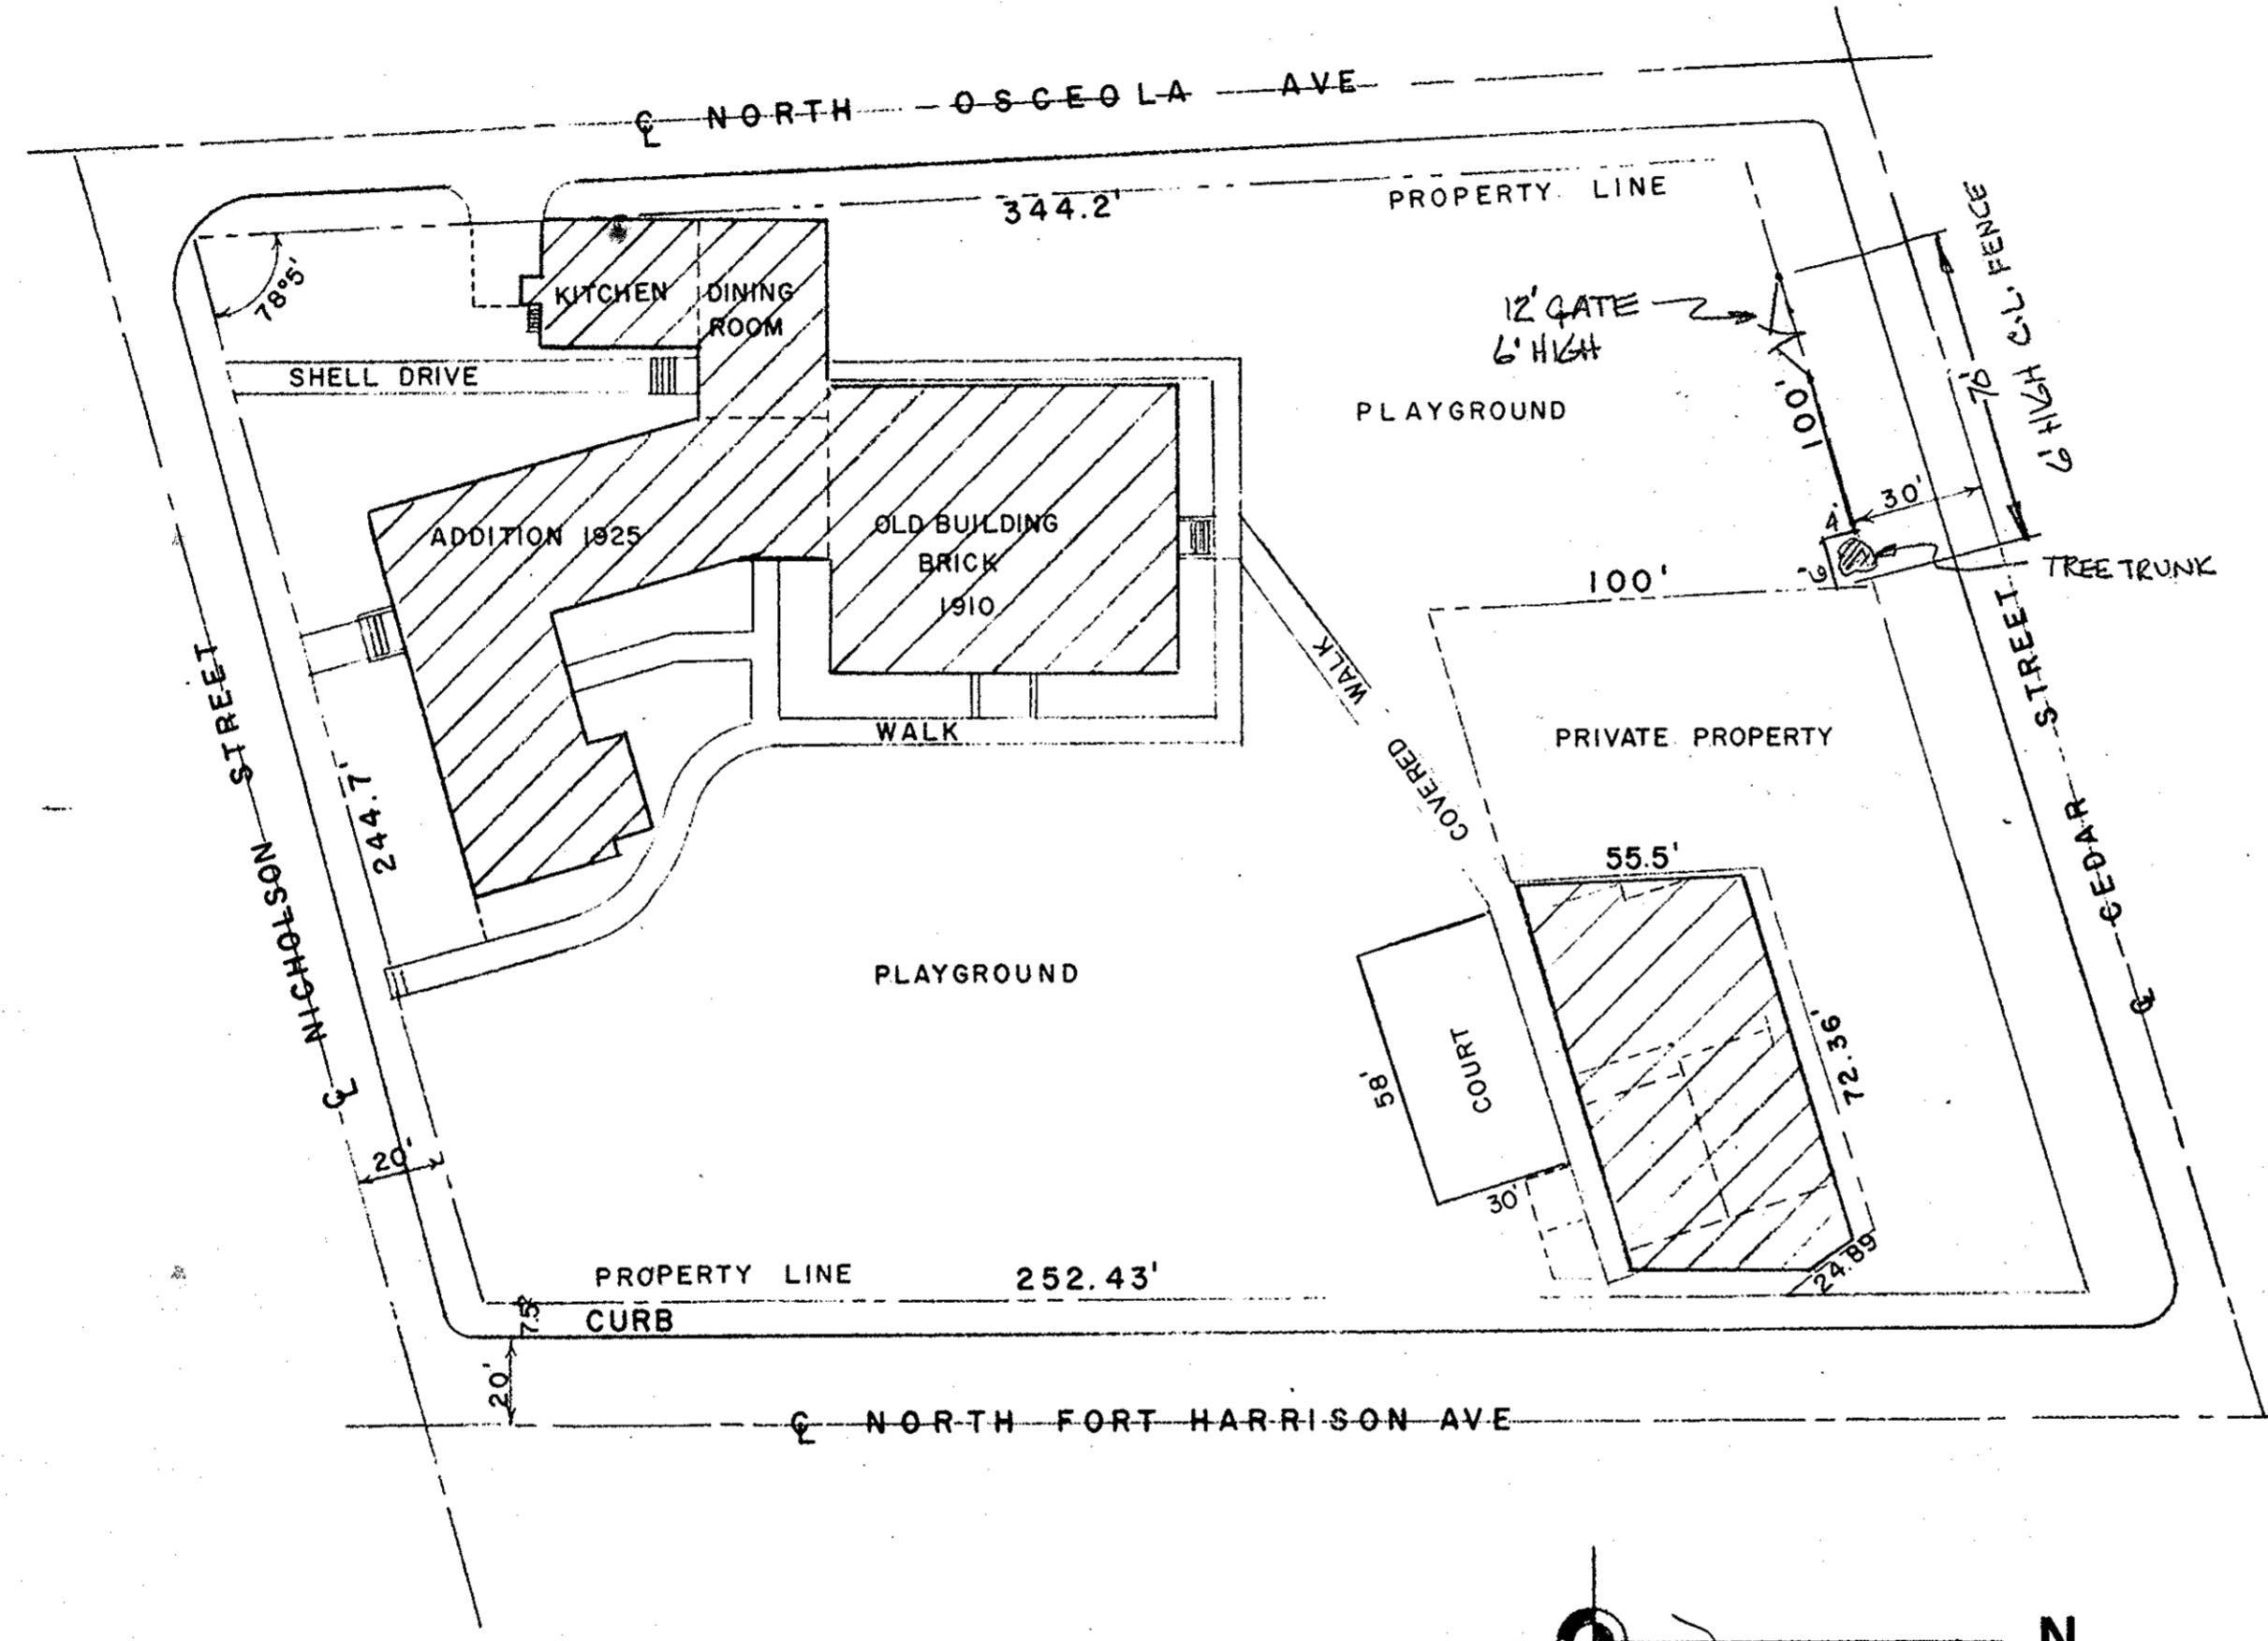

LEGAL

PURCHASE - JULY 11, 1945
BEGIN AT S.W. CORNER OF THE INTER-
SECTION OF CEDAR ST. AND NORTH OSCEOLA
AVE, IN THE TOWN OF CLEARWATER, PINELLAS
COUNTY, FLA. RUN THENCE EASTERLY ALONG
THE S. LINE OF CEDAR ST., 100FT. AND
SOUTHERLY ON A LINE PARRALLEL TO SAID
NORTH OSCEOLA AVE. 100FT., THENCE WESTERLY
AND LINE PARRALLEL TO SAID CEDAR ST.
100FT, THENCE NORTHERLY ALONG THE E. LINE
OF OSCEOLA AVE. 100FT. TO P.O.B.

PURCHASE - OCTOBER 27, 1913

LOT 2, 3, 4, 5, 6, 7, AND 8 IN BLOCK 1, AND ALSO
LOTS 2 AND 3 IN BLOCK 2 ALL OF THE SAID LAND
AND BEING IN J.A. GORRA'S SUB OF THE TOWN
OF CLEARWATER, FLA. ACCORDING TO THE MAP
OR PLAT OF SAID LAND OR SUBDIVISION AS
RECORDED IN THE OFFICE OF THE CLERK OF THE
CIRCUIT COURT IN AND FOR PINELLAS COUNTY,
FLORIDA, IN PLAT BOOK I, AT PAGE 44.

PURCHASE - JUNE 5, 1915


LOTS 2, 3, 4, 5, 6, 7, AND 8 OF BLOCK 1, OF J.A.
GORRA'S SUB IN THE CITY OF CLEARWATER,
FLA. ACCORDING TO A MAP OR PLAT THEREOF
RECORDED IN PLAT BOOK I, AT PAGE 44 OF
THE PUBLIC RECORDS OF PINELLAS COUNTY,
FLA.

PURCHASE - MAY 28, 1919

LOT 1 OF BLOCK 1 OF J.C. GORRA'S SUB OF
THE CITY OF CLEARWATER, FLA., ACCORDING
TO THE MAP OF SAID SUB AS RECORDED IN THE
OFFICE OF THE CIRCUIT COURT OF PINELLAS
COUNTY IN PLAT BOOK I PAGE 44.

PURCHASE - JANUARY 25, 1956

BEGIN AT THE S.W. CORNER OF THE INTERSECTION
OF FT. HARRISON AVE AND CEDAR ST. IN THE
CITY OF CLEARWATER, FLA AS THIS INTERSEC-
TION EXISTED ON THE DATE OF AUGUST 22, 1919,
RUN THENCE SOUTH 15° 52' WEST ALONG THE
WESTERLY LINE OF FT. HARRISON AVE 44.5 FT
FOR P.O.B. THENCE S 15° 52' W 55.5 FT, THENCE
WEST PARALLEL TO THE SOUTH LINE OF CEDAR
STREET 95 FT THENCE N. 15° 52' E 55.5 FT, THENCE
EAST PARALLEL TO THE SOUTH LINE OF CEDAR
STREET 95 FT TO P.O.B. BEING A PART OF GOVER-
MENT LOTS 2 AND 3, IN SECTION 9, TOWNSHIP 29 S,
RANGE 15 E.

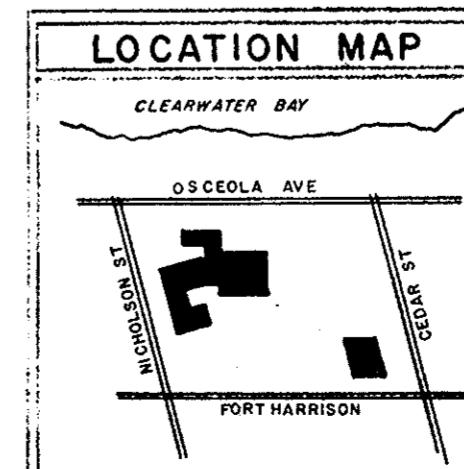


BOARD OF PUBLIC INSTRUCTION

NORTH WARD ELEMENTARY
CLEARWATER

PLOT PLAN DATE

SCALE 1" = 40'

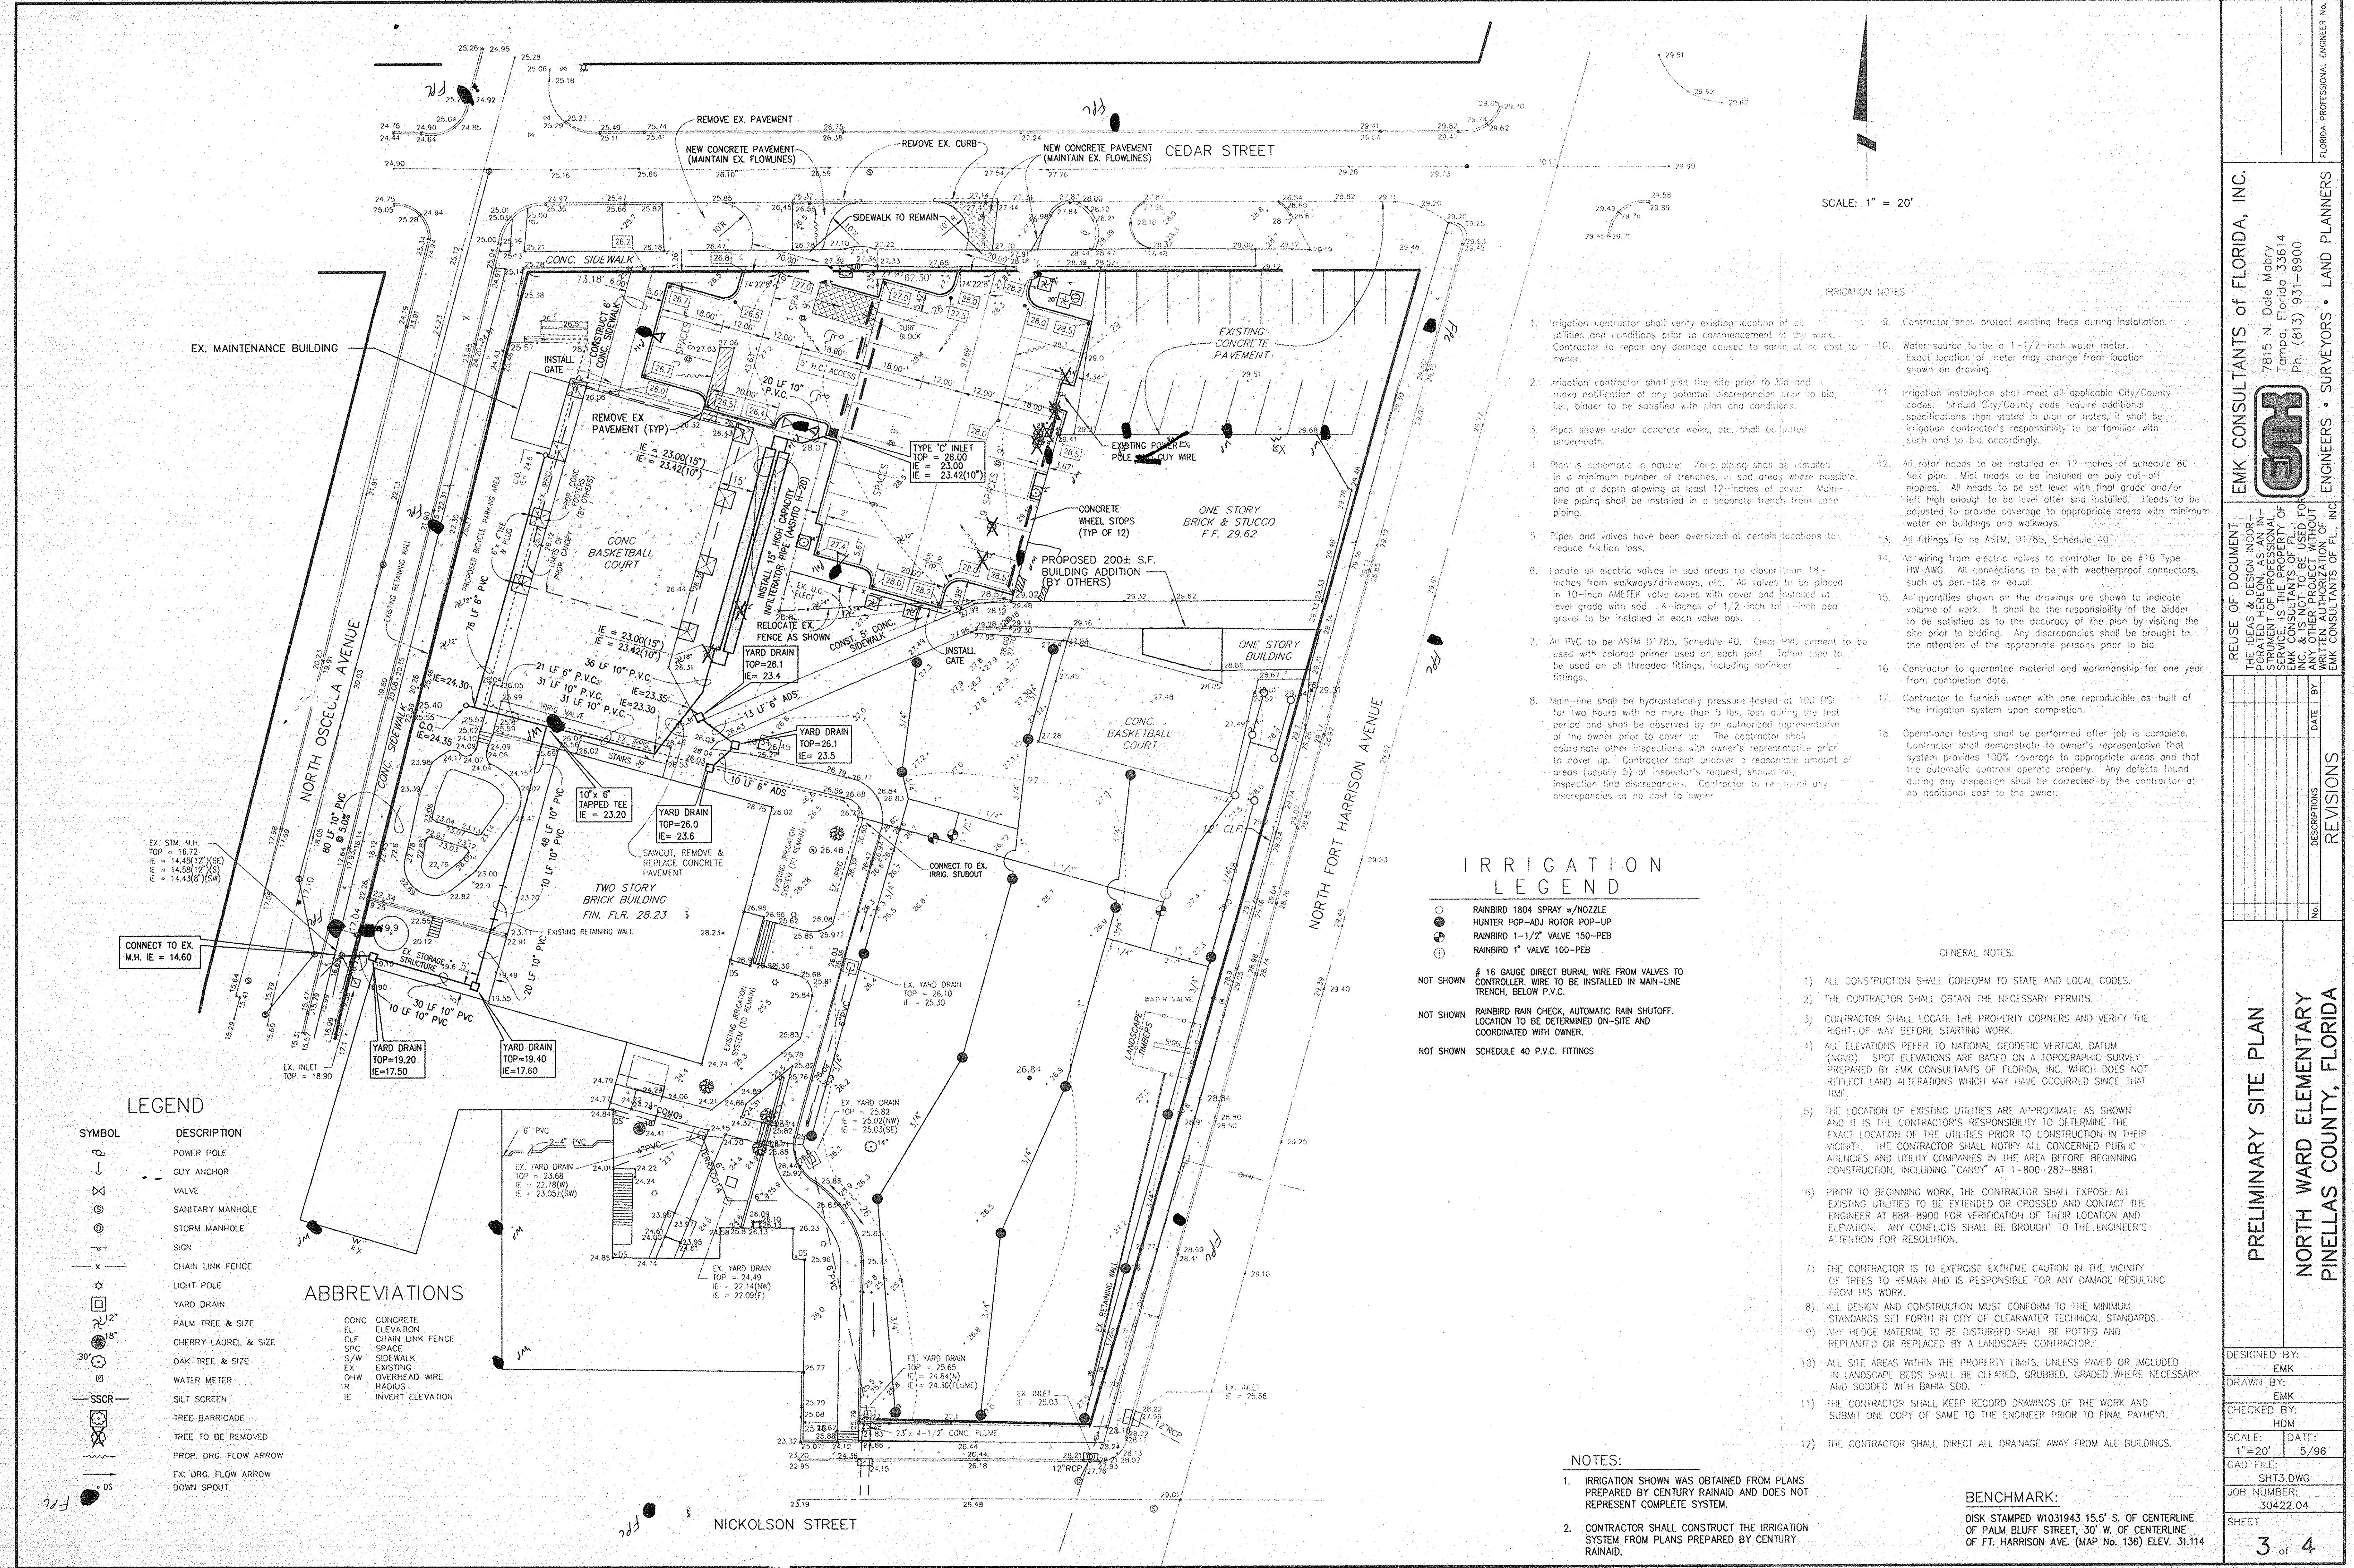

NORTH WARD ELEMENTARY SCHOOL

WINDOW REPLACEMENT

900 N. FT. HARRISON

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REVISIONS

NO.

DATE

DESCRIPTION





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DATE: 5/22/92
REVIEWED BY:
DATE:

PROJECT NO.
994


DRAWING NO.

A1
MAY 22 1992

OF 5

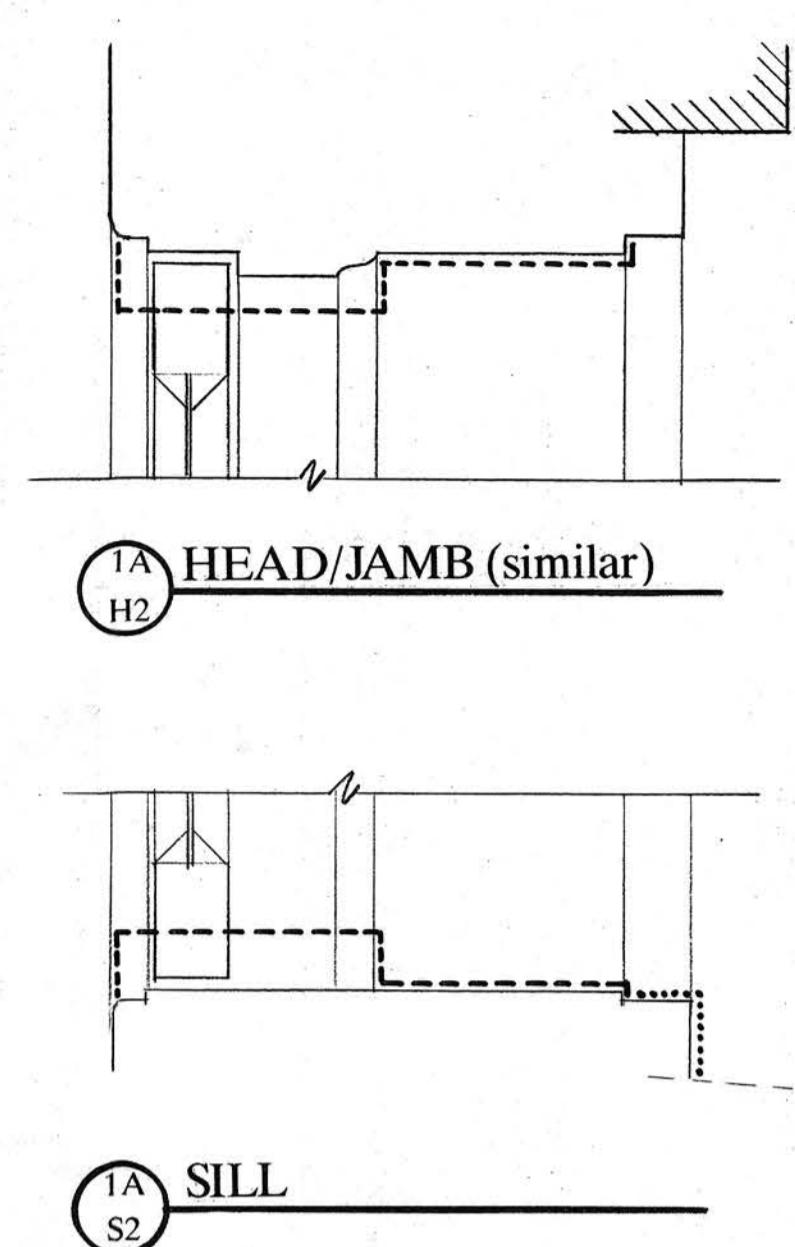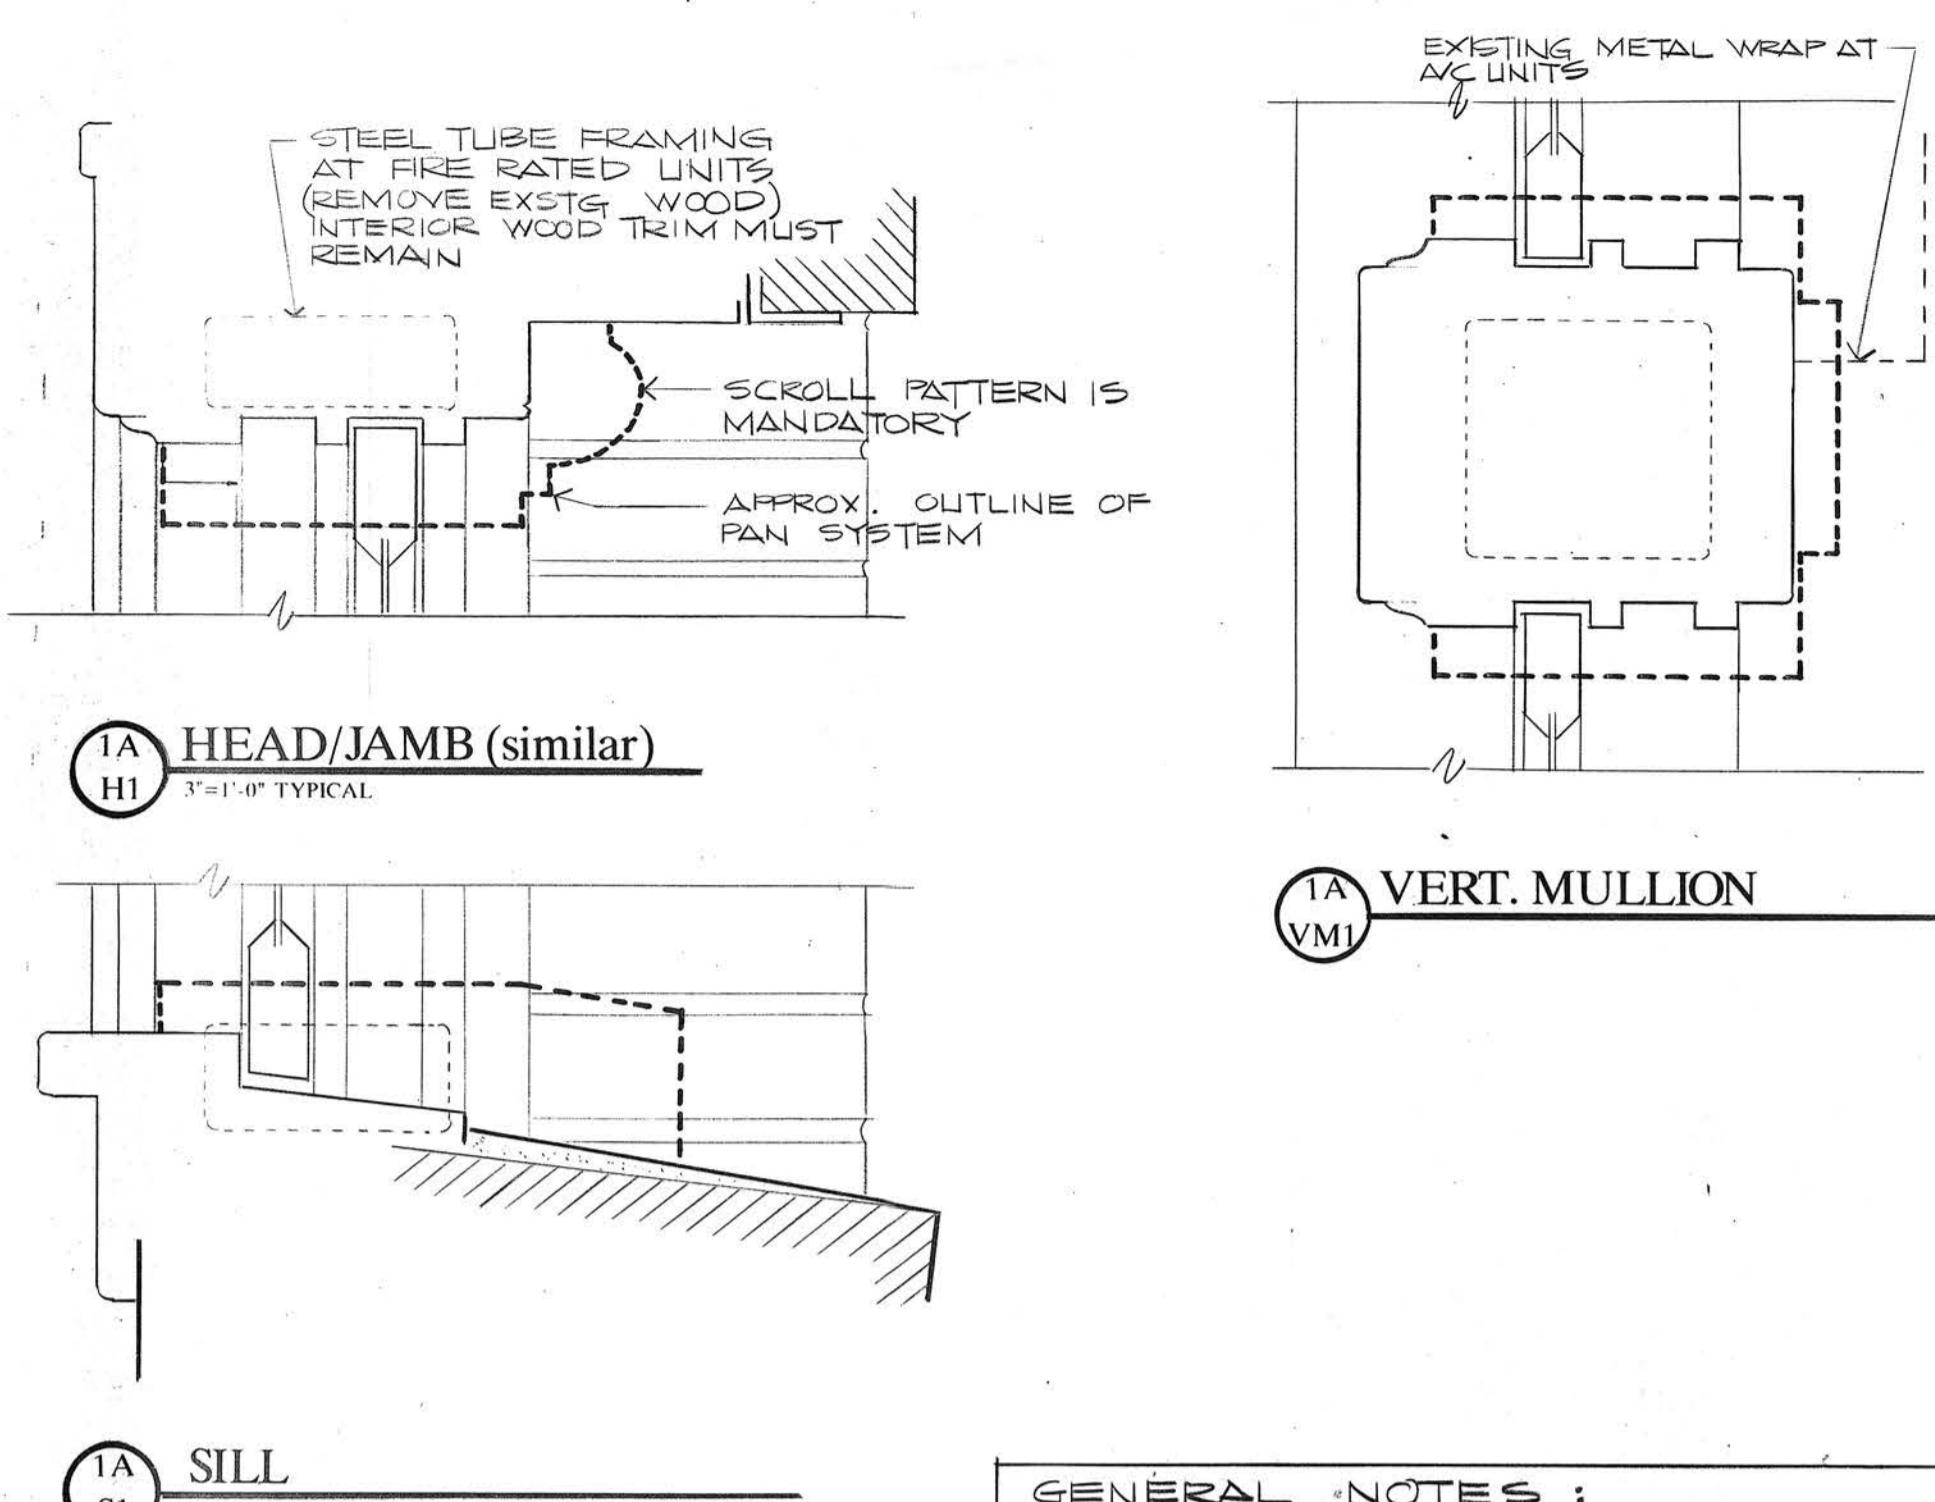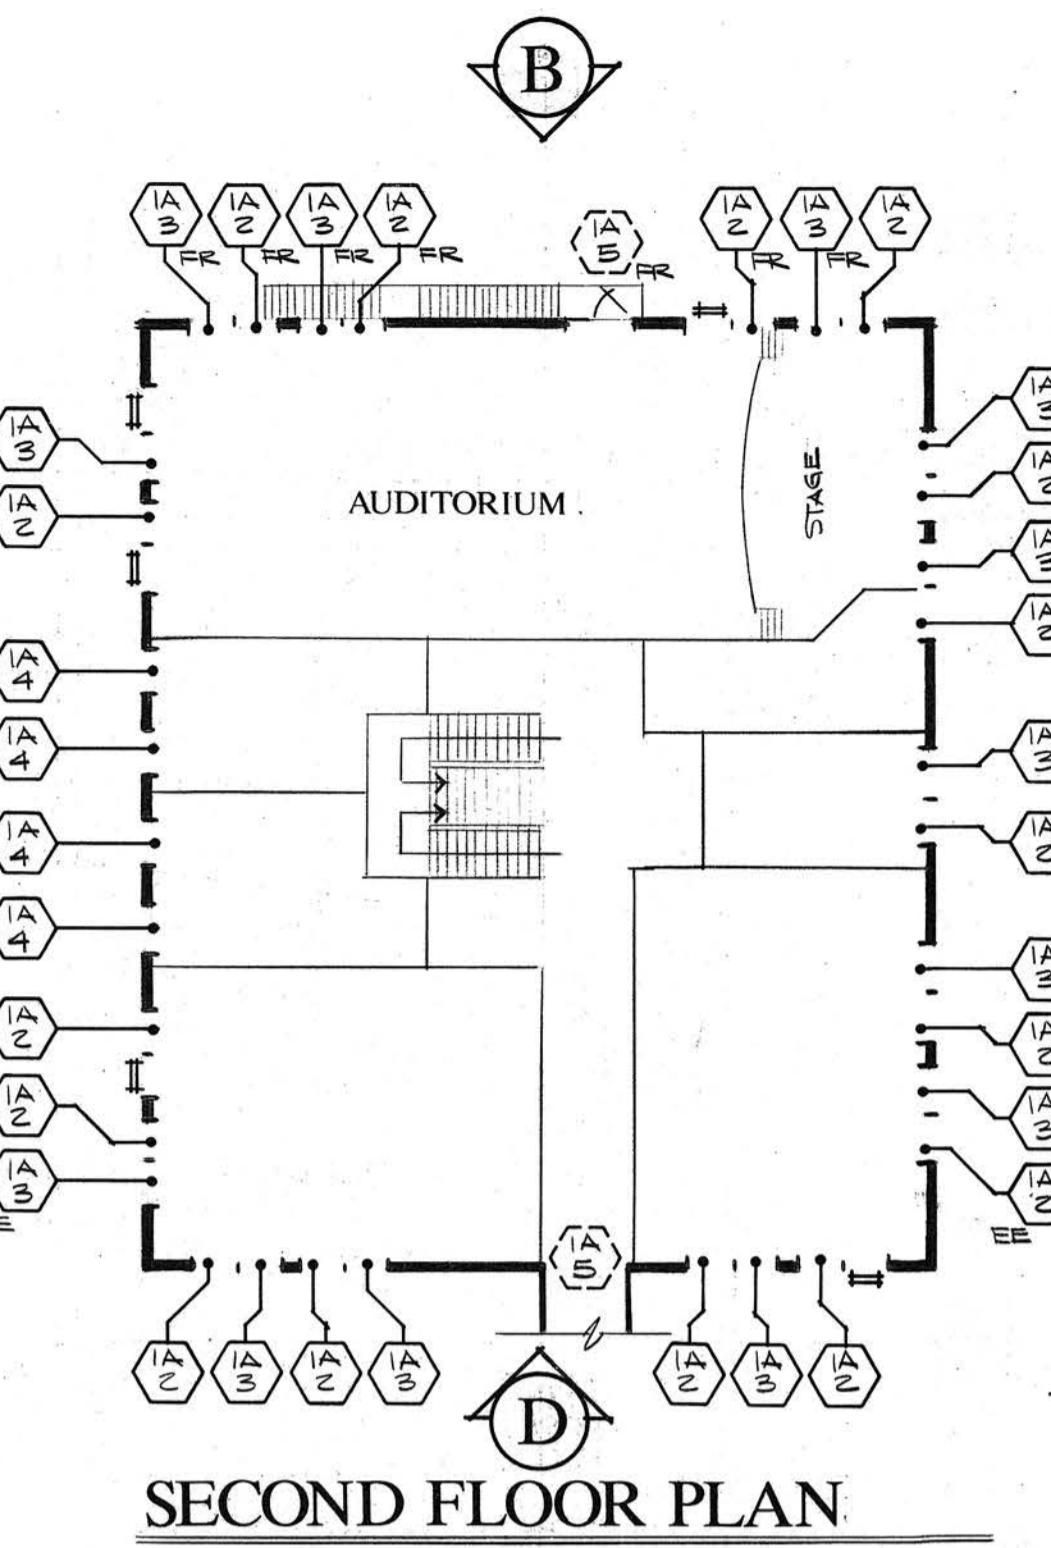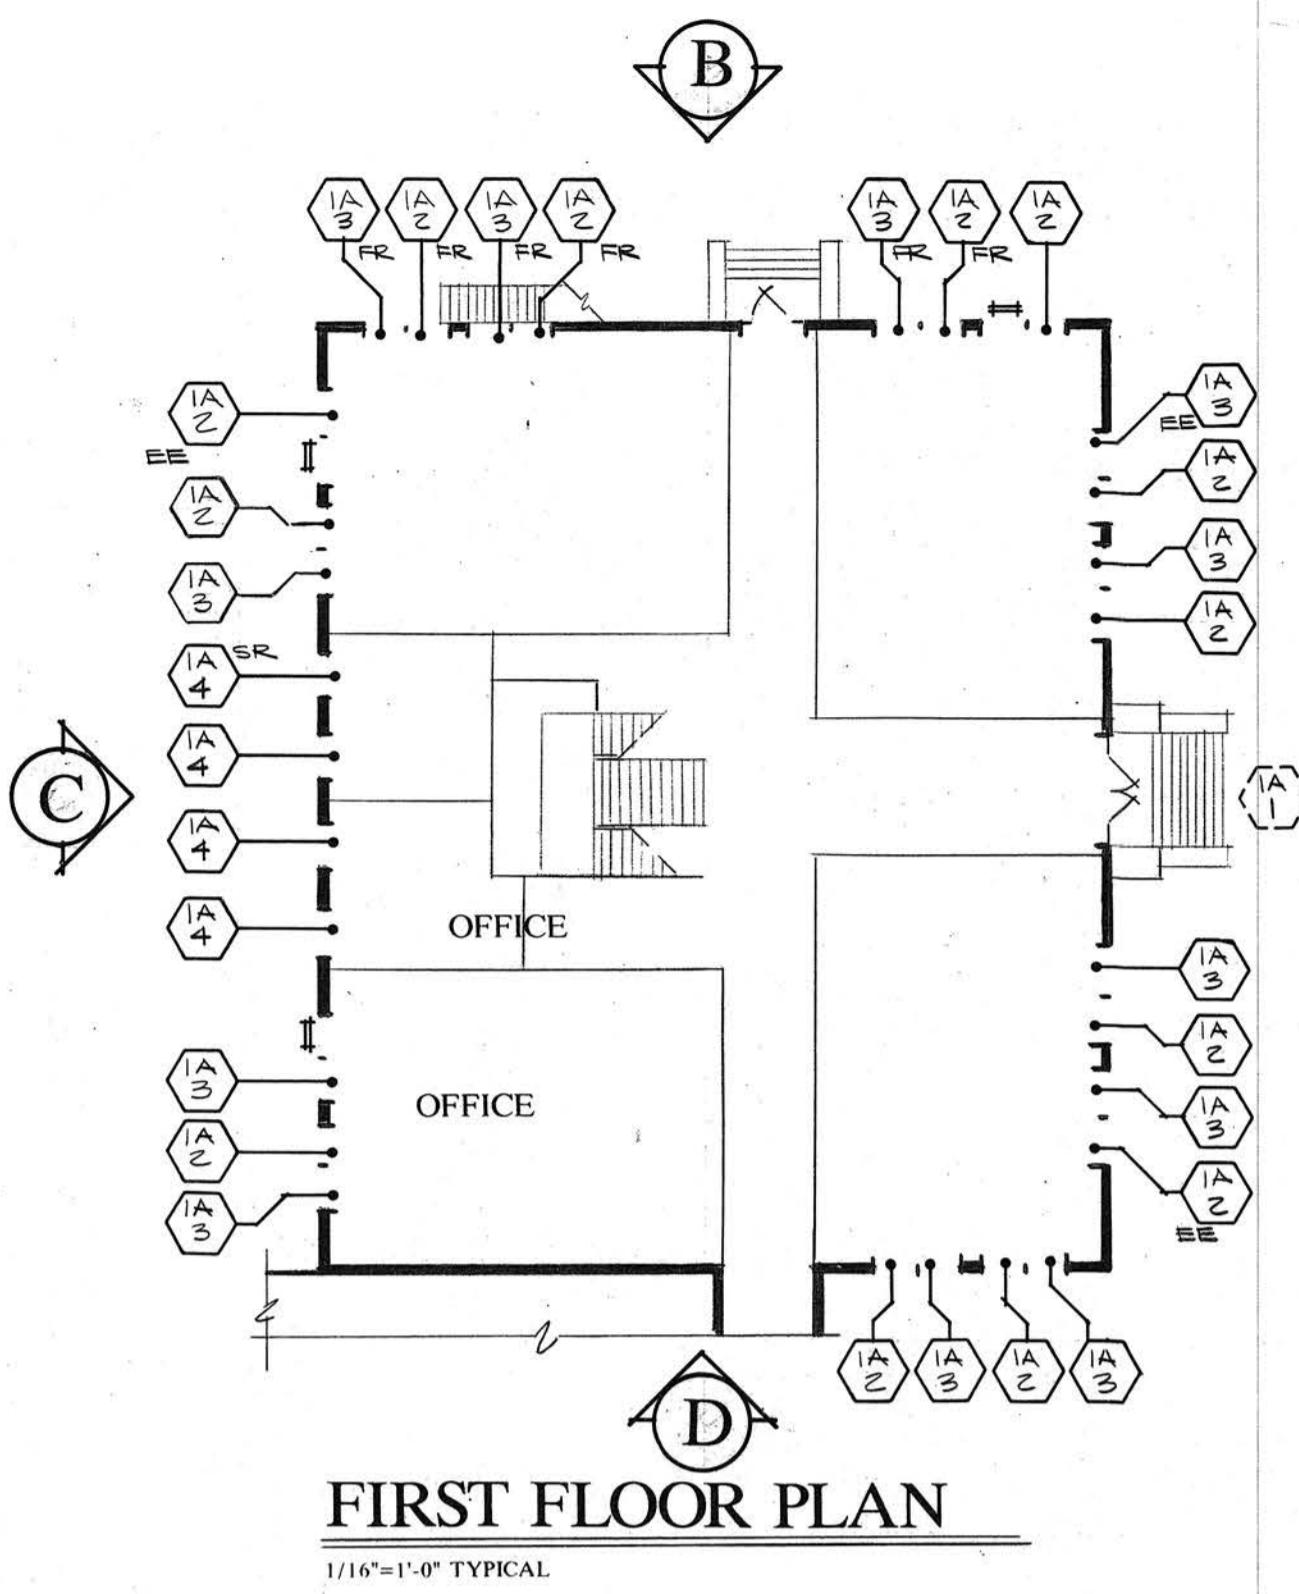


- GENERAL NOTES :**
- 1) CONTRACTOR, BY SUBMISSION OF HIS BID, ATTESTS THAT HE HAS PERFORMED HIS SITE INVESTIGATION AND IS THOROUGHLY FAMILIAR WITH THE SCOPE OF WORK AND ANY CONSTRAINTS THAT MAY EXIST.
 - 2) CONTRACTOR SHALL SUBMIT A LIST OF AT LEAST 3 PREVIOUS PROJECTS OF THIS TYPE FOR WHICH HE WAS THE RESPONSIBLE INSTALLER.
 - 3) CONTRACTOR SHALL BE SOLELY RESPONSIBLE FOR REMOVING, PROTECTING AND RE-INSTALLING EXISTING ITEMS SUCH AS EXHAUST VENTS, LOUVERS, CABLES, WIRING, THRU SASH A/C UNITS (WINDOW UNITS, NOT THE LARGE BARD UNITS), EXIT SIGNS, PIPE HANGERS, FLASHINGS, PROTECTIVE SCREENS, BACK GUARDS, HAND RAILS, WINDOW COVERINGS, ETC., THAT MAY BE ASSOCIATED WITH THIS WINDOW REPLACEMENT PROJECT.
 - 4) CONTRACTOR SHALL BE RESPONSIBLE FOR PROTECTING EXISTING WALLS, FLOORS, TRIM, FURNISHINGS, EQUIPMENT, FINISHES, ETC. AND SHALL ACCEPT THE FINANCIAL RESPONSIBILITY FOR ANY DAMAGE THAT HE AND THOSE IN HIS EMPLOY MAY CREATE.
 - 5) CONTRACTOR SHALL CO-ORDINATE ALL ASPECTS OF THE WORK WITH THE ARCHITECT AND THE ADMINISTRATIVE PERSONNEL OF THE SCHOOL IN ORDER TO MINIMIZE DISRUPTION OF ANY ON-GOING SCHOOL ACTIVITIES.
 - 6) TEAR OUT DEBRIS MUST REMAIN ON THE EXTERIOR OF THE BUILDING AND NOT BE TRANSPORTED THROUGH THE INTERIOR SPACES OF THE SCHOOL.
 - 7) CONTRACTOR SHALL NOT PERMIT ANY UNSECURED OVERNIGHT OPENINGS TO OCCUR.
 - 8) ALL REPLACEMENT WINDOW COMPONENTS SHALL BE OF A SINGLE MANUFACTURER. (EXCEPT FIRE RATED COMPONENTS)

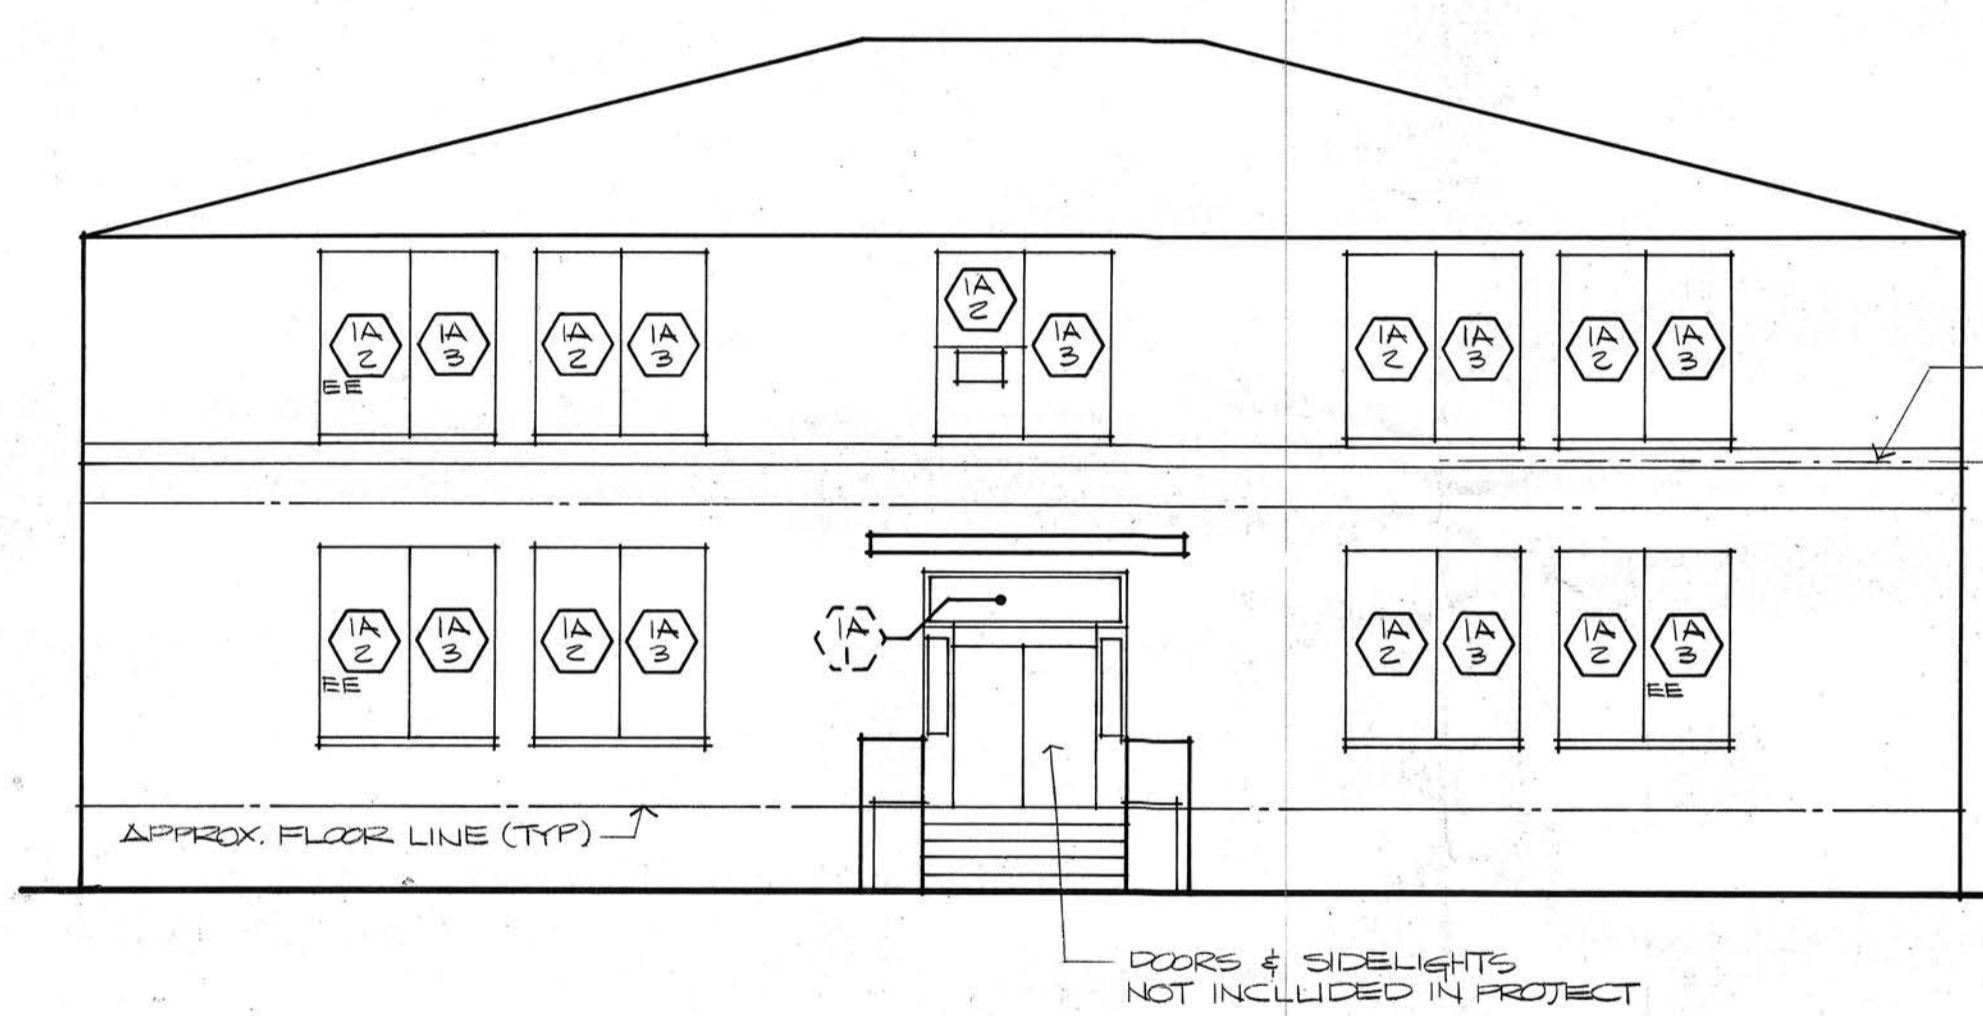


ELEVATION A (EAST)


1/8" = 1'-0" TYPICAL

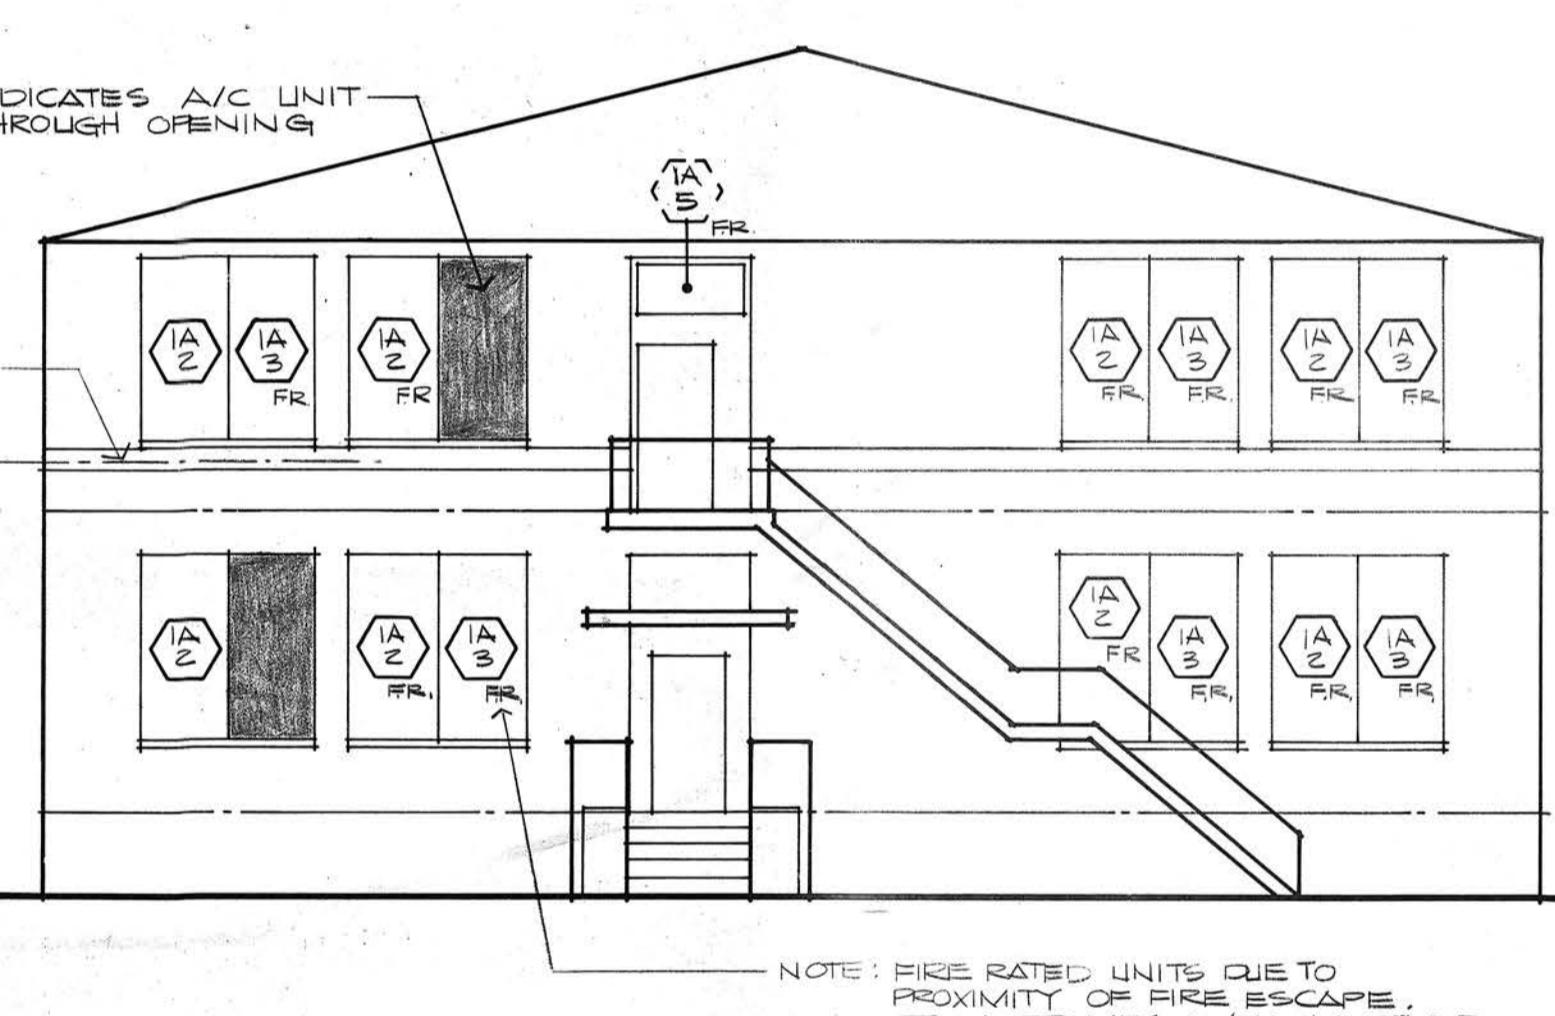


ELEVATION B (NORTH)

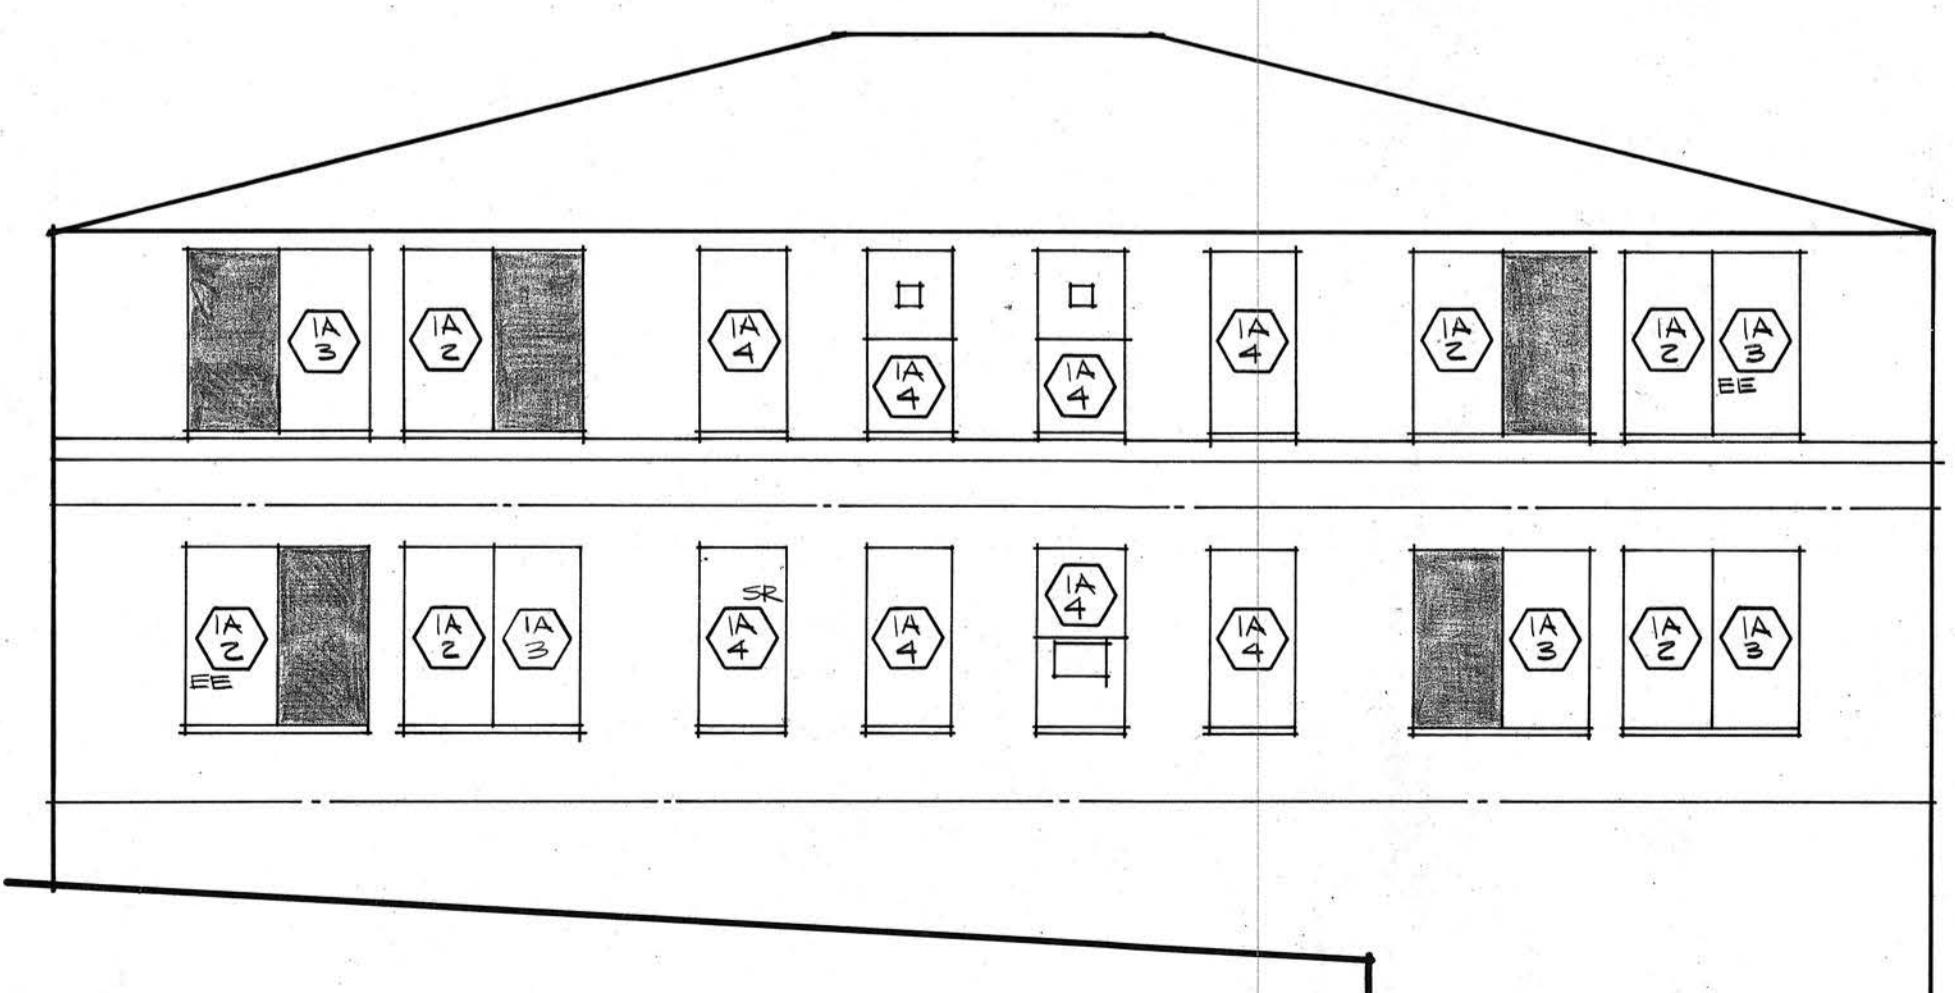

ELEVATION C (WEST)

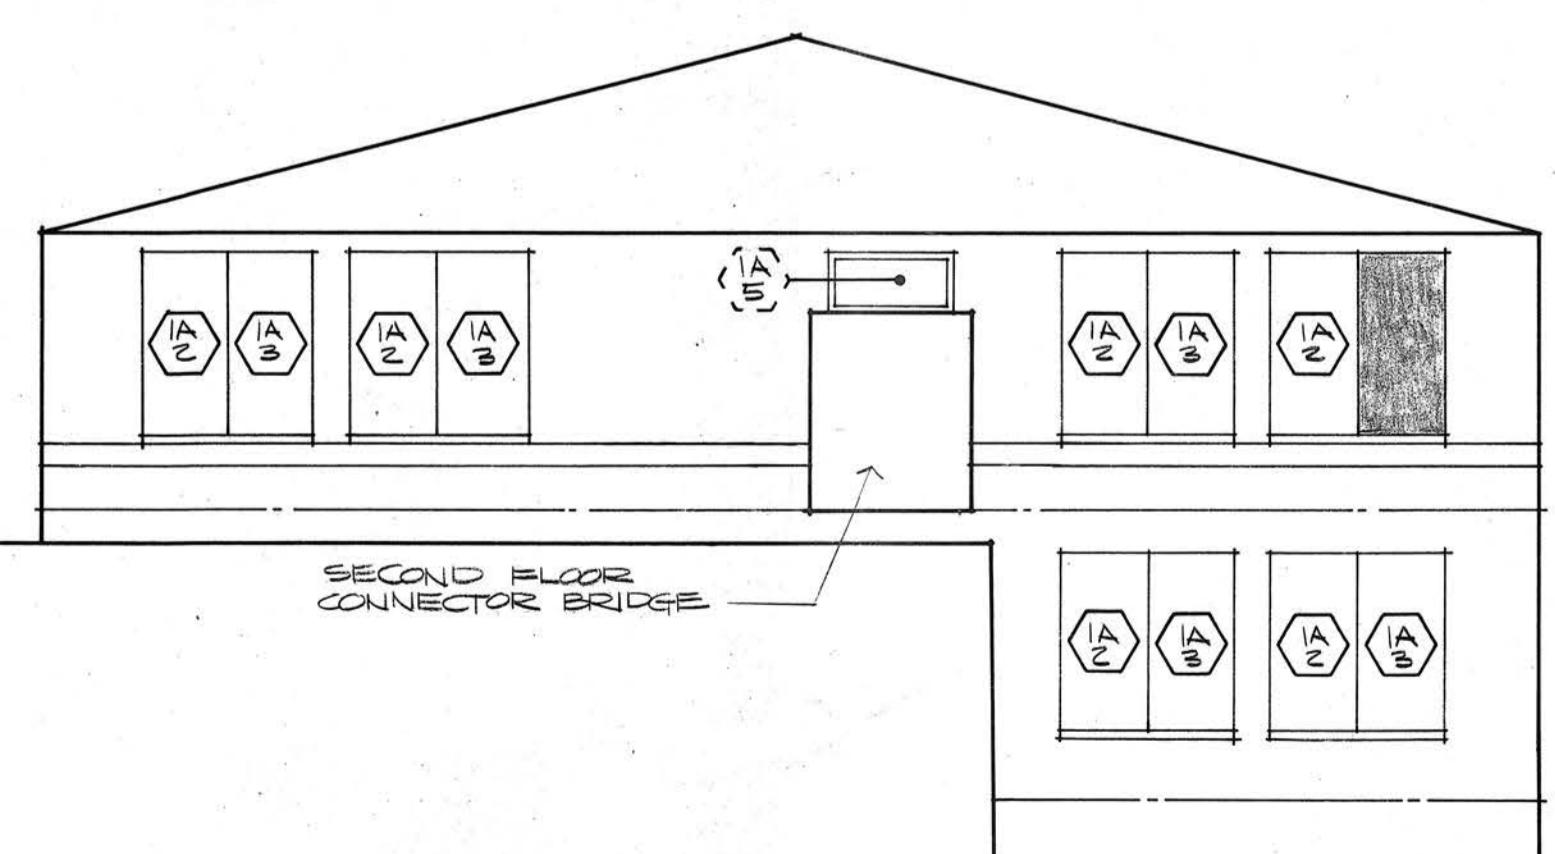


ELEVATION D (SOUTH)

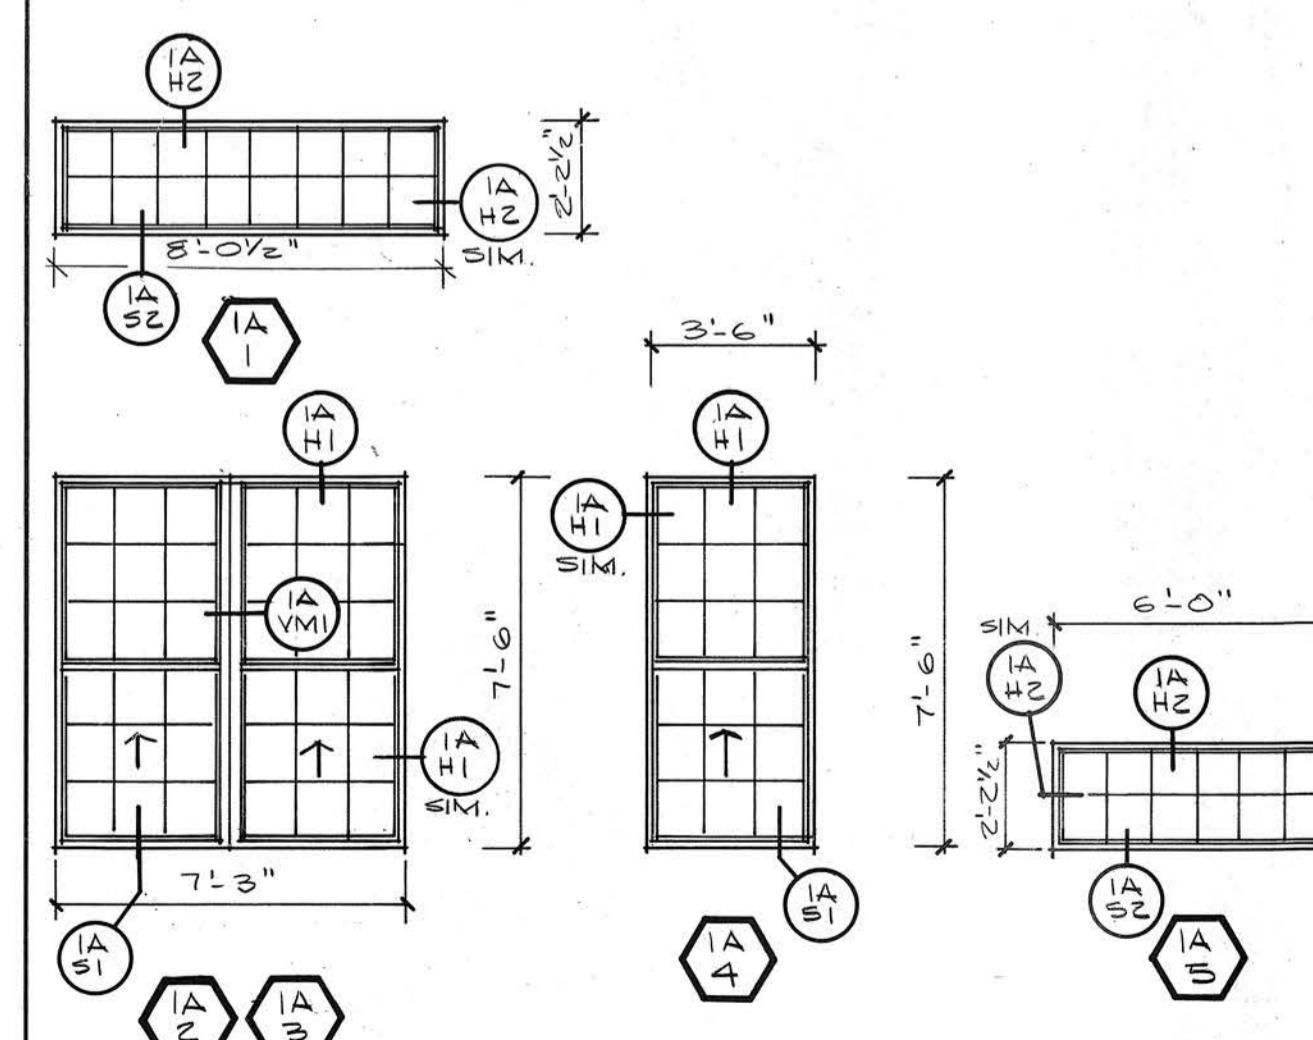

WINDOW TYPES @ BLDG. #1A

1/4" = 1'-0"

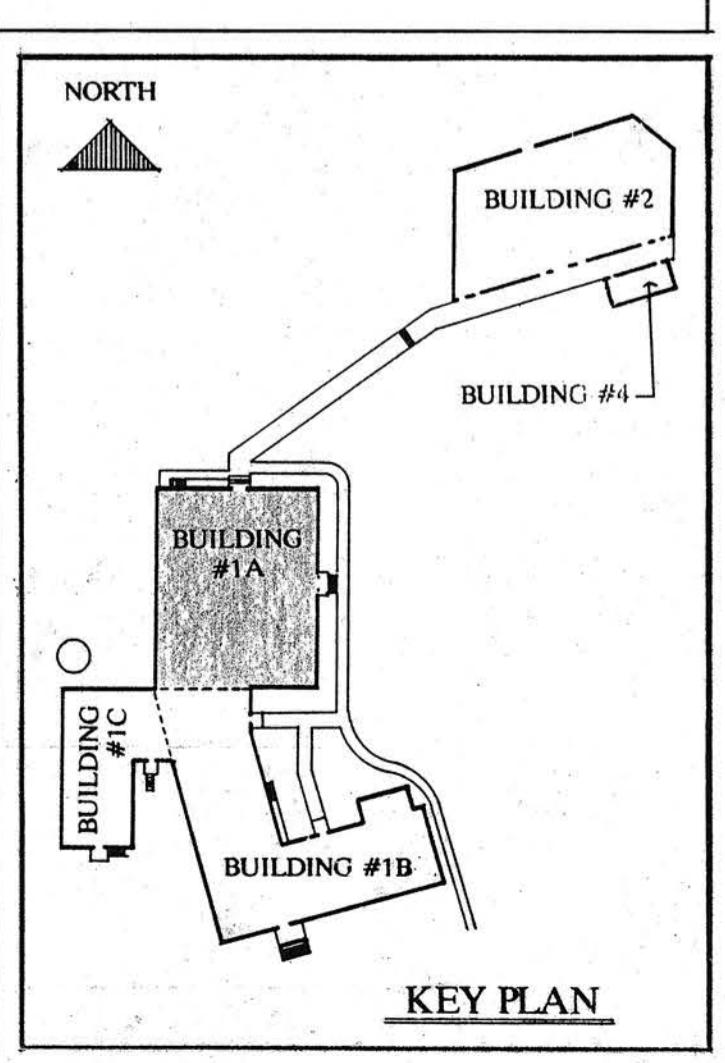


KEY PLAN

NORTH WARD ELEMENTARY SCHOOL

WINDOW REPLACEMENT

C.L.FARWATER, FL.
900 N. FT. HARRISON

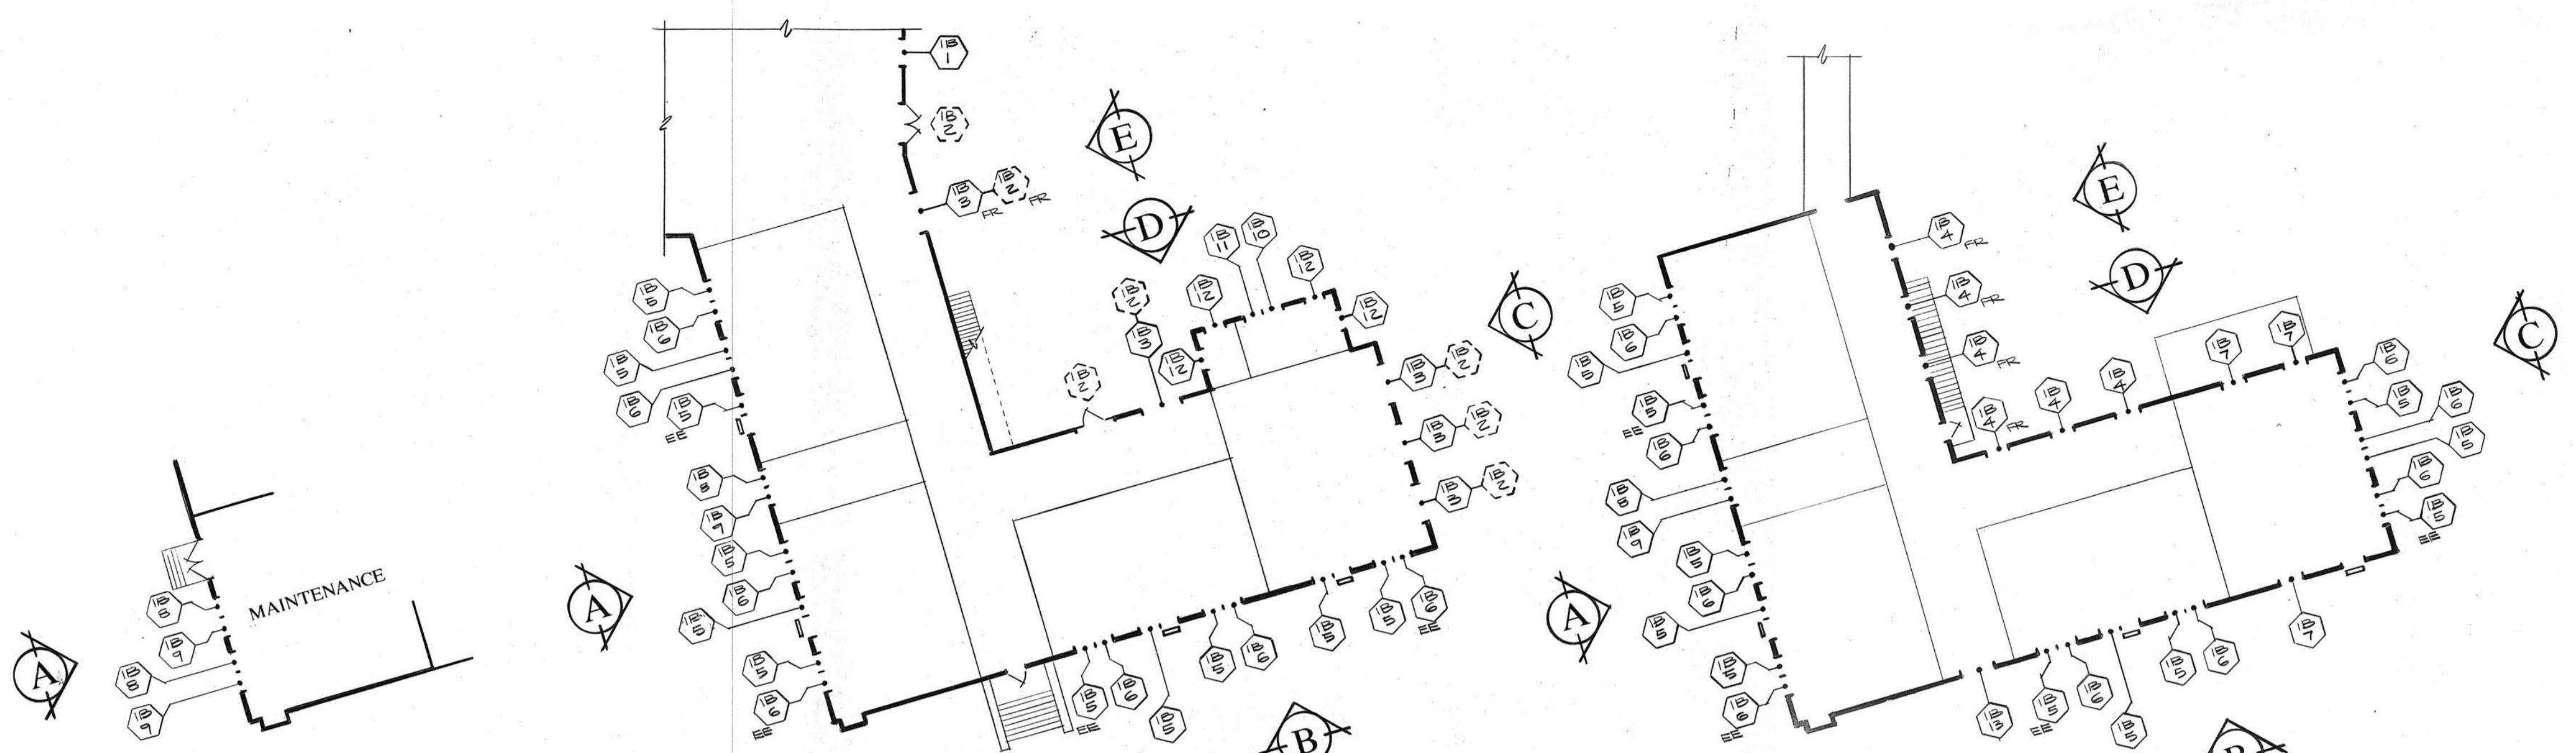


BASEMENT PLAN

1/16"=1'-0" TYPICAL

FIRST FLOOR PLAN



SECOND FLOOR PLAN

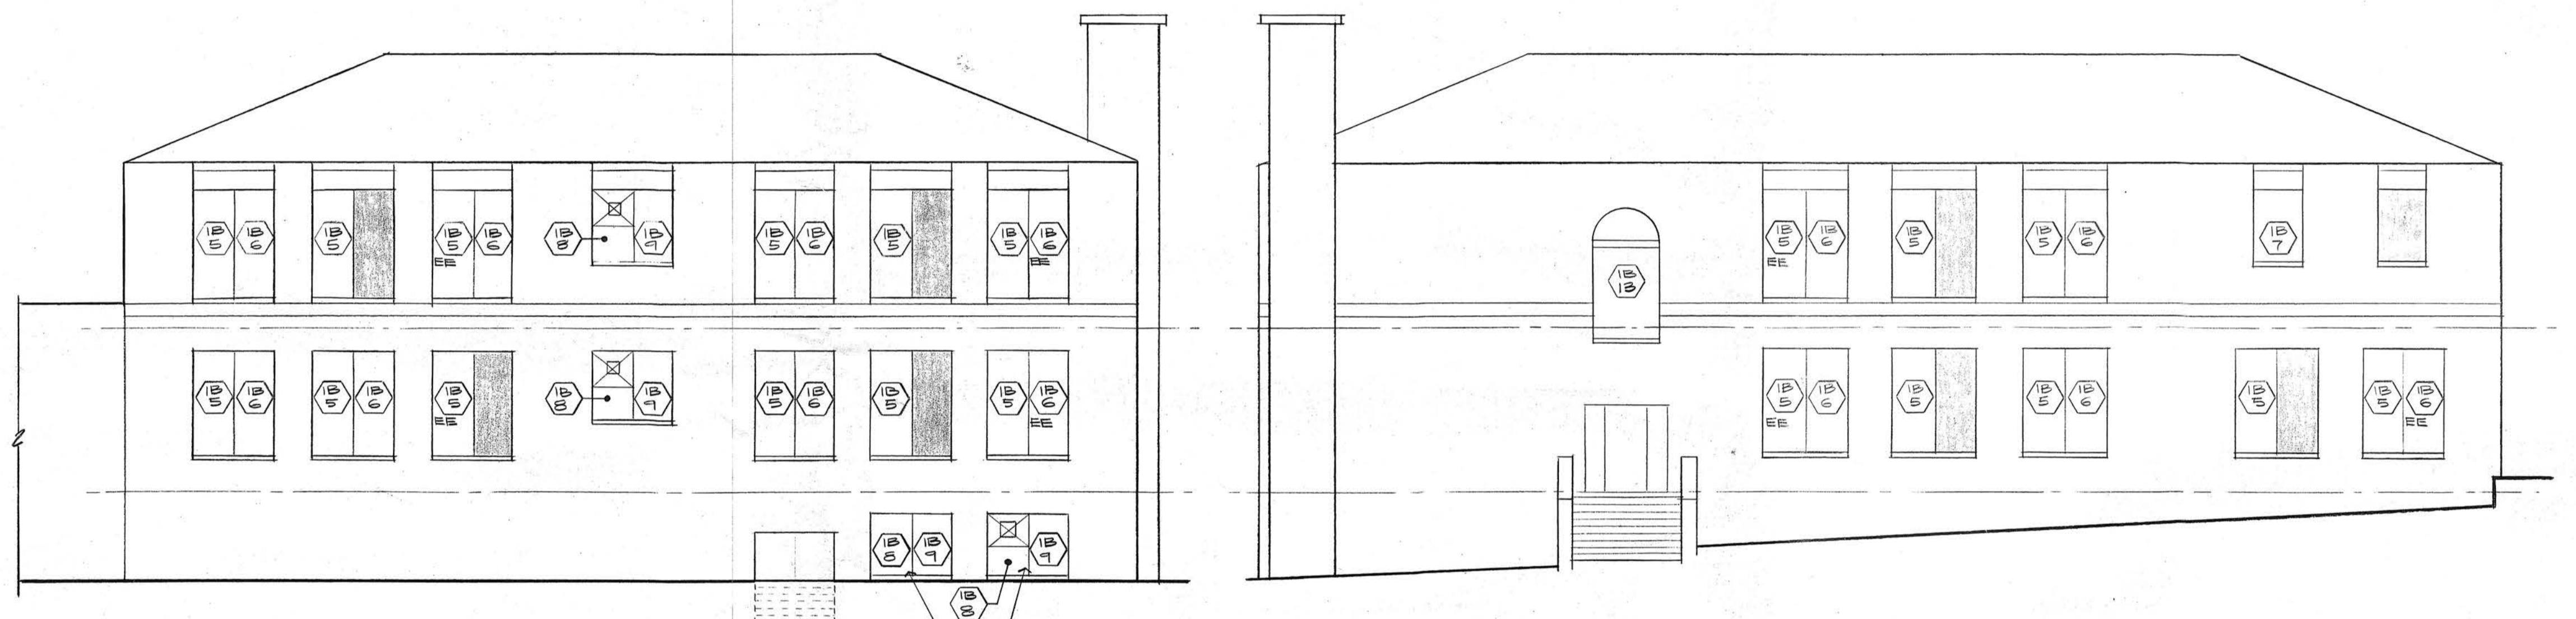

ELEVATION A (WEST)

1/8"=1'-0" TYPICAL

ELEVATION B (SOUTH)

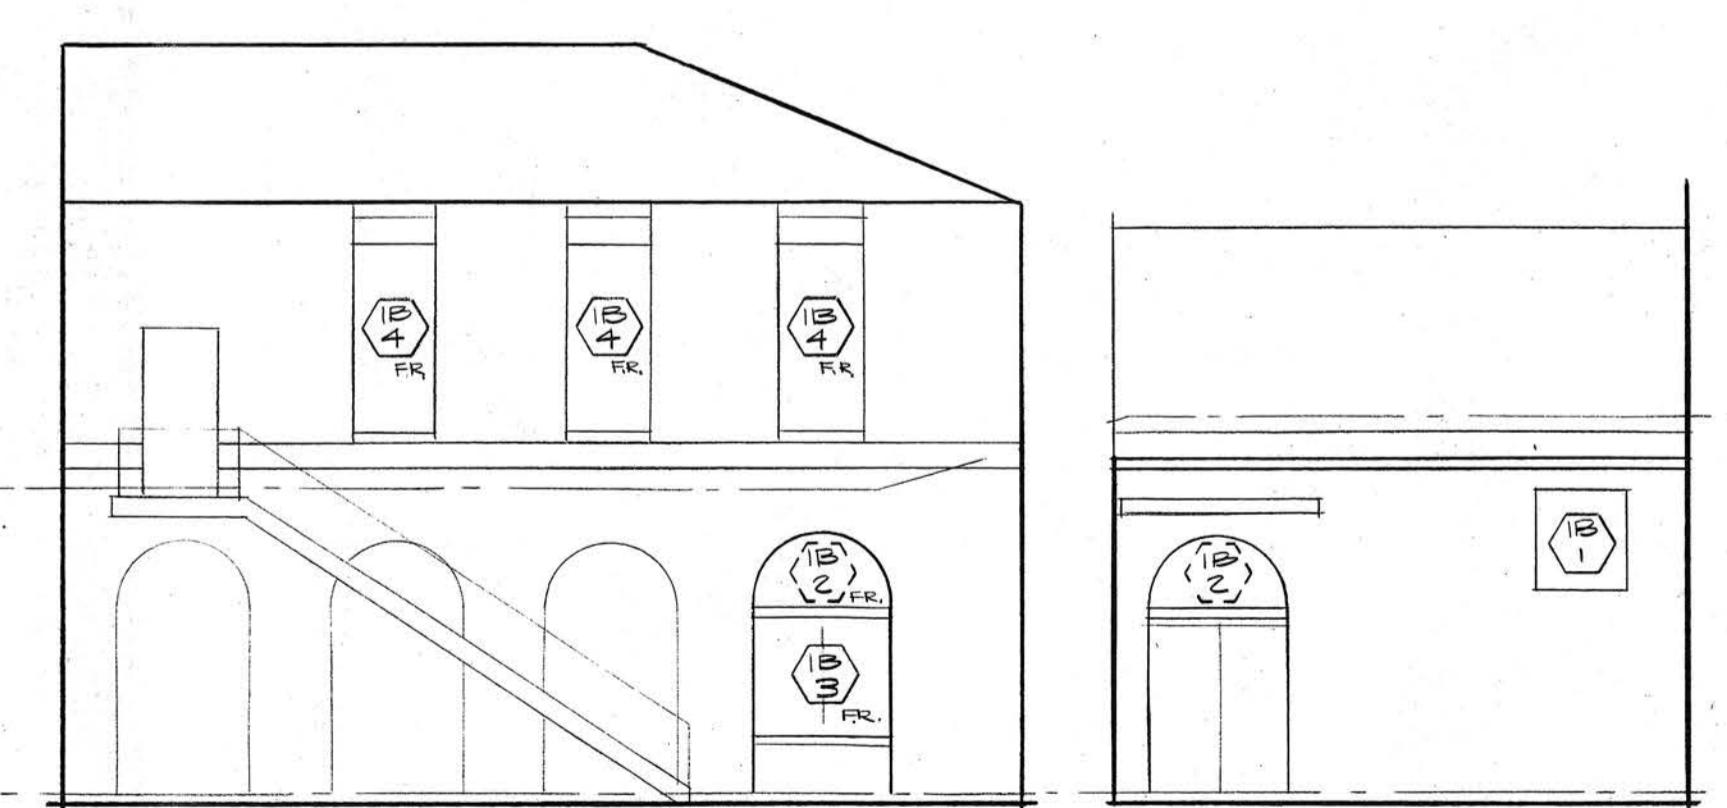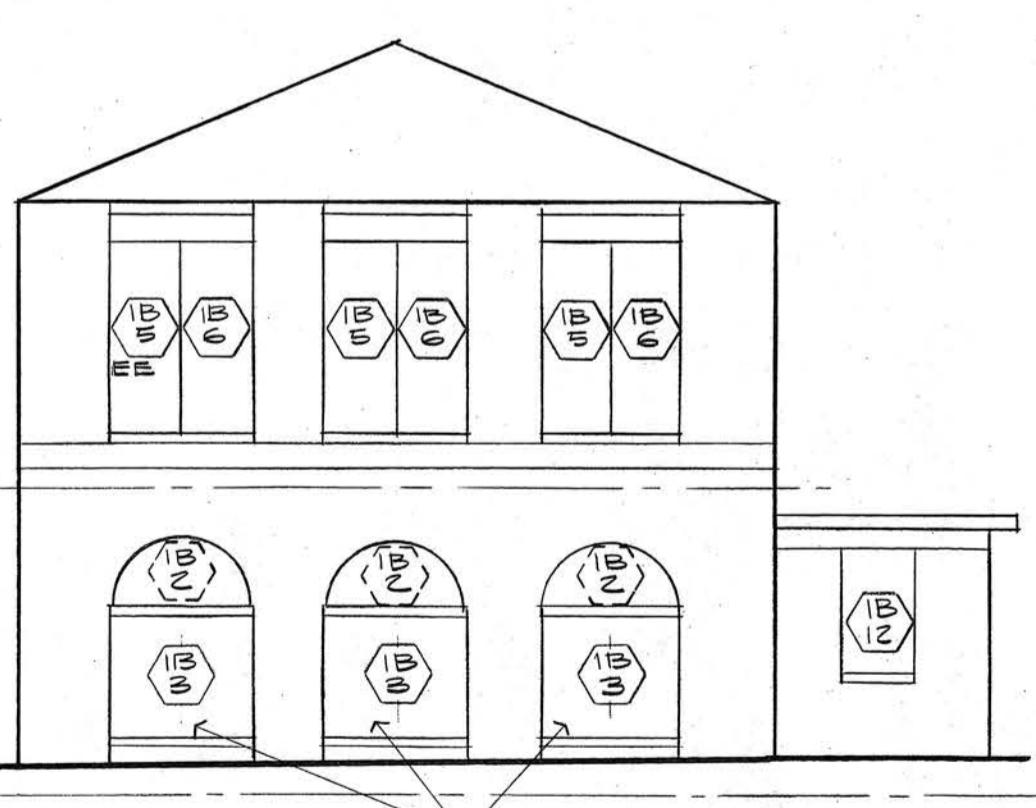

ELEVATION C (EAST)


ELEVATION D (NORTH)

ELEVATION E (EAST, COURTYARD)

GENERAL NOTES :

- 1) CONTRACTOR, BY SUBMISSION OF HIS BID, ATTESTS THAT HE HAS PERFORMED HIS SITE INVESTIGATION AND IS THOROUGHLY FAMILIAR WITH THE SCOPE OF WORK AND ANY CONSTRAINTS THAT MAY EXIST.
- 2) CONTRACTOR SHALL SUBMIT A LIST OF AT LEAST 3 PREVIOUS PROJECTS OF THIS TYPE FOR WHICH HE WAS THE RESPONSIBLE INSTALLER.
- 3) CONTRACTOR SHALL BE SOLELY RESPONSIBLE FOR REMOVING, PROTECTING AND RE-INSTALLING EXISTING ITEMS SUCH AS EXHAUST VENTS, LOUVERS, CABLES, WIRING, THRU SASH AC UNITS (WINDOW UNITS, NOT THE LARGE BARD UNITS), EXIT SIGNS, PIPE HANGERS, FLASHINGS, PROTECTIVE SCREENS, BAR GUARDS, HAND RAILS, WINDOW COVERINGS, ETC., THAT MAY BE ASSOCIATED WITH THIS WINDOW REPLACEMENT PROJECT.
- 4) CONTRACTOR SHALL BE RESPONSIBLE FOR PROTECTING EXISTING WALLS, FLOORS, TRIM, FURNISHINGS, EQUIPMENT, FINISHES, ETC. AND SHALL ACCEPT THE FINANCIAL RESPONSIBILITY FOR ANY DAMAGE THAT HE AND THOSE IN HIS EMPLOY MAY CREATE.

- 5) CONTRACTOR SHALL COORDINATE ALL ASPECTS OF THE WORK WITH THE ARCHITECT AND THE ADMINISTRATIVE PERSONNEL OF THE SCHOOL IN ORDER TO MINIMIZE DISRUPTION OF ANY ONGOING SCHOOL ACTIVITIES.
- 6) TEAR-OUT DEBRIS MUST REMAIN ON THE EXTERIOR OF THE BUILDING AND NOT BE TRANSPORTED THROUGH THE INTERIOR SPACES OF THE SCHOOL.
- 7) CONTRACTOR SHALL NOT PERMIT ANY UNSECURED OVERNIGHT OPENINGS TO OCCUR.
- 8) ALL REPLACEMENT WINDOW COMPONENTS SHALL BE OF A SINGLE MANUFACTURER. (EXCEPT FIRE RATED COMPONENTS)

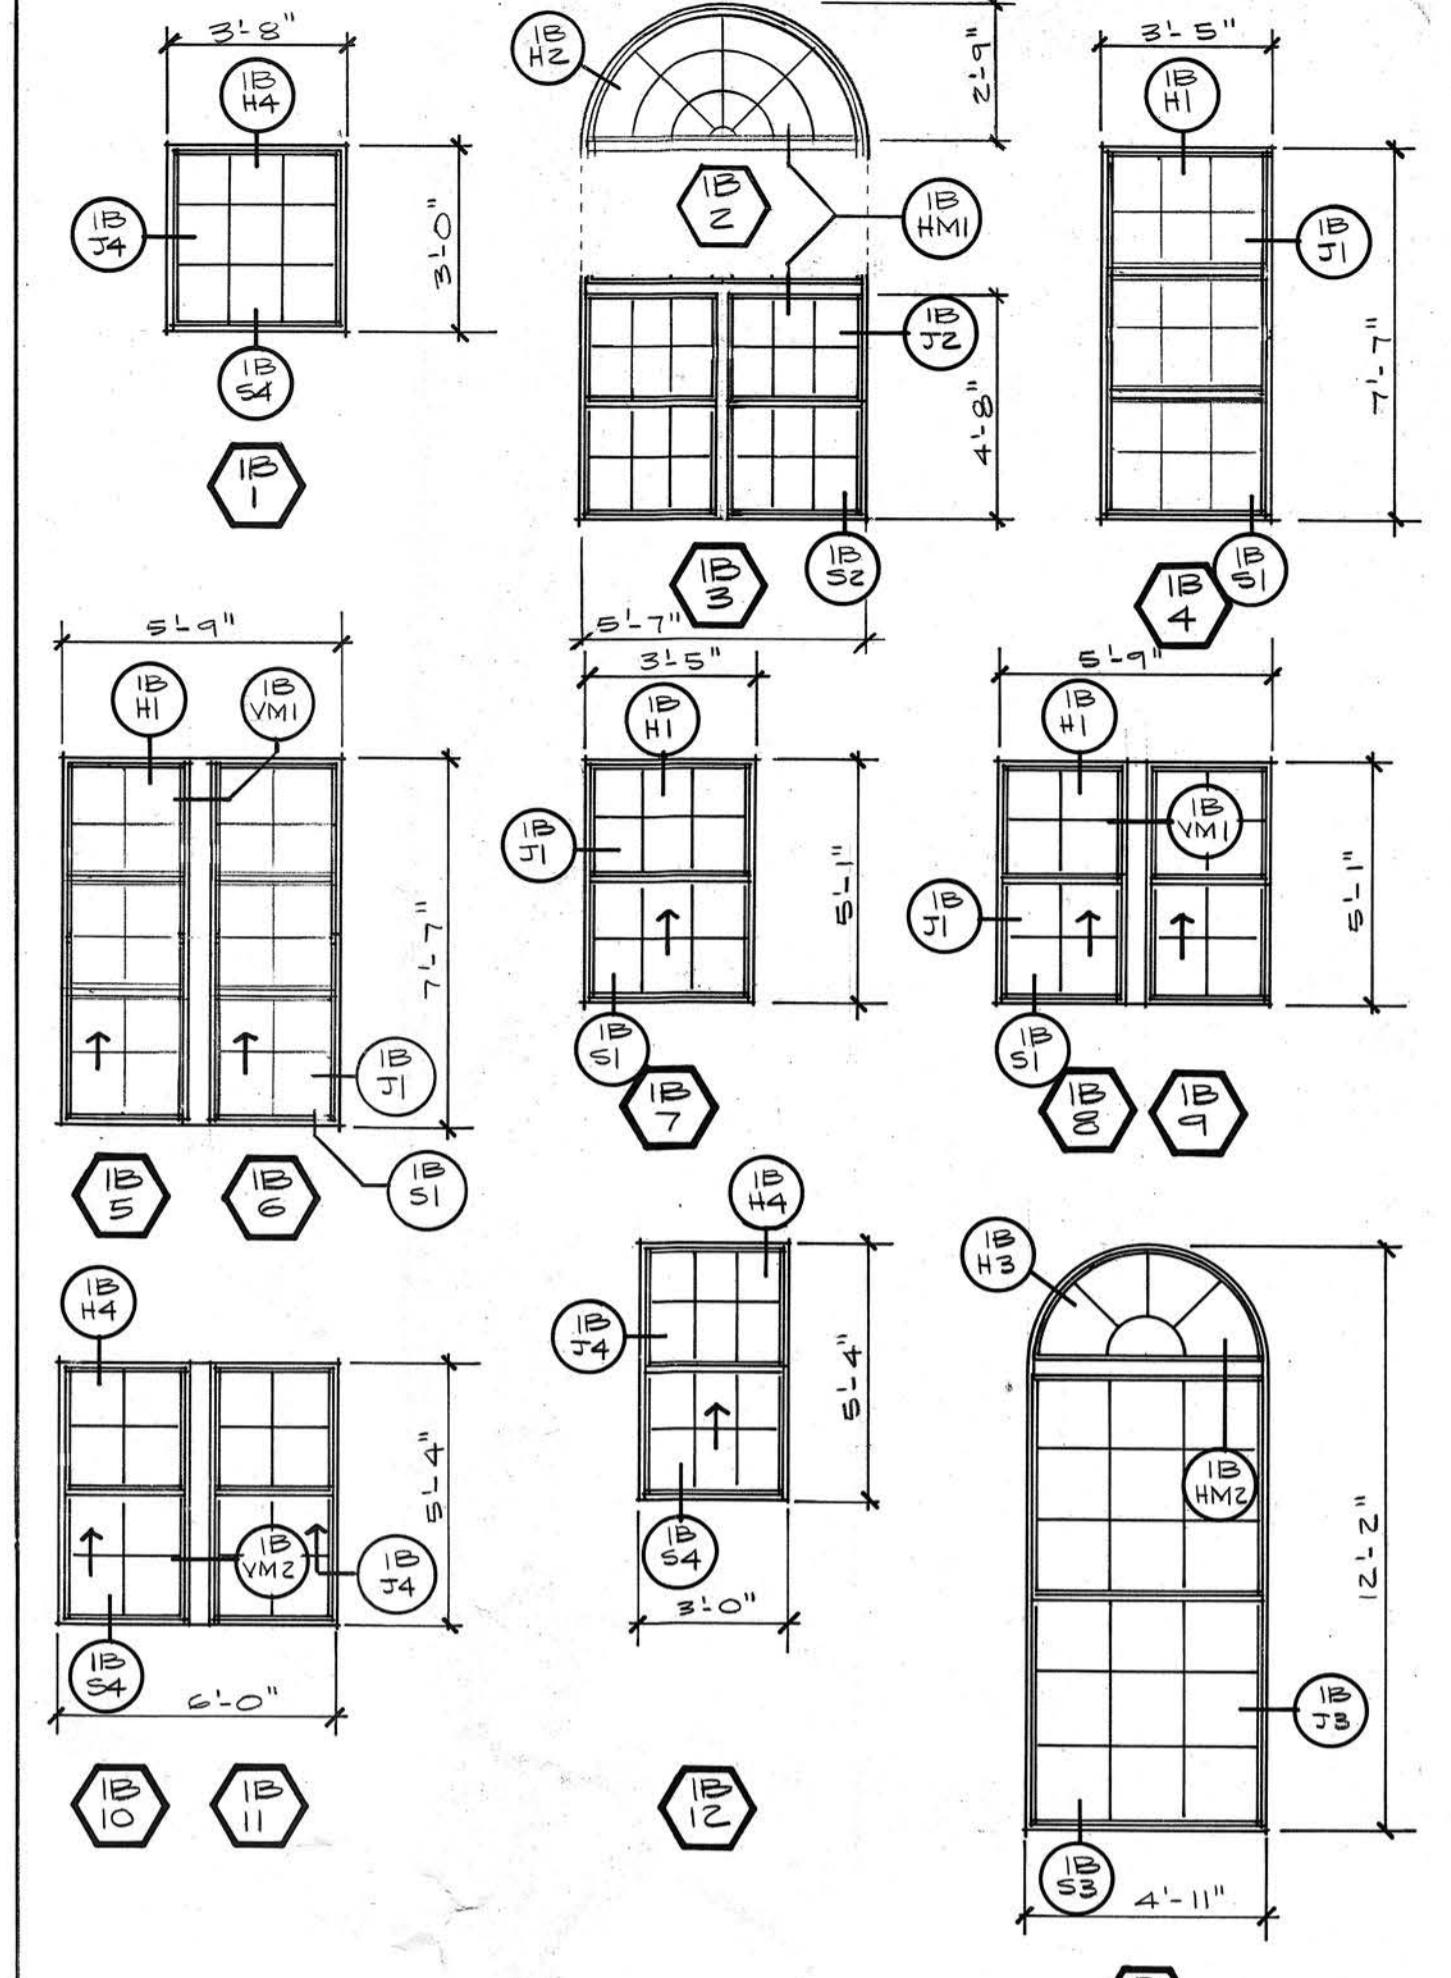

WINDOW TYPES @ BLDG. #1B

1/4" = 1'-0"

WINDOW NOTES :
1) MANUFACTURER MUST FURNISH DETAILED STRUCTURAL CALCULATIONS AS PER SPECS.
2) ALL FINISHES SHALL BE WHITE, SILICONIZED POLYESTER PAINTED ENAMEL AS PER SPECS.
3) GLASS SHALL BE $\frac{1}{4}$ " THICK, MINIMUM, WITH MEDIUM BRONZE TINT. (SAMPLES REQ'D)
4) ALUMINUM GRIDS MUST BE PLACED ON THE INSIDE OF THE GLASS SASH.
5) ALL EXPOSED EDGES MUST BE SMOOTH AND FINISHED PROPERLY. NO POTENTIAL FOR INJURY.
6) ALL DIMENSIONS AND DETAILS SHOWN ARE APPROXIMATE. CONTRACTOR MUST PRECISELY FIELD MEASURE AND DETERMINE EXACT SIZES AND EACH CONDITION.
7) PANNING EXTRUSIONS SHALL HAVE MIN. WALL THICKNESS OF .08 INCHES. PROFILE PROPOSALS SHOULD BE SUBMITTED WITH BID.

EE DESIGNATES EMERGENCY EXIT WITH MIN. CLEAR OPENING 20 INCHES WIDE BY 24 INCHES HIGH, NOT LESS THAN 5.7 SQ. FT. IN AREA. MUST BE OPENABLE FROM INSIDE WITHOUT TOOLS. OPENING DEVICE SHALL NOT BE OVER 4'-0" ABOVE THE FLOOR. BOTTOM OF THIS OPENING SHALL NOT BE MORE THAN 4'-0" ABOVE THE FLOOR. LOCATED ON THE SOUTH SIDE OF THE BUILDING AS AN EMERGENCY EXIT.
FR DESIGNATES FIRE RATED ASSEMBLY (1 HR.) DUE TO PROXIMITY OF FIRE ESCAPE.
SR INDICATES SILL ROT AT EXISTING SILL (MUST BE REPLACED WITH PT.).

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NO	DATE	DESCRIPTION


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DATE:

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994

DRAWING NO.

A2

MAY 22 1992
OF 5

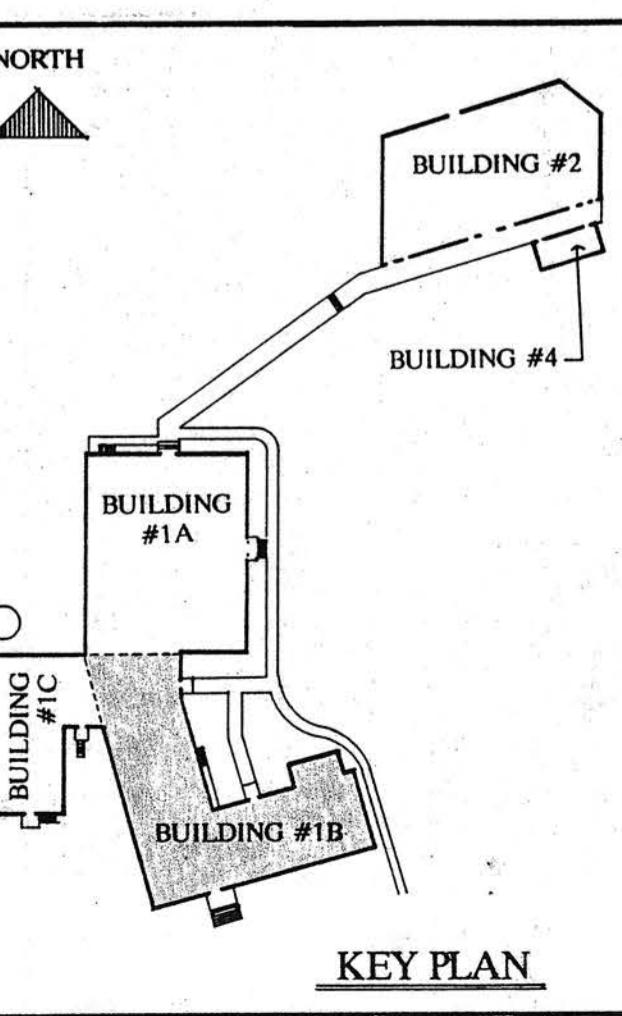

KEY PLAN

NORTH WARD ELEMENTARY SCHOOL

WINDOW REPLACEMENT


CLEARWATER, FL.

900 N. FT. HARRISON

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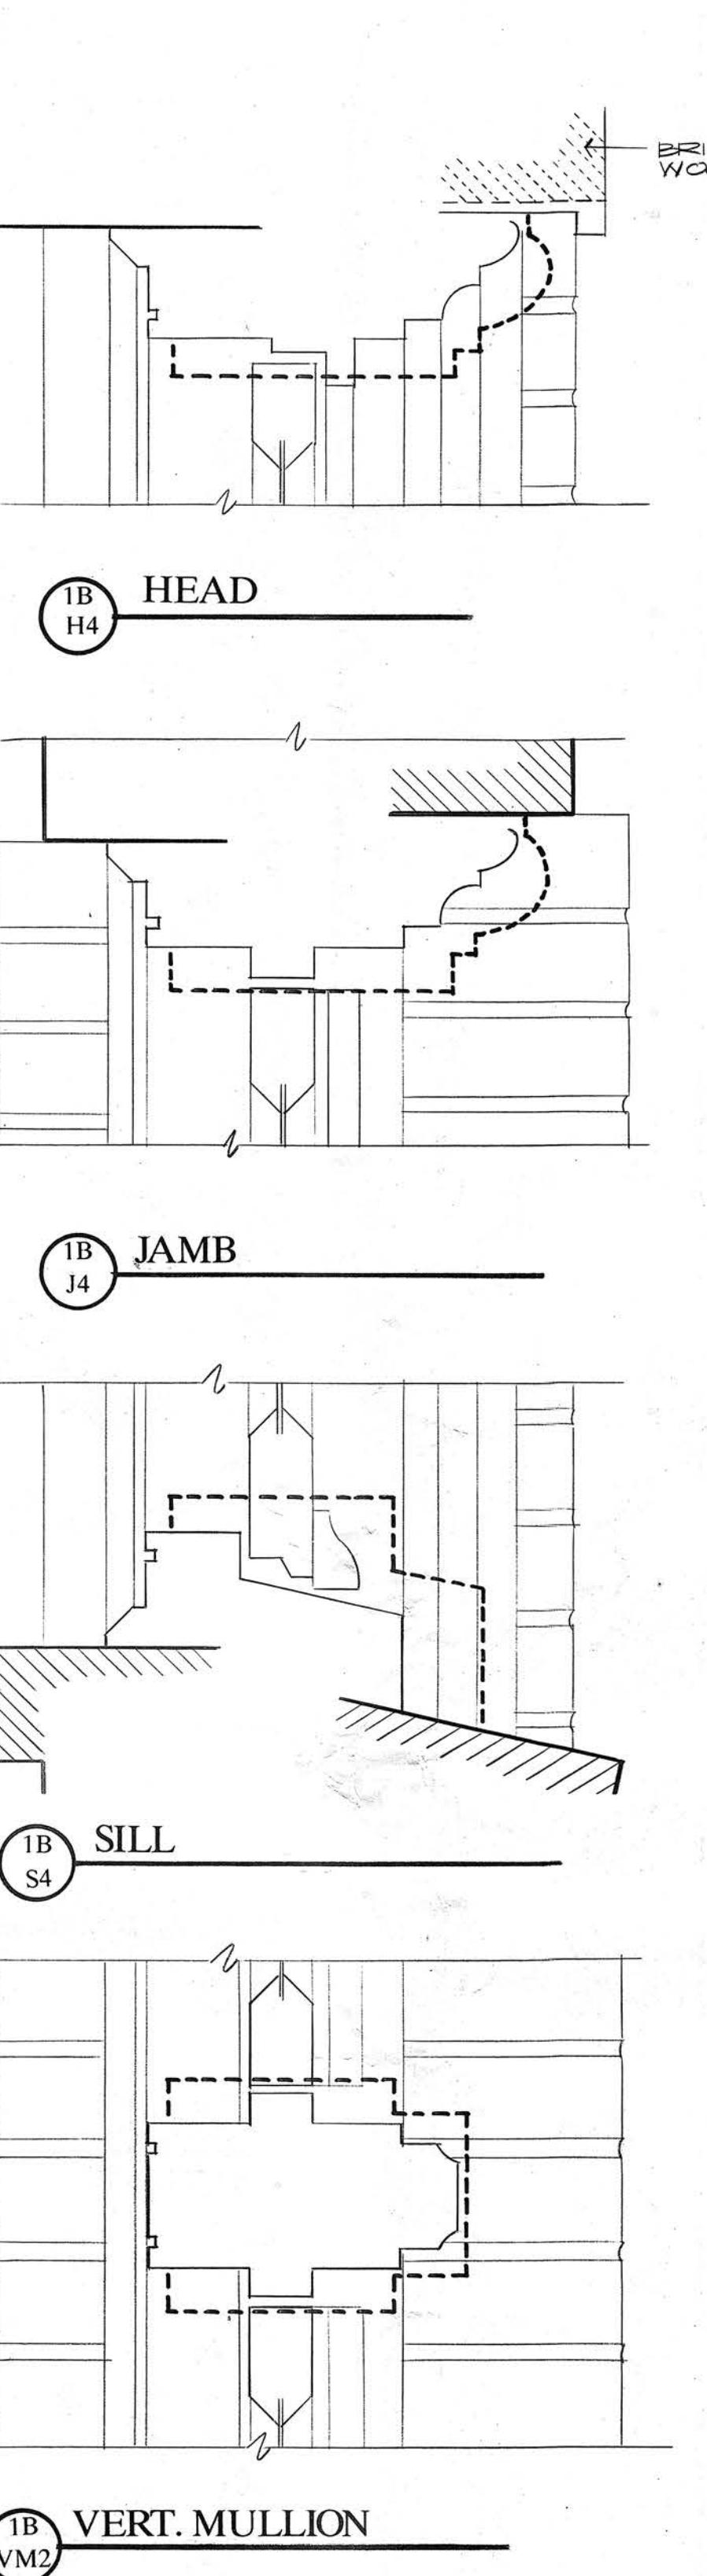
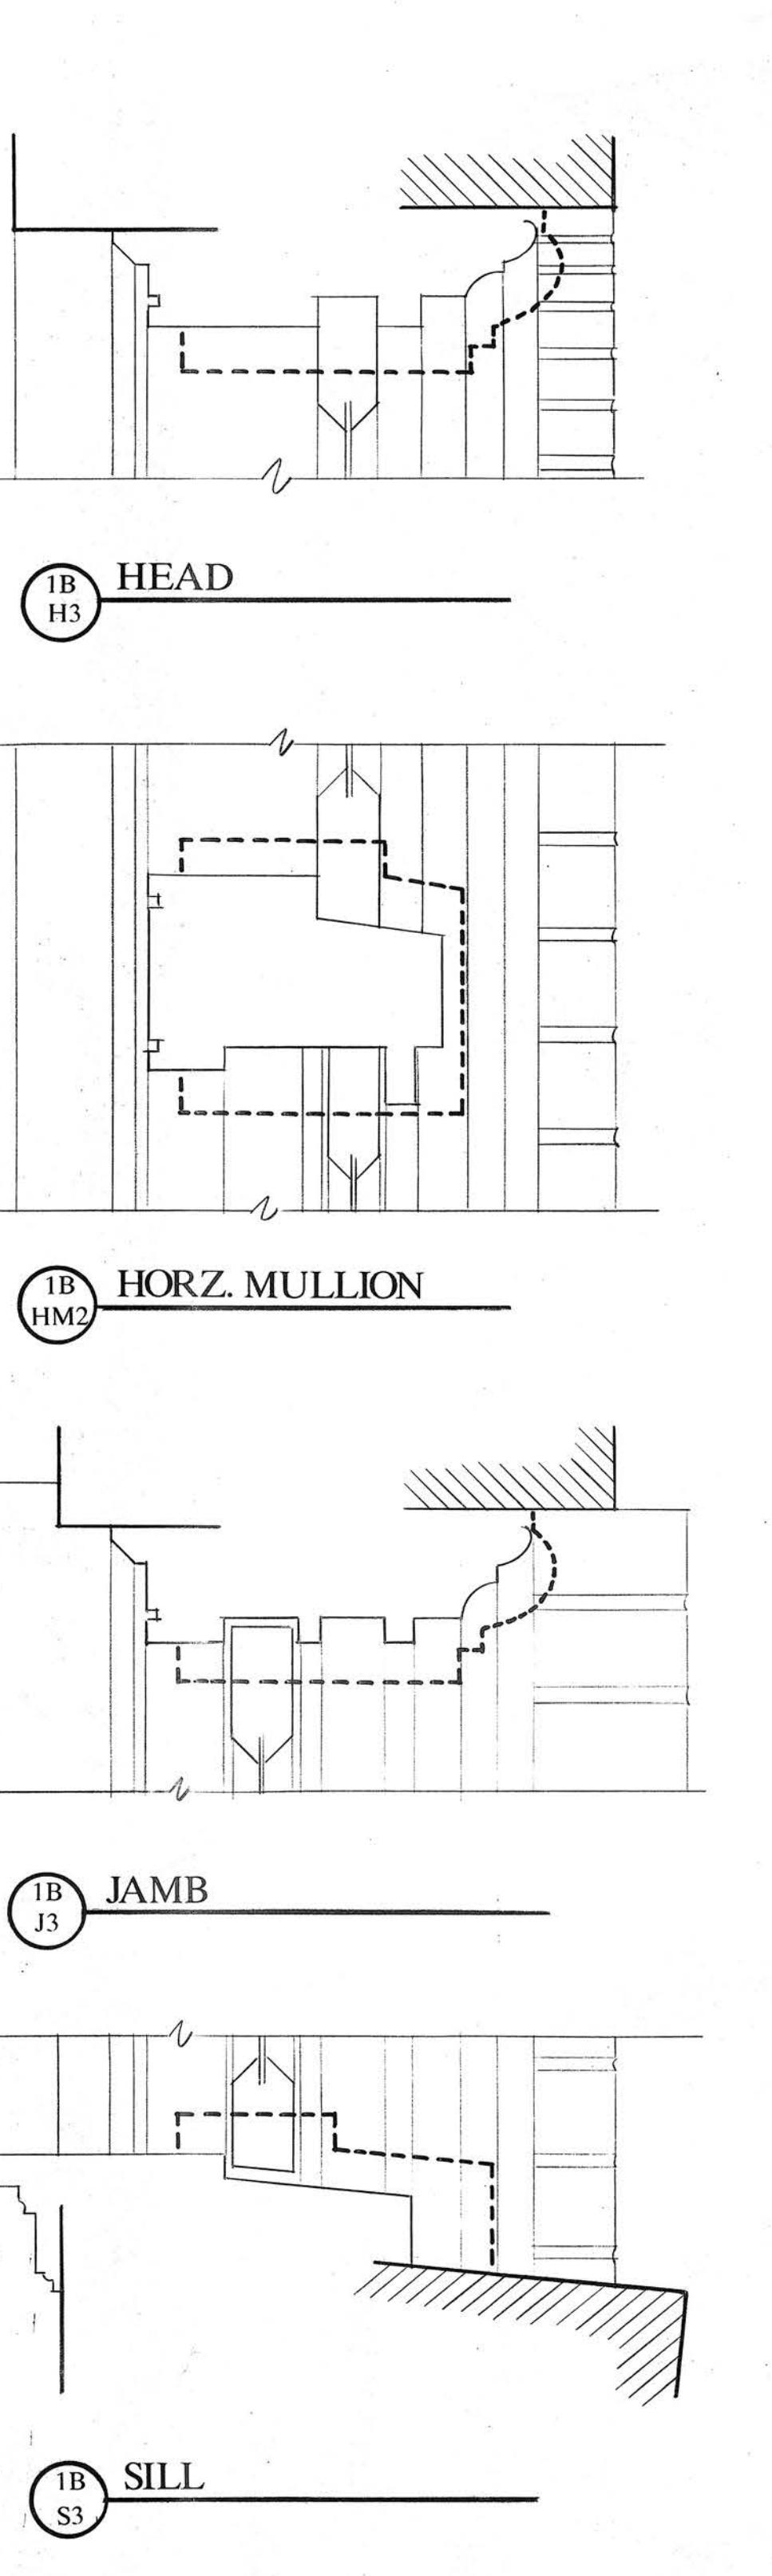
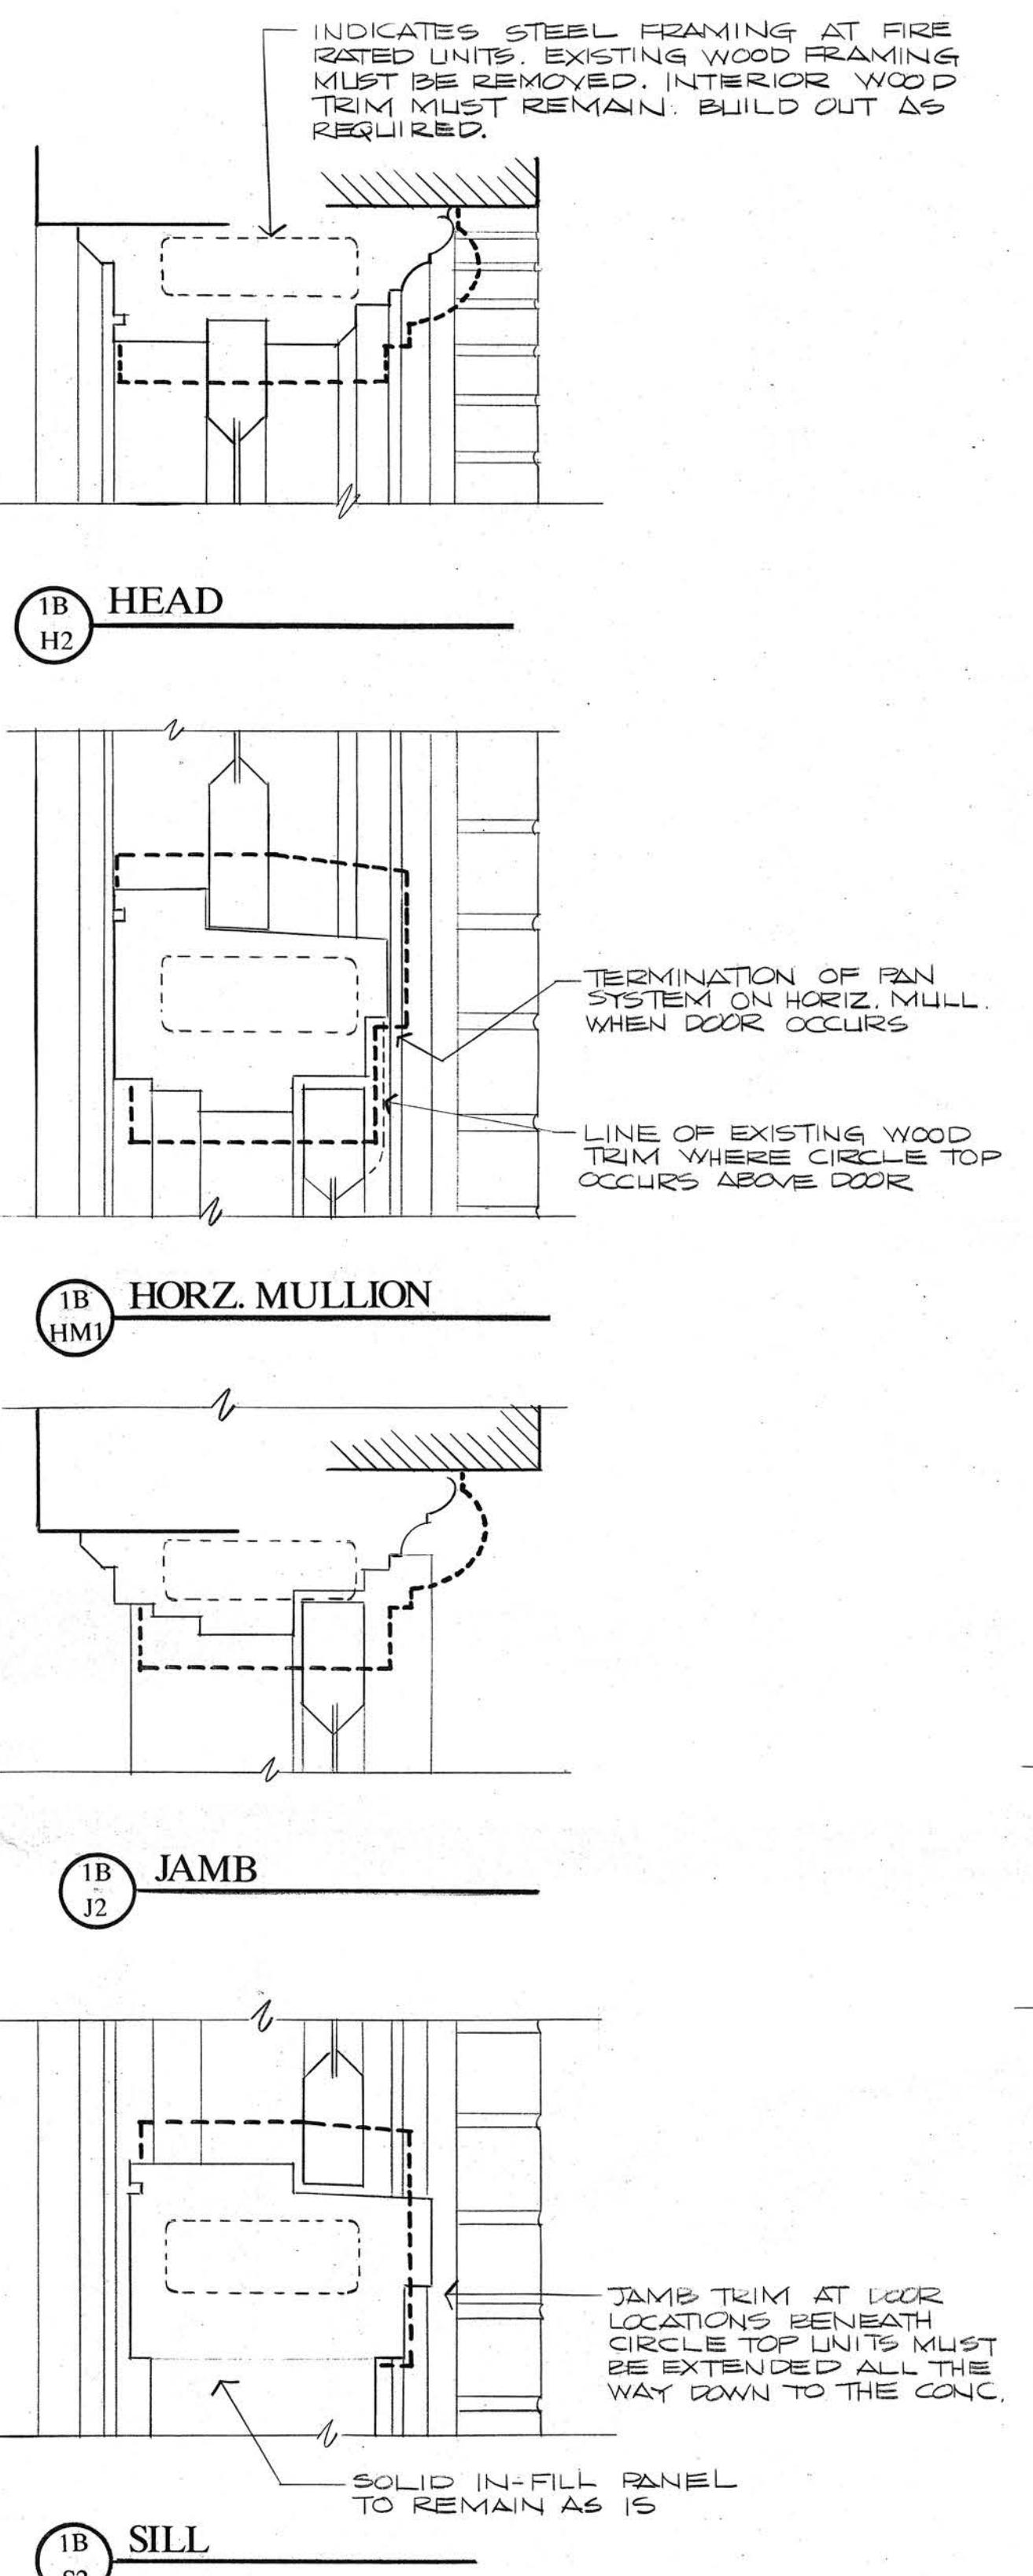
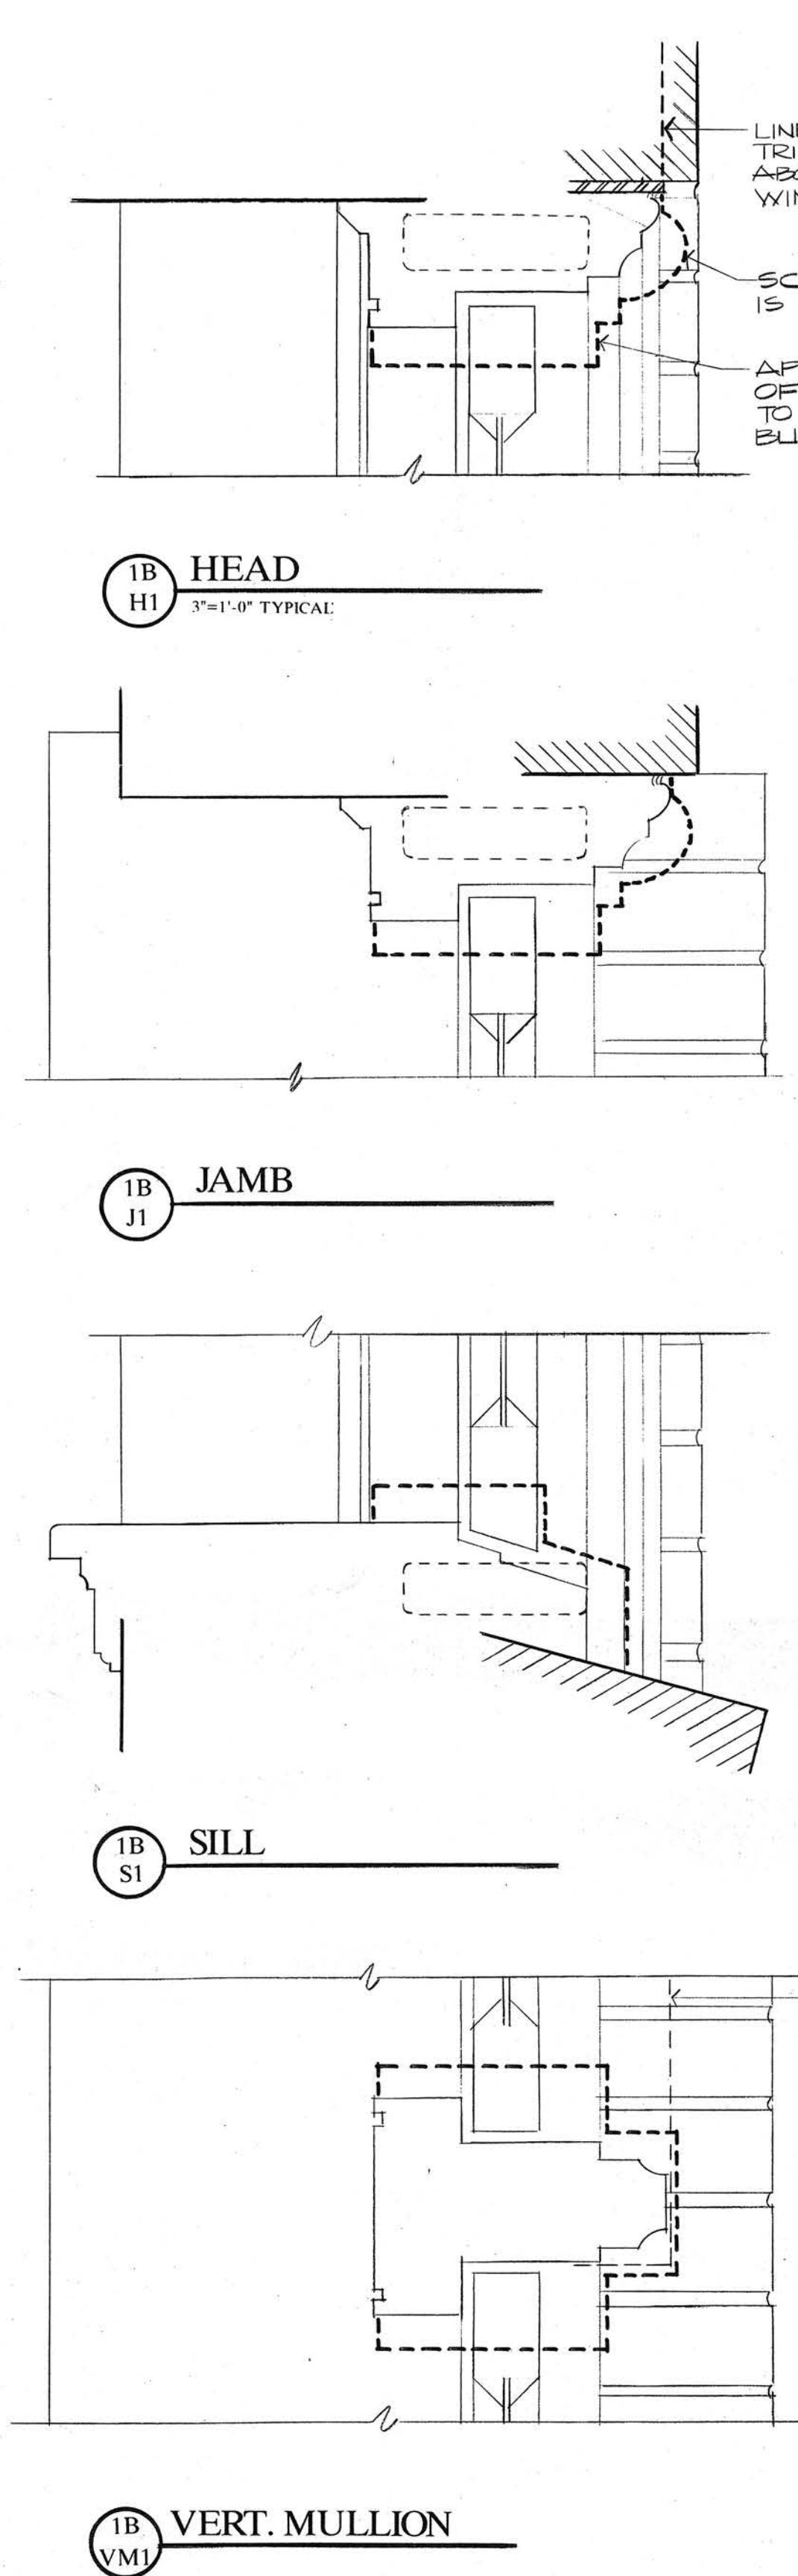


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A3
MAY 22 1992
OF 5

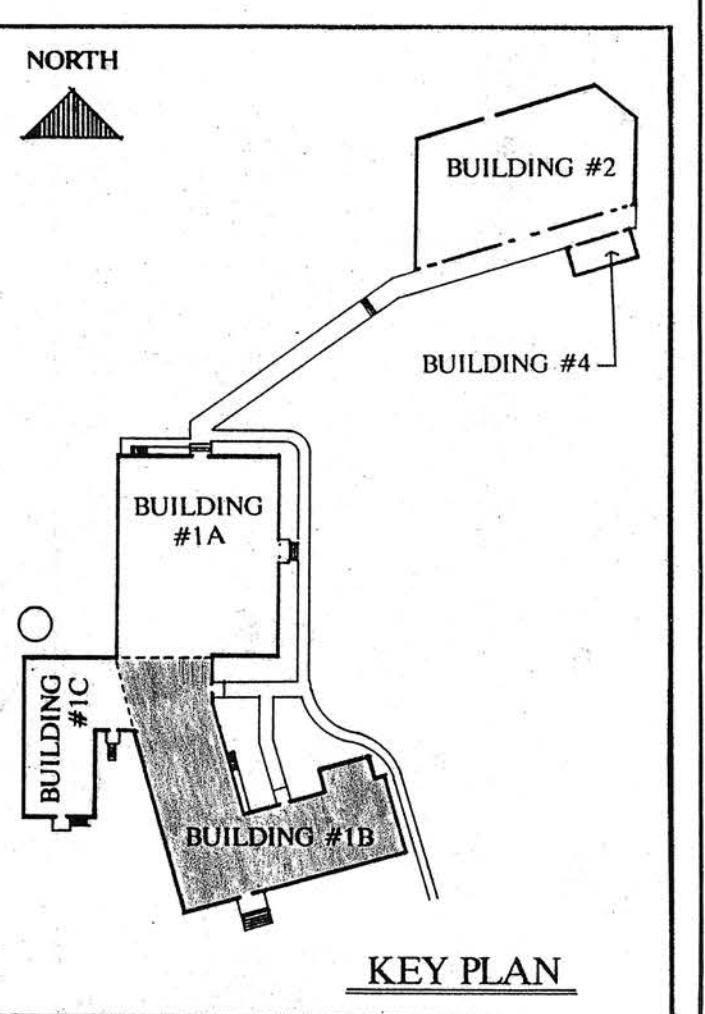

NORTH WARD ELEMENTARY SCHOOL

WINDOW REPLACEMENT

CLEARWATER, FL

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REVISIONS
NO. DATE DESCRIPTION


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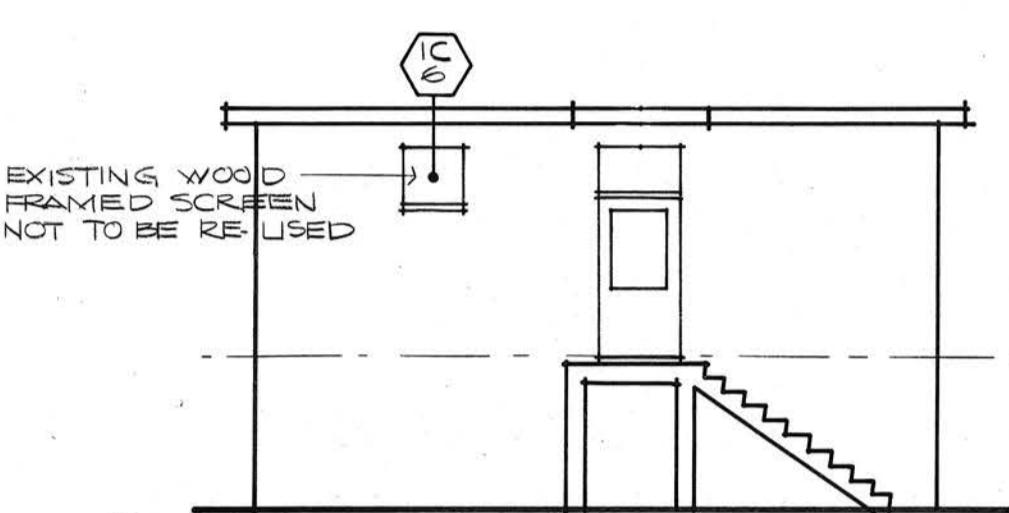
A4
MAY 22 1992

OF 5




ELEVATION A (NORTH)


1/8" = 1'-0" TYPICAL

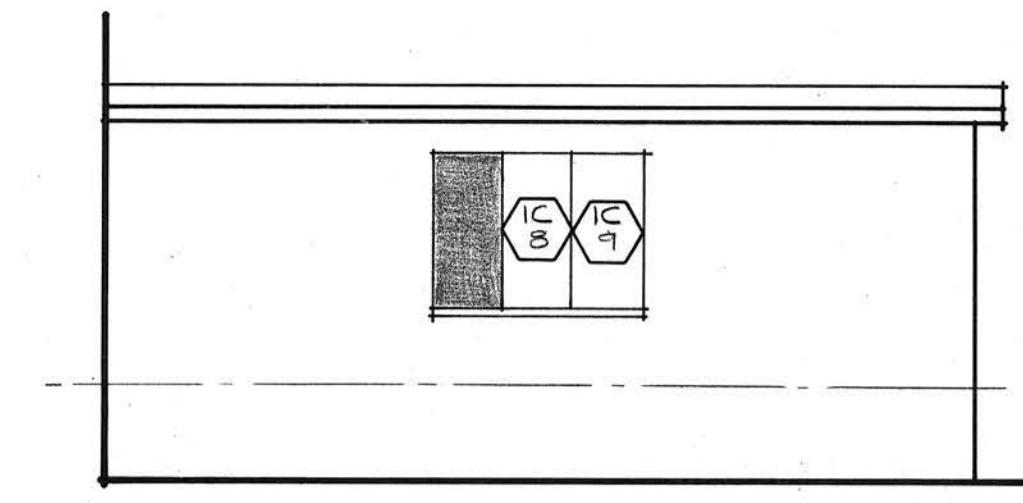

ELEVATION C (SOUTH)

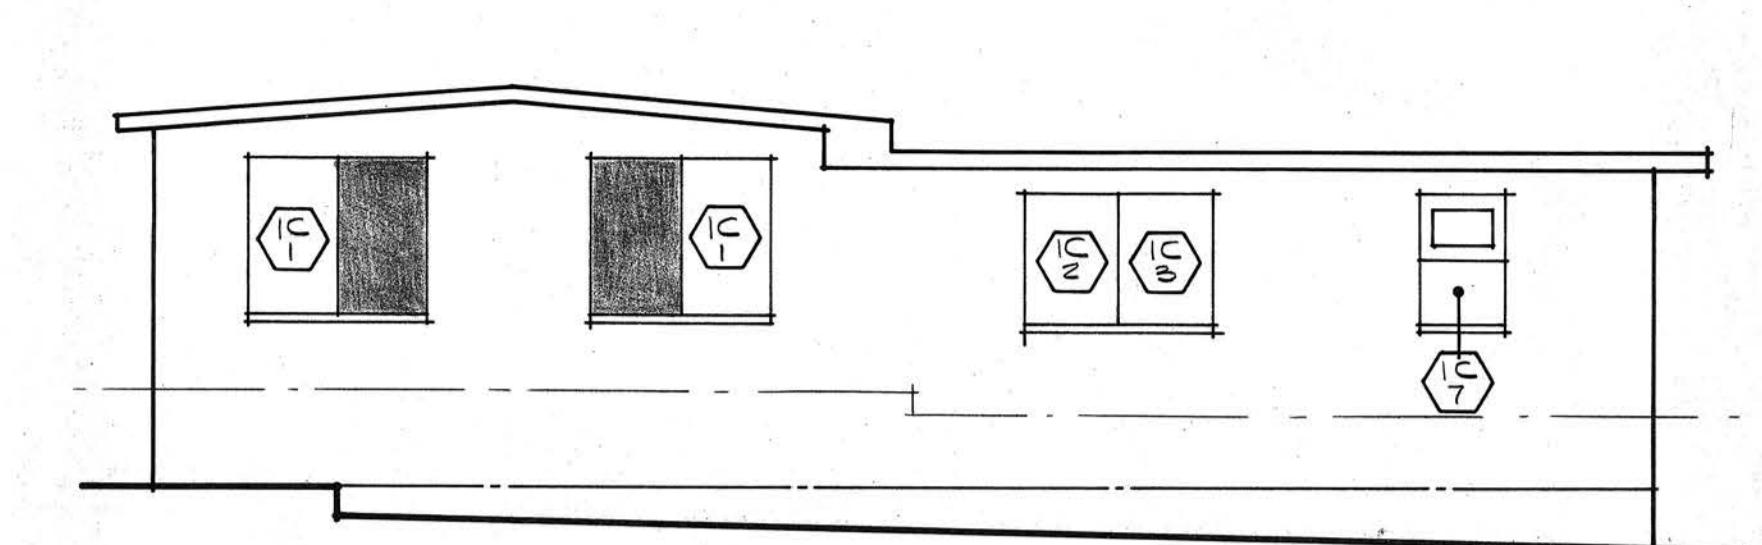


ELEVATION B (WEST)

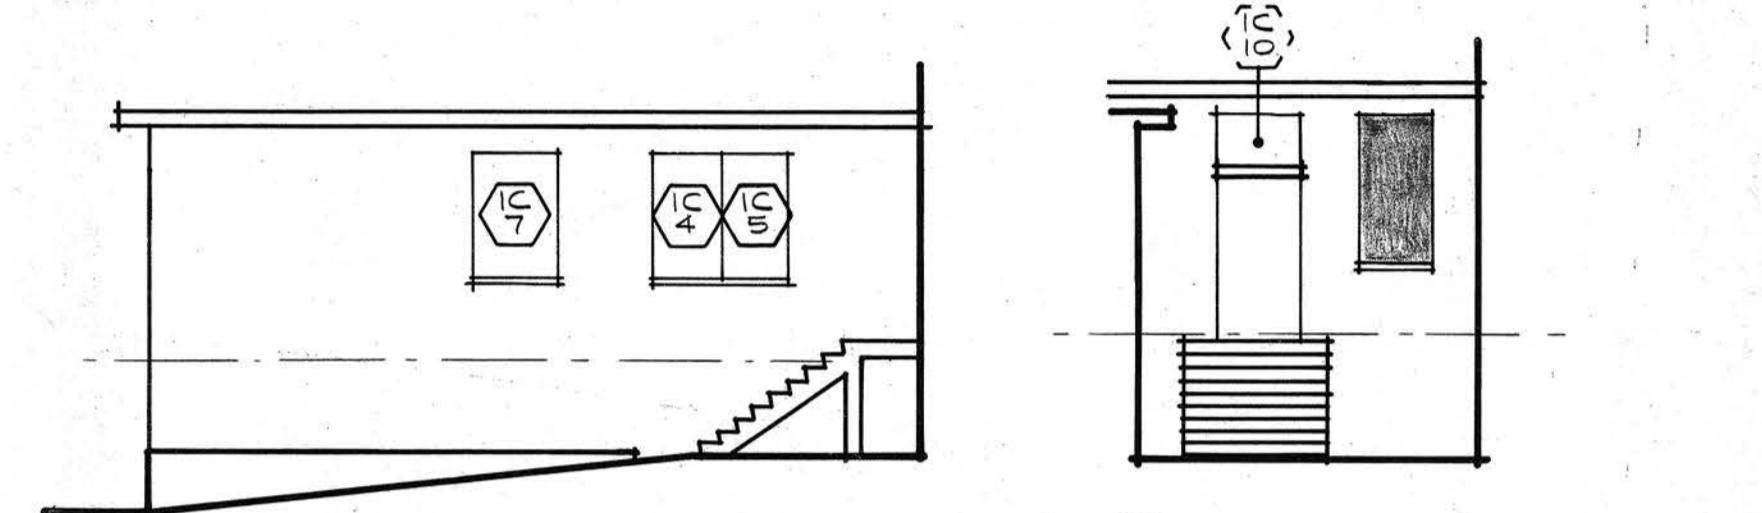

ELEVATION D (EAST)




ELEVATION E

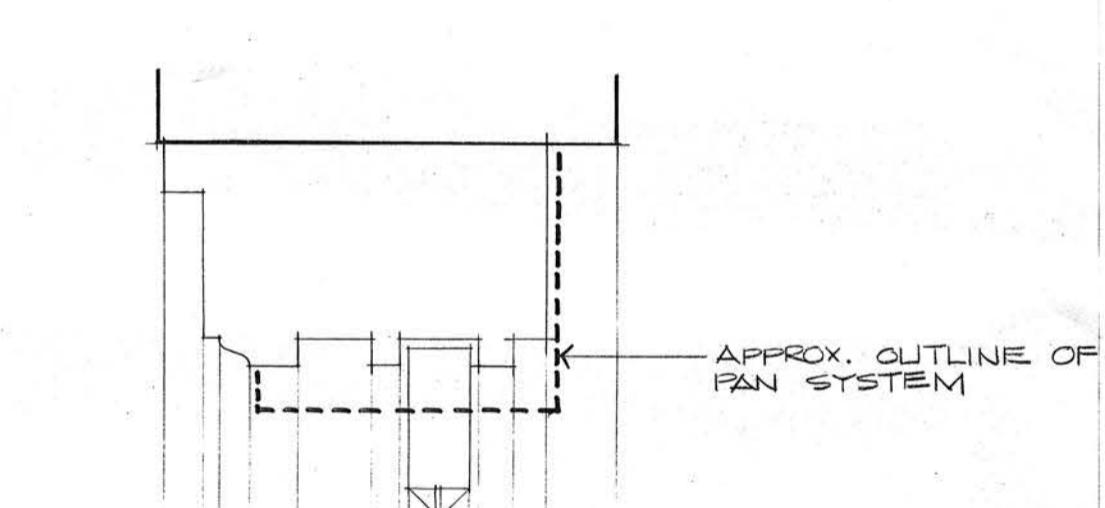


APPROX OUTLINE OF PAN SYSTEM

(1C H1) HEAD/JAMB (similar)

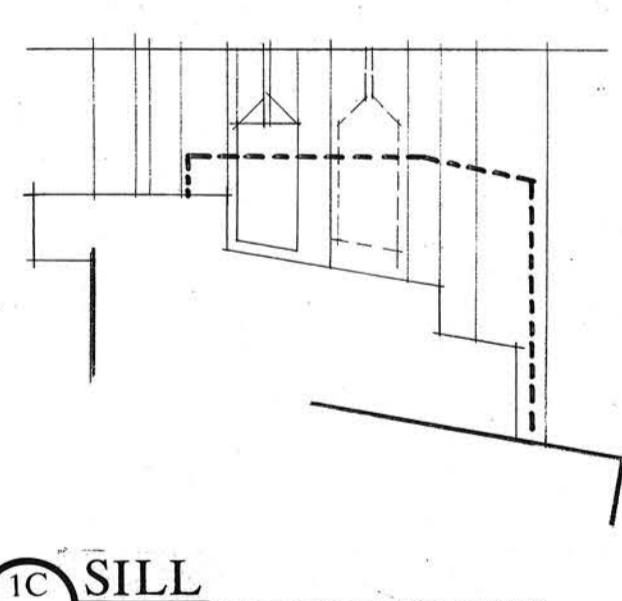


3' = 1'-0" TYPICAL

(1C S1) SILL

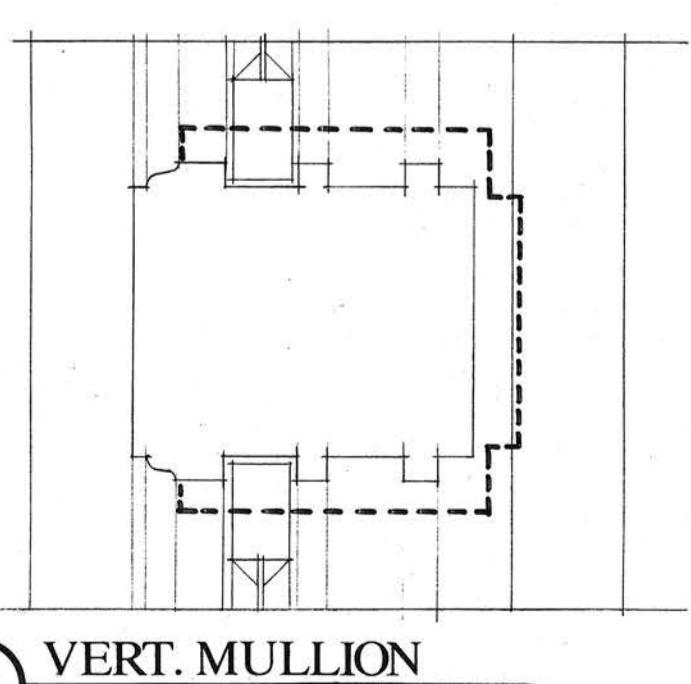


(1C VM1) VERT. MULLION

(1C H2) HEAD/JAMB (similar)

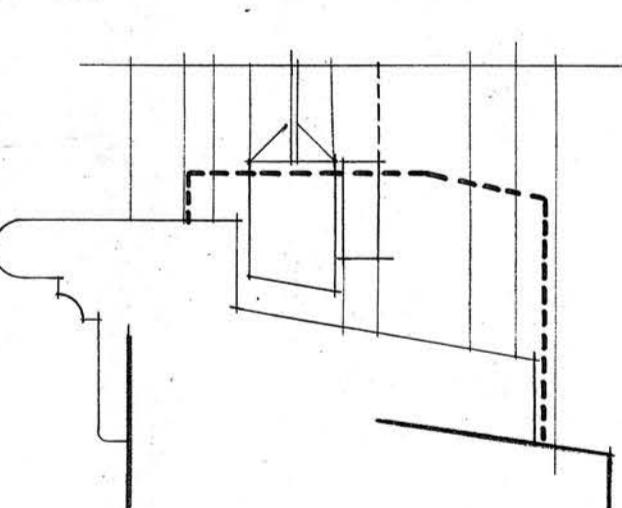


(1C S2) SILL

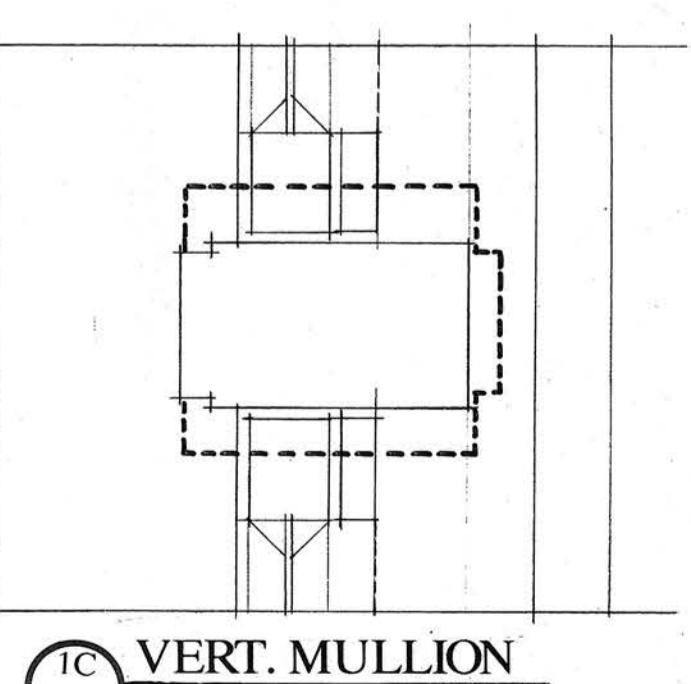


(1C VM2) VERT. MULLION

(1C H3) HEAD

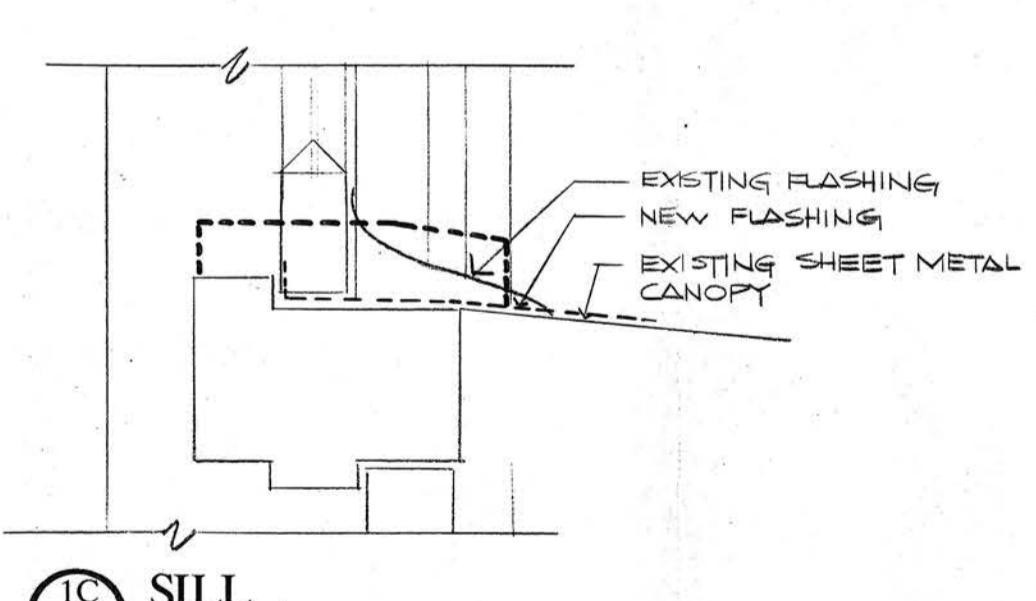

(1C S3) SILL

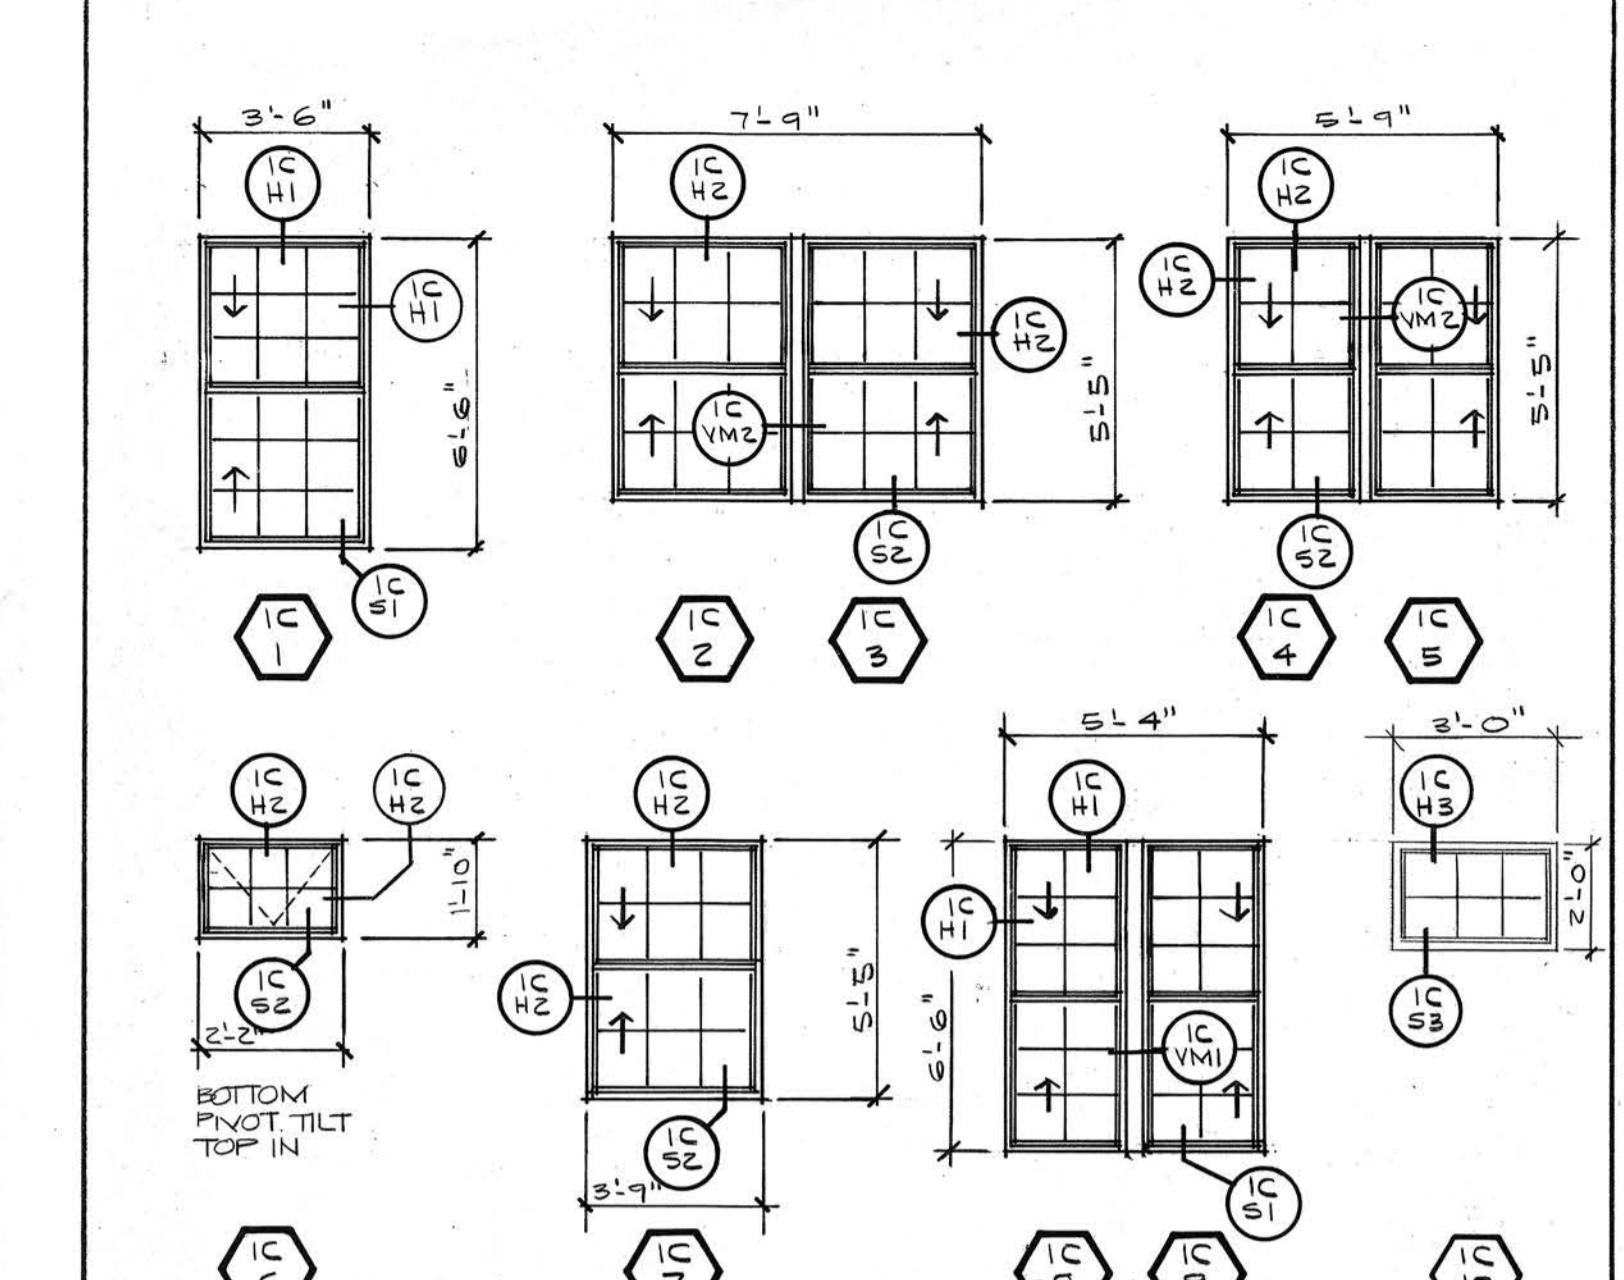

WINDOW TYPES @ BLDG. #1C


1/4" = 1'-0" TYPICAL

(SCREENS REQUIRED FOR ALL OPERABLE SASH)

WINDOW NOTES :


- 1) MANUFACTURER MUST FURNISH DETAILED STRUCTURAL CALCULATIONS AS PER SPECS.
- 2) ALL FINISHED SHILLIPS SHALL BE WHITE SILICONIZED POLYESTER PAINTED ENAMEL AS PER SPECS.
- 3) GLASS PANELS SHALL BE 1/4" THICK, MINIMUM, WITH MEDIUM BRONZE TINT. (SAMPLES READ).
- 4) ALL EXPOSED EDGES MUST BE SMOOTH AND FINISHED PREVENTING ANY POTENTIAL FOR INJURY.
- 5) ALL DIMENSIONS AND DETAILS SHOWN ARE APPROXIMATE. CONTRACTOR MUST PRECISELY FIELD MEASURE AND DRAWINGS AND EACH CONDITION.
- 6) PANNING EXTRUSIONS SHALL HAVE MIN. WALL THICKNESS OF .08 INCHES. PROFILE PROPOSALS SHOULD BE SUBMITTED WITH BID.

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FIRST FLOOR PLAN

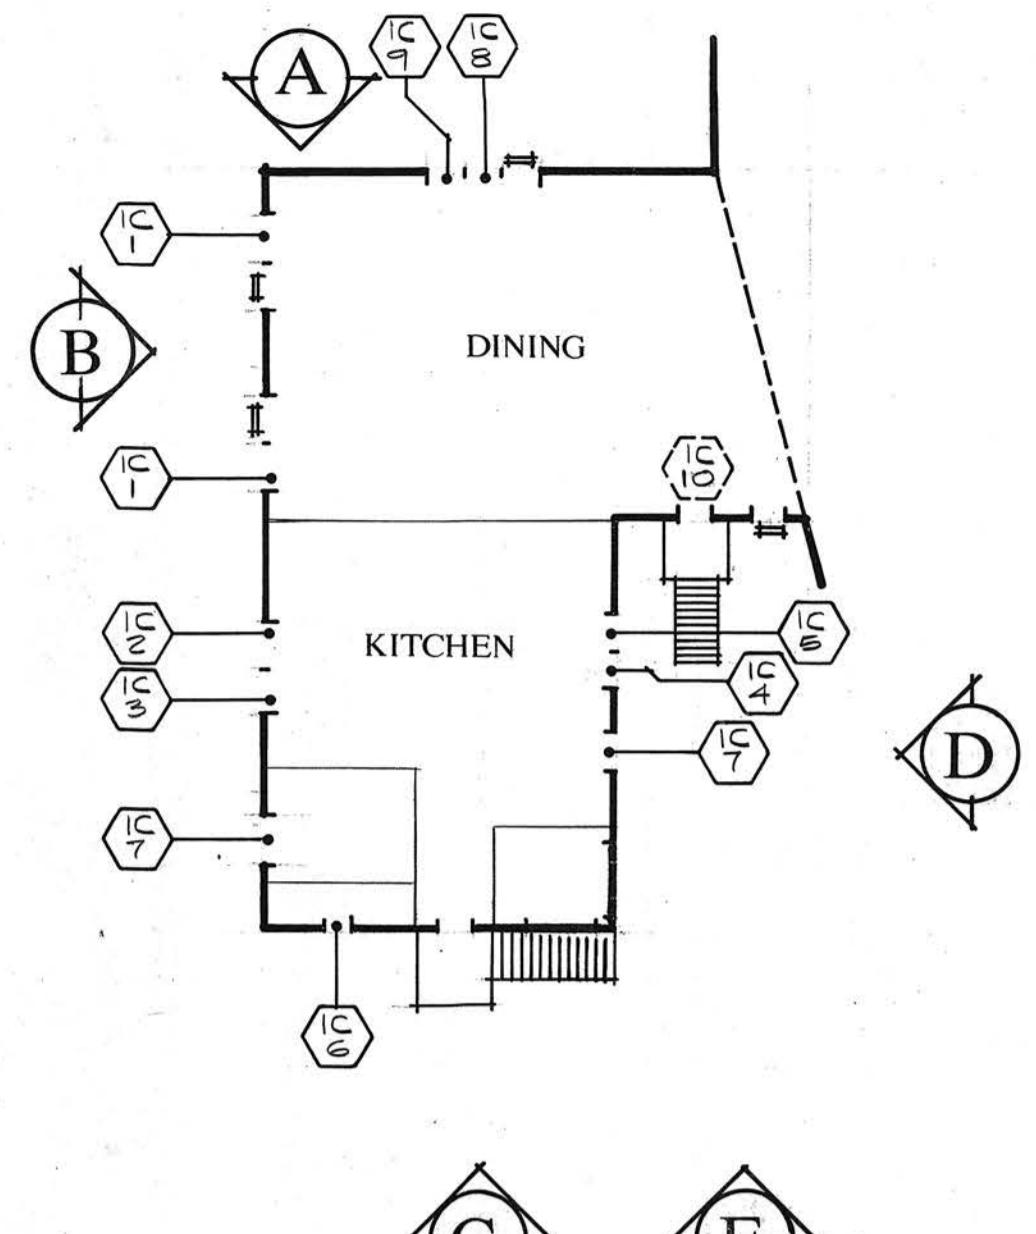1/16" = 1'-0" TYPICAL



GENERAL NOTES :
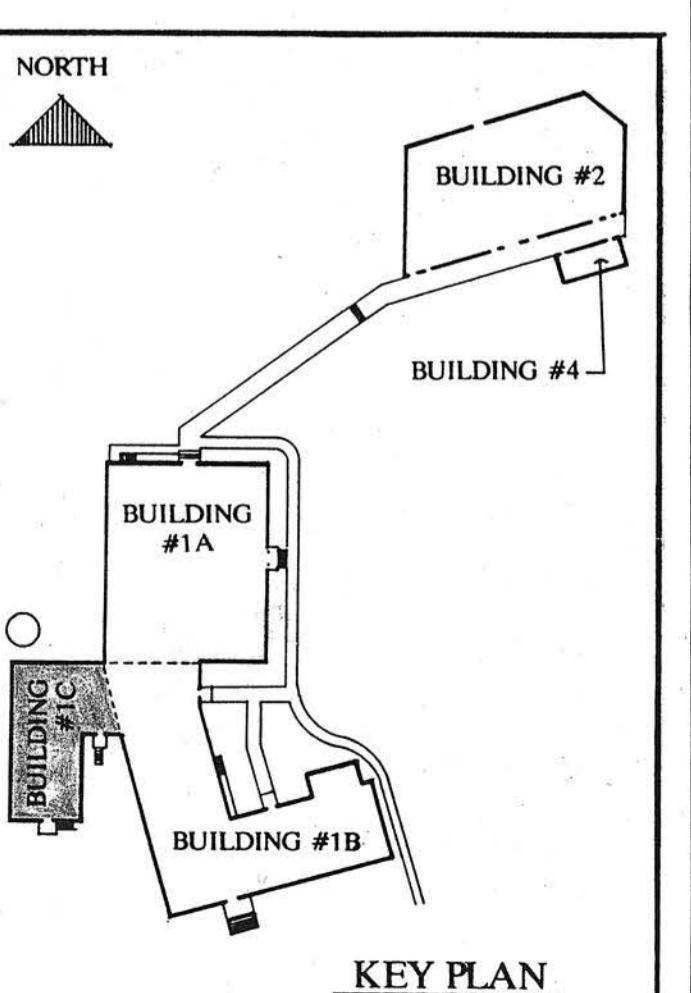
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NORTH WARD ELEMENTARY SCHOOL

WINDOW REPLACEMENT


900 N. FT. HARRISON

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REVISIONS


NO. DATE DESCRIPTION

DRAWN BY: PRL
DATE: 5/22/92
REVIEWED BY:
DATE:
PROJECT NO.
994
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MAY 22 1992
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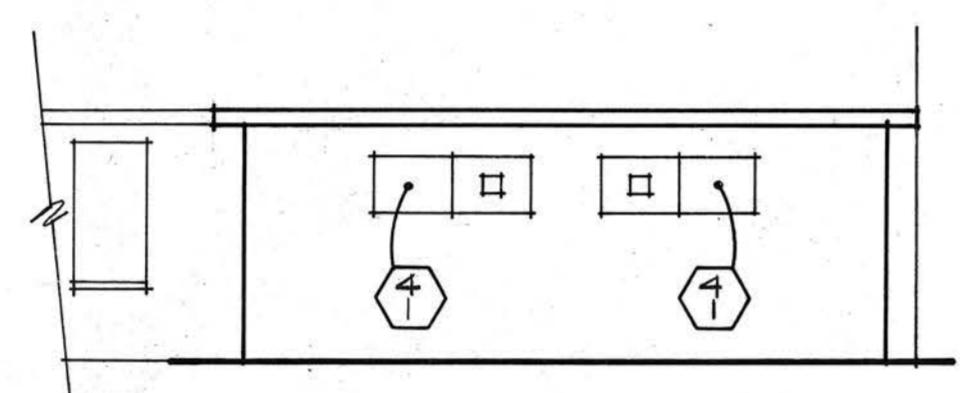


ELEVATION A (NORTH)

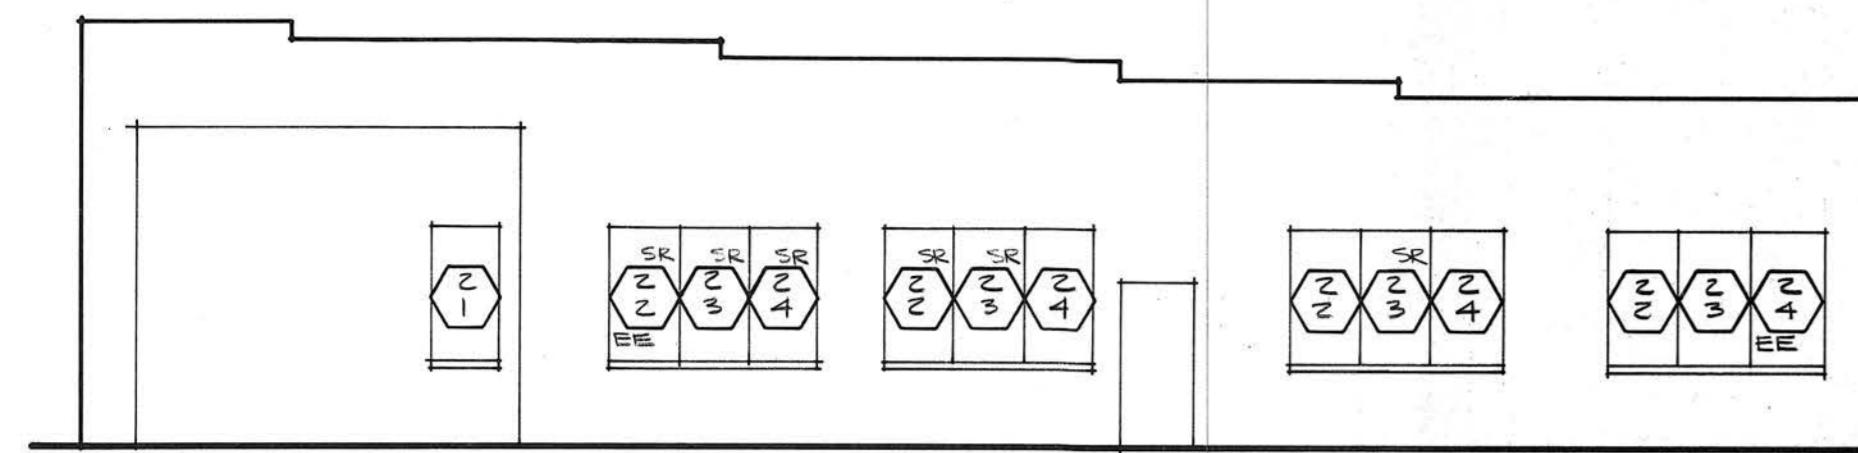
1/8" = 1'-0" TYPICAL

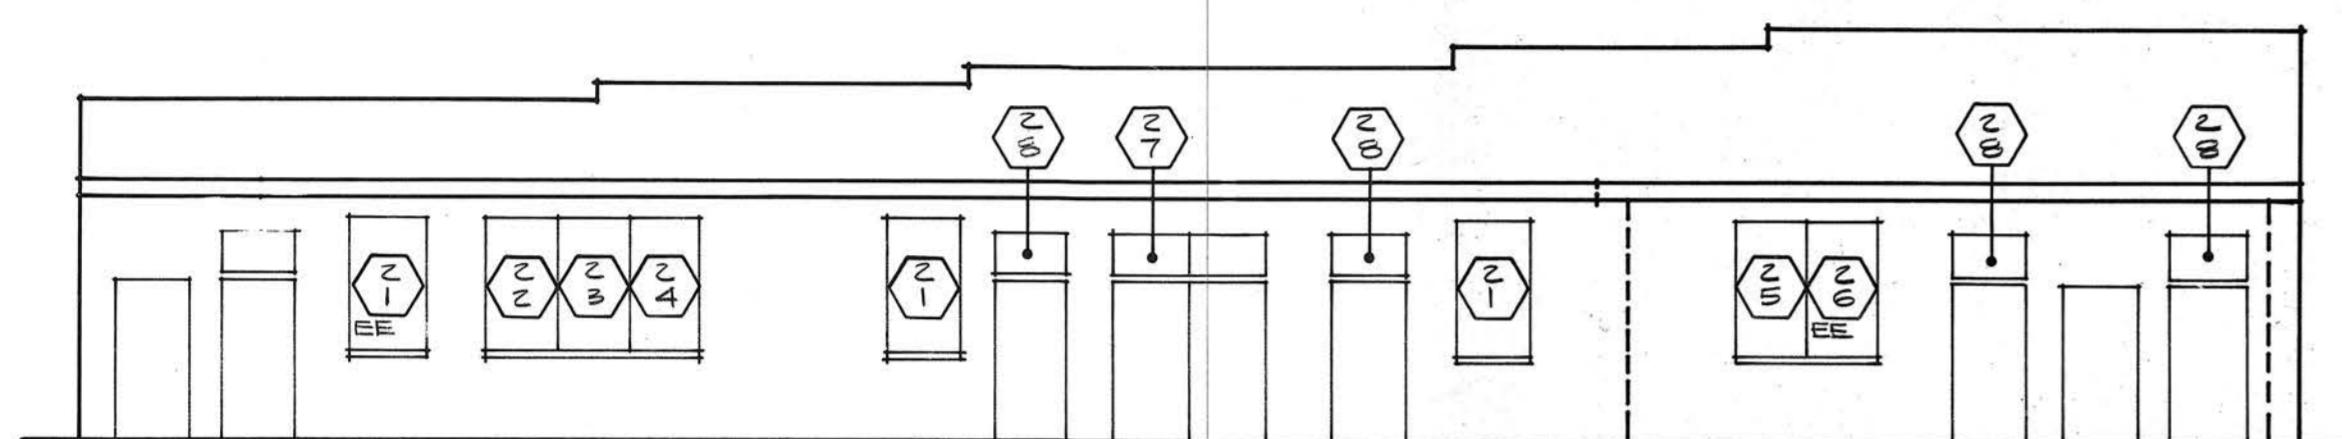


ELEVATION B (SOUTH)




ELEVATION C (SOUTH)

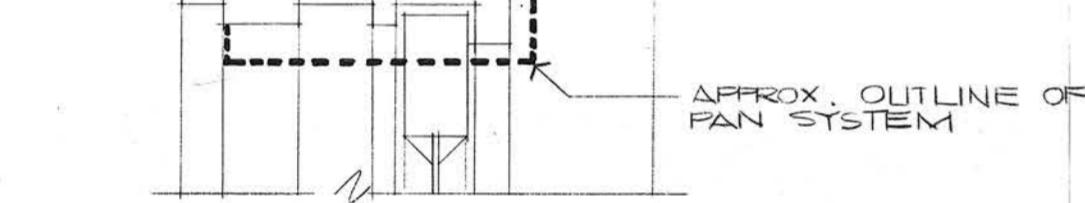


2 HEAD
H1 3" = 1'-0" TYPICAL

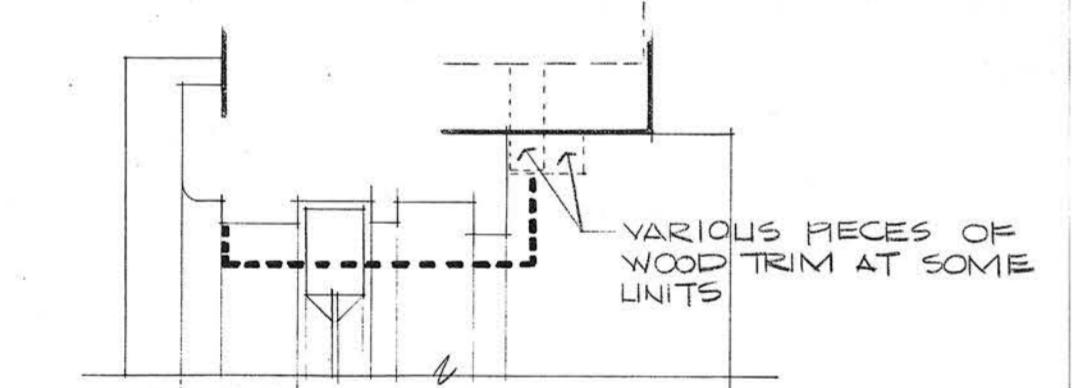


2 JAMB
H1

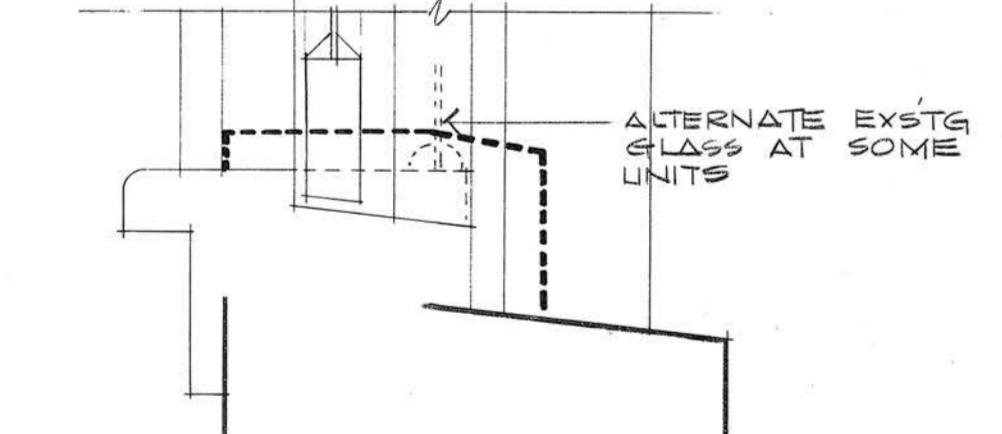

2 SILL
S1

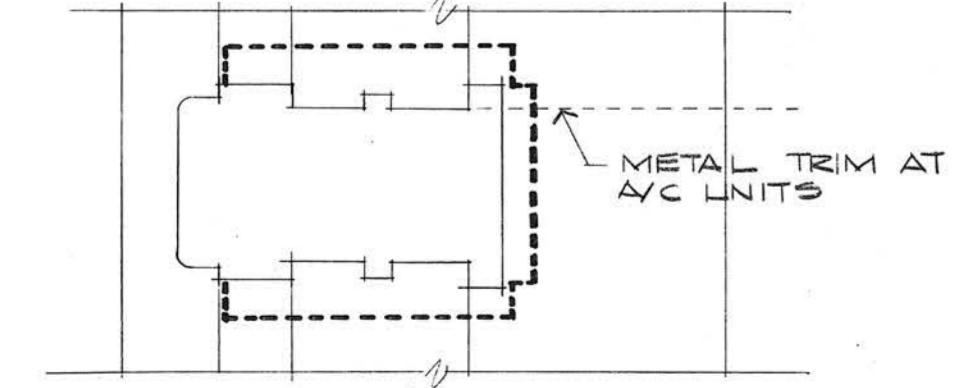

2 VERT. MULLION
VM1

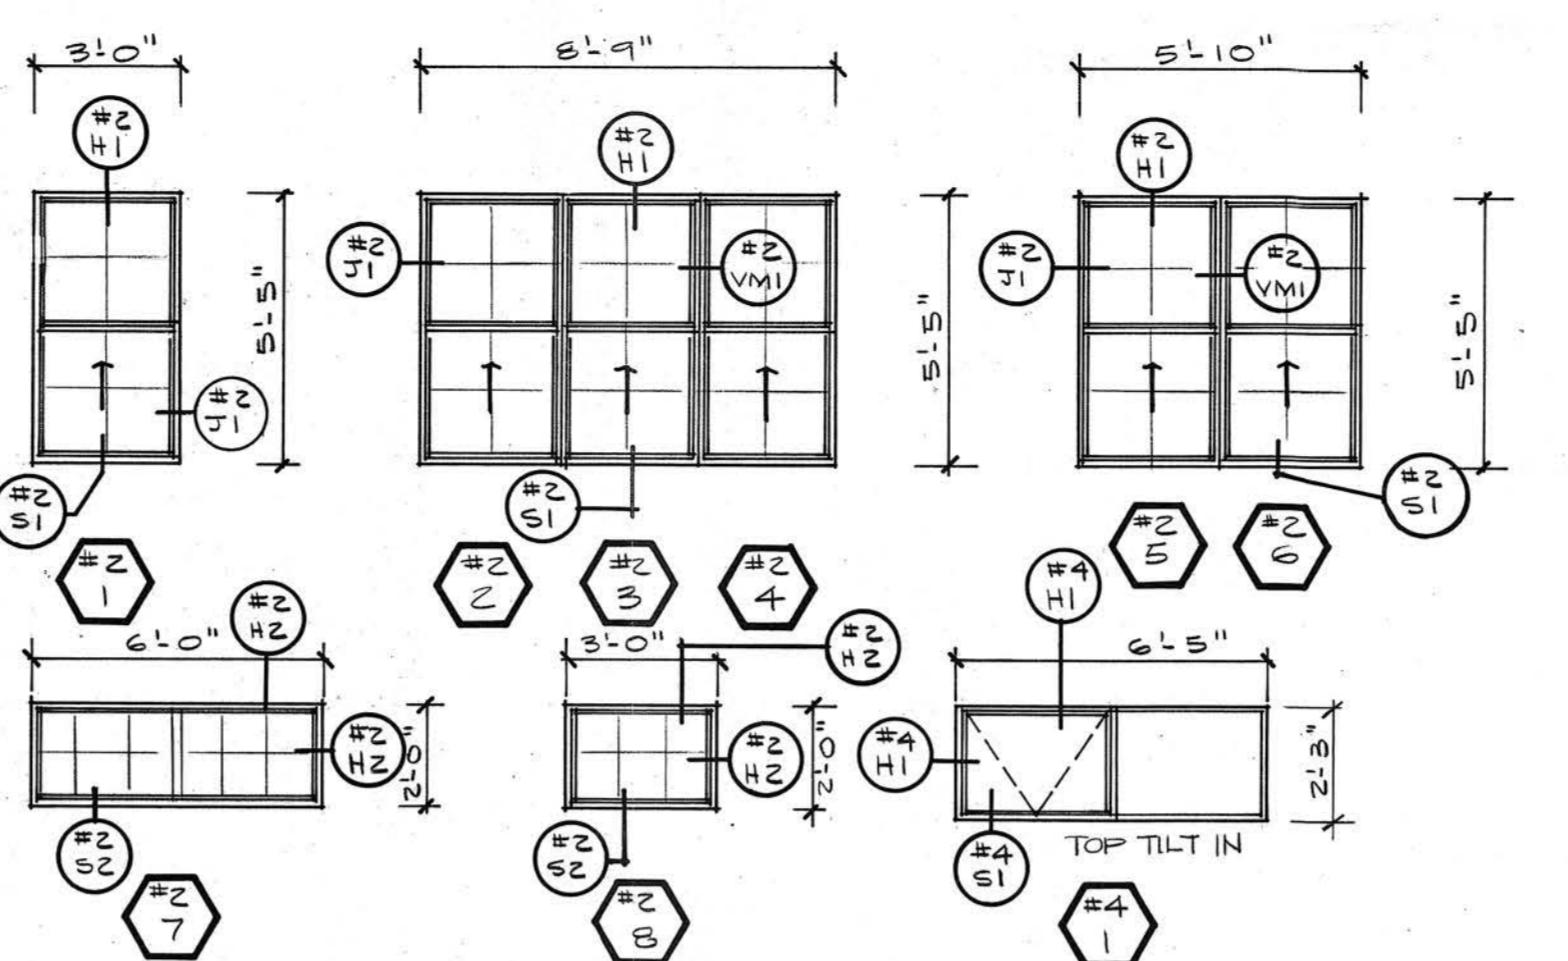


WINDOW TYPES @ BLDG. #2 & #4

1/4" = 1'-0"


WINDOW NOTES:
1) MANUFACTURER MUST FURNISH DETAILED STRUCTURAL CALCULATIONS AS PER SPECS.
2) ALL GLASS SHALL BE WHITE SILICONEIZED POLYESTER LAMINATED AS PER SPECS.
3) GLASS SHALL BE $\frac{1}{4}$ " THICK, MINIMUM WITH MEDIUM BRONZE TINT (SAMPLES #2 & 3).
4) MULLIONS SHALL BE EXTRUDED ALUM. GLAZED-IN ON THE EXTERIOR GLASS SURFACE.
5) GLASS SHATTER RESISTANT, PREVENTING NO POTENTIAL FOR INJURY.
6) ALL DIMENSIONS AND DETAILS SHOWN ARE APPROXIMATE. CONTRACTOR MUST PRECISELY FIELD MEASURE EACH OPENING AND EACH CONDITION.
7) FRAMING EXTRUSIONS SHALL HAVE MIN. WALL THICKNESS OF .08 INCHES. PROFILE PROPOSALS SHOULD BE SUBMITTED WITH BID.

EE EXIT: EXISTING EXIT WITH MIN. CLEAR OPENING 28 INCHES WIDE BY 24 INCHES HIGH, NOT LESS THAN 4' 0" FT. IN CLEARANCE FROM GROUND OUT TO DOOR. THIS OPENING SHALL NOT BE OVER 4'-0" ABOVE THE FLOOR. BOTTOM OF THIS OPENING SHALL NOT BE MORE THAN 4' 0" IN. ABOVE THE FLOOR. EACH SUCH OPENING SHALL BE CLEARLY MARKED EMERGENCY EXIT. FR DESIGNATES FIRE RATED ASSEMBLY (1 HR. DUE TO PROXIMITY TO FIRE ESCAPE). SR INDICATES SILL ROT AT EXISTING SILL (MUST BE REPLACED WITH PT.).

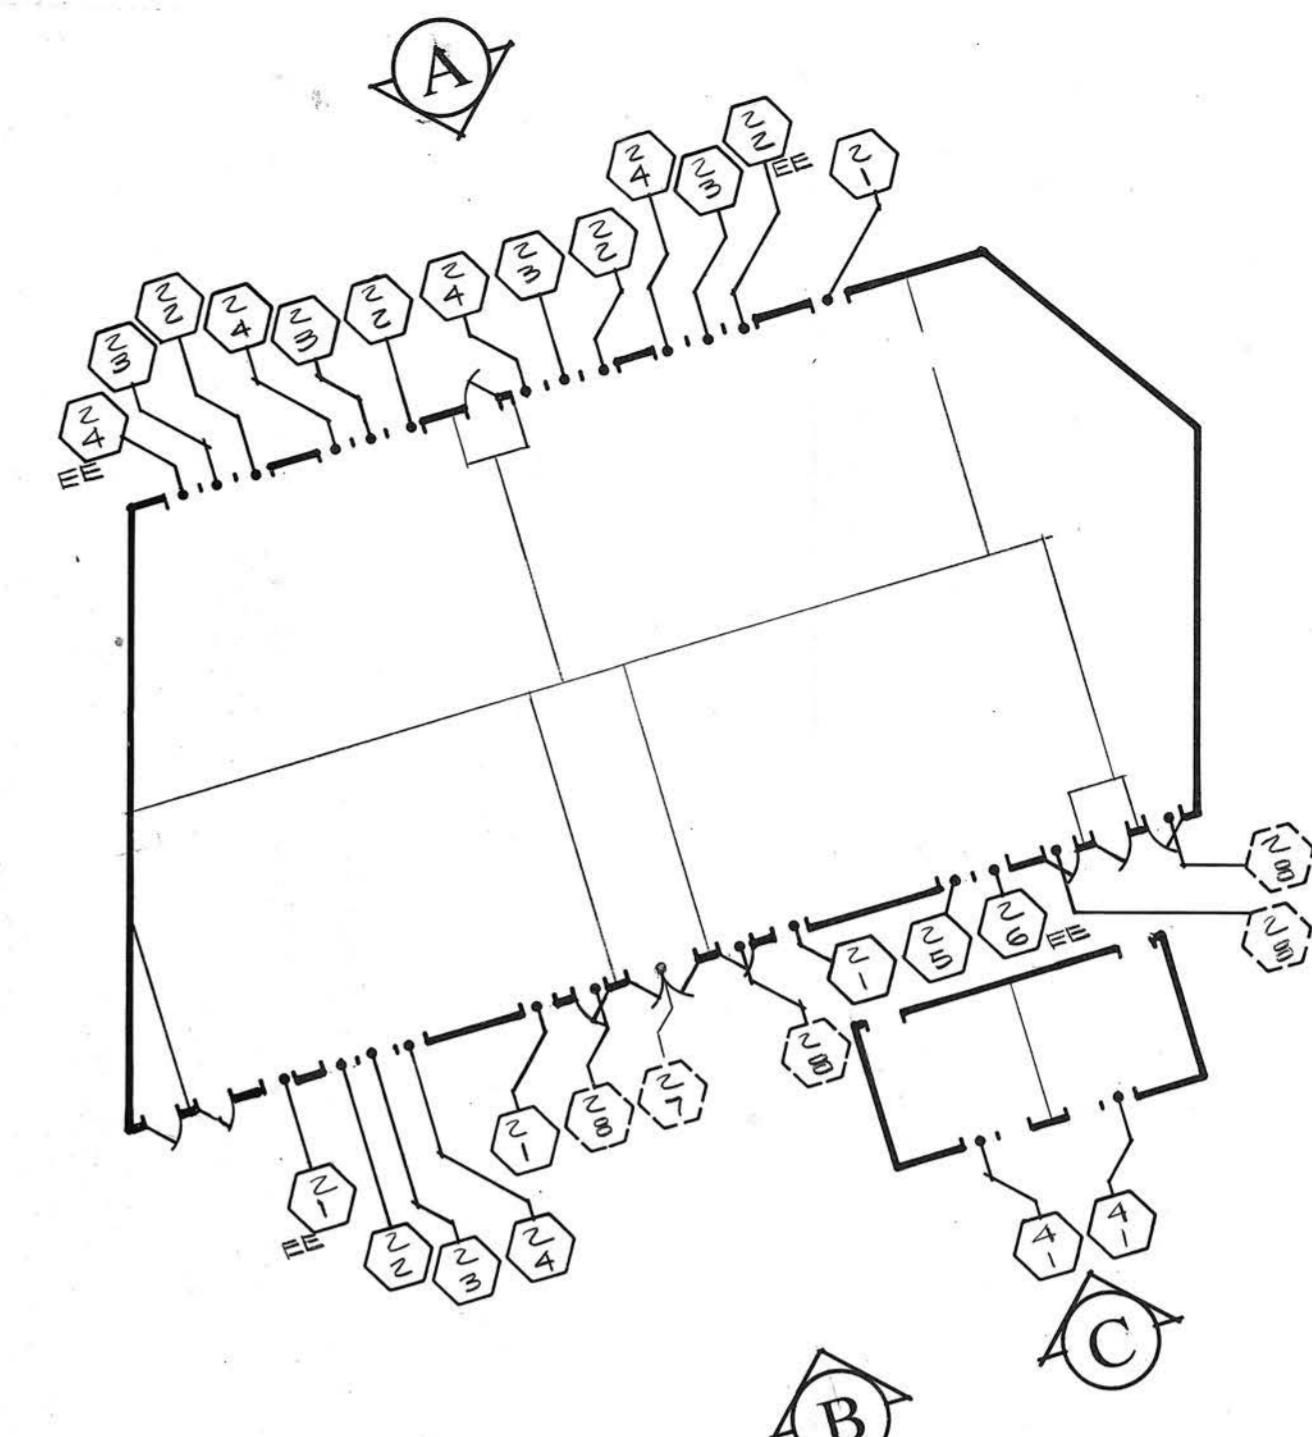


FIRST FLOOR PLAN


1/16" = 1'-0" TYPICAL

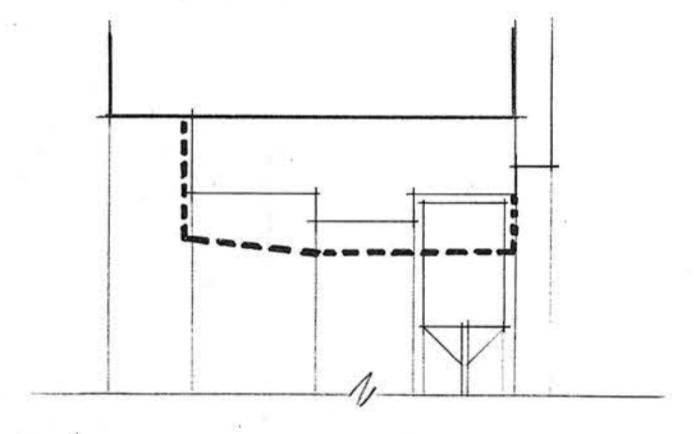

4 HEAD/JAMB (similar)
H1

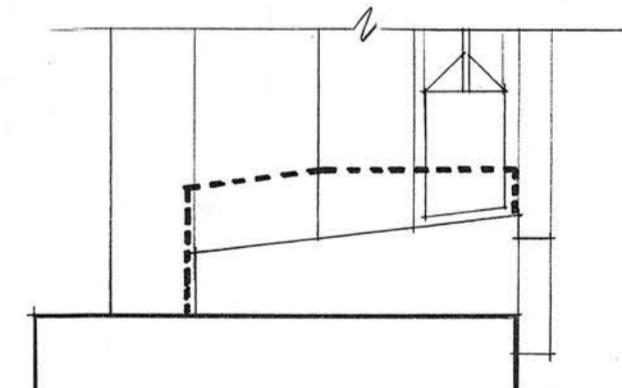

4 SILL
S1

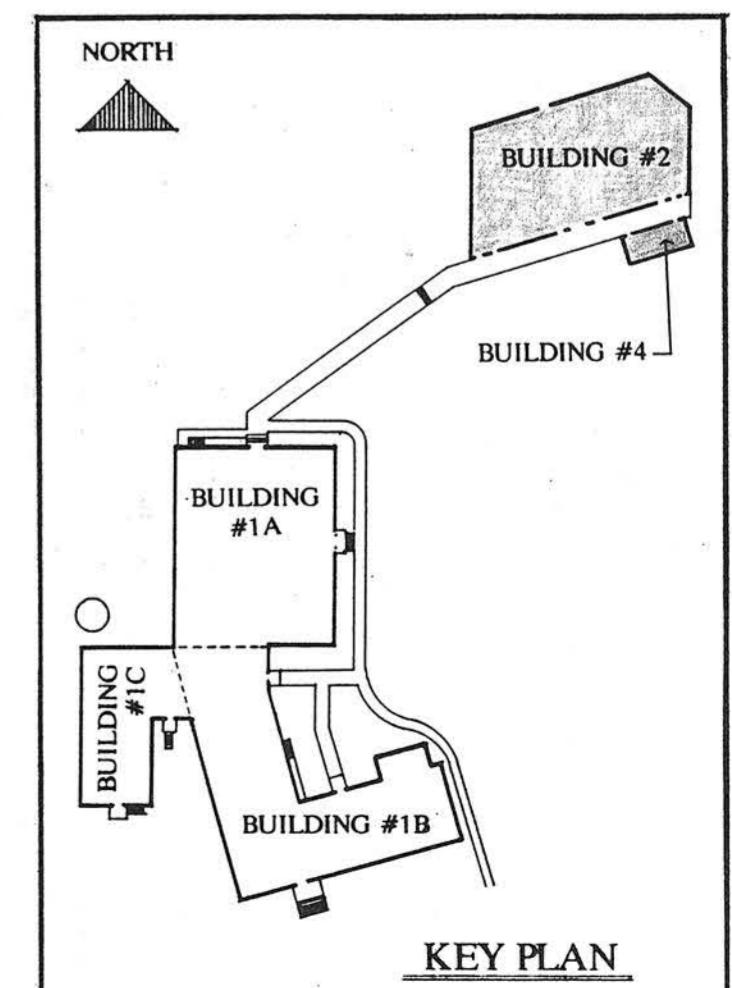

GENERAL NOTES:

- 1) CONTRACTOR, BY SUBMISSION OF HIS BID, ATTESTS THAT HE HAS PERFORMED HIS SITE INVESTIGATION AND IS THOROUGHLY FAMILIAR WITH THE SCOPE OF WORK AND ANY CONSTRAINTS THAT MAY EXIST.
- 2) CONTRACTOR SHALL SUBMIT A LIST OF AT LEAST 3 PREVIOUS PROJECTS OF THIS TYPE FOR WHICH HE WAS THE RESPONSIBLE INSTALLER.
- 3) CONTRACTOR SHALL BE SOLELY RESPONSIBLE FOR REMOVING, PROTECTING AND RE-INSTALLING EXISTING ITEMS SUCH AS EXHAUST VENTS, DOLVERS, CABLES, WIRING, THRU SASH AC UNITS (WINDOW UNITS, NOT THE LARGE BARD UNITS), EXIT SIGNS, PIPE HANGERS, FLASHINGS, PROTECTIVE SCREENS, BAR GUARDS, HAND RAILS, WINDOW COVERINGS, ETC., THAT MAY BE ASSOCIATED WITH THIS WINDOW REPLACEMENT PROJECT.
- 4) CONTRACTOR SHALL BE RESPONSIBLE FOR PROTECTING EXISTING WALLS, FLOORS, TRIM, FURNISHINGS, EQUIPMENT, FINISHES, ETC. AND SHALL ACCEPT THE FINANCIAL RESPONSIBILITY FOR ANY DAMAGE THAT HE AND THOSE IN HIS EMPLOY MAY CREATE.
- 5) CONTRACTOR SHALL CO-ORDINATE ALL ASPECTS OF THE WORK WITH THE ARCHITECT AND THE ADMINISTRATIVE PERSONNEL OF THE SCHOOL, IN ORDER TO MINIMIZE DISRUPTION OF ANY ONGOING SCHOOL ACTIVITIES.
- 6) TEAR OUT DEBRIS MUST REMAIN ON THE EXTERIOR OF THE BUILDING AND NOT BE TRANSPORTED THROUGH THE INTERIOR SPACES OF THE SCHOOL.
- 7) CONTRACTOR SHALL NOT PERMIT ANY UNSECURED OVERNIGHT OPENINGS TO COOLER.
- 8) ALL REPLACEMENT WINDOW COMPONENTS SHALL BE OF A SINGLE MANUFACTURER. (EXCEPT FIRE RATED COMPONENTS).