




1. CONTRACTOR SHALL RESTORE SIDEWALK AND CURB TO ORIGINAL CONDITION AFTER INSTALLATION OF POLE FOUNDATION. CONCRETE SIDEWALK SHALL INCLUDE XYPEX IN MIX DESIGN WITH CONSOLIDECK SALT GUARD CLEAR COAT OR EQUAL APPLIED ONTO FINISHED SURFACE.
2. CONTRACTOR SHALL PROTECT THE ADJACENT EXISTING STRUCTURES AT ALL TIMES DURING CONSTRUCTION OF POLE FOUNDATION.
3. SEE GENERAL NOTES FOR ALL OTHER APPLICABLE NOTES AND REQUIREMENTS.
4. PROVIDE CONDUIT TO PULL BOX OR AS SHOWN ON ELECTRICAL PLANS.
5. PROVIDE CASING FOR CIDH AS REQUIRED.
6. DO NOT DEMO SIDEWALK OVER (E) BRICK ARCH OUTSIDE OF (N) ROOF SLAB.
7. PROVIDE SHORING FOR (E) SLAB BEFORE CUTTING HOLE & REBARS AS REQUIRED.
8. CONTRACTOR SHALL LOCATE UNDERGROUND UTILITY CONFLICTS BEFORE DRILLING TO AVOID DAMAGING (E) UTILITIES.
9. PROVIDE (3) HEX NUTS, A LEVELING NUT AND (4) WASHERS FOR EACH ANCHOR BOLT.
10. FOR ANCHOR BOLTS, THREAD TOP 10" AND GALVANIZE TOP 1'-0"; THREAD BOTTOM 8".
11. SEE TRAFFIC SIGNAL DRAWINGS FOR INFORMATION ON MAST ARM BASE PLATE, ANCHOR BOLTS, AND ANCHOR EMBED PLATE.
12. HIGH GROUNDWATER LEVEL MAY BE PRESENT. DURING CONSTRUCTION, THE CONTRACTOR SHALL PROVIDE ALL NECESSARY PROTECTION OF BASEMENT STRUCTURE. THE CONTRACTOR SHALL BEAR ALL EXPENSE FOR REPAIR OR REPLACEMENT.
13. SIDEWALK THICKNESS VARIES. PROTECT EXISTING SIDEWALK FROM DAMAGES DURING CONSTRUCTION FOR OPENING DEMOLITION.

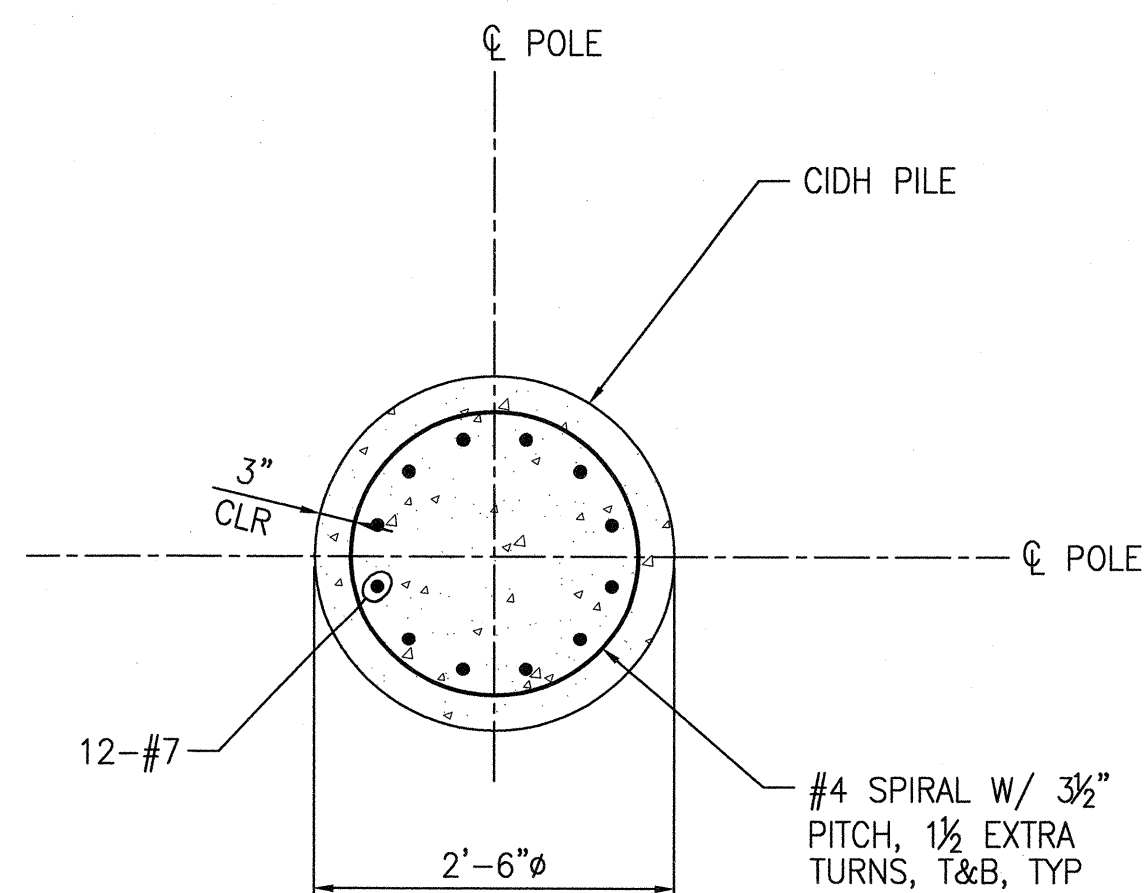


CAST-IN-DRILLED-HOLE CONC PILE SECTION 9  
SCALE: 3/4"=1'-0"

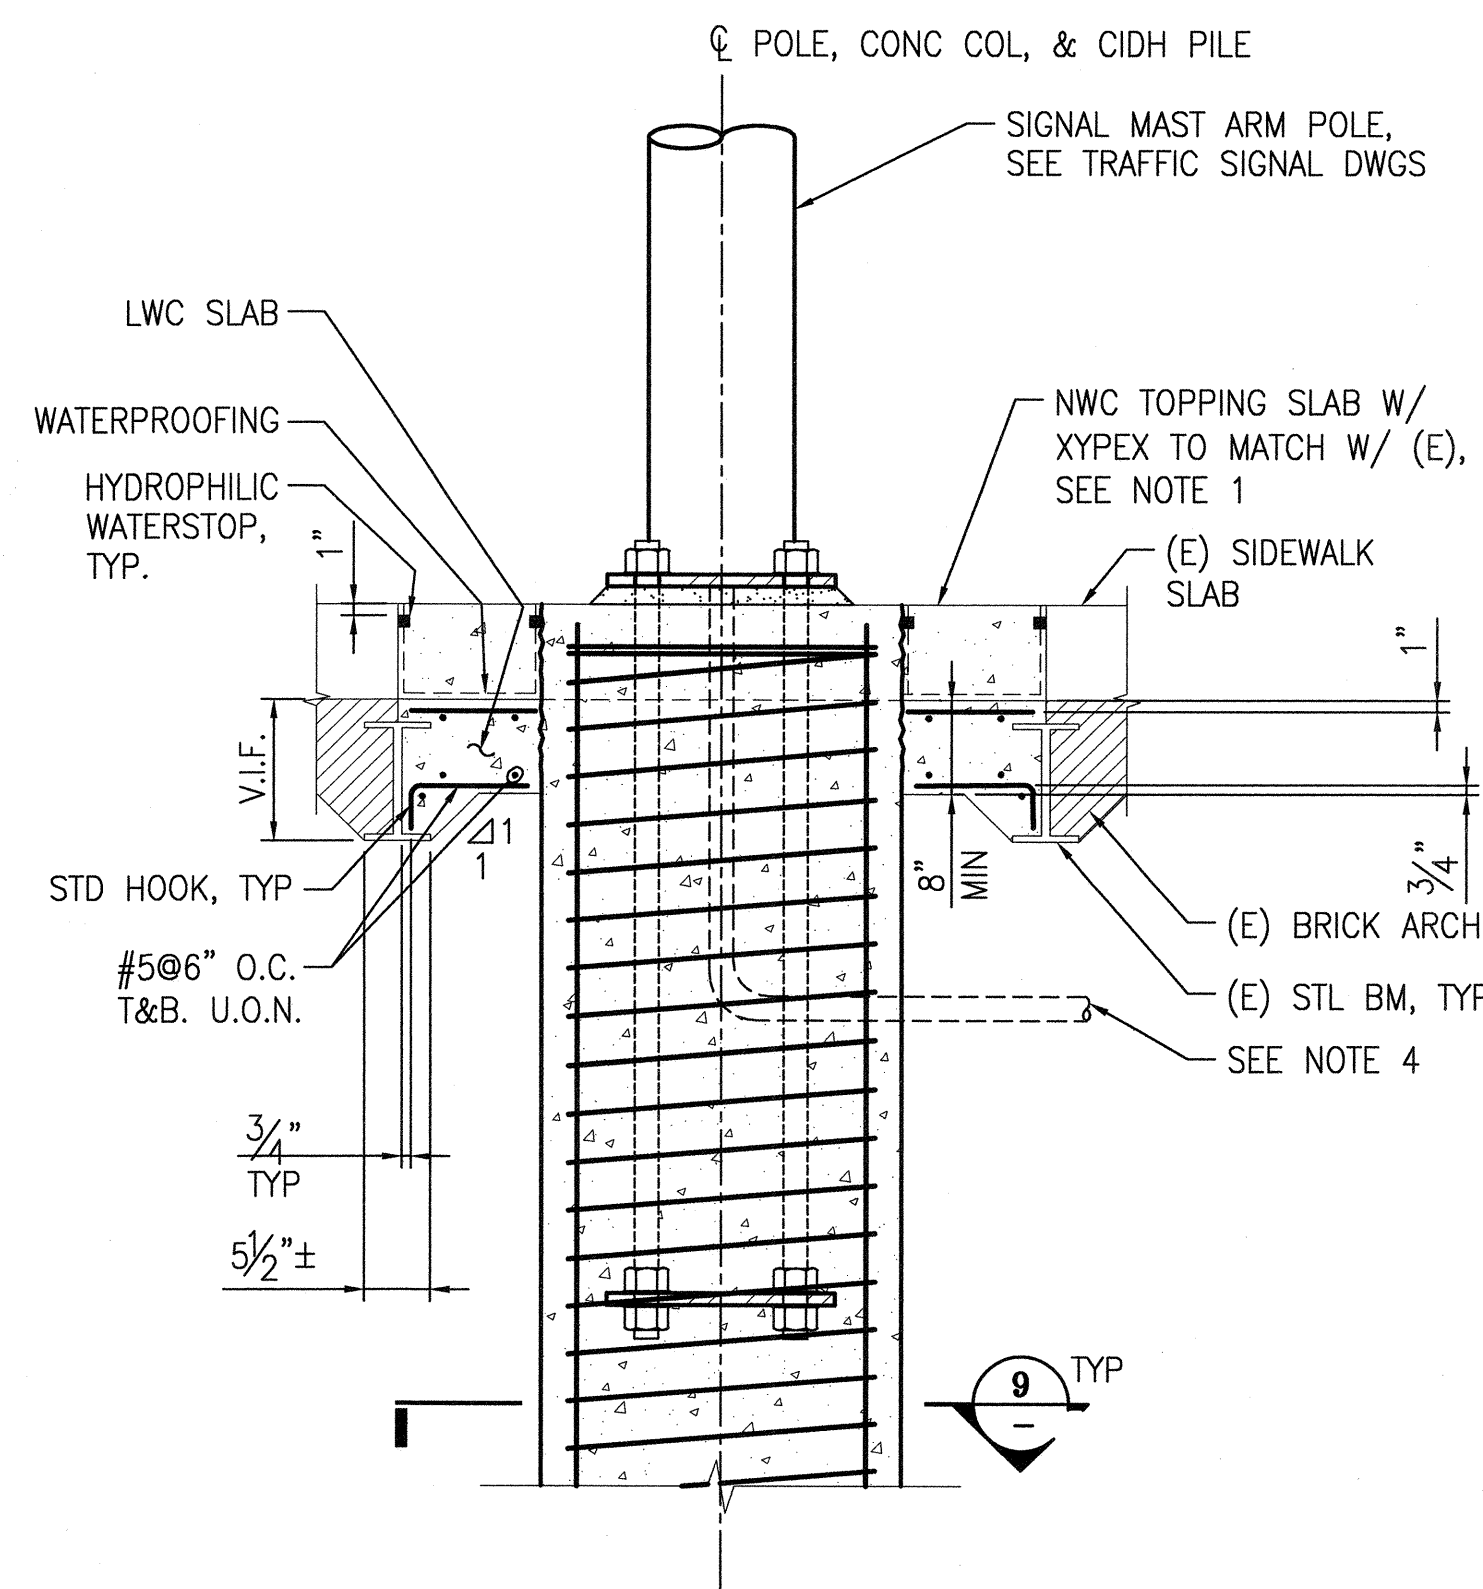

**SECTION**  
**SCALE: 3/4"=1'-0"**

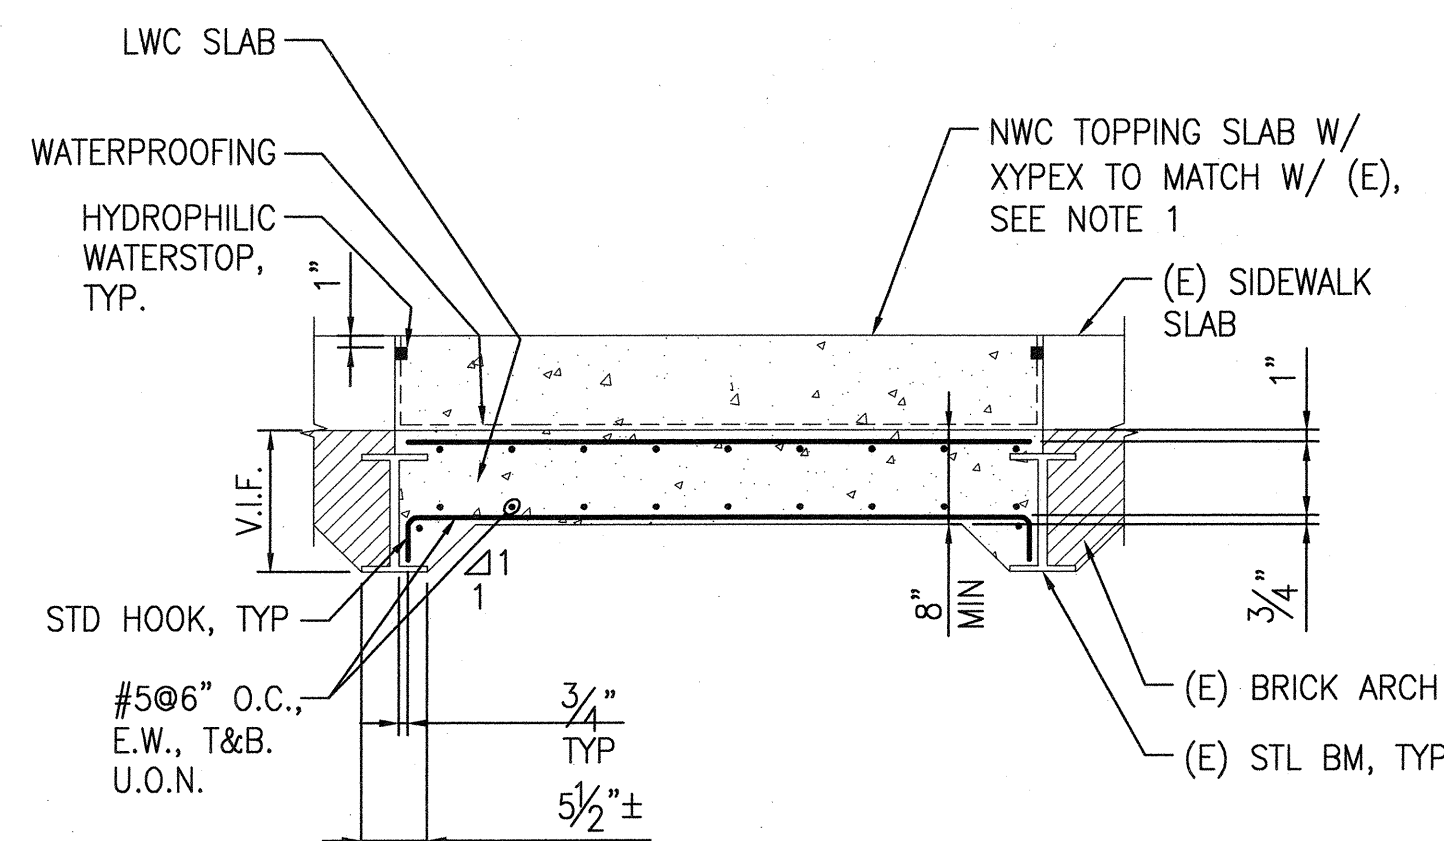

**SECTION**  
**SCALE: 3/4"=1'-0"**

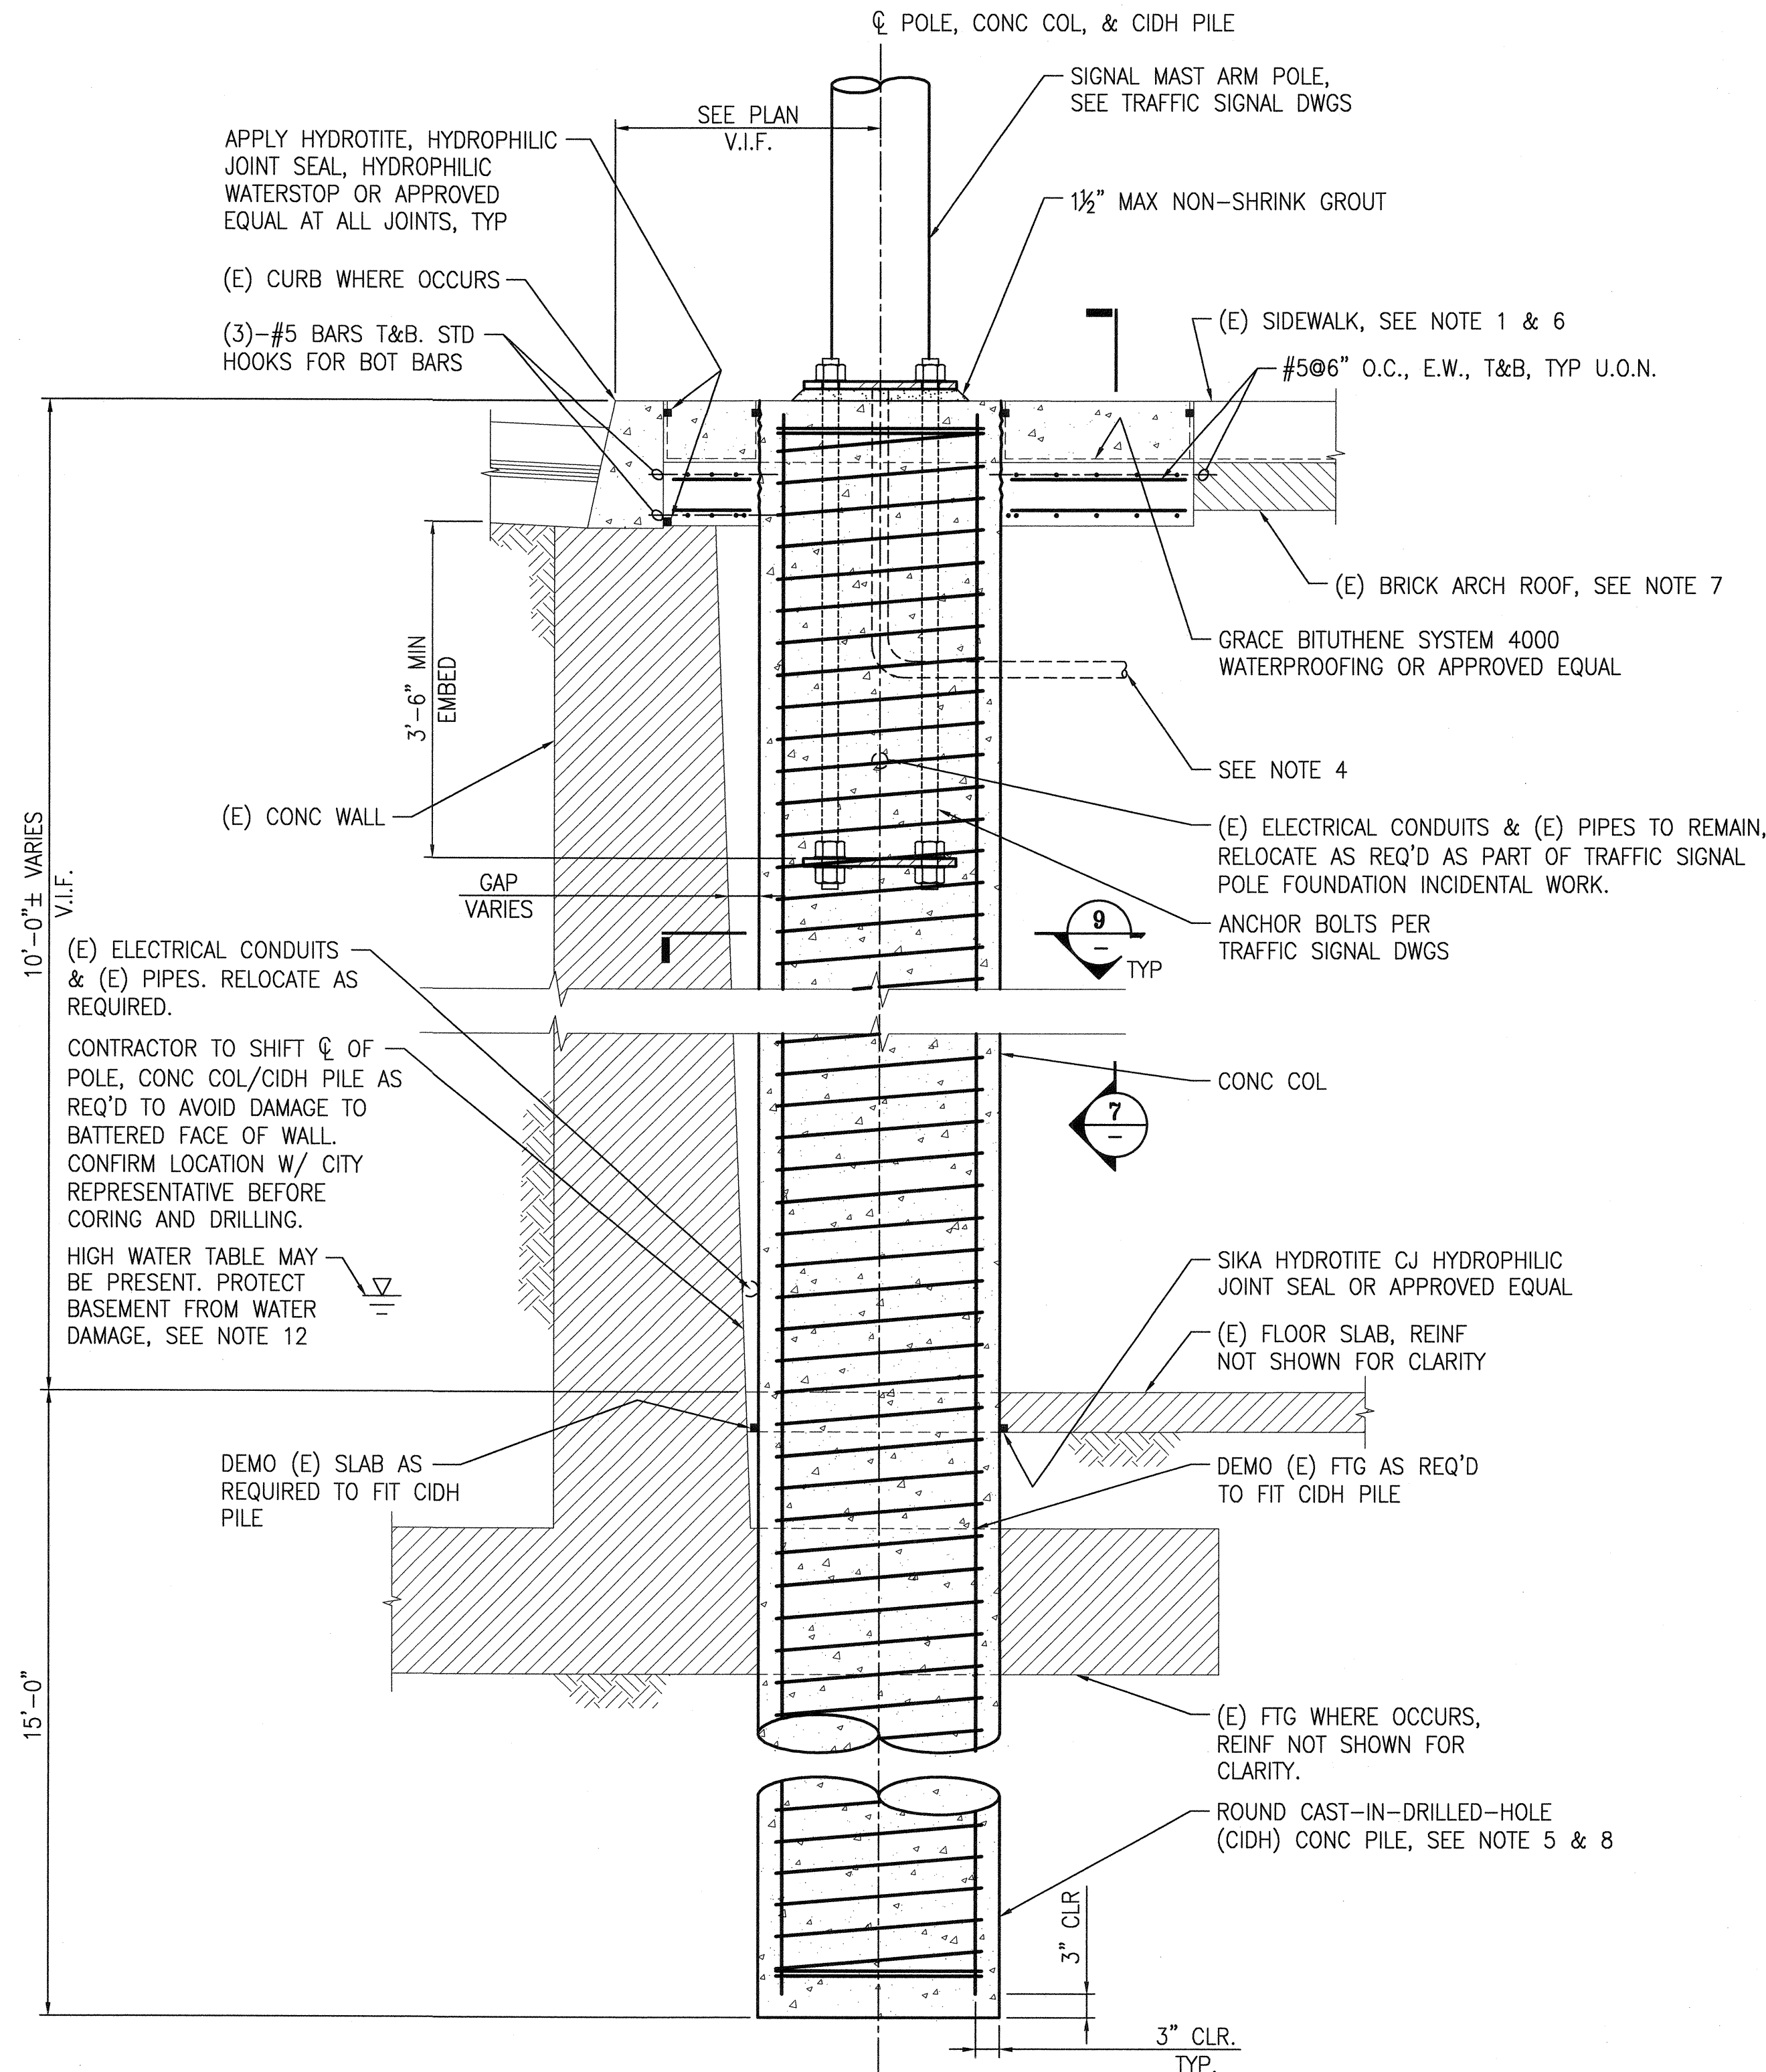

**SECTION**  
**SCALE: 3/4"=1'-0"**

NO.	DATE	DESCRIPTION	BY	APP.
<b>TABLE OF REVISIONS</b>				
<b>CHECK WITH TRACING TO SEE IF YOU HAVE LATEST REVISION</b>				

REFERENCE INFORMATION  
& FILE NO. OF SURVEYS



DESIGN AND  
ENGINEERING DIVISION  
PUBLIC WORKS  
CITY & COUNTY OF SAN FRANCISCO

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30 VAN NESS AVENUE, 5TH FLOOR  
SAN FRANCISCO, CA 94102 - 8028

	Date:
Section Mgr: RAYMOND LUI	9/12/16
Deputy Division Mgr: FERNANDO CISNEROS	9/26/16
Division Mgr: PATRICK RIVERA	9/21/16

DESIGNED	JN
DRAWN	VY
CHECKED	JS
REVIEWED	
RECOMMENDED	
APPROVED	

SCALE:  
AS SHOWN  
SHEET OF SHEETS

## 2ND STREET STREETSCAPE IMPROVEMENTS PROJECT

## SUB-SIDEWALK BASEMENT TRAFFIC SIGNAL POLE SECTIONS AND DETAILS

SPECIFICATION NO.	1064J (R)
DRAWING NO.	S-402
FILE NO.	106,301
REV. NO.	