


#### KEYNOTES:


- ① APPROXIMATE LOCATION OF PROPOSED IRRIGATION TRENCH. CONTRACTOR SHALL SAWCUT AND REMOVE EXISTING A.C. PAVEMENT IN ACCORDANCE WITH CITY OF SACRAMENTO STANDARD DWG. NO. T-80 ON SHEET LG-C6. REPLACE A.C. PAVEMENT TO MATCH EXISTING PAVEMENT SECTION (MINIMUM 4" A.C. OVER 8" A.B. OVER COMPACTED SUBGRADE) IN ACCORDANCE WITH CITY OF SACRAMENTO STANDARD DWG. NO. T-80. SEE LANDSCAPE PLANS FOR ACTUAL TRENCH LOCATION.
- ② APPROXIMATE LOCATION OF PROPOSED IRRIGATION TRENCH. CONTRACTOR SHALL SAWCUT EXISTING CURB AT NEAREST JOINTS/SCORE LINES AND REMOVE EXISTING CURB AND ASPHALT PAVEMENT FOR PROPOSED IRRIGATION TRENCH. REPLACE A.C. PAVEMENT TO MATCH EXISTING (MINIMUM 4" A.C. OVER 8" A.B. OVER COMPACTED SUBGRADE). REPLACE CURB TO MATCH EXISTING. SEE LANDSCAPE PLANS FOR ACTUAL TRENCH LOCATION.

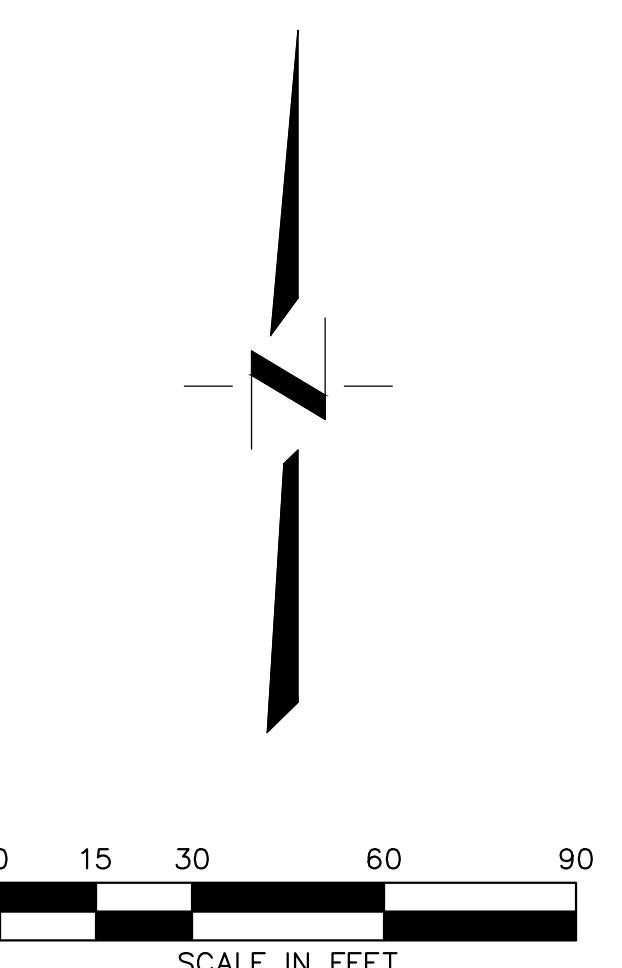

#### CONSTRUCTION DOCUMENTS CSUS LID STORMWATER SYSTEM SITE PLAN

CALIFORNIA STATE UNIVERSITY, SACRAMENTO

NO.	DATE	REVISIONS	BY	APFD.	DESIGNED BY	NC
					DRAWN BY	NC
					CHECKED BY	DF
					SCALE	
					1" = 30'	

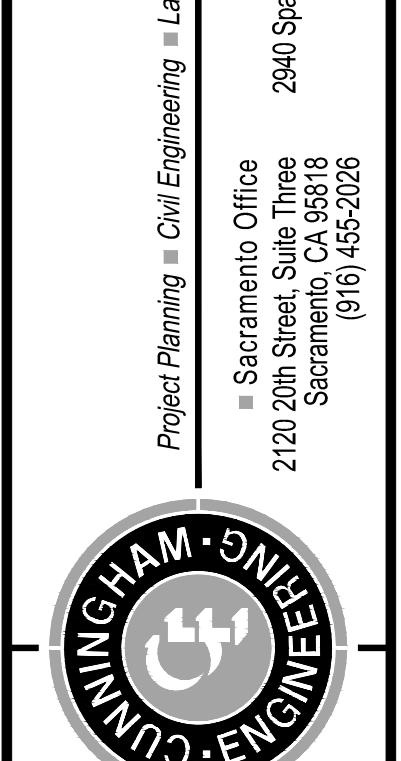


CONSTRUCTION DOCUMENTS CSUS LID STORMWATER SYSTEM SITE PLAN		CALIFORNIA		4/21/2015 – 20:09PM		4/21/2015 – 20:09PM
DATE SIGNED:						
THESE DRAWINGS ARE NOT CONSIDERED FINAL UNTIL THE ENGINEER'S SEAL BELOW HAS BEEN SIGNED AND DATED.						
REGISTERED PROFESSIONAL ENGINEER DANIEL A. FENCO, C.E. No. C51484						
CIVIL STATE OF CALIFORNIA						


SHEET  
**LG-C1**  
OF  
**6**

DATE: 4/24/2015

JOB NO: 1432.01

**LG - RG - 2**  
RAIN GARDEN 1"=10'

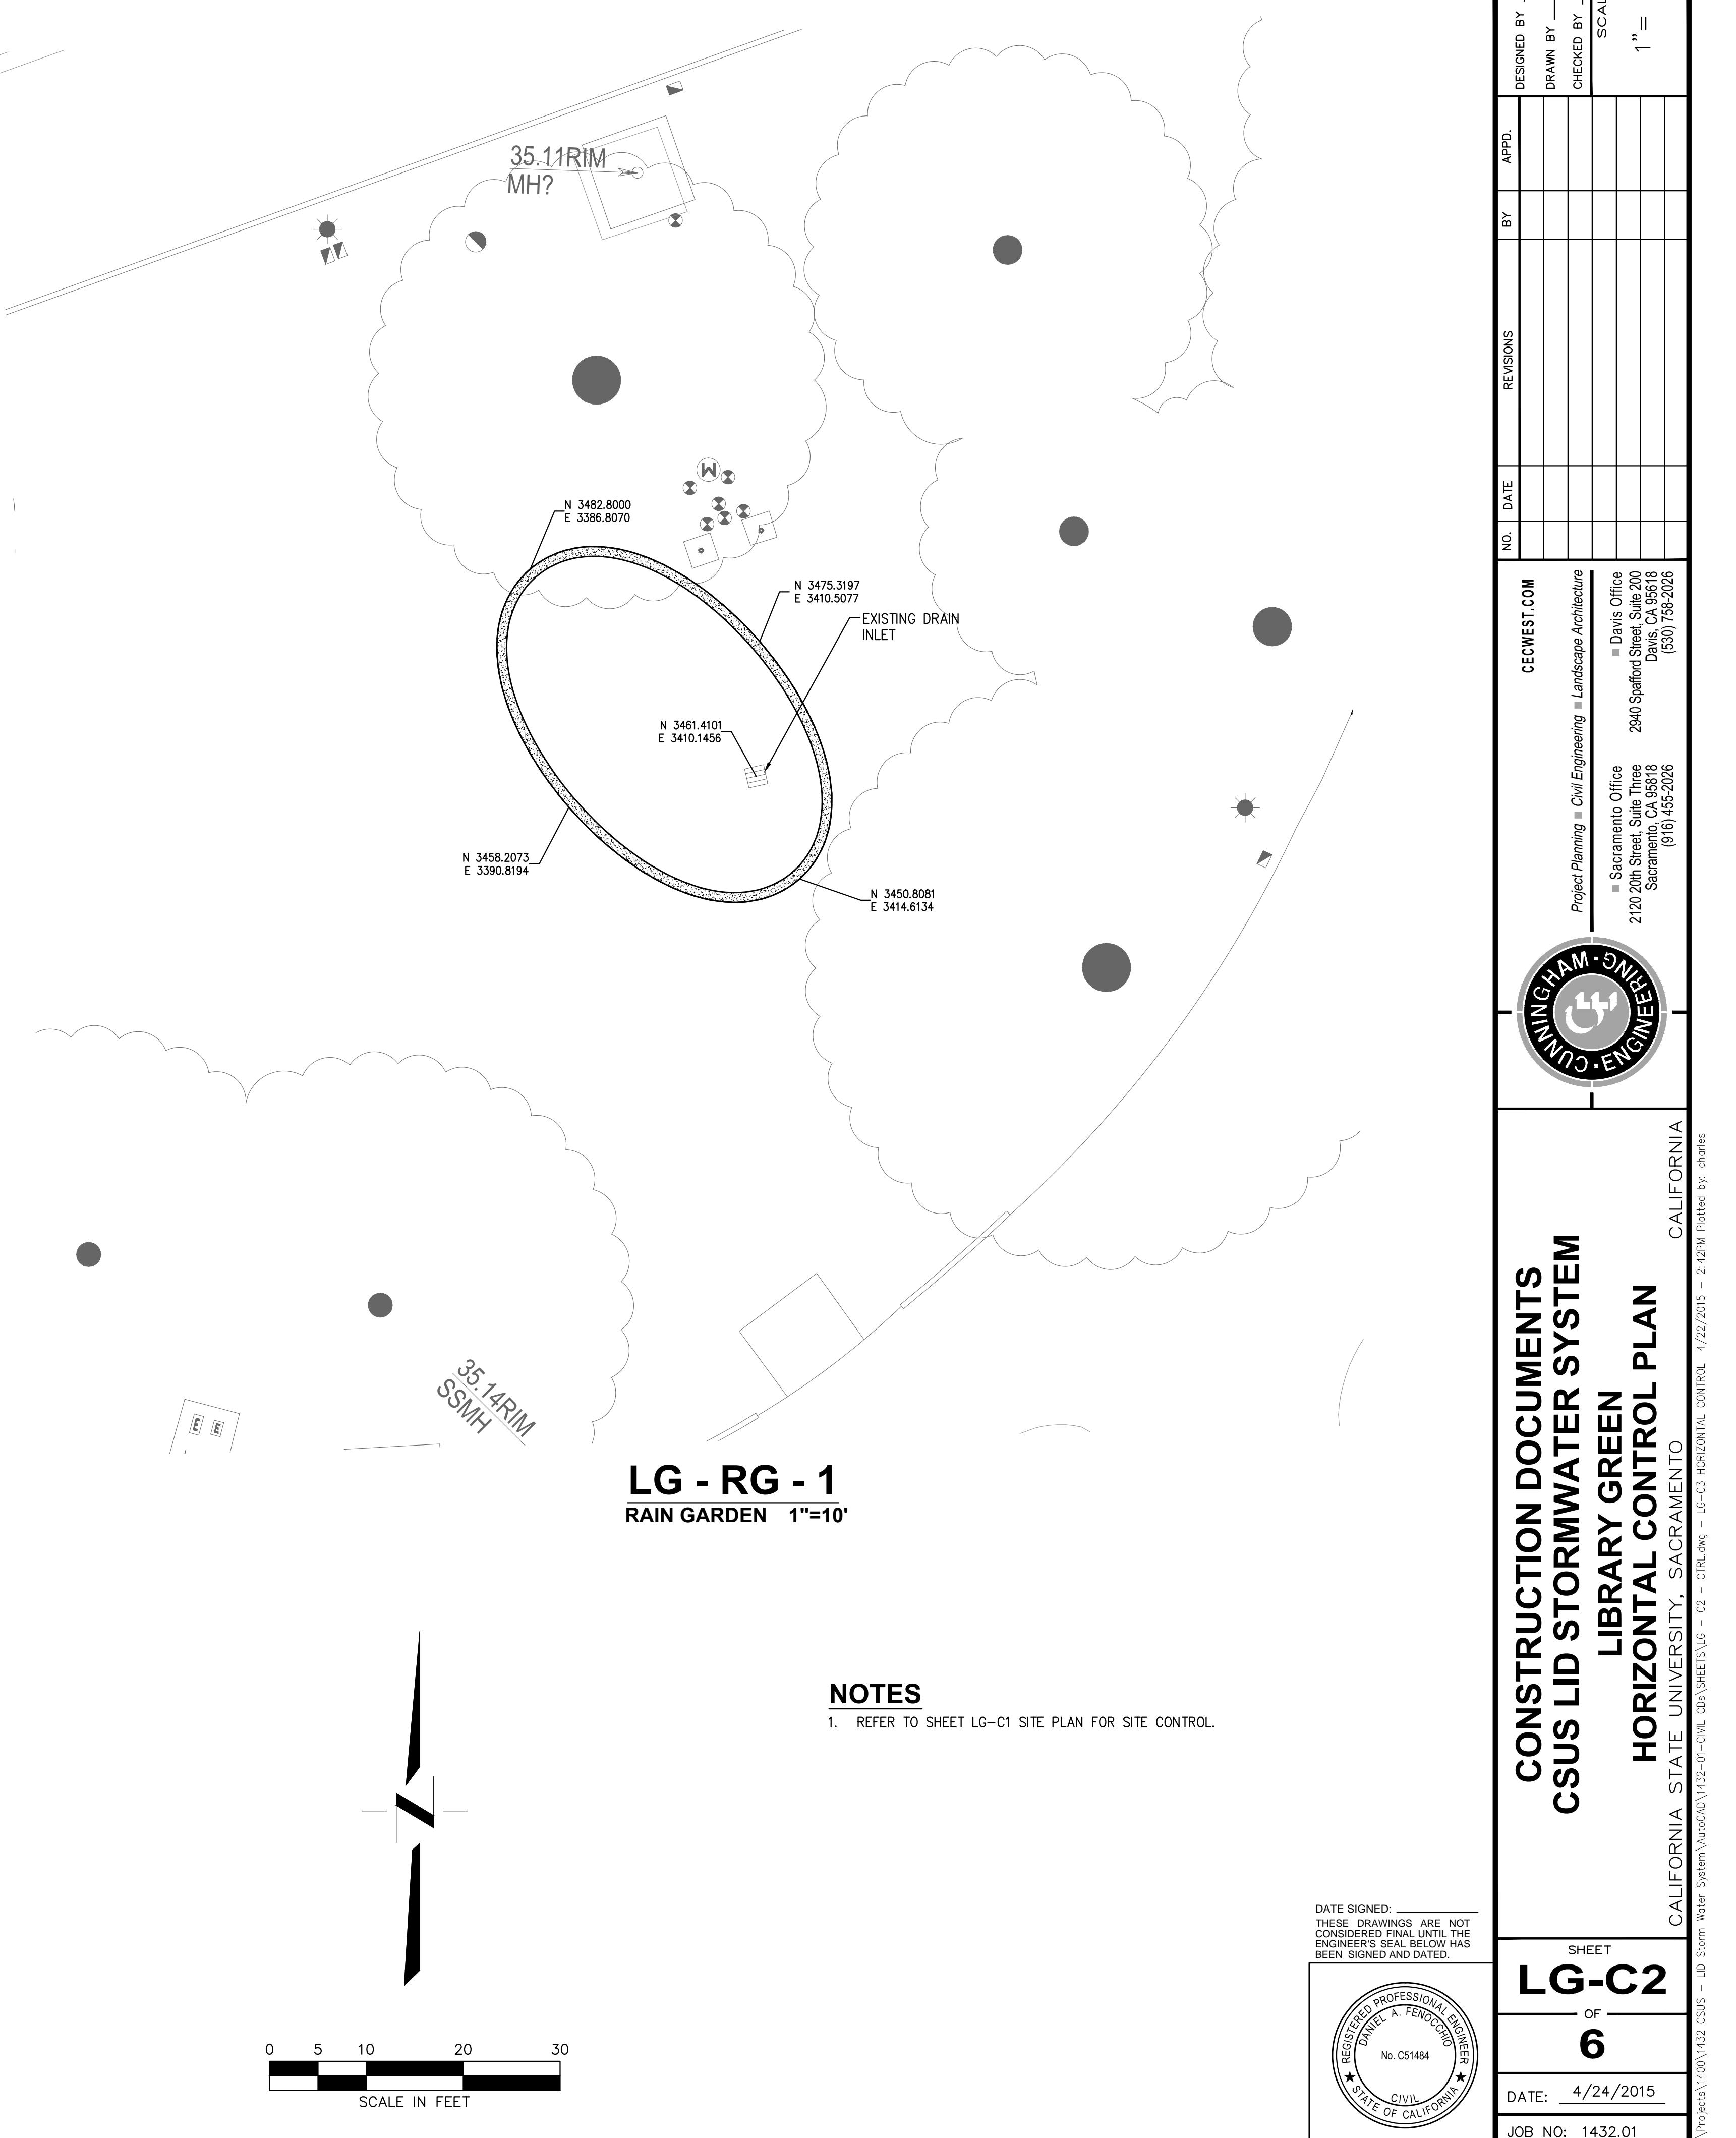


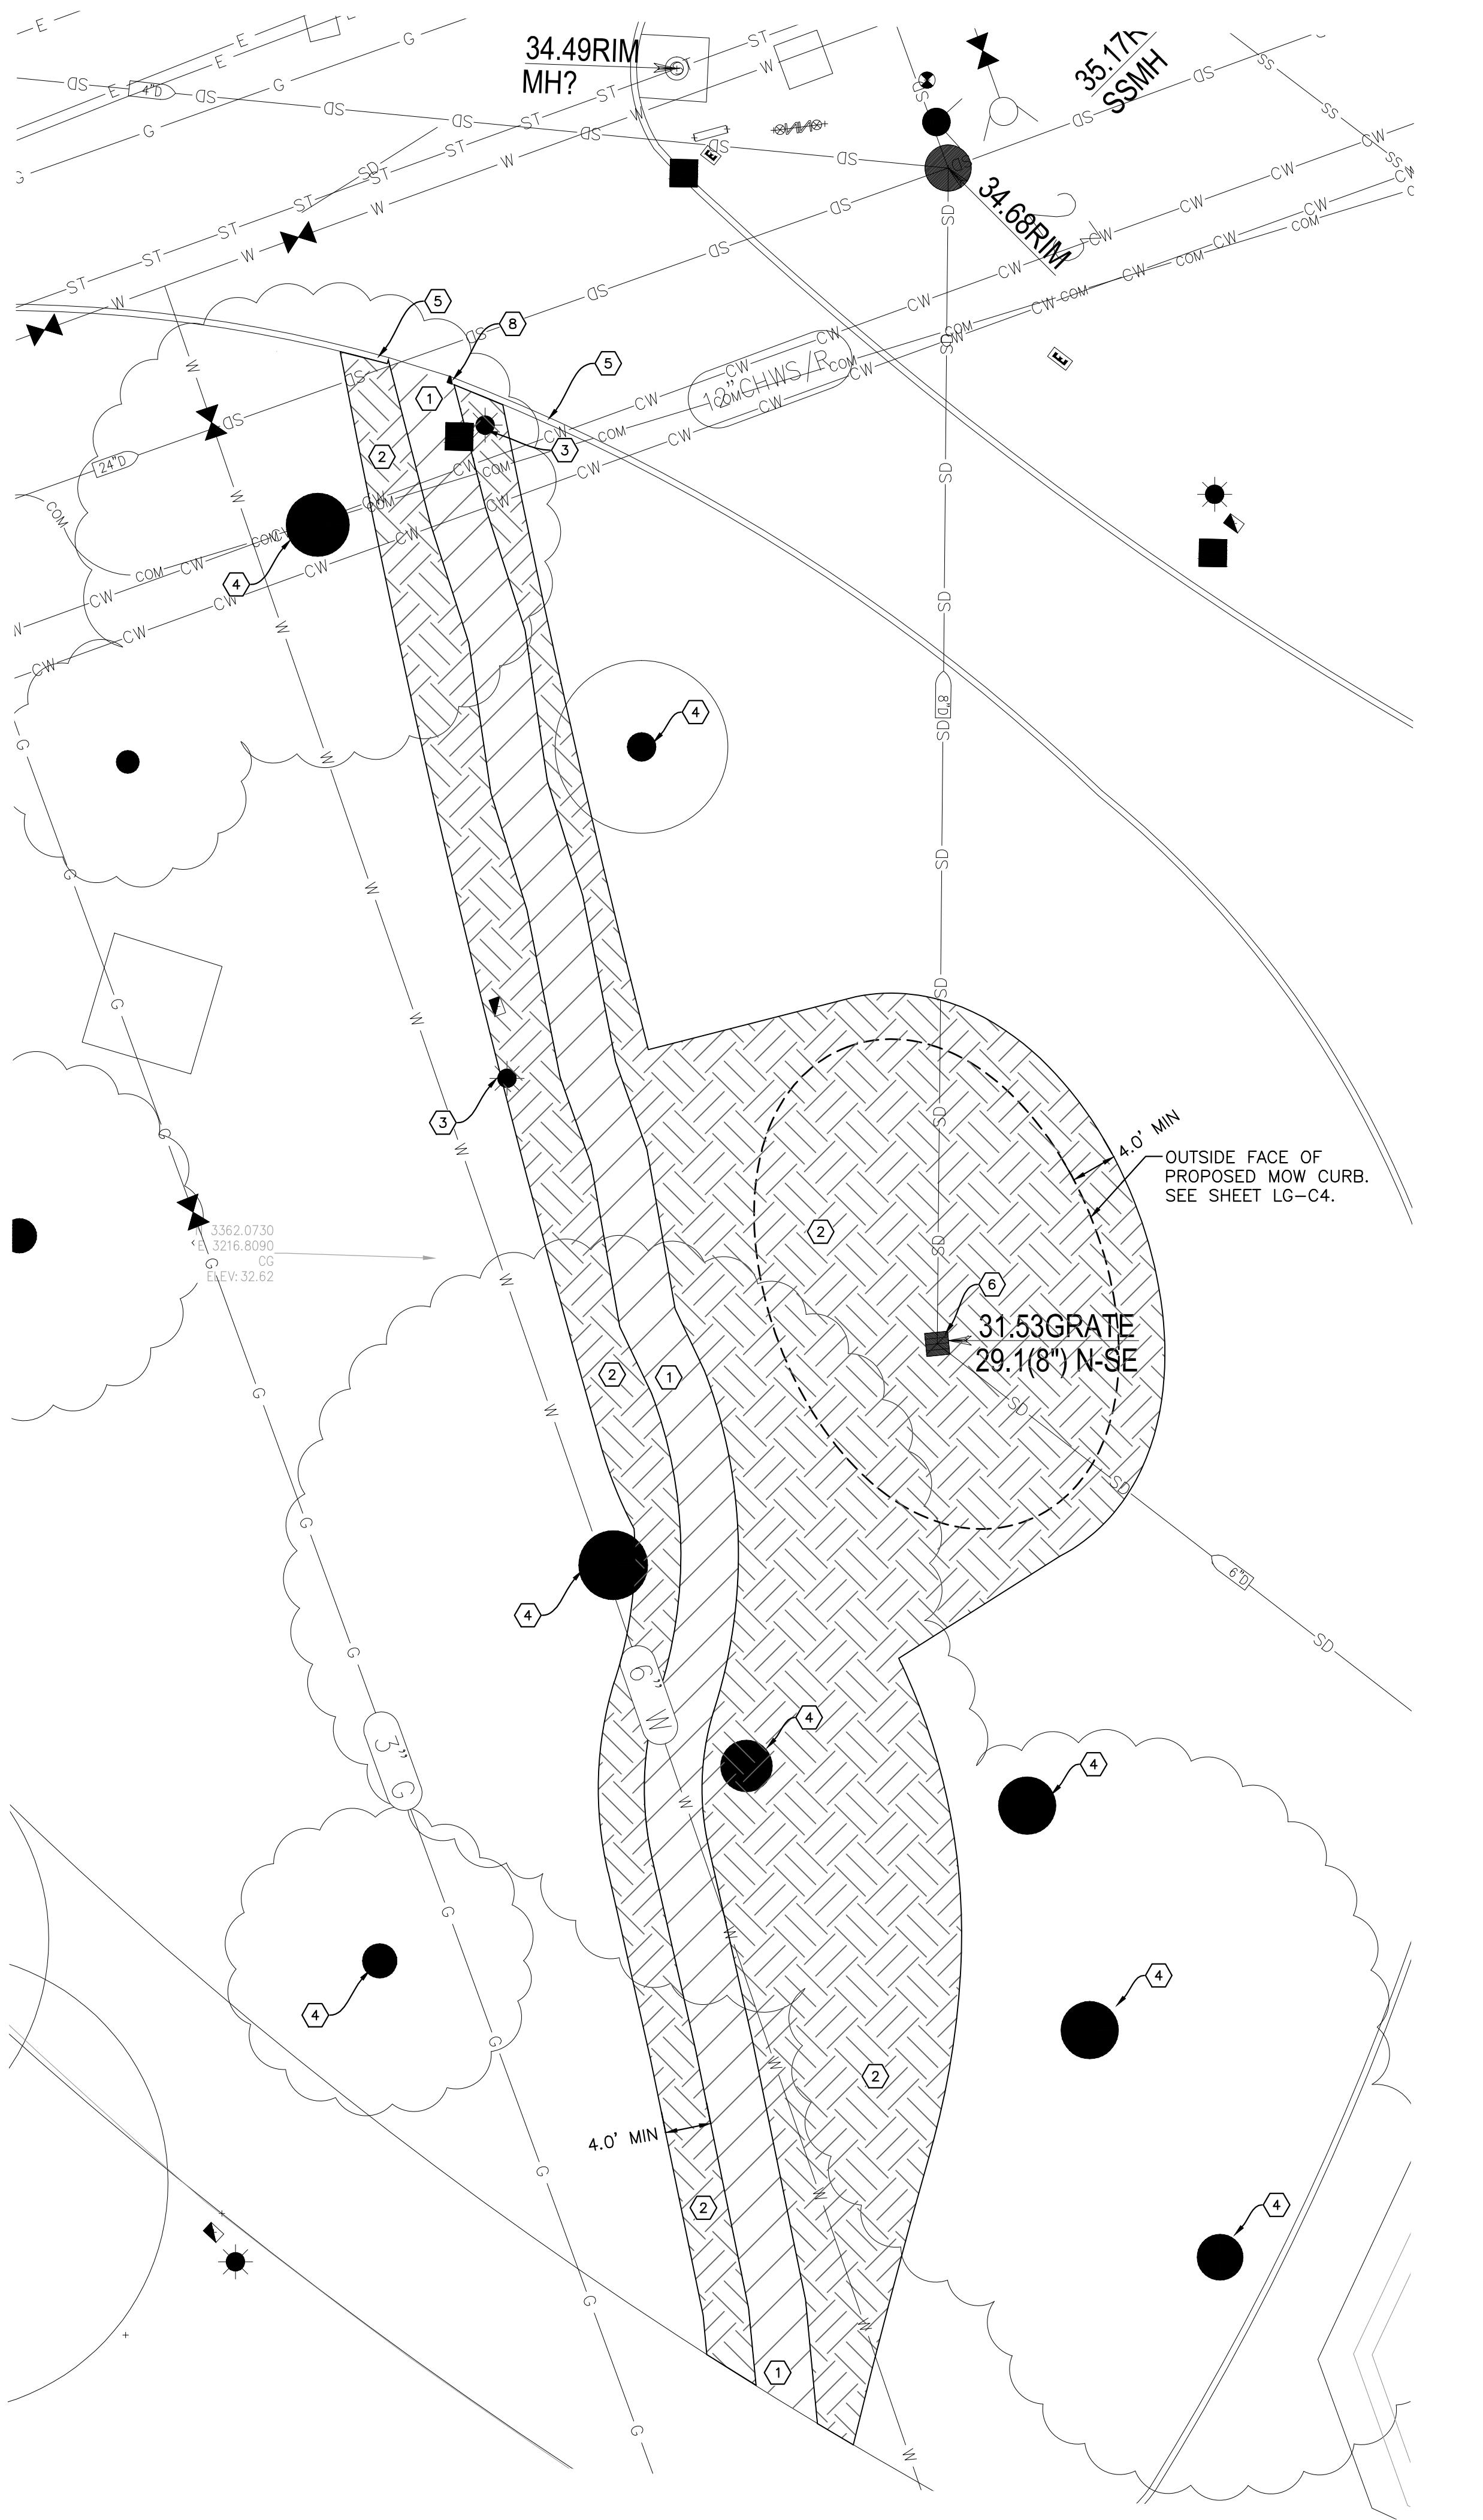

# **LG - RG - 2**

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## **RAIN GARDEN 1"=10'**

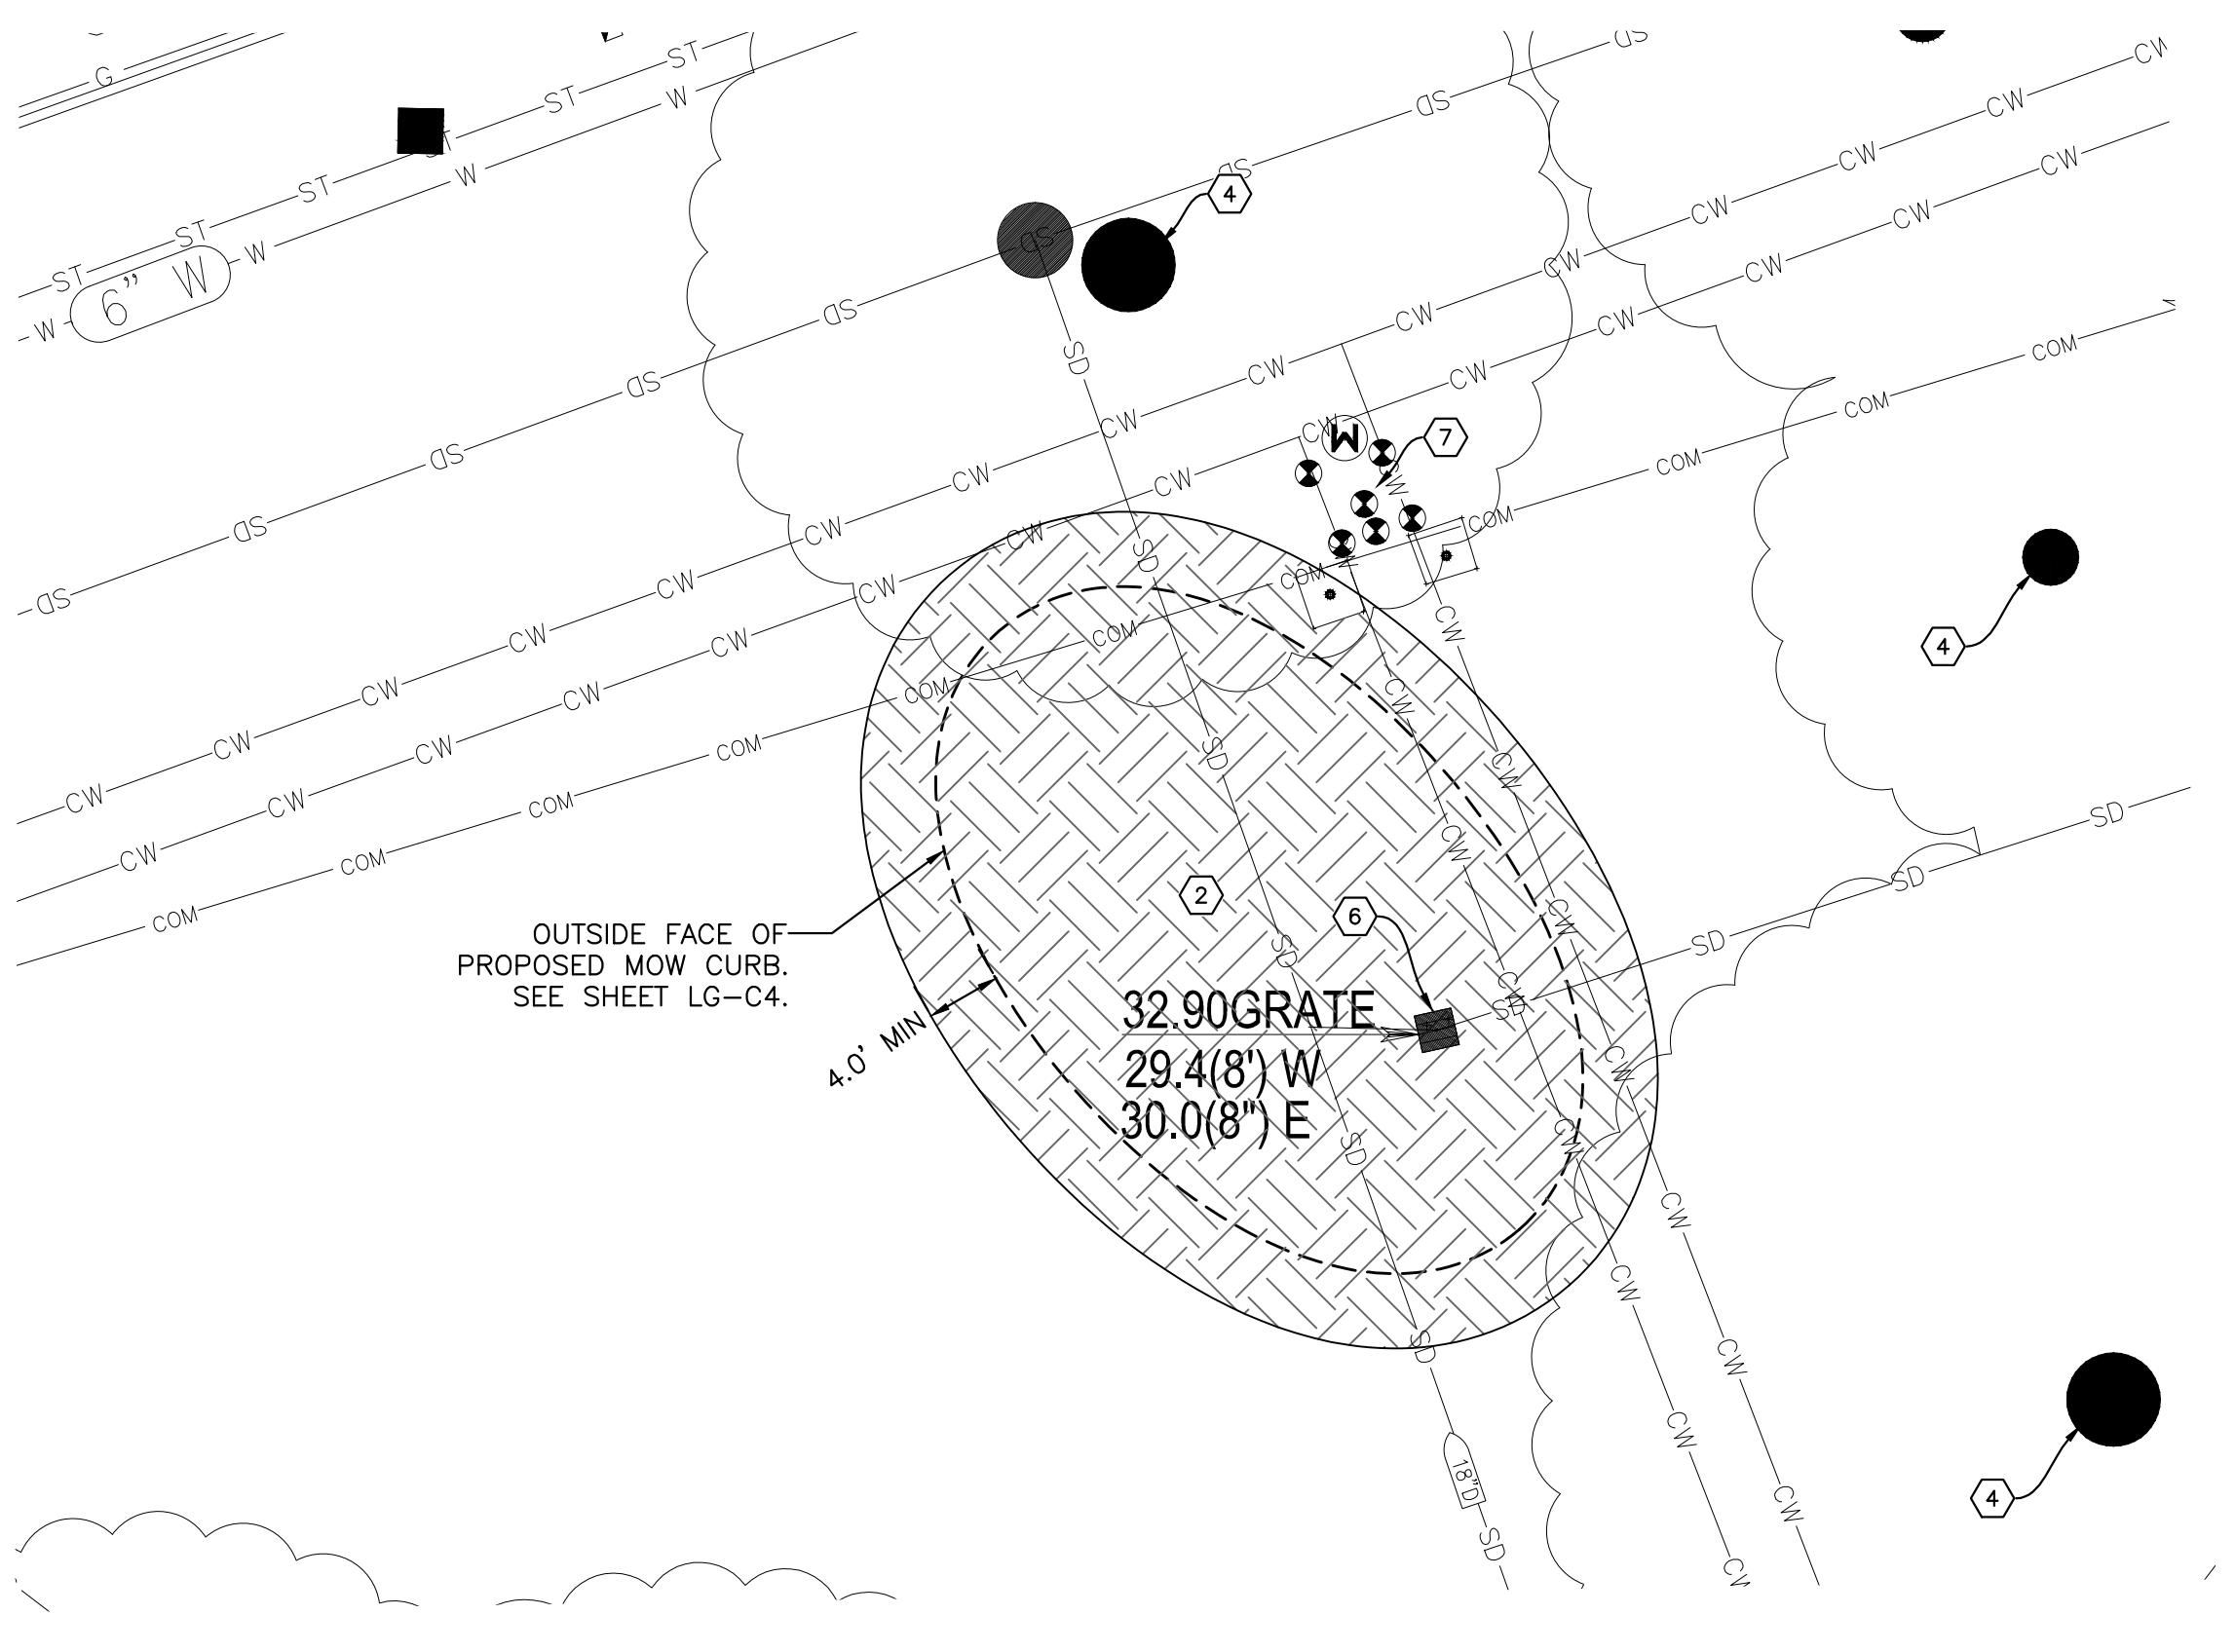

# **LG - RG - 1**

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## **RAIN GARDEN 1"=10'**


# KEYNOTES:

-  REMOVE EXISTING DG PATH TO EXTENTS SHOWN.
  -  REMOVE EXISTING VEGETATION TO EXTENTS SHOWN.
  -  PROTECT EXISTING LIGHT POLE AND PULL BOX IN PLACE.
  -  PROTECT EXISTING TREE. SEE SHEET T-3 FOR TREE PROTECTION NOTES.
  -  PROTECT EXISTING CURB.
  -  PROTECT EXISTING DRAIN INLET
  -  PROTECT EXISTING WATER APPURTENANCES.
  -  SAWCUT EXISTING CURB TO LIMITS SHOWN.

## **NOTES:**

- NOTES:**

  1. INTENT OF DEMOLITION PLAN IS TO PROVIDE GENERAL SITE DEMOLITION REQUIREMENTS TO CONTRACTOR. PLAN IS NOT INTENDED TO PROVIDE DETAILED INFORMATION ON SITE REMOVAL, PROTECTION AND PHASING. CONTRACTOR SHALL BE RESPONSIBLE FOR PERFORMING SITE VISITS TO DEVELOP A DETAILED DEMOLITION PLAN IN ACCORDANCE WITH THE PROPOSED SITE IMPROVEMENTS.
  2. SITE DEMOLITION INCLUDES:
    - REMOVE EXISTING LANDSCAPE AREA.
    - REMOVE EXISTING DECOMPOSED GRANITE PATH
    - REMOVE/ADJUST EXISTING ABOVE GROUND AND UNDERGROUND IRRIGATION FACILITIES. COORDINATE EXTENT OF IMPROVEMENTS WITH LANDSCAPE PLANS
  3. CONTRACTOR SHALL DISPOSE OF ALL MATERIALS PROPERLY OFFSITE.
  4. LIMITS OF REMOVAL SHOWN ON THESE PLANS ARE APPROXIMATE. CONTRACTOR SHALL MODIFY LIMITS OF DEMOLITION AS NECESSARY TO PROVIDE FOR NEW CONSTRUCTION, BASED ON CONTRACTOR'S METHOD OF CONSTRUCTION.
  5. CONTRACTOR SHALL PROVIDE TRAFFIC CONTROL FLAGGING FOR VEHICULAR INGRESS/EGRESS.
  6. PROJECT VEHICULAR AND PEDESTRIAN ACCESS PLAN SHALL BE PREPARED BY CONTRACTOR.
  7. THE TYPES, LOCATIONS, SIZES AND/OR DEPTHS OF EXISTING UTILITIES SHOWN ON THESE PLANS WERE OBTAINED FROM SOURCES OF VARYING RELIABILITY. THE CONTRACTOR IS CAUTIONED THAT ONLY ACTUAL EXCAVATION WILL REVEAL THE TYPES, EXTENT, SIZE, LOCATION AND DEPTH OF SUCH UNDERGROUND FACILITIES. HOWEVER, THE ENGINEER CAN ASSUME NO RESPONSIBILITY FOR THE COMPLETENESS OR ACCURACY OF ITS DELINEATION OF SUCH UNDERGROUND FACILITIES NOR FOR THE EXISTENCE OF OTHER BURIED OBJECTS WHICH ARE NOT SHOWN ON THESE PLANS. IF NO ELEVATION IS SHOWN ON THE PLANS THE CONTRACTOR SHALL ASSUME THE ELEVATION IS UNKNOWN.
  8. SEE SHEET LG-C1 FOR IRRIGATION TRENCH IMPROVEMENTS.
  9. CONTRACTOR SHALL VERIFY LIMITS OF REMOVAL WITH LANDSCAPE PLANS.

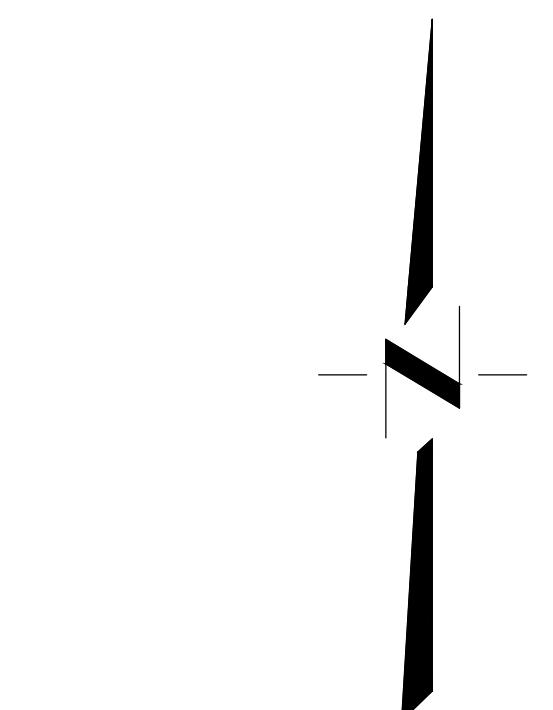

A horizontal scale bar divided into three segments. The first segment is black and labeled '0'. The second segment is white and labeled '5'. The third segment is black and labeled '10'. This pattern repeats once more, with a black segment labeled '20' and a white segment labeled '30'. Below the scale bar, the text 'SCALE IN FEET' is centered.

DATE SIGNED: \_\_\_\_\_

THESE DRAWINGS ARE NOT  
CONSIDERED FINAL UNTIL THE  
ENGINEER'S SEAL BELOW HAS  
BEEN SIGNED AND DATED.

SHEET  
**LG-C3**



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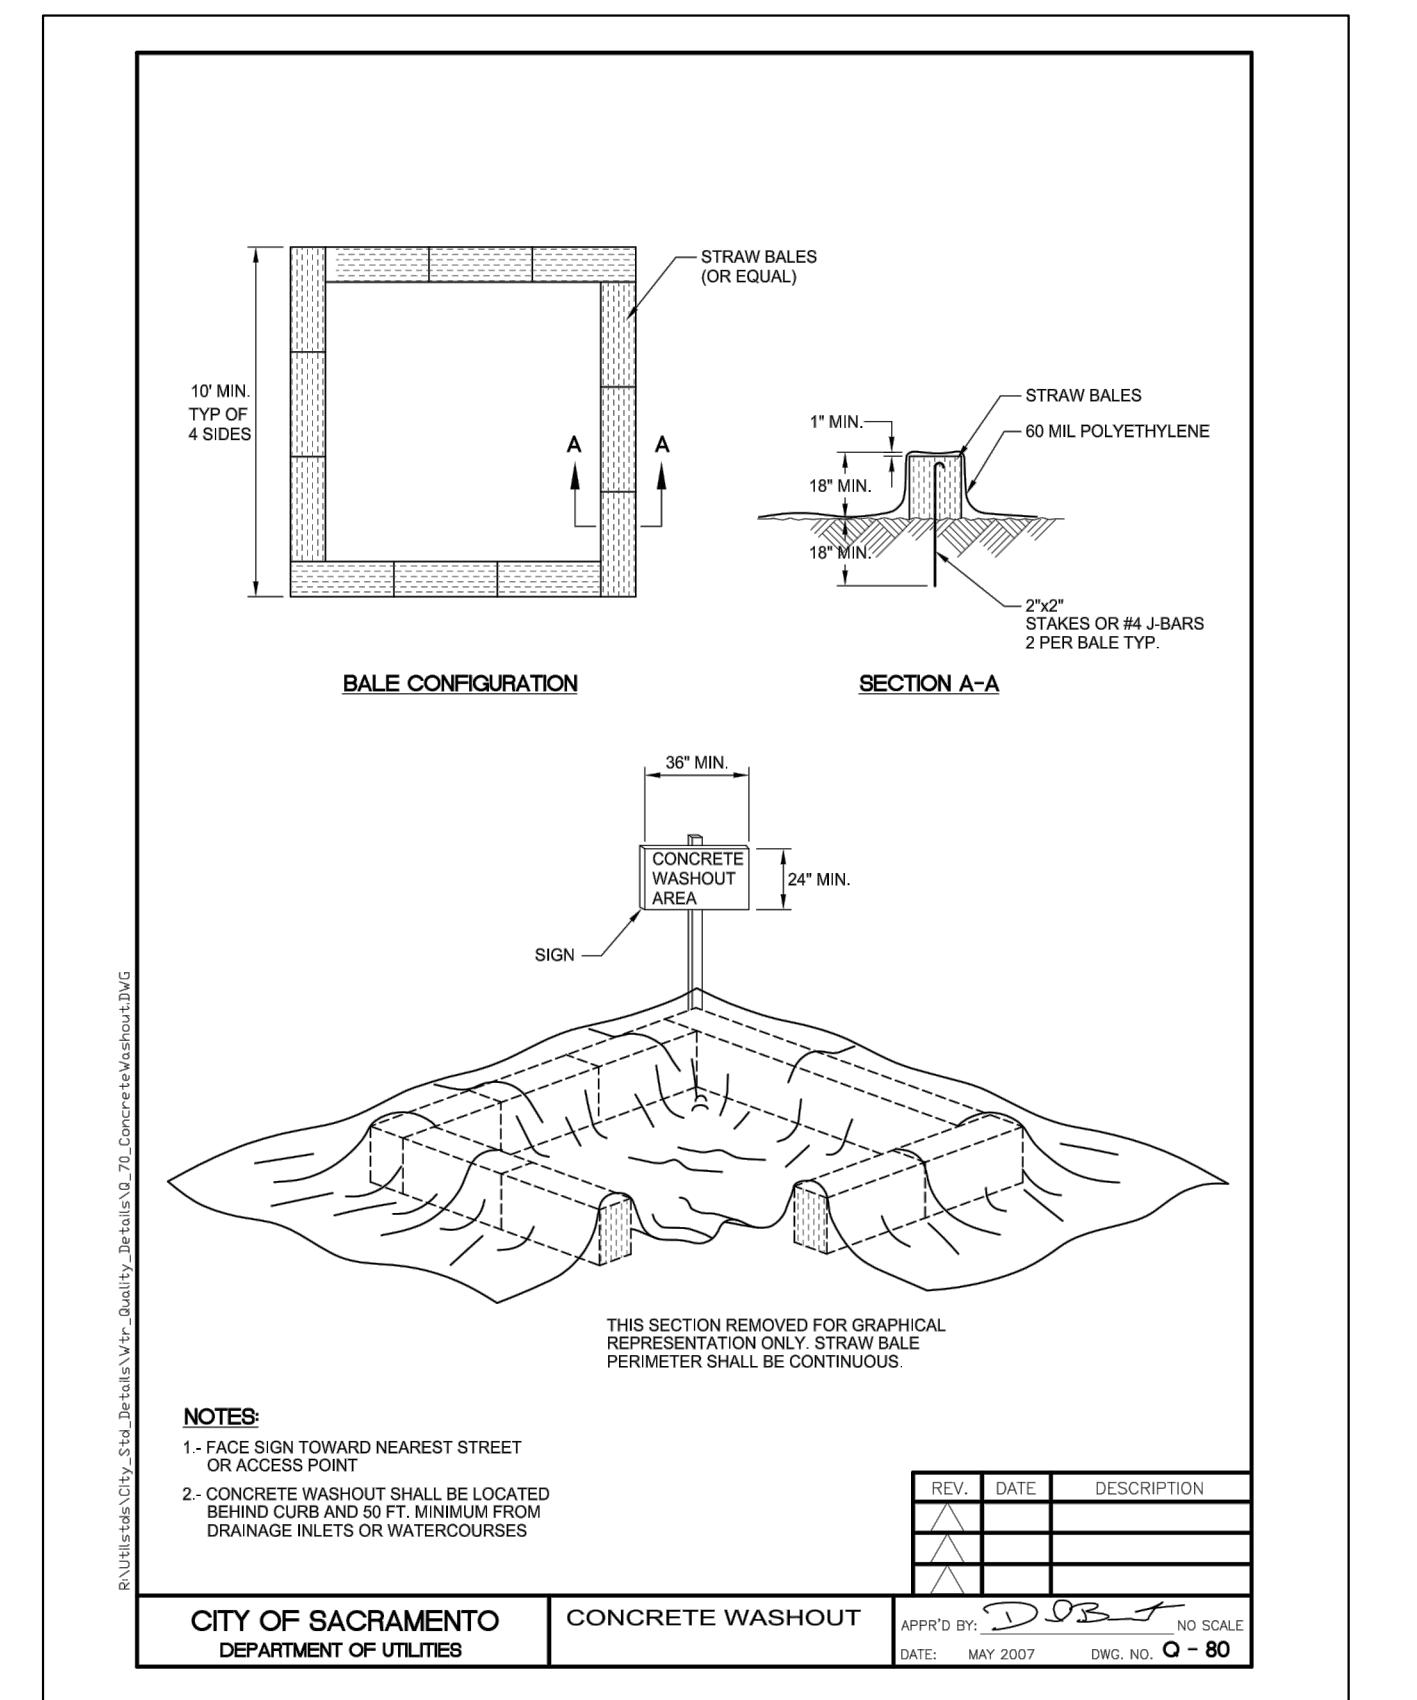
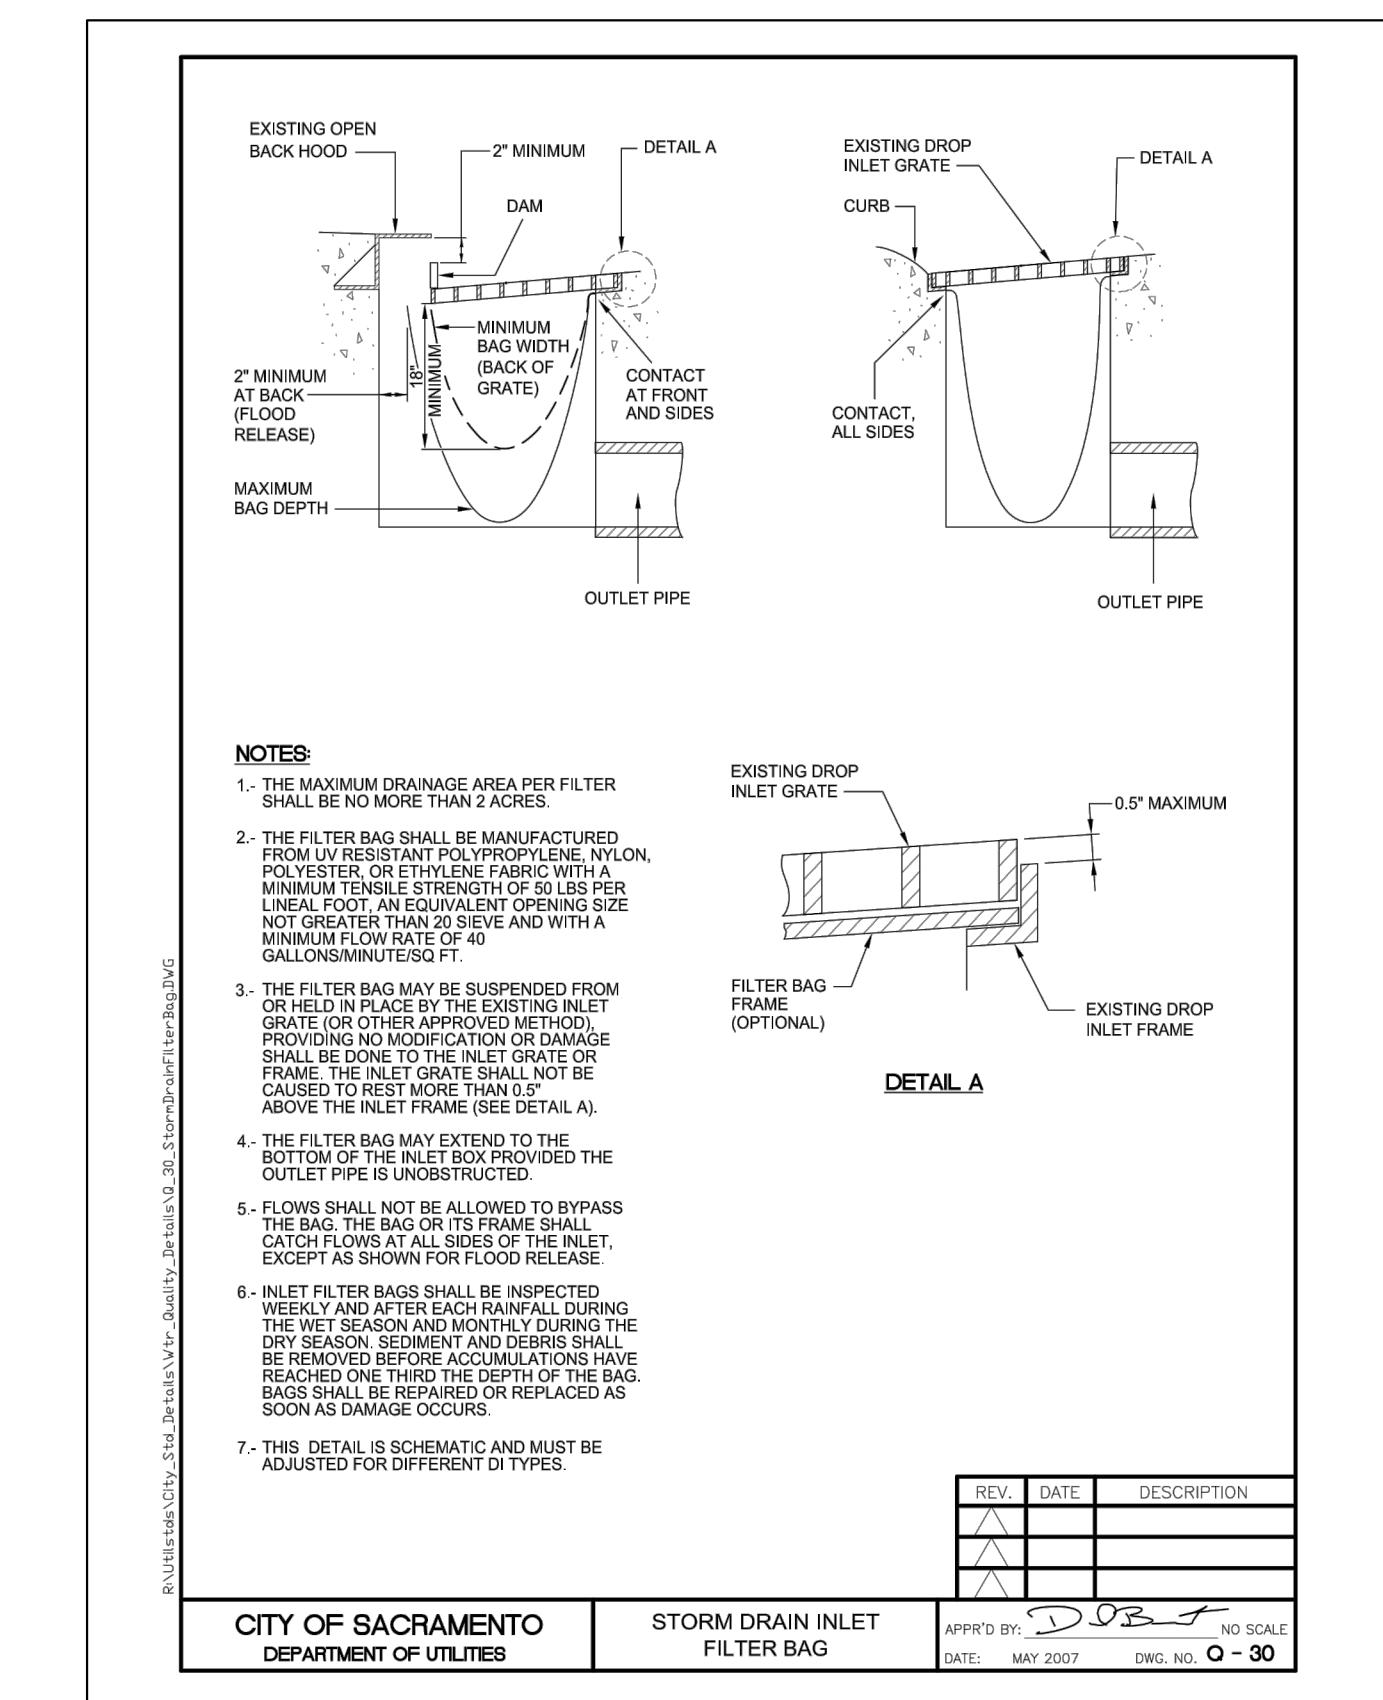
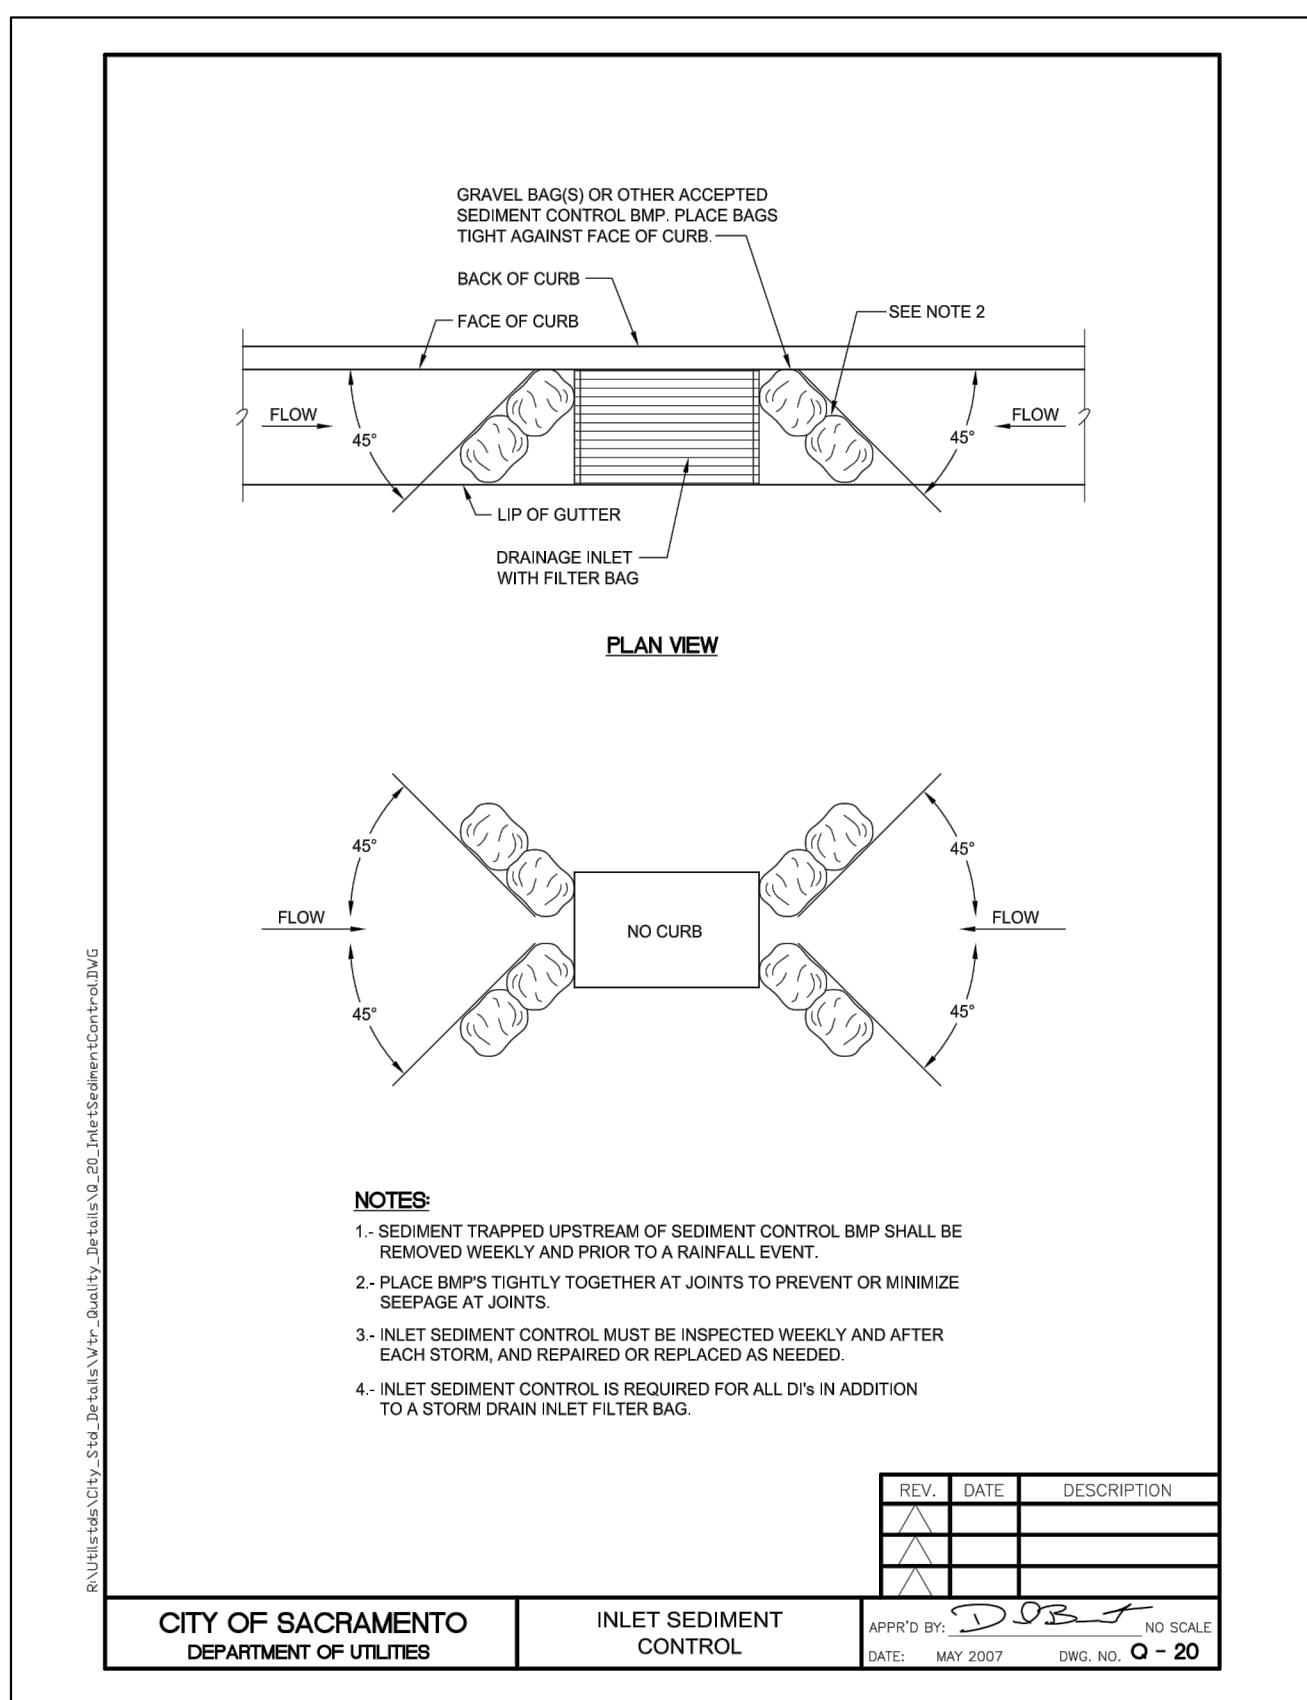
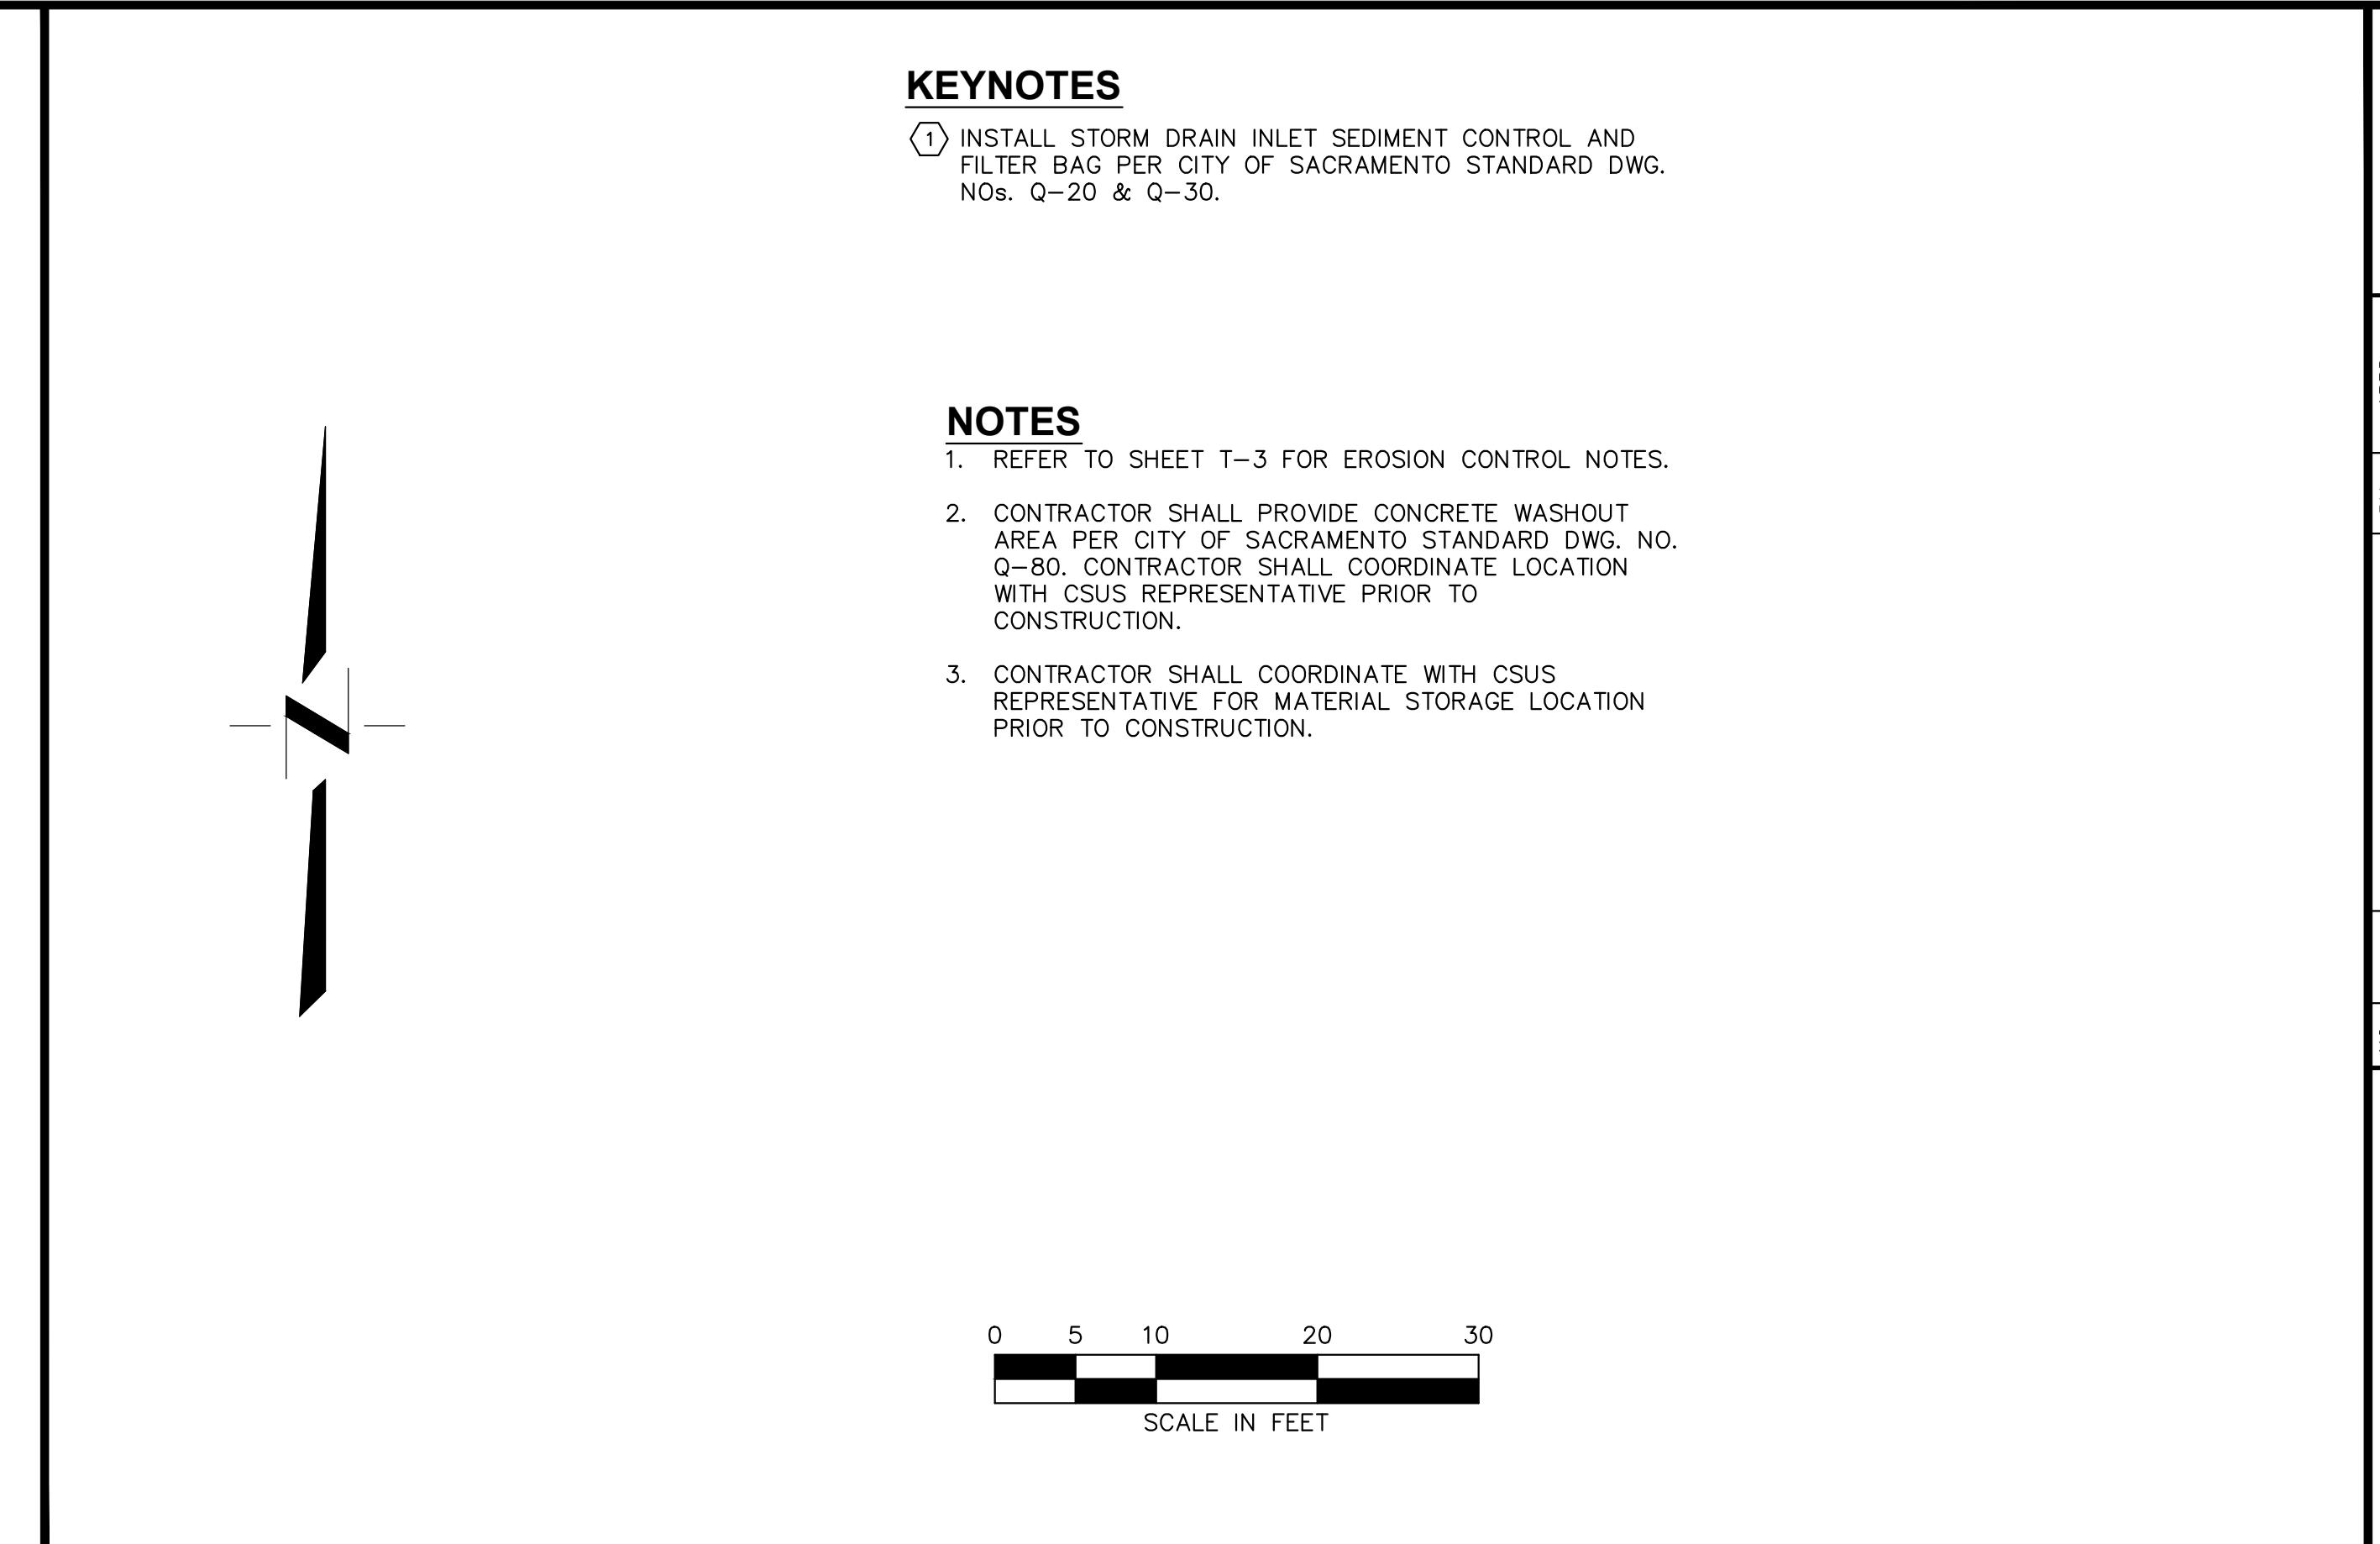
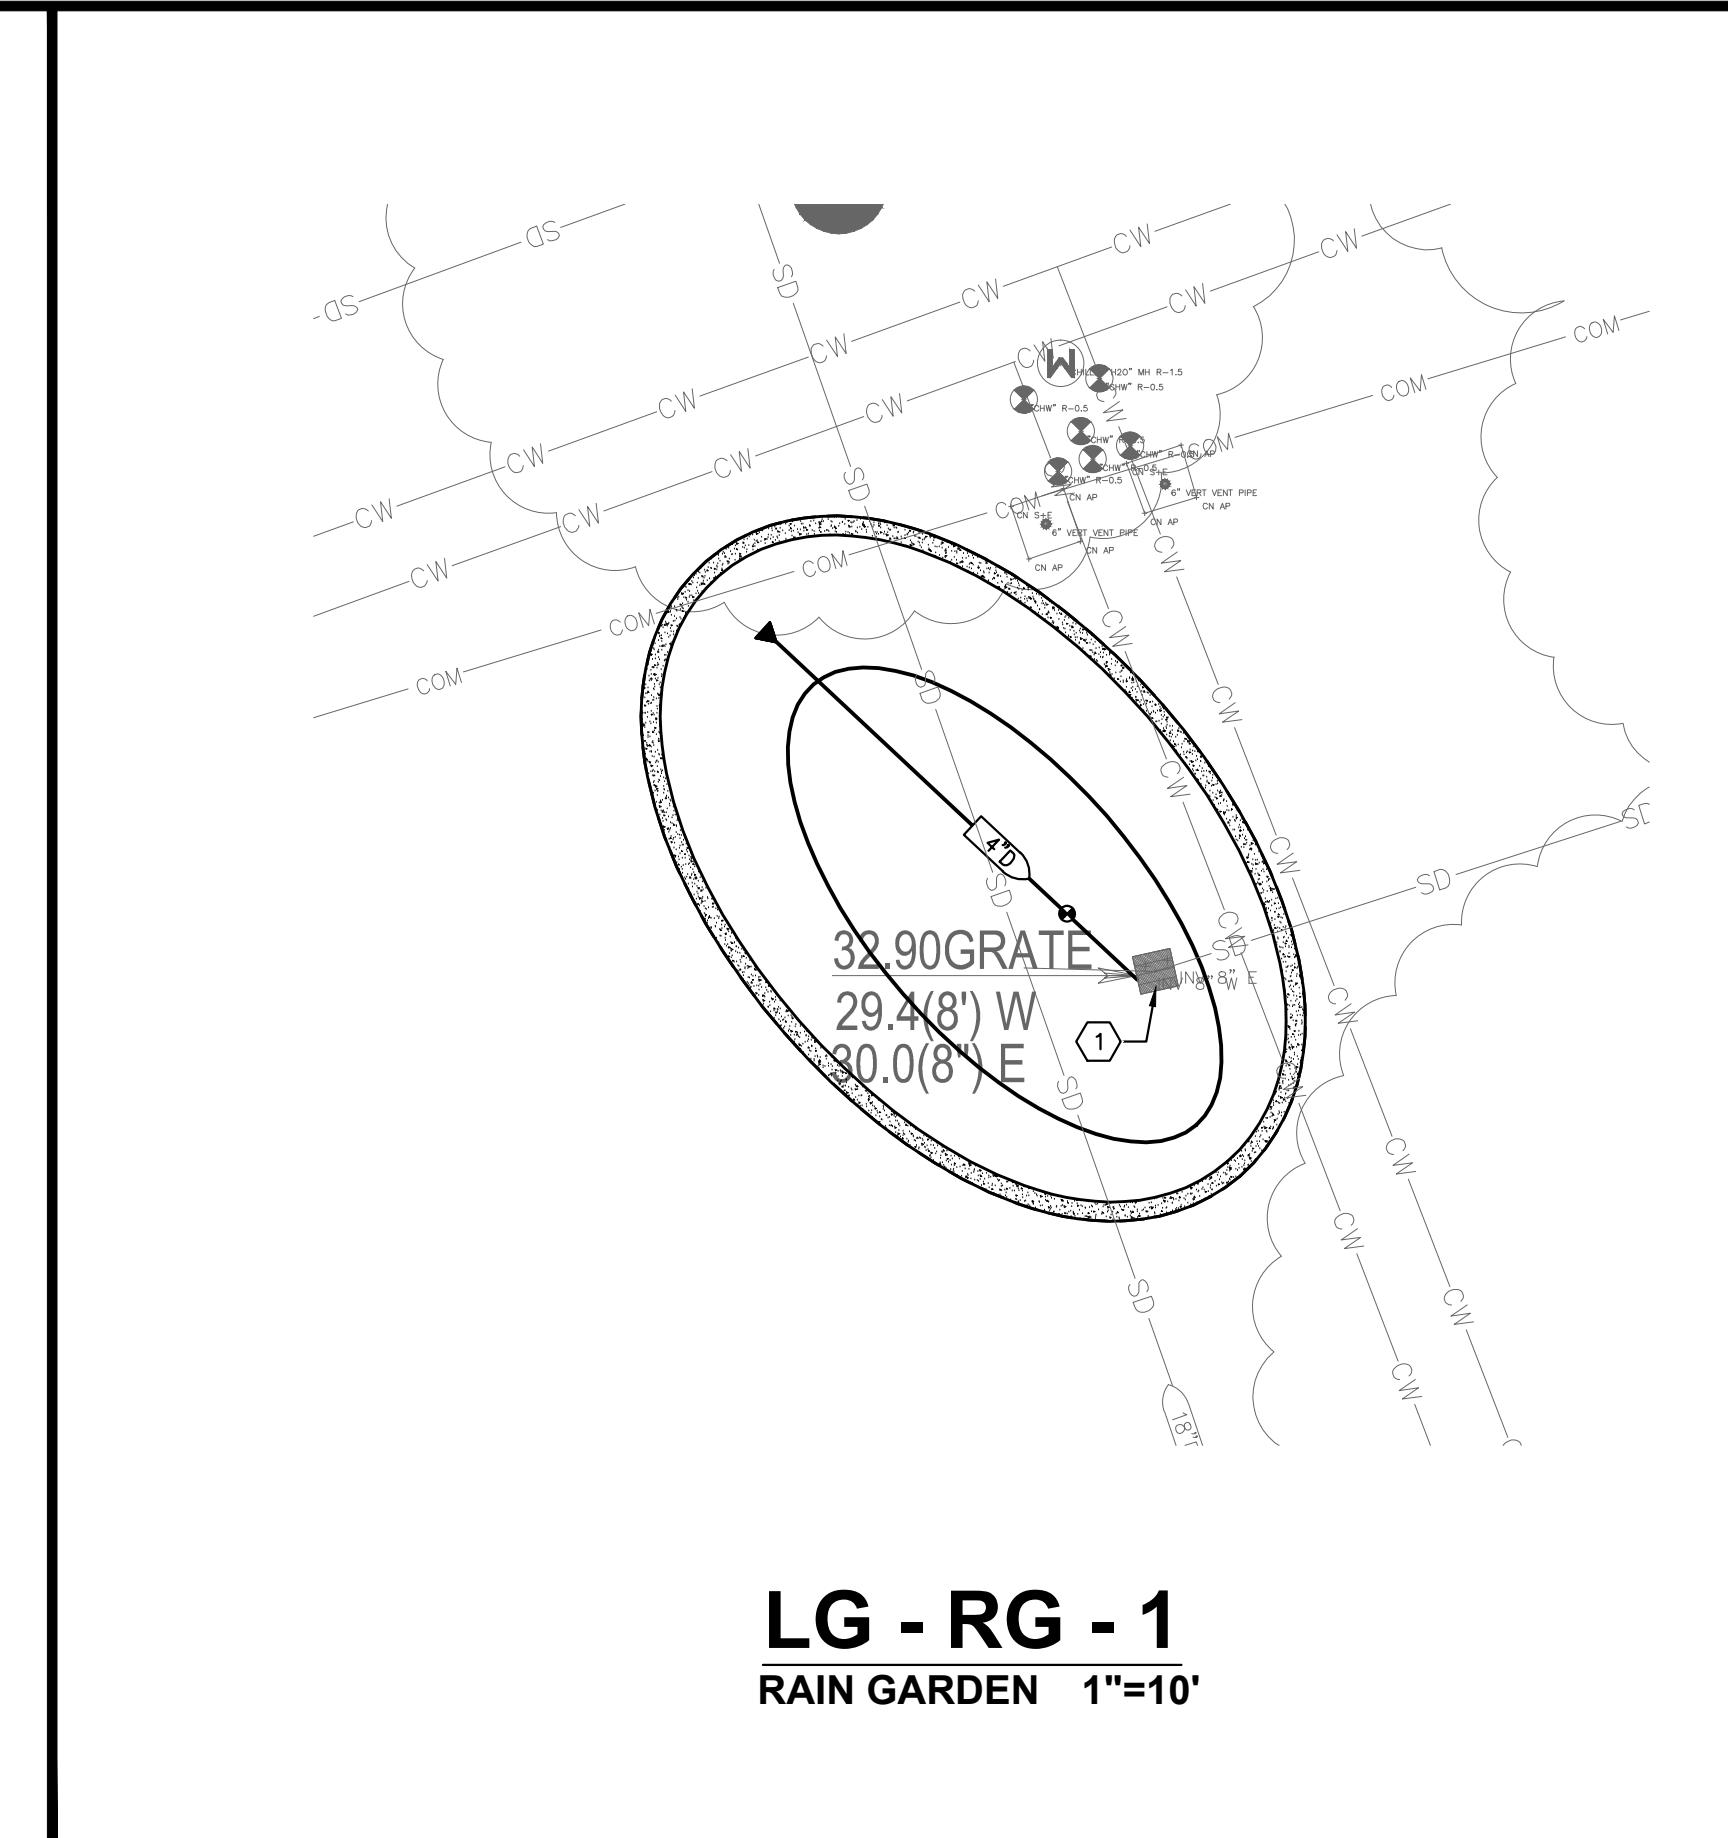
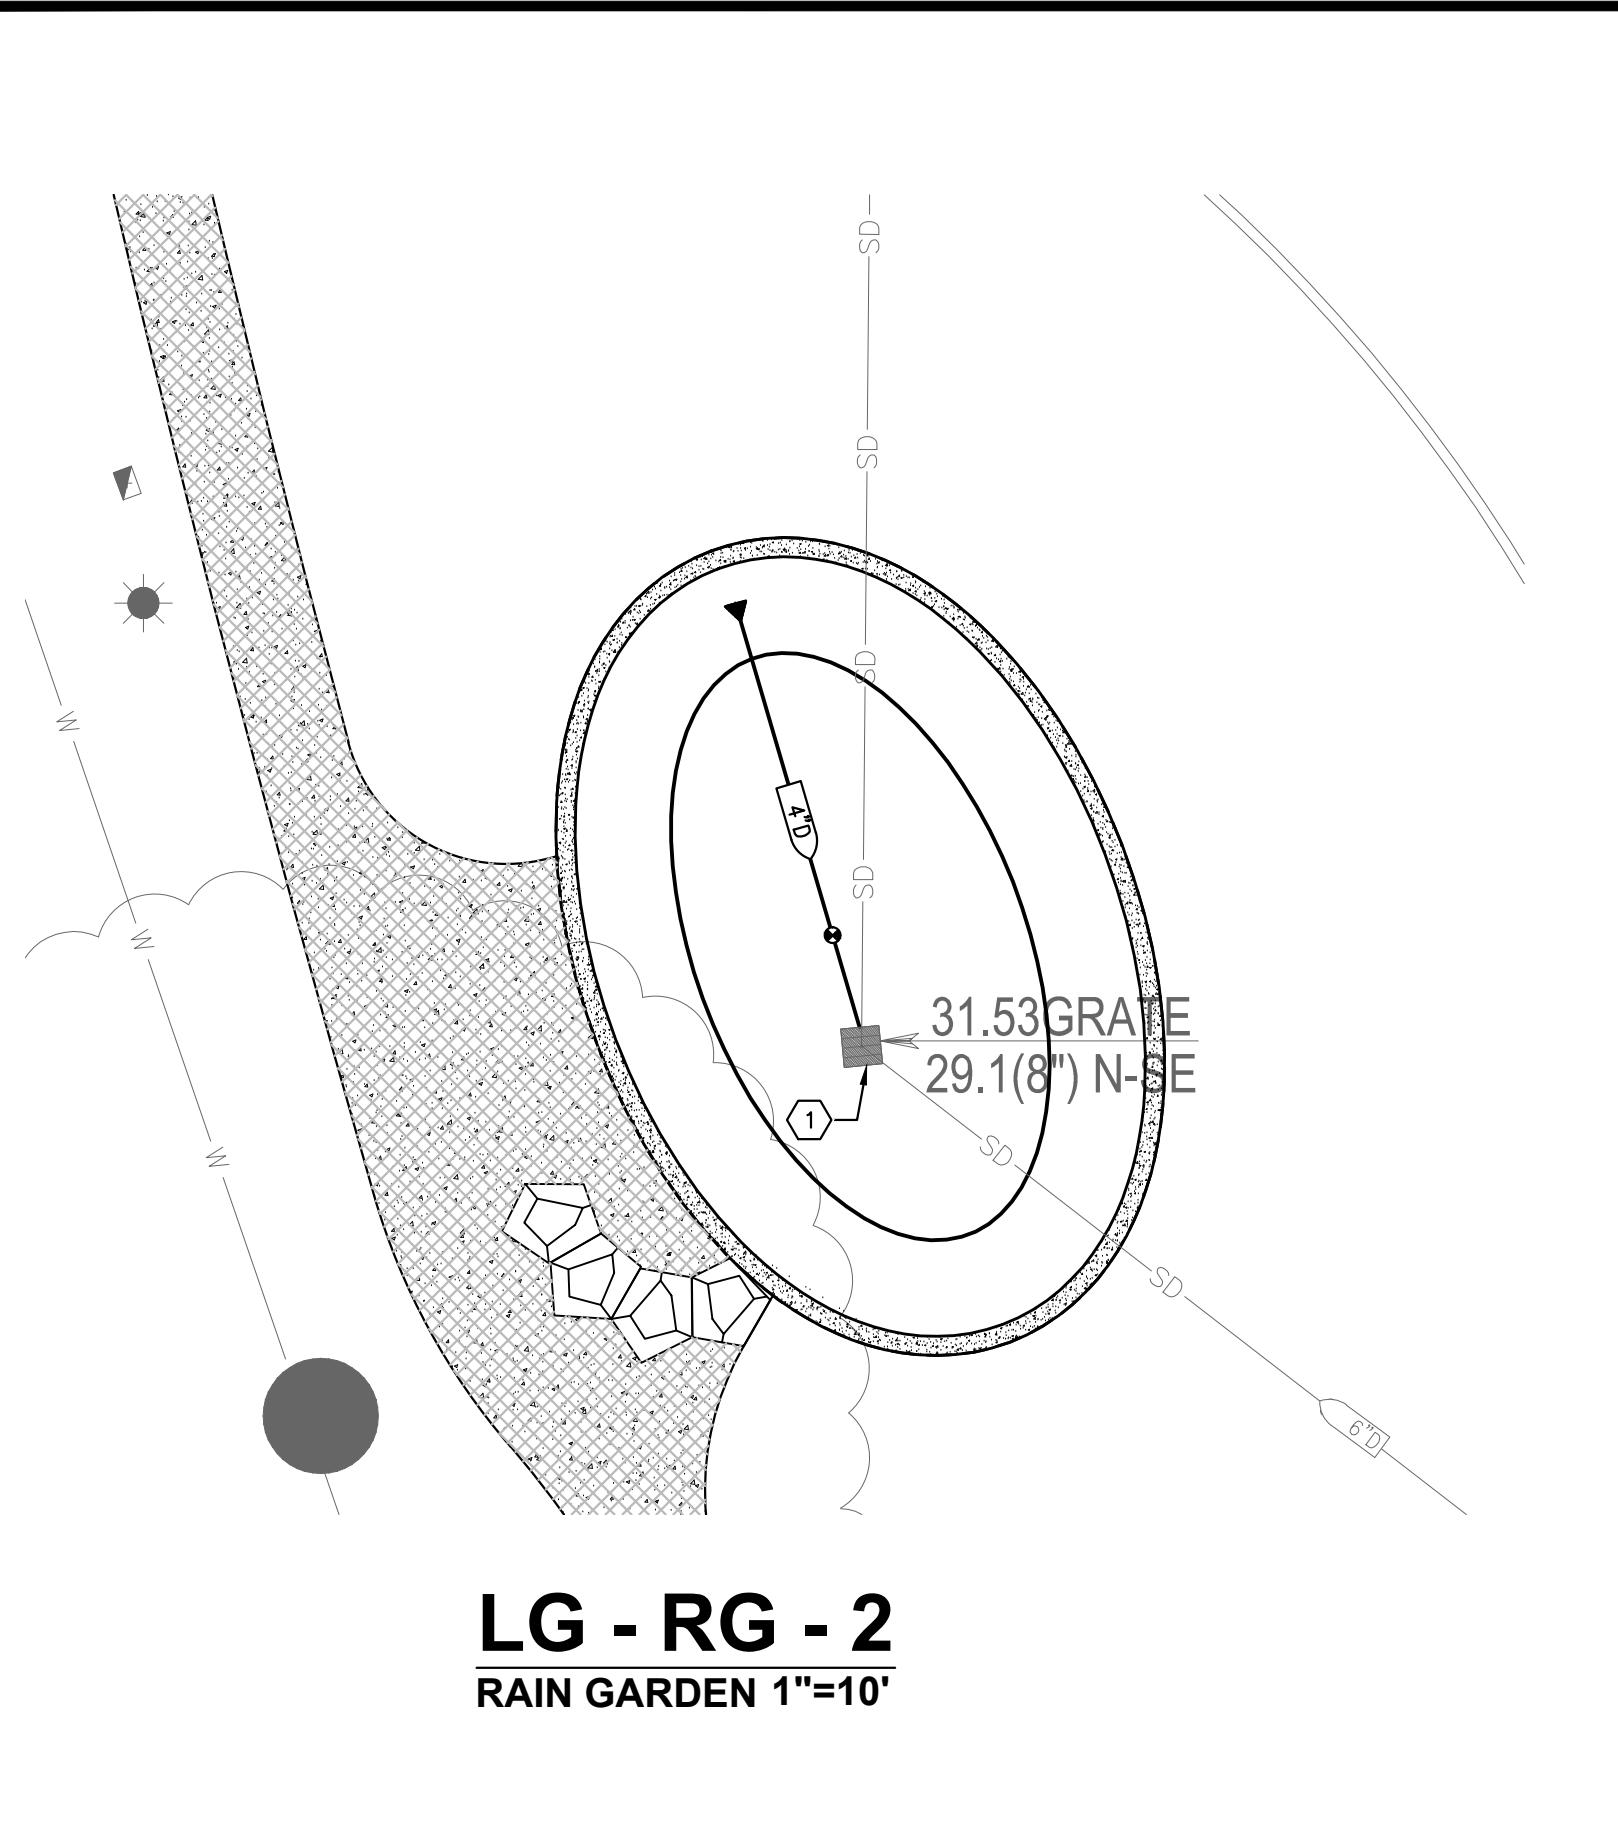
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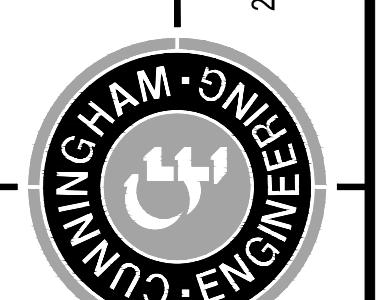
JOB NO: 1432.01

CALIFORNIA STATE UNIVERSITY SACRAMENTO  
**DEMOCRATIC PLAN**  
3  
15





NO.	DATE	REVISONS	BY	APPR'D.	DESIGNED BY	NC
CECWEST.COM						
Project Planning Civil Engineering Landscape Architecture						
Sacramento Office 2120 20th Street, Suite Three Davis Office 2940 Stafford Street, Suite 200 Sacramento, CA 95816 (916) 455-2026						

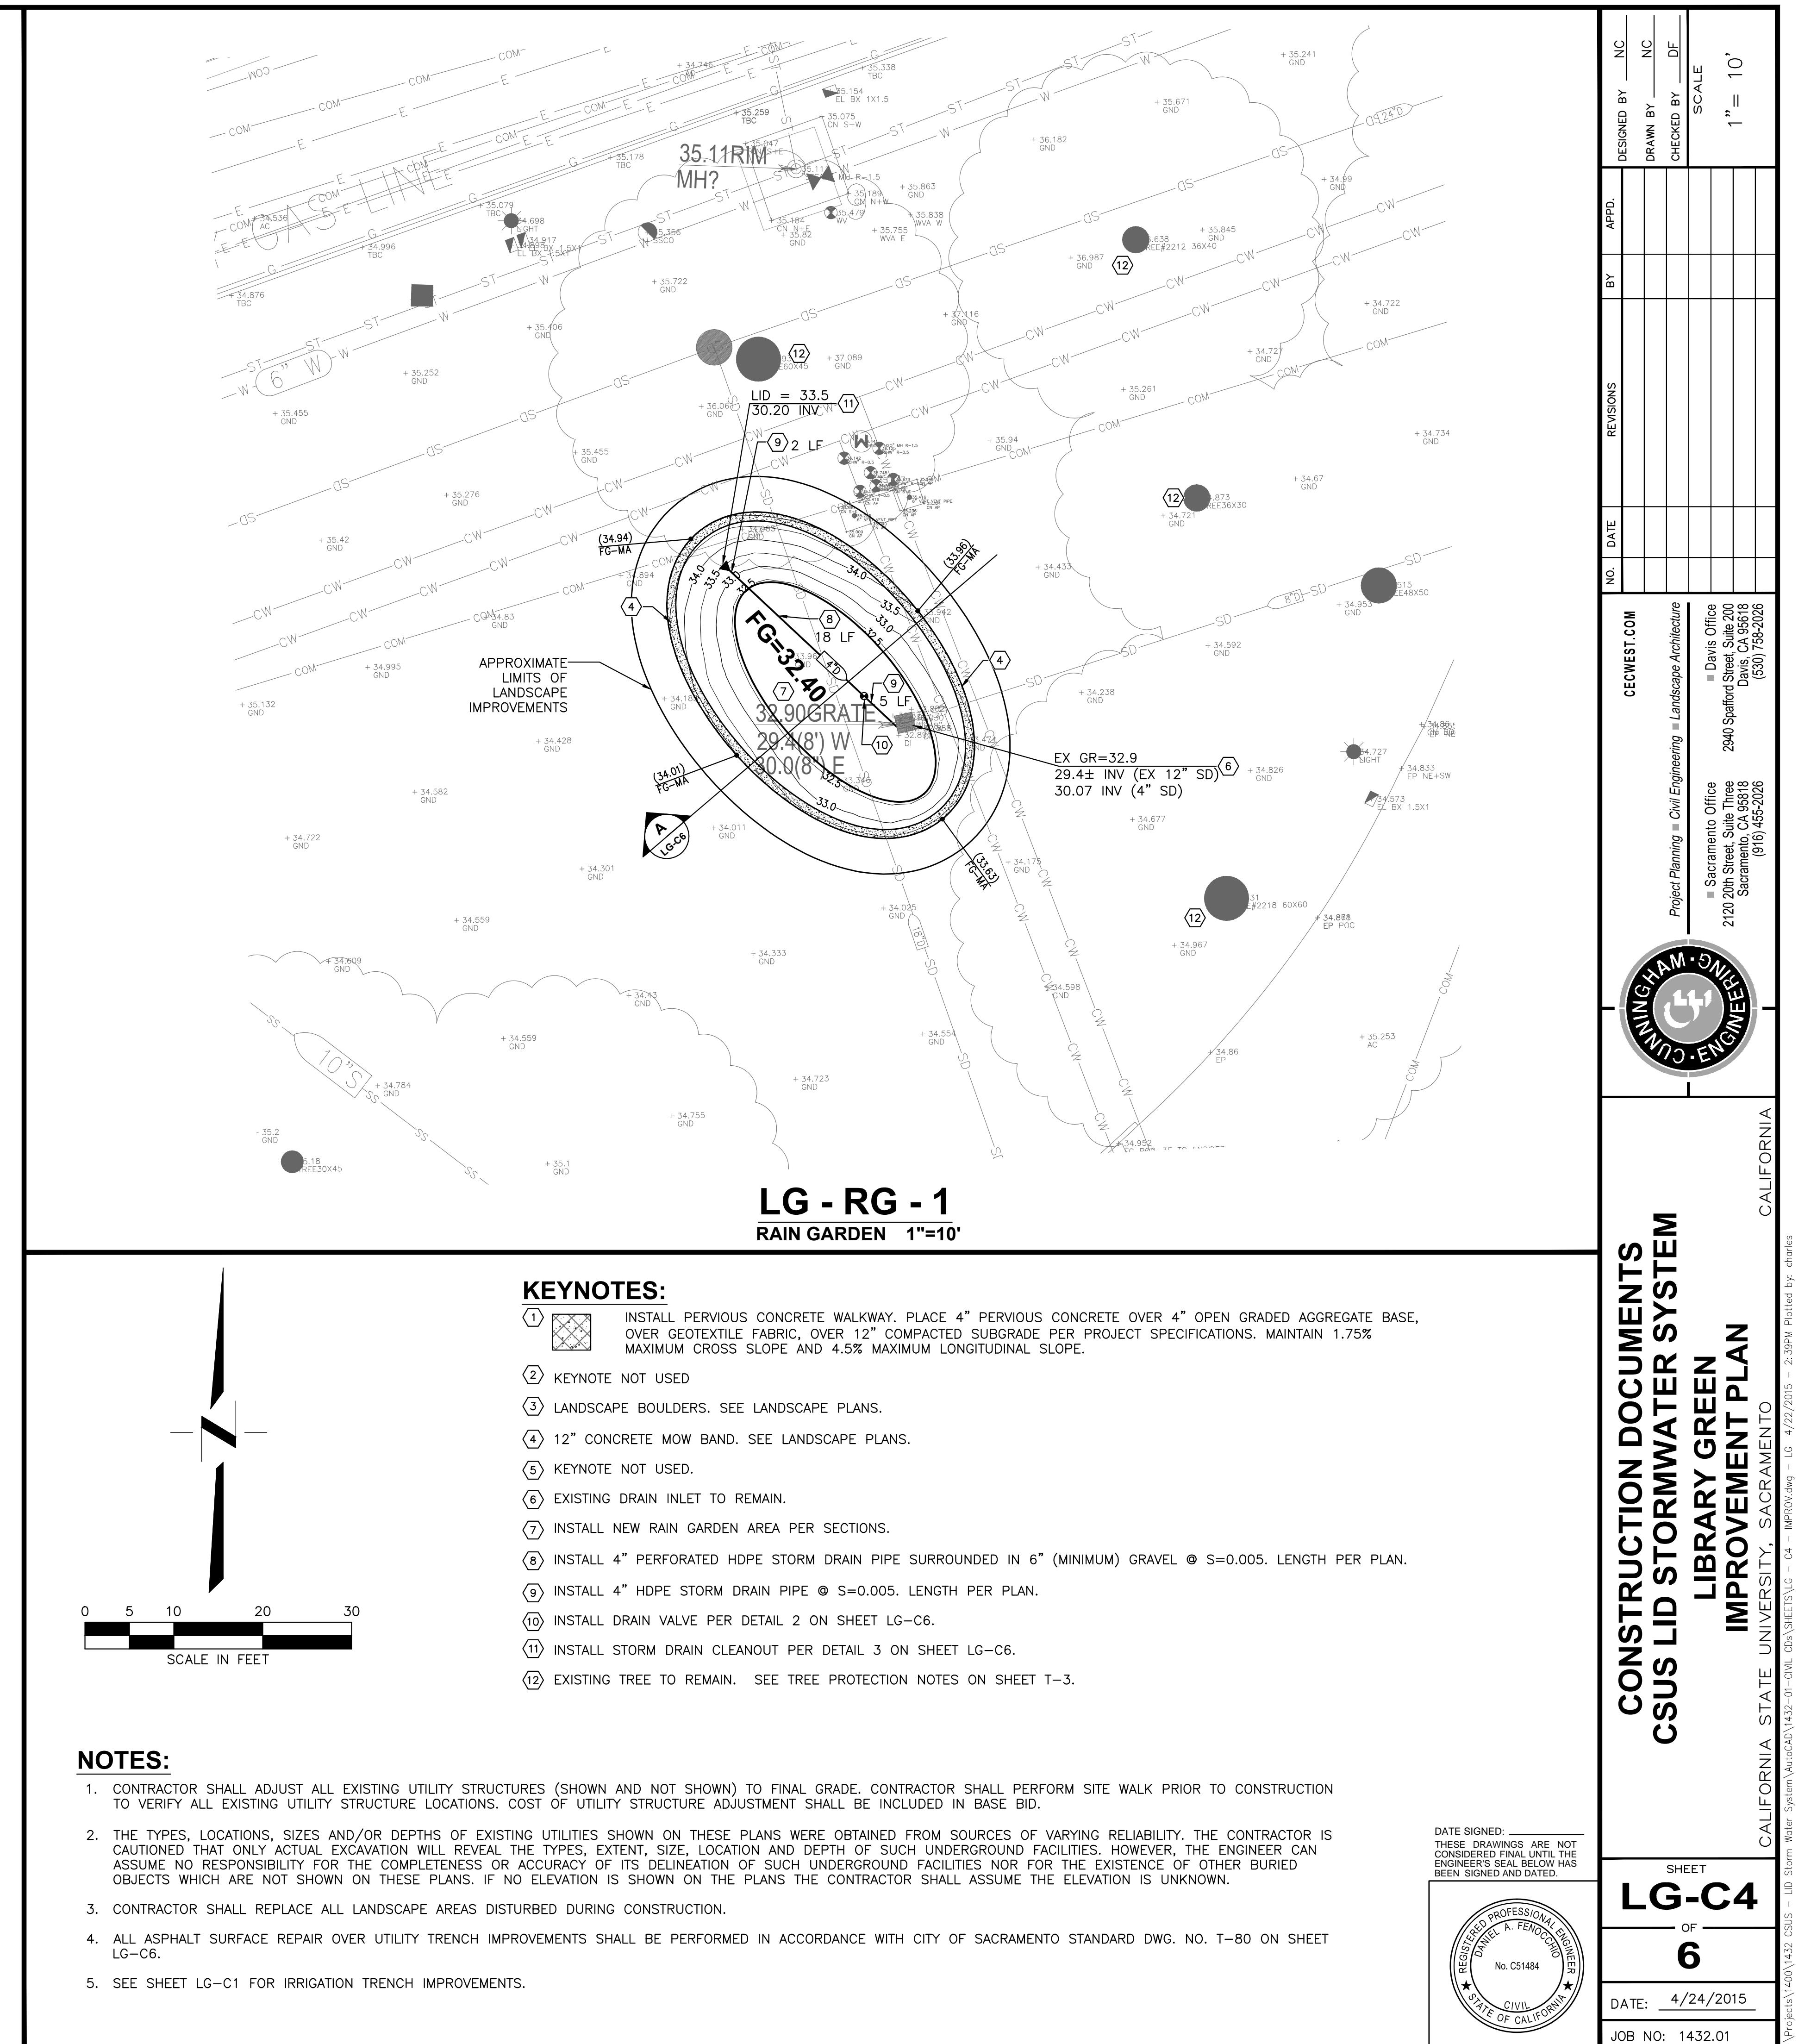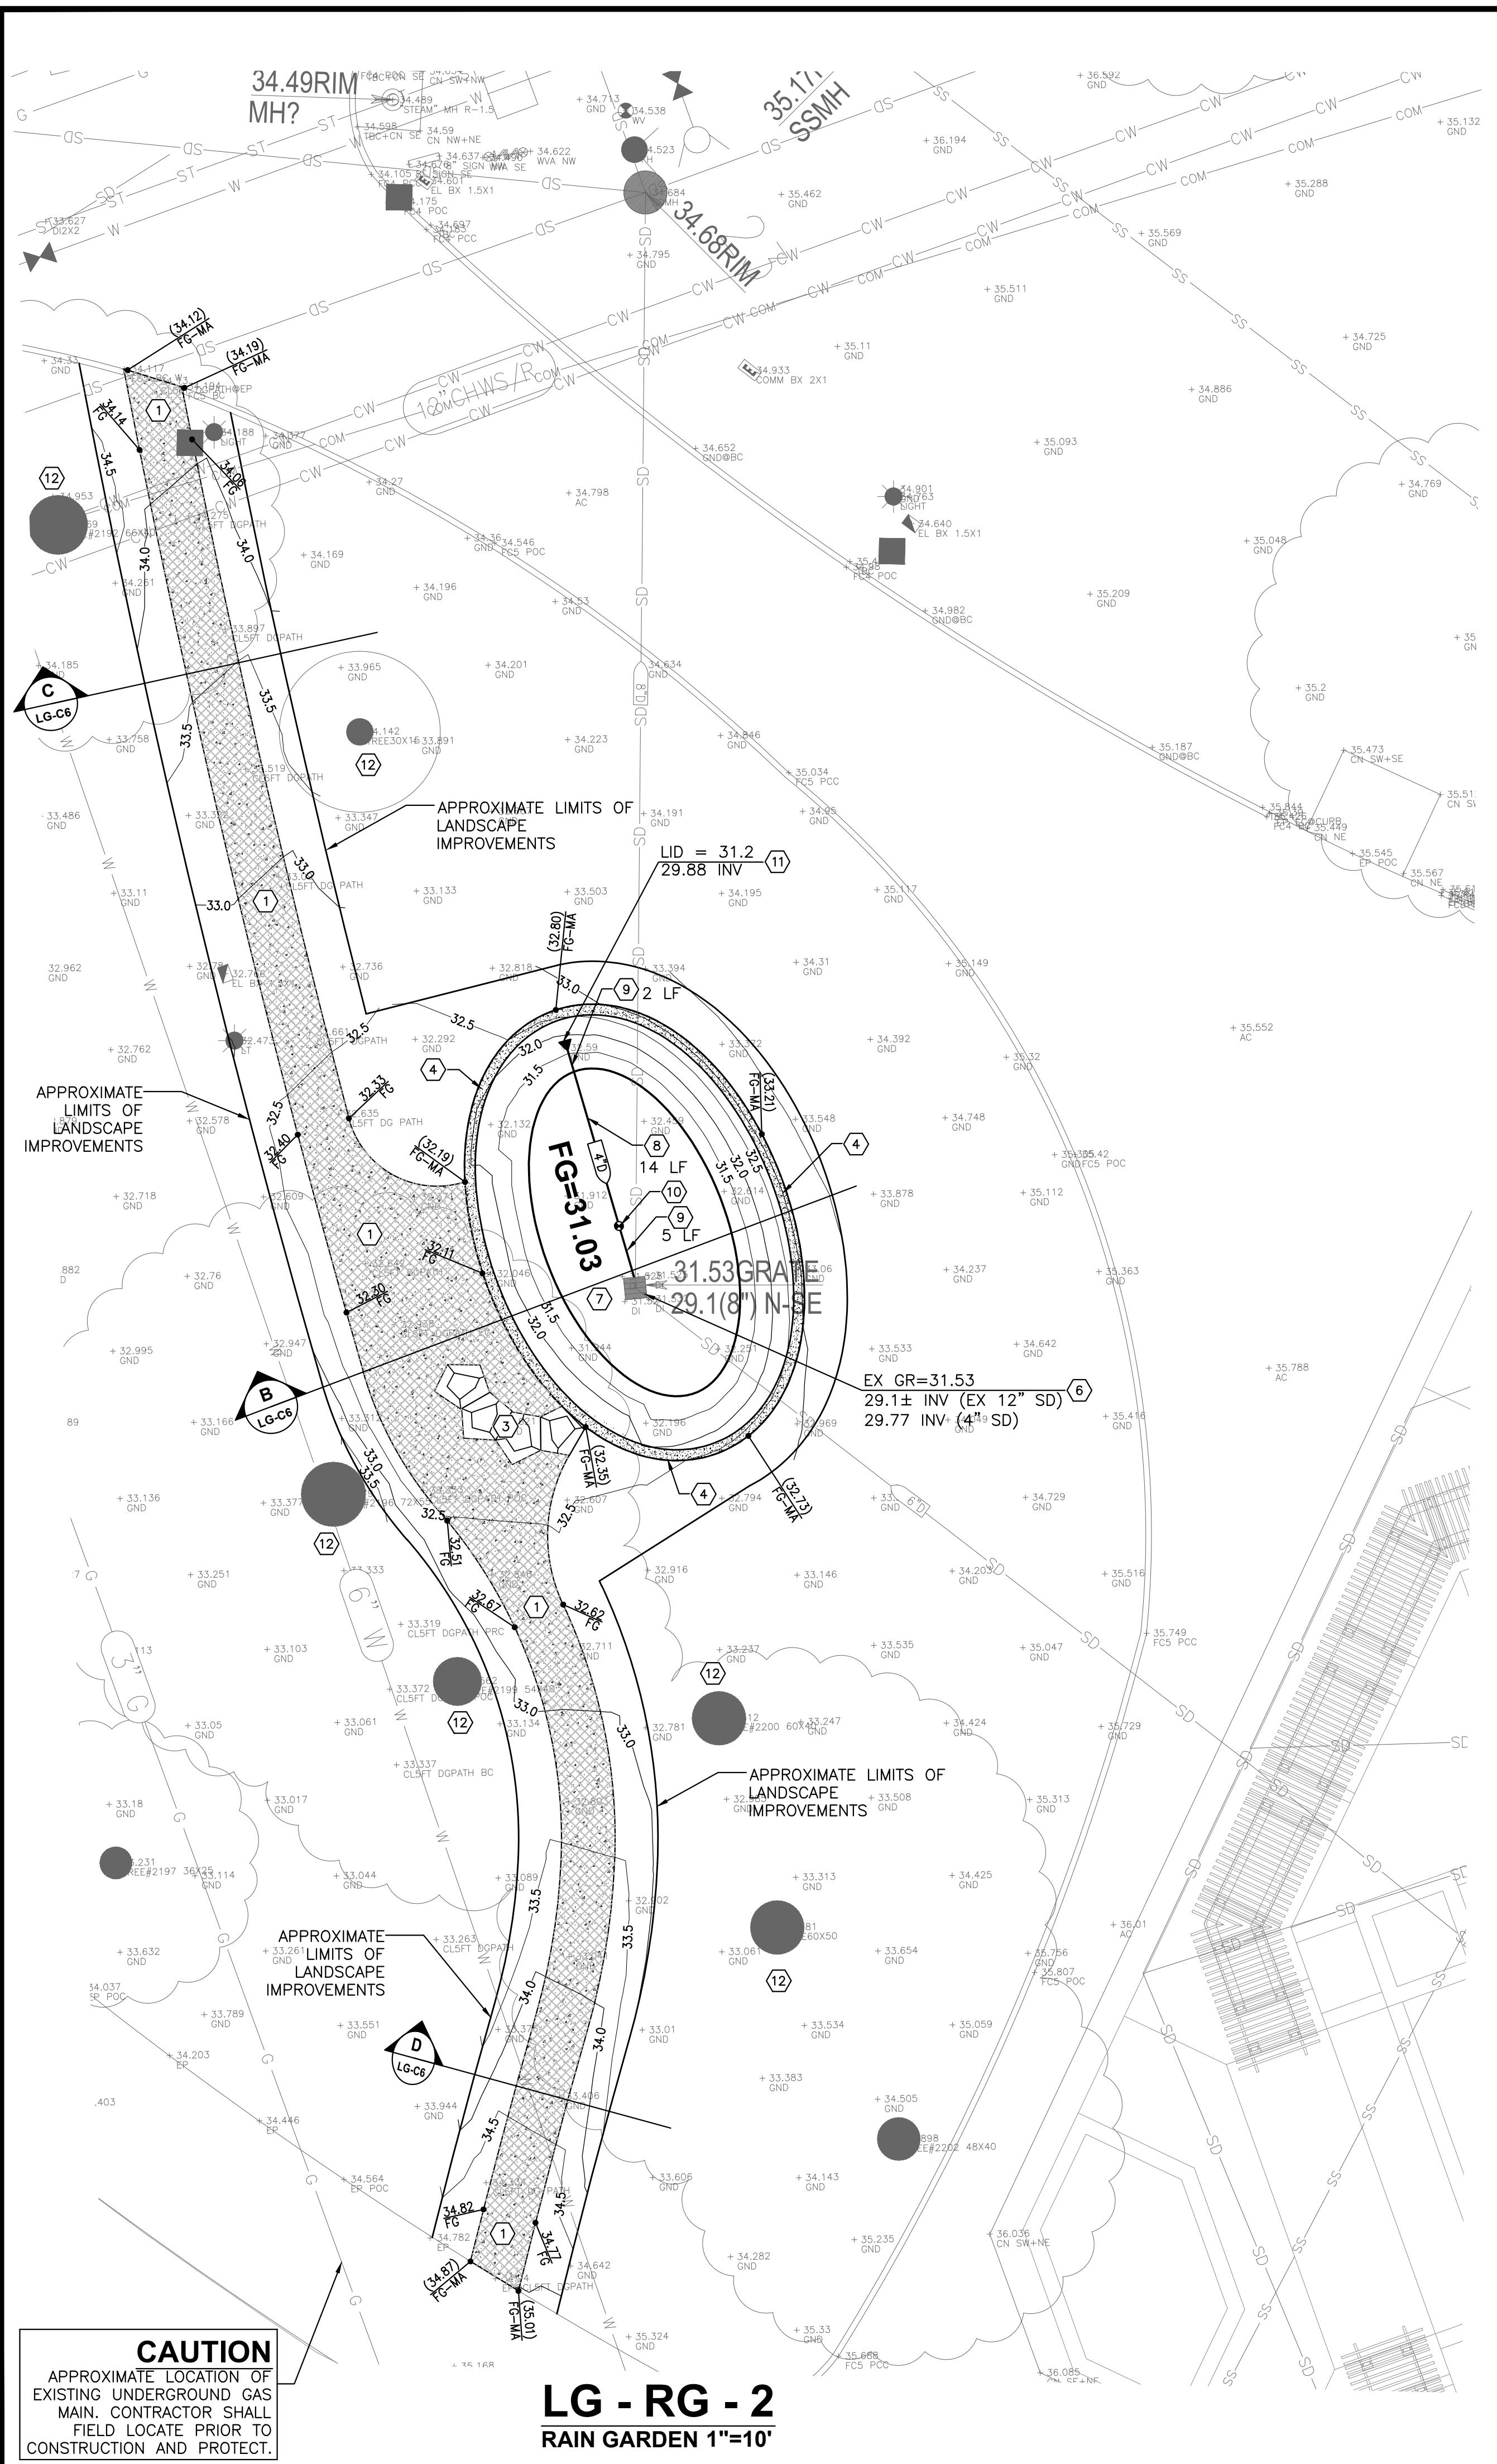

## CONSTRUCTION DOCUMENTS CSUS LID STORMWATER SYSTEM

CALIFORNIA STATE UNIVERSITY, SACRAMENTO

## LIBRARY GREEN EROSION CONTROL PLAN


CALIFORNIA STATE UNIVERSITY, SACRAMENTO


**LG-C5**

OF  
**6**

DATE: 4/24/2015

JOB NO: 1432.01

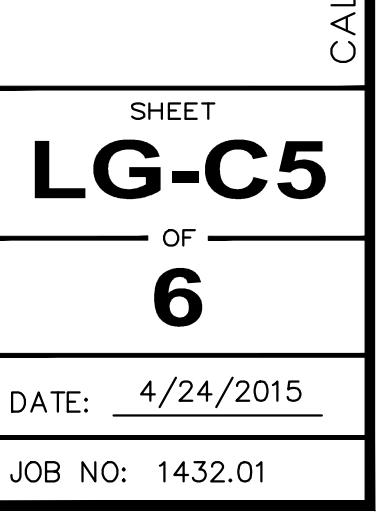

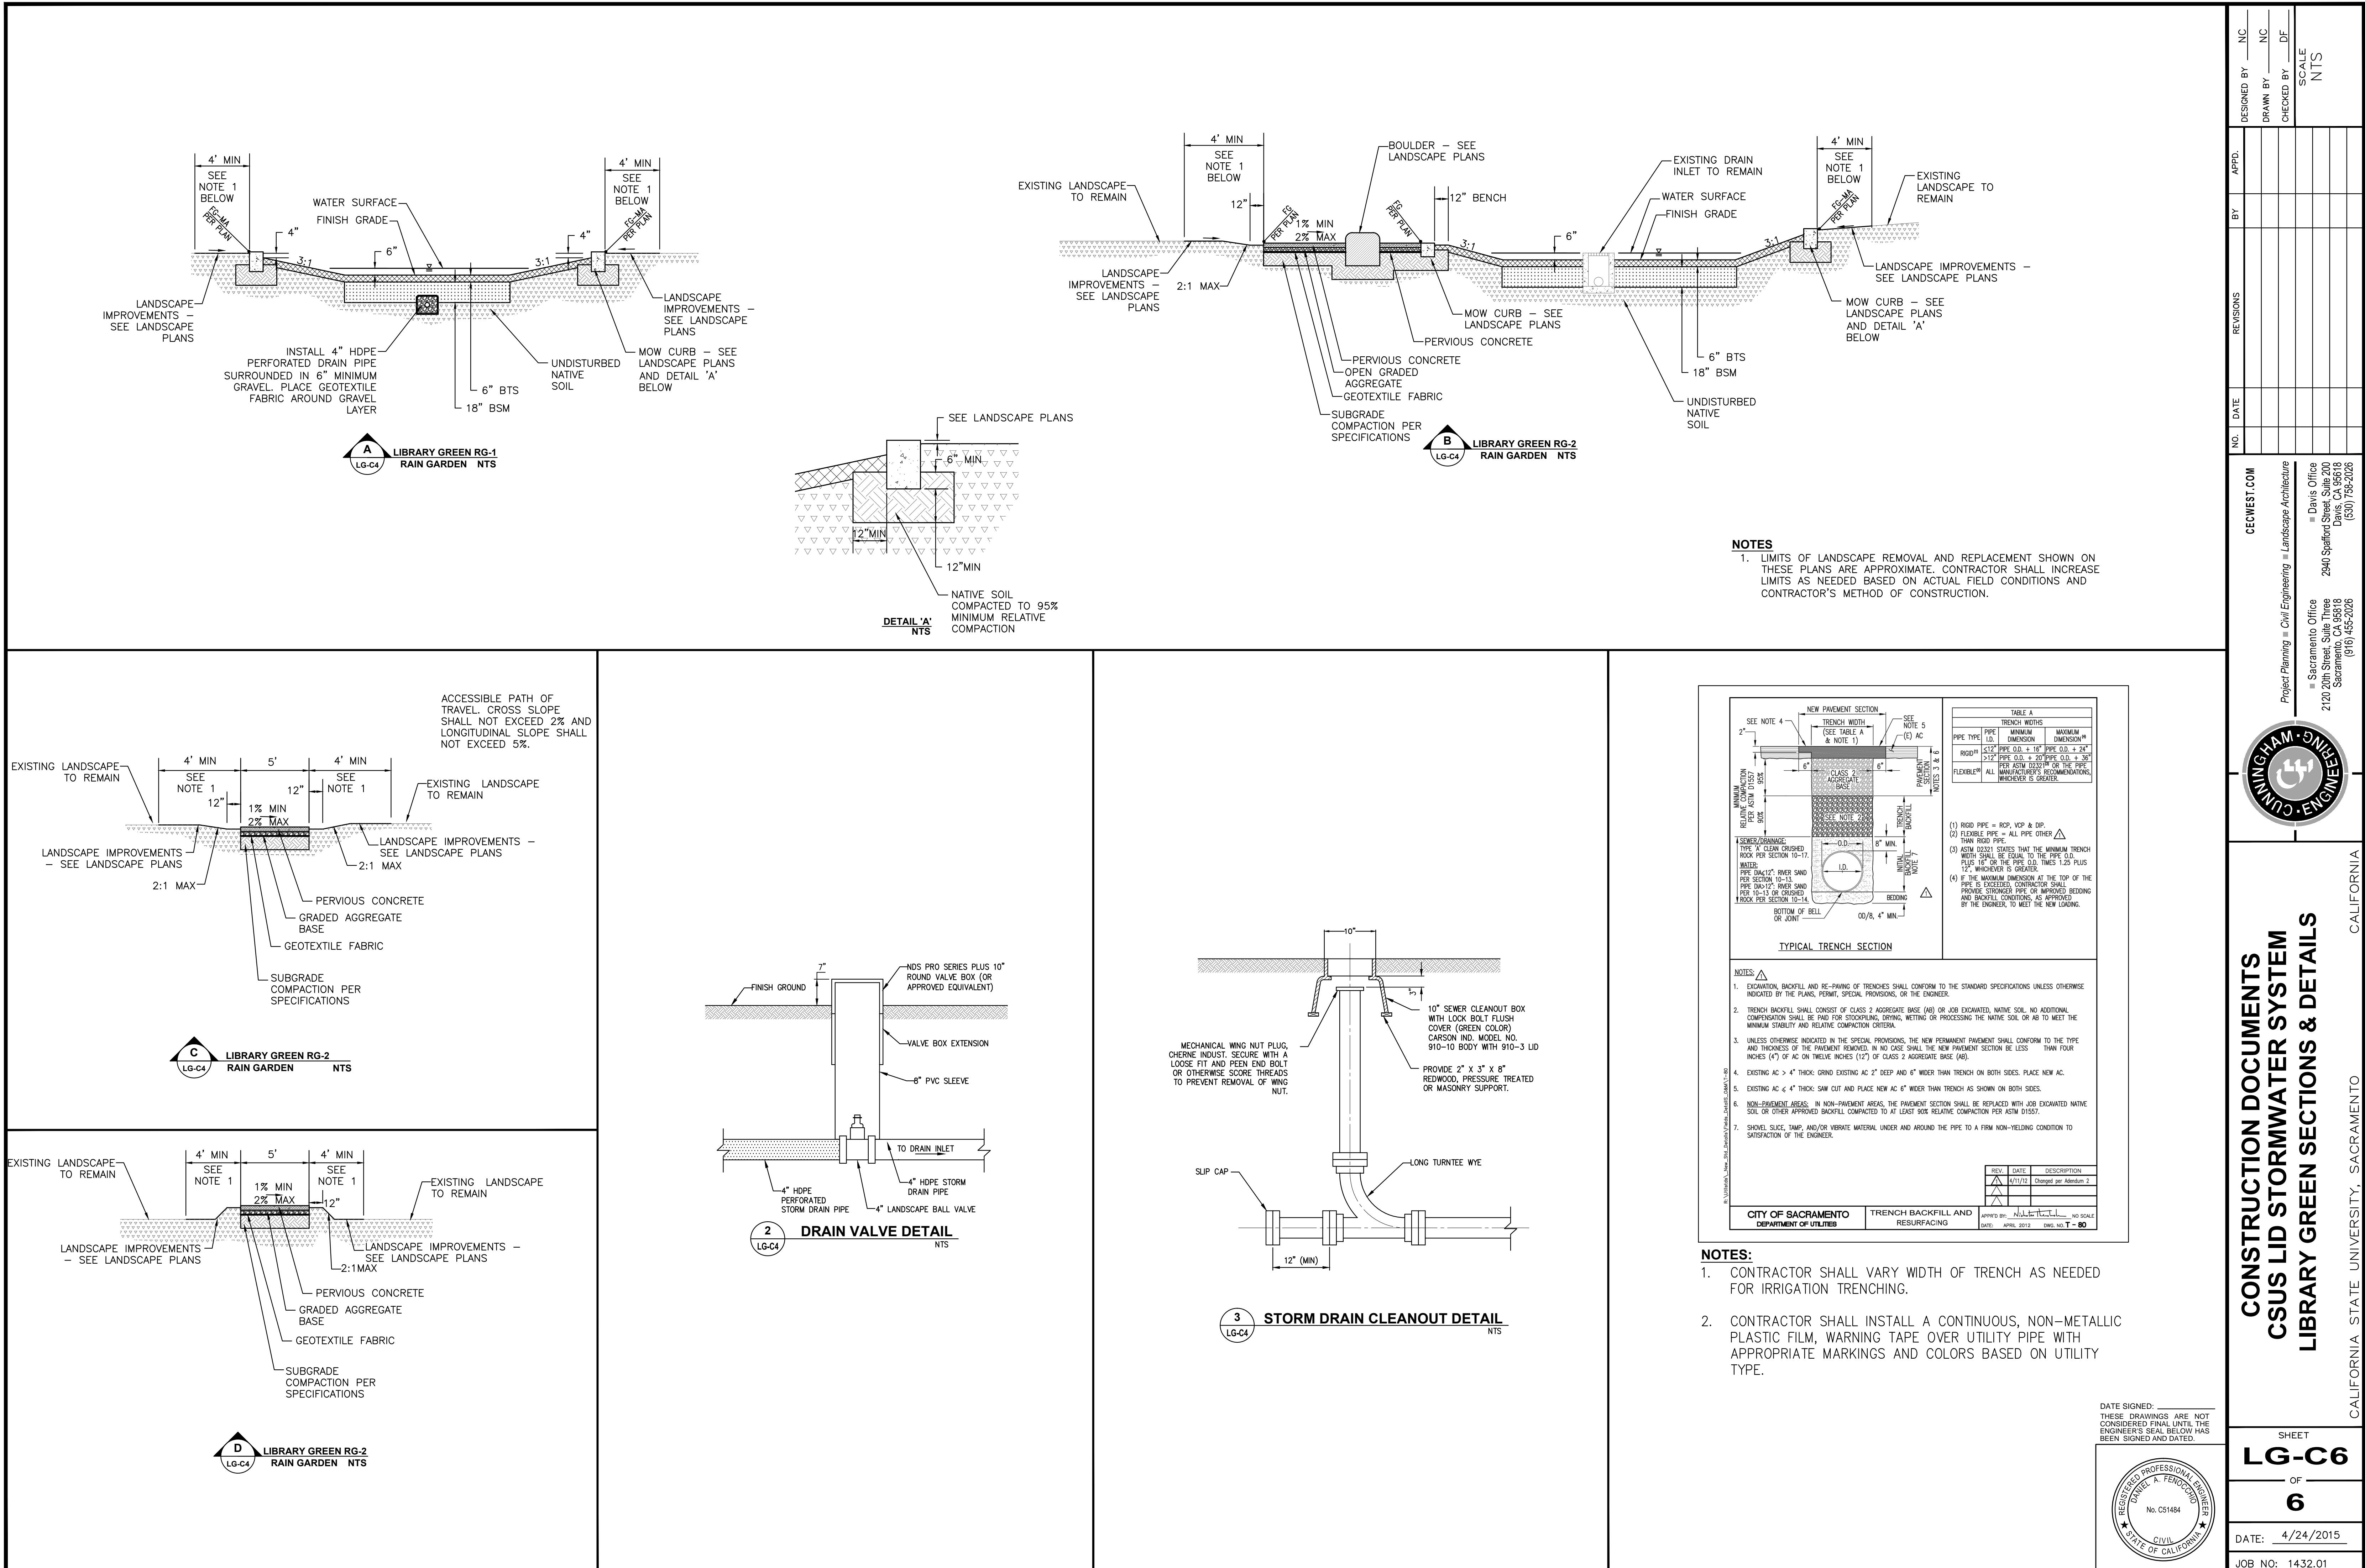

# CONSTRUCTION DOCUMENTS CSUSLID STORMWATER SYSTEM LIBRARY GREEN SECTIONS & DETAILS