

# VALPARAISO UNIVERSITY POLICE DEPARTMENT

# NEW POLICE STATION RENOVATIONS - 2015

813 LAPORTE AVENUE, VALPARAISO, IN, 46385

			TDIV	
		CODE MA		
	REQUIRED:	ACTUAL:	SECTION:	NOTES:
OCCUPANCY		BUSINESS - B	304.1	
CONSTRUCTION TYPE		TYPE V-B	602.5	
SPRINKLED		NONE		
AREA LIMIT	9,000 SFT / FLR	5,459 SFT / FLR.	503.1	NOTE 1
HEIGHT LIMIT	2 STORIES / 40'	1 STORIES / 8.5'	503.1	NOTE 1
FIRE SEPARATION	0 HOUR, X > 10'	0 HOUR / 29'	602	
FIRE RESISTANCE REQUIREMENTS:				
STRUCTURAL FRAME	0 HOUR	N/A	601	
BEARING WALLS	0 HOUR	N/A	601	
NON-BEARING WALLS (EXTERIOR)	0 HOUR	N/A	601	
NON-BEARING WALLS (INTERIOR)	0 HOUR	N/A	601	
FLOORS	0 HOUR	N/A	601	
ROOFS	0 HOUR	N/A	601	
CORRIDORS	1 HOUR	1 HOUR	1018.1	NOTE 2
STAIRWAYS	1 HOUR	N/A	1022.2	NOTE 7
TENANT SEPARATION	N/A	N/A		
EGRESS REQUIREMENTS:				
OCCUPANT LOAD		55 PERSONS	1004.1.2	NOTE 3
CORRIDOR WIDTH	36"	39" MIN.	1023.2	NOTE 8
TRAVEL DISTANCE	200'	75'-7" WORST CASE	1016.2	
COMMON PATH OF TRAVEL	75'	31'-0" WORST CASE	1014.3	
DEAD END CORRIDOR LENGTH	20'	14'-3" WORST CASE	1018.4	
EGRESS WIDTH, STAIRS	44" MINIMUM	34" / 45"	1009.4	NOTE 7
EGRESS WIDTH, DOORS	32" CLEAR WIDTH	34" CLEAR WIDTH	1008.1.1	
NUMBER OF EXITS PER STORY	2	1	1021.2(1)	
PLUMBING FIXTURES:				
WATER CLOSETS	3	6	2902.1	NOTE 4
LAVATORIES	2	10	2902.1	NOTE 5
DRINKING FOUNTAINS	1	1	2902.1	NOTE 6
SERVICE SINK	1	2	2902.1	

HEIGHT & AREA LIMITS DO NOT INCLUDE AREA INCREASE FOR FRONTAGE.

BASEMENT OCCUPANT LOAD IS LESS.

PER TABLE 2902.1, 1 PER 100 OCCUPANTS.

EXIST. CORRIDOR WALLS TO REMAIN CANNOT BE VERIFIED. NEW CORRIDOR WALLS TO MEET REQUIREMENT.


PER TABLE 2902.1, 1 PER 25 FOR THE FIRST 50 OCCUPANTS AND 1 PER 50 FOR THE REMAINDER EXCEEDING 50. PER TABLE 2902.1, 1 PER 40 FOR THE FIRST 80 OCCUPANTS AND 1 PER 80 FOR THE REMAINDER EXCEEDING 80.

REQUIRED WIDTH BASED ON OCCUPANT LOAD SERVED BY CORRIDORS PER SECTION 1005.3.2.

PER SECTION 1004.1.2, OCCUPANT LOAD BASED ON 2,721 GSFT PER FLOOR / 200 GROSS SFT PER PERSON. BASED ON FIRST FLOOR;

EXIST. INTERIOR STAIR TO REMAIN IS 34" WIDE & STAIRWAY ENCLOSURE IS NOT A RATED ASSEMBLY. EXIST. EXTERIOR STAIR TO REMAIN

	NON-RESIDENTIAL:			
	REQUIRED:	REFERENCE:	ACTUAL:	REFERENCE:
ROOF ASSEMBLY:				
(INSULATION ENTIRELY ABOVE DECK)	U-0.048 / R-20.0 c.i.	TABLE 5.5-5	EXISTING TO REMAIN	N/A
WALLS, ABOVE GRADE:				
(WOOD FRAMED)	U-0.064 / R13.0 + R-3.8 c.i.	TABLE 5.5-5	EXISTING TO REMAIN	N/A
FLOORS:				
SLAB ON GRADE FLOORS:				
(HEATED)	U-0.86 / R-15 for 24"	TABLE 5.5-5	EXISTING TO REMAIN	N/A
OPAQUE DOORS:				
(SWINGING, NON-STOREFRONT)	U-0.70	TABLE 5.5-5	U-0.091 / R-11.0	MANUF. RATING
FENESTRATION:				
(VERTICAL GLAZING / NON-METAL)	U-0.35 / SHGC-0.40	TABLE 5.5-5	EXISTING TO REMAIN	N/A

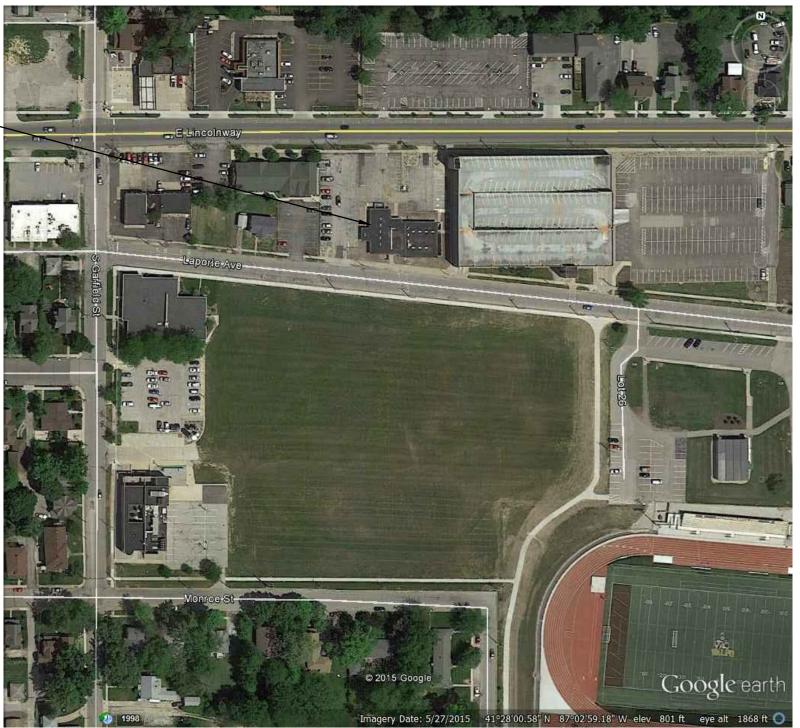



Scale: NTS

### **DRAWING INDEX:**

**COVER SHEET COVER SHEET** 

SITE PLAN

STRUCTURAL DRAWINGS:

#### ARCHITECTURAL DRAWINGS:

LOWER LEVEL DEMOLITION PLAN A110 FIRST FLOOR DEMOLITION PLAN A120

A130 FIRST FLOOR PLAN

A140 LOWER LEVEL REFLECTED CEILING PLAN A150 FIRST FLOOR REFLECTED CEILING PLAN

LOWER LEVEL FLOOR PLAN

A200 EXTERIOR ELEVATIONS A210 EXTERIOR ELEVATIONS

A400 INTERIOR ELEVATIONS, SCHEDULES & DETAILS

#### **ELECTRICAL DRAWINGS:**

E100 LOWER LEVEL POWER / AUXILIARY PLAN E110 FIRST FLOOR POWER / AUXILIARY PLAN

### **GENERAL NOTES:**

- 1. CONTRACTOR TO VERIFY ALL EXISTING CONDITIONS AND NOTIFY ARCHITECT OF ANY
- DISCREPANCIES. 2. SITE & OTHER DEMOLITION SHALL BE CLEAN AND COMPLETE. PATCH OR REPAIR ALL EXISTING
- CONSTRUCTION TO REMAIN AS REQUIRED TO MATCH SURROUNDING SIMILAR CONSTRUCTION. 3. CONTRACTOR TO PROVIDE ALL TEMPORARY SHORING, BRACING, BARRIERS, PARTITIONS,
- FENCING, SILT CONTROL MEASURES OR OTHER TEMPORARY FACILITIES AS REQUIRED.
- 4. MAINTAIN EXISTING CONSTRUCTION OR UTILITIES TO REMAIN IN A SAFE AND WEATHER-TIGHT CONDITION THROUGHOUT CONSTRUCTION.
- 5. DO NOT SCALE DRAWINGS. ALL DIMENSIONS NOTED ARE TO BE VERIFIED IN THE FIELD. NOTIFY
- ARCHITECT OF ANY DISCREPANCIES. 6. CONTRACTOR IS RESPONSIBLE FOR SECURING ALL REQUIRED BUILDING PERMITS AND ANY OTHER
- REQUIRED APPROVALS. 7. ALL CONSTRUCTION AND INSTALLATION SHALL COMPLY WITH ALL APPLICABLE STATE AND

LOCAL CODES, ORDINANCES AND REGULATIONS.

I HEREBY CERTIFY THAT THESE PLANS HAVE BEEN PREPARED BY ME AND UNDER MY DIRECT SUPERVISION AND ARE, TO THE BEST OF MY KNOWLEDGE, IN ACCORDANCE WITH THE RULES AND REGULATIONS OF THE INDIANA DEPARTMENT OF FIRE PREVENTION AND BUILDING SAFETY



DAVID R. HILL, INDIANA LICENSE #AR10600080

# M2Ke design

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**VALPARAISO UNIVERSITY POLICE DEPARTMENT** 

> **NEW POLICE** STATION **RENOVATIONS**

813 LAPORTE AVE., VALPARAISO, INDIANA


•	MARK	DATE	DESCRIPTION
•	1	10/26/15	75% CDs
•	2	11/12/15	95% CDs
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COVER	
SHEET	


SCALE: N.T.S. CLIENT: DATE: 10/07/15 PROJECT:

DRAWN: DRH

FILE: 029001A-A000-CS

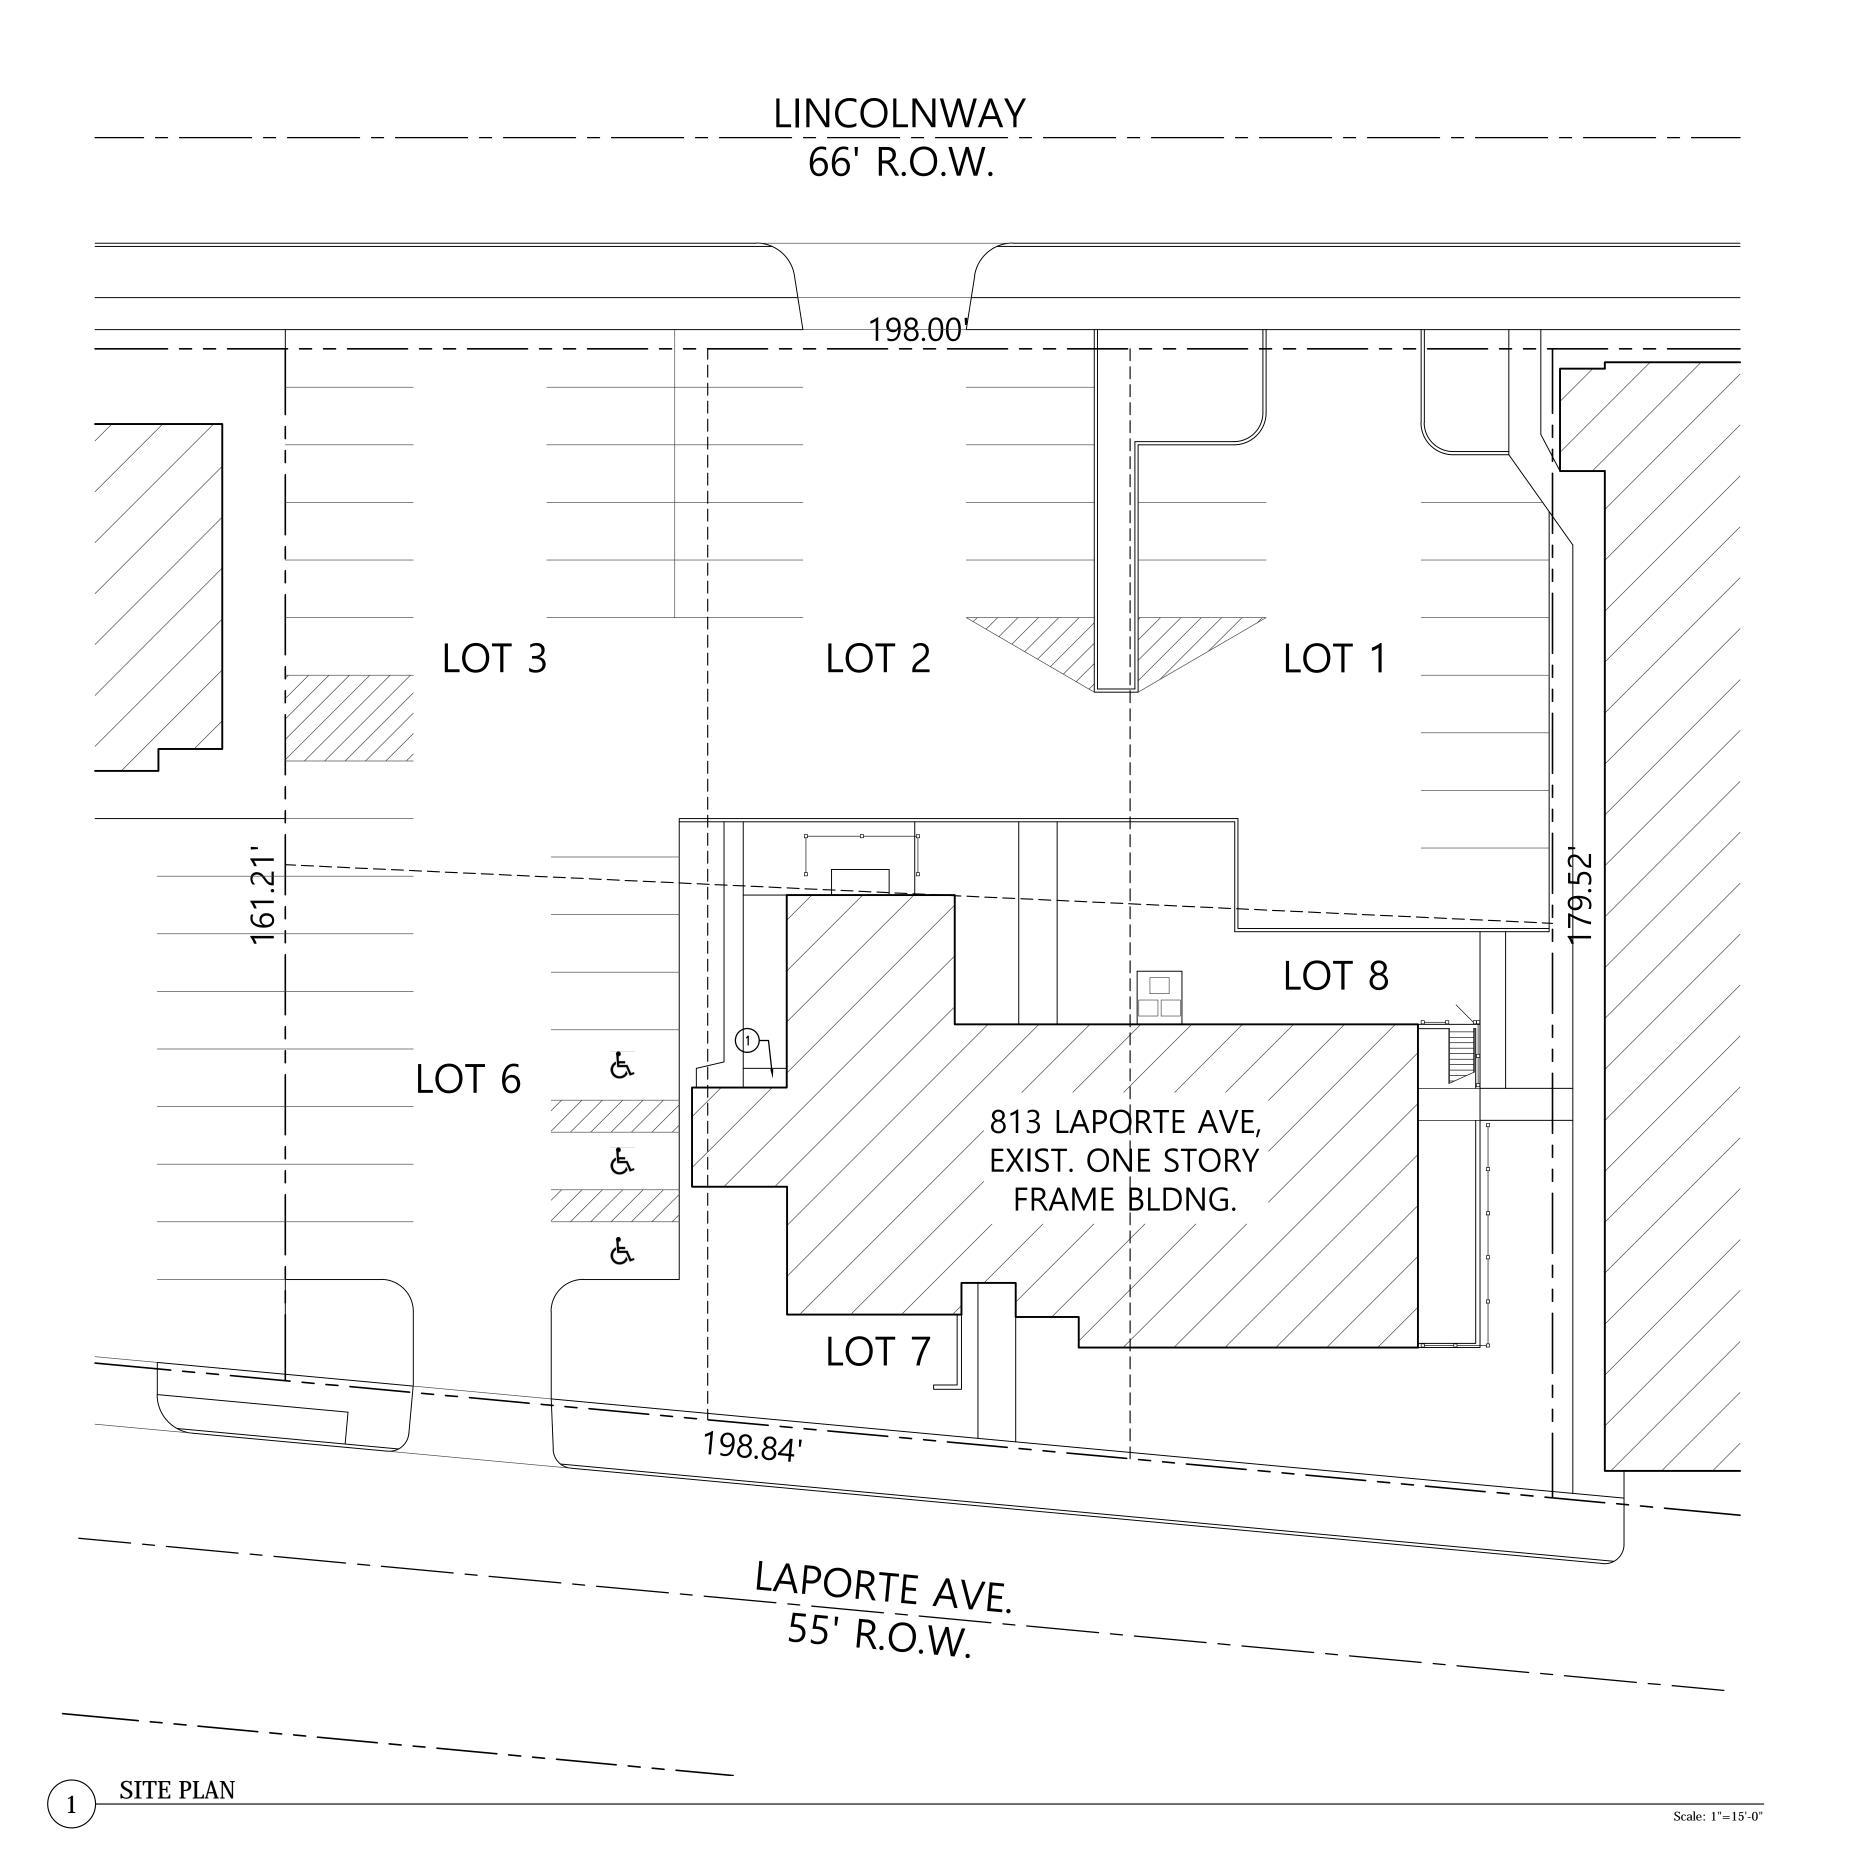


SITE PLAN SYMBOLS:

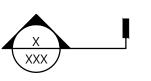


SECTION

SECTION CUT SYMBOL

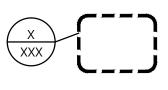

ELEVATION DETAIL SYMBOL

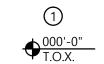

ELEVATION NOTE DESIGNATION

ELEVATION HEIGHT DESIGNATION

#### GENERAL SITE PLAN NOTES:

- all site improvements shown are existing to re
- JNLESS NOTED OTHERWISE.
- 2. PATCH & RE-SURFACE EXISTING ASPHALT PARKING LOT AS REQUIRED AND RE-STRIPE AS INDICATED.
- 3. LANDSCAPING TO BE PROVIDED BY OTHERS.

#### KEYED SITE PLAN NOTES:

1. PROVIDE NEW CONCRETE SIDEWALK IN THIS AREA.



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## VALPARAISO UNIVERSITY POLICE DEPARTMENT

NEW POLICE STATION RENOVATIONS 2015

813 LAPORTE AVE., VALPARAISO, INDIANA

MARK	DATE	DESCRIPTION
1	11/12/15	95% CDs

SI	TE
Ы	AN

SCALE: 1"=15'-0" CLIENT:


DATE: 10/07/15 PROJECT: 029001

DRAWN: DRH

APPRVD: DRH

C100


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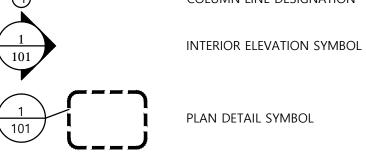
LOWER LEVEL FLOOR PLAN

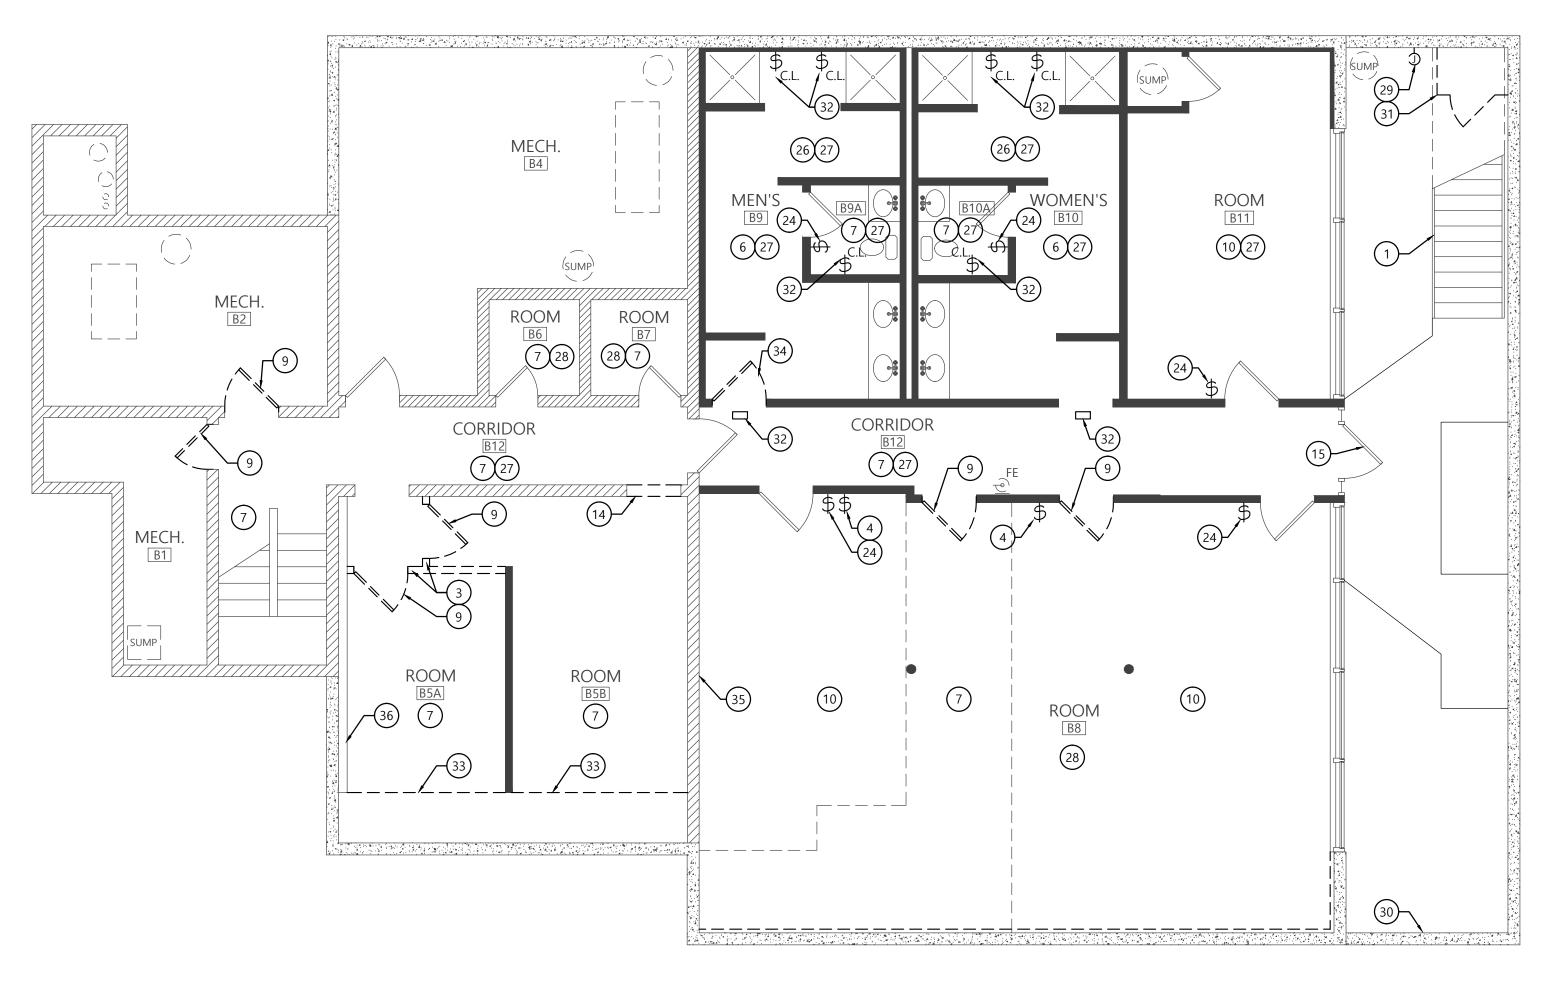Scale: 3/16"=1'-0"

#### PLAN SYMBOLS:



COLUMN LINE DESIGNATION

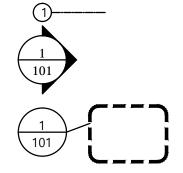

EXISTING WALLS TO REMAIN



EXIST. LIGHT FIXTURES FROM NEW SWITCHES OR SWITCH LOCATIONS.

COMPLETE IN THIS ROOM OR AREA. PREP EXISTING SUBSTRATES FOR

26. DEMOLISH EXIST. RUBBER FLOOR FINISH, ADHESIVES AND WALL BASE

27. REMOVE & DISPOSE OF EXIST. CEILING TILE IN THIS AREA OR ROOM.

28. DEMOLISH EXIST. CEILING GRID, TILE, LIGHT FIXTURES, DIFFUSERS &

29. DEMOLISH EXIST. POWER FEED TO EXIST. STAIR SNOW MELT SYSTEM.

30. REMOVE EXIST. BACK-BOX, CONDUIT & WIRING COMPLETE BACK TO

32. DEMOLISH EXIST. CALL LIGHT SWITCH, HALL LIGHT, BACK-BOXES,

BRANCH DUCTS, AND ACCESSORIES COMPLETE, TO INCLUDE EXIST.

REMOVE BACK-BOX, CONDUIT & WIRING COMPLETE BACK TO PANEL.

33. DEMOLISH UPPER PORTION OF FORMER GYP. BD. PARTITION, TO INCLUDE

34. REMOVE EXIST. DOOR SLAB & HARDWARE. EXIST. FRAME TO REMAIN.

36. REMOVE EXIST. DRAIN, VENT OR WATER SUPPLY LINES. CAP & VALVE

37. REMOVE EXIST. EXIT SIGN, EM LIGHT FIXTURE OR SMOKE DETECTOR &

38. DEMOLISH EXIST. FIXTURE & REMOVE WIRING BACK TO PANEL COMPLETE.

35. REMOVE EXIST. 1x FURRING STRIPS COMPLETE ON THIS WALL.

WATER SUPPLY LINE IN AN ACCESSIBLE LOCATION.

PROVIDE BLANK COVER PLATE ON EXIST. BACK-BOX. 39. REMOVE EXIST. WOOD POST. REFER TO STRUCTURAL DRAWINGS.

25. DEMOLISH EXIST. GRAB BAR.

PANEL.

NEW FLOORING FINISHES INDICATED.

ANCHORS AND SUSPENSION WIRE.

EXIST. GRID & SUSPENSION SYSTEM TO REMAIN.

31. DEMOLISH EXIST. WOOD FRAMED SHED COMPLETE.

CONDUIT & WIRING COMPLETE BACK TO PANEL.

STUDS, DRYWALL, FASTNERS & ACCESSORIES.

SALVAGE FOR RE-USE IN THE SAME AREA.

EXISTING CONSTRUCTION TO BE DEMOLISHED

PLAN NOTE DESIGNATION

#### **GENERAL DEMOLITION PLAN NOTES:**

- 1. CONTRACTOR TO VERIFY ALL EXISTING CONDITIONS AND NOTIFY ARCHITECT OF ANY DISCREPANCIES.
- 2. DEMOLITION SHALL BE CLEAN AND COMPLETE. PATCH OR REPAIR ALL EXISTING CONSTRUCTION TO REMAIN AS REQUIRED TO MATCH SURROUNDING SIMILAR CONSTRUCTION.
- 3. CONTRACTOR TO PROVIDE ALL TEMPORARY SHORING, BRACING, BARRIERS, PARTITIONS OR OTHER TEMPORARY FACILITIES AS REQUIRED.
- 4. MAINTAIN EXISTING CONSTRUCTION TO REMAIN IN A SAFE AND WEATHER-TIGHT CONDITION THROUGHOUT CONSTRUCTION.
- 5. MAINTAIN ALL EXISTING UTILITY, MECHANICAL, ELECTRICAL AND PLUMBING SERVICES TO ALL EXISTING AREAS INDICATED TO REMAIN. RE-ROUTE OR RE-WORK EXISTING SERVICES AS REQUIRED.
- 6. ALL ITEMS NOTED TO BE DEMOLISHED SHALL BE DISPOSED OF IN ACCORDANCE WITH STATE AND LOCAL REGULATIONS AND POLICIES.
- 7. VERIFY WITH OWNER PRIOR TO DISPOSING OF ANY ITEMS NOTED TO BE DEMOLISHED.

8. WHERE EXISTING WALL, ROOF OR FLOOR CONSTRUCTION IS INDICATED TO

- BE DEMOLISHED, DEMOLISH ALL ELECTRICAL, MECHANICAL OR PLUMBING FIXTURES, DEVICES, CONDUIT, WIRING, DUCTWORK OR PIPING LOCATED IN SUCH CONSTRUCTION COMPLETE UNLESS NOTED OTHERWISE.
- 9. WHERE DATA OR PHONE JACKS ARE SHOWN TO BE DEMOLISHED, VERIFY IN FIELD QUANTITIES OF PHONE AND DATA DEVICES AND CABLING TO BE REMOVED.

10. WHERE ELECTRICAL DEVICES ARE SHOWN TO BE DEMOLISHED, MAINTAIN CONTINUITY OF EXISTING CIRCUITS FOR ANY EXISTING DEVICES TO REMAIN. 11. REFER TO OWNER'S FUNCTIONAL SPECIFICATIONS FOR FURTHER INFORMATION AND REQUIREMENTS.

#### **DEMOLITION KEYED PLAN NOTES:**

- REMOVE & DEMOLISH EXIST. GUARD RAILS & HANDRAILS ON EXIST. STEEL & CONC. STAIR TO REMAIN.
- DEMOLISH EXIST. STEEL & CONCRETE BRIDGE ASSEMBLY COMPLETE. DEMOLISH EXISTING GYPSUM BOARD PARTITION COMPLETE, TO INCLUDE:
- 3.A. REMOVE ALL EXISTING WALL MOUNTED MARKER BOARDS, TACK BOARDS, COAT HOOK STRIPS AND OTHER SIMILAR ITEMS AND RETURN TO OWNER.
- 3.B. DEMOLISH ALL EXISTING ELECTRICAL RECEPTACLES, DATA PORTS, HVAC CONTROLS, FIRE ALARM DEVICES, BACK-BOXES, CONDUIT &
- WIRING COMPLETE BACK TO PANEL OR SWITCH BOARD. 3.C. EXIST. CONDUIT MAY BE RE-USED FOR NEW OR RELOCATED DEVICES WHEN SUPPORTED PER N.E.C. BUT MAY NOT BE ABANDONED IN
- DEMOLISH EXISTING HVAC CONTROL DEVICE, ELECTRICAL SWITCH, POWER RECEPTACLE OR DATA PORT IN EXISTING WALL TO REMAIN. REMOVE BACK-BOX, CONDUIT & WIRING COMPLETE BACK TO PANEL OR
- SWITCH BOARD. DEMOLISH EXISTING GYP. BD. SOFFIT & FRAMING COMPLETE.
- DEMOLISH EXISTING CARPET FLOOR FINISH, ADHESIVES AND WALL BA COMPLETE IN THIS ROOM OR AREA. PREP EXISTING SUBSTRATES FOR NEW FLOORING FINISHES INDICATED.
  - 7. DEMOLISH EXISTING VCT FLOOR FINISH, ADHESIVES AND WALL BASE COMPLETE IN THIS ROOM OR AREA. PREP EXISTING SUBSTRATES FOR
  - NEW FLOORING FINISHES INDICATED. REMOVE EXIST. PLUMBING FIXTURE. RE-WORK EXIST. DRAIN, VENT &
  - SUPPLY LINES AS REQ'D TO ACCOMMODATE NEW FIXTURE LOCATION. DEMOLISH EXISTING DOOR, FRAME & HARDWARE COMPLETE.
  - 10. REMOVE EXIST. FLOOR ADHESIVES COMPLETE IN THIS ROOM & PREP
  - SUBSTRATES FOR NEW FLOORING FINISHES INDICATED. 11. DEMOLISH INDICATED PORTION OF EXISTING CEILING GRID, TILE AND ACCESSORIES COMPLETE. EXISTING ANCHORS AND SUSPENSION WIRE
  - 12. DEMOLISH EXIST. GYP. BD. CEILING & FRAMING SYSTEM COMPLETE, INCLUDING ANY CEILING MOUNTED ACCESS PANELS, DEVICES OR ACCESSORIES.
  - 13. REMOVE & DISPOSE OF EXIST. LIGHT FIXTURE. RETAIN EXIST. CIRCUIT FOR NEW LIGHT FIXTURE. EXISTING WIRE & CONDUIT MAY BE REUSED WHEN SECURELY SUPPORTED PER N.E.C.
  - 14. DEMOLISH PORTION OF EXIST. WALL ASSEMBLY AS REQ'D TO CREATE NEW DOOR OPENING. FOR STUD WALLS, PROVIDE FULL HEIGHT STUDS
  - ON EACH SIDE OF NEW ROUGH OPENING, TYP. 15. REMOVE & DISPOSE OF EXIST. LATCHSET.

BE RE-USED TO THE EXTENT POSSIBLE, TYP.

- 16. REMOVE EXIST. SHELVING STANDARDS COMPLETE, TO INCLUDE ANY
- ANCHORS OR FASTENERS. PATCH EXIST. WALL SURFACE AS REQ'D. 17. DEMOLISH EXIST. SPECIALTY SWITCH IN EXIST. WALL TO REMAIN. REMOVE BACK-BOX, CONDUIT & WIRING COMPLETE BACK TO PANEL OR SWITCH
- 18. REMOVE EXIST. LIGHT FIXTURE & SALVAGE FOR RE-USE. RETAIN EXIST. CIRCUIT FOR NEW LIGHT FIXTURE. EXISTING WIRE & CONDUIT MAY BE REUSED WHEN SECURELY SUPPORTED PER N.E.C.
- 19. DEMOLISH EXIST. WALL SWITCHES & BACK BOX. MODIFY EXIST, WIRING & CONDUIT AS REQ'D TO ACCOMMODATE NEW SWITCH LOCATION.
- 20. REMOVE EXIST. EXHAUST FAN COMPLETE. RETAIN EXIST. CIRCUIT & VENT FOR NEW EXHAUST FAN. EXISTING WIRE & CONDUIT MAY BE REUSED WHEN SECURELY SUPPORTED PER N.E.C.
- 21. DEMOLISH EXIST. CASEWORK COMPLETE. REMOVE EXIST. PLUMBING FIXTURES & CAP DRAIN & WATER SUPPLY LINES. 22. DEMOLISH EXIST. EXPOSED CONDUIT, WIRING, BOXES, FITTINGS AND
- ACCESSORIES COMPLETE. 23. REMOVE EXIST. I/T RACK & PANELS AND SALVAGE FOR RE-USE IN NEW
- 24. DEMOLISH EXIST. SWITCH(S). RETAIN CIRCUITS & RECONNECT NEW OR

## M2Ke design

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NEW POLICE STATION **RENOVATIONS** 

813 LAPORTE AVE., VALPARAISO, INDIANA

	MARK	DATE	DESCRIPTION
ASE	1	10/26/15	75% CDs
	2	11/12/15	95% CDs
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E TO			

LOWER LEVEL
DEMOLITION
PLAN


SCALE: 3/16"=1'-0" CLIENT:

DATE: 10/07/15 PROJECT: 029001

DRAWN: DRH

APPRVD: DRH

FILE: 029001A-A100-XP00

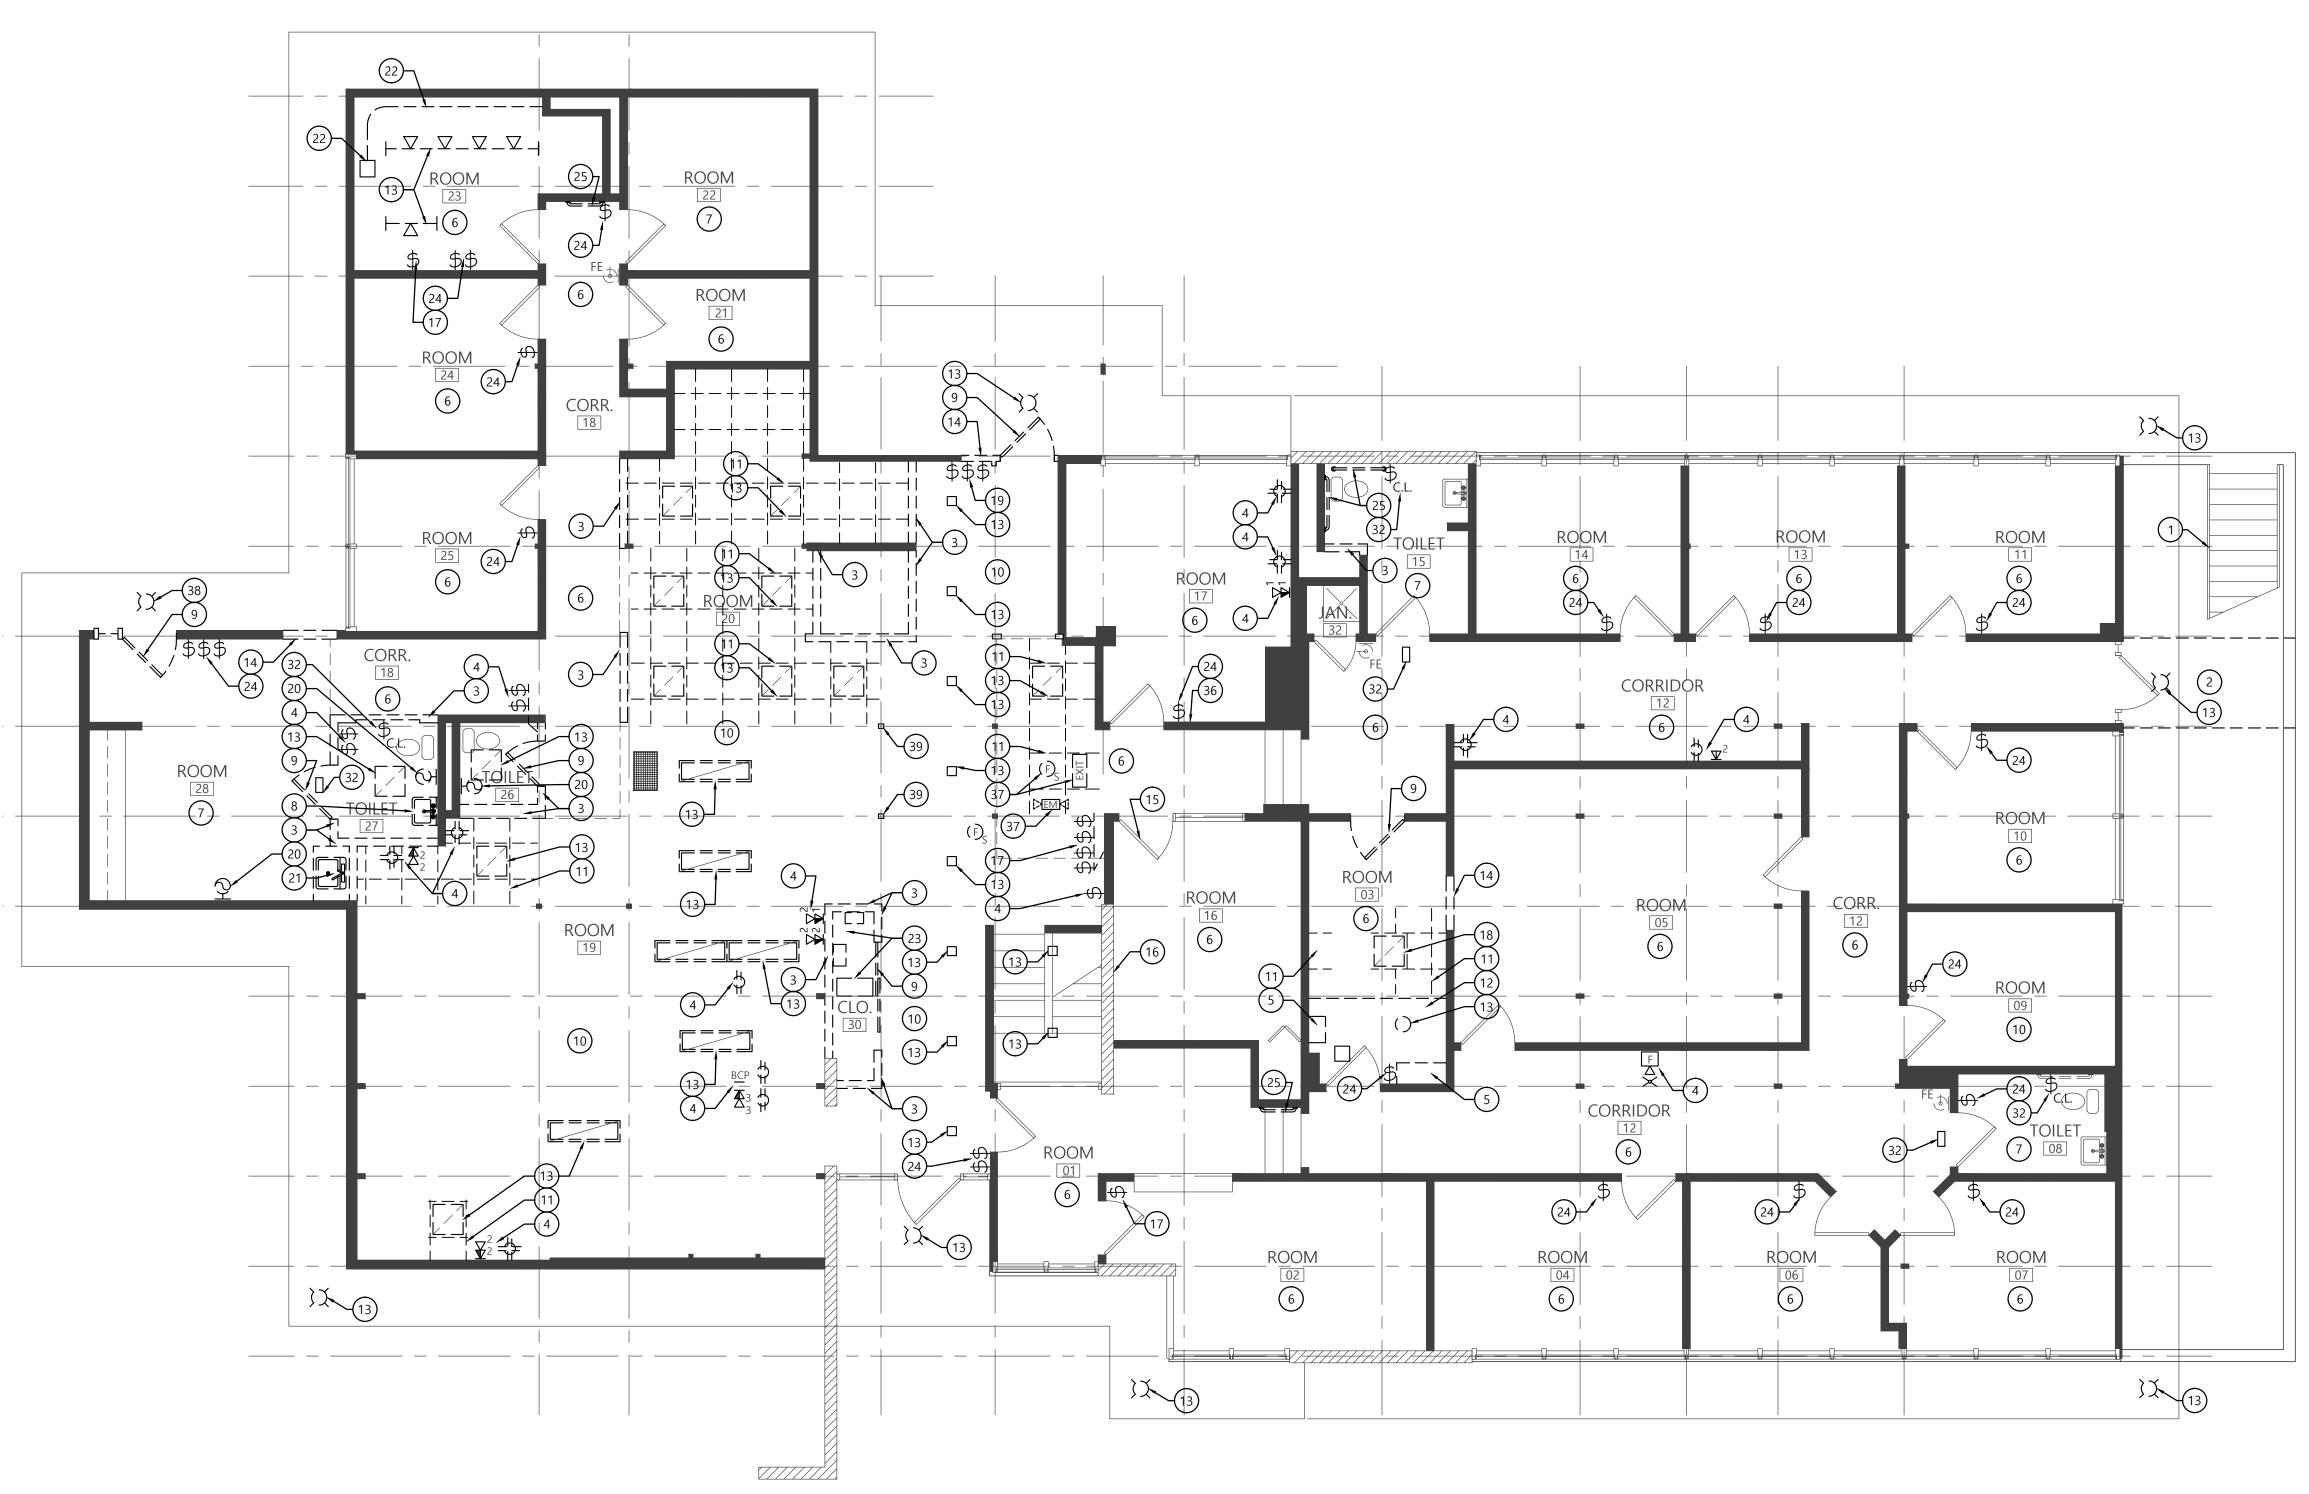


FIRST FLOOR DEMOLITION PLAN


Scale: 3/16"=1'-0"

- EXIST. LIGHT FIXTURES FROM NEW SWITCHES OR SWITCH LOCATIONS.
- 25. DEMOLISH EXIST. GRAB BAR. 26. DEMOLISH EXIST. RUBBER FLOOR FINISH, ADHESIVES AND WALL BASE COMPLETE IN THIS ROOM OR AREA. PREP EXISTING SUBSTRATES FOR NEW FLOORING FINISHES INDICATED.
- 27. REMOVE & DISPOSE OF EXIST. CEILING TILE IN THIS AREA OR ROOM. EXIST. GRID & SUSPENSION SYSTEM TO REMAIN.
- 28. DEMOLISH EXIST. CEILING GRID, TILE, LIGHT FIXTURES, DIFFUSERS & BRANCH DUCTS, AND ACCESSORIES COMPLETE, TO INCLUDE EXIST. ANCHORS AND SUSPENSION WIRE.
- 29. DEMOLISH EXIST. POWER FEED TO EXIST. STAIR SNOW MELT SYSTEM.
- REMOVE BACK-BOX, CONDUIT & WIRING COMPLETE BACK TO PANEL. 30. REMOVE EXIST. BACK-BOX, CONDUIT & WIRING COMPLETE BACK TO
- PANEL.
- 31. DEMOLISH EXIST. WOOD FRAMED SHED COMPLETE.
- 32. DEMOLISH EXIST. CALL LIGHT SWITCH, HALL LIGHT, BACK-BOXES,
- CONDUIT & WIRING COMPLETE BACK TO PANEL. 33. DEMOLISH UPPER PORTION OF FORMER GYP. BD. PARTITION, TO INCLUDE
- STUDS, DRYWALL, FASTNERS & ACCESSORIES.
- 34. REMOVE EXIST. DOOR SLAB & HARDWARE. EXIST. FRAME TO REMAIN.
- 35. REMOVE EXIST. 1x FURRING STRIPS COMPLETE ON THIS WALL.
- 36. REMOVE EXIST. DRAIN, VENT OR WATER SUPPLY LINES. CAP & VALVE WATER SUPPLY LINE IN AN ACCESSIBLE LOCATION. 37. REMOVE EXIST. EXIT SIGN, EM LIGHT FIXTURE OR SMOKE DETECTOR &
- SALVAGE FOR RE-USE IN THE SAME AREA. 38. DEMOLISH EXIST. FIXTURE & REMOVE WIRING BACK TO PANEL COMPLETE. PROVIDE BLANK COVER PLATE ON EXIST. BACK-BOX.
- 39. REMOVE EXIST. WOOD POST. REFER TO STRUCTURAL DRAWINGS.

#### PLAN SYMBOLS:

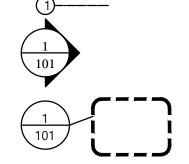

COLUMN LINE DESIGNATION

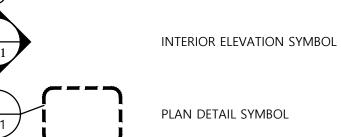

EXISTING CONSTRUCTION TO BE DEMOLISHED EXISTING WALLS TO REMAIN

PLAN NOTE DESIGNATION

#### **GENERAL DEMOLITION PLAN NOTES:**

- 1. CONTRACTOR TO VERIFY ALL EXISTING CONDITIONS AND NOTIFY ARCHITECT OF ANY DISCREPANCIES.
- 2. DEMOLITION SHALL BE CLEAN AND COMPLETE. PATCH OR REPAIR ALL EXISTING CONSTRUCTION TO REMAIN AS REQUIRED TO MATCH SURROUNDING SIMILAR CONSTRUCTION.
- 3. CONTRACTOR TO PROVIDE ALL TEMPORARY SHORING, BRACING, BARRIERS, PARTITIONS OR OTHER TEMPORARY FACILITIES AS REQUIRED.
- 4. MAINTAIN EXISTING CONSTRUCTION TO REMAIN IN A SAFE AND WEATHER-TIGHT CONDITION THROUGHOUT CONSTRUCTION.
- 5. MAINTAIN ALL EXISTING UTILITY, MECHANICAL, ELECTRICAL AND PLUMBING SERVICES TO ALL EXISTING AREAS INDICATED TO REMAIN. RE-ROUTE OR RE-WORK EXISTING SERVICES AS REQUIRED.
- 6. ALL ITEMS NOTED TO BE DEMOLISHED SHALL BE DISPOSED OF IN
- ACCORDANCE WITH STATE AND LOCAL REGULATIONS AND POLICIES. 7. VERIFY WITH OWNER PRIOR TO DISPOSING OF ANY ITEMS NOTED TO BE DEMOLISHED.
- BE DEMOLISHED, DEMOLISH ALL ELECTRICAL, MECHANICAL OR PLUMBING FIXTURES, DEVICES, CONDUIT, WIRING, DUCTWORK OR PIPING LOCATED IN SUCH CONSTRUCTION COMPLETE UNLESS NOTED OTHERWISE

8. WHERE EXISTING WALL, ROOF OR FLOOR CONSTRUCTION IS INDICATED TO

- 9. WHERE DATA OR PHONE JACKS ARE SHOWN TO BE DEMOLISHED, VERIFY IN FIELD QUANTITIES OF PHONE AND DATA DEVICES AND CABLING TO BE
- 10. WHERE ELECTRICAL DEVICES ARE SHOWN TO BE DEMOLISHED, MAINTAIN CONTINUITY OF EXISTING CIRCUITS FOR ANY EXISTING DEVICES TO REMAIN. 11. REFER TO OWNER'S FUNCTIONAL SPECIFICATIONS FOR FURTHER INFORMATION AND REQUIREMENTS.

#### **DEMOLITION KEYED PLAN NOTES:**

- REMOVE & DEMOLISH EXIST. GUARD RAILS & HANDRAILS ON EXIST. STEEL & CONC. STAIR TO REMAIN.
- DEMOLISH EXIST. STEEL & CONCRETE BRIDGE ASSEMBLY COMPLETE.
- DEMOLISH EXISTING GYPSUM BOARD PARTITION COMPLETE, TO INCLUDE: 3.A. REMOVE ALL EXISTING WALL MOUNTED MARKER BOARDS, TACK BOARDS, COAT HOOK STRIPS AND OTHER SIMILAR ITEMS AND
- RETURN TO OWNER. 3.B. DEMOLISH ALL EXISTING ELECTRICAL RECEPTACLES, DATA PORTS, HVAC CONTROLS, FIRE ALARM DEVICES, BACK-BOXES, CONDUIT & WIRING COMPLETE BACK TO PANEL OR SWITCH BOARD.
- 3.C. EXIST. CONDUIT MAY BE RE-USED FOR NEW OR RELOCATED DEVICES WHEN SUPPORTED PER N.E.C. BUT MAY NOT BE ABANDONED IN
- DEMOLISH EXISTING HVAC CONTROL DEVICE, ELECTRICAL SWITCH, POWER RECEPTACLE OR DATA PORT IN EXISTING WALL TO REMAIN. REMOVE BACK-BOX, CONDUIT & WIRING COMPLETE BACK TO PANEL OR SWITCH BOARD.
- DEMOLISH EXISTING GYP. BD. SOFFIT & FRAMING COMPLETE. DEMOLISH EXISTING CARPET FLOOR FINISH, ADHESIVES AND WALL BAS
- COMPLETE IN THIS ROOM OR AREA. PREP EXISTING SUBSTRATES FOR NEW FLOORING FINISHES INDICATED.
- DEMOLISH EXISTING VCT FLOOR FINISH, ADHESIVES AND WALL BASE COMPLETE IN THIS ROOM OR AREA. PREP EXISTING SUBSTRATES FOR
- NEW FLOORING FINISHES INDICATED. REMOVE EXIST. PLUMBING FIXTURE. RE-WORK EXIST. DRAIN, VENT &
- SUPPLY LINES AS REQ'D TO ACCOMMODATE NEW FIXTURE LOCATION.
- DEMOLISH EXISTING DOOR, FRAME & HARDWARE COMPLETE. 10. REMOVE EXIST. FLOOR ADHESIVES COMPLETE IN THIS ROOM & PREP
- SUBSTRATES FOR NEW FLOORING FINISHES INDICATED.
- 11. DEMOLISH INDICATED PORTION OF EXISTING CEILING GRID, TILE AND ACCESSORIES COMPLETE. EXISTING ANCHORS AND SUSPENSION WIRE
- 12. DEMOLISH EXIST. GYP. BD. CEILING & FRAMING SYSTEM COMPLETE, INCLUDING ANY CEILING MOUNTED ACCESS PANELS, DEVICES OR ACCESSORIES.

BE RE-USED TO THE EXTENT POSSIBLE, TYP.

- 13. REMOVE & DISPOSE OF EXIST. LIGHT FIXTURE. RETAIN EXIST. CIRCUIT FOR NEW LIGHT FIXTURE. EXISTING WIRE & CONDUIT MAY BE REUSED WHEN SECURELY SUPPORTED PER N.E.C.
- 14. DEMOLISH PORTION OF EXIST. WALL ASSEMBLY AS REQ'D TO CREATE NEW DOOR OPENING. FOR STUD WALLS, PROVIDE FULL HEIGHT STUDS
- ON EACH SIDE OF NEW ROUGH OPENING, TYP. 15. REMOVE & DISPOSE OF EXIST. LATCHSET.
- 16. REMOVE EXIST. SHELVING STANDARDS COMPLETE, TO INCLUDE ANY
- ANCHORS OR FASTENERS. PATCH EXIST. WALL SURFACE AS REQ'D. 17. DEMOLISH EXIST. SPECIALTY SWITCH IN EXIST. WALL TO REMAIN. REMOVE BACK-BOX, CONDUIT & WIRING COMPLETE BACK TO PANEL OR SWITCH
- 18. REMOVE EXIST. LIGHT FIXTURE & SALVAGE FOR RE-USE. RETAIN EXIST. CIRCUIT FOR NEW LIGHT FIXTURE. EXISTING WIRE & CONDUIT MAY BE REUSED WHEN SECURELY SUPPORTED PER N.E.C.
- 19. DEMOLISH EXIST. WALL SWITCHES & BACK BOX. MODIFY EXIST, WIRING & CONDUIT AS REQ'D TO ACCOMMODATE NEW SWITCH LOCATION.
- 20. REMOVE EXIST. EXHAUST FAN COMPLETE. RETAIN EXIST. CIRCUIT & VENT FOR NEW EXHAUST FAN. EXISTING WIRE & CONDUIT MAY BE REUSED WHEN SECURELY SUPPORTED PER N.E.C.
- 21. DEMOLISH EXIST. CASEWORK COMPLETE. REMOVE EXIST. PLUMBING
- FIXTURES & CAP DRAIN & WATER SUPPLY LINES. 22. DEMOLISH EXIST. EXPOSED CONDUIT, WIRING, BOXES, FITTINGS AND ACCESSORIES COMPLETE.
- 23. REMOVE EXIST. I/T RACK & PANELS AND SALVAGE FOR RE-USE IN NEW

24. DEMOLISH EXIST. SWITCH(S). RETAIN CIRCUITS & RECONNECT NEW OR

791 Lincoln Street Hobart, Indiana, 46342-5233 (219) 798-0395

M2Ke design

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VALPARAISO UNIVERSITY POLICE DEPARTMENT

NEW POLICE STATION **RENOVATIONS** 

813 LAPORTE AVE., VALPARAISO, INDIANA

711			
	MARK	DATE	DESCRIPTION
SE	1	10/26/15	75% CDs
	2	11/12/15	95% CDs
TO.			
TO			

## FIRST FLOOR **DEMOLITION** PLAN


SCALE: 3/16"=1'-0" CLIENT:

DRAWN: DRH

APPRVD: DRH

DATE: 10/07/15 PROJECT: 029001

FILE: 029001A-A110-XP01

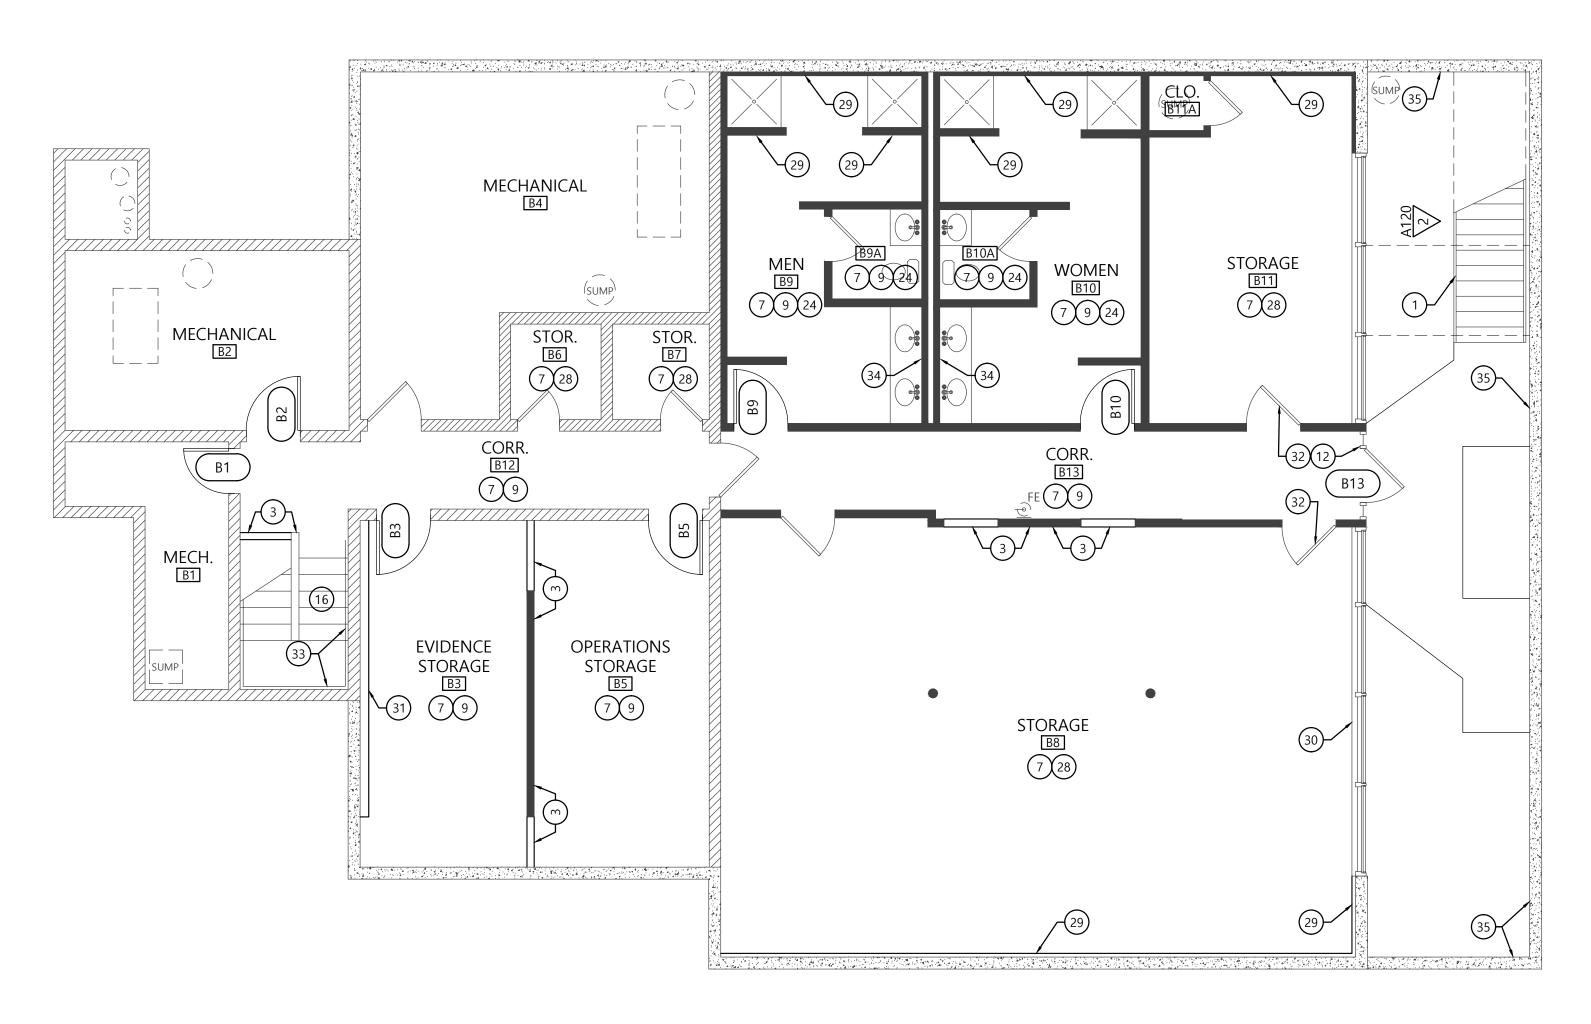

LOWER LEVEL FLOOR PLAN

3/8"x1" BAR STOCK —

SHOE RAIL, TYP.

1 1/4" SQ. STEEL POST

W/ FILLER BLOCK. WELD

TO EXIST. STEEL STRINGER,

Scale: 3/16"=1'-0"

**KEYED PLAN NOTES:** 

WINDOW SILL

REMAIN.

Scale: 1/4"=1'-0"

30. LAMINATE NEW 5/8" DRYWALL ON EXIST. BRICK WALL BELOW

31. INSTALL NEW 5/8" DRYWALL ON EXIST. 2x4 STUDS ON THIS

34. PROVIDE NEW 30"x72" PLATE GLASS MIRROR & HARDWARE.

35. SHOT BLAST EXIST. CONCRETE FOUNDATION WALL TO

PROVIDE NEW WD. HAD RAILS ON MTL. WALL BRACKETS, TYP.

32. REFINISH OR REPLACE EXIST. WD. DOOR SLAB.

#### EXIST. BEAM, TYP. 2" THICK MELAMINE 2" THICK MELAMINE FOAM ACOUSTIC FOAM ACOUSTIC WALL PANELS, TYP. WALL PANELS, TYP. - 1 1/2"ø STEEL GUARD RAIL WELD TO POSTS, 1 1/2"ø STEEL HAND RAIL ON STEEL BRACKETS TYP. ACOUSTIC WALL PANEL ELEVATIONS WELDED TO POSTS, 1/2" SQ. STEEL BALUS. @ 4" o.c. MAX, TYP.

STAIR ELEVATION Scale: 1/2"=1'-0"

EXIST. STEEL STRINGER

& CONC. PAN TREADS

TO REMAIN, TYP.

INTERIOR ELEVATION

## Scale: 1/4"=1'-0"

GYP. BD. SOFFIT. ALIGN

W. BOTT. OF BEAM, TYP.

BALLISTIC RESISTANT

GLAZING SYSTEM, TYP.

PROVIDE TRANSACTION

WINDOW IN GLAZING


GYP. BD. WALL BELOW. FILL STUD SPACES W/

LIGHTWEIGHT CONC., TYP.

SYSTEM, TYP.

P. LAM. SILL, TYP.

## PLAN SYMBOLS:

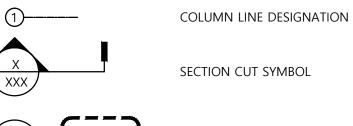

PLAN DETAIL SYMBOL

INTERIOR ELEVATION SYMBOL

PLAN NOTE DESIGNATION **EQUIPMENT DESIGNATION** TOILET ACCESSORY DESIGNATION WINDOW SCHEDULE DESIGNATION 000 DOOR SCHEDULE DESIGNATION W3 WALL TYPE DESIGNATION

> **ELEVATION HEIGHT DESIGNATION** EXISTING WALLS TO REMAIN

1 HOUR RATED PARTITION

#### **GENERAL PLAN NOTES:**

- 1. DO NOT SCALE PLANS. ENLARGED PLAN DIMENSIONS TAKE PRECEDENCE OVER SMALLER SCALE PLAN DIMENSIONS.
- 2. ALL EXTERIOR DIMENSIONS ARE TAKEN FROM THE FACE OF CONCRETE, MASONRY OR EXTERIOR SHEATHING UNLESS NOTED OTHERWISE.
- 3. ALL INTERIOR DIMENSIONS ARE TAKEN FROM THE FACE OF MASONRY, CONCRETE OR DRYWALL UNLESS NOTED OTHERWISE
- 4. ALL INTERIOR FRAME WALLS ARE TO BE WALL TYPE W3.1 OR W3.2
- 5. THE HINGE SIDE FACE OF ALL INTERIOR DOOR FRAMES TO BE SET 4 1/2" FROM THE FINISHED FACE OF THE ADJACENT PERPENDICULAR WALL UNLESS NOTED OTHERWISE. 6. PROVIDE SOLID WOOD BLOCKING AT ALL WALL MOUNTED
- DEVICES AND FIXTURES. 7. REFER TO OWNER'S FUNCTIONAL SPECIFICATIONS FOR FURTHER
- INFORMATION AND REQUIREMENTS
- 8. CLEAN, ADJUST & REPAIR ALL EXIST. SURFACES, FINISHES, CASEWROK, FIXTURES OR ACCESSORIES SHOWN TO REMAIN.

#### **KEYED PLAN NOTES:**

- SAND-BLAST & SCRAPE EXIST. STEEL STAIR ASSEMBLY. PRIME & PAINT EXIST. STEEL & CLEAN EXIST. CONC. TREADS. PROVIDE NEW STEEL GUARD RAIL & HAND RAILS PER DETAIL.
- FURNISH & INSTALL NEW STEEL & CONCRETE BRIDGE ASSEMBLY. FABRICATOR TO FIELD VERIFY EXIST. CONDITIONS AND PROVIDE ENGINEERING AND DETAILED SHOP DRAWINGS PRIOR TO FABRICATION.
- 3. ALIGN FINISHED SURFACES, TYP.
- 4. NEW FURNITURE SYSTEMS BY OWNER, TYP.
- PROVIDE NEW PRE-FABRICATED METAL LOCKERS, TYP. PROVIDE NEW PLASTIC LAMINATE CASEWORK & COUNTERTOP,
- PAINT ALL WALLS IN THIS ROOM, FULL HEIGHT FROM FLOOR TO CEILING. REMOVE ANY WALL MOUNTED COVER PLATES, ACCESSORIES OR OTHER ITEMS NOT OTHERWISE NOTED TO BE DEMOLISHED AND RE-INSTALL AFTER PAINTING IS COMPLETE. PATCH, TAPE, FINISH & PRIME ALL EXIST. DRYWALL AS REQ'D TO ACHIEVE LEVEL FIVE FINISH PRIOR TO PAINTING. PAINT
- WOOD OR MTL. DOOR OR WINDOW FRAMES & STOPS. 8. INSTALL NEW CARPET FLOORING AND WALL BASE IN THIS
- INSTALL NEW VCT FLOORING AND WALL BASE IN THIS ROOM. 10. PROVIDE DRYWALL RETURN AT WINDOW SILL WITH MTL.
- J-BEAD, CORNER BEAD & SEALANT, TYP. 11. PROVIDE NEW MTL. L-BEAD AND SEALANT AT WINDOW JAMB
- POST BELOW SILL. TAPE & FINISH, TYP. 12. PAINT EXIST. MTL. DOOR & FRAME.
- 13. PROVIDE NEW S.S. DROP IN SINK AND LEVER HANDLE FAUCET. CONNECT VENT TO EXIST. ADJACENT TOILET ROOM VENT. CONNECT DOMESTIC HOT & COLD WATER SUPPLIES AND DRAIN PIPING THROUGH FLOOR TO EXIST. WATER & DRAIN
- LINES IN BASEMENT. 14. PROVIDE 4x4 SOLID WD. POST IN NEW WALL CONSTRUCTION. 15. ALIGN FACE OF WALL WITH FACE OF EXIST. SKYLIGHT ABOVE.

16. PROVIDE NEW ONE PIECE VINYL STAIR TREADS & VINYL RISER

- COVERS OVER EXIST. WD. STAIRS. PROVIDE NEW VCT FLOORING AND WALL BASE AT STAIR LANDINGS. 17. REMOVE EXIST. LATCH & REPLACE WITH NEW PASSAGE SET TO
- MATCH EXIST.PROVIDE NEW CLOSET ROD & P. LAM. 18. PAINT EXIST. MTL. CABINETS & PROVIDE NEW PULLS.

19. PROVIDE NEW DRINKING FOUNTAIN. CONNECT TO EXIST.

- WATER SUPPLY & DRAIN LINE. 20. PROVIDE NEW MOP BASIN. CONNECT TO EXIST. WATER
- SUPPLY & DRAIN LINE. 21. INFILL EXIST. EXTERIOR WALL AND PREP EXTERIOR SURFACE
- FOR NEW E.I.F.S. FINISH. 22. FURR EXIST. WALL SURFACE AS REQ'D TO BRING DRYWALL
- FINISH INTO ONE PLANE. 23. PROVIDE NEW P. LAM. COUNTERTOP ON WALL BRACKETS.
- 24. PROVIDE NEW SURFACE MOUNTED TOILET ACCESSORIES, TO INCLUDE; GRAB BARS WHERE SHOWN, TOILET PAPER DISPENSER, PAPER TOWEL DISPENSER & TRASH RECEPTACLE. MOUNT ACCESSORIES PER ACCESSIBILITY CODE REQUIREMENTS.
- 25. FILL STUD SPACES IN KNEE WALL BELOW WITH LIGHT-WEIGHT CONCRETE TO PROVIDE BALLISTIC RESISTANT WALL ASSEMBLY.
- 26. COORDINATE CHASE WALL LAY-OUT WITH LOCATION OF EXIST. PIPING.
- 27. SEE DETAIL 3/A120 FOR TYPICAL ACOUSTIC WALL PANEL LAY-OUT.
- 28. POLISH EXIST. CONC. FLOOR.
- 29. INSTALL NEW RIGID FOIL-BACKED INSUL. & 5/8" DRYWALL ON EXIST. FURRING STRIPS ON THIS WALL.

## M2Ke design

791 Lincoln Street Hobart, Indiana, 46342-5233 **(2**19) 798-0395 (312) 550-3203 dhill@m2ke.com www.m2ke.com

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VALPARAISO UNIVERSITY POLICE DEPARTMENT

NEW POLICE STATION **RENOVATIONS** 

813 LAPORTE AVE., VALPARAISO, INDIANA

	MARK	DATE	DESCRIPTION
	1	10/20/15	OWNER REVIEW
	2	10/26/15	75% CDs
	3	11/12/15	95% CDs
•			


## LOWER LEVEL **FLOOR** PLAN

SCALE: 3/16"=1'-0" CLIENT: DATE: 10/07/15 PROJECT: 029001


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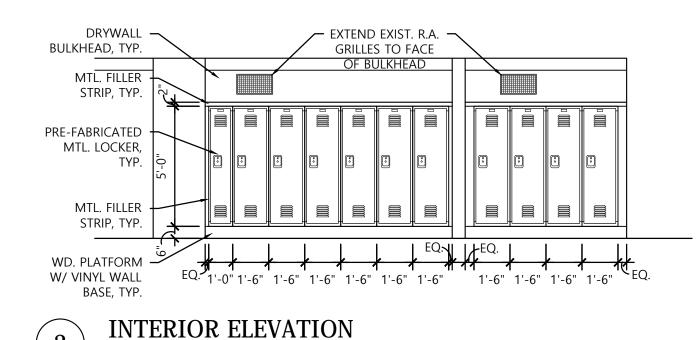
APPRVD: DRH

FILE: 029001A-A120-FP00

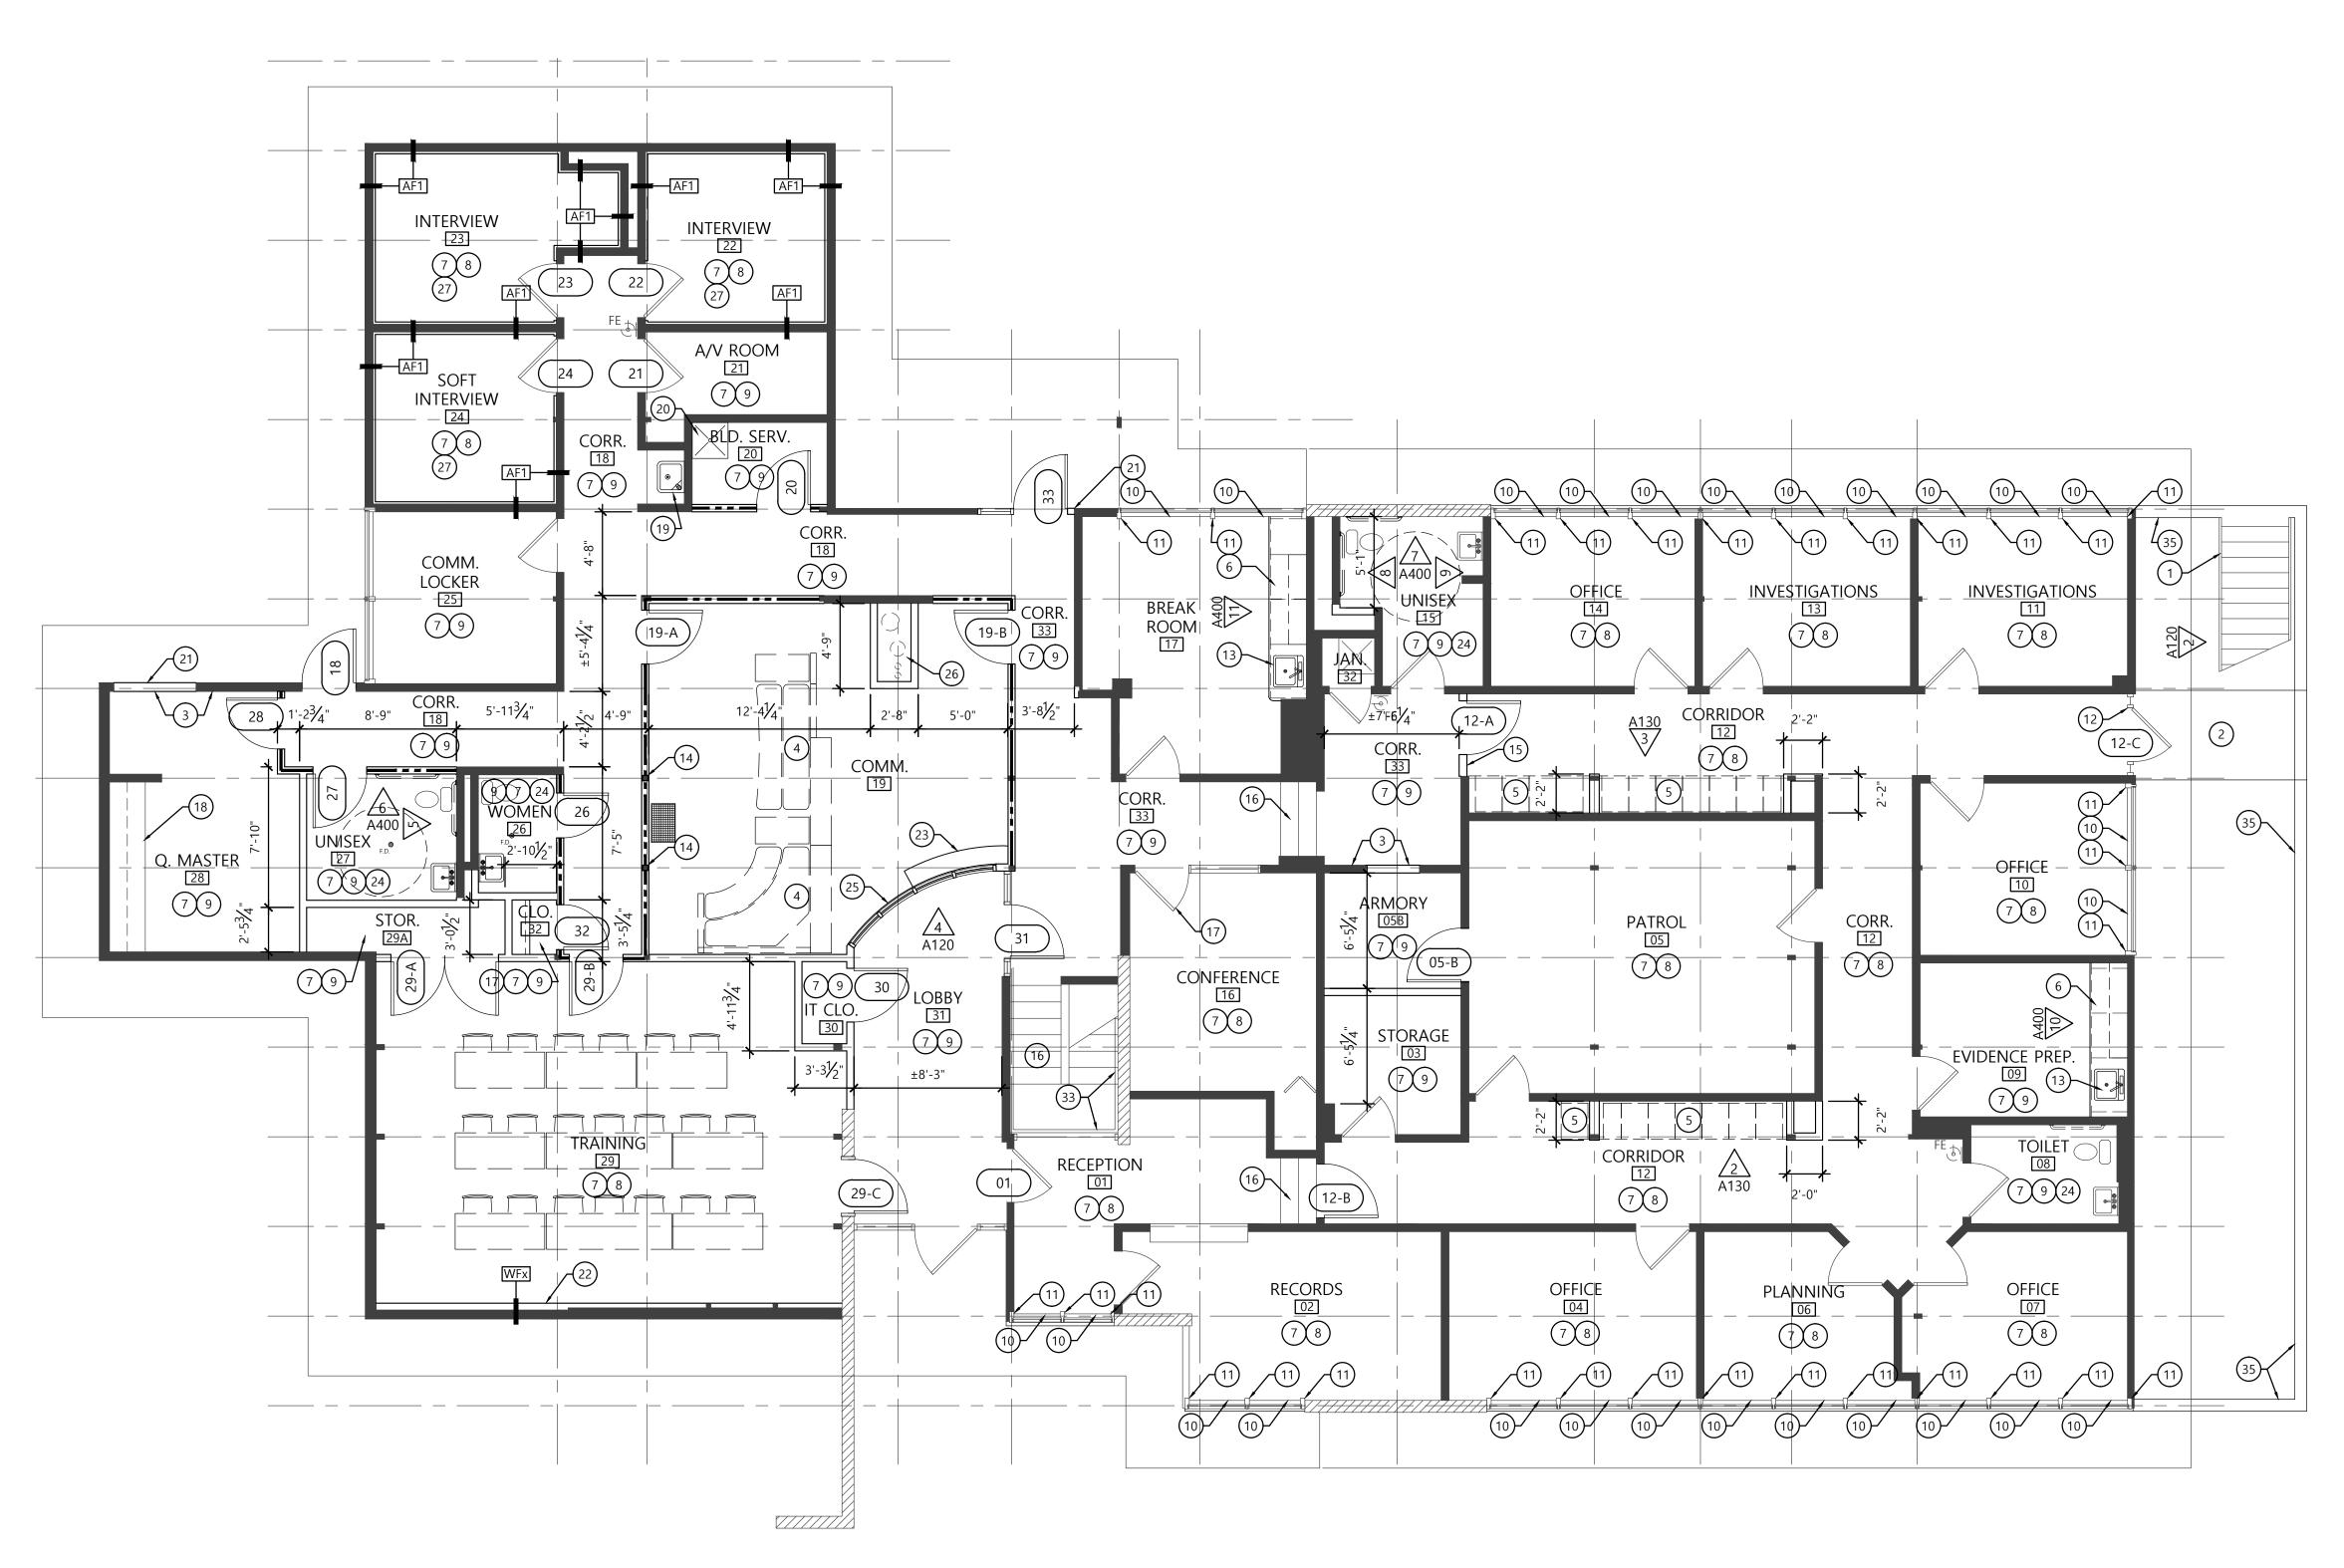

FIRST FLOOR PLAN Scale: 3/16"=1'-0"



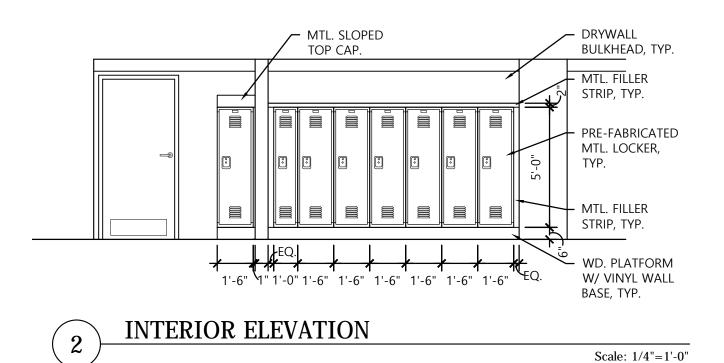


Scale: 1/4"=1'-0"

**KEYED PLAN NOTES:** 

- 30. LAMINATE NEW 5/8" DRYWALL ON EXIST. BRICK WALL BELOW WINDOW SILL.
- 31. INSTALL NEW 5/8" DRYWALL ON EXIST. 2x4 STUDS ON THIS
- 32. REFINISH OR REPLACE EXIST. WD. DOOR SLAB.
- 33. PROVIDE NEW WD. HAD RAILS ON MTL. WALL BRACKETS, TYP.
- 34. PROVIDE NEW 30"x72" PLATE GLASS MIRROR & HARDWARE.
- 35. SHOT BLAST EXIST. CONCRETE FOUNDATION WALL TO
- REMAIN.

#### PLAN SYMBOLS:

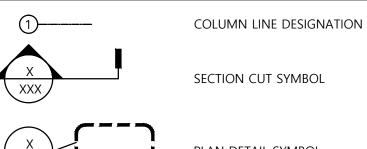

PLAN DETAIL SYMBOL



PLAN NOTE DESIGNATION **EQUIPMENT DESIGNATION** TOILET ACCESSORY DESIGNATION

000 DOOR SCHEDULE DESIGNATION W3 WALL TYPE DESIGNATION **ELEVATION HEIGHT DESIGNATION** 

EXISTING WALLS TO REMAIN

1 HOUR RATED PARTITION

#### **GENERAL PLAN NOTES:**

- 1. DO NOT SCALE PLANS. ENLARGED PLAN DIMENSIONS TAKE PRECEDENCE OVER SMALLER SCALE PLAN DIMENSIONS.
- 2. ALL EXTERIOR DIMENSIONS ARE TAKEN FROM THE FACE OF CONCRETE, MASONRY OR EXTERIOR SHEATHING UNLESS NOTED OTHERWISE.
- 3. ALL INTERIOR DIMENSIONS ARE TAKEN FROM THE FACE OF MASONRY, CONCRETE OR DRYWALL UNLESS NOTED OTHERWISE
- 4. ALL INTERIOR FRAME WALLS ARE TO BE WALL TYPE W3.1 OR W3.2

5. THE HINGE SIDE FACE OF ALL INTERIOR DOOR FRAMES TO BE SET

- 4 1/2" FROM THE FINISHED FACE OF THE ADJACENT PERPENDICULAR WALL UNLESS NOTED OTHERWISE. 6. PROVIDE SOLID WOOD BLOCKING AT ALL WALL MOUNTED
- DEVICES AND FIXTURES. 7. REFER TO OWNER'S FUNCTIONAL SPECIFICATIONS FOR FURTHER
- INFORMATION AND REQUIREMENTS
- 8. CLEAN, ADJUST & REPAIR ALL EXIST. SURFACES, FINISHES, CASEWROK, FIXTURES OR ACCESSORIES SHOWN TO REMAIN.

#### **KEYED PLAN NOTES:**

- SAND-BLAST & SCRAPE EXIST. STEEL STAIR ASSEMBLY. PRIME & PAINT EXIST. STEEL & CLEAN EXIST. CONC. TREADS. PROVIDE NEW STEEL GUARD RAIL & HAND RAILS PER DETAIL.
- FURNISH & INSTALL NEW STEEL & CONCRETE BRIDGE ASSEMBLY. FABRICATOR TO FIELD VERIFY EXIST. CONDITIONS AND PROVIDE ENGINEERING AND DETAILED SHOP DRAWINGS PRIOR TO FABRICATION.
- 3. ALIGN FINISHED SURFACES, TYP.
- 4. NEW FURNITURE SYSTEMS BY OWNER, TYP.
- PROVIDE NEW PRE-FABRICATED METAL LOCKERS, TYP. PROVIDE NEW PLASTIC LAMINATE CASEWORK & COUNTERTOP,
- PAINT ALL WALLS IN THIS ROOM, FULL HEIGHT FROM FLOOR TO CEILING. REMOVE ANY WALL MOUNTED COVER PLATES, ACCESSORIES OR OTHER ITEMS NOT OTHERWISE NOTED TO BE DEMOLISHED AND RE-INSTALL AFTER PAINTING IS COMPLETE. PATCH, TAPE, FINISH & PRIME ALL EXIST. DRYWALL AS REQ'D TO ACHIEVE LEVEL FIVE FINISH PRIOR TO PAINTING. PAINT
- WOOD OR MTL. DOOR OR WINDOW FRAMES & STOPS. 8. INSTALL NEW CARPET FLOORING AND WALL BASE IN THIS
- 9. INSTALL NEW VCT FLOORING AND WALL BASE IN THIS ROOM. 10. PROVIDE DRYWALL RETURN AT WINDOW SILL WITH MTL.
- J-BEAD, CORNER BEAD & SEALANT, TYP. 11. PROVIDE NEW MTL. L-BEAD AND SEALANT AT WINDOW JAMB
- POST BELOW SILL. TAPE & FINISH, TYP.
- 12. PAINT EXIST. MTL. DOOR & FRAME. 13. PROVIDE NEW S.S. DROP IN SINK AND LEVER HANDLE FAUCET. CONNECT VENT TO EXIST. ADJACENT TOILET ROOM VENT. CONNECT DOMESTIC HOT & COLD WATER SUPPLIES AND
- LINES IN BASEMENT. 14. PROVIDE 4x4 SOLID WD. POST IN NEW WALL CONSTRUCTION. 15. ALIGN FACE OF WALL WITH FACE OF EXIST. SKYLIGHT ABOVE.

DRAIN PIPING THROUGH FLOOR TO EXIST. WATER & DRAIN

COVERS OVER EXIST. WD. STAIRS. PROVIDE NEW VCT FLOORING AND WALL BASE AT STAIR LANDINGS.

16. PROVIDE NEW ONE PIECE VINYL STAIR TREADS & VINYL RISER

- 17. REMOVE EXIST. LATCH & REPLACE WITH NEW PASSAGE SET TO MATCH EXIST.PROVIDE NEW CLOSET ROD & P. LAM.
- 18. PAINT EXIST. MTL. CABINETS & PROVIDE NEW PULLS. 19. PROVIDE NEW DRINKING FOUNTAIN. CONNECT TO EXIST.
- WATER SUPPLY & DRAIN LINE. 20. PROVIDE NEW MOP BASIN. CONNECT TO EXIST. WATER SUPPLY & DRAIN LINE.
- 21. INFILL EXIST. EXTERIOR WALL AND PREP EXTERIOR SURFACE FOR NEW E.I.F.S. FINISH.
- 22. FURR EXIST. WALL SURFACE AS REQ'D TO BRING DRYWALL FINISH INTO ONE PLANE.
- 23. PROVIDE NEW P. LAM. COUNTERTOP ON WALL BRACKETS. 24. PROVIDE NEW SURFACE MOUNTED TOILET ACCESSORIES, TO INCLUDE; GRAB BARS WHERE SHOWN, TOILET PAPER DISPENSER, PAPER TOWEL DISPENSER & TRASH RECEPTACLE. MOUNT ACCESSORIES PER ACCESSIBILITY CODE
- REQUIREMENTS. 25. FILL STUD SPACES IN KNEE WALL BELOW WITH LIGHT-WEIGHT CONCRETE TO PROVIDE BALLISTIC RESISTANT WALL ASSEMBLY.
- 26. COORDINATE CHASE WALL LAY-OUT WITH LOCATION OF EXIST. PIPING.
- 27. SEE DETAIL 3/A120 FOR TYPICAL ACOUSTIC WALL PANEL LAY-OUT.
- 28. POLISH EXIST. CONC. FLOOR.
- 29. INSTALL NEW RIGID FOIL-BACKED INSUL. & 5/8" DRYWALL ON EXIST. FURRING STRIPS ON THIS WALL.

## M2Ke design

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M2Ke Design LLC IN LIC#: PC81500014 © M2Ke design 2015



## VALPARAISO UNIVERSITY POLICE DEPARTMENT

## NEW POLICE STATION RENOVATIONS 2015

813 LAPORTE AVE., VALPARAISO, INDIANA

	MARK	DATE	DESCRIPTION
	1	10/20/15	OWNER REVIEW
	2	10/26/15	75% CDs
	3	11/12/15	95% CDs
•			
•			
•			


## **FIRST FLOOR** PLAN

SCALE: 3/16"=1'-0" CLIENT: DATE: 10/07/15 PROJECT: 029001

DRAWN: DRH

APPRVD: DRH

FILE: 029001A-A130-FP01

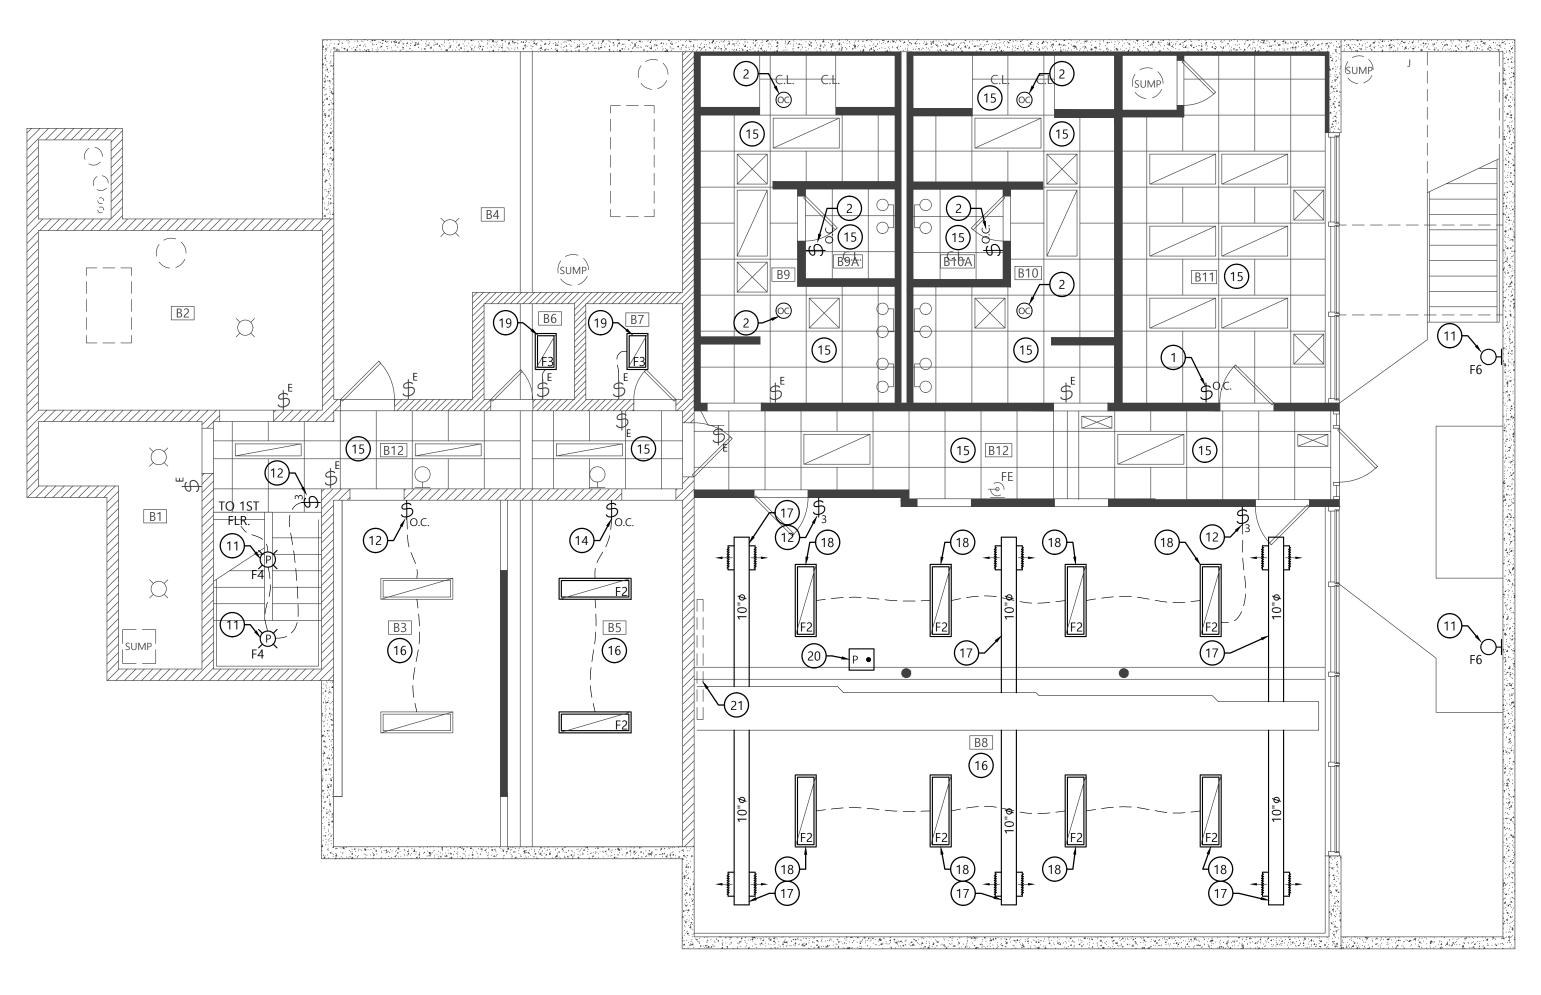


LOWER LEVEL REFLECTED CEILING PLAN

Scale: 3/16"=1'-0"


	LIGHT FIXTURE SCHEDULE			
LABEL:	FIXTURE:	LAMP:	DESCRIPTION:	
F1	EXIST.	EXIST.	RE-INSTALL OR MATCH EXIST. 2'x2' LAY-IN FLUOR. FIXTURE.	
F2	LITHONIA LBL4 40L EZ1 LP840 (120/277) LED	4,000K / CRI 82	10"Wx48"L SURFACE MOUNTED LED FIXTURE W/ WRAP AROUND ACRYLIC LENS.	
F3	LITHONIA LBL2 20L EZ1 LP840 (120/277) LED	4,000K / CRI 82	10"Wx48"L SURFACE MOUNTED LED FIXTURE W/ WRAP AROUND ACRYLIC LENS.	
F4	LITHONIA FMLRL 11 14840 (120/277) LED	4,000K / CRI >80	11"Ø LOW PROFILE SURFACE FLUSH MOUNT LED FIXTURE.	
F5	LITHONIA OFLR 6LC 120 P WH LED		WALL OR SOFFIT MOUNTED LED FLOOD LIGHT FIXTURE.	
F6	LITHONIA TWH LED 10C 40K T3M PE DWHXD	4,000K / CRI >80	16"Wx15"T WALL MOUNTED LED LIGHT FIXTURE.	

### **CEILING PLAN SYMBOLS:**

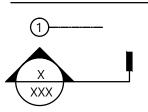

COLUMN LINE DESIGNATION

SECTION CUT SYMBOL

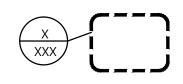



INTERIOR ELEVATION SYMBOL

PLAN NOTE DESIGNATION EQUIPMENT DESIGNATION

ELEVATION HEIGHT DESIGNATION

2'x2' SUSPENDED ACOUSTIC CEILING

GYPSUM BOARD SUSPENDED CEILING

2'x4' SUSPENDED ACOUSTIC CEILING INFORMATION AND REQUIREMENTS.

#### **GENERAL CEILING PLAN NOTES: KEYED CEILING PLAN NOTES:**

- 1. DO NOT SCALE PLANS. ENLARGED PLAN DIMENSIONS TAKE PRECEDENCE OVER SMALLER SCALE PLAN DIMENSIONS.
- 2. ALL INTERIOR DIMENSIONS ARE TAKEN FROM THE FACE OF MASONRY OR FINISHED WALL SURFACE UNLESS NOTED
- 3. COORDINATE ALL CEILING MOUNTED DEVICES, FIXTURES AND EQUIPMENT WITH APPLICABLE MECHANICAL AND ELECTRICAL
- 4. ALL ACOUSTICAL CEILING TILE TO MATCH EXIST. UNLESS NOTED OTHERWISE.
- 5. ALL FINISHED CEILING HEIGHTS TO BE MATCH EXIST. UNLESS NOTED OTHERWISE.
- 6. NEW FIRE ALARM DEVICES TO BE CONNECTED TO EXIST. FIRE ALARM PANEL. COORDINATE WITH FIRE ALARM VENDOR FOR REQUIRED SHUT-DOWNS, TESTING AND OTHER FIRE ALARM WORK. PLENUM WIRING TO BE RUN IN RIGID CONDUIT IN UNFINISHED AREAS & SURFACE RACEWAY WHERE VISIBLE IN
- FINISHED AREAS. 7. CONTRACTOR TO VERIFY FUNCTIONING OF EXISTING SWITCHES & LIGHTING CONTROLS INDICATED TO REMAIN.
- 8. PROTECT EXISTING SMOKE DETECTORS AND FIRE ALARM DEVICES DURING CONSTRUCTION. MECHANICAL PLAN, TYP.
- 9. REFER TO OWNER'S FUNCTIONAL SPECIFICATIONS FOR FURTHER
- PROVIDE NEW DIFFUSER TO MATCH EXISTING. REFER TO

1. INSTALL IN EXIST. BACK-BOX. WIRE TO EXIST. CIRCUIT &

PROVIDE NEW CEILING GRID, TILE, HANGERS AND

4. WIRE WITH 3-#12, 3/4" CONDUIT OR SURFACE RACEWAY

FROM NEW LIGHT FIXTURES TO OCCUPANCY SENSOR /

EXISTING CEILING TYPE, STYLE & COLOR, TYP.

WIRE EXIST. LIGHTING IN ROOM THROUGH NEW OCCUPANCY

ACCESSORIES IN PORTION OF CEILING INDICATED. MATCH

SWITCH BACK TO PANEL. RE-USE EXISTING CIRCUIT(S) THAT

PREVIOUSLY FED THIS AREA. EXISTING CONDUIT & WIRING

MAY BE REUSED WHEN SECURELY SUPPORTED PER NEC.

WIRE WITH 3-#12, 3/4" CONDUIT OR SURFACE RACEWAY

FROM NEW OR EXIST. LIGHT FIXTURE(S) TO OCCUPANCY

SENSOR / SWITCH & BACK TO PANEL. RE-USE EXISTING

CIRCUIT(S) THAT PREVIOUSLY FED THIS AREA. EXISTING

CONDUIT & WIRING MAY BE REUSED WHEN SECURELY

RE-INSTALL SALVAGED DIFFUSER. REFER TO MECHANICAL

LIGHTING IN SAME ROOM.

SENSOR TO EXIST. SWITCH.

SUPPORTED PER NEC.

NEW EXIT SIGN. WIRE WITH 3-#12, 3/4" CONDUIT OR SURFACE RACEWAY TO NEAREST AVAILABLE CIRCUIT IN EXIST. PANEL. 10. NOT USED.

11. INSTALL IN EXIST. BACK-BOX & WIRE TO EXIST. CIRCUIT. 12. VERIFY SWITCH OPERATION OF EXIST. LIGHTS & SWITCHES.

RE-RUN CIRCUITS AS REQ'D FOR NEW SWITCHING &

- CONNECT TO NEW OR EXIST. LIGHT FIXTURES AS INDICATED. 13. INSTALL IN EXIST. BACK-BOX. RE-RUN CIRCUIT AND PROVIDE NEW WIRING & CONDUIT OR SURFACE RACEWAY AS REQ'D
- FOR NEW CIRCUITING AND SWITCHING. 14. WIRE WITH 3-#12, 3/4" CONDUIT OR SURFACE RACEWAY FROM NEW LIGHT FIXTURE TO SWITCH & BACK TO PANEL. RE-USE EXISTING CIRCUIT(S) THAT PREVIOUSLY FED THIS AREA. EXISTING CONDUIT & WIRING MAY BE REUSED WHEN
- SECURELY SUPPORTED PER NEC. 15. CLEAN EXIST. CEILING GRID IN THIS ROOM OR AREA, PROVIDE NEW CEILING TILES THROUGHOUT.
- 16. CEILINGS ARE EXPOSED TO STRUCTURE IN THIS AREA, PAINT
- STRUCTURE, PIPING, CONDUIT AND OTHER EXPOSED ITEMS. 17. PROVIDE NEW RIGID SPIRAL DUCTWORK TAPPED INTO EXISTING SUPPLY TRUNK.
- 18. MOUNT FIXTURE TO UNI-STRUT SUPPORTS MOUNTED TO UNDERSIDE OF BAR JOISTS. 19. CONNECT NEW OR RE-USED LIGHT FIXTURE TO EXIST. CIRCUIT
- & SWITCH. 20. CEILING MOUNTED PROJECTOR BY OWNER.
- 21. PROVIDE NEW CEILING MOUNTED MANUAL PROJECTOR SCREEN.

- 22. RE-INSTALL EXIST. EXIT SIGN, EM LIGHT FIXTURE OR SMOKE DETECTOR IN SAME AREA & CONNECT TO EXIST. CIRCUIT.
- 23. PROVIDE NEW DRYWALL BULKHEAD. ALIGN WITH FACE OF BEAM.

### MECHANICAL & ELECTRICAL SYMBOL LEDGEND:

SINGLE POLE SWITCH EXISTING SWITCH TO BE REMOVED EXISTING SWITCH TO REMAIN SINGLE POLE SWITCH WITH OCCUPANCY SENSOR THREE-WAY SWITCH FOUR-WAY SWITCH DIMMABLE SWITCH  $\Rightarrow$ **DUPLEX OUTLET** EXISTING OUTLET TO BE REMOVED EXISTING OUTLET TO REMAIN QUAD OUTLET DUPLEX OUTLET, GROUND FAULT INTERUPT  $\rightarrow$ GF <del>─</del>W.P. DUPLEX OUTLET, WEATHER PROOF **DUPLEX OUTLET ON DEDICATED CIRCUT** DUPLEX OUTLET, FLOOR MOUNTED 

 $-\bigcirc$ JUNCTION BOX  $\bigcirc$ JUNCTION BOX, FLOOR MOUNTED  $\bigcirc$ JUNCTION BOX, CEILING MOUNTED

 $\blacksquare$ 

 $- \bigcirc$ SPECIALTY OUTLET -O<sub>220V</sub> SPECIALTY OUTLET, 220 VOLT

TELEPHONE JACK DATA PORT (NUMBER INDICATES # OF JACKS & CABLES EXISTING TELEPHONE OR DATA PORT TO BE REMOVED

DUPLEX OUTLET, CEILING MOUNTED

EXISTING TELEPHONE OR DATA PORT TO REMAIN N TELEPHONE JACK, FLOOR MOUNTED

DATA PORT, FLOOR MOUNTED

WALL MOUNTED SMOKE DETECTOR

DATA PORT, CEILING MOUNTED CABLE TV OUTLET

GAS APPLIANCE CONNECTION  $\bigcirc$ CEILING MOUNTED SPEAKER (C) CARBON MONOXIDE DETECTOR

**⊚** CEILING MOUNTED OCCUPANCY SENSOR SMOKE DETECTOR HP<sub>S</sub>

P.S. FIRE ALARM PULL STATION FX FIRE ALARM STROBE

> EXIT SIGN (ARROWS AS INDICATED) +42"A.F.F

HEIGHT TO CENTER OF DEVICE OR BOX A.F.F. **ELECTRICAL DISTRIBUTION PANEL** 

FIRE ALARM STROBE & HORN

LAY-IN FLUORESCENT LIGHT FIXTURE LAY-IN DIFFUSER FLUORESCENT LIGHT FIXTURE SURFACE MOUNTED FLUORESCENT LIGHT FIXTURE EMERGENCY LIGHT FIXTURE W/ BATTERY BACK-UP

SURFACE MOUNTED LIGHT FIXTURE PULL CHAIN LIGHT FIXTURE  $\mathfrak{D}$ SUSPENDED OR PENDANT MOUNTED LIGHT FIXTURE

RECESSED CAN LIGHT FIXTURE MP MOISTURE-PROOF RECESSED CAN LIGHT FIXTURE

RECESSED CAN LIGHT W/ DIRECTIONAL BAFFLE Ю WALL MOUNTED LIGHT FIXTURE

QQQQ OVER VANITY LIGHT FIXTURE D EM □ WALL MOUNTED EMERGENCY LIGHT FIXTURE

EXHAUST FAN Ю WALL MOUNTED EXHAUST FAN otinEXHAUST FAN WITH LIGHT  $\sim$ GARBAGE DISPOSAL

CEILING MOUNTED PROJECTOR -T HVAC CONTROL DEVICE

CEILING MOUNTED HVAC SUPPLY AIR REGISTER

CEILING MOUNTED LINEAR HVAC SUPPLY AIR REGISTER CEILING MOUNTED ROUND HVAC SUPPLY REGISTER CEILING MOUNTED HVAC RETURN AIR REGISTER

FLOOR MOUNTED HVAC SUPPLY AIR REGISTER FLOOR MOUNTED HVAC RETURN AIR REGISTER

DUCT MOUNTED HVAC SUPPLY AIR REGISTER

 $\bigoplus$ SPRINKLER HEAD  $\boxtimes$ GAS OR WATER MAIN SHUT-OFF VALVE

ELECTRICAL MAIN DISCONNECT SWITCH F.P. H.B. FROST-PROOF DOMESTIC WATER HOSE BIBB

## DOMESTIC COLD WATER CONNECTION (SIZE AS NOTED)

© M2Ke design 2015

M2Ke design

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dhill@m2ke.com

www.m2ke.com

M2Ke Design LLC

IN LIC#: PC81500014

Hobart, Indiana, 46342-5233

**VALPARAISO UNIVERSITY POLICE** DEPARTMENT

**NEW POLICE** STATION **RENOVATIONS** 

813 LAPORTE AVE., VALPARAISO, INDIANA


MARK DATE DESCRIPTION |10/26/15 | 75% CDs 11/12/15 | 95% CDs

## LOWER LEVEL REFLECTED **CEILING PLAN**

SCALE: 3/16"=1'-0" CLIENT: DATE: 10/07/15 PROJECT: 029001

DRAWN: DRH


FILE: 029001A-A140-RCP00

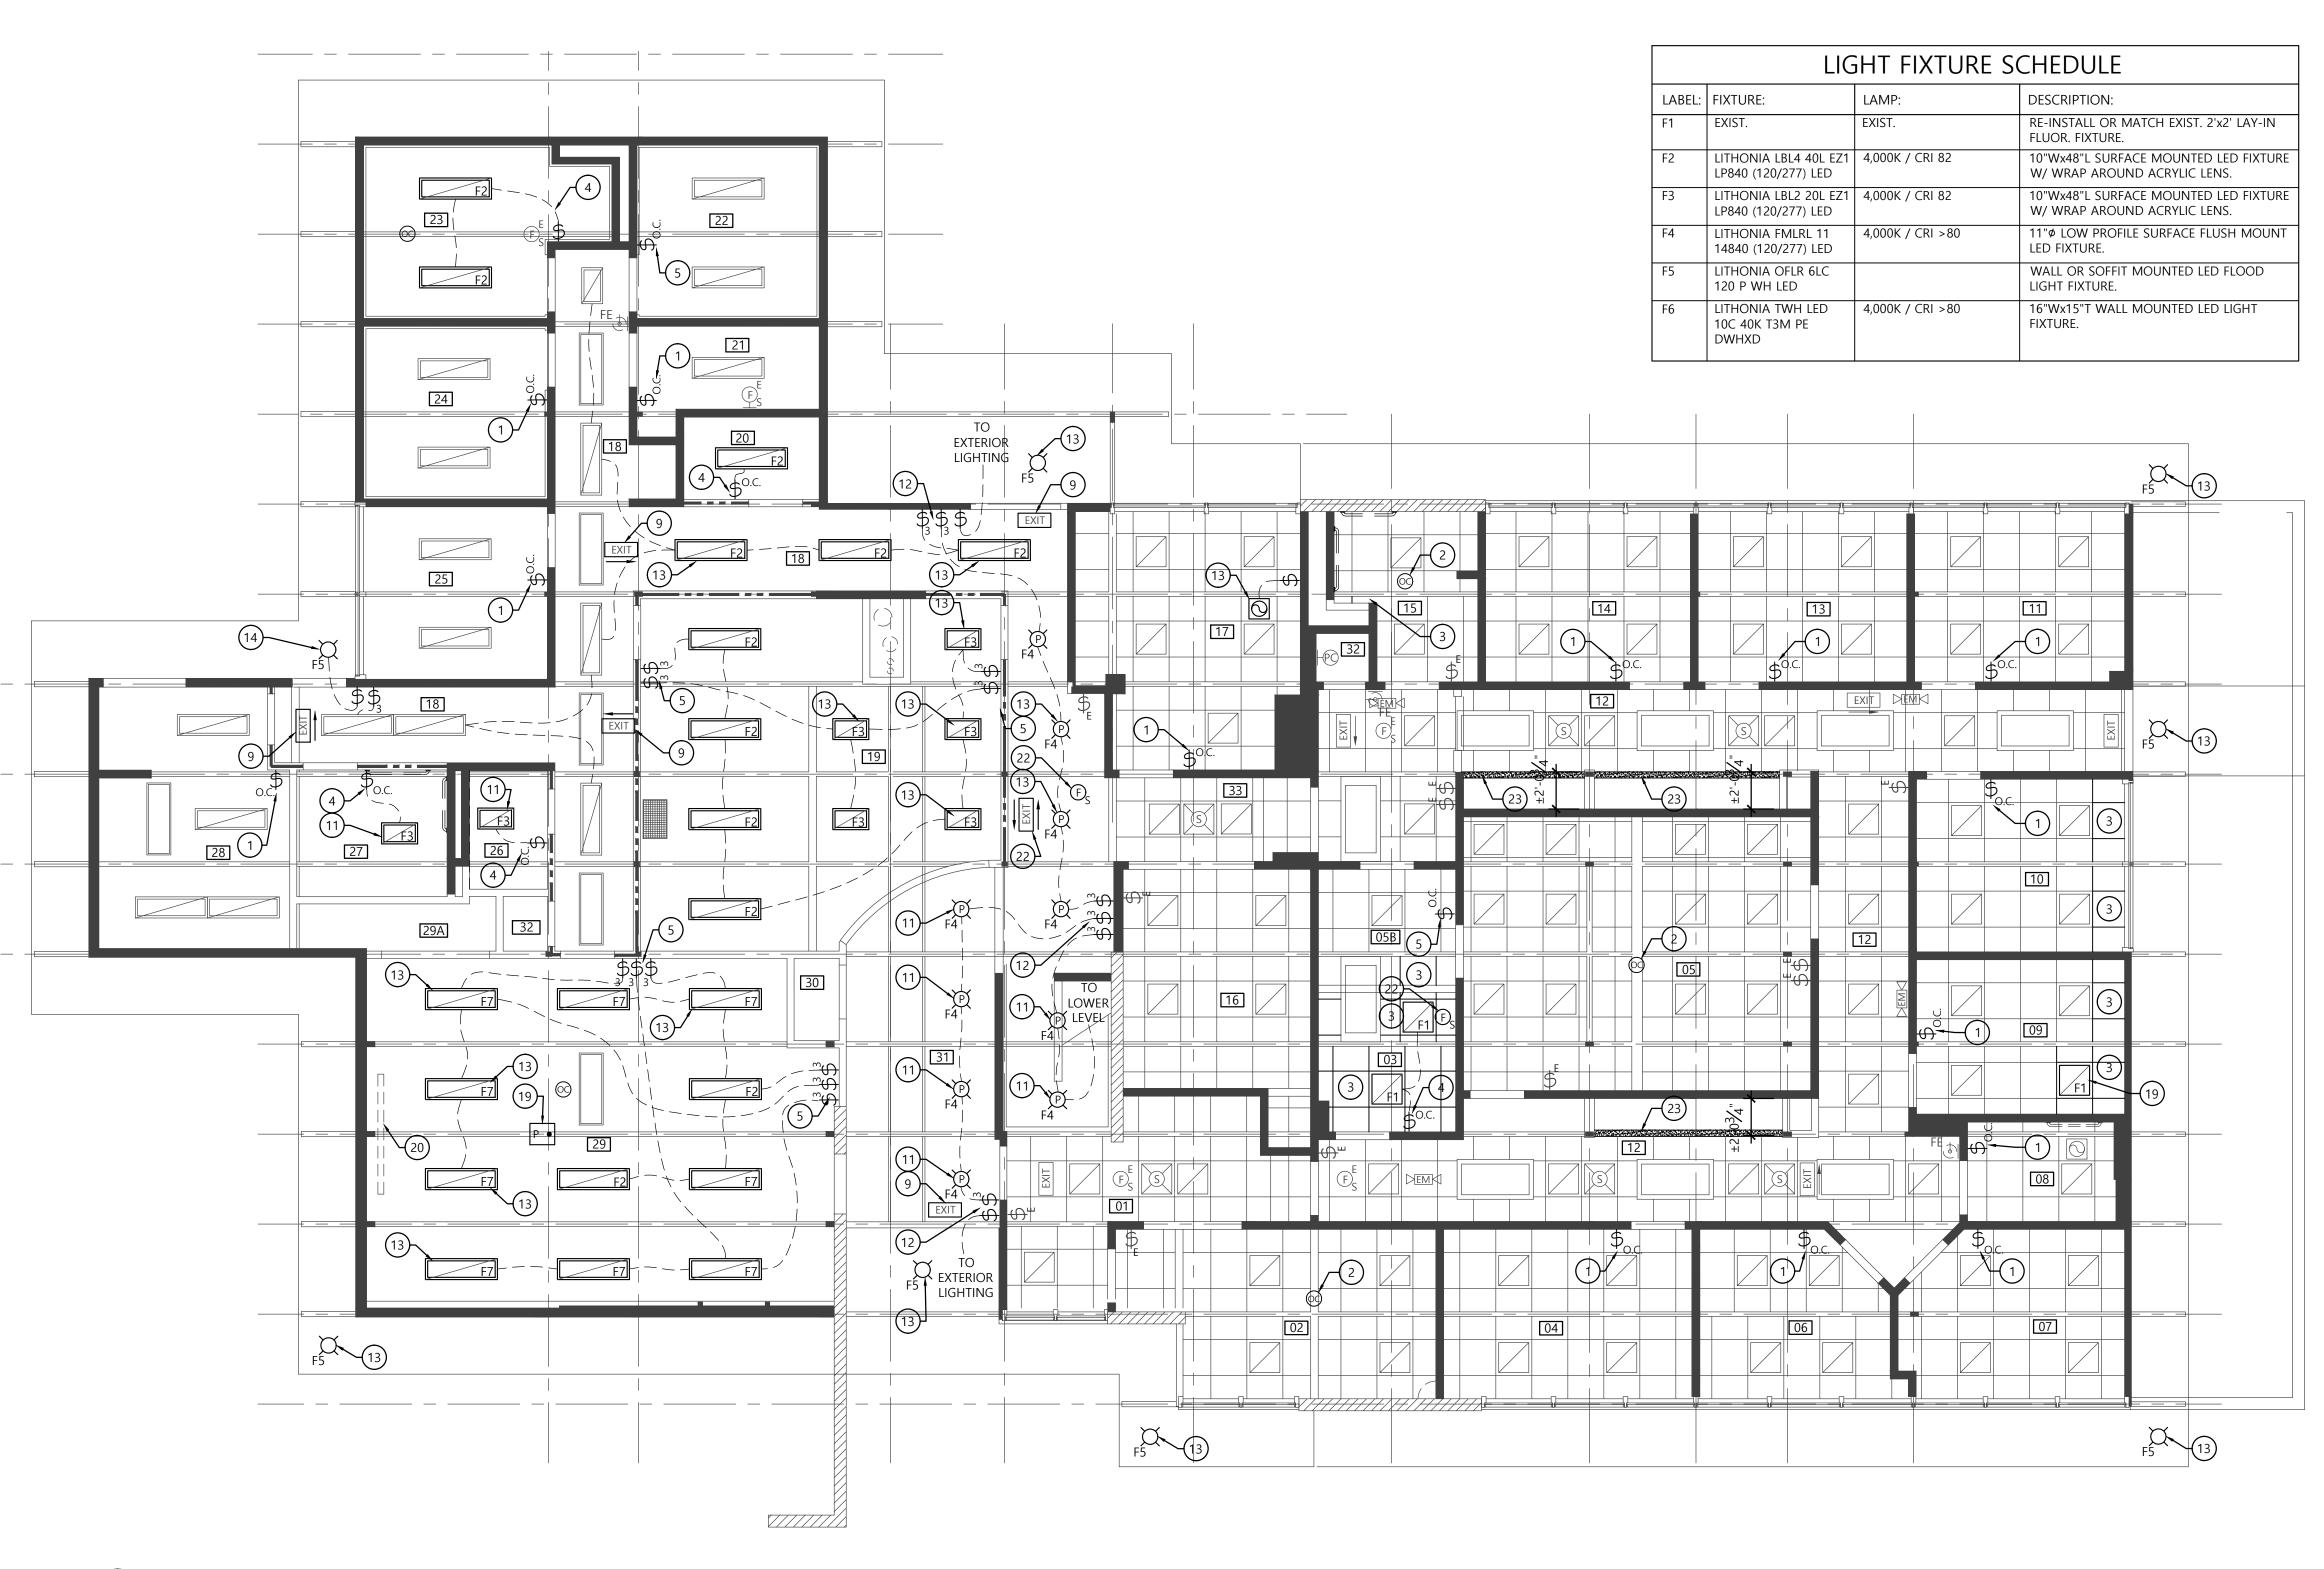

FIRST FLOOR REFLECTED CEILING PLAN


Scale: 3/16"=1'-0"

#### **CEILING PLAN SYMBOLS:**

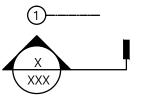


COLUMN LINE DESIGNATION



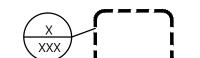

PLAN DETAIL SYMBOL

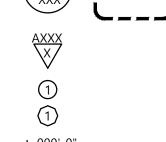

INTERIOR ELEVATION SYMBOL

PLAN NOTE DESIGNATION **EQUIPMENT DESIGNATION** 

**ELEVATION HEIGHT DESIGNATION** 

2'x2' SUSPENDED ACOUSTIC CEILING

2'x4' SUSPENDED ACOUSTIC CEILING

GYPSUM BOARD SUSPENDED CEILING

### **GENERAL CEILING PLAN NOTES:**

- 1. DO NOT SCALE PLANS. ENLARGED PLAN DIMENSIONS TAKE PRECEDENCE OVER SMALLER SCALE PLAN DIMENSIONS. 2. ALL INTERIOR DIMENSIONS ARE TAKEN FROM THE FACE OF MASONRY OR FINISHED WALL SURFACE UNLESS NOTED
- OTHERWISE. 3. COORDINATE ALL CEILING MOUNTED DEVICES, FIXTURES AND
- EQUIPMENT WITH APPLICABLE MECHANICAL AND ELECTRICAL DRAWINGS. 4. ALL ACOUSTICAL CEILING TILE TO MATCH EXIST. UNLESS NOTED
- OTHERWISE.
- 5. ALL FINISHED CEILING HEIGHTS TO BE MATCH EXIST. UNLESS NOTED OTHERWISE.
- 6. NEW FIRE ALARM DEVICES TO BE CONNECTED TO EXIST. FIRE ALARM PANEL. COORDINATE WITH FIRE ALARM VENDOR FOR REQUIRED SHUT-DOWNS, TESTING AND OTHER FIRE ALARM WORK. PLENUM WIRING TO BE RUN IN RIGID CONDUIT IN UNFINISHED AREAS & SURFACE RACEWAY WHERE VISIBLE IN FINISHED AREAS.
- 7. CONTRACTOR TO VERIFY FUNCTIONING OF EXISTING SWITCHES & LIGHTING CONTROLS INDICATED TO REMAIN.
- 8. PROTECT EXISTING SMOKE DETECTORS AND FIRE ALARM DEVICES DURING CONSTRUCTION.
- 9. REFER TO OWNER'S FUNCTIONAL SPECIFICATIONS FOR FURTHER INFORMATION AND REQUIREMENTS.

#### **KEYED CEILING PLAN NOTES:**

- 1. INSTALL IN EXIST. BACK-BOX. WIRE TO EXIST. CIRCUIT & LIGHTING IN SAME ROOM.
- 2. WIRE EXIST. LIGHTING IN ROOM THROUGH NEW OCCUPANCY SENSOR TO EXIST. SWITCH. 3. PROVIDE NEW CEILING GRID, TILE, HANGERS AND
- ACCESSORIES IN PORTION OF CEILING INDICATED. MATCH EXISTING CEILING TYPE, STYLE & COLOR, TYP. 4. WIRE WITH 3-#12, 3/4" CONDUIT OR SURFACE RACEWAY
- FROM NEW LIGHT FIXTURES TO OCCUPANCY SENSOR / SWITCH BACK TO PANEL. RE-USE EXISTING CIRCUIT(S) THAT PREVIOUSLY FED THIS AREA. EXISTING CONDUIT & WIRING MAY BE REUSED WHEN SECURELY SUPPORTED PER NEC.
- WIRE WITH 3-#12, 3/4" CONDUIT OR SURFACE RACEWAY FROM NEW OR EXIST. LIGHT FIXTURE(S) TO OCCUPANCY SENSOR / SWITCH & BACK TO PANEL. RE-USE EXISTING CIRCUIT(S) THAT PREVIOUSLY FED THIS AREA. EXISTING CONDUIT & WIRING MAY BE REUSED WHEN SECURELY
- SUPPORTED PER NEC. RE-INSTALL SALVAGED DIFFUSER. REFER TO MECHANICAL
- PROVIDE NEW DIFFUSER TO MATCH EXISTING. REFER TO MECHANICAL PLAN, TYP.

NOT USED.

NEW EXIT SIGN. WIRE WITH 3-#12, 3/4" CONDUIT OR SURFACE RACEWAY TO NEAREST AVAILABLE CIRCUIT IN EXIST. PANEL.

11. INSTALL IN EXIST. BACK-BOX & WIRE TO EXIST. CIRCUIT 12. VERIFY SWITCH OPERATION OF EXIST. LIGHTS & SWITCHES.

RE-RUN CIRCUITS AS REQ'D FOR NEW SWITCHING &

- CONNECT TO NEW OR EXIST. LIGHT FIXTURES AS INDICATED. 13. INSTALL IN EXIST. BACK-BOX. RE-RUN CIRCUIT AND PROVIDE NEW WIRING & CONDUIT OR SURFACE RACEWAY AS REQ'D FOR NEW CIRCUITING AND SWITCHING.
- 14. WIRE WITH 3-#12, 3/4" CONDUIT OR SURFACE RACEWAY FROM NEW LIGHT FIXTURE TO SWITCH & BACK TO PANEL. RE-USE EXISTING CIRCUIT(S) THAT PREVIOUSLY FED THIS AREA. EXISTING CONDUIT & WIRING MAY BE REUSED WHEN SECURELY SUPPORTED PER NEC.
- 15. CLEAN EXIST. CEILING GRID IN THIS ROOM OR AREA, PROVIDE NEW CEILING TILES THROUGHOUT.
- 16. CEILINGS ARE EXPOSED TO STRUCTURE IN THIS AREA, PAINT STRUCTURE, PIPING, CONDUIT AND OTHER EXPOSED ITEMS. 17. PROVIDE NEW RIGID SPIRAL DUCTWORK TAPPED INTO
- EXISTING SUPPLY TRUNK. 18. MOUNT FIXTURE TO UNI-STRUT SUPPORTS MOUNTED TO
- UNDERSIDE OF BAR JOISTS. 19. CONNECT NEW OR RE-USED LIGHT FIXTURE TO EXIST. CIRCUIT & SWITCH.
- 20. CEILING MOUNTED PROJECTOR BY OWNER. 21. PROVIDE NEW CEILING MOUNTED MANUAL PROJECTOR SCREEN.

22. RE-INSTALL EXIST. EXIT SIGN, EM LIGHT FIXTURE OR SMOKE DETECTOR IN SAME AREA & CONNECT TO EXIST. CIRCUIT. 23. PROVIDE NEW DRYWALL BULKHEAD. ALIGN WITH FACE OF BEAM.

#### M2Ke design MECHANICAL & ELECTRICAL SYMBOL LEDGEND:

SINGLE POLE SWITCH

THREE-WAY SWITCH

FOUR-WAY SWITCH

DIMMABLE SWITCH

DUPLEX OUTLET

QUAD OUTLET

JUNCTION BOX

SPECIALTY OUTLET

TELEPHONE JACK

CABLE TV OUTLET

SMOKE DETECTOR

FIRE ALARM STROBE

\$<sup>0.c.</sup>

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\$<sup>DIM</sup>

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EXISTING SWITCH TO BE REMOVED

EXISTING OUTLET TO BE REMOVED

DUPLEX OUTLET, WEATHER PROOF

DUPLEX OUTLET, FLOOR MOUNTED

DUPLEX OUTLET, CEILING MOUNTED

JUNCTION BOX, FLOOR MOUNTED

JUNCTION BOX, CEILING MOUNTED

TELEPHONE JACK, FLOOR MOUNTED

DATA PORT, FLOOR MOUNTED

DATA PORT, CEILING MOUNTED

GAS APPLIANCE CONNECTION

CARBON MONOXIDE DETECTOR

WALL MOUNTED SMOKE DETECTOR

EXIT SIGN (ARROWS AS INDICATED)

ELECTRICAL DISTRIBUTION PANEL

LAY-IN FLUORESCENT LIGHT FIXTURE

SURFACE MOUNTED LIGHT FIXTURE

PULL CHAIN LIGHT FIXTURE

RECESSED CAN LIGHT FIXTURE

WALL MOUNTED LIGHT FIXTURE

WALL MOUNTED EXHAUST FAN

CEILING MOUNTED PROJECTOR

**EXHAUST FAN WITH LIGHT** 

HVAC CONTROL DEVICE

SPRINKLER HEAD

GARBAGE DISPOSAL

QQQQ OVER VANITY LIGHT FIXTURE

EXHAUST FAN

HEIGHT TO CENTER OF DEVICE OR BOX A.F.F.

LAY-IN DIFFUSER FLUORESCENT LIGHT FIXTURE

SURFACE MOUNTED FLUORESCENT LIGHT FIXTURE EMERGENCY LIGHT FIXTURE W/ BATTERY BACK-UP

SUSPENDED OR PENDANT MOUNTED LIGHT FIXTURE

MOISTURE-PROOF RECESSED CAN LIGHT FIXTURE

RECESSED CAN LIGHT W/ DIRECTIONAL BAFFLE

WALL MOUNTED EMERGENCY LIGHT FIXTURE

CEILING MOUNTED HVAC SUPPLY AIR REGISTER

CEILING MOUNTED LINEAR HVAC SUPPLY AIR REGISTER

CEILING MOUNTED ROUND HVAC SUPPLY REGISTER

CEILING MOUNTED HVAC RETURN AIR REGISTER

FLOOR MOUNTED HVAC SUPPLY AIR REGISTER

FLOOR MOUNTED HVAC RETURN AIR REGISTER

DUCT MOUNTED HVAC SUPPLY AIR REGISTER

GAS OR WATER MAIN SHUT-OFF VALVE

ELECTRICAL MAIN DISCONNECT SWITCH

FROST-PROOF DOMESTIC WATER HOSE BIBB

DOMESTIC COLD WATER CONNECTION (SIZE AS NOTED)

CEILING MOUNTED OCCUPANCY SENSOR

CEILING MOUNTED SPEAKER

FIRE ALARM PULL STATION

FIRE ALARM STROBE & HORN

DATA PORT (NUMBER INDICATES # OF JACKS & CABLES)

EXISTING TELEPHONE OR DATA PORT TO BE REMOVED

EXISTING TELEPHONE OR DATA PORT TO REMAIN

SPECIALTY OUTLET, 220 VOLT

**DUPLEX OUTLET ON DEDICATED CIRCUT** 

DUPLEX OUTLET, GROUND FAULT INTERUPT

EXISTING OUTLET TO REMAIN

SINGLE POLE SWITCH WITH OCCUPANCY SENSOR

EXISTING SWITCH TO REMAIN

791 Lincoln Street Hobart, Indiana, 46342-5233 **(2**19) 798-0395 (312) 550-3203 dhill@m2ke.com www.m2ke.com

M2Ke Design LLC IN LIC#: PC81500014 © M2Ke design 2015



VALPARAISO **UNIVERSITY POLICE** DEPARTMENT

> NEW POLICE **STATION RENOVATIONS** 2015

813 LAPORTE AVE., VALPARAISO, INDIANA

	MARK	DATE	DESCRIPTION
	1	10/26/15	75% CDs
	2	11/12/15	95% CDs
•			
•			


## **FIRST** FLOOR REFLECTED **CEILING PLAN**


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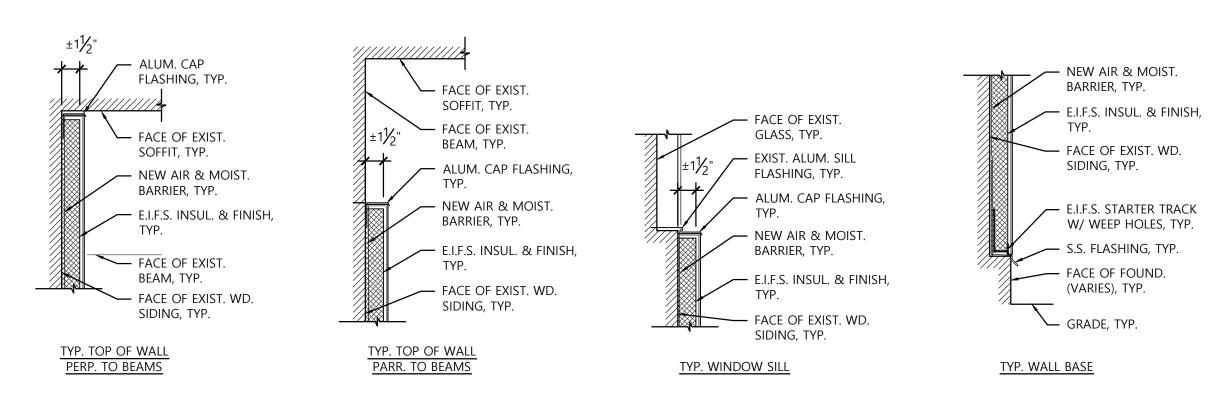
DRAWN: DRH

029001

FILE: 029001A-A150-RCP01



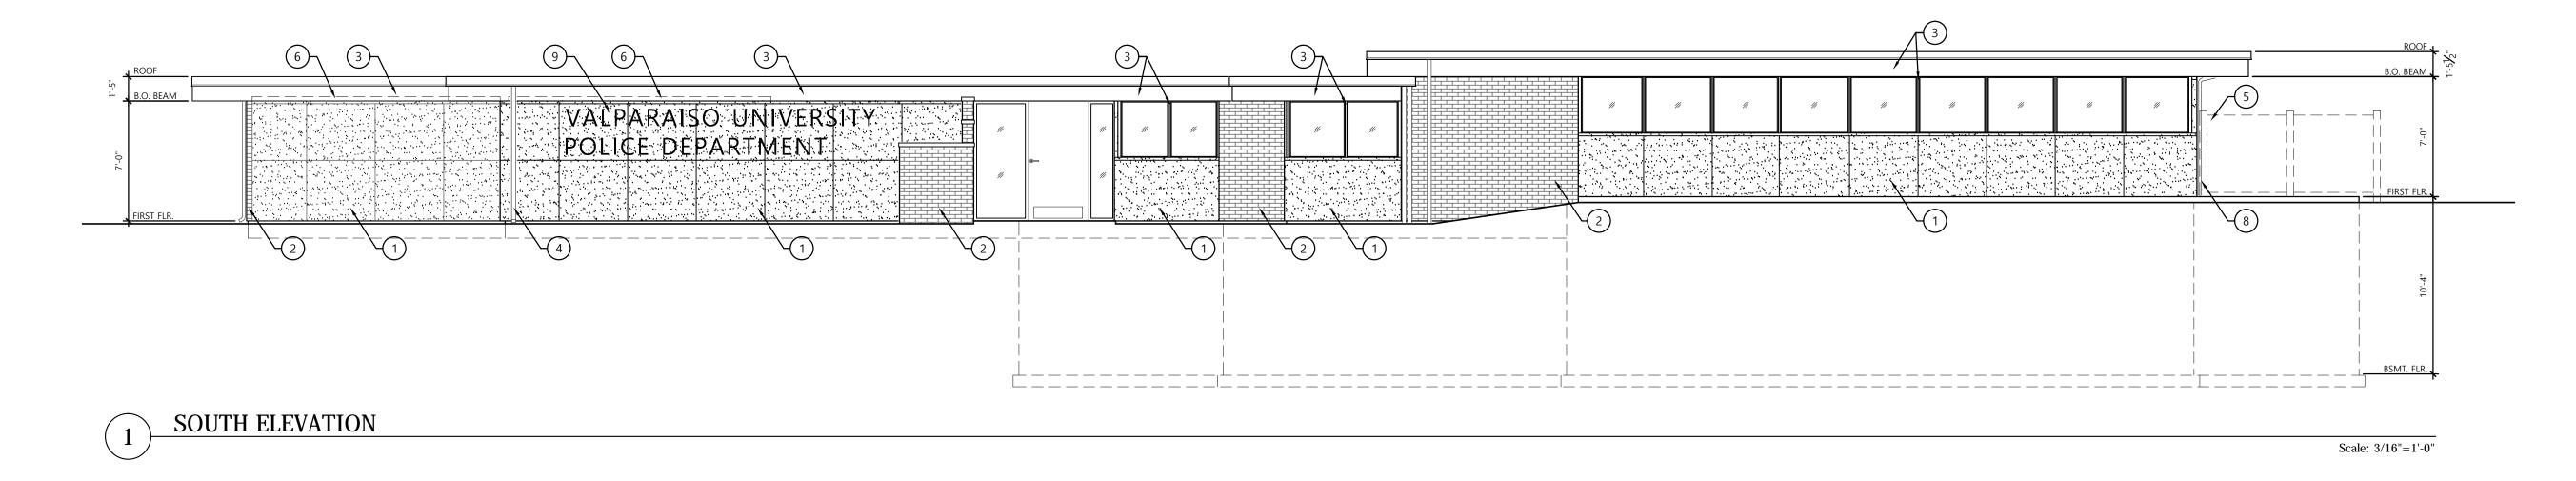

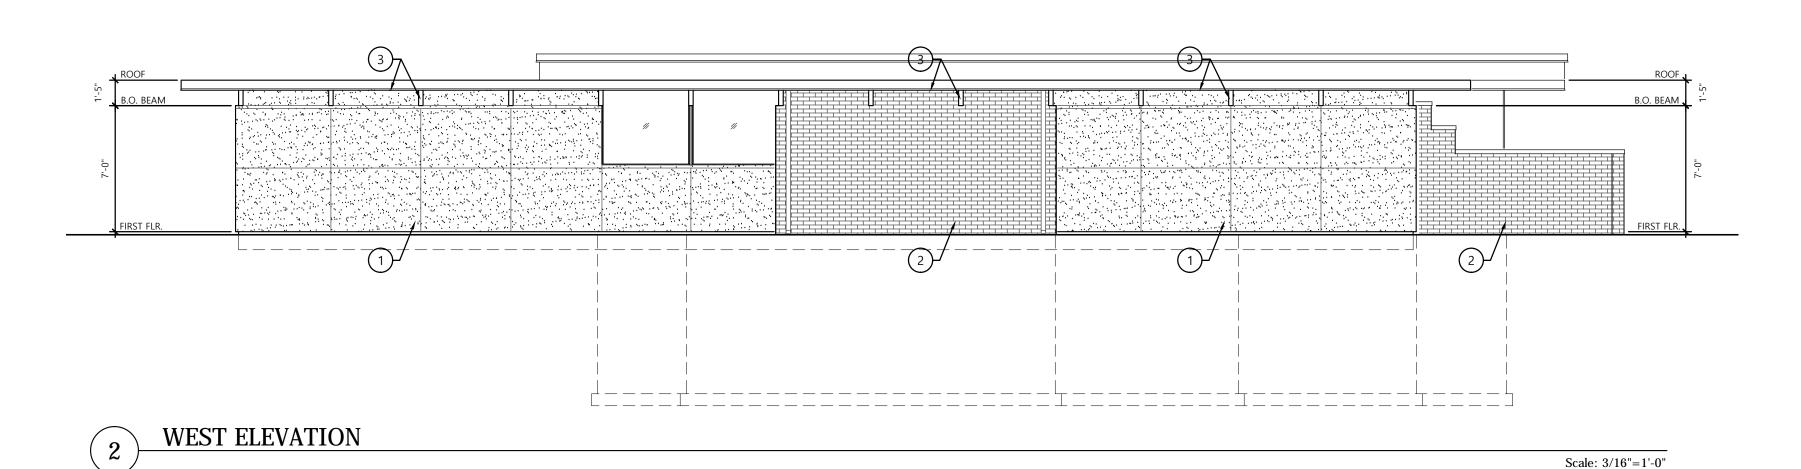

TYP. E.I.F.S. DETAILS

Scale: 1 1/2"=1'-0"

## M2Ke design

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M2Ke Design LLC
IN LIC#: PC81500014
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## VALPARAISO UNIVERSITY POLICE DEPARTMENT

NEW POLICE STATION RENOVATIONS 2015

813 LAPORTE AVE., VALPARAISO, INDIANA

MARK	DATE	DESCRIPTION
1	10/20/15	OWNER REVIEW
2	10/26/15	75% CDs

#### **ELEVATION SYMBOLS:**



COLUMN LINE DESIGNATION

SECTION CUT SYMBOL

ELEVATION DETAIL SYMBOL

1 ELEVATION NOTE DESIGNATION

WINDOW SCHEDULE DESIGNATION

000'-0"

ELEVATION HEIGHT DESIGNATION

### GENERAL ELEVATION NOTES:

- CONTRACTOR TO VERIFY ALL EXISTING CONDITIONS AND NOTIFY ARCHITECT OF ANY DISCREPANCIES.
- 2. DO NOT SCALE DRAWINGS. ENLARGED DRAWING DIMENSIONS TAKE PRECEDENCE OVER SMALLER SCALE DRAWING DIMENSIONS.
- 3. ALL EXTERIOR DIMENSIONS ARE TAKEN FROM THE FACE OF CONCRETE OR MASONRY UNLESS NOTED OTHERWISE.
- 4. ALL FLOOR LEVEL DIMENSIONS ARE TAKEN FROM THE FACE OF CONCRETE SLABS UNLESS NOTED OTHERWISE.
- 5. ALL HEAD HEIGHTS ARE TAKEN FROM THE ADJACENT FLOOR LEVEL UNLESS NOTED OTHERWISE.
- 6. CONTRACTOR TO PROVIDE ALL TEMPORARY SHORING, BRACING, BARRIERS, PARTITIONS OR OTHER TEMPORARY FACILITIES AS REQUIRED.
- 7. MAINTAIN EXISTING CONSTRUCTION TO REMAIN IN A SAFE AND WEATHER-TIGHT CONDITION THROUGHOUT CONSTRUCTION.

#### **KEYED ELEVATION NOTES:**

- PROVIDE NEW E.I.F.S. WALL FINISH. VARY EXTERIOR INSULATION THICKNESS (± 1 1/2" AVERAGE THICKNESS) AS REQUIRED TO ACHIEVE AN EVEN EXTERIOR WALL PLANE. REFER TO TYPICAL DETAILS & FUNCTIONAL SPECIFICATIONS FOR FURTHER INFORMATION & REQUIREMENTS.
- 2. TUCK-POINT EXIST. BRICK WALL SURFACE TO REMAIN. PROVIDE
- FULL DEPTH, TOOLED JOINTS, TYP.

  3. PREP, PRIME & PAINT ALL EXPOSED WOOD SURFACES WITH OIL-DBASED EXTERIOR PAINT. REFER TO FUNCTIONAL SPECIFICATIONS FOR FURTHER INFORMATION & REQUIREMENTS.
- ACCOMMODATE NEW E.I.F.S. WALL FINISH, TYP.

  5. EXIST. FENCING TO REMAIN. PROTECT FROM DAMAGE DURING

  CONSTRUCTION OF PENALVE & PENALVE AT CONTRACTORIS

4. REMOVE & RE-INSTALL EXIST. DOWNSPOUTS AS REQ'D TO

- CONSTRUCTION OR REMOVE & REINSTALL AT CONTRACTOR'S OPTION.
- 6. REMOVE PORTION OF EXIST. WOOD SIDING THAT EXTENDS ABOVE BOTTOM OF BEAM IN THIS AREA.7. SHOT BLAST EXIST. CONCRETE FOUNDATION WALL TO REMAIN.
- SHOT BLAST EXIST. CONCRETE FOUNDATION WALL TO REMAIN.
   EXTEND EXIST. DOWNSPOUT TO COURTYARD & CONNECT TO COURTYARD SUMP.
- 9. INSTALL WALL MOUNTED SIGNAGE LETTERS FURNISHED BY OWNER.

EXTER	IOR
ELEVA	TIONS


SCALE: 3/16"=1'-0" CLIENT: 029


DATE: 10/07/15 PROJECT: 029001

DRAWN: DRH

APPRVD: DRH


FILE: 029001A-A200-XELEVS

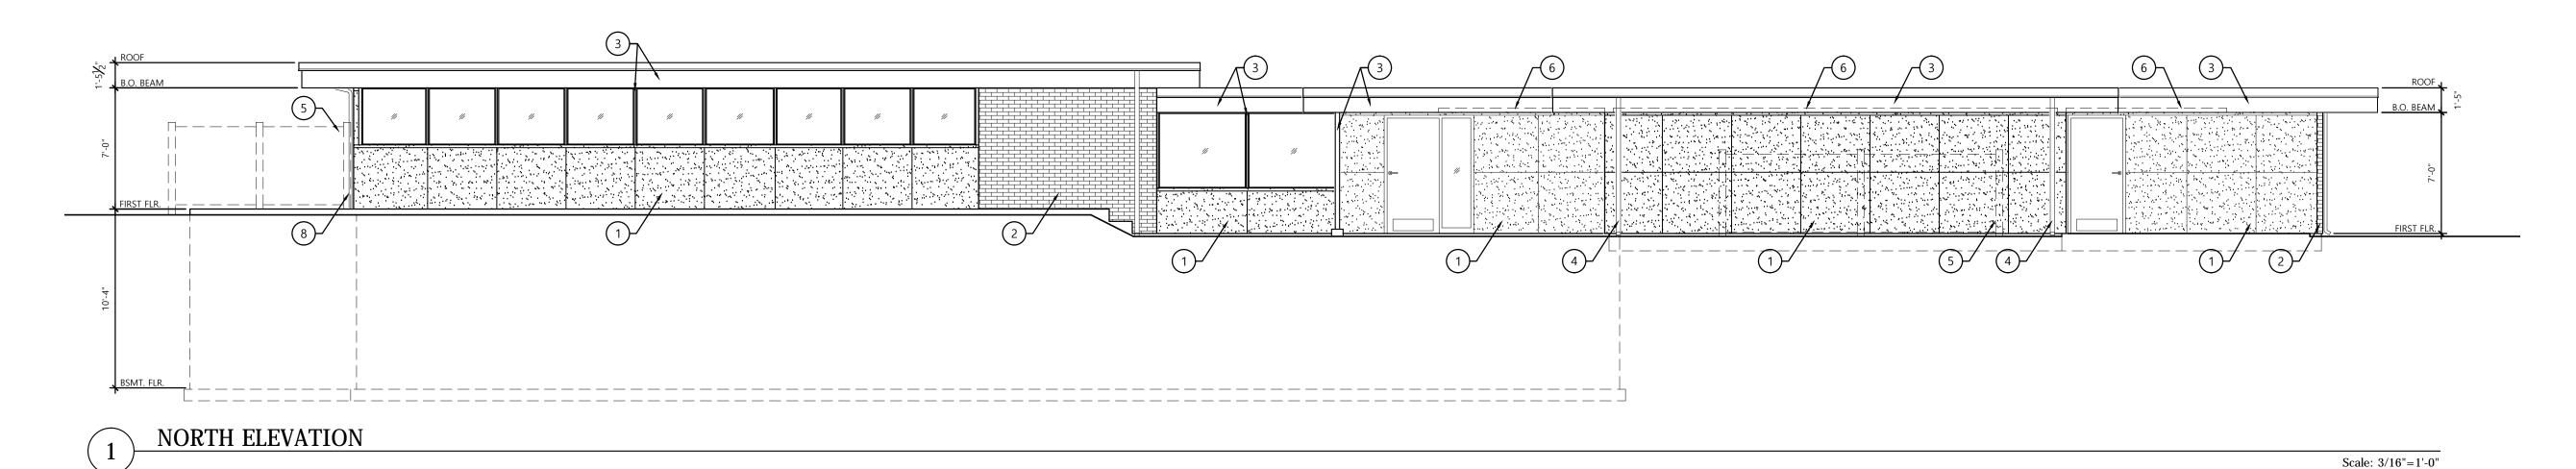

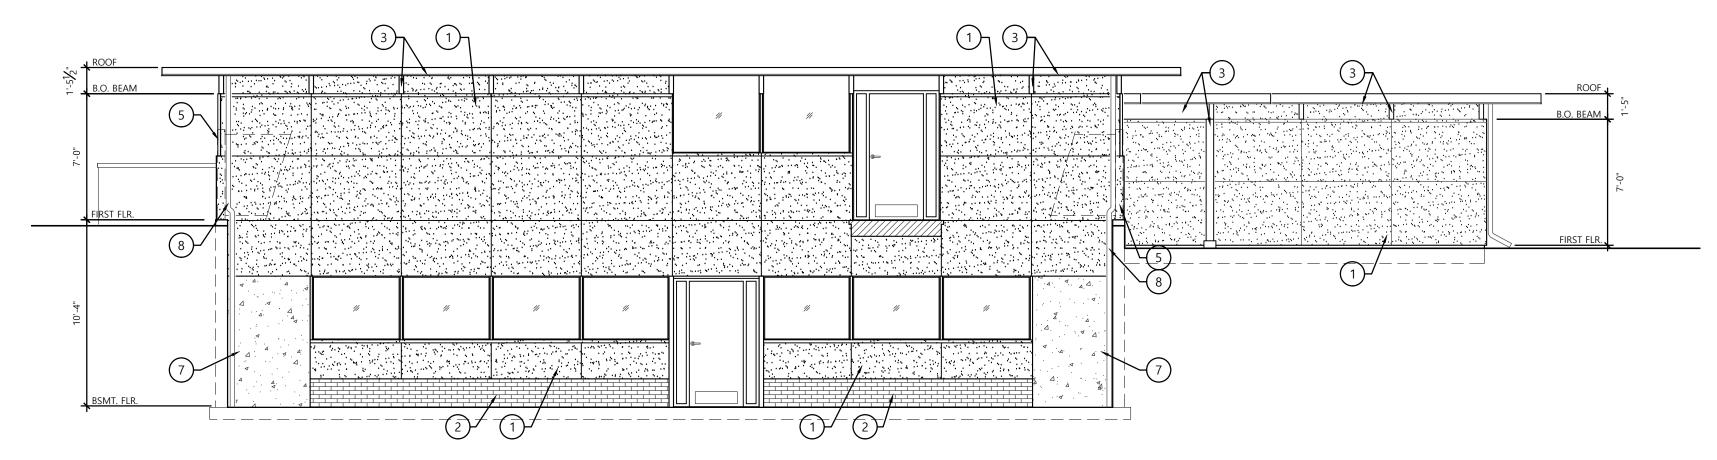

2 EAST ELEVATION

Scale: 3/16"=1'-0"

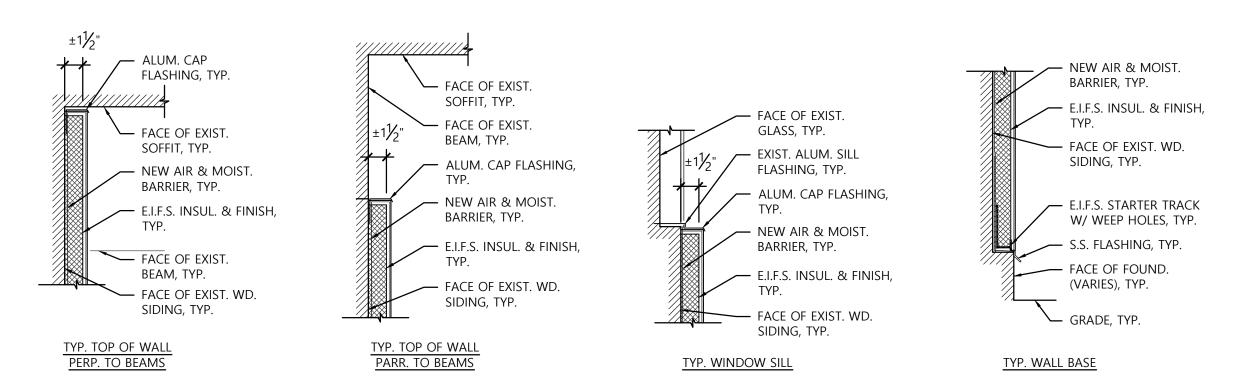

TYP. E.I.F.S. DETAILS

Scale: 1 1/2"=1'-0"

## M2Ke design

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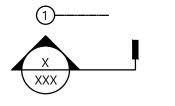
## VALPARAISO UNIVERSITY POLICE DEPARTMENT

## NEW POLICE STATION RENOVATIONS 2015

813 LAPORTE AVE., VALPARAISO, INDIANA

MARK	DATE	DESCRIPTION
1	11/12/15	95% CDs

#### **ELEVATION SYMBOLS:**



COLUMN LINE DESIGNATION

SECTION CUT SYMBOL

XXXX	
1	

ELEVATION DETAIL SYMBOL

1	
1	
◆ 000'-0" T.O.X.	
T.O.X.	-

ELEVATION NOTE DESIGNATION

WINDOW SCHEDULE DESIGNATION

ELEVATION HEIGHT DESIGNATION

### GENERAL ELEVATION NOTES:

- CONTRACTOR TO VERIFY ALL EXISTING CONDITIONS AND NOTIFY
   ARCHITECT OF ANY DISCREPANCIES.
- 2. DO NOT SCALE DRAWINGS. ENLARGED DRAWING DIMENSIONS TAKE PRECEDENCE OVER SMALLER SCALE DRAWING DIMENSIONS.
- 3. ALL EXTERIOR DIMENSIONS ARE TAKEN FROM THE FACE OF CONCRETE OR MASONRY UNLESS NOTED OTHERWISE.4. ALL FLOOR LEVEL DIMENSIONS ARE TAKEN FROM THE FACE OF
- CONCRETE SLABS UNLESS NOTED OTHERWISE.

  5. ALL HEAD HEIGHTS ARE TAKEN FROM THE ADJACENT FLOOR LEVEL
- UNLESS NOTED OTHERWISE.

  6. CONTRACTOR TO PROVIDE ALL TEMPORARY SHORING, BRACING, BARRIERS, PARTITIONS OR OTHER TEMPORARY FACILITIES AS
- REQUIRED.

  7. MAINTAIN EXISTING CONSTRUCTION TO REMAIN IN A SAFE AND WEATHER-TIGHT CONDITION THROUGHOUT CONSTRUCTION.

#### **KEYED ELEVATION NOTES:**

- PROVIDE NEW E.I.F.S. WALL FINISH. VARY EXTERIOR INSULATION
   THICKNESS (± 1 1/2" AVERAGE THICKNESS) AS REQUIRED TO
   ACHIEVE AN EVEN EXTERIOR WALL PLANE. REFER TO TYPICAL
   DETAILS & FUNCTIONAL SPECIFICATIONS FOR FURTHER
   INFORMATION & REQUIREMENTS.
- 2. TUCK-POINT EXIST. BRICK WALL SURFACE TO REMAIN. PROVIDE FULL DEPTH, TOOLED JOINTS, TYP.
- PREP, PRIME & PAINT ALL EXPOSED WOOD SURFACES WITH OIL-DBASED EXTERIOR PAINT. REFER TO FUNCTIONAL SPECIFICATIONS FOR FURTHER INFORMATION & REQUIREMENTS.
   REMOVE & RE-INSTALL EXIST. DOWNSPOUTS AS REQ'D TO
- ACCOMMODATE NEW E.I.F.S. WALL FINISH, TYP.

  5. EXIST. FENCING TO REMAIN. PROTECT FROM DAMAGE DURING CONSTRUCTION OR REMOVE & REINSTALL AT CONTRACTOR'S
- 6. REMOVE PORTION OF EXIST. WOOD SIDING THAT EXTENDS ABOVE BOTTOM OF BEAM IN THIS AREA.
- 7. SHOT BLAST EXIST. CONCRETE FOUNDATION WALL TO REMAIN.8. EXTEND EXIST. DOWNSPOUT TO COURTYARD & CONNECT TO
- COURTYARD SUMP.

  9. INSTALL WALL MOUNTED SIGNAGE LETTERS FURNISHED BY OWNER.


EXTERIOR
<b>ELEVATIONS</b>

SCALE:	3/16"=1'-0	" CLIENT:	029
DATE:	10/07/15	PROJECT:	029001

DRAWN: DRH

PPRVD: DRH

FILE: 029001A-A210-XELEVS

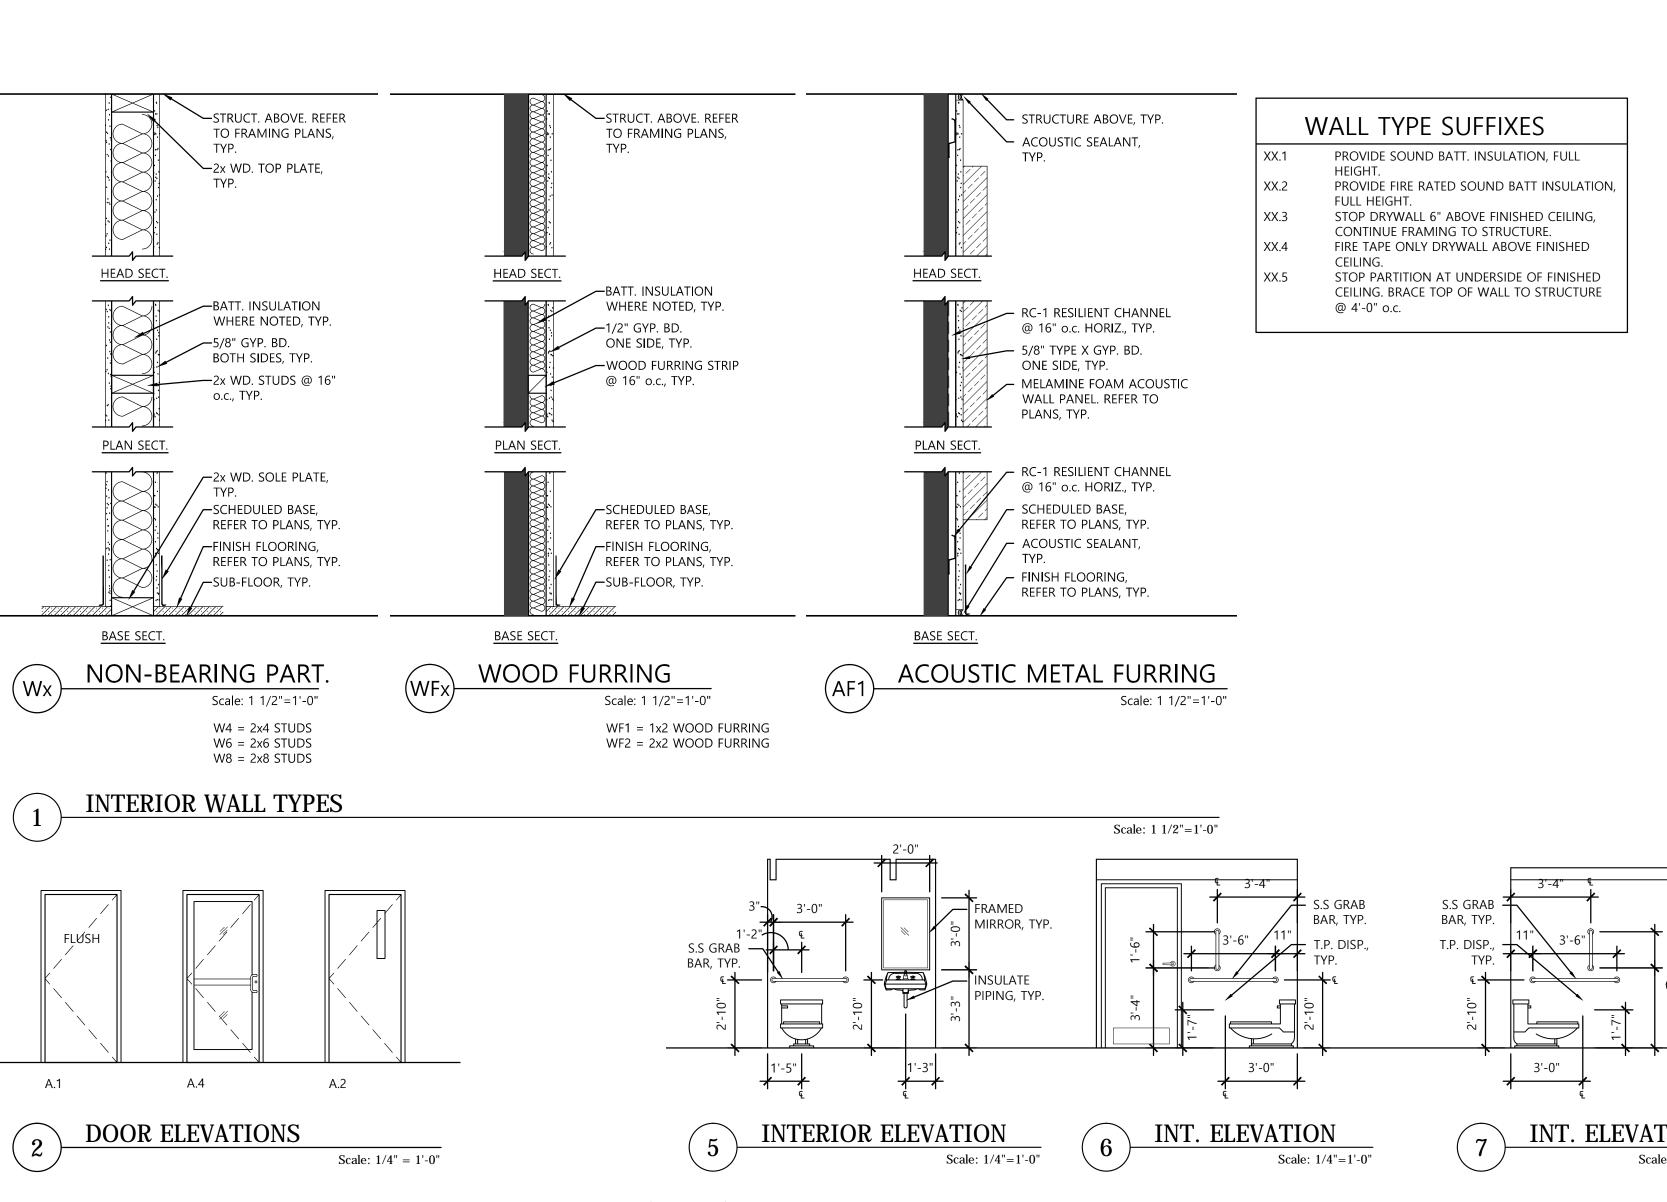

DR.	RM.			DOOR			FRAME				
NO.		ROOM NAME	RAT'G	NOM. SIZE	MATL.	ELEV.	MATL.	ELEV.	DETL.	HDWR.	REMARKS
31	B1	MECHANICAL	N/A	CUSTOM	H.MTL.	A.1, 2/A400	H.MTL.	M.1, 3/A400	SET 02, 4/A400	SET 01	CECO GALV'D DOOR & FRAME, FIT TO EXIST. M.O.
32	B2	MECHANICAL	N/A	CUSTOM	H.MTL.	A.1, 2/A400	H.MTL.	M.1, 3/A400	SET 02, 4/A400	SET 01	CECO GALV'D DOOR & FRAME, FIT TO EXIST. M.O.
3	В3	EVIDENCE STOR.	N/A	3-0x7-0	H.MTL.	A.1, 2/A400	EXIST.	EXIST.	EXIST.	SET 01	CECO DOOR & EXIST. FRAME
35	B5	OPERATIONS STOR.	N/A	3-0x7-0	H.MTL.	A.1, 2/A400	H.MTL.	M.1, 3/A400	SET 02, 4/A400	SET 01	CECO DOOR & FRAME
39	В9	MEN'S	N/A	EXIST.	FL.WD.	A.1, 2/A400	EXIST.	EXIST.	EXIST.	SET 02	OWNER FURNISHED SLAB. INSTALL SLAB & HARDWARE
310	B10	WOMEN'S	N/A	EXIST.	FL.WD.	A.1, 2/A400	EXIST.	EXIST.	EXIST.	SET 02	OWNER FURNISHED SLAB. INSTALL SLAB & HARDWARE
313	B13	CORRIDOR	N/A	EXIST.	EXIST.	EXIST.	EXIST.	EXIST.	EXIST.	SET 03	
21		RECORDS	N/A	EXIST.		EXIST.		EXIST.	EXIST.	SET 08	
Э5-B		ARMORY	N/A	3-0x6-8		A.1, 2/A400	WD.	W.1, 3/A400	SET 04, 4/A400		
12-A	12	CORRIDOR	N/A	3-0x6-8		A.2, 2/A400	WD.	W.1, 3/A400	SET 04, 4/A400		
12-B	12	CORRIDOR	N/A	3-0x6-8		A.2, 2/A400		EXIST.	EXIST.	SET 04	NEW SLAB, TRIM & HARDWARE IN EXIST. FRAME
12-C	12	CORRIDOR		EXIST.		EXIST.		EXIST.	EXIST.	SET 03	
18	18	CORRIDOR	N/A	3-0x6-8				M.1, 3/A400	SET 03, 4/A400		CECO POLYURETHANE INSUL'D GALV'D DOOR & FRAM
19-A	19	COMMUNICATIONS	20 min.	3-0x6-8				M.1, 3/A400	SET 03, 4/A400		
19-B	19	COMMUNICATIONS		3-0x6-8				M.1, 3/A400	SET 03, 4/A400		
20	20	BUILDING SERVICES	20 min.		FL.WD.			M.1, 3/A400	SET 03, 4/A400		
21	21	A/V ROOM	20 min.			EXIST.		EXIST.	EXIST.	SET 10	
22	22	INTERVIEW	20 min.			EXIST.		EXIST.	EXIST.	SET 10	
23	23	INTERVIEW	20 min.			EXIST.		EXIST.	EXIST.	SET 10	
24	24	SOFT INTERVIEW	20 min.	3-0x6-8		EXIST.		EXIST.	EXIST.	SET 10	
26	26	WOMEN'S	20 min.	2-6x6-8				M.1, 3/A400	SET 03, 4/A400		
27	27	UNISEX	20 min.	3-0x6-8				M.1, 3/A400	SET 03, 4/A400		
28	28	QUARTER MASTER		2-10x6-8				M.1, 3/A400	SET 03, 4/A400		
29-A	29	TRAINING	N/A	(2)3-0x6-8		A.1, 2/A400	WD.	W.1, 3/A400	SET 04, 4/A400		
29-B	29	TRAINING	20 min.					M.1, 3/A400	SET 03, 4/A400		
29-C	29	TRAINING	N/A	3-0x6-8				M.1, 3/A400	SET 02, 4/A400		
30	30	IT CLOSET	N/A	3-0x6-8				M.1, 3/A400	SET 03, 4/A400		
31	31	LOBBY	N/A	3-0x6-8			H.MTL.		SET 03, 4/A400		
32	32	CLOSET	N/A	2-6x6-8	FL.WD.	A.1, 2/A400	WD.	W.1, 3/A400	SET 04, 4/A400		
33	33	CORRIDOR	N/A	3-0x6-8	H.MTL.	A.1, 2/A400	H.MTL.	M.3, 3/A400	SET 03, 4/A400	SET 06	CECO POLYURETHANE INSUL'D GALV'D DOOR & FRAM

PROVIDE 1/4" TEMPERED GLASS GLAZING PER CODE REQUIREMENTS.

PROVIDE NEW LEVEL HANDLED LATCH SETS ON ALL EXIST. LOWER LEVEL DOORS SHOWN TO REMAIN. VERIFY LATCH SET FUNCTIONS & KEYING WITH OWNER. REFINISH EXIST. DOOR SLABS AS REQ'D.

OWNER TO RE-KEY ALL EXIST. FIRST FLOOR DOORS SHOWN TO REMAIN.

NO	ITEM	TYPE	1	MANUF.	1	SCHEDULE Tremarks
NO.	HINGES	4.5"x4.5" BALL BEARING	3	HAGER	FINISH BHMA 626	HINGES BY DOOR MANUFACTURER FOR PRE-HUNG DOORS
361 01	LATCH SET	9K37D16C (STORAGE)	1	BEST	BHMA 626	W/ "ATHENS" LEVER TRIM
	LOCK	BEST CYLINDER	1 1	BEST	BHMA 626	KEY WAY TO MATCH EXIST. KEY SYSTEM
	CLOSER	4040 SURFACE CLOSER	1	LCN	BHMA 628	ALUMINUM COVER
	KICKPLATES	K1050-B4E-CSK	2	ROCKWOOD	BHMA 626	
SET 02	HINGES	4.5"x4.5" BALL BEARING	3	HAGER	BHMA 626	HINGES BY DOOR MANUFACTURER FOR PRE-HUNG DOORS
JL1 02	LATCH SET	9K37L16C (PRIVACY)	1	BEST	BHMA 626	W/ "ATHENS" LEVER TRIM
	CLOSER	4040 SURFACE CLOSER	1	LCN	BHMA 628	ALUMINUM COVER
	KICKPLATES	K1050-B4E-CSK	2	ROCKWOOD	BHMA 626	
SET 03	EXIT DEVICE	9927L-NL	1	VON DUPRIN	RHMΔ 626	ALL OTHER HARDWARE IS EXIST. TO REMAIN
JL1 0J	LOCK	BEST CYLINDER	1 1	BEST	BHMA 626	KEY WAY TO MATCH EXIST. KEY SYSTEM
	KICKPLATES	K1050-B4E-CSK	2	ROCKWOOD	BHMA 626	
CET OA	HINGES	4.5"x4.5" BALL BEARING	3	HAGER	BHMA 626	HINGES BY DOOR MANUFACTURER FOR PRE-HUNG DOORS
JL1 U4	EXIT DEVICE	9927L-BE	1	VON DUPRIN		THINGES BY DOOR WANDI ACTURER FOR PRE-HUNG DOORS
	LOCK	BEST CYLINDER	1	BEST	BHMA 626	KEY WAY TO MATCH EXIST. KEY SYSTEM
	CLOSER	4040 SURFACE CLOSER	1	LCN	BHMA 628	ALUMINUM COVER
	KICKPLATES	K1050-B4E-CSK	2	ROCKWOOD	BHMA 626	
SET 05	HINGES	4.5"x4.5" BALL BEARING	3	HAGER	BHMA 626	HINGES BY DOOR MANUFACTURER FOR PRE-HUNG DOORS
	EXIT DEVICE	9927L-NL	1	VON DUPRIN	BHMA 626	
	LOCK	BEST CYLINDER	1	BEST	BHMA 626	KEY WAY TO MATCH EXIST. KEY SYSTEM
	CLOSER KICKPLATES	4040 SURFACE CLOSER K1050-B4E-CSK	1 2	LCN ROCKWOOD	BHMA 628 BHMA 626	PUSH SIDE MOUNT, ALUMINUM COVER
	RICKPLATES	K1030-b4E-C3K		ROCKWOOD	BHIVIA 020	
SET 06	HINGES	4.5"x4.5" BALL BEARING	3	HAGER	BHMA 626	HINGES BY DOOR MANUFACTURER FOR PRE-HUNG DOORS
	EXIT DEVICE LOCK	9927L-NL BEST CYLINDER	1 1	VON DUPRIN BEST	BHMA 626 BHMA 626	KEY WAY TO MATCH EXIST. KEY SYSTEM
	ELECTRIC STRIKE		1	ADAMS RITE		REY WAY TO MATCH EXIST. REY SYSTEM
	CLOSER	4040 SURFACE CLOSER	1	LCN	BHMA 628	PUSH SIDE MOUNT, ALUMINUM COVER
	KICKPLATES	K1050-B4E-CSK	2	ROCKWOOD	BHMA 626	
SET 07	HINGES	4.5"x4.5" BALL BEARING	3	HAGER	BHMA 626	HINGES BY DOOR MANUFACTURER FOR PRE-HUNG DOORS
	LATCH SET	9K37R16C (CLASSROOM)	1	BEST	BHMA 626	W/ "ATHENS" LEVER TRIM
	LOCK	BEST CYLINDER	1	BEST	BHMA 626	KEY WAY TO MATCH EXIST. KEY SYSTEM
	ELECTRIC STRIKE		1	ADAMS RITE		ALLINAINI INA COVER
	CLOSER KICKPLATES	4040 SURFACE CLOSER K1050-B4E-CSK	1 2	LCN ROCKWOOD	BHMA 628 BHMA 626	ALUMINUM COVER
	SOUND GASKET		1	ZERO INT.	GREY	
		367 AUTOMATIC	1	ZERO INT.	BHMA 626	
CET NO	ELECTRIC STRIKE	7140 2 1 0 626	1	ADAMS RITE	DUMA 626	ALL OTHER HARDWARE IS EXIST. TO REMAIN
SE1 00	ELECTRIC STRIKE	7140-3-1-0-020	'	ADAIVIS KITE	DHIVIA 020	ALL OTHER HARDWARE IS EXIST. TO REMAIN
SET 09	HINGES	4.5"x4.5" BALL BEARING	3	HAGER	BHMA 626	
	LATCH SET	9K37R16C (CLASSROOM)	1	BEST	BHMA 626	W/ "ATHENS" LEVER TRIM
	LOCK	BEST CYLINDER 4040 SURFACE CLOSER	1 1	BEST LCN	BHMA 626 BHMA 628	KEY WAY TO MATCH EXIST. KEY SYSTEM ALUMINUM COVER
	CLOSER KICKPLATES	K1050-B4E-CSK	2	ROCKWOOD	BHMA 626	ALUMINOM COVER
<u> </u>						
SEI 10	SOUND GASKET	770A 367 AUTOMATIC	1	ZERO INT. ZERO INT.	GREY BHMA 626	ALL OTHER HARDWARE IS EXIST. TO REMAIN
		JOI NOTOWINTIC		ZENO IIVI.	טווויות טבט	
SET 11	HINGES	4.5"x4.5" BALL BEARING	6	HAGER	BHMA 626	HINGES BY DOOR MANUFACTURER FOR PRE-HUNG DOORS
	LATCH SET LOCK	9K37D16C (STORAGE)	1	BEST BEST	BHMA 626 BHMA 626	W/ "ATHENS" LEVER TRIM
	FLUSH BOLTS	BEST CYLINDER FB358	2	IVES	BHMA 626	KEY WAY TO MATCH EXIST. KEY SYSTEM
	KICKPLATES	K1050-B4E-CSK	4	ROCKWOOD	BHMA 626	
CET 10	HINGES	4.5"x4.5" BALL BEARING	6	HAGER	BHMA 626	HINGES BY DOOR MANUFACTURER FOR PRE-HUNG DOORS
JLI 1Z	LATCH SET	9K37N16C (PASSAGE)	1	BEST	BHMA 626	W/ "ATHENS" LEVER TRIM
	KICKPLATES	K1050-B4E-CSK	4	ROCKWOOD	BHMA 626	
CET 12	HINGES	4.5"x4.5" BALL BEARING	3	HAGER	BHMA 626	HINGES BY DOOR MANUFACTURER FOR PRE-HUNG DOORS
JĽI 13	LATCH SET	9K37R16C (CLASSROOM)	1	BEST	BHMA 626	W/ "ATHENS" LEVER TRIM
		BEST CYLINDER	1	BEST	BHMA 626	KEY WAY TO MATCH EXIST. KEY SYSTEM
	ELECTRIC STRIKE	7140-3-1-0-626	1	ADAMS RITE	BHMA 626	
		4040 SURFACE CLOSER	_			ALUMINUM COVER
	KICKPLATES	K1050-B4E-CSK	2	ROCKWOOD	BHMA 626	

## M2Ke design

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## VALPARAISO **UNIVERSITY POLICE** DEPARTMENT

## NEW POLICE STATION **RENOVATIONS** 2015

813 LAPORTE AVE., VALPARAISO, INDIANA

MARK	DATE	DESCRIPTION
1	11/12/15	95% CDs


## INTERIOR ELEVS, SCHEDULES & DETAILS


SCALE: VARIES CLIENT: DATE: 10/07/15 PROJECT: 029001

DRAWN: DRH

APPRVD: DRH

FILE: 029001A-A400-SCHEDS

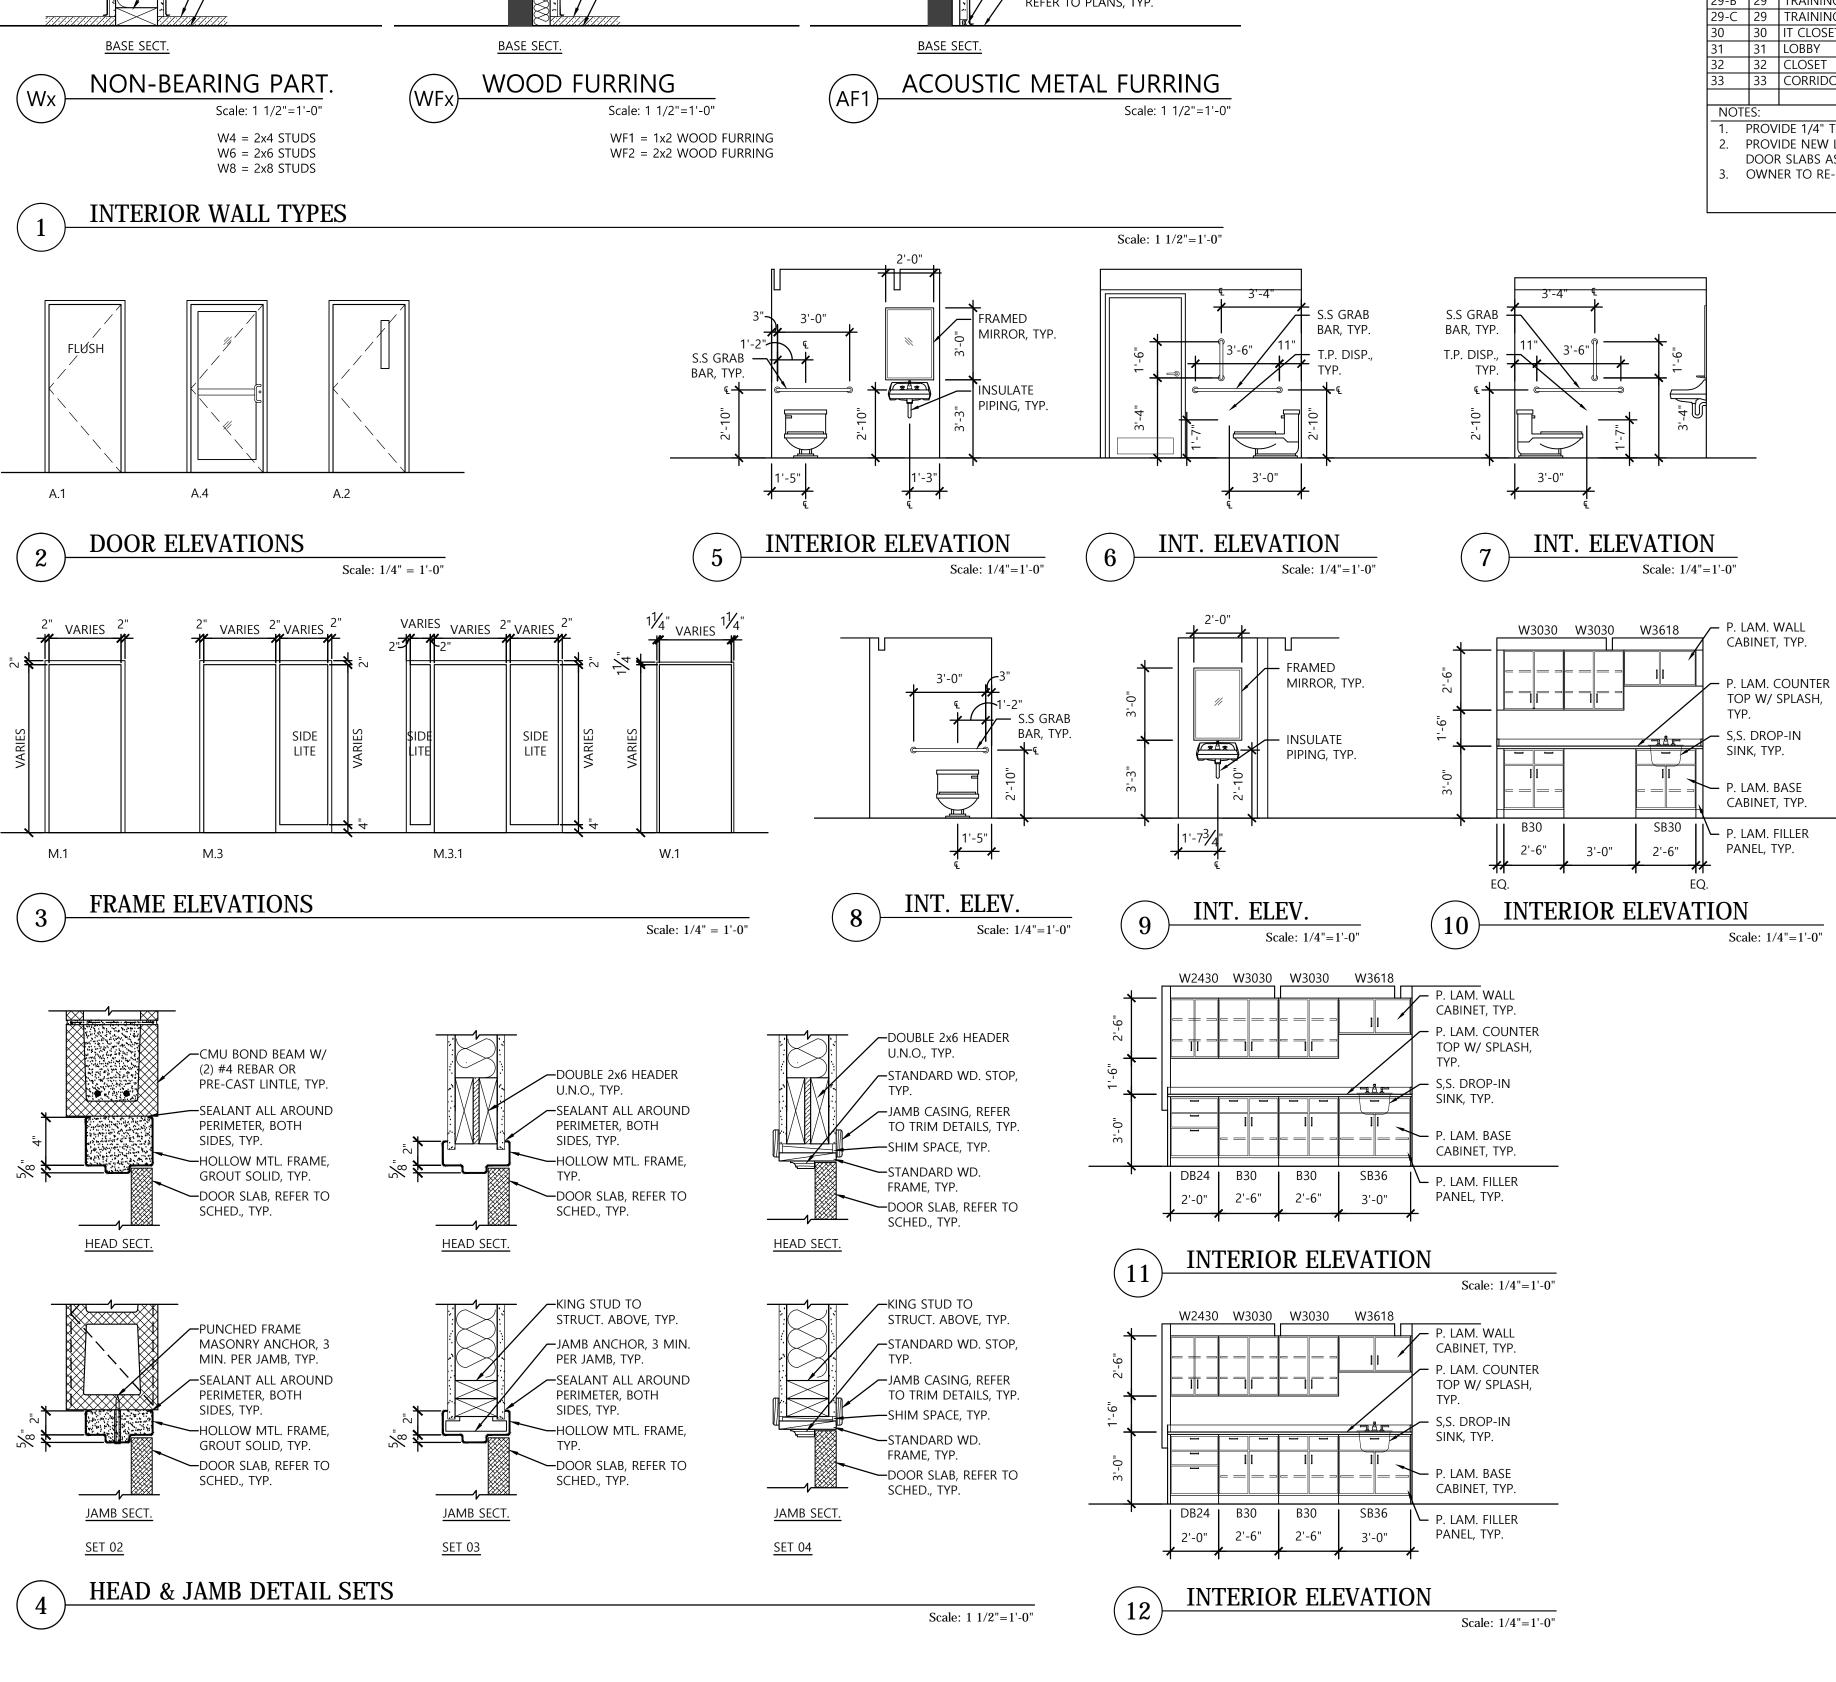

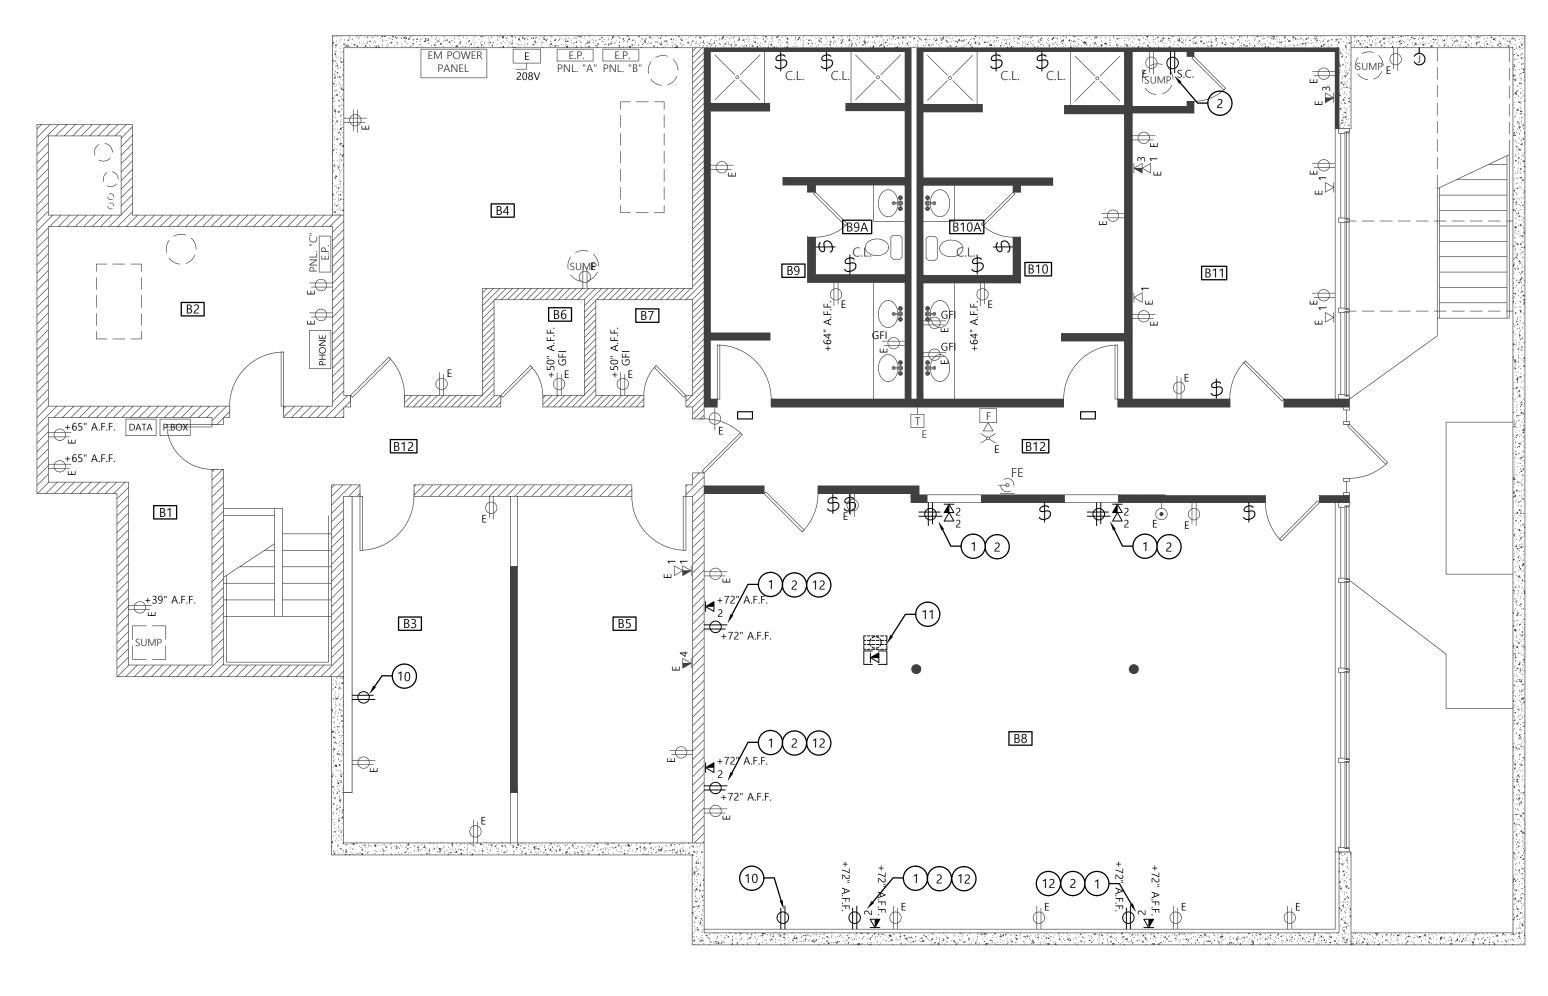

LOWER LEVEL POWER & AUXILIARY PLAN

Scale: 3/16"=1'-0"

#### GENERAL POWER/AUX. PLAN NOTES:

- 1. CONTRACTOR TO VERIFY CONDITION. LOCATION AND CAPACITY OF ALL EXISTING ELECTRICAL PANELS. FURNISH & INSTALL NEW FUSE BLOCKS OR BREAKERS IN EACH LOCATION THAT IS BEING TERMINATED TO WHERE EXISTING ARE UNSERVICEABLE. MATCH EXISTING TYPE & RATING.
- 2. ALL NEW CIRCUITS TO BE 20A UNLESS NOTED OTHERWISE. 3. WHERE EXIST. POWER RECEPTACLES AND DATA OR PHONE JACKS ARE INDICATED TO REMAIN, VERIFY CONTINUITY OR CONNECTIVITY OF EACH DEVICE. REPLACE DAMAGED OR UNSERVICEABLE DEVICES AND COVER
- PLATES AS REQUIRED. 4. WHERE SHOWN IN THE SAME LOCATIONS, DATA & PHONE JACKS TO BE
- INSTALLED IN THE SAME SINGLE GANG BOX.
- 5. DATA AND PHONE WIRING TO BE INSTALLED ABOVE FINISHED CEILINGS UTILIZING J-HOOKS OR CABLE TRAY. CABLING MAY NOT BE SUPPORTED BY FINISHED CEILING SYSTEMS. PROVIDE SURFACE MOUNTED RACEWAY IN EXPOSED AREAS.
- 6. NEW FIRE ALARM DEVICES TO BE CONNECTED TO EXIST. FIRE ALARM PANEL. COORDINATE WITH FIRE ALARM VENDOR FOR REQUIRED SHUT-DOWNS, TESTING AND OTHER FIRE ALARM WORK.
- 7. PROTECT EXISTING SMOKE DETECTORS AND FIRE ALARM DEVICES DURING CONSTRUCTION.
- 8. REFER TO OWNER'S FUNCTIONAL SPECIFICATIONS FOR FURTHER INFORMATION AND REQUIREMENTS.

#### KEYED POWER/AUX. PLAN NOTES:

- PROVIDE NEW DATA OR PHONE JACK(S) AS INDICATED. ALL WIRING TO BE NEW. WIRE BACK TO TECHNOLOGY RACK IN ROOM 30. PROVIDE 5' OF EXTRA CABLE AT IDF RACK, CABLE TO BE TERMINATED IN RACK BY OWNER. PROVIDE ALL ACCESSORIES AND MODIFICATIONS REQUIRED, TYP.
- PROVIDE NEW POWER RECEPTACLE. WIRE WITH 3-#12, 3/4" CONDUIT TO NEAREST AVAILABLE CIRCUIT IN EXISTING POWER PANEL. PROVIDE SURFACE MOUNTED RACEWAY IN EXPOSED AREAS. EXISTING CONDUIT MAY BE REUSED WHEN SECURELY SUPPORTED PER NEC.
- 3. PROVIDE NEW DUAL CHANNEL SURFACE MOUNTED RACEWAY AT 42"
- 4. PROVIDE NEW TOILET ROOM EXHAUST FAN. CONNECT TO EXIST.
- CIRCUIT AND VENT DUCT. WIRE THROUGH NEW SWITCH IN ROOM. 5. PROVIDE NEW THROUGH-WALL EXHAUST FAN. WIRE TO NEW OR EXIST. FAN SWITCH AS INDICATED.
- 6. RE-INSTALL & CONNECT EXIST. I/T RACKS & PANELS IN NEW I/T
- 7. PROVIDE POWER & DATA CONNECTIONS TO FURNITURE SYSTEMS AS REQUIRED. WIRE DATA BACK TO TECHNOLOGY RACK IN ROOM 30. WIRE POWER WITH 3-#12, 3/4" CONDUIT TO NEAREST AVAILABLE CIRCUIT IN EXISTING POWER PANEL.
- 8. PROVIDE 120V TO STEP-DOWN TRANSFORMER FOR LOW-VOLTAGE ELECTRIC STRIKE. WIRE POWER WITH 3-#12, 3/4" CONDUIT TO

- NEAREST AVAILABLE CIRCUIT IN EXISTING POWER PANEL. 9. PROVIDE NEW CABLE TV JACK. VERIFY CABLING REQUIREMENTS WITH
- 10. PROVIDE NEW POWER RECEPTACLE IN EXIST. BACK-BOX. CONNECT TO EXIST. CIRCUIT & PROVIDE NEW WIRING AS REQUIRED.
- 11. PROVIDE CEILING MOUNTED POWER & DATA FOR CEILING MOUNTED PROJECTOR.
- 12. PROVIDE NEW A/V CHASE CONSISTING OF ONE SINGLE GANG RECESSED BOX AT 42" A.F.F. AND ONE SINGLE GANG RECESSED BOX AT 60" A.F.F. CONNECTED BY 1 1/2" CONDUIT IN WALL. RUN VGA CABLE BETWEEN BOXES AND TERMINATE WITH VGA TERMINALS &
- TRIM PLATES. 13. PROVIDE NEW EXHAUST FAN & VENT THROUGH ROOF. PROVIDE FLASHING BOOT FOR EXISTING ROOFING TO REMAIN & PATCH ROOFING AS REQ'D. WIRE 3-#12, 3/4" CONDUIT THROUGH SWITCH TO
- NEAREST AVAILABLE CIRCUIT IN EXISTING POWER PANEL. 14. EXTEND EXIST. BACK-BOXES FOR EXIST. RECEPTACLES AND DEVICES TO REMAIN IN THIS ROOM AS REQ'D TO ACCOMMODATE NEW WALL FURRING. PROVIDE NEW WIRING AS REQ'D.

⁄IECHAN	ICAL & ELECTRICAL SYMBOL LEDGEND:
ò	SINGLE POLE SWITCH
) ·E	EXISTING SWITCH TO BE REMOVED
`` ∙O.C.	EXISTING SWITCH TO REMAIN
3	SINGLE POLE SWITCH WITH OCCUPANCY SENSOR
) .4 )	THREE-WAY SWITCH
DIM	FOUR-WAY SWITCH
-	DIMMABLE SWITCH
<del>&gt;</del> ``	DUPLEX OUTLET TO BE DEMONSED
<b>∋</b> - ~	EXISTING OUTLET TO BE REMOVED
<b>}</b>	EXISTING OUTLET TO REMAIN  QUAD OUTLET
	DUPLEX OUTLET, GROUND FAULT INTERUPT
<del>}</del> GFI	DUPLEX OUTLET, WEATHER PROOF
→ W.P.	DUPLEX OUTLET ON DEDICATED CIRCUT
∋ <sub>s.c.</sub> ∋	DUPLEX OUTLET, FLOOR MOUNTED
<u>.</u>	DUPLEX OUTLET, CEILING MOUNTED
D 21	JUNCTION BOX
	JUNCTION BOX, FLOOR MOUNTED
	JUNCTION BOX, CEILING MOUNTED
<b>3</b>	SPECIALTY OUTLET
	SPECIALTY OUTLET, 220 VOLT
D <sub>220V</sub>	TELEPHONE JACK
2	DATA PORT (NUMBER INDICATES # OF JACKS & CABLES)
2	EXISTING TELEPHONE OR DATA PORT TO BE REMOVED
E	EXISTING TELEPHONE OR DATA PORT TO REMAIN
1	TELEPHONE JACK, FLOOR MOUNTED
<u> </u>	DATA PORT, FLOOR MOUNTED
<u>.                                    </u>	DATA PORT, CEILING MOUNTED
_	CABLE TV OUTLET
•	GAS APPLIANCE CONNECTION
GAS 1	CEILING MOUNTED SPEAKER
) ) )	CARBON MONOXIDE DETECTOR
9	CEILING MOUNTED OCCUPANCY SENSOR
) <sub>s</sub>	SMOKE DETECTOR
$\mathcal{O}_{S}$	WALL MOUNTED SMOKE DETECTOR
P.S.	FIRE ALARM PULL STATION
X	FIRE ALARM STROBE
^   <b>√</b> X	FIRE ALARM STROBE & HORN
<b>&gt;</b>	
<u> </u>	EXIT SIGN (ARROWS AS INDICATED)
42"A.F.F.	HEIGHT TO CENTER OF DEVICE OR BOX A.F.F.
NL. 00A	ELECTRICAL DISTRIBUTION PANEL
	LAY-IN FLUORESCENT LIGHT FIXTURE
	LAY-IN DIFFUSER FLUORESCENT LIGHT FIXTURE
	SURFACE MOUNTED FLUORESCENT LIGHT FIXTURE
	EMERGENCY LIGHT FIXTURE W/ BATTERY BACK-UP
ζ	SURFACE MOUNTED LIGHT FIXTURE
ğ	PULL CHAIN LIGHT FIXTURE
Z Z	SUSPENDED OR PENDANT MOUNTED LIGHT FIXTURE
)	RECESSED CAN LIGHT FIXTURE
Ð	MOISTURE-PROOF RECESSED CAN LIGHT FIXTURE
	RECESSED CAN LIGHT W/ DIRECTIONAL BAFFLE
$\supset$	WALL MOUNTED LIGHT FIXTURE
QQQ	OVER VANITY LIGHT FIXTURE
M	WALL MOUNTED EMERGENCY LIGHT FIXTURE
<u>)</u>	EXHAUST FAN
9	WALL MOUNTED EXHAUST FAN
<u>J</u>	EXHAUST FAN WITH LIGHT
$\sim$	GARBAGE DISPOSAL
•	CEILING MOUNTED PROJECTOR
T	HVAC CONTROL DEVICE
	CEILING MOUNTED HVAC SUPPLY AIR REGISTER
	CEILING MOUNTED LINEAR HVAC SUPPLY AIR REGISTER
	CEILING MOUNTED ROUND HVAC SUPPLY REGISTER
<u></u>	
	CEILING MOUNTED HVAC RETURN AIR REGISTER
F	FLOOR MOUNTED HVAC SUPPLY AIR REGISTER
<u></u> F	FLOOR MOUNTED HVAC RETURN AIR REGISTER
<u> </u>	
	DUCT MOUNTED HVAC SUPPLY AIR REGISTER
₩	SPRINKLER HEAD
$\boxtimes$	GAS OR WATER MAIN SHUT-OFF VALVE
	ELECTRICAL MAIN DISCONNECT SWITCH

ELECTRICAL MAIN DISCONNECT SWITCH

FROST-PROOF DOMESTIC WATER HOSE BIBB

DOMESTIC COLD WATER CONNECTION (SIZE AS NOTED)

— F.P. H.B.

# M2Ke design

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M2Ke Design LLC IN LIC#: PC81500014 **vosb** © M2Ke design 2015



## VALPARAISO UNIVERSITY POLICE DEPARTMENT

**NEW POLICE** STATION **RENOVATIONS** 

813 LAPORTE AVE., VALPARAISO, INDIANA

MARK DATE DESCRIPTION

1	10/26/15	75% CDs
2	11/12/15	95% CDs


## LOWER LEVEL POWER & **AUXILIARY PLAN**

SCALE: 3/16"=1'-0" CLIENT:

DATE: 10/07/15 PROJECT: 029001

DRAWN: DRH

FILE: 029001A-E100-EP0

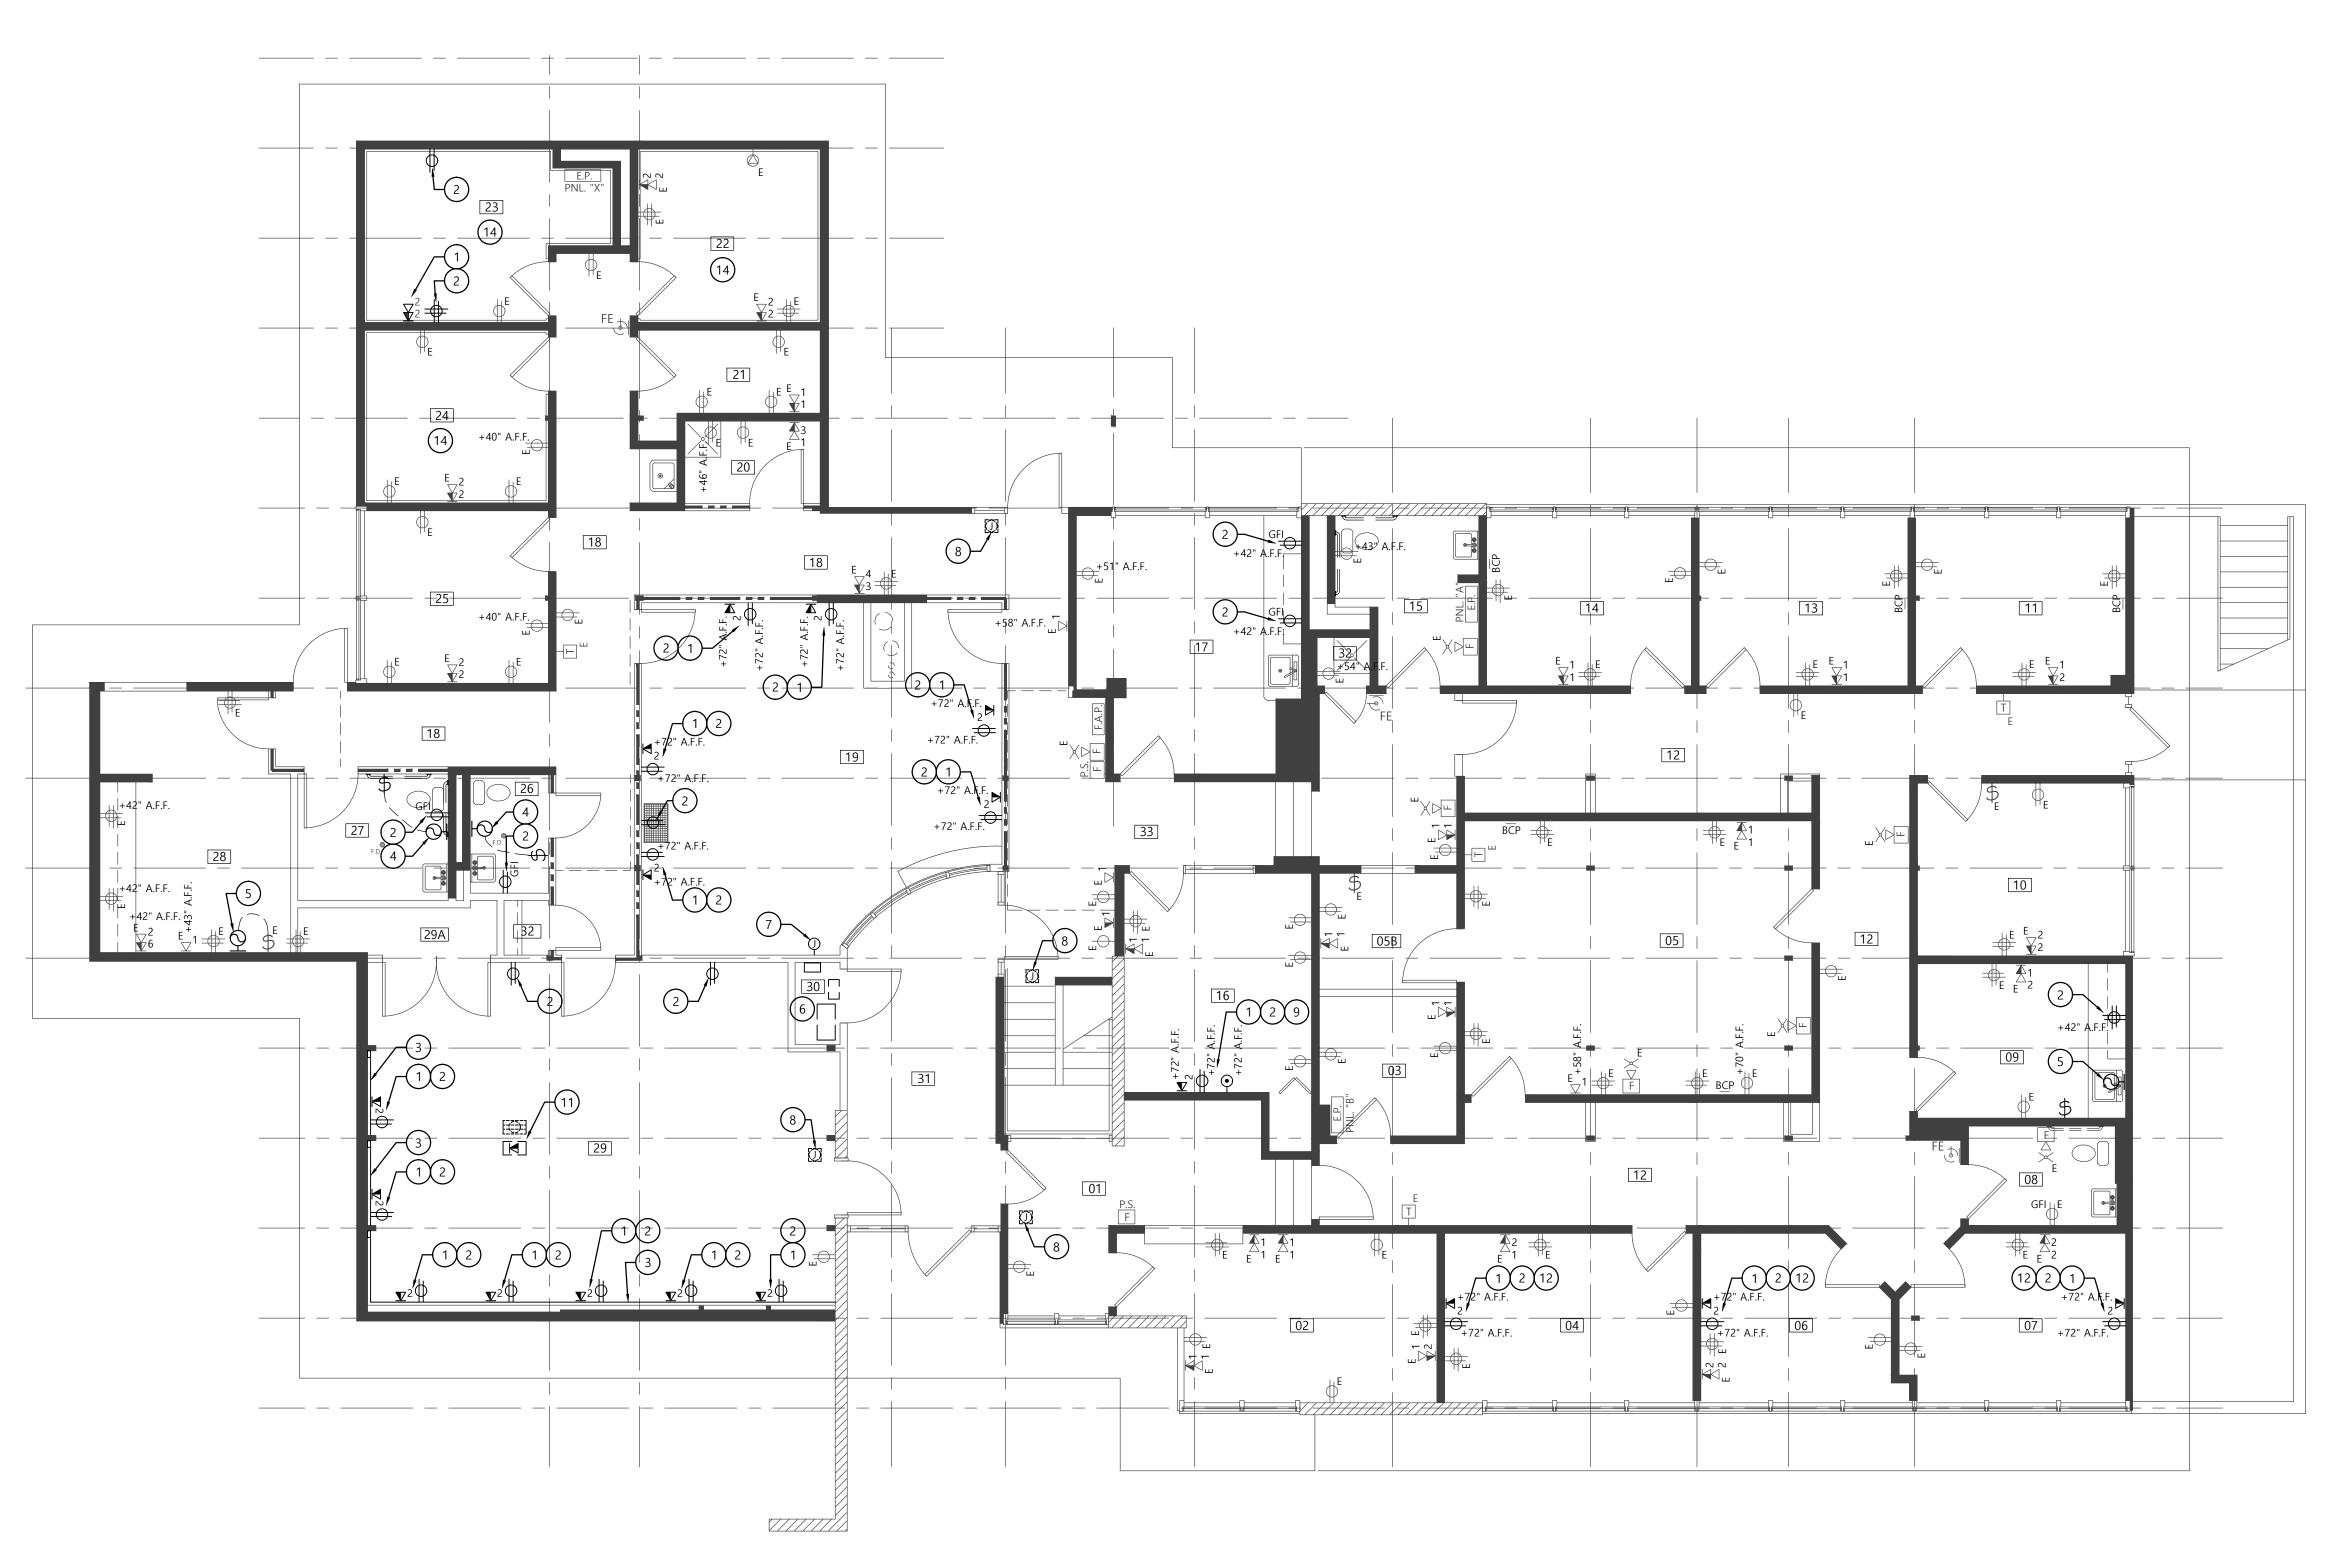

FIRST FLOOR POWER & AUXILIARY PLAN

Scale: 3/16"=1'-0"

#### GENERAL POWER/AUX. PLAN NOTES:

- 1. CONTRACTOR TO VERIFY CONDITION. LOCATION AND CAPACITY OF ALL EXISTING ELECTRICAL PANELS. FURNISH & INSTALL NEW FUSE BLOCKS OR BREAKERS IN EACH LOCATION THAT IS BEING TERMINATED TO WHERE EXISTING ARE UNSERVICEABLE. MATCH EXISTING TYPE & RATING.
- 2. ALL NEW CIRCUITS TO BE 20A UNLESS NOTED OTHERWISE. 3. WHERE EXIST. POWER RECEPTACLES AND DATA OR PHONE JACKS ARE INDICATED TO REMAIN, VERIFY CONTINUITY OR CONNECTIVITY OF EACH
- PLATES AS REQUIRED. 4. WHERE SHOWN IN THE SAME LOCATIONS, DATA & PHONE JACKS TO BE

DEVICE. REPLACE DAMAGED OR UNSERVICEABLE DEVICES AND COVER

- INSTALLED IN THE SAME SINGLE GANG BOX.
- 5. DATA AND PHONE WIRING TO BE INSTALLED ABOVE FINISHED CEILINGS UTILIZING J-HOOKS OR CABLE TRAY. CABLING MAY NOT BE SUPPORTED BY FINISHED CEILING SYSTEMS. PROVIDE SURFACE MOUNTED RACEWAY IN EXPOSED AREAS.
- 6. NEW FIRE ALARM DEVICES TO BE CONNECTED TO EXIST. FIRE ALARM PANEL. COORDINATE WITH FIRE ALARM VENDOR FOR REQUIRED
- SHUT-DOWNS, TESTING AND OTHER FIRE ALARM WORK. 7. PROTECT EXISTING SMOKE DETECTORS AND FIRE ALARM DEVICES DURING CONSTRUCTION.
- 8. REFER TO OWNER'S FUNCTIONAL SPECIFICATIONS FOR FURTHER INFORMATION AND REQUIREMENTS.

#### KEYED POWER/AUX. PLAN NOTES:

- PROVIDE NEW DATA OR PHONE JACK(S) AS INDICATED. ALL WIRING TO BE NEW. WIRE BACK TO TECHNOLOGY RACK IN ROOM 30. PROVIDE 5' OF EXTRA CABLE AT IDF RACK, CABLE TO BE TERMINATED IN RACK BY OWNER. PROVIDE ALL ACCESSORIES AND MODIFICATIONS REQUIRED, TYP.
- PROVIDE NEW POWER RECEPTACLE. WIRE WITH 3-#12, 3/4" CONDUIT TO NEAREST AVAILABLE CIRCUIT IN EXISTING POWER PANEL. PROVIDE SURFACE MOUNTED RACEWAY IN EXPOSED AREAS. EXISTING CONDUIT MAY BE REUSED WHEN SECURELY SUPPORTED PER NEC.
- 3. PROVIDE NEW DUAL CHANNEL SURFACE MOUNTED RACEWAY AT 42"
- 4. PROVIDE NEW TOILET ROOM EXHAUST FAN. CONNECT TO EXIST. CIRCUIT AND VENT DUCT. WIRE THROUGH NEW SWITCH IN ROOM.
- 5. PROVIDE NEW THROUGH-WALL EXHAUST FAN. WIRE TO NEW OR EXIST. FAN SWITCH AS INDICATED. 6. RE-INSTALL & CONNECT EXIST. I/T RACKS & PANELS IN NEW I/T
- 7. PROVIDE POWER & DATA CONNECTIONS TO FURNITURE SYSTEMS AS REQUIRED. WIRE DATA BACK TO TECHNOLOGY RACK IN ROOM 30. WIRE POWER WITH 3-#12, 3/4" CONDUIT TO NEAREST AVAILABLE CIRCUIT IN EXISTING POWER PANEL.
- 8. PROVIDE 120V TO STEP-DOWN TRANSFORMER FOR LOW-VOLTAGE ELECTRIC STRIKE. WIRE POWER WITH 3-#12, 3/4" CONDUIT TO

- NEAREST AVAILABLE CIRCUIT IN EXISTING POWER PANEL. PROVIDE NEW CABLE TV JACK, VERIFY CABLING REQUIREMENTS WITH
- 10. PROVIDE NEW POWER RECEPTACLE IN EXIST. BACK-BOX. CONNECT TO EXIST. CIRCUIT & PROVIDE NEW WIRING AS REQUIRED.
- 11. PROVIDE CEILING MOUNTED POWER & DATA FOR CEILING MOUNTED PROJECTOR.
- 12. PROVIDE NEW A/V CHASE CONSISTING OF ONE SINGLE GANG RECESSED BOX AT 42" A.F.F. AND ONE SINGLE GANG RECESSED BOX AT 60" A.F.F. CONNECTED BY 1 1/2" CONDUIT IN WALL. RUN VGA CABLE BETWEEN BOXES AND TERMINATE WITH VGA TERMINALS &
- TRIM PLATES. 13. PROVIDE NEW EXHAUST FAN & VENT THROUGH ROOF. PROVIDE FLASHING BOOT FOR EXISTING ROOFING TO REMAIN & PATCH ROOFING AS REQ'D. WIRE 3-#12, 3/4" CONDUIT THROUGH SWITCH TO NEAREST AVAILABLE CIRCUIT IN EXISTING POWER PANEL.
- 14. EXTEND EXIST. BACK-BOXES FOR EXIST. RECEPTACLES AND DEVICES TO REMAIN IN THIS ROOM AS REQ'D TO ACCOMMODATE NEW WALL FURRING. PROVIDE NEW WIRING AS REO'D.

MECHANICAL & ELECTRICAL SYMBOL LEDGEND: SINGLE POLE SWITCH EXISTING SWITCH TO BE REMOVED EXISTING SWITCH TO REMAIN SINGLE POLE SWITCH WITH OCCUPANCY SENSOR THREE-WAY SWITCH FOUR-WAY SWITCH DIMMABLE SWITCH  $\Rightarrow$ **DUPLEX OUTLET** EXISTING OUTLET TO BE REMOVED EXISTING OUTLET TO REMAIN QUAD OUTLET DUPLEX OUTLET, GROUND FAULT INTERUPT  $\rightarrow$ GF ₩.P. DUPLEX OUTLET, WEATHER PROOF **DUPLEX OUTLET ON DEDICATED CIRCUT** 

<del>- 0</del> DUPLEX OUTLET, FLOOR MOUNTED DUPLEX OUTLET, CEILING MOUNTED -() JUNCTION BOX  $\bigcirc$ JUNCTION BOX, FLOOR MOUNTED

 $\mathbb{O}$ JUNCTION BOX, CEILING MOUNTED  $- \bigcirc$ SPECIALTY OUTLET SPECIALTY OUTLET, 220 VOLT **-**∅<sub>220\</sub> TELEPHONE JACK

EXISTING TELEPHONE OR DATA PORT TO BE REMOVED EXISTING TELEPHONE OR DATA PORT TO REMAIN  $\bowtie_{\mathsf{E}}$ M TELEPHONE JACK, FLOOR MOUNTED

GAS APPLIANCE CONNECTION

DATA PORT (NUMBER INDICATES # OF JACKS & CABLES

 $\blacksquare$ DATA PORT, FLOOR MOUNTED  $[\!\![ \!\! A ]\!\!]$ DATA PORT, CEILING MOUNTED CABLE TV OUTLET

S CEILING MOUNTED SPEAKER (C) CARBON MONOXIDE DETECTOR <u></u> CEILING MOUNTED OCCUPANCY SENSOR  $\mathbb{F}_{\varsigma}$ SMOKE DETECTOR

HP<sub>S</sub> WALL MOUNTED SMOKE DETECTOR P.S. FIRE ALARM PULL STATION FX FIRE ALARM STROBE

F₫X

EXIT EXIT SIGN (ARROWS AS INDICATED) HEIGHT TO CENTER OF DEVICE OR BOX A.F.F. +42"A.F.F

FIRE ALARM STROBE & HORN

PNL. 200A **ELECTRICAL DISTRIBUTION PANEL** 

LAY-IN FLUORESCENT LIGHT FIXTURE LAY-IN DIFFUSER FLUORESCENT LIGHT FIXTURE SURFACE MOUNTED FLUORESCENT LIGHT FIXTURE EMERGENCY LIGHT FIXTURE W/ BATTERY BACK-UP SURFACE MOUNTED LIGHT FIXTURE

Ø PULL CHAIN LIGHT FIXTURE  $\mathfrak{D}$ SUSPENDED OR PENDANT MOUNTED LIGHT FIXTURE  $\circ$ RECESSED CAN LIGHT FIXTURE

MP MOISTURE-PROOF RECESSED CAN LIGHT FIXTURE RECESSED CAN LIGHT W/ DIRECTIONAL BAFFLE Ю WALL MOUNTED LIGHT FIXTURE

QQQQ OVER VANITY LIGHT FIXTURE WALL MOUNTED EMERGENCY LIGHT FIXTURE

D EM □ 0 EXHAUST FAN Ю WALL MOUNTED EXHAUST FAN EXHAUST FAN WITH LIGHT  $\sim$ GARBAGE DISPOSAL

CEILING MOUNTED PROJECTOR -T HVAC CONTROL DEVICE

CEILING MOUNTED HVAC SUPPLY AIR REGISTER

CEILING MOUNTED LINEAR HVAC SUPPLY AIR REGISTER CEILING MOUNTED ROUND HVAC SUPPLY REGISTER CEILING MOUNTED HVAC RETURN AIR REGISTER

FLOOR MOUNTED HVAC SUPPLY AIR REGISTER FLOOR MOUNTED HVAC RETURN AIR REGISTER

DUCT MOUNTED HVAC SUPPLY AIR REGISTER

 $\bigoplus$ SPRINKLER HEAD

GAS OR WATER MAIN SHUT-OFF VALVE ELECTRICAL MAIN DISCONNECT SWITCH

FROST-PROOF DOMESTIC WATER HOSE BIBB

DOMESTIC COLD WATER CONNECTION (SIZE AS NOTED)

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M2Ke design

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Hobart, Indiana, 46342-5233

M2Ke Design LLC IN LIC#: PC81500014 © M2Ke design 2015



## VALPARAISO **UNIVERSITY POLICE** DEPARTMENT

## NEW POLICE STATION **RENOVATIONS**

813 LAPORTE AVE., VALPARAISO, INDIANA

	MARK	DATE	DESCRIPTION
	1	10/26/15	75% CDs
	2	11/12/15	95% CDs
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### **FIRST** FLOOR POWER & **AUXILIARY PLAN**

SCALE: 3/16"=1'-0" CLIENT:

029001

DRAWN: DRH

DATE: 10/07/15 PROJECT:

FILE: 029001A-E110-EP01