

- 1. DIMENSIONS TO BE USED IN PREFERENCE TO SCALING.
- 2. ALL LEVELS & DIMENSIONS TO BE CHECKED PRIOR TO WORK BEING PUT IN HAND. DISCREPANCIES TO BE REPORTED TO THE ARCHITECT.
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### DRAINAGE RETICULATION

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# FIRE RETICULATION

1. ALL BUILDING TO BE IN ACCORDANCE WITH PART "T" OF THE NATIONAL BUILDING REGULATIONS FOR THE RELEVANT CLASS OF OCCUPANCY.

**OWNER'S** 

**ENGINEER'S** 

**REVISIONS** 

No DATE DESCRIPTION



THE CRAYFISH INN CLIENT

CRAYFISH INN RESTAURANT

ADDITION AND ALTERATION STAND 2105 RAMSGATE

DRAWING


SCALE

SITE PLAN & ROOF PLAN

S RAUBENHEIMER S RAUBENHEIMER 04/12/2016

PROJECT NO: DWG NO: REV: 1601

As indicated

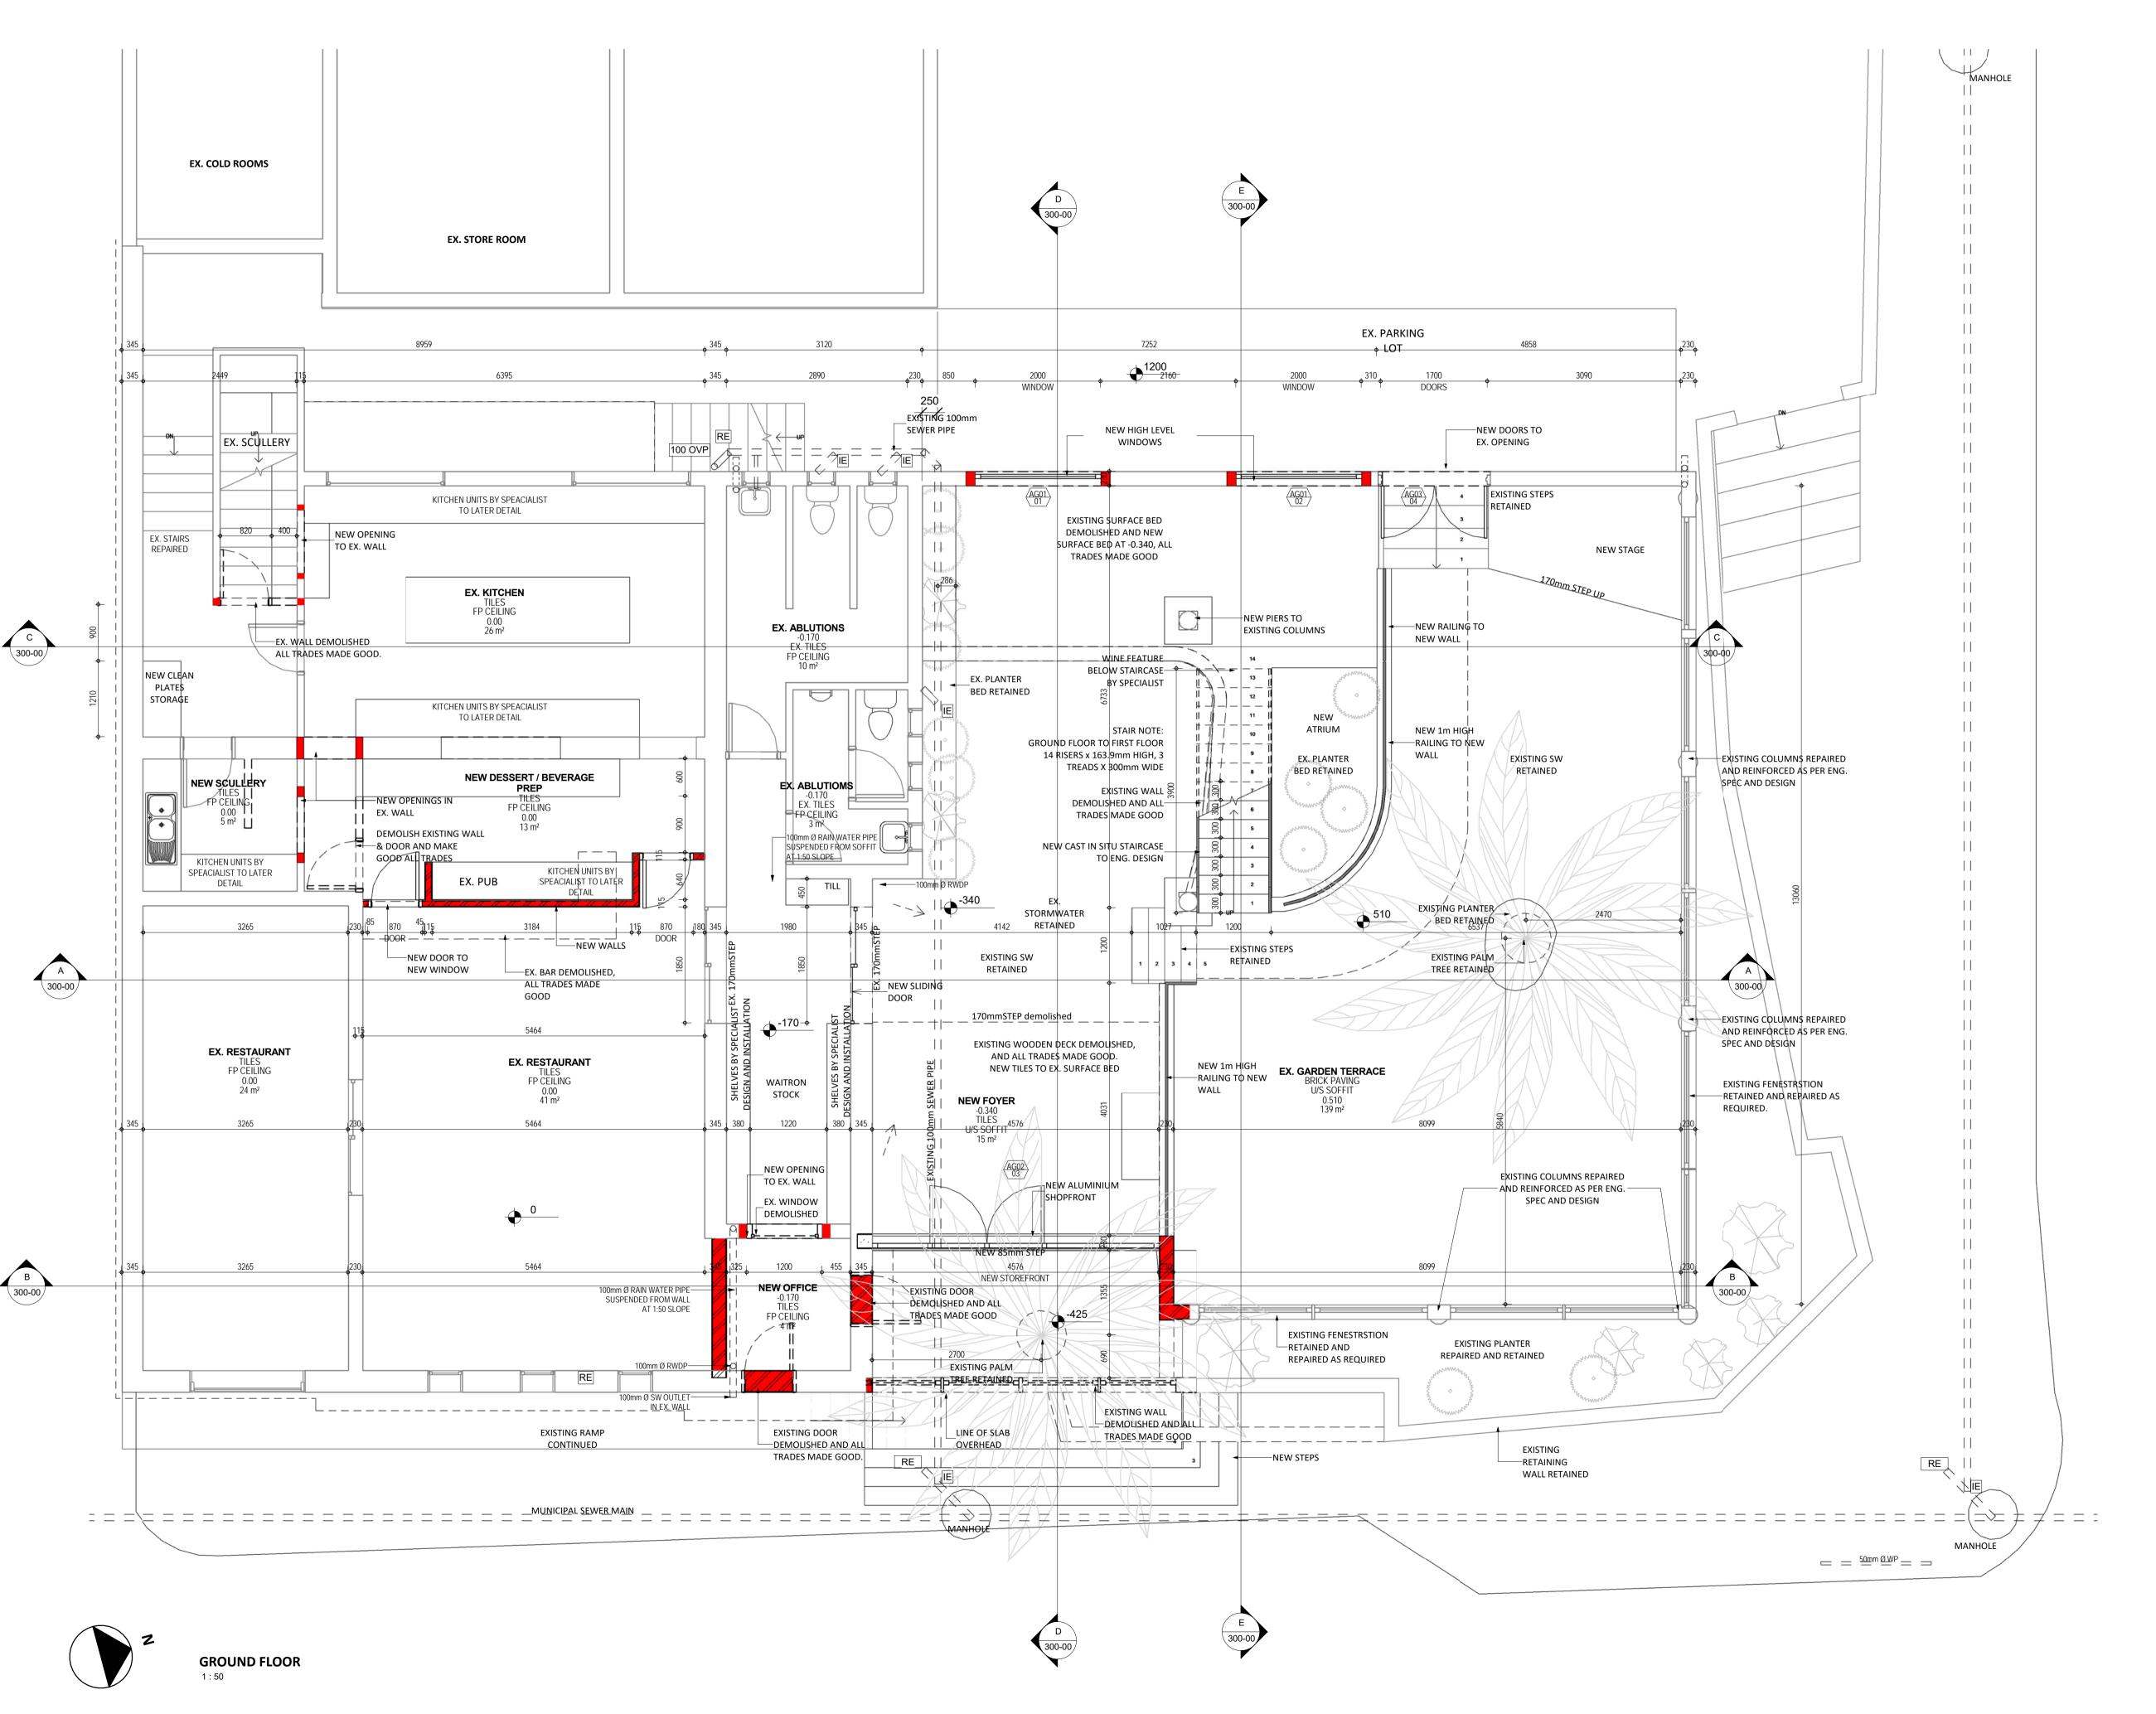

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**ENGINEER'S** 

**REVISIONS** 

No DATE DESCRIPTION



THE CRAYFISH INN CLIENT

CRAYFISH INN RESTAURANT

ADDITION AND ALTERATION STAND NO STAND 2105 RAMSGATE

DRAWING GROUND FLOOR PLAN


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S RAUBENHEIMER S RAUBENHEIMER 04/12/2016 SCALE

DWG NO: REV: PROJECT NO: 200-00

1601

As indicated

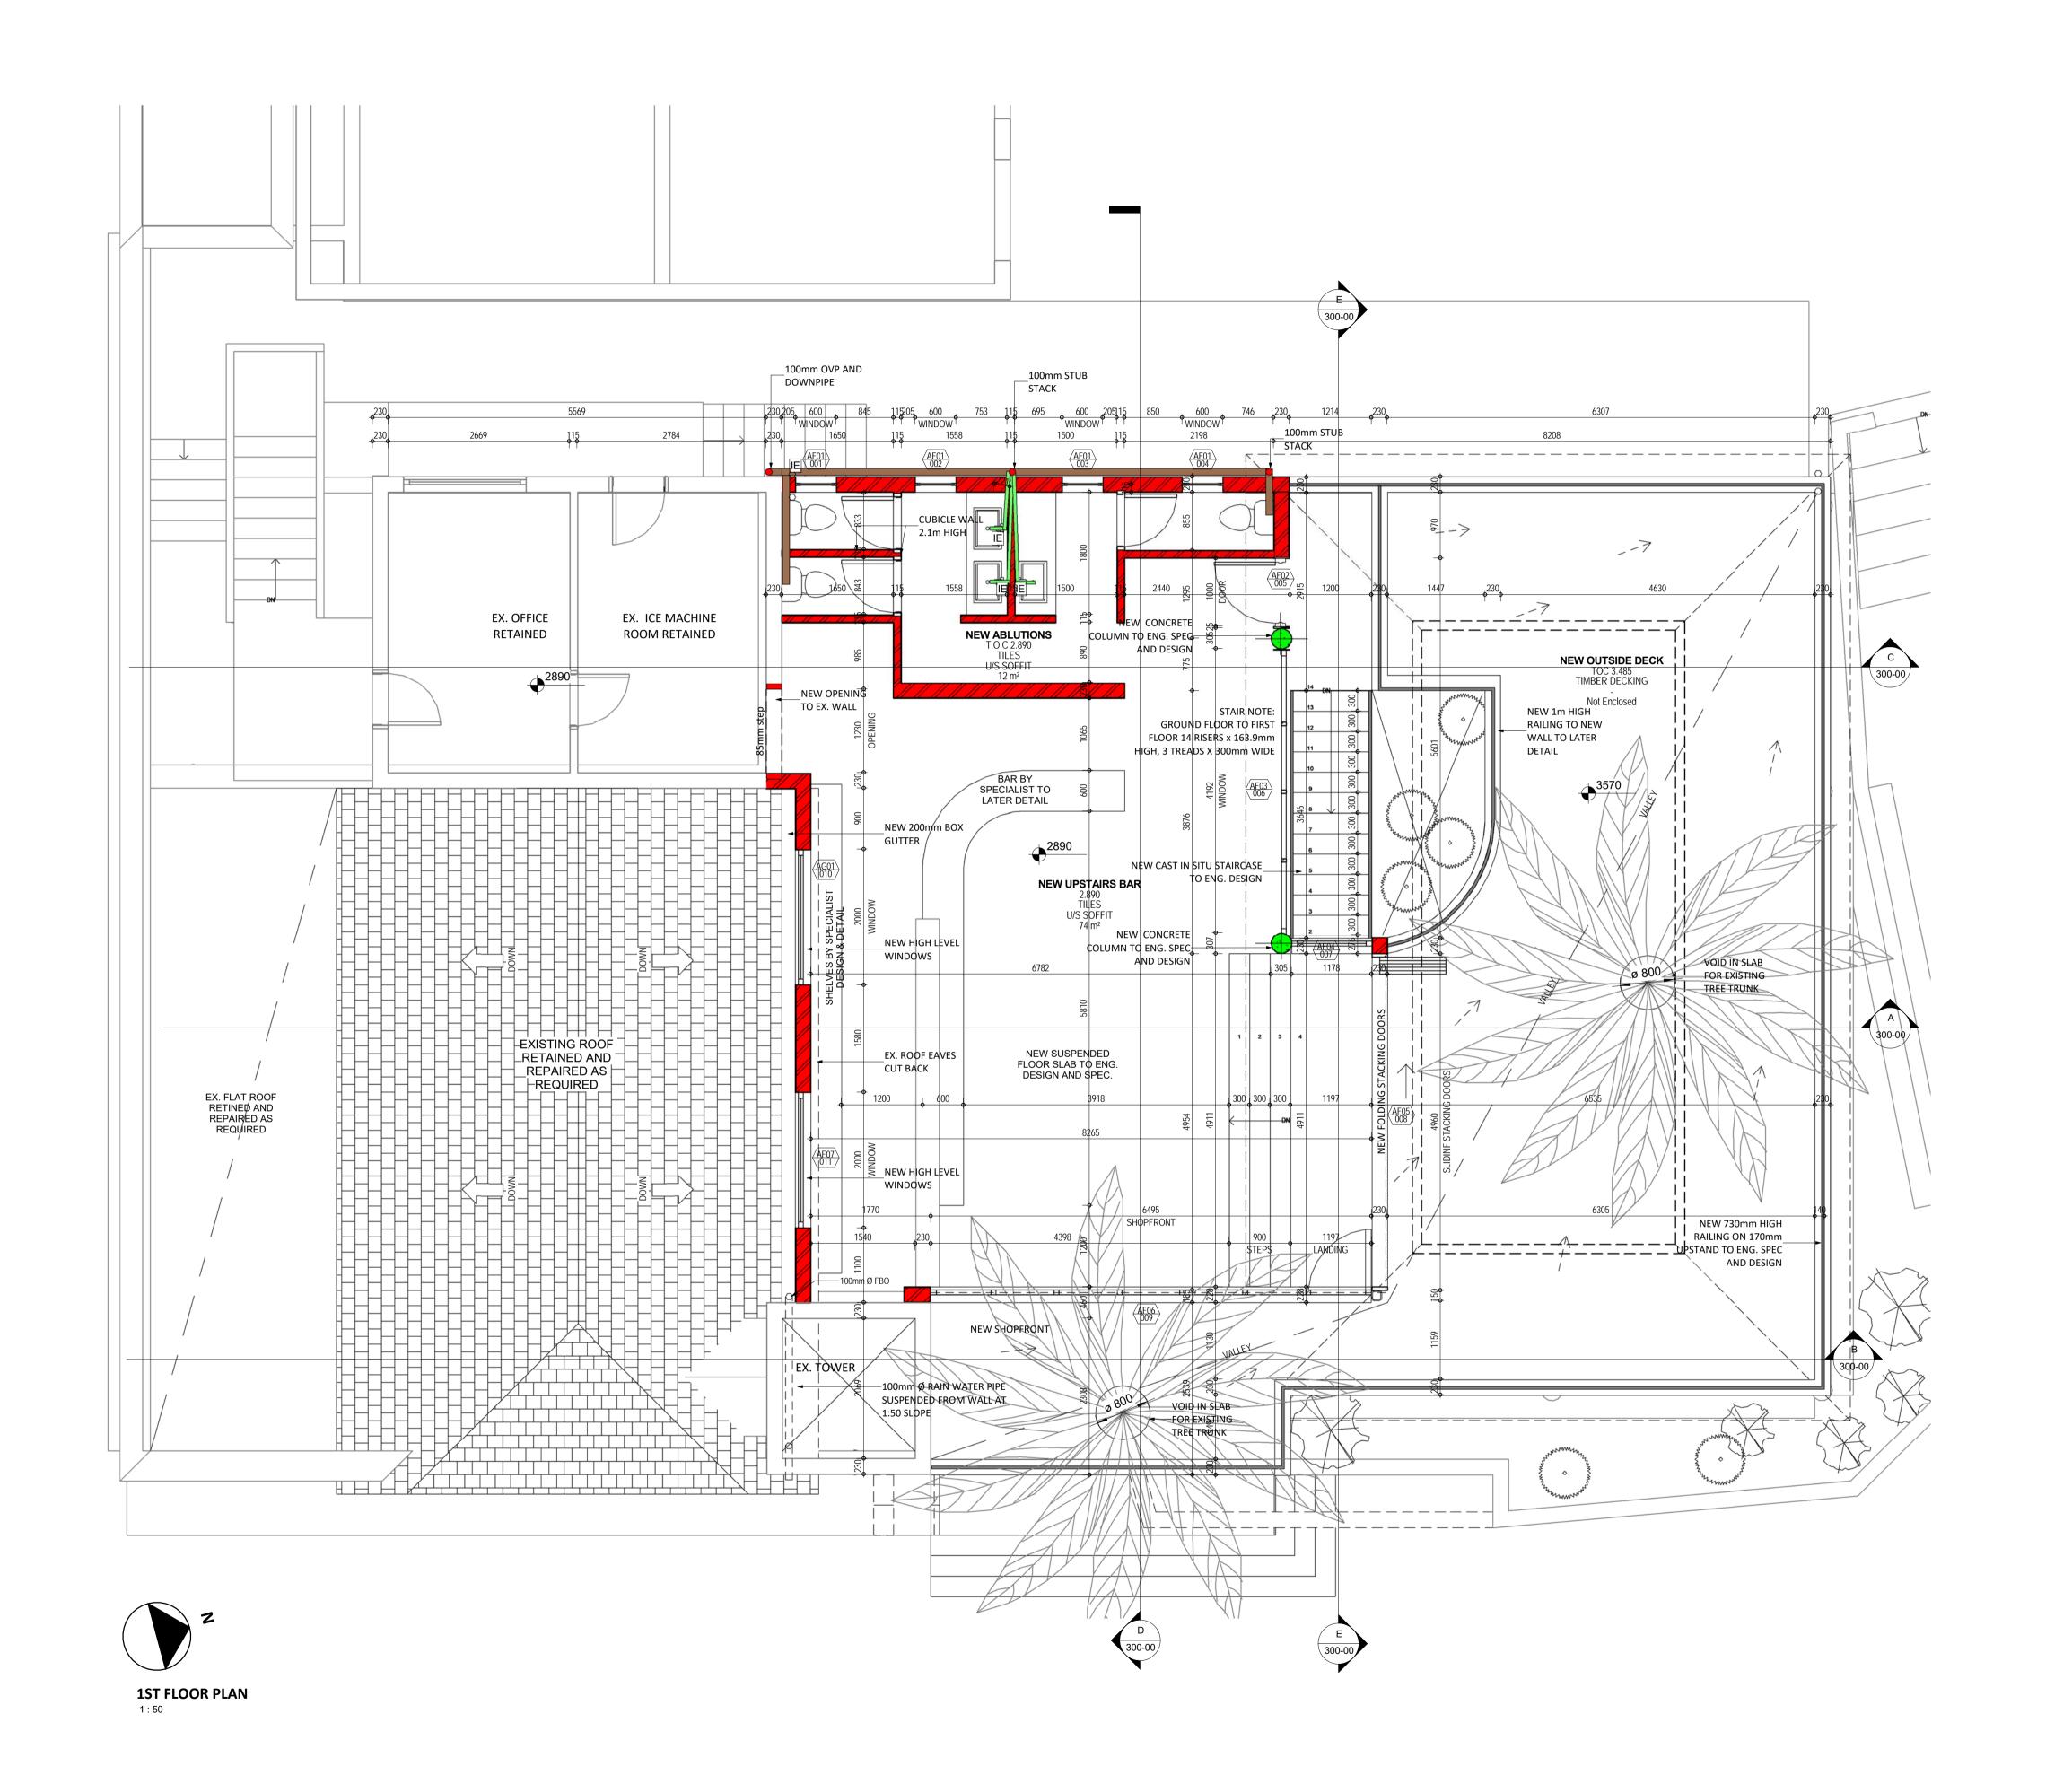

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# **OWNER'S**

**ENGINEER'S** 

**REVISIONS** 

No DATE DESCRIPTION



THE CRAYFISH INN CLIENT

CRAYFISH INN RESTAURANT ADDITION AND ALTERATION

STAND 2105 RAMSGATE

DRAWING


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FIRST FLOOR PLAN

S RAUBENHEIMER S RAUBENHEIMER 04/12/2016 SCALE As indicated

DWG NO: REV: PROJECT NO: 201-00

1601

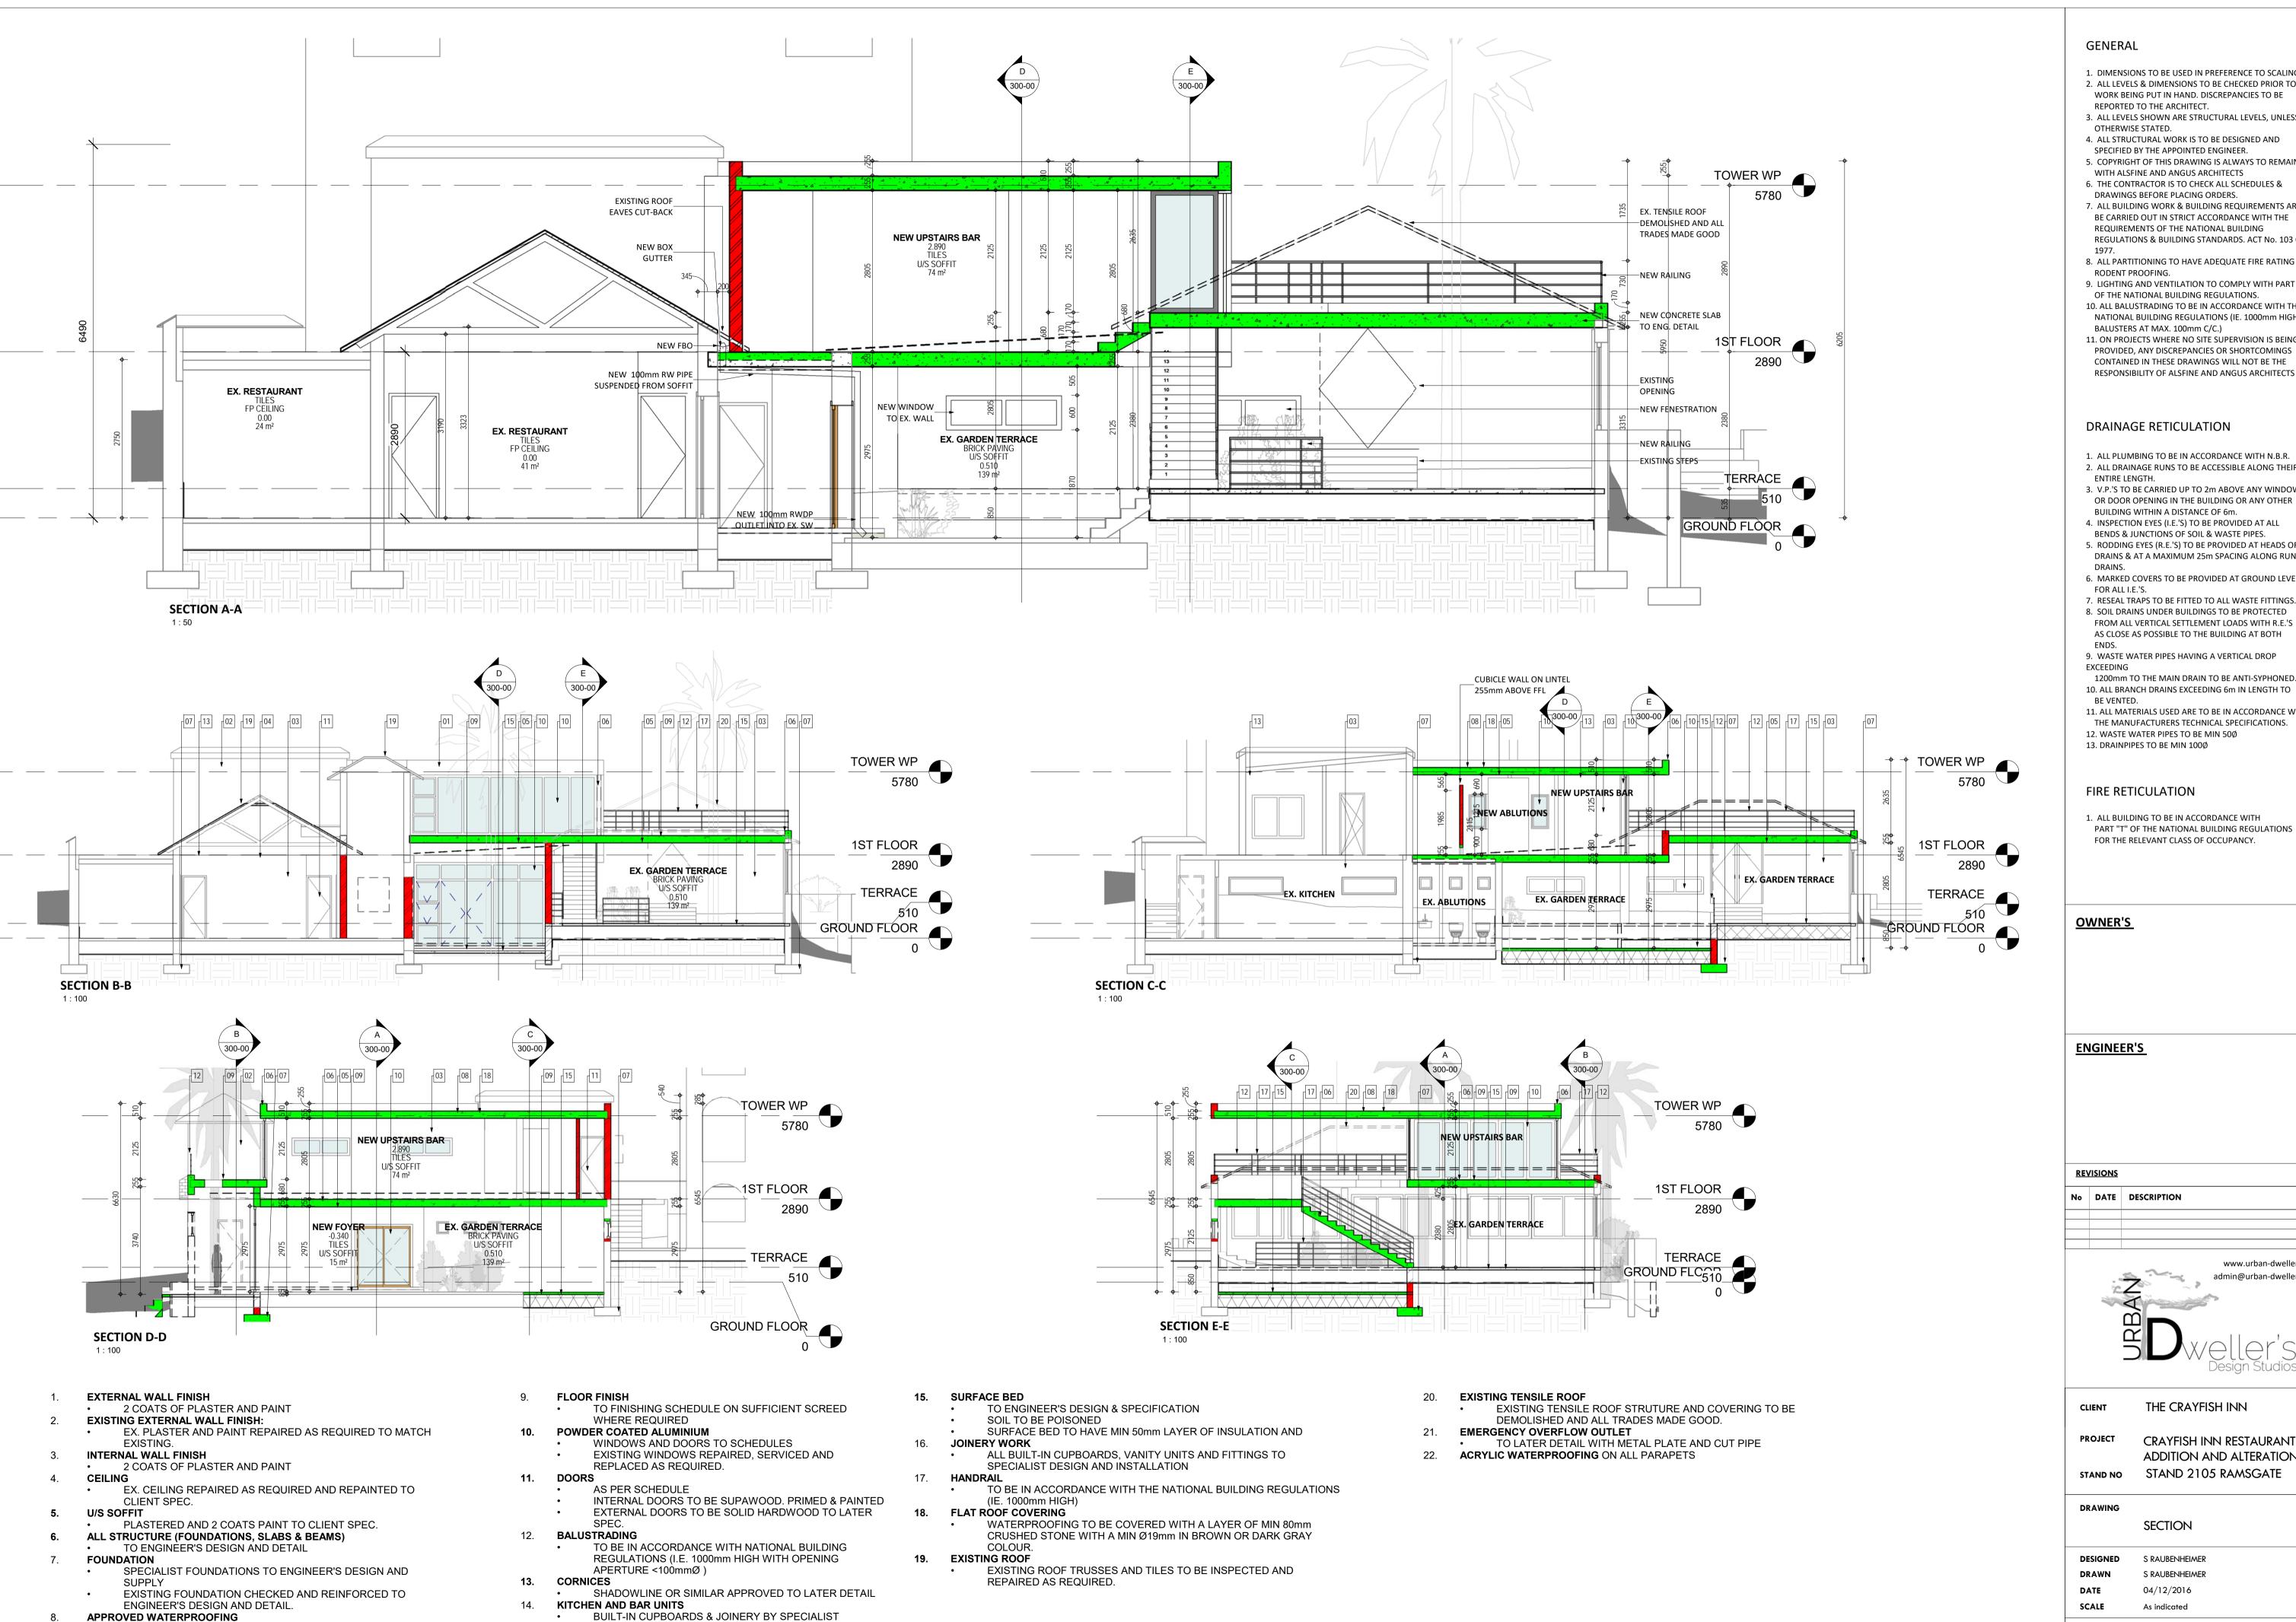

WITH NO BREAKS OR TEARS LAPPED AND SEALED TO BREEZE

GRADING @ MIN 1:100 FALL TO OVERFLOW

TO CARRY A 10YEAR MANUFACTURER'S GUARANTEE

**GENERAL** 

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OWNER'S

**ENGINEER'S** 

No DATE DESCRIPTION



THE CRAYFISH INN

CRAYFISH INN RESTAURANT ADDITION AND ALTERATION

STAND NO STAND 2105 RAMSGATE


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2017/05/28 13:07:53

SECTION

DESIGNED S RAUBENHEIMER S RAUBENHEIMER 04/12/2016 As indicated

DWG NO: REV: PROJECT NO: 300-00

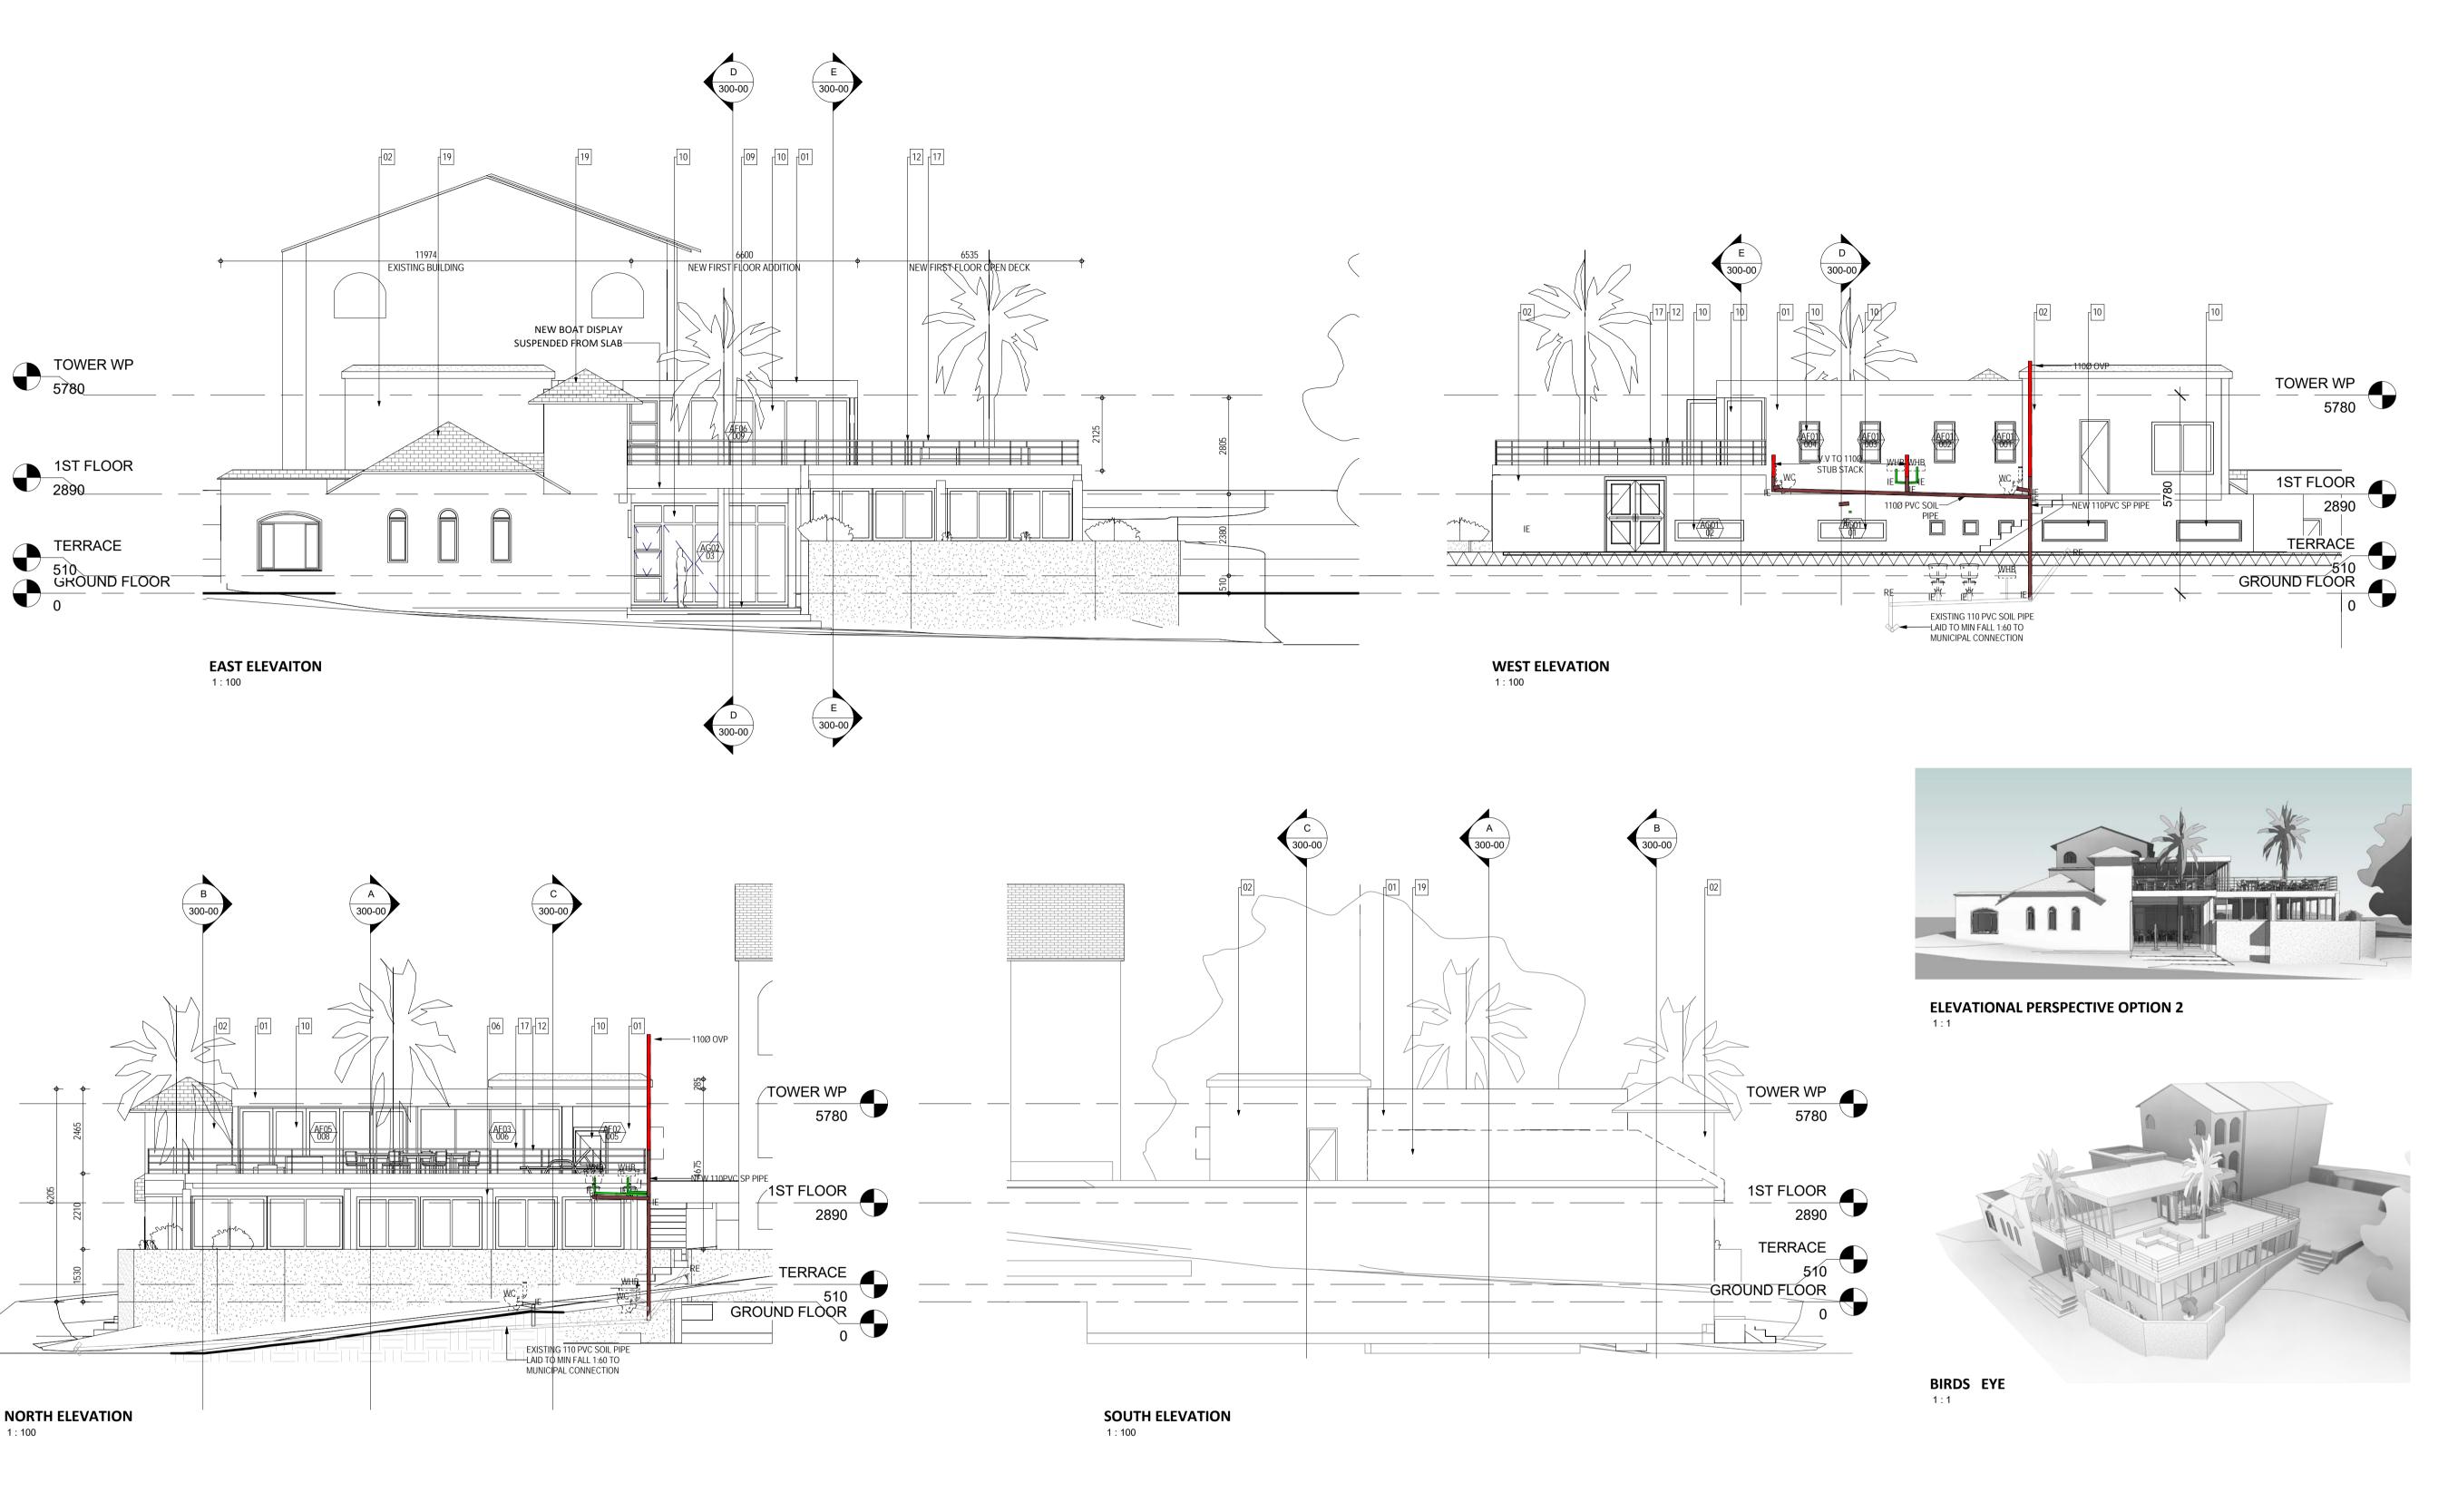

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OWNER'S

**ENGINEER'S** 

**REVISIONS** 

No DATE DESCRIPTION



THE CRAYFISH INN CLIENT

CRAYFISH INN RESTAURANT

ADDITION AND ALTERATION STAND NO STAND 2105 RAMSGATE

DRAWING

**ELEVATIONS** 

S RAUBENHEIMER DRAWN S RAUBENHEIMER 04/12/2016 DATE SCALE As indicated

PROJECT NO: DWG NO: REV:

REPAIRED AS REQUIRED.

**EXISTING TENSILE ROOF** 

EXISTING TENSILE ROOF STRUTURE AND COVERING TO BE DEMOLISHED AND ALL TRADES MADE GOOD.

EMERGENCY OVERFLOW OUTLET

 TO LATER DETAIL WITH METAL PLATE AND CUT PIPE 22. **ACRYLIC WATERPROOFING** ON ALL PARAPETS

EXTERNAL WALL FINISH 2 COATS OF PLASTER AND PAINT

**EXISTING EXTERNAL WALL FINISH:** EX. PLASTER AND PAINT REPAIRED AS REQUIRED TO MATCH EXISTING.

INTERNAL WALL FINISH 2 COATS OF PLASTER AND PAINT

CEILING EX. CEILING REPAIRED AS REQUIRED AND REPAINTED TO CLIENT SPEC.

U/S SOFFIT PLASTERED AND 2 COATS PAINT TO CLIENT SPEC. ALL STRUCTURE (FOUNDATIONS, SLABS & BEAMS) TO ENGINEER'S DESIGN AND DETAIL

SPECIALIST FOUNDATIONS TO ENGINEER'S DESIGN AND

EXISTING FOUNDATION CHECKED AND REINFORCED TO ENGINEER'S DESIGN AND DETAIL. APPROVED WATERPROOFING

WITH NO BREAKS OR TEARS LAPPED AND SEALED TO BREEZE GRADING @ MIN 1:100 FALL TO OVERFLOW TO CARRY A 10YEAR MANUFACTURER'S GUARANTEE

FLOOR FINISH

TO FINISHING SCHEDULE ON SUFFICIENT SCREED WHERE REQUIRED

WINDOWS AND DOORS TO SCHEDULES

EXISTING WINDOWS REPAIRED, SERVICED AND REPLACED AS REQUIRED.

POWDER COATED ALUMINIUM

11. DOORS INTERNAL DOORS TO BE SUPAWOOD. PRIMED & PAINTED

APERTURE <100mmØ)

EXTERNAL DOORS TO BE SOLID HARDWOOD TO LATER 12. **BALUSTRADING** TO BE IN ACCORDANCE WITH NATIONAL BUILDING REGULATIONS (I.E. 1000mm HIGH WITH OPENING

13. CORNICES SHADOWLINE OR SIMILAR APPROVED TO LATER DETAIL

14. KITCHEN AND BAR UNITS BUILT-IN CUPBOARDS & JOINERY BY SPECIALIST 15. SURFACE BED TO ENGINEER'S DESIGN & SPECIFICATION

SOIL TO BE POISONED SURFACE BED TO HAVE MIN 50mm LAYER OF INSULATION AND

ALL BUILT-IN CUPBOARDS, VANITY UNITS AND FITTINGS TO SPECIALIST DESIGN AND INSTALLATION

TO BE IN ACCORDANCE WITH THE NATIONAL BUILDING REGULATIONS (IE. 1000mm HIGH) 18. FLAT ROOF COVERING

WATERPROOFING TO BE COVERED WITH A LAYER OF MIN 80mm


CRUSHED STONE WITH A MIN Ø19mm IN BROWN OR DARK GRAY COLOUR. 19. EXISTING ROOF EXISTING ROOF TRUSSES AND TILES TO BE INSPECTED AND

2017/05/28 13:07:57

1601

OOW SCHEDULE N	O. POSITION	NO. POSITION	NO. POSITION	
0	EX. GARDEN TERRACE EX. GARDEN TERRACE	03 NEW FOYER	01 EX. GARDEN TERRACE	
2.125mm  D. LINTOL  T.O.C. GROUND FLOOR 0.000mm	2000	4576	0001.7	
DOW TYPE ZING NTITY REQUIRED ME TYPE ME FINISH	AG01  AS PER SANS 204 CALCULATIONS. IN ACCORDANCE WITH SABS 0400 2 OFF 50mm PURPOSE MADE ALUMINIUM FRAME (2 TOP HUNG OUTWARD OPENING WINDOWS CHARCOAL POWDER COATED ALUMINIUM 'U' CHANNEL TO CLIENTS APPROVAL	AG02  AS PER SANS 204 CALCULATIONS. IN ACCORDANCE WITH SABS 0400  1 OFF  50mm PURPOSE MADE ALUMINIUM FRAME (2 TOP HUNG OUTWARD OPENING WINDOWS; DOUBLE INWARD OPENING DOOR)  CHARCOAL POWDER COATED ALUMINIUM 'U'  CHANNEL  TO CLIENTS APPROVAL	AG01  AS PER SANS 204 CALCULATIONS. IN ACCORDANCE WITH SABS 0400 2 OFF 50mm PURPOSE MADE ALUMINIUM FRAME (2 TOP HUNG OUTWARD OPENING WINDOWS CHARCOAL POWDER COATED ALUMINIUM 'U' CHANNEL TO CLIENTS APPROVAL	

WINDOW SCHEDULE	NO. POSITION	NO. POSITION	NO. POSITION	NO. POSITION	NO. POSITION	NO.	POSITION
FIDOT OTODEV	001 NEW ABLUTIONS	005 NEW UPSTAIRS BAR	006 NEW UPSTAIRS BAR	007 NEW UPSTAIRS BAR	008 NEW UPSTAIRS BAR	009	NEW UPSTAIRS BAR
FIRST STOREY	002 NEW ABLUTIONS						
ALUMINIUM	003 NEW ABLUTIONS						
ALOWINIOW	004 NEW ABLUTIONS						
+5.015mm U.O. LINTOL  T.O.C. FIRST FLOOR  ±2.890mm	925 1200	1000		1178		4960	890
WINDOW TYPE	AF01	AF02	AF03	AF04		F05	AF06
GLAZING	AS PER SANS 204 CALCULATIONS. IN ACCORDANCE WITH SABS 0400	AS PER SANS 204 CALCULATIONS. IN ACCORDANCE WITH SABS 0400	AS PER SANS 204 CALCULATIONS. IN ACCORDANCE WITH SABS 0400	AS PER SANS 204 CALCULATIONS. IN ACCORDANCE WITH SABS 0400		4 CALCULATIONS. IN E WITH SABS 0400	AS PER SANS 204 CALCULATIONS. IN ACCORDANCE WITH SABS 0400
QUANTITY REQUIRE	ED 4 OFF	1 OFF	1 OFF	1 OFF		OFF	1 OFF
FRAME TYPE	50mm PURPOSE MADE ALUMINIUM FRAME (1 TOP HUNG OUTWARD OPENING WINDOW)	50mm PURPOSE MADE ALUMINIUM FRAME (SINGLE DOOR)	50mm PURPOSE MADE ALUMINIUM FRAME (FIXED GLAZING)	50mm PURPOSE MADE ALUMINIUM FRAME (FIXED GLAZING)	50mm PURPOSE MAD (SLIDING STAC		50mm PURPOSE MADE ALUMINIUM FRAME (2 TOP HUNG OUTWARD OPENING WINDOWS; 1 SINGLE DOOR)
FRAME FINISH	CHARCOAL POWDER COATED ALUMINIUM 'U' CHANNEL	CHARCOAL POWDER COATED ALUMINIUM 'U' CHANNEL	CHARCOAL POWDER COATED ALUMINIUM 'U' CHANNEL	CHARCOAL POWDER COATED ALUMINIUM 'U' CHANNEL		R COATED ALUMINIUM 'U'	CHARCOAL POWDER COATED ALUMINIUM 'U' CHANNEL
IRONMONGERY	TO CLIENTS APPROVAL	TO CLIENTS APPROVAL	TO CLIENTS APPROVAL	TO CLIENTS APPROVAL	TO CLIEN	TS APPROVAL	TO CLIENTS APPROVAL

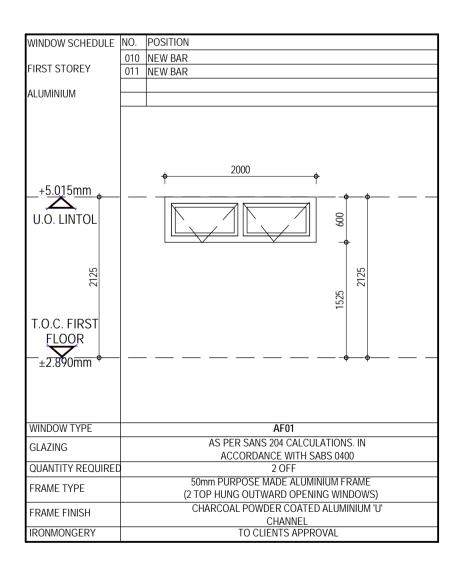

# WINDOW SCHEDULE

1:50

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- AS CLOSE AS POSSIBLE TO THE BUILDING AT BOTH 9. WASTE WATER PIPES HAVING A VERTICAL DROP
- 1200mm TO THE MAIN DRAIN TO BE ANTI-SYPHONED. 10. ALL BRANCH DRAINS EXCEEDING 6m IN LENGTH TO
- 11. ALL MATERIALS USED ARE TO BE IN ACCORDANCE WITH THE MANUFACTURERS TECHNICAL SPECIFICATIONS. 12. WASTE WATER PIPES TO BE MIN 50Ø

# FIRE RETICULATION

13. DRAINPIPES TO BE MIN 100Ø

1. ALL BUILDING TO BE IN ACCORDANCE WITH PART "T" OF THE NATIONAL BUILDING REGULATIONS FOR THE RELEVANT CLASS OF OCCUPANCY.

# **OWNER'S**

**ENGINEER'S** 

**REVISIONS** 

No DATE DESCRIPTION



THE CRAYFISH INN CLIENT

CRAYFISH INN RESTAURANT ADDITION AND ALTERATION

STAND 2105 RAMSGATE

DRAWING


ALUMINIUM SCHEDULE

S RAUBENHEIMER S RAUBENHEIMER DATE 04/12/16 SCALE As indicated

PROJECT NO: DWG NO: REV:

1601

2017/05/28 13:07:58

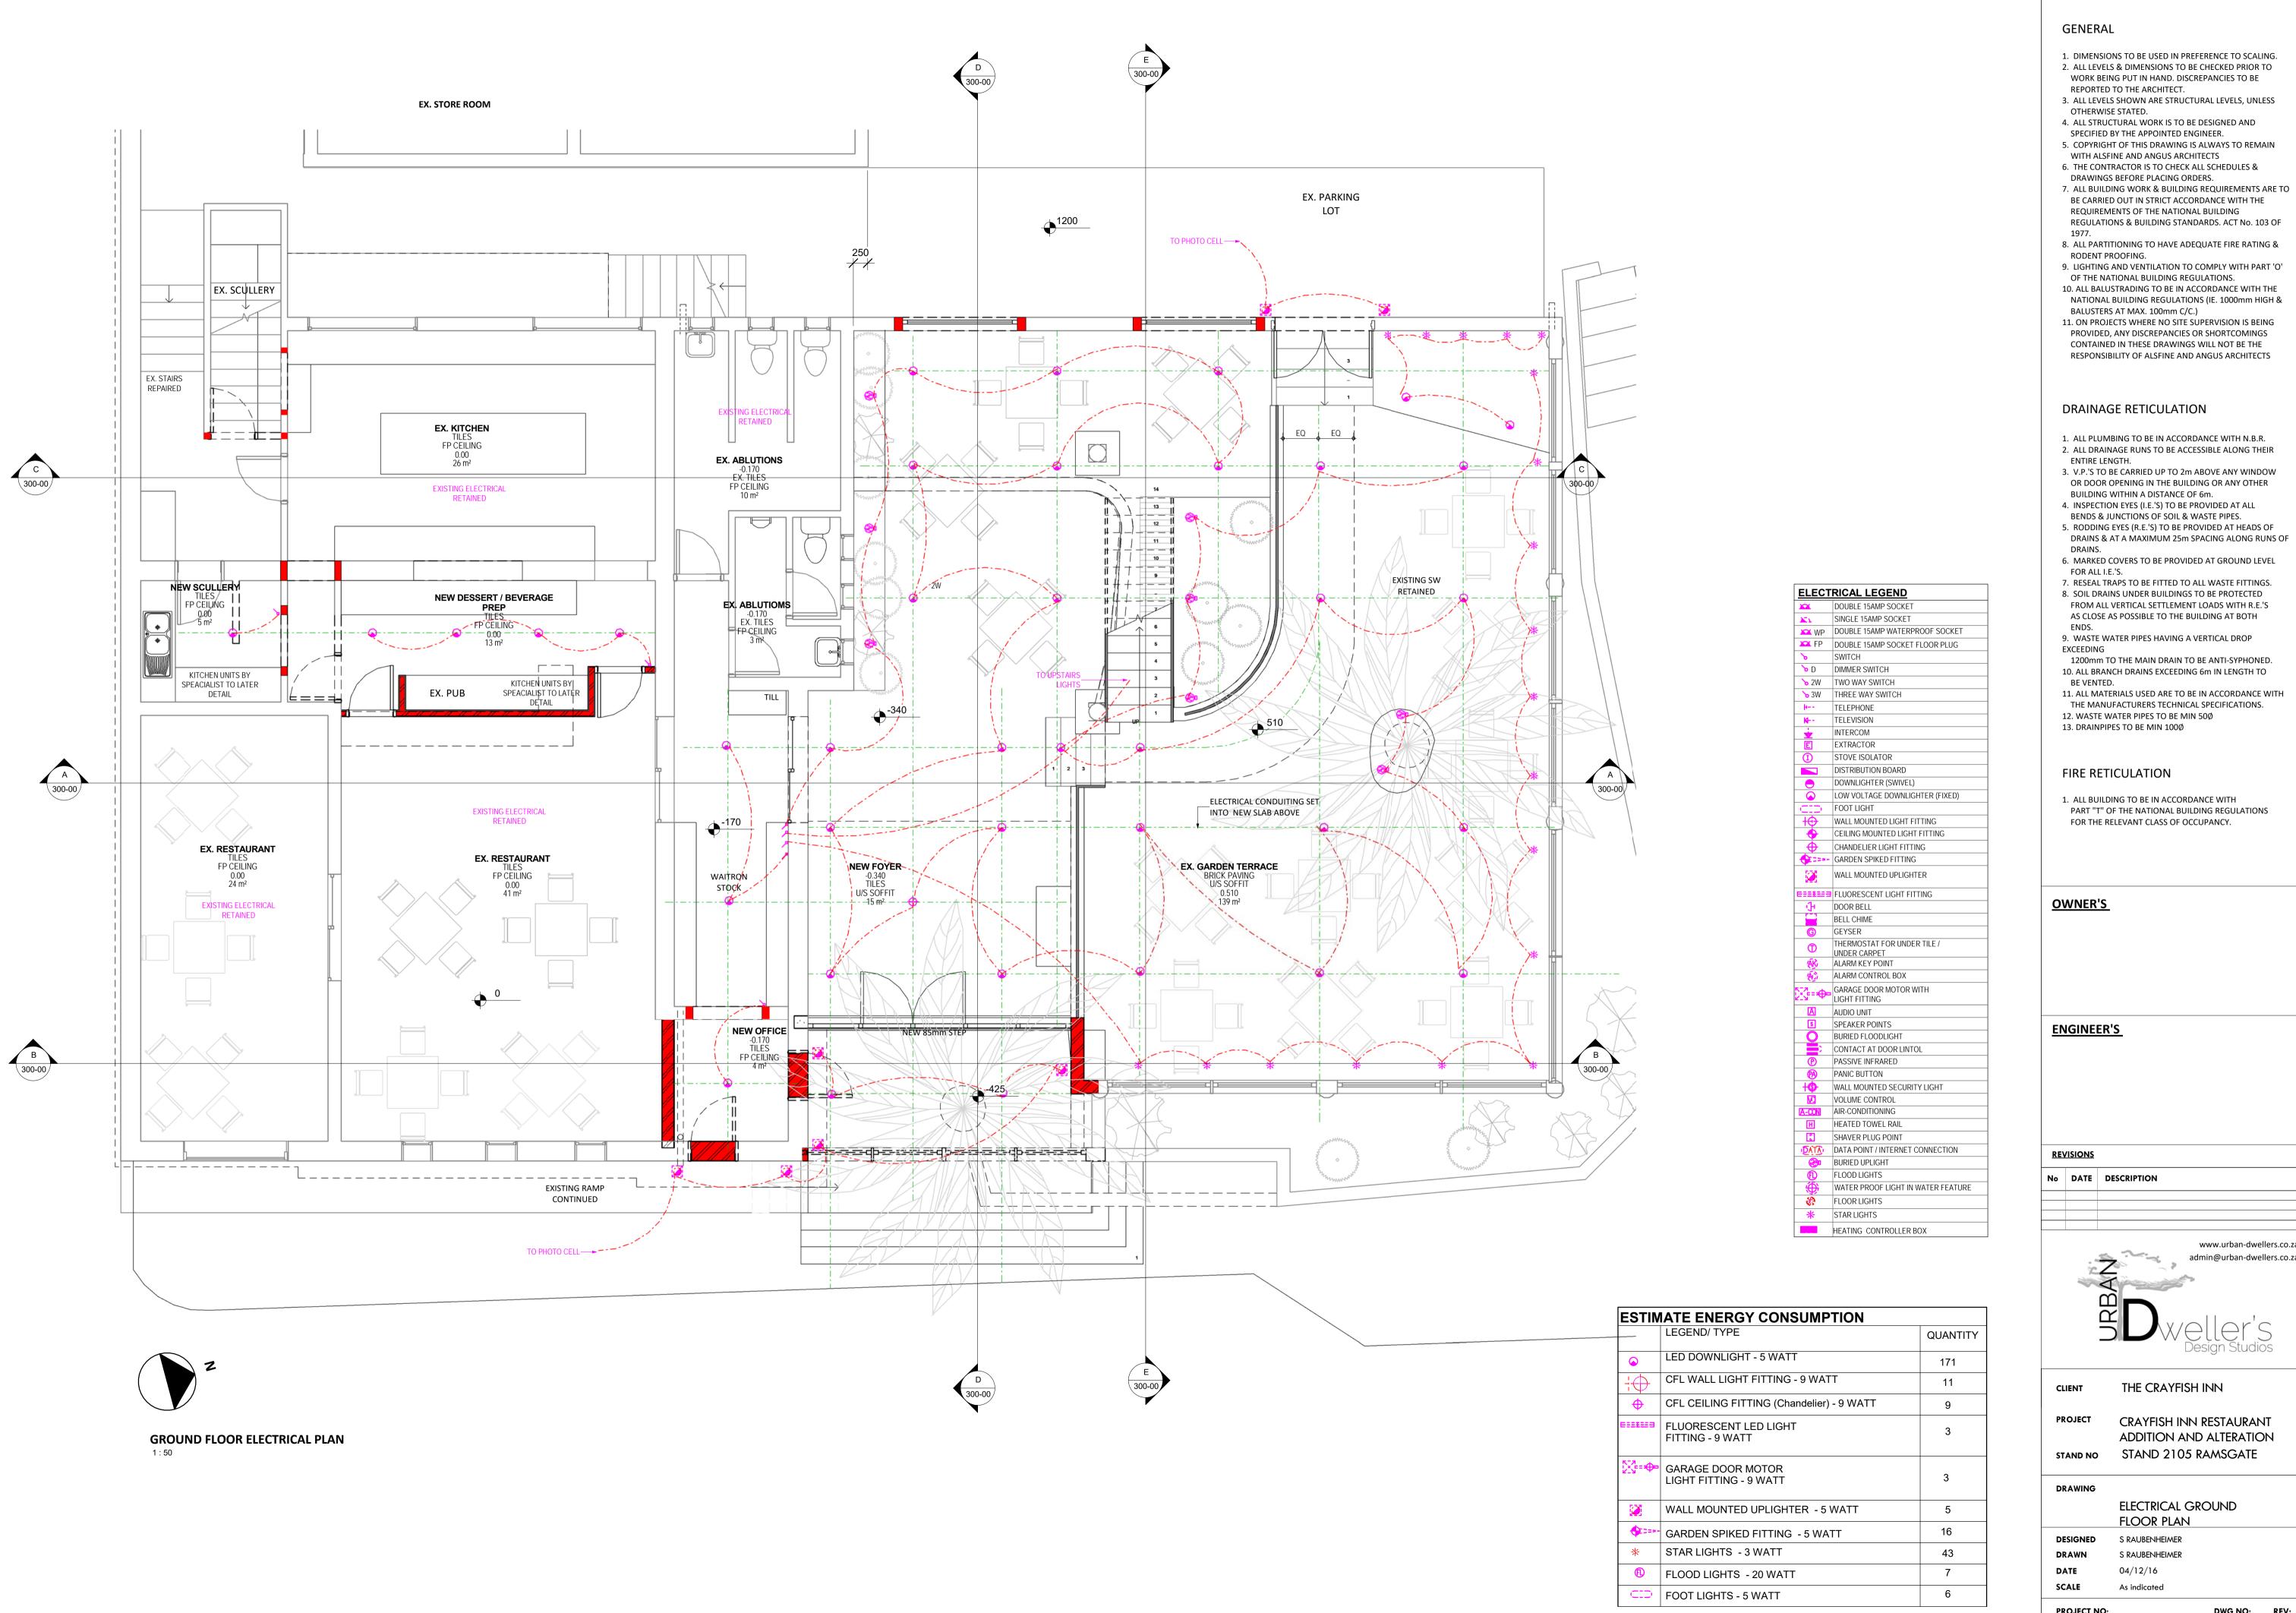

1. DIMENSIONS TO BE USED IN PREFERENCE TO SCALING.

WORK BEING PUT IN HAND. DISCREPANCIES TO BE

3. ALL LEVELS SHOWN ARE STRUCTURAL LEVELS, UNLESS

4. ALL STRUCTURAL WORK IS TO BE DESIGNED AND

SPECIFIED BY THE APPOINTED ENGINEER.

5. COPYRIGHT OF THIS DRAWING IS ALWAYS TO REMAIN

WITH ALSFINE AND ANGUS ARCHITECTS 6. THE CONTRACTOR IS TO CHECK ALL SCHEDULES &

BE CARRIED OUT IN STRICT ACCORDANCE WITH THE REQUIREMENTS OF THE NATIONAL BUILDING

8. ALL PARTITIONING TO HAVE ADEQUATE FIRE RATING &

9. LIGHTING AND VENTILATION TO COMPLY WITH PART 'O'

OF THE NATIONAL BUILDING REGULATIONS. 10. ALL BALUSTRADING TO BE IN ACCORDANCE WITH THE

NATIONAL BUILDING REGULATIONS (IE. 1000mm HIGH & 11. ON PROJECTS WHERE NO SITE SUPERVISION IS BEING

1. ALL PLUMBING TO BE IN ACCORDANCE WITH N.B.R.

OR DOOR OPENING IN THE BUILDING OR ANY OTHER

4. INSPECTION EYES (I.E.'S) TO BE PROVIDED AT ALL

5. RODDING EYES (R.E.'S) TO BE PROVIDED AT HEADS OF DRAINS & AT A MAXIMUM 25m SPACING ALONG RUNS OF

6. MARKED COVERS TO BE PROVIDED AT GROUND LEVEL

7. RESEAL TRAPS TO BE FITTED TO ALL WASTE FITTINGS. 8. SOIL DRAINS UNDER BUILDINGS TO BE PROTECTED

1200mm TO THE MAIN DRAIN TO BE ANTI-SYPHONED. 10. ALL BRANCH DRAINS EXCEEDING 6m IN LENGTH TO

11. ALL MATERIALS USED ARE TO BE IN ACCORDANCE WITH THE MANUFACTURERS TECHNICAL SPECIFICATIONS.

1. ALL BUILDING TO BE IN ACCORDANCE WITH PART "T" OF THE NATIONAL BUILDING REGULATIONS


admin@urban-dwellers.co.za

CRAYFISH INN RESTAURANT

STAND NO STAND 2105 RAMSGATE

DWG NO: REV: PROJECT NO: 700-00 1601

2017/05/28 13:08:03

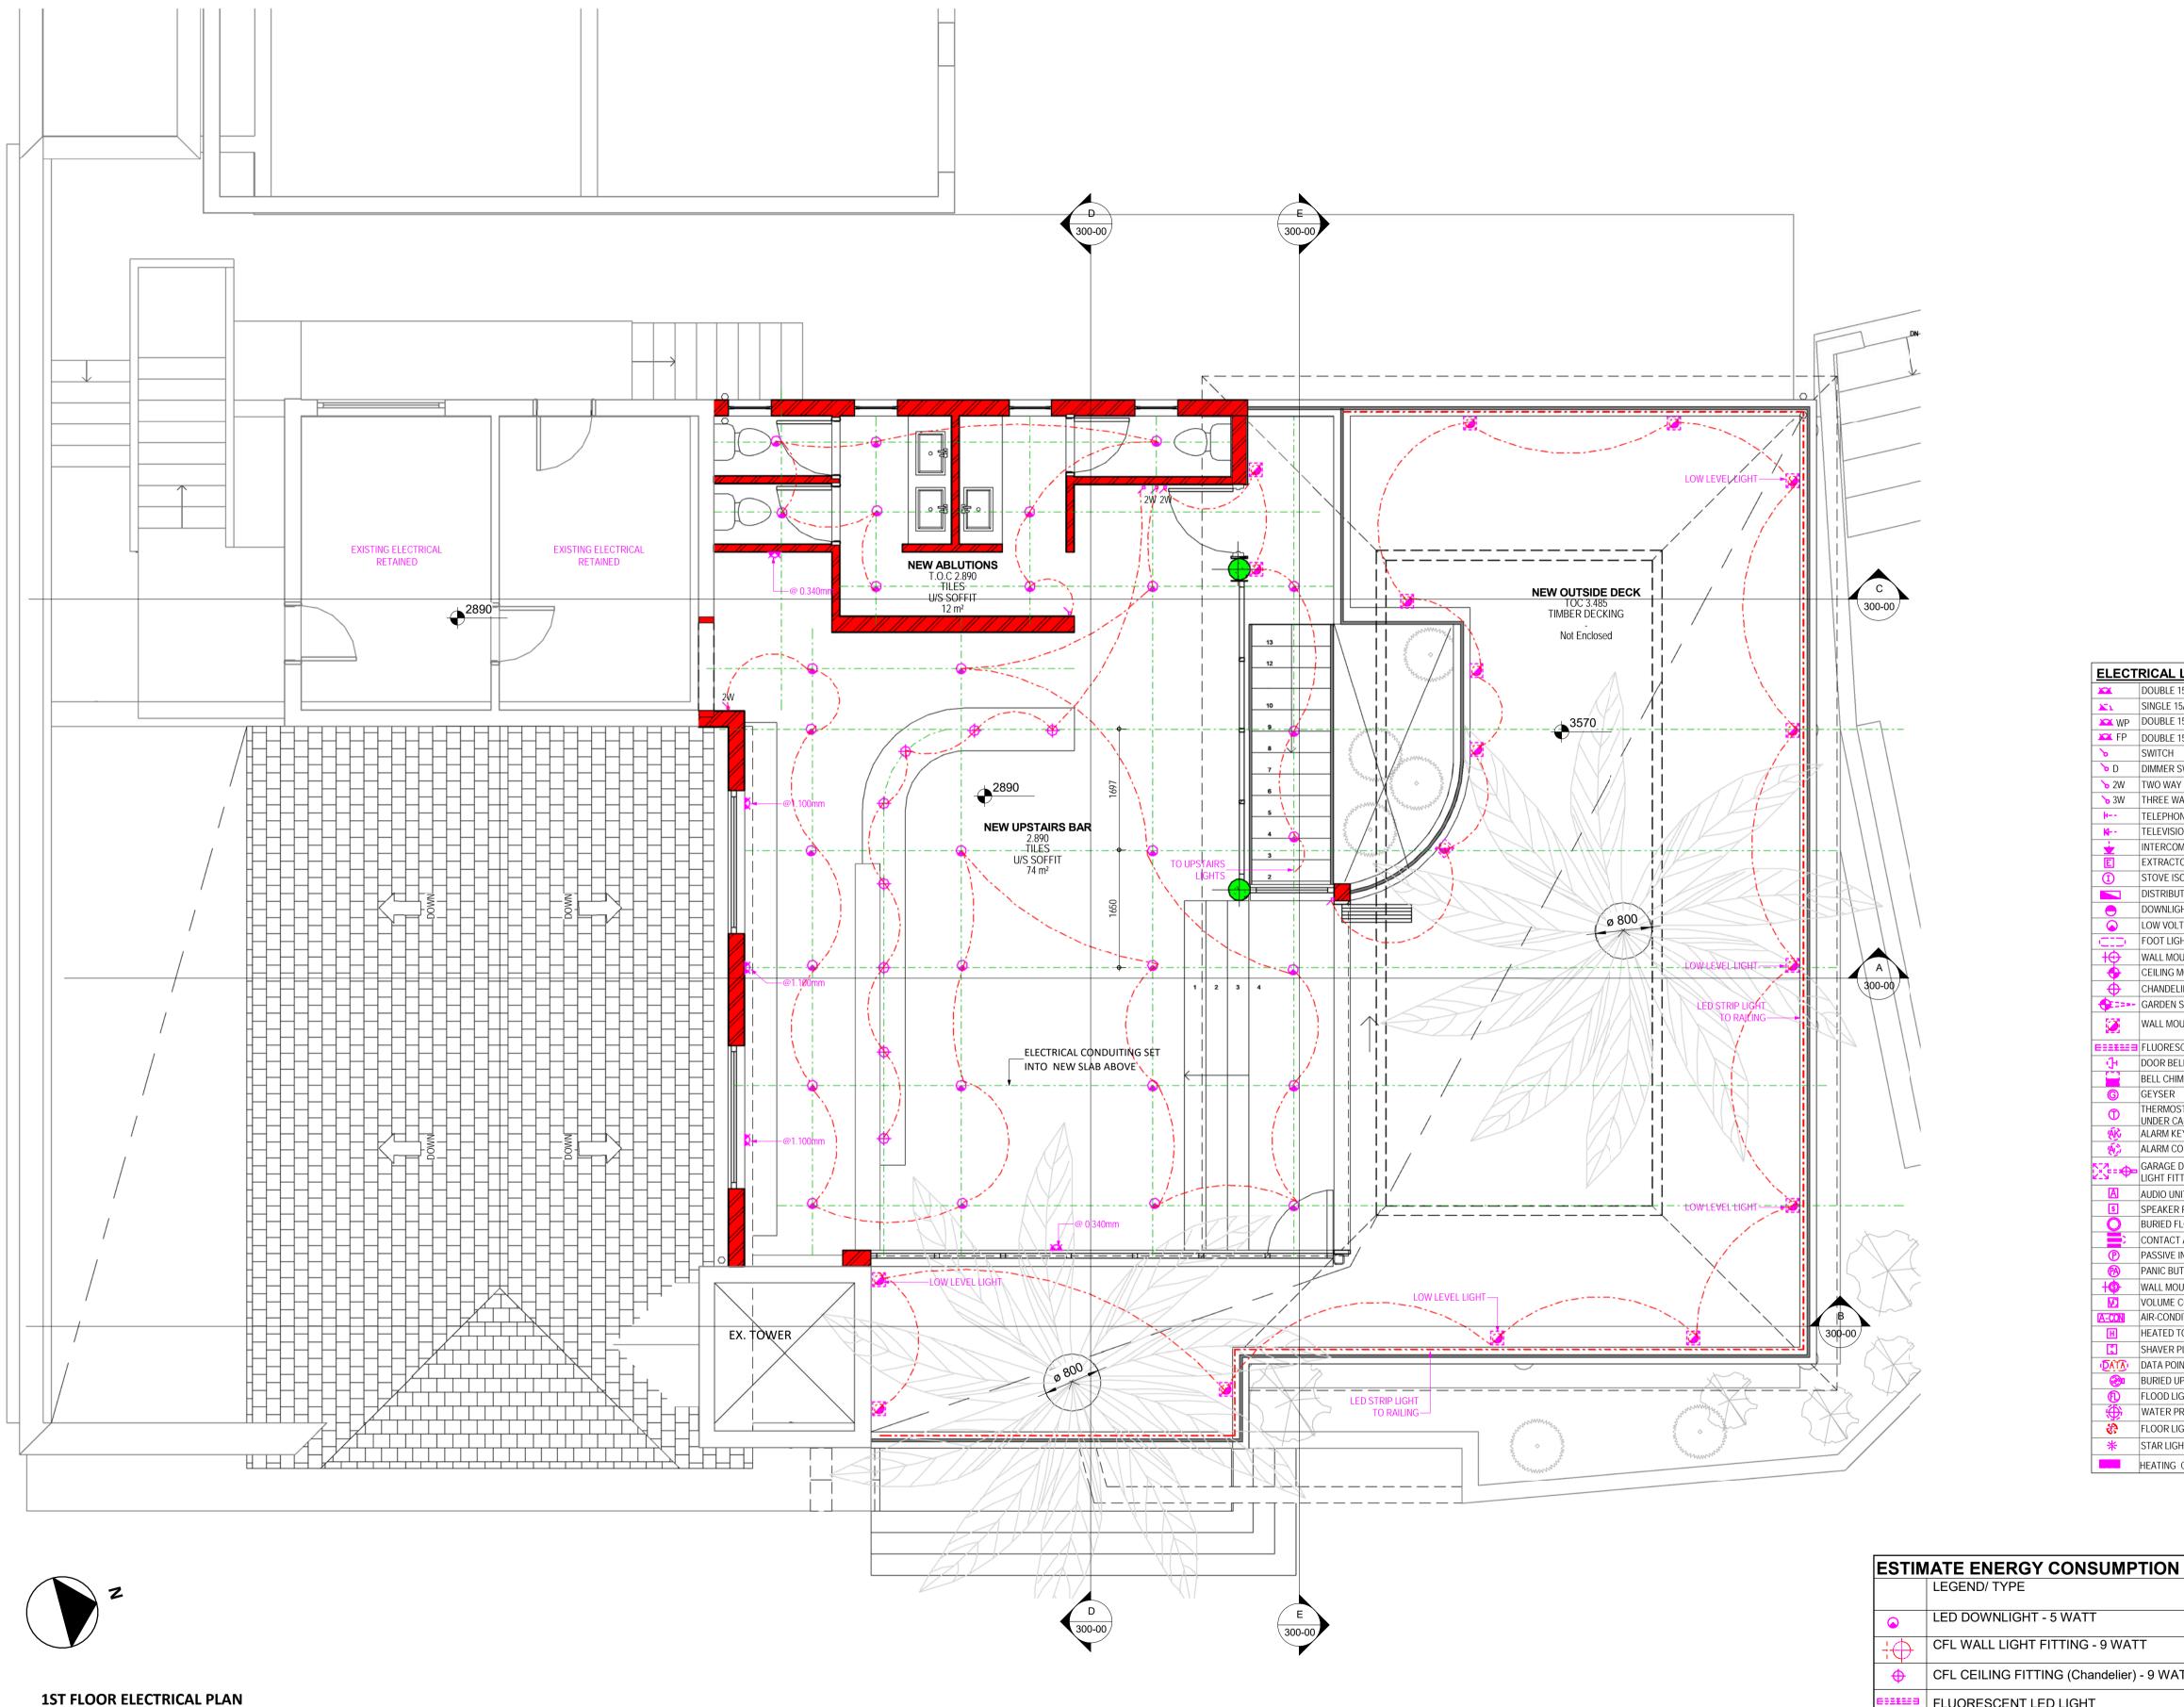

SINGLE 15AMP SOCKET ■ WP DOUBLE 15AMP WATERPROOF SOCKET FP DOUBLE 15AMP SOCKET FLOOR PLUG D DIMMER SWITCH > 2W TWO WAY SWITCH > 3W THREE WAY SWITCH TELEPHONE TELEVISION INTERCOM EXTRACTOR STOVE ISOLATOR DISTRIBUTION BOARD DOWNLIGHTER (SWIVEL) LOW VOLTAGE DOWNLIGHTER (FIXED) FOOT LIGHT WALL MOUNTED LIGHT FITTING CEILING MOUNTED LIGHT FITTING CHANDELIER LIGHT FITTING GARDEN SPIKED FITTING WALL MOUNTED UPLIGHTER = FLUORESCENT LIGHT FITTING DOOR BELL BELL CHIME GEYSER THERMOSTAT FOR UNDER TILE / UNDER CARPET ALARM KEY POINT ALARM CONTROL BOX GARAGE DOOR MOTOR WITH AUDIO UNIT SPEAKER POINTS BURIED FLOODLIGHT CONTACT AT DOOR LINTOL PASSIVE INFRARED PANIC BUTTON WALL MOUNTED SECURITY LIGHT VOLUME CONTROL AIR-CONDITIONING HEATED TOWEL RAIL SHAVER PLUG POINT DATA POINT / INTERNET CONNECTION BURIED UPLIGHT FLOOD LIGHTS WATER PROOF LIGHT IN WATER FEATURE

> FLOOR LIGHTS STAR LIGHTS

STAR LIGHTS - 3 WATT

FOOT LIGHTS - 5 WATT

HEATING CONTROLLER BOX

QUANTITY

171

11

16

43

2017/05/28 13:08:07

ELECTRICAL LEGEND

DOUBLE 15AMP SOCKET

LED DOWNLIGHT - 5 WATT

CFL WALL LIGHT FITTING - 9 WATT CFL CEILING FITTING (Chandelier) - 9 WATT FLUORESCENT LED LIGHT FITTING - 9 WATT GARAGE DOOR MOTOR LIGHT FITTING - 9 WATT WALL MOUNTED UPLIGHTER - 5 WATT GARDEN SPIKED FITTING - 5 WATT

#### **GENERAL**

- 1. DIMENSIONS TO BE USED IN PREFERENCE TO SCALING.
- 2. ALL LEVELS & DIMENSIONS TO BE CHECKED PRIOR TO WORK BEING PUT IN HAND. DISCREPANCIES TO BE REPORTED TO THE ARCHITECT.
- 3. ALL LEVELS SHOWN ARE STRUCTURAL LEVELS, UNLESS OTHERWISE STATED.
- 4. ALL STRUCTURAL WORK IS TO BE DESIGNED AND
- SPECIFIED BY THE APPOINTED ENGINEER. 5. COPYRIGHT OF THIS DRAWING IS ALWAYS TO REMAIN
- WITH ALSFINE AND ANGUS ARCHITECTS
- 6. THE CONTRACTOR IS TO CHECK ALL SCHEDULES &
- DRAWINGS BEFORE PLACING ORDERS. 7. ALL BUILDING WORK & BUILDING REQUIREMENTS ARE TO
- BE CARRIED OUT IN STRICT ACCORDANCE WITH THE
- REQUIREMENTS OF THE NATIONAL BUILDING REGULATIONS & BUILDING STANDARDS. ACT No. 103 OF
- 8. ALL PARTITIONING TO HAVE ADEQUATE FIRE RATING &
- RODENT PROOFING.
- 9. LIGHTING AND VENTILATION TO COMPLY WITH PART 'O' OF THE NATIONAL BUILDING REGULATIONS.
- 10. ALL BALUSTRADING TO BE IN ACCORDANCE WITH THE NATIONAL BUILDING REGULATIONS (IE. 1000mm HIGH & BALUSTERS AT MAX. 100mm C/C.)
- 11. ON PROJECTS WHERE NO SITE SUPERVISION IS BEING
- PROVIDED, ANY DISCREPANCIES OR SHORTCOMINGS CONTAINED IN THESE DRAWINGS WILL NOT BE THE RESPONSIBILITY OF ALSFINE AND ANGUS ARCHITECTS

### DRAINAGE RETICULATION

- 1. ALL PLUMBING TO BE IN ACCORDANCE WITH N.B.R.
- 2. ALL DRAINAGE RUNS TO BE ACCESSIBLE ALONG THEIR ENTIRE LENGTH.
- 3. V.P.'S TO BE CARRIED UP TO 2m ABOVE ANY WINDOW
- OR DOOR OPENING IN THE BUILDING OR ANY OTHER
- BUILDING WITHIN A DISTANCE OF 6m. 4. INSPECTION EYES (I.E.'S) TO BE PROVIDED AT ALL
- BENDS & JUNCTIONS OF SOIL & WASTE PIPES.
- 5. RODDING EYES (R.E.'S) TO BE PROVIDED AT HEADS OF
- DRAINS & AT A MAXIMUM 25m SPACING ALONG RUNS OF
- 6. MARKED COVERS TO BE PROVIDED AT GROUND LEVEL
- FOR ALL I.E.'S.
- 7. RESEAL TRAPS TO BE FITTED TO ALL WASTE FITTINGS. 8. SOIL DRAINS UNDER BUILDINGS TO BE PROTECTED
- FROM ALL VERTICAL SETTLEMENT LOADS WITH R.E.'S AS CLOSE AS POSSIBLE TO THE BUILDING AT BOTH
- 9. WASTE WATER PIPES HAVING A VERTICAL DROP
- **EXCEEDING** 1200mm TO THE MAIN DRAIN TO BE ANTI-SYPHONED. 10. ALL BRANCH DRAINS EXCEEDING 6m IN LENGTH TO
- 11. ALL MATERIALS USED ARE TO BE IN ACCORDANCE WITH
- THE MANUFACTURERS TECHNICAL SPECIFICATIONS. 12. WASTE WATER PIPES TO BE MIN 50Ø

FIRE RETICULATION

13. DRAINPIPES TO BE MIN 100Ø

1. ALL BUILDING TO BE IN ACCORDANCE WITH PART "T" OF THE NATIONAL BUILDING REGULATIONS FOR THE RELEVANT CLASS OF OCCUPANCY.

**OWNER'S** 

**ENGINEER'S** 

**REVISIONS** 

No DATE DESCRIPTION



THE CRAYFISH INN CLIENT

CRAYFISH INN RESTAURANT ADDITION AND ALTERATION

STAND NO STAND 2105 RAMSGATE

DRAWING

SCALE

ELECTRICAL FIRST FLOOR

S RAUBENHEIMER S RAUBENHEIMER 04/12/16

As indicated

PROJECT NO: DWG NO: REV: