

# CITY OF BOISE FIRE STATION 8 - DEMO SET

CONTRACT DRAWINGS FOR:

## CITY OF BOISE FIRE STATION 8 - SITE/ BUILDING DEMOLITION SET 3575 W Overland Rd Boise, ID 83705

PROJECT NO. 15-28  
PLOT DATE: 02.04.16

PROJECT PHASE:  
DEMOLITON SET

CIVIL  
ARCHITECTURAL  
STRUCTURAL  
ELECTRICAL  
MECHANICAL  
PLUMBING

## PROJECT CONTACT INFORMATION:

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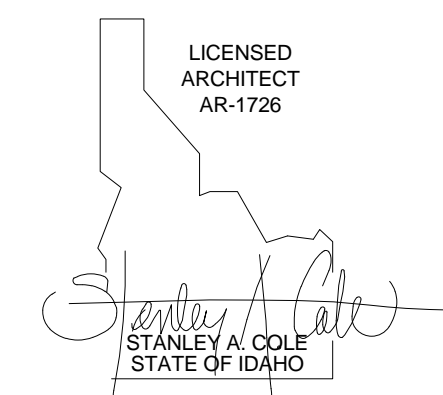
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**G000**



A	5		4		3		2		1		ARCHITECT:	
	ABBREVIATIONS:		ARCHITECTURAL SYMBOLS		GENERAL PROJECT NOTES:		VICINITY MAP:		SHEET INDEX:		<div>ARCHITECT:</div> <div>COLE ARCHITECTS</div> <div>COLE ARCHITECTS   802 W. BANNOCK SUIT 208 Boise, ID 83702   (208) 345-1800</div> <div>TCA</div> <div>architecture • planning</div> <div>TCA   6211 Roosevelt Way NE Seattle, WA 98115   (206) 522-3820</div> <div>STAMP:</div> <div>LICENSED ARCHITECT AR-1726</div> <div>CONSULTANT:</div> <div>PROJECT INFORMATION:</div> <div><div>BOISECITY OF TREES</div><div>BOISE FIRE EST. 1878 DEDICATION</div></div> <div>City of Boise Fire Station 8</div> <div>3575 W. Overland Rd. Boise, ID 83705</div>	
ABBREVIATIONDESCRIPTION		0COLUMN GRID LINE (EXISTING - HALFTONE)		A. GENERAL PROJECT NOTES APPLY TO ALL SHEETS & SPECIFICATIONS. CONTRACTOR AND SUB-CONTRACTORS ARE TO REVIEW ALL CONTRACT DOCUMENTS AND COORDINATE THEIR SCOPE OF WORK WITH THE GENERAL CONTRACTOR AND OTHER SUB-CONTRACTORS. INFORMATION COMMON TO SEVERAL DRAWINGS MAY BE NOTED ON ONLY ONE. CONTRACTOR IS RESPONSIBLE FOR ENTIRE SET OF DOCUMENTS.				SHEET INDEX				
ABANCHOR BOLT		0COLUMN GRID LINE (NEW)		B. IF INFORMATION ON SEPARATE SHEETS OR DETAILS INDICATE CONFLICTING INFORMATION OR QUESTIONS ABOUT THE SCOPE OF WORK OR DESIGN INTENT, THE CONTRACTOR IS TO NOTIFY THE ARCHITECT IMMEDIATELY BEFORE BIDS ARE FINALIZED TO CLARIFY SCOPE OF WORK. IF THE SCOPE OF WORK REMAINS UNCLEAR THEN THE CONTRACTOR OR SUB-CONTRACTOR IS INSTRUCTED TO PRICE AND PROVIDE THE MOST EXPENSIVE SCOPE OF WORK OPTION IN THEIR BID.				xxSheet Name				
AFFABOVE FINISH FLOOR		CLCENTER LINE		C. WHERE CONFLICTING DIRECTION IS GIVEN WITHIN THE SPECIFICATIONS AND DRAWINGS THE CONTRACTOR IS TO NOTIFY THE ARCHITECT IMMEDIATELY BEFORE BIDS ARE FINALIZED TO CLARIFY SCOPE OF WORK. IF THE SCOPE OF WORK REMAINS UNCLEAR THEN THE CONTRACTOR OR SUB-CONTRACTOR IS INSTRUCTED TO PRICE AND PROVIDED THE MOST EXPENSIVE SCOPE OF WORK OPTION IN THEIR BID.				G000COVER SHEET				
ALUMALUMINUM		DIMENSION LINE TO FACE OF STUD, FACE OF CONCRETE, COLUMN LINE, OR AS NOTED.		D. COORDINATE CONSTRUCTION ACTIVITY WITH PROJECT SPECIFICATIONS. ALL SPECIFICATIONS, REFERENCED IN DRAWINGS OR NOT, SHALL BE PART THIS PROJECTS SCOPE OF WORK. MISNUMBERED (OR MISLABELED) SPECIFICATIONS OR REFERENCES ARE ALSO PART OF THIS PROJECTS SCOPE OF WORK AND SHALL BE BROUGHT TO THE ATTENTION OF THE ARCHITECT. THE CONTRACTOR IS RESPONSIBLE TO INCORPORATE ALL SPECIFICATIONS INTO THE PROJECTS SCOPE OF WORK.				G001SHEET LEGEND & PROJECT INFORMATION				
B	APPROXAPPROXIMATELY		XXXROOM TAG XXXROOM NAME XXXROOM NUMBER XXXAREA OR VOLUME		E. WHEN APPLICABLE, PROTECT ITEMS THAT ARE TO BE SALVAGED TO THE OWNER. THESE INCLUDE BUT NOT LIMITED TO: WINDOWS, FRAMES, LIGHT FIXTURES, CEILING COMPONENTS, EQUIPMENT, MILLWORK, FIRE EXTINGUISHERS, CABINETS, AND CARPET. COORDINATE LOCATION AND TIME OF DELIVERY OF ITEMS TO BE RETURNED WITH THE OWNER.		<div>MATERIAL LEGEND:</div> <div>CONCRETE (SECTION)</div> <div>GRANULAR FILL</div> <div>CONCRETE MASONRY UNITS</div> <div>BRICK</div> <div>RIGID INSULATION (SECTION)</div> <div>ACOUSTIC/THERMAL INSULATION (SECTION)</div> <div>STUD WALL (PLAN &amp; SECTION)</div> <div>EXISTING WALL TO REMAIN (PLAN &amp; SECTION)</div> <div>DEMO WALL (PLAN &amp; SECTION)</div> <div>STEEL (SECTION)</div> <div>ALUMINUM (SECTION)</div> <div>WOOD - FINISH (SECTION)</div> <div>DIMENSIONAL LUMBER CONTINUOUS (SECTION)</div> <div>DIMENSIONAL LUMBER BLOCKING (SECTION)</div> <div>LUMBER - FINISH (SECTION)</div> <div>EARTHWORK (SECTION)</div>		A2001ST FLOOR DEMOLITION PLAN			
	BDBOARD		XXWALL TYPE TAG		F. DO NOT SCALE DRAWINGS. IF SPECIFIC DIMENSIONS ARE NEEDED CONSULT ARCHITECT.				MEP000M/E/P DEMOLITION PLAN			
	BLDGBUILDING		123WINDOW TAG		G. FIGURED DIMENSIONS TAKE PRECEDENCE OVER SCALED DRAWINGS. WHERE DISCREPANCIES OCCUR, THEY SHALL BE REPORTED TO ARCHITECT FOR RESOLUTION.							
	BMBASEMENT		DRAWING REVISION		H. DETAILED DRAWINGS AND LARGER SCALE DRAWINGS TAKE PRECEDENCE OVER SMALLER SCALE DRAWINGS.							
	BOTBOTTOM		NORTH ARROW		I. THE DRAWINGS INDICATE LOCATION, DIMENSIONS, REFERENCE, AND TYPICAL DETAILS OF CONSTRUCTION. THE DRAWINGS DO NOT INDICATE EVERY CONDITION. WORK THAT IS NOT SPECIFICALLY DETAILED SHALL BE OF CONSTRUCTION SIMILAR TO PARTS THAT ARE DETAILED.							
C	BRGBEARING		LEVEL DATUM		J. SUBCONTRACTORS FOR EACH TRADE ARE ADVISED THAT INFORMATION PERTINENT TO THEIR WORK MAY OCCUR IN OTHER PORTIONS OF THE CONTRACT DOCUMENTS. ALL NOTES ARE TO BE REVIEWED AND APPLIED TO RELATED BUILDING DOCUMENTS.				ADDRESS: 3575 W. OVERLAND RD.			
	CJCONTROL/CONSTRUCTION JOINT		LEVEL NAME X'-X"		K. WHERE NO MATERIAL NOTES OCCUR, THE GRAPHIC MATERIAL INDICATION SHALL INDICATE MATERIAL TYPES AND ITEMS. SEE SYMBOL AND MATERIALS LIST ON THIS SHEET.				PROPERTY DESCRIPTION: PAR #0340 OF LOTS 26-32 BLK 03 & LOTS 01-07 & VAC ALLEY STEINS ADD R/S 5532 #0376-S #0337-C			
	CLDCEILING		SPOT ELEVATION		L. THE U. S. ENVIRONMENTAL PROTECTION AGENCY MUST BE NOTIFIED 10 WORKING DAYS IN ADVANCE FOR ALL RENOVATIONS THAT DISTURB 260 L.F./160 SQ. FT./35 CU. FT. OF ASBESTOS CONTAINING MATERIALS.				PARCEL NUMBER: R8123000340			
	CLRCLEAR		DETAIL - SECTION		M. UNLESS OTHERWISE INDICATED ALL DRAWINGS, NOTES WHICH DO NOT READ "N.I.C.", "EXISTING", OR "EXISTING TO REMAIN", OR "BY OTHERS" SHALL INDICATE NEW WORK WHICH SHALL BE CONTRACTOR FURNISHED AND CONTRACTOR INSTALLED.				LOT SIZE: 0.653 ACRES			
	CMUCONCRETE MASONRY UNIT		DETAIL - PLAN		N. THE CONTRACTOR(S) SHALL KEEP ALL AREAS OF CONSTRUCTION CLEAN AND FREE OF DEBRIS. AFTER CONSTRUCTION IS COMPLETE, THE GENERAL CONTRACTOR SHALL PROVIDE FINAL CLEAN UP, ENFORCE REQUIREMENTS STRICTLY. DISPOSE OF MATERIALS LAWFULLY.				NUMBER OF STORIES: 1			
D	CONCOLUMN		BUILDING SECTION		O. THE CONTRACTOR SHALL VERIFY ALL EXISTING CONDITIONS AND DIMENSIONS FOR ACCURACY PRIOR TO COMMENCING WITH THE WORK. ANY DISCREPANCY SHALL BE BROUGHT TO THE ATTENTION OF THE ARCHITECT.				SQUARE FOOTAGE: 11,936 SQ FT			
	CONCCONCRETE		WALL SECTION		P. FIELD MEASUREMENTS: TAKE FIELD MEASUREMENTS AS REQUIRED TO FIT THE WORK PROPERLY. RECHECK MEASUREMENTS BEFORE INSTALLING EACH PRODUCT. WHERE PORTIONS OF THE WORK ARE INDICATED TO FIT TO OTHER CONSTRUCTION, VERIFY DIMENSIONS OF OTHER CONSTRUCTION BY FIELD MEASUREMENTS BEFORE FABRICATION. COORDINATE FABRICATION SCHEDULE WITH CONSTRUCTION PROGRESS TO AVOID DELAYING THE WORK.				CONSTRUCTION TYPE: VB			
	CONNCONNECTION		EXTERIOR ELEVATION		Q. COORDINATE STRUCTURAL, MECHANICAL, ELECTRICAL, AND FIRE PROTECTION REQUIREMENTS, ROUTING, AND FIELD VERIFY.				OCCUPANCY: GROUP B-BUSINESS			
	CONTCONTINUOUS		INTERIOR ELEVATION		R. WHERE NEW CONSTRUCTION JOINS WITH EXISTING CONSTRUCTION, ALIGN FINISHED SURFACE OF NEW CONSTRUCTION WITH EXISTING CONSTRUCTION.				LAND USE CODE: C-2D			
	CONTRCONTRACTOR		VIEW TITLE		S. ALL CONSTRUCTION ADDENDA, CHANGE ORDERS, OR DESIGN CLARIFICATIONS TO THOSE ITEMS REGULATED BY THE CODES MUST BE SUBMITTED TO THE FIELD INSPECTOR FOR REVIEW AND APPROVAL PRIOR TO COMMENCING WITH ANY OF THE PROPOSED WORK RELATED TO THE PROPOSED FIELD CHANGE.				FIRE SPRINKLERS: FULL SPRINKLERS			
E	CONCCONCRETE		VIEW NAME		T. EXAMINATION AND ACCEPTANCE OF CONDITIONS: BEFORE PROCEEDING WITH EACH COMPONENT OF THE WORK, EXAMINE SUBSTRATES, AREAS, AND CONDITIONS WITH INSTALLER OR APPLICATOR PRESENT WHERE INDICATED, FOR COMPLIANCE WITH REQUIREMENTS FOR INSTALLATION TOLERANCES AND OTHER CONDITIONS AFFECTING PERFORMANCE. RECORD OBSERVATIONS.							
	CONNCONNECTION		DRAWING NUMBER		U. PROCEED WITH INSTALLATION ONLY AFTER UNSATISFACTORY CONDITIONS HAVE BEEN CORRECTED. PROCEEDING WITH THE WORK INDICATES ACCEPTANCE OF SURFACES AND CONDITIONS.							
	CONTCONTINUOUS		DRAWING SCALE									
	CONTRCONTRACTOR											
	CONCCONCRETE											

02.04.16




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### TREE PROTECTION NOTES:

- PROTECT THE CRITICAL ROOT ZONE (THE AREA DIRECTLY BELOW THE DRIP LINE OF THE TREE) OF THE TREES TO REMAIN ON SITE BY:
  - CONSTRUCTING A TEMPORARY CHAIN LINK FENCE AROUND THE CRITICAL ROOT ZONE OF THE TREE TO BE PROTECTED PRIOR TO DEMOLITION, CONSTRUCTION, OR ANY SITE WORK.
  - NOT ALLOWING COMPACTION BY EQUIPMENT TRAFFIC DURING CONSTRUCTION OR DURING DEMOLITION.
  - NOT ALLOWING CONCRETE TRUCKS TO RINSE WITHIN THE PROTECTION AREA, OR ANYWHERE NEAR EXISTING TREE ROOTS OR IN PLANNED PLANTING BEDS AREAS. SEE EROSION AND SEDIMENT CONTROL PLAN FOR APPROVED CONCRETE WASHOUT AREAS.
  - NOT STOCKPILING MATERIALS, DEBRIS, OR DIRT WITHIN THE TREE PROTECTION AREA.
  - WATERING WITHIN THE CRITICAL ROOT ZONE FROM MID-APRIL TO MID-OCTOBER AT THE RATE OF NOT LESS THAN THE EQUIVALENT OF 1-1/2" OF WATER OVER THE ENTIRE AREA PER WEEK.
  - NOT TRENCHING, EXCAVATING, FILLING, OR OTHERWISE DISTURBING THE SOIL WITHIN THE CRITICAL ROOT ZONE.
  - ADJUST PROPOSED IMPROVEMENT LOCATIONS AS REQUIRED TO AVOID DAMAGING TREE ROOTS.
- PROTECT THE CROWN AND TRUNK OF TREES TO BE RETAINED BY:
  - OPERATING EQUIPMENT IN SUCH A WAY AS TO AVOID CONTACT WITH TREE TRUNKS OR BRANCHES.
  - HAVING TREES PRUNED BY A LICENSED ARBORIST.
- ALL TREES DAMAGED OR DESTROYED DURING CONSTRUCTION SHALL BE REPLACED USING THE FOLLOWING CRITERIA:


EXISTING TREE	REPLACEMENT
1" TO 6" CALIPER	2X
CALIPER OF TREE REMOVED	
6" TO 12" CALIPER	1.5X
CALIPER OF TREE REMOVED	
> 12" OR LARGER CALIPER	1X
CALIPER OF TREE REMOVED	

EXAMPLE: IF AN 8" CALIPER TREE IS REMOVED, AN ACCEPTABLE REPLACEMENT WOULD BE (3) 4" CALIPER TREES OR (4) 3" CALIPER TREES.

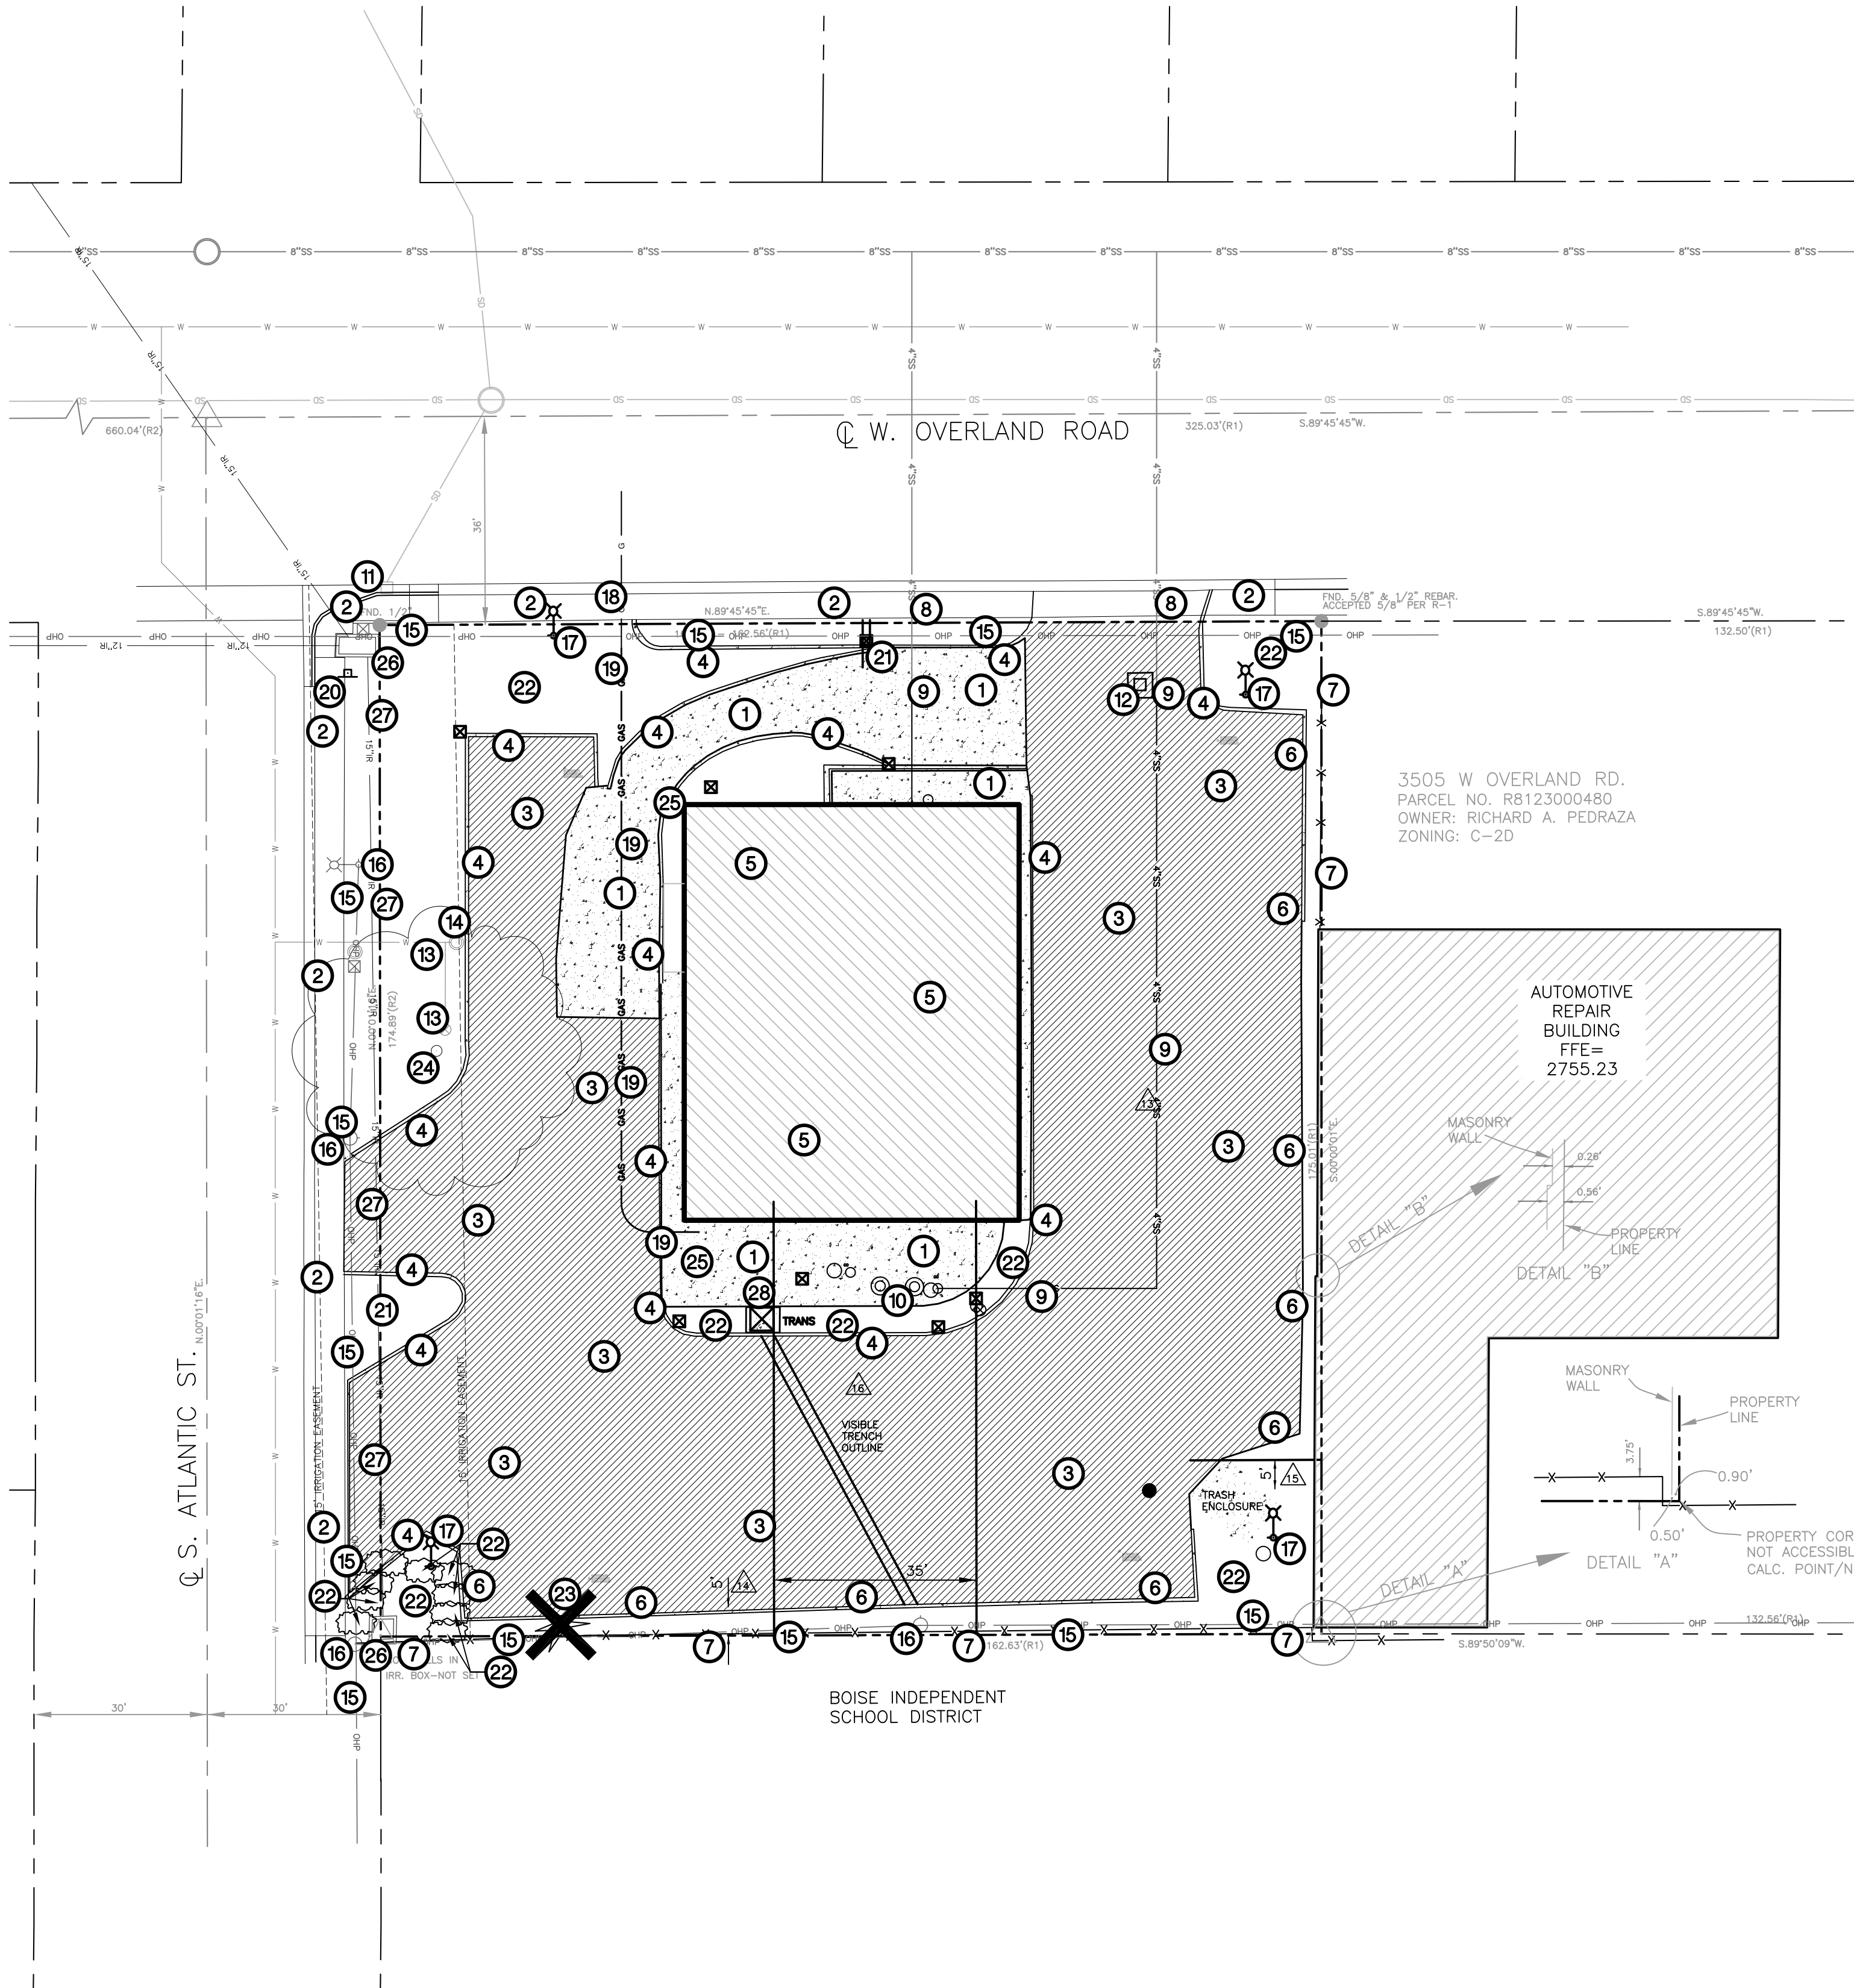

## 1 DEMOLITION PLAN

SCALE: 1" = 20'-0"

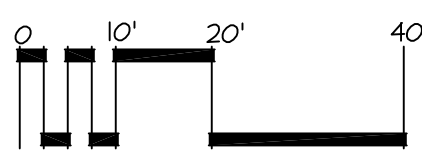

### DEMOLITION LEGEND

- EXISTING PLANTS TO REMAIN
- EXISTING PLANTS TO BE REMOVED
- CONSTRUCTION LIMITS
- EXISTING CURB TO BE REMOVED
- APPROXIMATE AREA OF ASPHALT REMOVAL
- APPROXIMATE AREA OF CONCRETE REMOVAL
- EXISTING BUILDINGS TO BE REMOVED

### DEMOLITION NOTES

- COORDINATE ALL DEMOLITION, GRADING, AND EARTHWORK OPERATIONS WITH MECHANICAL, AND ELECTRICAL ENGINEERING SHEETS.
- CONTRACTOR SHALL REFER TO SPECIFICATIONS AND DETAILS FOR ADDITIONAL REQUIREMENTS.
- LIMITS OF WORK ARE IDENTIFIED ON PLANS.
- IN THE EVENT OF A DISCREPANCY, NOTIFY THE LANDSCAPE ARCHITECT IMMEDIATELY.

### DEMOLITION CALLOUT LEGEND

- SAWCUT AND REMOVE EXISTING CONCRETE FLAT WORK AS INDICATED. COORDINATE WITH LAYOUT PLAN.
- SAVE AND PROTECT EXISTING CONCRETE FLAT WORK.
- SAWCUT AND REMOVE EXISTING ASPHALT.
- SAWCUT AND REMOVE EXISTING CONCRETE CURB.
- REMOVE EXISTING BUILDING. COORDINATE BUILDING DEMOLITION WITH ARCHITECTURAL REQUIREMENTS.
- REMOVE (30) EXISTING CONCRETE WHEEL STOPS.
- SAVE AND PROTECT EXISTING CHAIN LINK FENCE.
- SAVE AND PROTECT EXISTING SANITARY SEWER SERVICE.
- REMOVE EXISTING SANITARY SEWER SERVICE LINE CAP AS DIRECTED BY BOISE CITY PUBLIC WORKS DEPARTMENT.
- REMOVE EXISTING GREASE INTERCEPTOR.
- SAVE AND PROTECT EXISTING STORM DRAIN INLET AND ASSOCIATED PIPING.
- REMOVE EXISTING STORM DRAIN INLET, PIPING AND ASSOCIATED IMPROVEMENTS.
- REMOVE EXISTING WATER LINE. CUT AND CAP AT PROPERTY LINE. COORDINATE WITH UNITED WATER AND UTILITIES PLANS FOR CAPPING LOCATIONS.
- REMOVE EXISTING WATER METER AND SERVICE LINE.
- SAVE AND PROTECT EXISTING UNDERGROUND AND OVERHEAD POWER LINES.
- SAVE AND PROTECT EXISTING POWER POLE, LIGHT POLE AND GUY WIRES.
- REMOVE EXISTING LIGHT POLES AND ASSOCIATED WIRING.
- SAVE AND PROTECT EXISTING GAS LINE.
- CUT AND CAP EXISTING GAS SERVICE LINE AT BACK OF WALK AS DIRECTED BY INTERMOUNTAIN GAS COMPANY. REMOVE EXISTING GAS SERVICE LINE ON SITE. COORDINATE AS REQUIRED.
- SAVE AND PROTECT EXISTING SIGN.
- REMOVE EXISTING SIGN.
- REMOVE EXISTING SHRUBS.
- REMOVE EXISTING TREE AND GRIND STUMP.
- SAVE AND PROTECT EXISTING TREE AND TREE ROOTS. ALL EXCAVATION WITHIN THE DRIP LINE SHALL BE HAND DUG.
- REMOVE EXISTING BOLLARDS AND CONCRETE FOOTINGS.
- SAVE AND PROTECT CONCRETE GRAVITY IRRIGATION BOX.
- SAVE AND PROTECT EXISTING 15" IRRIGATION PIPE.
- REMOVE EXISTING TRANSFORMER. COORDINATE WITH IDAHO POWER AS REQUIRED.



ARCHITECT:

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STAMP:

CONSULTANT:

**BRECKON** landscape

• Landscape Architecture • www.breckonlandscape.com  
• Erosion & Sediment Control • Fax: 208-376-6528  
• Geographic Info Systems • Phone: **208-376-5153**  
• Graphic Communication •  
• Water Management • 181 East 50th Street  
• Irrigation Design • Garden City, Idaho 83714  
• Land Planning •

PROJECT INFORMATION:

**City of Boise Fire Station 8**  
3575 W. Overland Rd. Boise, ID 83705

REVISIONS:

MARK	DATE	DESCRIPTION
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PROJECT PHASE	Project Status
PROJECT NUMBER	15045
PROJECT MANAGER	R. TeBeau
PROJECT ARCHITECT	R. TeBeau
DESIGN	JB
DRAWN BY	BS, LP, TC

SHEET NAME:


**DEMOLITION PLAN**

SHEET NUMBER:

**D1.2**

1.28.16



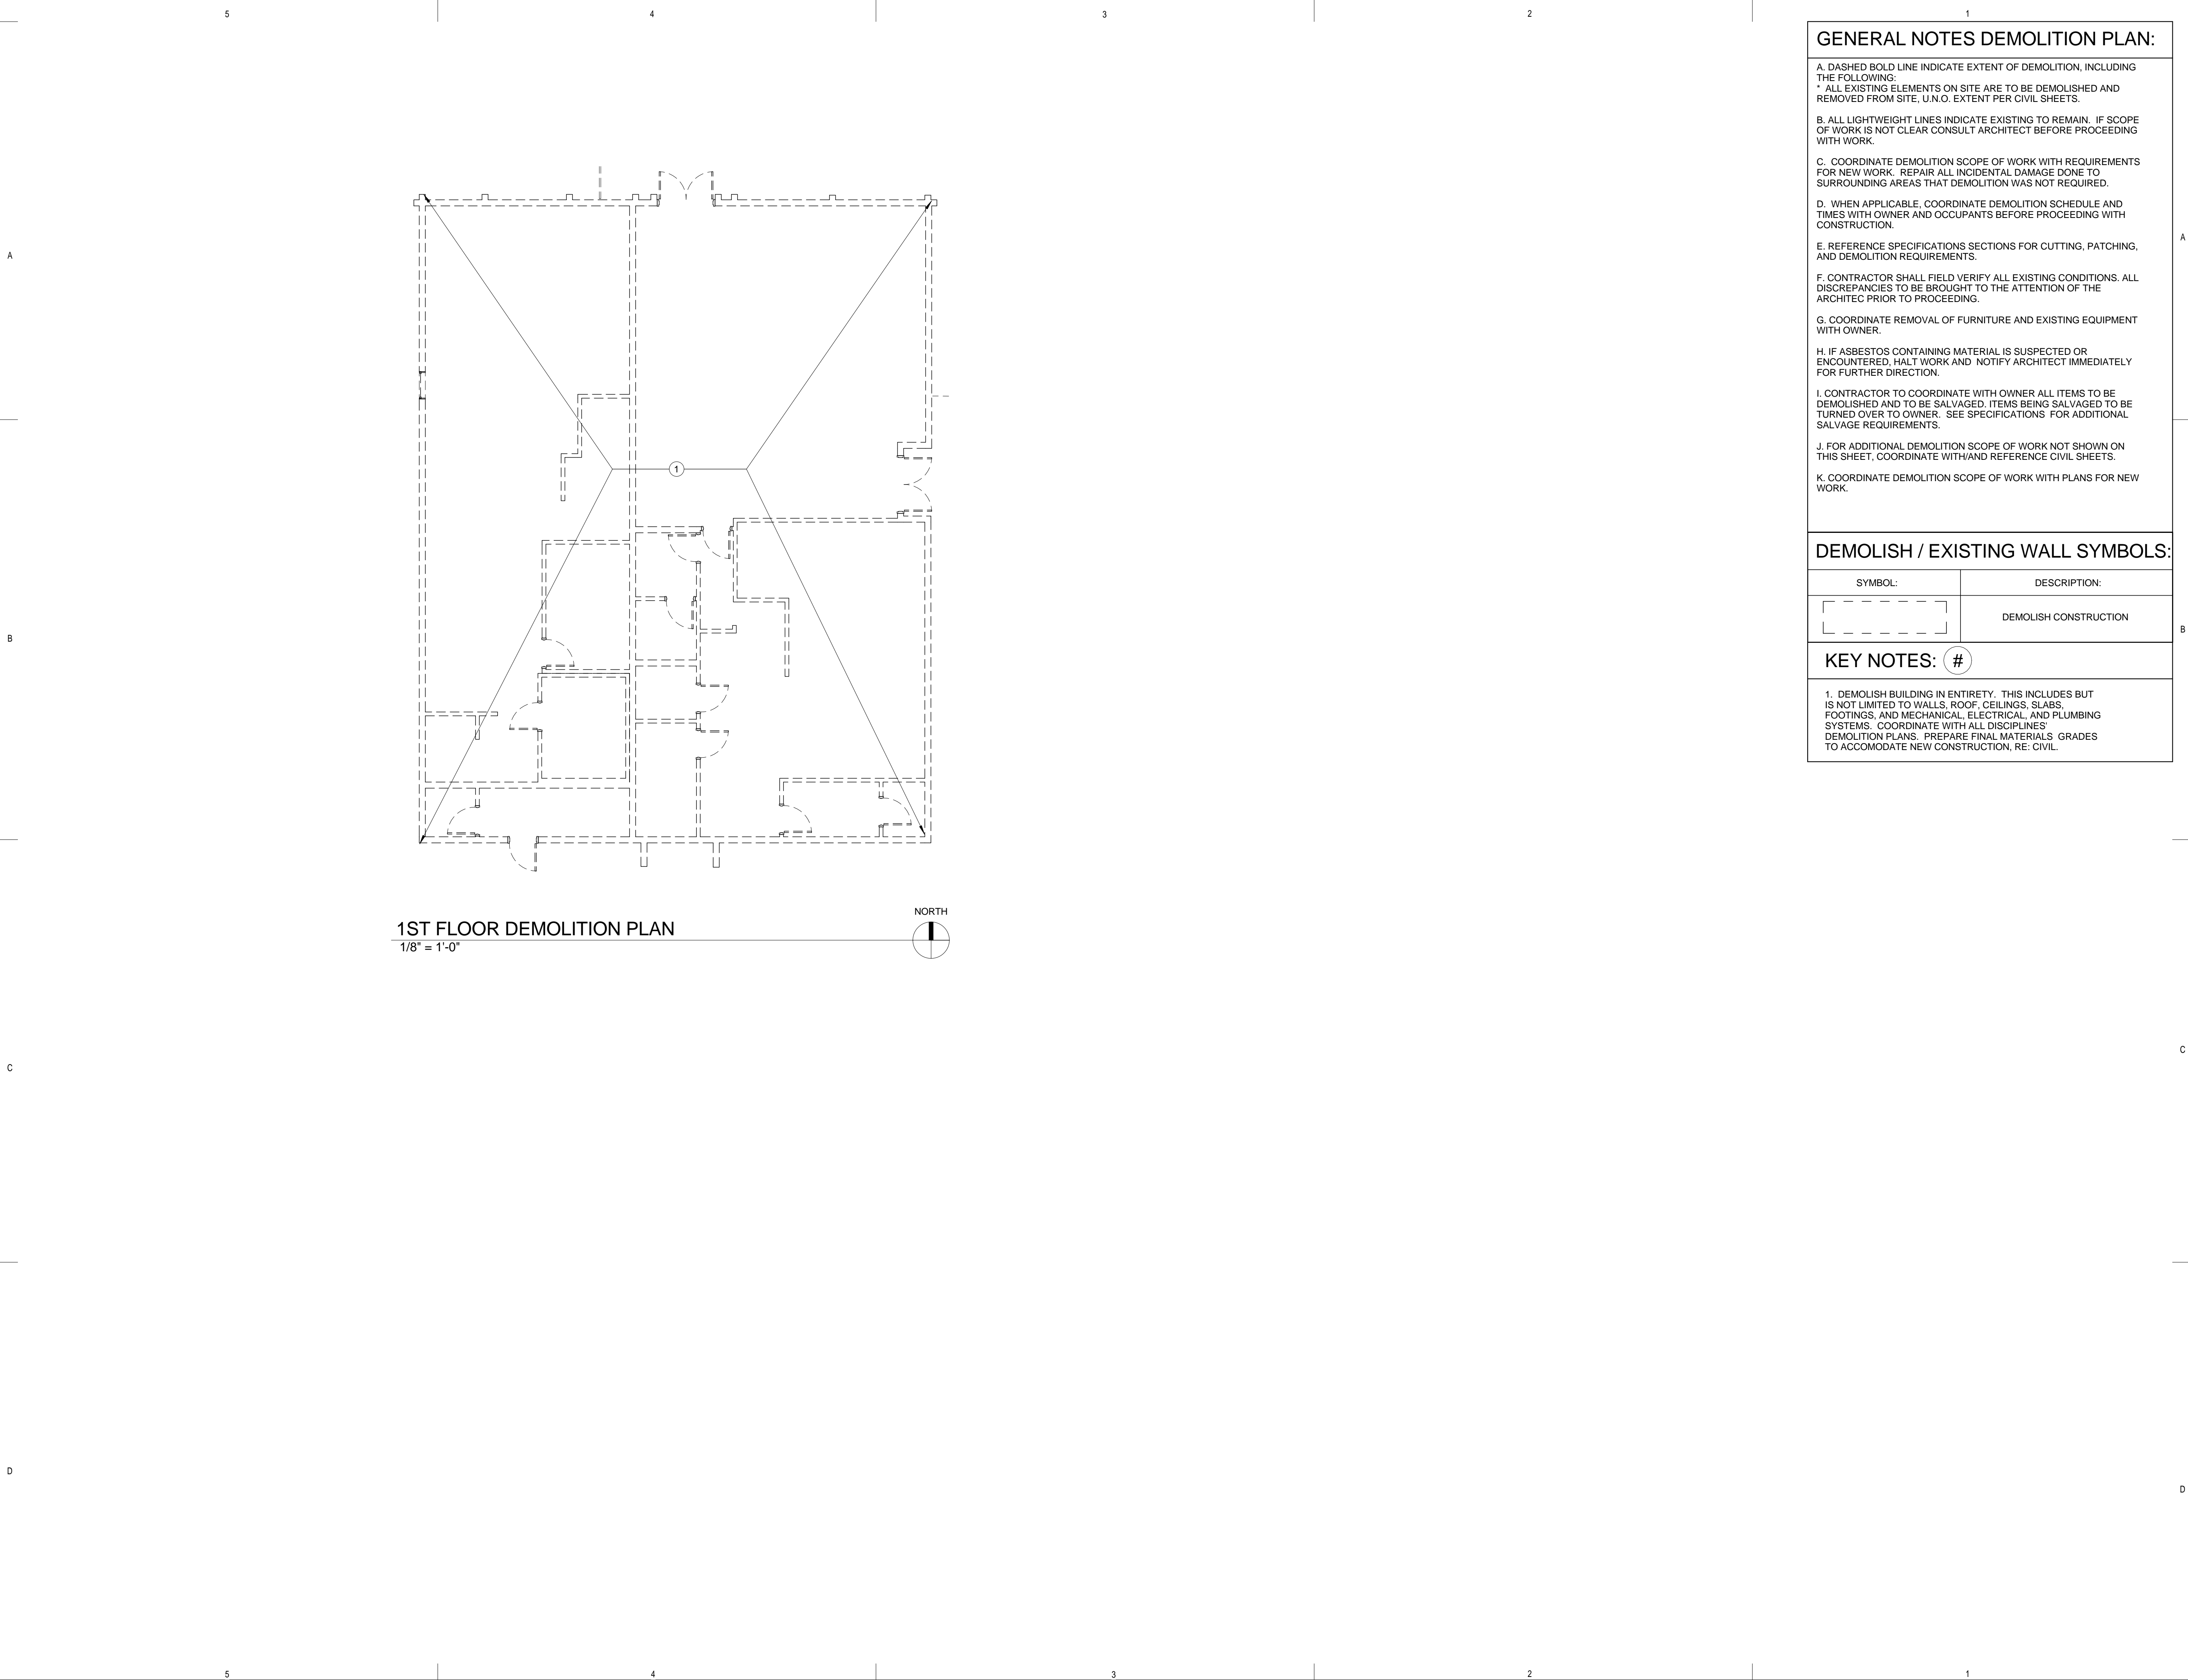

1ST FLOOR DEMOLITION PLAN  
1/8" = 1'-0"

GENERAL NOTES DEMOLITION PLAN:

- A. DASHED BOLD LINE INDICATE EXTENT OF DEMOLITION, INCLUDING THE FOLLOWING:  
\* ALL EXISTING ELEMENTS ON SITE ARE TO BE DEMOLISHED AND REMOVED FROM SITE, U.N.O. EXTENT PER CIVIL SHEETS.
- B. ALL LIGHTWEIGHT LINES INDICATE EXISTING TO REMAIN. IF SCOPE OF WORK IS NOT CLEAR CONSULT ARCHITECT BEFORE PROCEEDING WITH WORK.
- C. COORDINATE DEMOLITION SCOPE OF WORK WITH REQUIREMENTS FOR NEW WORK. REPAIR ALL INCIDENTAL DAMAGE DONE TO SURROUNDING AREAS THAT DEMOLITION WAS NOT REQUIRED.
- D. WHEN APPLICABLE, COORDINATE DEMOLITION SCHEDULE AND TIMES WITH OWNER AND OCCUPANTS BEFORE PROCEEDING WITH CONSTRUCTION.
- E. REFERENCE SPECIFICATIONS SECTIONS FOR CUTTING, PATCHING, AND DEMOLITION REQUIREMENTS.
- F. CONTRACTOR SHALL FIELD VERIFY ALL EXISTING CONDITIONS. ALL DISCREPANCIES TO BE BROUGHT TO THE ATTENTION OF THE ARCHITEC PRIOR TO PROCEEDING.
- G. COORDINATE REMOVAL OF FURNITURE AND EXISTING EQUIPMENT WITH OWNER.
- H. IF ASBESTOS CONTAINING MATERIAL IS SUSPECTED OR ENCOUNTERED, HALT WORK AND NOTIFY ARCHITECT IMMEDIATELY FOR FURTHER DIRECTION.
- I. CONTRACTOR TO COORDINATE WITH OWNER ALL ITEMS TO BE DEMOLISHED AND TO BE SALVAGED. ITEMS BEING SALVAGED TO BE TURNED OVER TO OWNER. SEE SPECIFICATIONS FOR ADDITIONAL SALVAGE REQUIREMENTS.
- J. FOR ADDITIONAL DEMOLITION SCOPE OF WORK NOT SHOWN ON THIS SHEET, COORDINATE WITH/AND REFERENCE CIVIL SHEETS.
- K. COORDINATE DEMOLITION SCOPE OF WORK WITH PLANS FOR NEW WORK.

DEMOLISH / EXISTING WALL SYMBOLS:

SYMBOL:	DESCRIPTION:
	DEMOLISH CONSTRUCTION

KEY NOTES: #

1. DEMOLISH BUILDING IN ENTIRETY. THIS INCLUDES BUT IS NOT LIMITED TO WALLS, ROOF, CEILINGS, SLABS, FOOTINGS, AND MECHANICAL, ELECTRICAL, AND PLUMBING SYSTEMS. COORDINATE WITH ALL DISCIPLINES' DEMOLITION PLANS. PREPARE FINAL MATERIALS GRADES TO ACCOMODATE NEW CONSTRUCTION, RE: CIVIL.

ARCHITECT:

COLE ARCHITECTS


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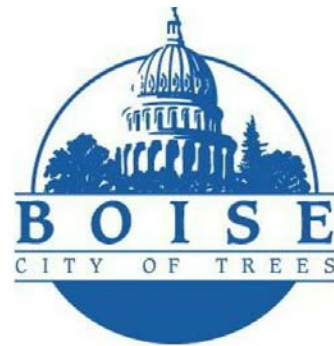
TCA | 8211 Roosevelt Way NE  
Seattle, WA 98115 | (206) 522-3820

STAMP:



CONSULTANT:

PROJECT INFORMATION:

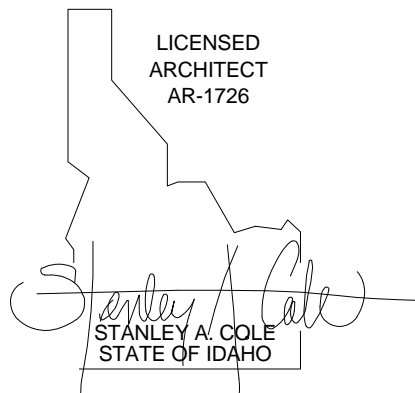

City of Boise Fire Station 8  
3575 W. Overland Rd. Boise, ID 83705

REVISIONS:

MARK	DATE	DESCRIPTION
------	------	-------------

PROJECT PHASE DEMOLITON SET

PROJECT NUMBER 15-28

PROJECT MANAGER R. TeBeau

PROJECT ARCHITECT R. TeBeau

DESIGN B. Harris/ R. TeBeau

DRAWN BY R. TeBeau


SHEET NAME:

1ST FLOOR  
DEMOLITION PLAN

SHEET NUMBER:

A200

02.04.16

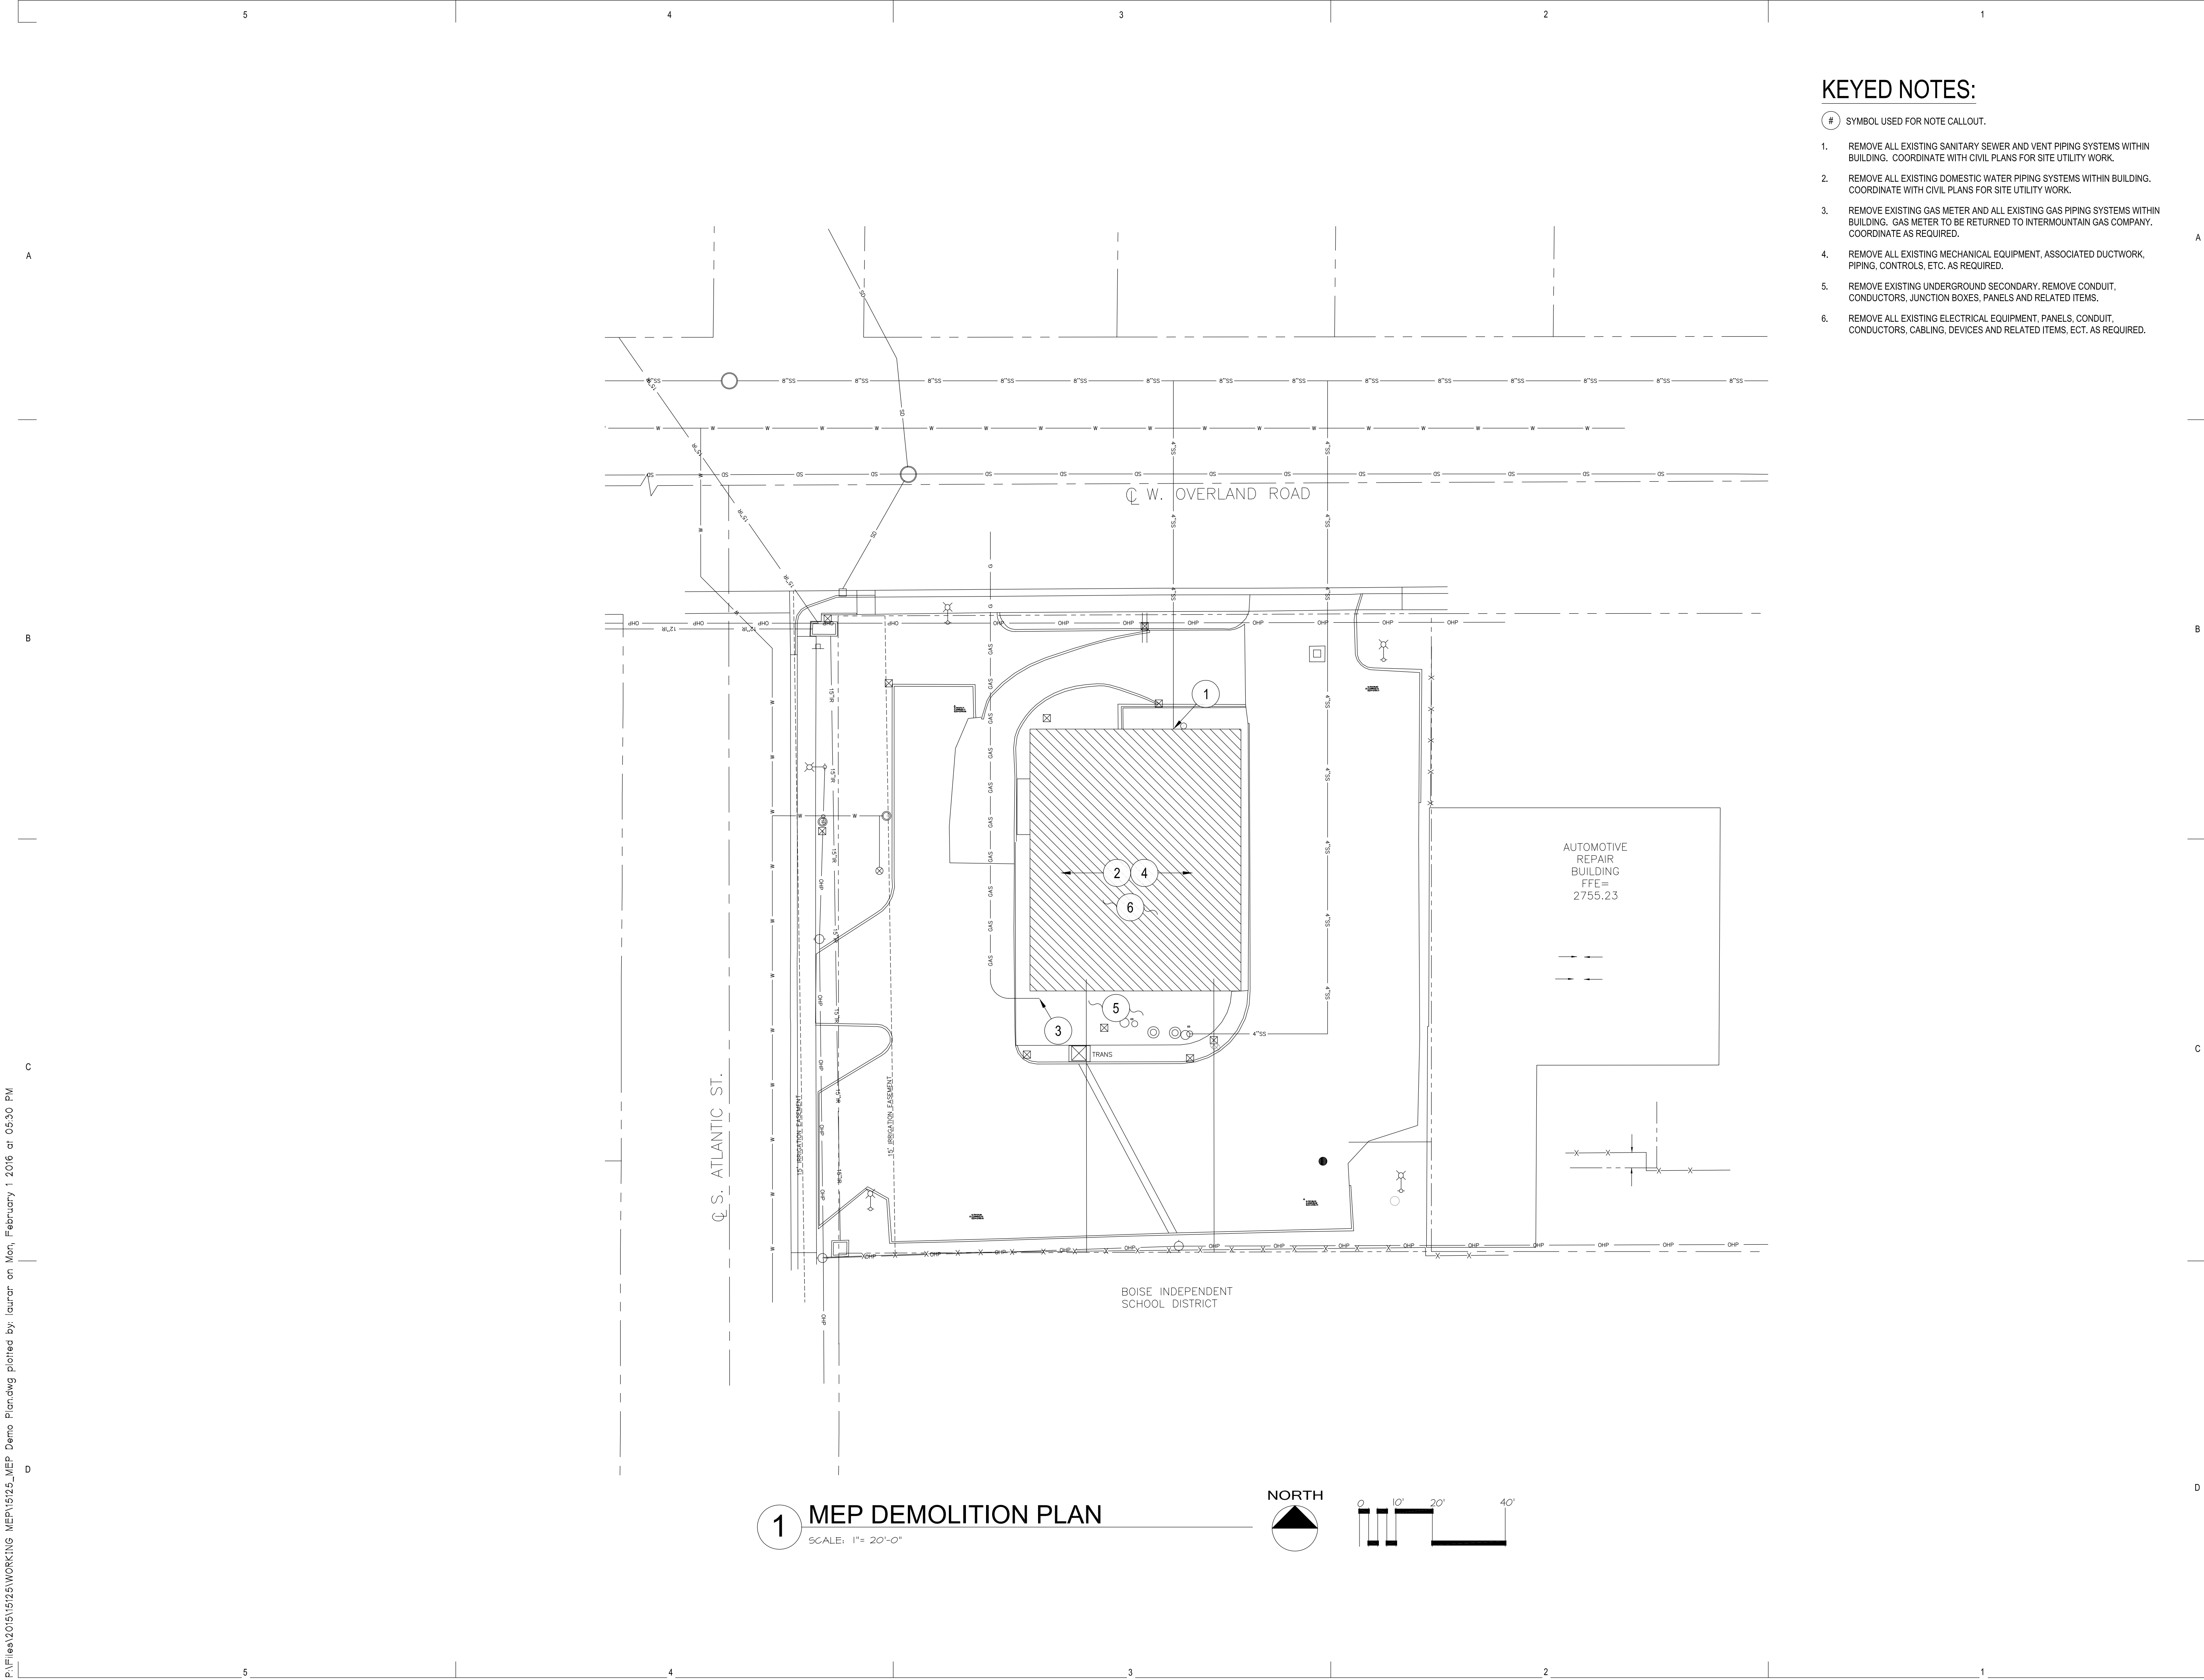

KEYED NOTES:

- # SYMBOL USED FOR NOTE CALLOUT.
1. REMOVE ALL EXISTING SANITARY SEWER AND VENT PIPING SYSTEMS WITHIN BUILDING. COORDINATE WITH CIVIL PLANS FOR SITE UTILITY WORK.
  2. REMOVE ALL EXISTING DOMESTIC WATER PIPING SYSTEMS WITHIN BUILDING. COORDINATE WITH CIVIL PLANS FOR SITE UTILITY WORK.
  3. REMOVE EXISTING GAS METER AND ALL EXISTING GAS PIPING SYSTEMS WITHIN BUILDING. GAS METER TO BE RETURNED TO INTERMOUNTAIN GAS COMPANY. COORDINATE AS REQUIRED.
  4. REMOVE ALL EXISTING MECHANICAL EQUIPMENT, ASSOCIATED DUCTWORK, PIPING, CONTROLS, ETC. AS REQUIRED.
  5. REMOVE EXISTING UNDERGROUND SECONDARY. REMOVE CONDUIT, CONDUCTORS, JUNCTION BOXES, PANELS AND RELATED ITEMS.
  6. REMOVE ALL EXISTING ELECTRICAL EQUIPMENT, PANELS, CONDUIT, CONDUCTORS, CABLING, DEVICES AND RELATED ITEMS. ECT. AS REQUIRED.

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TCA

architecture • planning

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STAMP:

PRELIMINARY



NOT FOR CONSTRUCTION  
2/1/16

CONSULTANT:



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ENGINEERING, P.A.  
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Boise, Idaho 83709  
208.384.0585  
www.musgrovepa.com  
OVER 30 YEARS OF EXCELLENCE  
project number: 15-125

PROJECT INFORMATION:



City of Boise Fire Station 8  
3575 W. Overland Rd. Boise, ID 83705

REVISIONS:

MARK	DATE	DESCRIPTION
------	------	-------------

PROJECT PHASE

Project Status

PROJECT NUMBER

15045

PROJECT MANAGER

R. TeBeau

PROJECT ARCHITECT

R. TeBeau

DESIGN

CP

DRAWN BY

LR

SHEET NAME:

MEP DEMOLITION PLAN

SHEET NUMBER:

MEP000

02.01.16