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COLE ARCHITECTS

COLE ARCHITECTS, PLLC | 802 W. BANNOCK SUITE 208
BOISE, IDAHO 83702 | (208) 345-1800



architecture • planning

CITY OF BOISE FIRE STATION 4 - DEMO SET

CONTRACT DRAWINGS FOR:

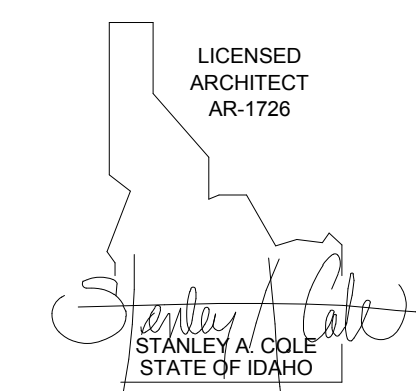
CITY OF BOISE FIRE STATION 4 - SITE/ BUILDING DEMOLITION SET

8485 W Ustick Rd
Boise, ID 83704

PROJECT NO. 15-27
PLOT DATE: 02.02.16

PROJECT CONTACT INFORMATION:

OWNER CITY OF BOISE 150 N CAPITOL BLVD. BOISE, ID 83702 CRAIG JOHNSON 208.384.3945 cjohnson@cityofboise.org	ARCHITECT OF RECORD COLE ARCHITECTS 802 W BANNOCK STE 208 BOISE, ID 83702 STAN COLE 208.345.1800 stan@colearchitects.net JON CHATFIELD 208.345.1800 jon@colearchitects.net	ARCHITECT DESIGN CONSULTANT TCA ARCHITECTURE • PLANNING 6211 ROOSEVELT WAY NE SEATTLE, WA 98115 BRIAN HARRIS 206.522.3830 EXT 101 brian@tca-inc.com	CIVIL & LANDSCAPE BRECKON LAND DESIGN 181 WEST 50TH ST BOISE, ID 83711 JON BRECKON 208.376.5153 jbreckon@breconld.com	STRUCTURAL KPFF 412 PARKCENTER BLVD BOISE, ID 83706 JORDAN TERRY 208.336.9511 jterry@kpff-id.com	MECHANICAL/ELECTRICAL/PLUMBING MUSGROVE ENGINEERING, INC. 234 S. WHISPERWOOD WAY BOISE, ID 83709 CHARLES PAULIN 208.384.0535 (1) charlesp@musgrovepa.com THAD MASON 208.384.0535 (303) thadm@musgrovepa.com	CONTRACTOR ENGINEERED STRUCTURES INCORPORATED 3330 E. LOUISE DR. STE 300 MERIDIAN, ID 83642 DUSTON HILGERT 208.362.3040 dustinhilgert@esiconstruction.com
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02.02.16 | DEMOLITION SET

ABBREVIATIONS:	
ABBREVIATION	DESCRIPTION
AB	ANCHOR BOLT
ABF	ABOVE FINISH FLOOR
ALUM	ALUMINUM
APPROX	APPROXIMATELY
BOARD	BOARD
BLDG	BUILDING
BM	BEAM
BOT	BOTTOM
BRG	BEARING
CJ	CONTROL/CONSTRUCTION JOINT
CLG	CEILING
CLR	CLEAR
CMU	CONCRETE MASONRY UNIT
COL	COLUMN
CONCRE	CONCRETE
CONN	CONNECTION
CONT	CONTINUOUS
CONTR	CONTRACTOR
CTR	CENTER
DBL	DOUBLE
DEMO	DEMOLITION
DIAM	DIAMETER
DIAG	DIAGONAL
DIM	DIMENSION
DOWN	DOWN
DWG	DRAWING
(E)	EXISTING
EA	EACH
ELEV	ELEVATION
EMB	EMBEDDED
EQ	EQUAL
EXP	EXPANSION
(F)	FUTURE
FB	FLAT BAR
FD	FLOOR DRAIN
FEI	FIRE EXTINGUISHER CABINET
FIN	FINISH
FLASH	FLASHING
FLR	FLOOR
FBR	FACE OF BRICK
FOF	FACE OF FOUNDATION
FACE	FACE OF MASONRY
FS	FACE OF STUD
FT	FOOT/FEET
GA	GALVE
GLV	GALVANIZED
GI	GALVANIZED IRON
GND	GROUND
GYP	GYP/SUM
H	HIGH
HB	HOSE BIB
HML	HOLLOW METAL or HERMAN MILLER
HORIZ	HORIZONTAL
HP	HIGH POINT
HR	HOUR
HS	HIGH STRENGTH
HT	HEIGHT
ID	INSIDE DIAMETER
INSUL	INSULATION
JT	JOINT
LG	LONG
LLV	LONG LEG VERTICAL
MAX	MAXIMUM
MB	MACHINE BOLT
MECH	MECHANICAL
MET	METAL
MFR	MANUFACTURER
MIN	MINIMUM
MO	MASONRY OPENING
(N)	NEW
NIC	NOT IN CONTRACT
NO	NUMBER
NTS	NOT TO SCALE
OC	ON CENTER
OD	OUTSIDE DIAMETER
OP	OPPOSITE HAND
OPNG	OPENING
OPP	OPPOSITE
PL	PLATE
PROJ	PROJECTION
PT	POINT
R	RISER
(R)	REL OCATED
RAD	RADIUS
RD	ROOF DRAIN
REF	REFERENCE
REIN	REINFORCEMENT, REINFORCED
REQ	REQUIREMENT
RO	ROUGH OPENING
RAW	RAW WATER CONDUCTOR OR DOWNSPOUT
SECT	SECTION
SM	SIMILAR
SHT	SHEET
SPEC	SPECIFICATION
SQ	SQUARE
STD	STANDARD
STL	STEEL
STRL	STRUCTURAL
TEL	TELEPHONE
TOP	TOP OF
TOC	TOP OF CURB
TOJ	TOP OF JOIST
TOF	TOP OF STEEL
TOW	TOP OF WALL
TY	TYPICAL
UNO	UNLESS NOTED OTHERWISE
VCT	VCT COMPOSITION TILE
VERT	VERTICAL
W	WIDE
WI	WITH
WO	WOOD
WO	WIDTH OF OPENING
WP	WEATHERPROOF
WS	WOOD SCREEN
WS	WORKSURFACE
WT	WEIGHT
WWF	WELDED WIRE FABRIC


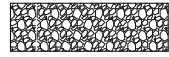


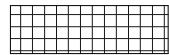
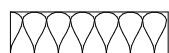
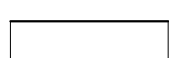
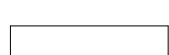


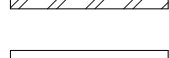
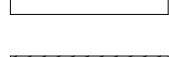


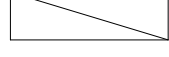
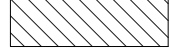
ARCHITECTURAL SYMBOLS



	COLUMN GRID LINE (EXISTING - HALFTONE)
	COLUMN GRID LINE (NEW)
	CENTER LINE
	DIMENSION LINE TO FACE OF STUD, FACE OF CONCRETE, COLUMN LINE, OR AS NOTED.
	ROOM TAG ROOM NAME ROOM NUMBER AREA OR VOLUME
	WALL TYPE TAG
	WINDOW TAG
	DRAWING REVISION
	KEYNOTE
	NORTH ARROW
	LEVEL DATUM LEVEL NAME LEVEL ELEVATION
	SPOT ELEVATION
	DETAIL - SECTION POSITION ON SHEET SHEET NUMBER
	DETAIL - PLAN POSITION ON SHEET SHEET NUMBER
	BUILDING SECTION POSITION ON SHEET SHEET NUMBER
	WALL SECTION POSITION ON SHEET SHEET NUMBER
	EXTERIOR ELEVATION POSITION ON SHEET SHEET NUMBER
	INTERIOR ELEVATION POSITION ON SHEET SHEET NUMBER
	VIEW TITLE DRAWING NUMBER DRAWING SCALE 1/8" = 1'-0"

GENERAL PROJECT NOTES:

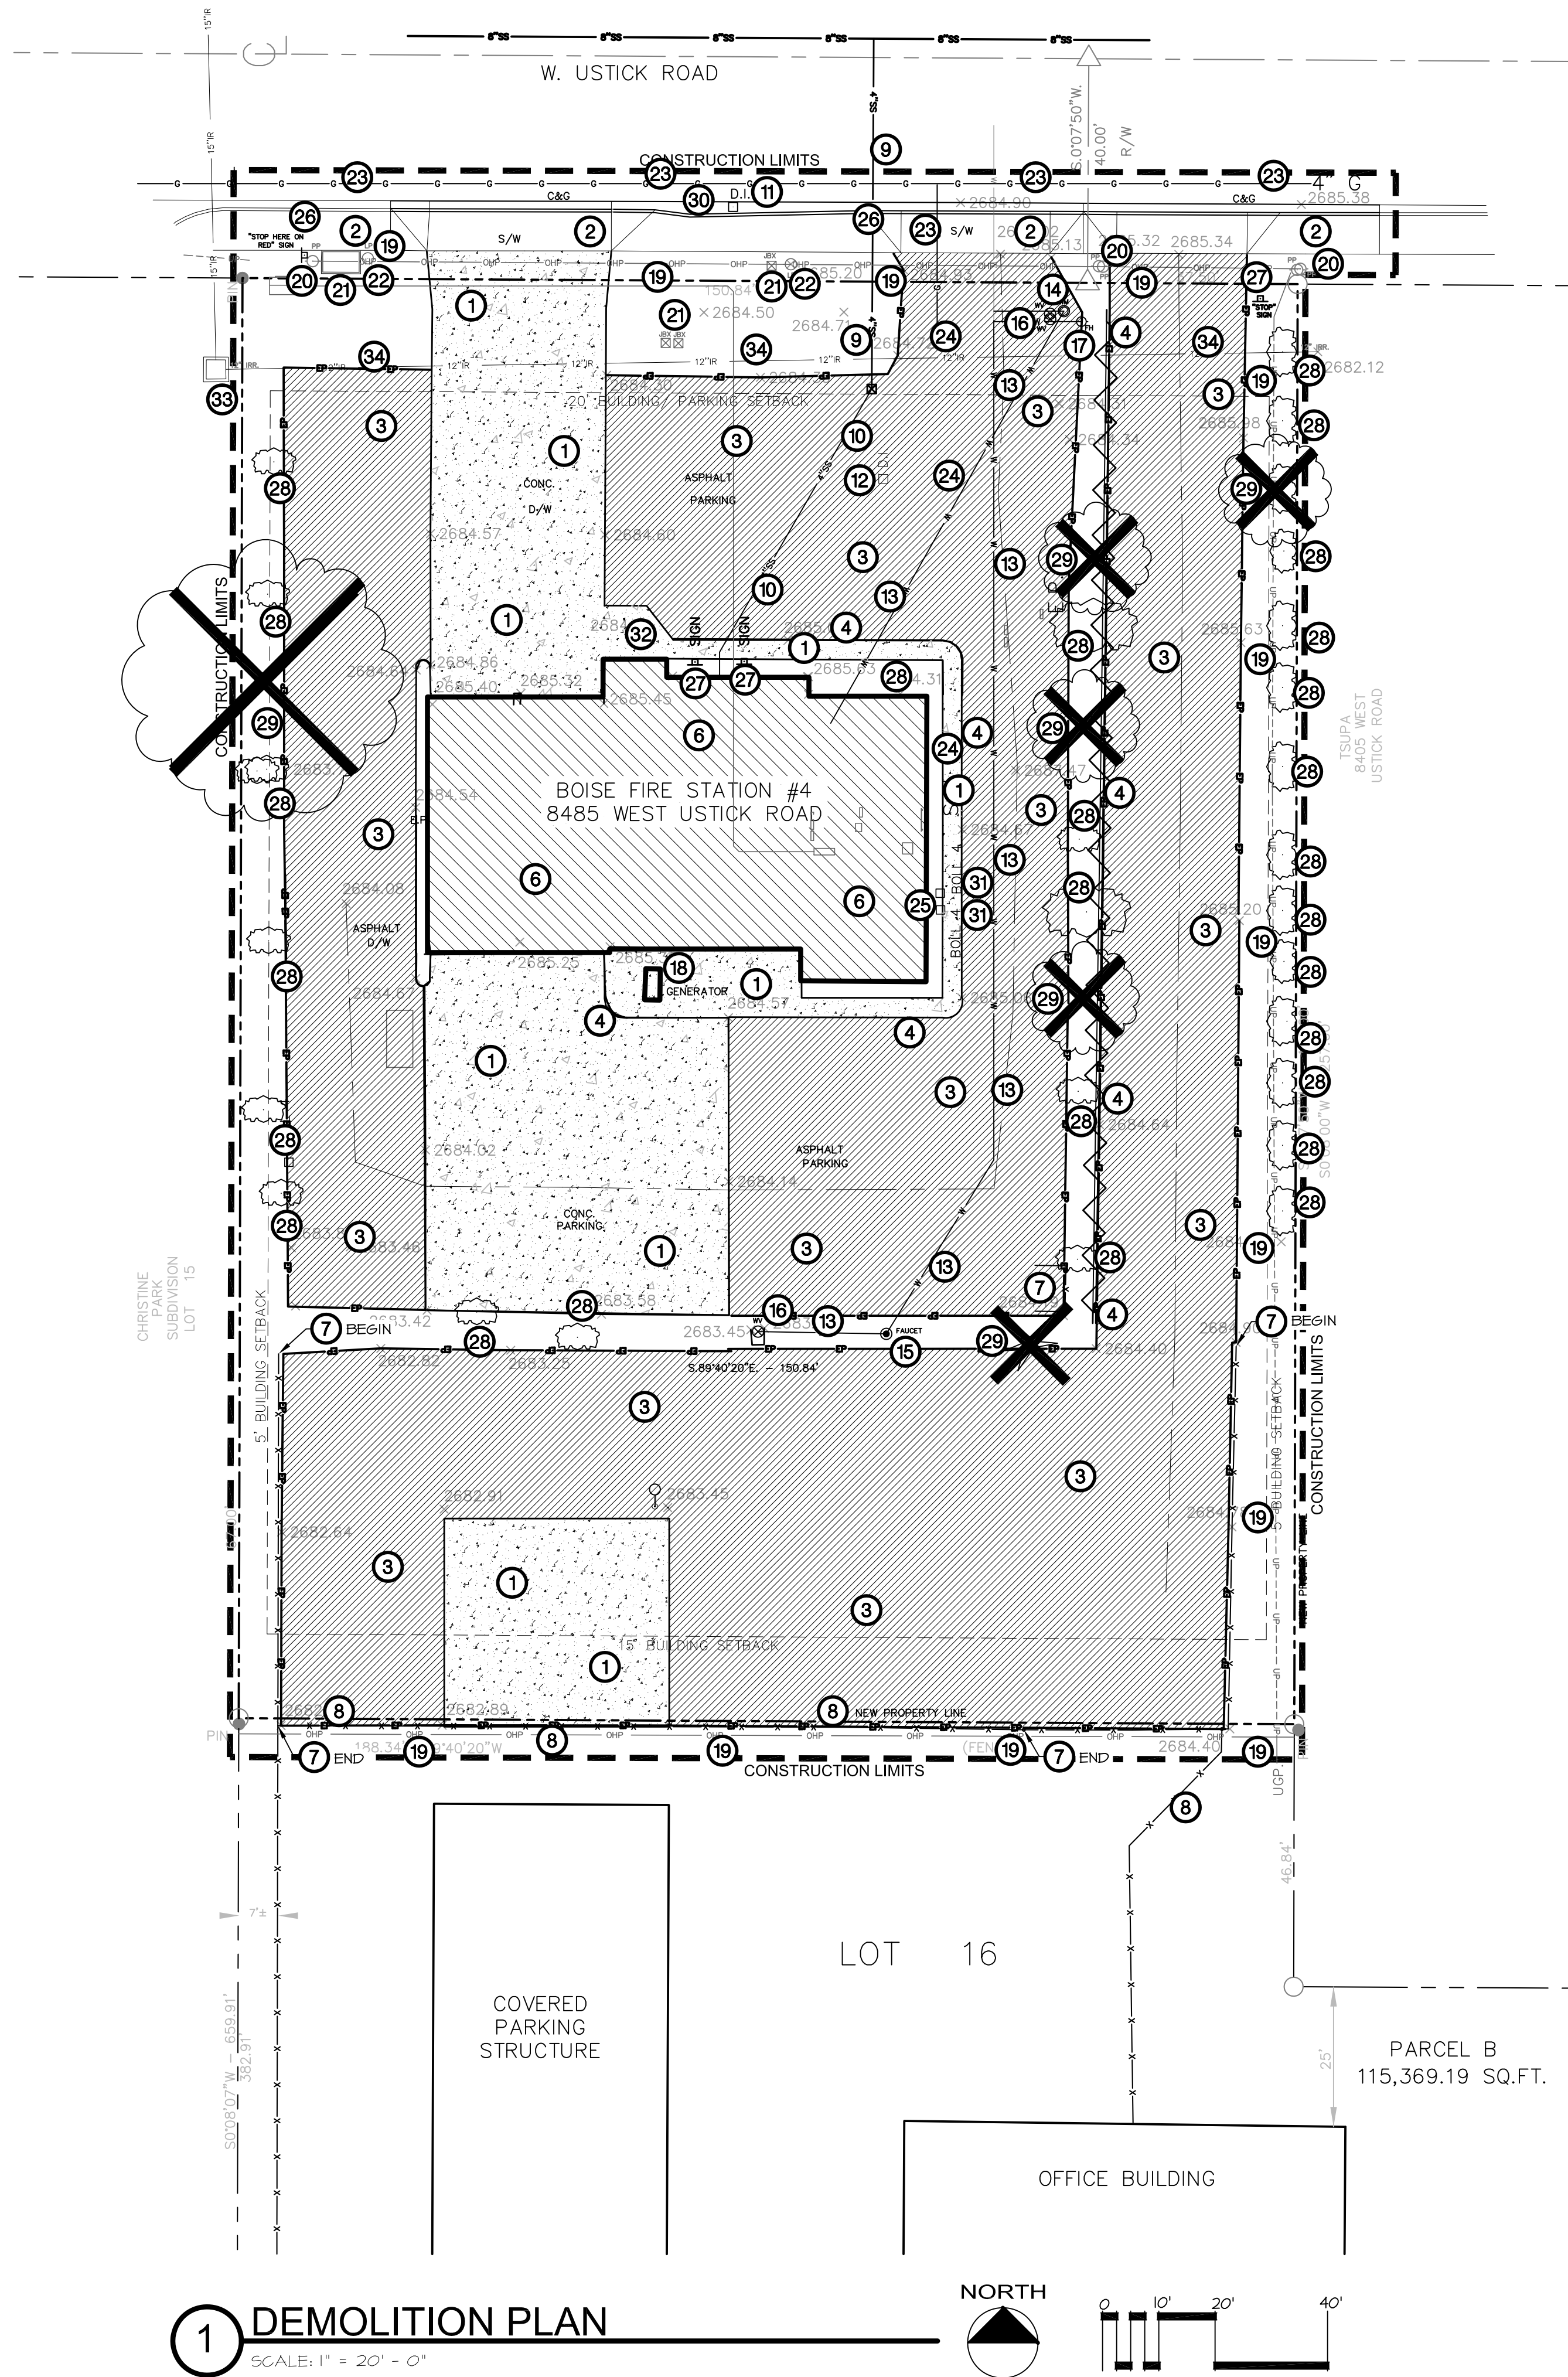
- A. GENERAL PROJECT NOTES APPLY TO ALL SHEETS & SPECIFICATIONS. CONTRACTOR AND SUB-CONTRACTORS ARE TO REVIEW ALL CONTRACT DOCUMENTS AND COORDINATE THEIR SCOPE OF WORK WITH THE GENERAL CONTRACTOR AND OTHER SUB-CONTRACTORS. INFORMATION COMMON TO SEVERAL DRAWINGS MAY BE NOTED ON ONLY ONE. CONTRACTOR IS RESPONSIBLE FOR ENTIRE SET OF DOCUMENTS.
- B. IF INFORMATION ON SEPARATE SHEETS OR DETAILS INDICATE CONFLICTING INFORMATION OR QUESTIONS ABOUT THE SCOPE OF WORK OR DESIGN INTENT, THE CONTRACTOR IS TO NOTIFY THE ARCHITECT IMMEDIATELY BEFORE BIDS ARE FINALIZED TO CLARIFY SCOPE OF WORK. IF THE SCOPE OF WORK REMAINS UNCLEAR THEN THE CONTRACTOR OR SUB-CONTRACTOR IS INSTRUCTED TO PRICE AND PROVIDE THE MOST EXPENSIVE SCOPE OF WORK OPTION IN THEIR BID.
- C. WHERE CONFLICTING DIRECTION IS GIVEN WITHIN THE SPECIFICATIONS AND DRAWINGS THE CONTRACTOR IS TO NOTIFY THE ARCHITECT IMMEDIATELY BEFORE BIDS ARE FINALIZED TO CLARIFY SCOPE OF WORK. IF THE SCOPE OF WORK REMAINS UNCLEAR THEN THE CONTRACTOR OR SUB-CONTRACTOR IS INSTRUCTED TO PRICE AND PROVIDED THE MOST EXPENSIVE SCOPE OF WORK OPTION IN THEIR BID.
- D. COORDINATE CONSTRUCTION ACTIVITY WITH PROJECT SPECIFICATIONS. ALL SPECIFICATIONS, REFERENCED IN DRAWINGS OR NOT, SHALL BE PART THIS PROJECTS SCOPE OF WORK. MISNUMBERED (OR MISLABELED) SPECIFICATIONS OR REFERENCES ARE ALSO PART OF THIS PROJECTS SCOPE OF WORK AND SHALL BE BROUGHT TO THE ATTENTION OF THE ARCHITECT. THE CONTRACTOR IS RESPONSIBLE TO INCORPORATE ALL SPECIFICATIONS INTO THE PROJECTS SCOPE OF WORK.
- E. WHEN APPLICABLE, PROTECT ITEMS THAT ARE TO BE SALVAGED TO THE OWNER. THESE INCLUDE BUT NOT LIMITED TO: WINDOWS, FRAMES, LIGHT FIXTURES, CEILING COMPONENTS, EQUIPMENT, MILLWORK, FIRE EXTINGUISHERS, CABINETS, AND CARPET. COORDINATE LOCATION AND TIME OF DELIVERY OF ITEMS TO BE RETURNED WITH THE OWNER.
- F. DO NOT SCALE DRAWINGS. IF SPECIFIC DIMENSIONS ARE NEEDED CONSULT ARCHITECT.
- G. FIGURED DIMENSIONS TAKE PRECEDENCE OVER SCALED DRAWINGS. WHERE DISCREPANCIES OCCUR, THEY SHALL BE REPORTED TO ARCHITECT FOR RESOLUTION.
- H. DETAILED DRAWINGS AND LARGER SCALE DRAWINGS TAKE PRECEDENCE OVER SMALLER SCALE DRAWINGS.
- I. THE DRAWINGS INDICATE LOCATION, DIMENSIONS, REFERENCE, AND TYPICAL DETAILS OF CONSTRUCTION. THE DRAWINGS DO NOT INDICATE EVERY CONDITION. WORK THAT IS NOT SPECIFICALLY DETAILED SHALL BE OF CONSTRUCTION SIMILAR TO PARTS THAT ARE DETAILED.
- J. SUBCONTRACTORS FOR EACH TRADE ARE ADVISED THAT INFORMATION PERTINENT TO THEIR WORK MAY OCCUR IN OTHER PORTIONS OF THE CONTRACT DOCUMENTS. ALL NOTES ARE TO BE REVIEWED AND APPLIED TO RELATED BUILDING DOCUMENTS.
- K. WHERE NO MATERIAL NOTES OCCUR, THE GRAPHIC MATERIAL INDICATION SHALL INDICATE MATERIAL TYPES AND ITEMS. SEE SYMBOL AND MATERIALS LIST ON THIS SHEET.
- L. THE U. S. ENVIRONMENTAL PROTECTION AGENCY MUST BE NOTIFIED 10 WORKING DAYS IN ADVANCE FOR ALL RENOVATIONS THAT DISTURBS 260 L.F., 160 SQ. FT., 35 CU. FT. OF ASBESTOS CONTAINING MATERIALS.
- M. UNLESS OTHERWISE INDICATED ALL DRAWINGS, NOTES WHICH DO NOT READ "N.I.C." "EXISTING" OR "EXISTING TO REMAIN" OR "BY OTHERS" SHALL INDICATE NEW WORK WHICH SHALL BE CONTRACTOR FURNISHED AND CONTRACTOR INSTALLED.
- N. THE CONTRACTOR(S) SHALL KEEP ALL AREAS OF CONSTRUCTION CLEAN AND FREE OF DEBRIS. AFTER CONSTRUCTION IS COMPLETE, THE GENERAL CONTRACTOR SHALL PROVIDE FINAL CLEAN UP. ENFORCE REQUIREMENTS STRICTLY. DISPOSE OF MATERIALS LAWFULLY.
- O. THE CONTRACTOR SHALL VERIFY ALL EXISTING CONDITIONS AND DIMENSIONS FOR ACCURACY PRIOR TO COMMENCING WITH THE WORK. ANY DISCREPANCY SHALL BE BROUGHT TO THE ATTENTION OF THE ARCHITECT.
- P. FIELD MEASUREMENTS: TAKE FIELD MEASUREMENTS AS REQUIRED TO FIT THE WORK CORRECTLY. RECHECK MEASUREMENTS BEFORE INSTALLING EACH PRODUCT. WHERE PORTIONS OF THE WORK ARE INDICATED TO FIT TO OTHER CONSTRUCTION, VERIFY DIMENSIONS OF OTHER CONSTRUCTION BY FIELD MEASUREMENTS BEFORE FABRICATION. COORDINATE FABRICATION SCHEDULE WITH CONSTRUCTION PROGRESS TO AVOID DELAYING THE WORK.
- Q. COORDINATE STRUCTURAL, MECHANICAL, ELECTRICAL, AND FIRE PROTECTION REQUIREMENTS, ROUTING, AND FIELD VERIFY.
- R. WHERE NEW CONSTRUCTION JOINS WITH EXISTING CONSTRUCTION, ALIGN FINISHED SURFACE OF NEW CONSTRUCTION WITH EXISTING CONSTRUCTION.
- S. ALL CONSTRUCTION ADDENDA, CHANGE ORDERS, OR DESIGN CLARIFICATIONS TO THOSE ITEMS REGULATED BY THE CODES MUST BE SUBMITTED TO THE FIELD INSPECTOR FOR REVIEW AND APPROVAL PRIOR TO COMMENCING WITH ANY OF THE PROPOSED WORK RELATED TO THE PROPOSED FIELD CHANGE.
- T. EXAMINATION AND ACCEPTANCE OF CONDITIONS: BEFORE PROCEEDING WITH EACH COMPONENT OF THE WORK, EXAMINE SUBSTRATES, AREAS, AND CONDITIONS WITH INSTALLER OR APPLICATOR PRESENT WHERE INDICATED, FOR COMPLIANCE WITH REQUIREMENTS FOR INSTALLATION TOLERANCES AND OTHER CONDITIONS AFFECTING PERFORMANCE. RECORD OBSERVATIONS.
- U. PROCEED WITH INSTALLATION ONLY AFTER UNSATISFACTORY CONDITIONS HAVE BEEN CORRECTED. PROCEEDING WITH THE WORK INDICATES ACCEPTANCE OF SURFACES AND CONDITIONS.

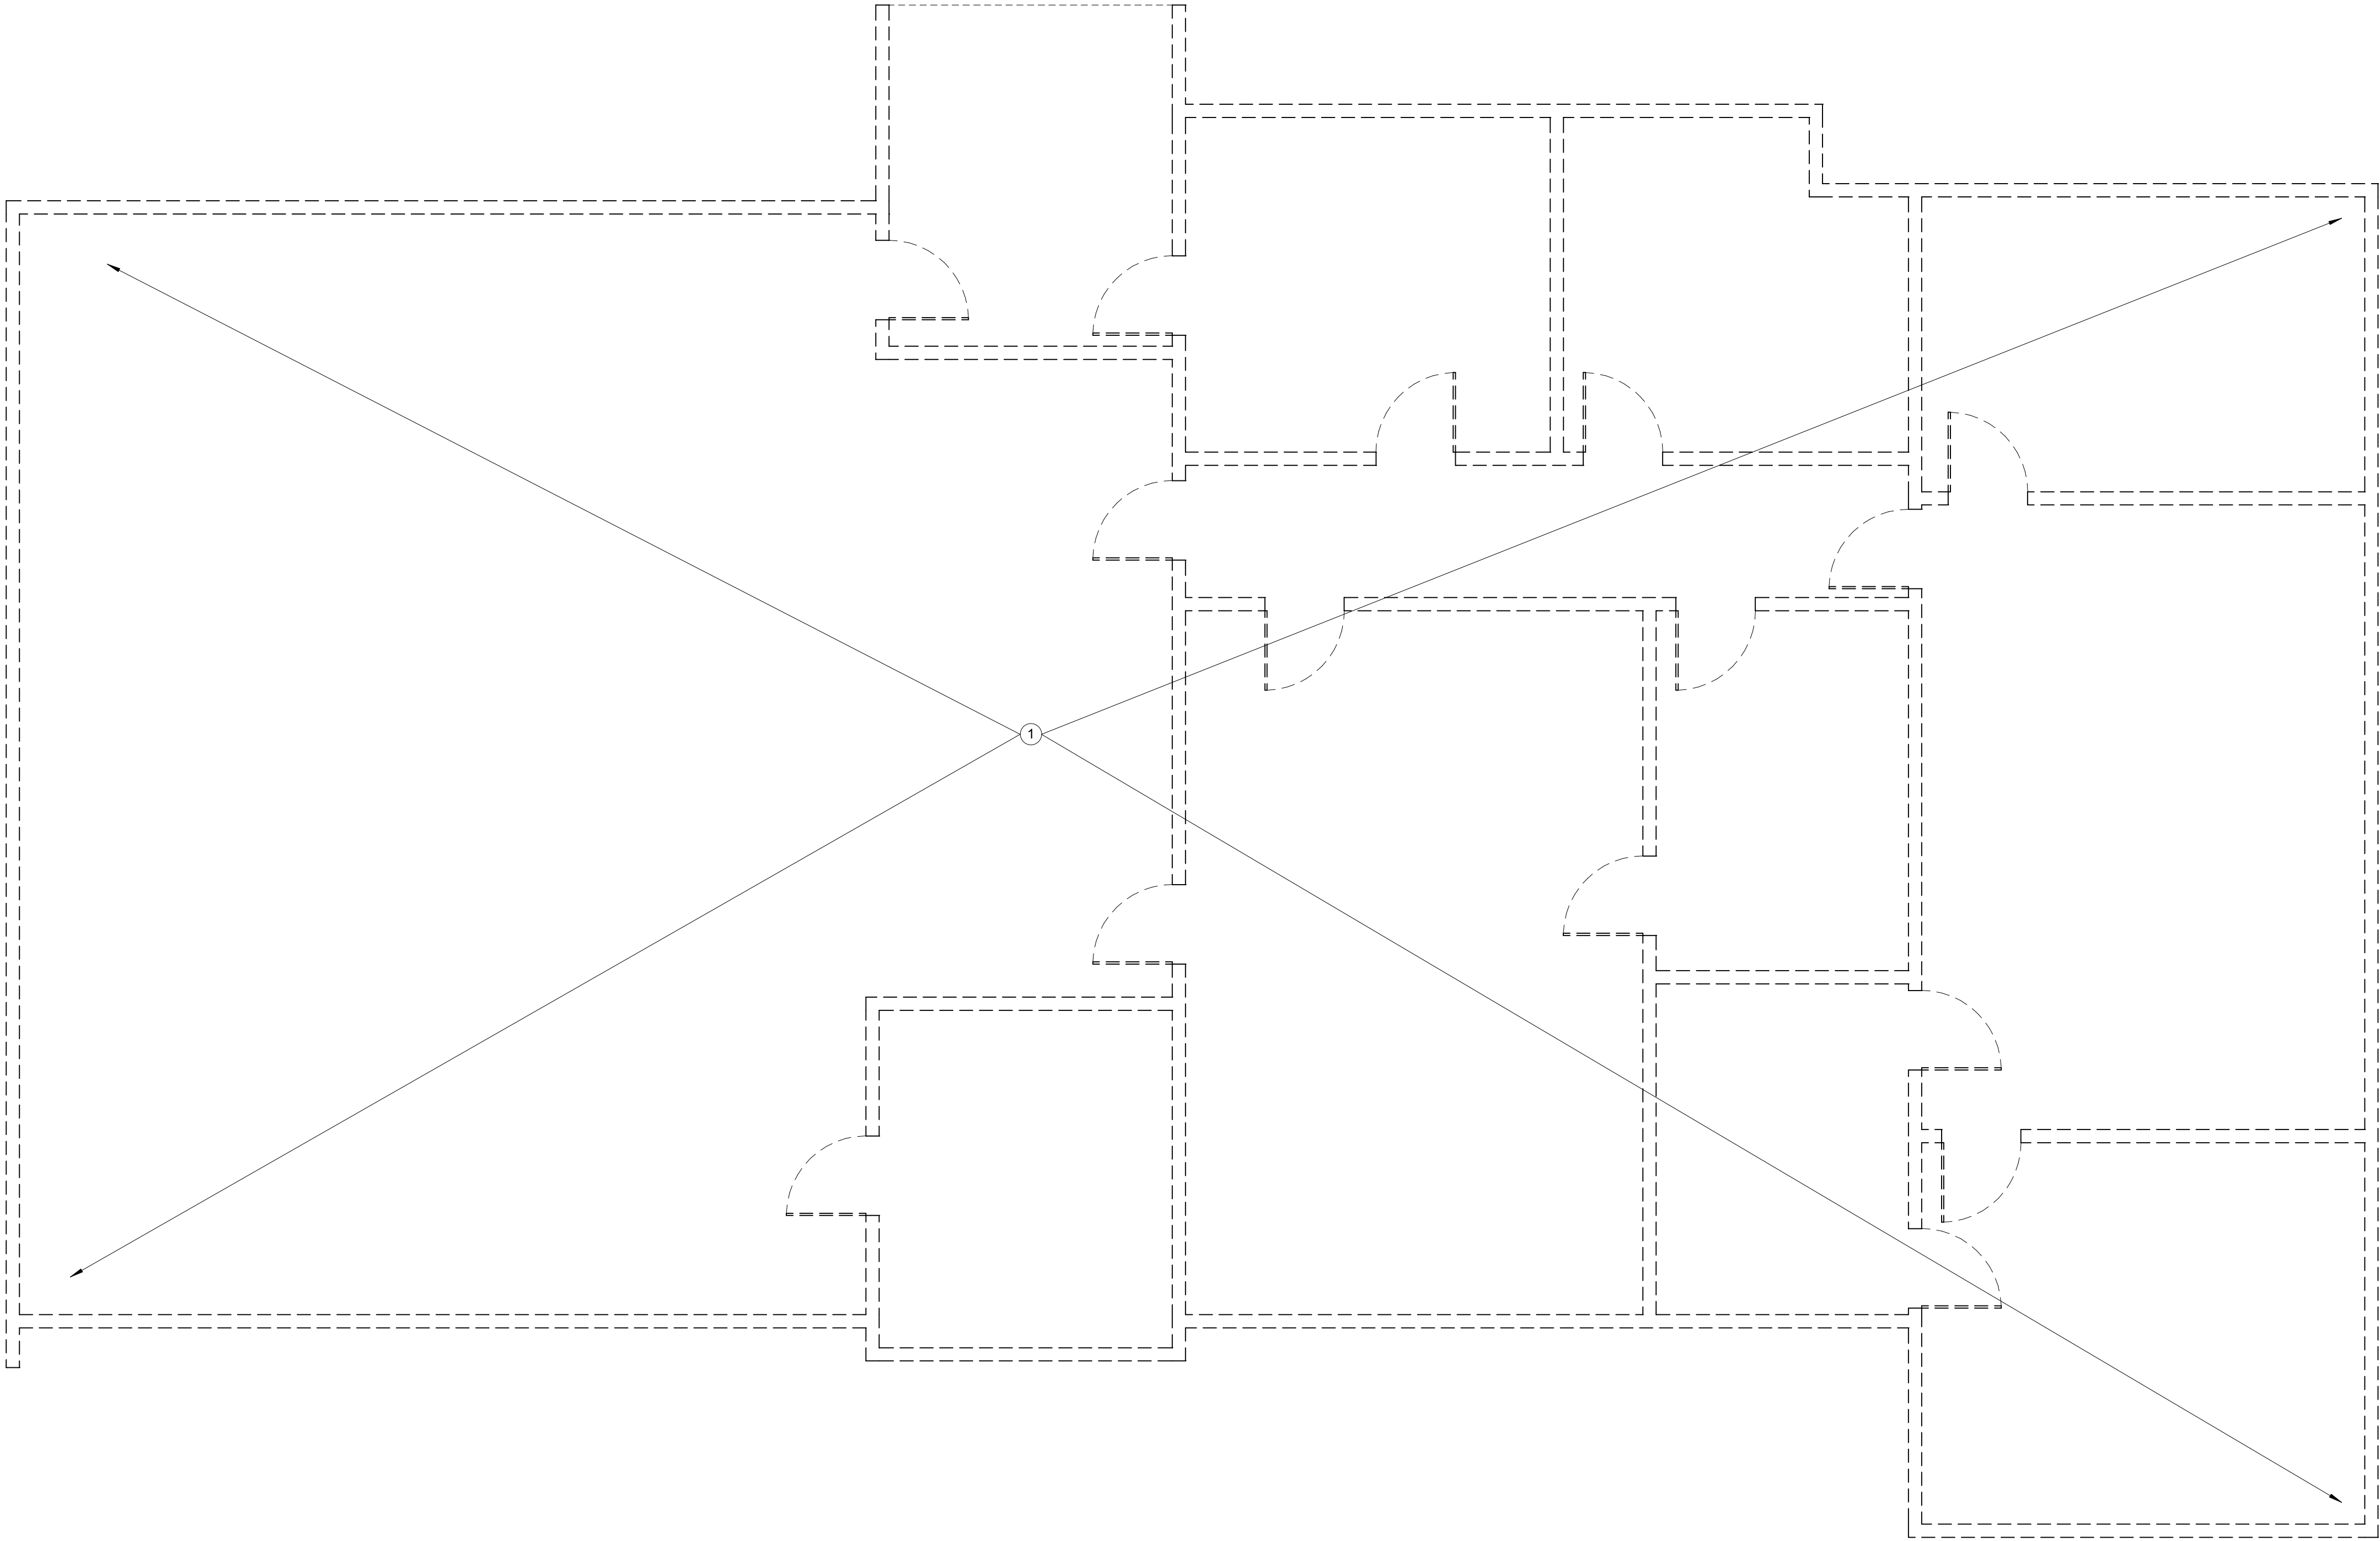
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<u>ADDRESS:</u> 8485 W USTICK RD	
<u>PROPERTY DESCRIPTION:</u> PAR #3794 OF N'LY POR LOT 16 SUBURBAN HOME SUB	
POR PARCEL A R/S 9355 #3793-S	
<u>PARCEL NUMBER:</u> R8207003794	
<u>LOT SIZE:</u> 453 ACRES	
<u>NUMBER OF STORIES:</u> 1 STORY	
<u>SQUARE FOOTAGE:</u> 4,020 SF	
<u>CONSTRUCTION TYPE:</u> VB	
<u>LAND USE CODE:</u> R-1C	

<h2 style="margin: 0;">MATERIAL LEGEND:</h2>	
	CONCRETE (SECTION)
	GRANULAR FILL
	CONCRETE MASONRY UNITS
	BRICK
	RIGID INSULATION (SECTION)
	ACOUSTIC/THERMAL INSULATION (SECTION)
	STUD WALL (PLAN & SECTION)
	EXISTING WALL TO REMAIN (PLAN & SECTION)
	DEMO WALL (PLAN & SECTION)
	STEEL (SECTION)
	ALUMINUM (SECTION)
	WOOD - FINISH (SECTION)
	DIMENSIONAL LUMBER CONTINUOUS (SECTION)
	DIMENSIONAL LUMBER BLOCKING (SECTION)
	LUMBER - FINISH (SECTION)
	EARTHWORK (SECTION)

ARCHITECT:		
<div>COLE ARCHITECTS</div> <div>COLE ARCHITECTS 802 W. BANNOCK SUIT 208 Boise, ID 83702 (208) 345-1800</div> <div>TCA</div> <div>architecture • planning</div> <div>TCA 6211 Roosevelt Way NE Seattle, WA 98115 (206) 522-3820</div>		
STAMP:		
<div>LICENSED ARCHITECT AR-1726</div> <div>Stanley A. Cole STATE OF IDAHO</div>		
CONSULTANT:		
PROJECT INFORMATION:		
<div></div> <div>City of Boise Fire Station 4</div> <div>8485 W Ustick Rd, Boise, ID 83704</div>		
REVISIONS:		
MARK	DATE	DESCRIPTION
PROJECT PHASE	DEMOLITION SET	
PROJECT NUMBER	15-27	
PROJECT MANAGER	J. Chatfield	
PROJECT ARCHITECT	J. Chatfield	
DESIGN	J. Chatfield	
DRAWN BY	J. Chatfield, C. Clay, R. Stewart	
SHEET NAME:		
SHEET LEGEND & PROJECT INFORMATION		
SHEET NUMBER:		
G001		
02.02.16		

S:\projects\2015\15043 Boise Fire #4\CA015043 D11.dwg plotted by user01 on Mon, February 1 2016 at 09:33 AM





1 1ST FLOOR DEMOLITION PLAN
1/4" = 1'-0"



GENERAL NOTES FLOOR PLAN:

- A. DASHED BOLD LINE INDICATE EXTENT OF DEMOLITION, INCLUDING THE FOLLOWING:
* ALL EXISTING ELEMENTS ON SITE ARE TO BE DEMOLISHED AND REMOVED FROM SITE, U.N.O. EXTENT PER CIVIL SHEETS.
- B. ALL LIGHTWEIGHT LINES INDICATE EXISTING TO REMAIN. IF SCOPE OF WORK IS NOT CLEAR CONSULT ARCHITECT BEFORE PROCEEDING WITH WORK.
- C. COORDINATE DEMOLITION SCOPE OF WORK WITH REQUIREMENTS FOR NEW WORK. REPAIR ALL INCIDENTAL DAMAGE DONE TO SURROUNDING AREAS THAT DEMOLITION WAS NOT REQUIRED.
- D. WHEN APPLICABLE, COORDINATE DEMOLITION SCHEDULE AND TIMES WITH OWNER AND OCCUPANTS BEFORE PROCEEDING WITH CONSTRUCTION.
- E. REFERENCE SPECIFICATIONS SECTIONS FOR CUTTING, PATCHING, AND DEMOLITION REQUIREMENTS.
- F. CONTRACTOR SHALL FIELD VERIFY ALL EXISTING CONDITIONS. ALL DISCREPANCIES TO BE BROUGHT TO THE ATTENTION OF THE ARCHITEC PRIOR TO PROCEEDING.
- G. COORDINATE REMOVAL OF FURNITURE AND EXISTING EQUIPMENT WITH OWNER.
- H. IF ASBESTOS CONTAINING MATERIAL IS SUSPECTED OR ENCOUNTERED, HALT WORK AND NOTIFY ARCHITECT IMMEDIATELY FOR FURTHER DIRECTION.
- I. CONTRACTOR TO COORDINATE WITH OWNER ALL ITEMS TO BE DEMOLISHED AND TO BE SALVAGED. ITEMS BEING SALVAGED TO BE TURNED OVER TO OWNER. SEE SPECIFICATIONS FOR ADDITIONAL SALVAGE REQUIREMENTS.
- J. FOR ADDITIONAL DEMOLITION SCOPE OF WORK NOT SHOWN ON THIS SHEET, COORDINATE WITH/AND REFERENCE CIVIL SHEETS.
- K. COORDINATE DEMOLITION SCOPE OF WORK WITH PLANS FOR NEW WORK.

DEMOLISH WALL SYMBOLS:

SYMBOL:	DESCRIPTION:
	DEMOLISH CONSTRUCTION

KEY NOTES: #

1. DEMOLISH BUILDING IN ENTIRETY. THIS INCLUDES BUT IS NOT LIMITED TO WALLS, ROOF, CEILINGS, SLABS, FOOTINGS, AND MECHANICAL, ELECTRICAL, AND PLUMBING SYSTEMS. COORDINATE WITH ALL DISCIPLINES' DEMOLITION PLANS. PREPARE FINAL MATERIALS GRADES TO ACCOMMODATE NEW CONSTRUCTION, RE: CIVIL.

ARCHITECT:

COLE ARCHITECTS

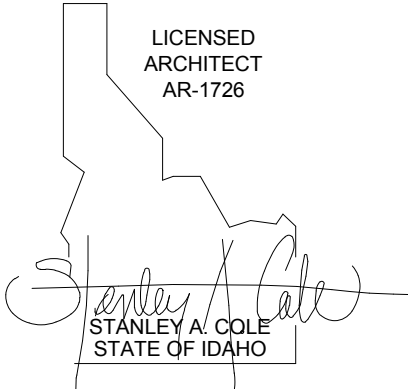
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Boise, ID 83702 | (208) 345-1800

T C A

architecture • planning

TCA | 6211 Roosevelt Way NE
Seattle, WA 98115 | (206) 522-3820

STAMP:



CONSULTANT:

PROJECT INFORMATION:



City of Boise Fire Station 4

8485 W Ustick Rd, Boise, ID 83704

REVISIONS:

MARK	DATE	DESCRIPTION
------	------	-------------

PROJECT PHASE DEMOLITION SET

PROJECT NUMBER 15-27

PROJECT MANAGER J. Chatfield

PROJECT ARCHITECT J. Chatfield

DESIGN J. Chatfield

DRAWN BY J. Chatfield, C. Clay, R. Stewart

SHEET NAME:

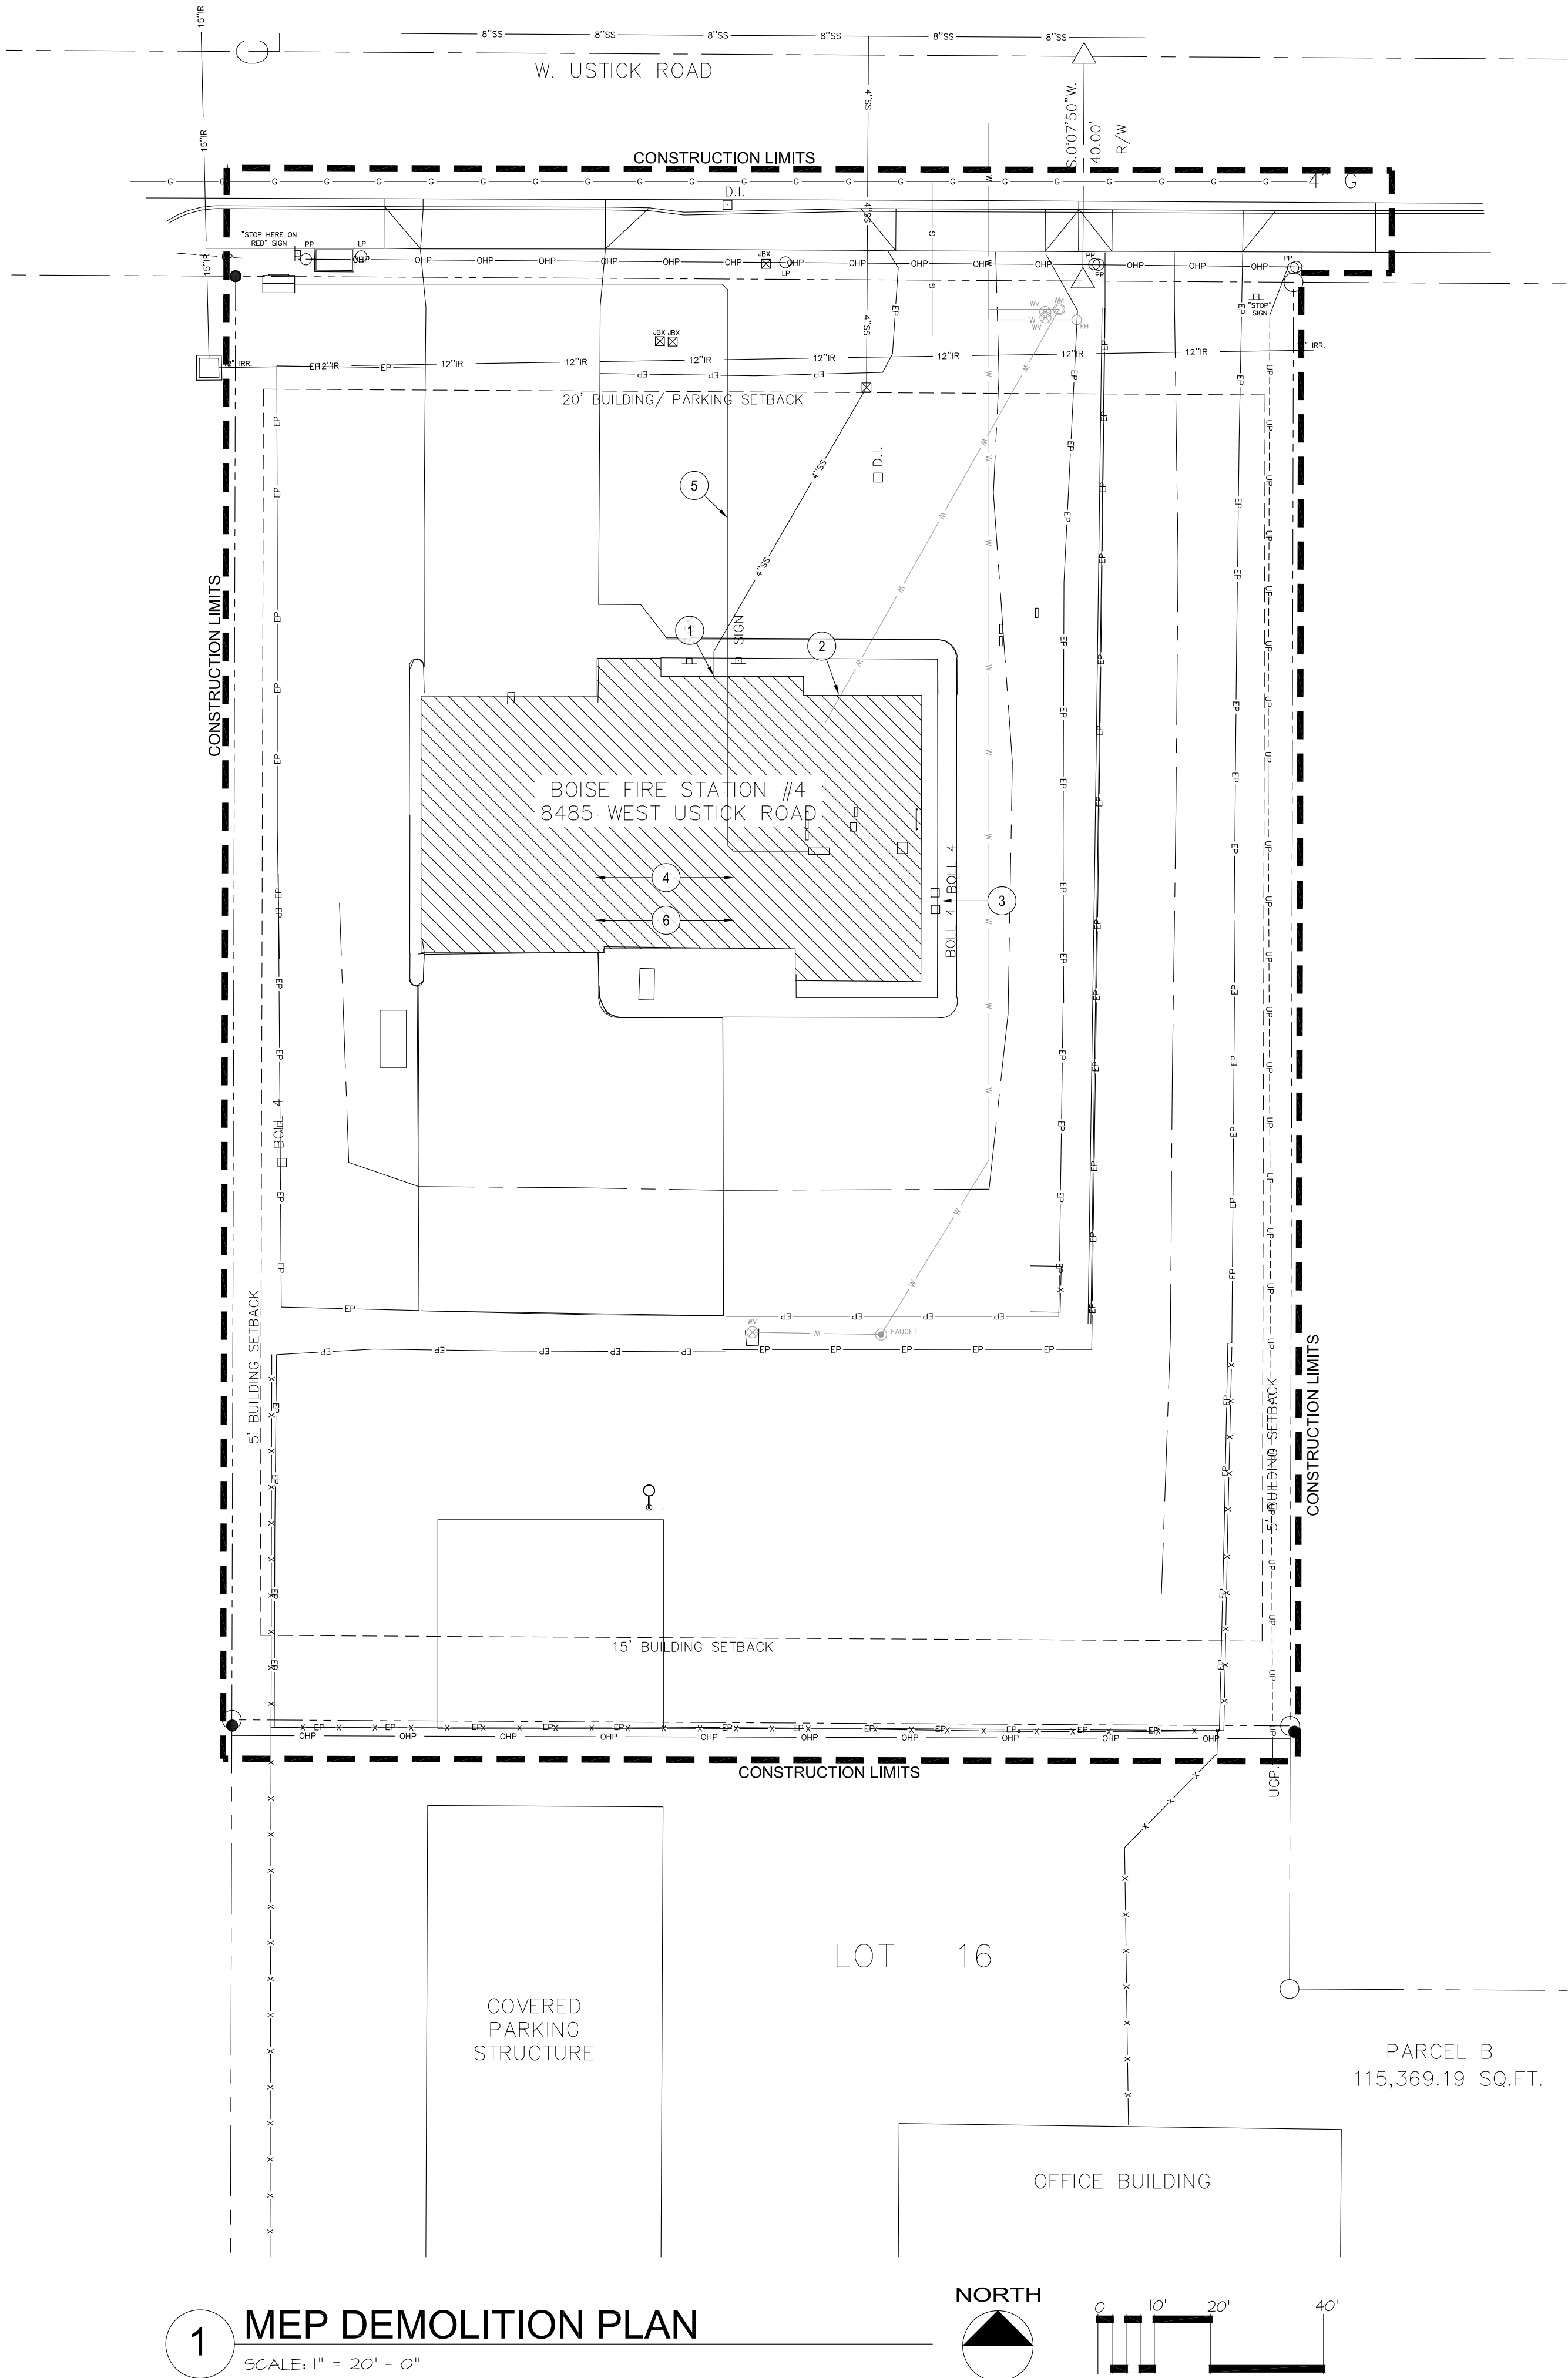
1ST FLOOR
DEMOLITION PLAN

SHEET NUMBER:

A200

02.02.16

P:\Files\2015\1506\1WORKING MEP\15061_MEP Demo Planning plotted by laurar on Mon, February 1 2016 at 05:32 PM



KEYED NOTES:

- # SYMBOL USED FOR NOTE CALLOUT.
1. REMOVE ALL EXISTING SANITARY SEWER AND VENT PIPING SYSTEMS WITHIN BUILDING. COORDINATE WITH CIVIL PLANS FOR SITE UTILITY WORK.
 2. REMOVE ALL EXISTING DOMESTIC WATER PIPING SYSTEMS WITHIN BUILDING. COORDINATE WITH CIVIL PLANS FOR SITE UTILITY WORK.
 3. REMOVE EXISTING GAS METER AND ALL EXISTING GAS PIPING SYSTEMS WITHIN BUILDING. COORDINATE WITH CIVIL PLANS FOR SITE UTILITY WORK.
 4. REMOVE ALL EXISTING MECHANICAL EQUIPMENT, ASSOCIATED DUCTWORK, PIPING, CONTROLS, ETC. AS REQUIRED.
 5. REMOVE EXISTING UNDERGROUND SECONDARY, REMOVE CONDUIT, CONDUCTORS, JUNCTION BOXES, PANELS AND RELATED ITEMS.
 6. REMOVE ALL EXISTING ELECTRICAL EQUIPMENT, PANELS, CONDUIT, CONDUCTORS, CABLING, DEVICES AND RELATED ITEMS, ECT. AS REQUIRED.

ARCHITECT:

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Boise, ID 83702 | (208) 345-1800

TCA

architecture • planning

TCA | 6211 Roosevelt Way NE
Seattle, WA 98115 | (206) 522-3820

STAMP:

PRELIMINARY

NOT FOR CONSTRUCTION
2/1/16

CONSULTANT:

MUSGROVE
ENGINEERING, P.A.
234 S. Whisperwood Way
Boise, Idaho 83709
208.384.0585
www.musgrovepa.com
OVER 30 YEARS OF EXCELLENCE
project number: 15-061

PROJECT INFORMATION:

City of Boise Fire Station 4
8485 W. Ustick Rd. Boise, ID 83704

REVISIONS:

MARK	DATE	DESCRIPTION
------	------	-------------

PROJECT PHASE	Project Status
PROJECT NUMBER	15043
PROJECT MANAGER	J. Chatfield
PROJECT ARCHITECT	J. Chatfield
DESIGN	CP
DRAWN BY	LR

SHEET NAME:

MEP DEMOLITION
PLAN

SHEET NUMBER:

MEP000

02.01.16