






**SECTIONAL ELEVATION OF (R/S) APRON AND WING WALL
(SECTION C-C)**

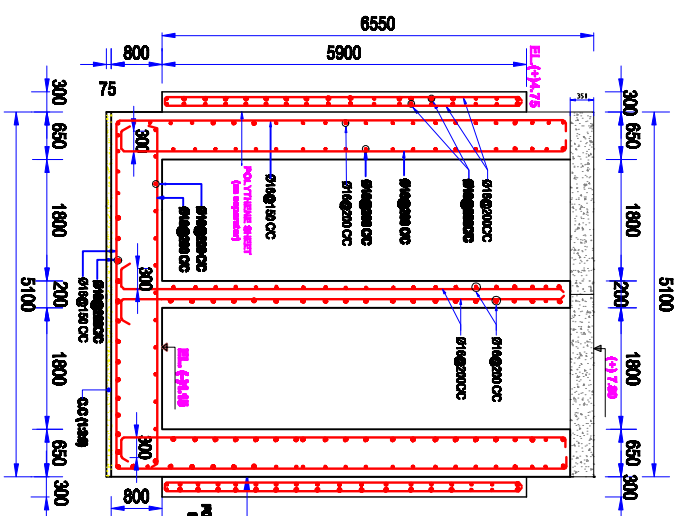

**SECTION R₁-R₁ (VALID FOR 450 LENGTH IN EXTENDED PORTION OF BARREL)
(FOUNDATION TREATMENT SHOWN IN SHEET NO. 21, 22 & 23 of 21)**

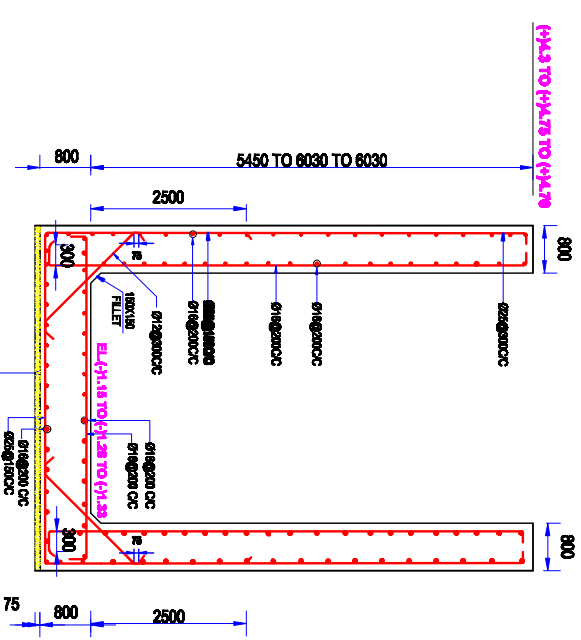

**SECTION R-R (VALD FOR 1000 LENGTH IN WING WALL PORTION)
FOUNDATION TREATMENT SHOWN IN SHEET NO 21, 22 & 23 OF 21)**

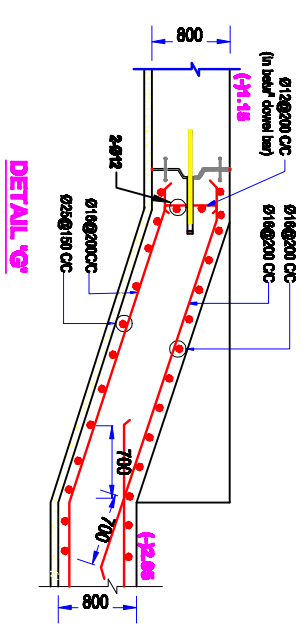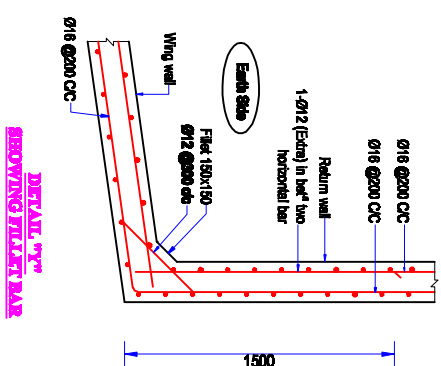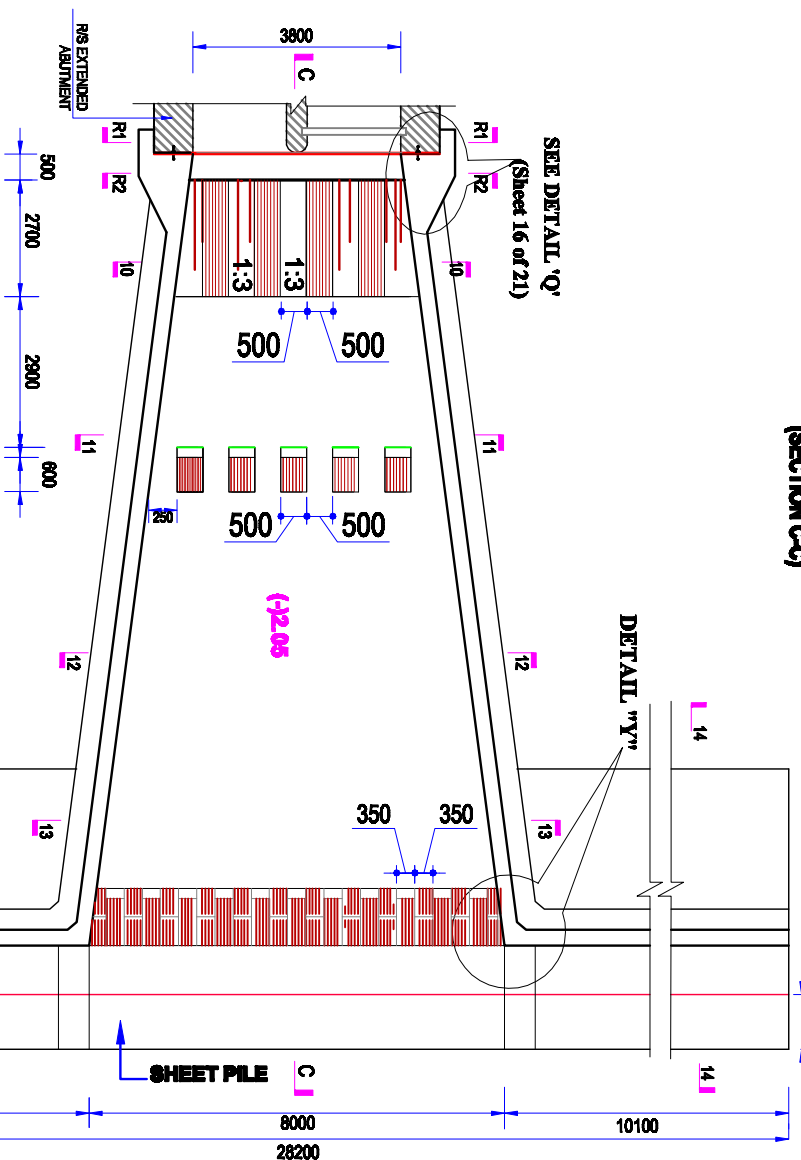

PLAN OF R/S APRON & RETURN WALL

Scale : Not To Scale

<p align="center">Bangladesh Water Development Board</p> <p align="center">Office of the Superintending Engineer</p> <p align="center">Design Circle-8</p>	
<p align="center">DESIGN OF DRAINAGE CUM FLOODING REGULATOR</p> <p align="center">2-VENUTY, 50mX1.80m) ON BAIBOSOT KHAL AT KM 13.00 IN POLDER NO-6(EXT) IN SATKHIRA DISTRICT, UNDER SATKHIRA O&M DIVISION-2, BWDB, SATKHIRA.</p>	
<p align="center">REINFORCEMENT DETAILS OF R/S APRON AND WING WALL</p>	
<p>DESIGNED BY :</p>	<p>APPROVED BY :</p>
<p>(ZAYED BIN SAIFY, AE</p>	
<p>CHECKED & RECOMMENDED BY :</p>	
<p>(JAKARIA PERVEZ, EE</p>	<p>(MOHAMMAD SAIF UDDIN), SE</p>
<p>DATE:</p>	<p>DWG. NO.:DC-8-0000-13/21</p>