

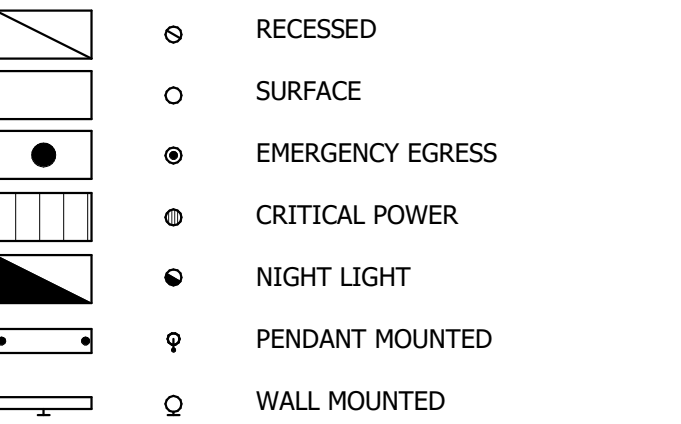


ELECTRICAL ABBREVIATIONS			
1P A, AMP AC ACLG ADO AFF AFG AFI AHU AL ALT AMP AMPL ANN APPX AQ-ST ATS AUTO AUX AV AWG BATT BD BLDG BMS C CAB CATV CB CCTV CKT CLG COMB CMPR CONN CONT CP CT CTR CU DEPT DIA DISC DN DPR DS DT DWG EC ELEC ELEV ELU EM EMS EMT EP EQUIP EWC EXIST EXH EXP FA FACP FCU FIXT FLR FLUOR FUDS GA GALV GC GEN GFI GFP GND GYP BD HMCPC HOA HORIZ HMCPC HP HT HTG HTR HV HVAC IG IMC INCA IR I/W J-BOX KAIC KV KVA KVAR KW KWH LOC LT LTG LTNG LV MAX MAG.S M/C	1 POLE (2P, 3P, 4P, ETC.) AMPERE ABOVE COUNTER ABOVE CEILING AUTOMATIC DOOR OPENER ABOVE FINISHED FLOOR ABOVE FINISHED GRADE ARC FAULT CIRCUIT INTERRUPTER AIR HANDLING UNIT ALUMINUM ALTERNATE AMPERE AMPLIFIER ANNUNCIATOR APPROXIMATELY AQUASTAT ARCHITECT, ARCHITECTURAL AUTOMATIC TRANSFER SWITCH AUTOMATIC AUXILIARY AUDIO VISUAL AMERICAN WIRE GAUGE BATTERY BOARD BUILDING BUILDING MANAGEMENT SYSTEM CONDUIT CABINET CABLE TELEVISION CIRCUIT BREAKER CLOSED CIRCUIT TELEVISION CIRCUIT CEILING COMBINATION COMPRESSOR CONNECTION CONTINUATION OR CONTINUOUS CONTROL PANEL CURRENT TRANSFORMER CENTER COPPER DEPARTMENT DIAMETER DISCONNECT DOWN DAMPER SAFETY DISCONNECT SWITCH DOUBLE THROW DRAWING ELECTRICAL CONTRACTOR ELECTRIC, ELECTRICAL ELEVATOR EMERGENCY LIGHTING UNIT EMERGENCY ENERGY MANAGEMENT SYSTEM ELECTRICAL METALLIC TUBING ELECTRIC PNEUMATIC EQUIPMENT ELECTRIC WATER COOLER EXISTING EXHAUST EXPLOSION PROOF FIRE ALARM FIRE ALARM CONTROL PANEL FAN COIL UNIT FIXTURE FLOOR FLUORESCENT FUSED SAFETY DISCONNECT SWITCH GALVANIZED GENERAL CONTRACTOR GENERATOR GROUND FAULT CIRCUIT INTERRUPTER GROUND FAULT PROTECTOR GROUND GYPSUM BOARD MOTOR PROTECTION CIRCUIT BREAKER HANDS-OFF-AUTOMATIC SWITCH HORIZONTAL MOTOR PROTECTION CIRCUIT BREAKER HORSEPOWER HEIGHT HEATING HEATER HIGH VOLTAGE HEATING, VENTILATING AND AIR CONDITIONING ISOLATED GROUND INTERMEDIATE METAL CONDUIT INCANDESCENT INFRARED INTERLOCK WITH JUNCTION BOX KILO-AMPS INTERRUPTING CAPACITY KILOVOLT KILOVOLT-AMPERE KILOVOLT-AMPERE REACTIVE KILOWATT KILOWATT HOUR LOCATE OR LOCATION LIGHT LIGHTING LIGHTNING LOW VOLTAGE LOW VOLTAGE MAXIMUM MAGNETIC STARTER MOMENTARY CONTACT	MC MCB MCC MCCB MCP MDP MFR MFS MH MIC MIN MLO MMS MSP MSB MSD MSS MT MTS MTR N.C. NEC NEMA NIC NL N.O. NPF NTS OC OH OL PA PB PED PF PH PM PNL PP PRI PRV PVC PWR RCPT RM RSC RTU SCCR SEC SHEET SIM SPEC SPKR SP SPD SPP SS SSW S/S STA STD SURF SW SYM SYS TC TEL TERM TL TR T-STAT TTC TV TVTC TYP UC UE UG UH UT UTIL UV V VA VERT VFD VOL W W/ WG WH W/O WP XFMR XFR ANGLE AT ▲ FEET INCHES NUMBER PHASE CENTER LINE PLATE	MECHANICAL CONTRACTOR MAIN CIRCUIT BREAKER MOTOR CONTROL CENTER MOLDED CASE CIRCUIT BREAKER MOTOR CIRCUIT PROTECTOR MAIN DISTRIBUTION PANEL MANUFACTURER MAIN FUSED DISCONNECT SWITCH MANHOLE MICROPHONE MINIMUM MAIN LUGS ONLY MANUAL MOTOR STARTER MULTIOUTLET ASSEMBLY MOTOR STARTER PANELBOARD MAIN SWITCHBOARD MAIN SERVICE DISCONNECT MOTOR STARTER SWITCH MOUNT MANUAL TRANSFER SWITCH MOTOR, MOTORIZED NORMALLY CLOSED NATIONAL ELECTRICAL CODE NATIONAL ELECTRICAL MANUFACTURER'S ASSOCIATION NOT IN CONTRACT NIGHT LIGHT N.O. NORMALLY OPEN NORMAL POWER FACTOR NOT TO SCALE ON CENTER OVERHEAD OVERLOADS PUBLIC ADDRESS PULL BOX OR PUSHBUTTON PEDESTAL POWER FACTOR PHASE POWER METER PANEL POWER POLE PRIMARY POWER ROOF VENTILATOR (CONDUIT) POWER RECEPTACLE ROOM RIGID STEEL CONDUIT ROOF TOP UNIT SHORT-CIRCUIT CURRENT RATING SECONDARY SHEET SIMILAR SPECIFICATION SPEAKER SPARE SURGE PROTECTION DEVICE SINGLE-POINT POWER STAINLESS STEEL SELECTOR SWITCH STOP/START PUSHBUTTONS STATION STANDARD SURFACE MOUNTED SWITCH SYMMETRICAL SYSTEM TIME CLOCK TELEPHONE TERMINAL TWIST LOCK TAMPER RESISTANT THERMOSTAT TELEPHONE TERMINAL CABINET TELEVISION TELEVISION TERMINAL CABINET TYPICAL UNDER COUNTER UNDERGROUND ELECTRICAL UNDERGROUND UNIT HEATER UNDERGROUND TELEPHONE UTILITY ULTRAVIOLET VOLT VOLT-AMPERES VERTICAL VARIABLE FREQUENCY DRIVE VOLUME WATT W/ WITH WIRE GUARD WATER HEATER WITHOUT WEATHERPROOF TRANSFORMER TRANSFER


LIGHTING FIXTURE SYMBOLS

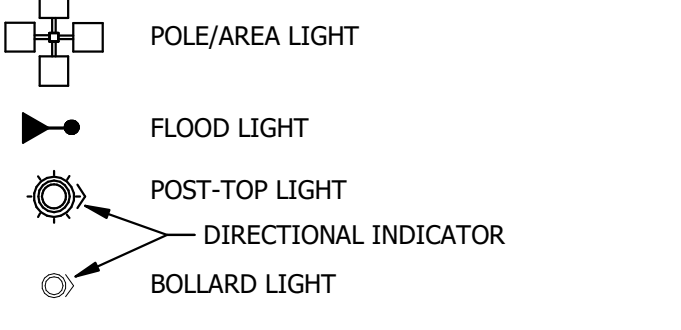


NOTE: A FIXTURE MAY CONTAIN MULTIPLE SYMBOL TYPES

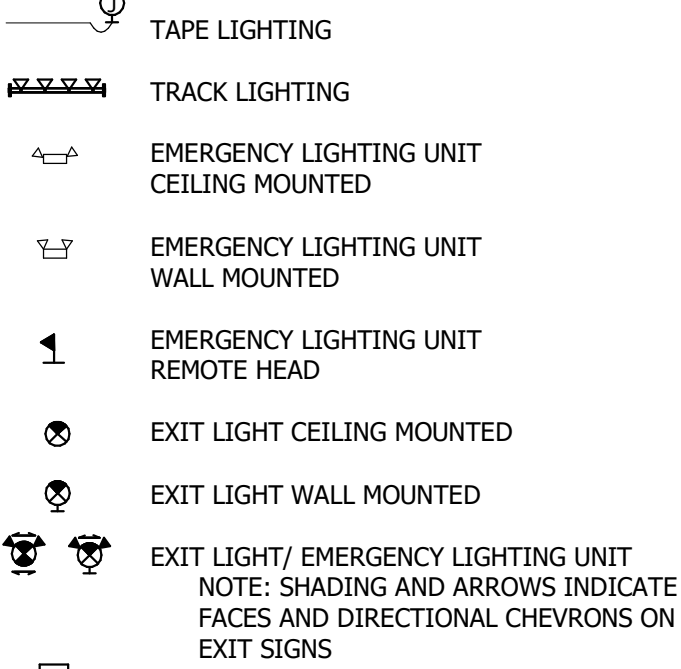


LIGHTING CONTROL SYMBOLS

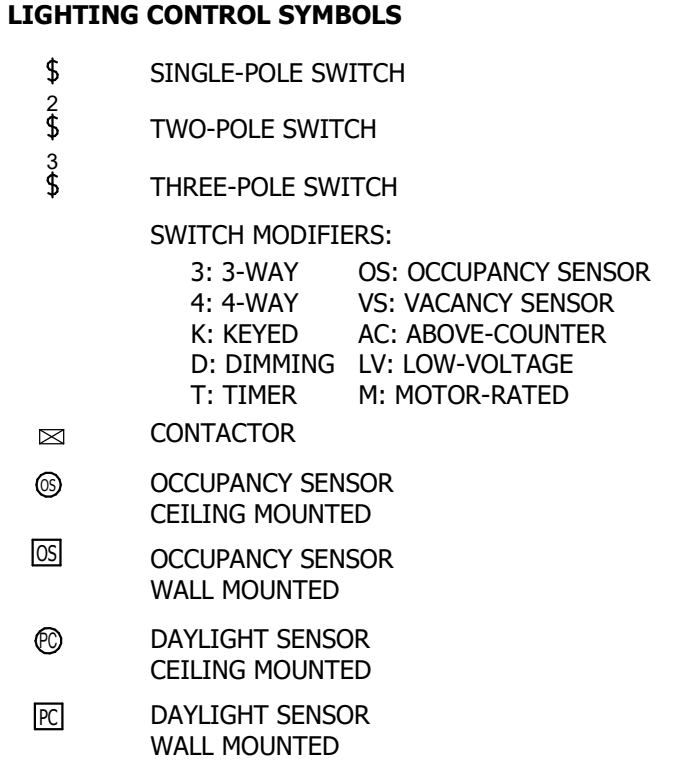




LIGHTING TAGS

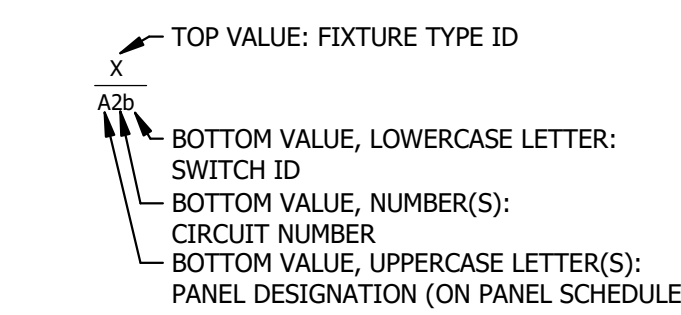
























ABSENCE OF A SWITCH DESIGNATION ON A LIGHTING FIXTURE INDICATES SPACE HAS A SINGLE SWITCHING ZONE AND LUMINAIRE IS CONTROLLED BY THE LIGHTING DEVICE(S) SHOWN IN THE SPACE.

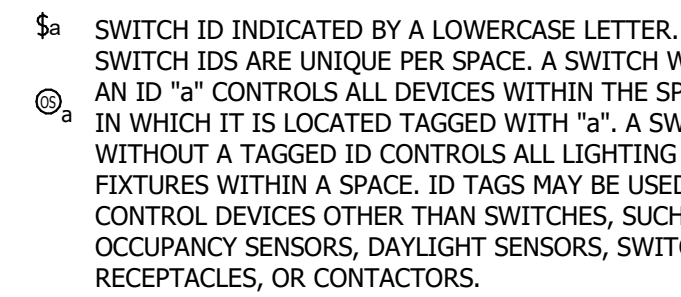

WIRING















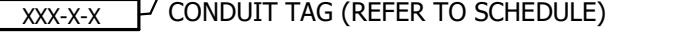
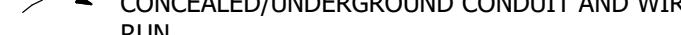
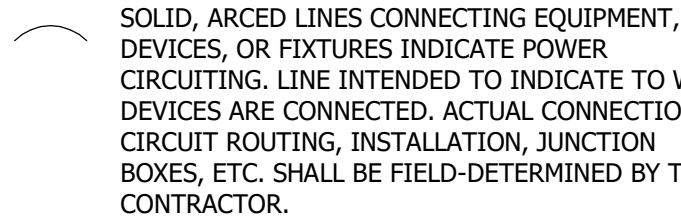


POWER SYMBOLS

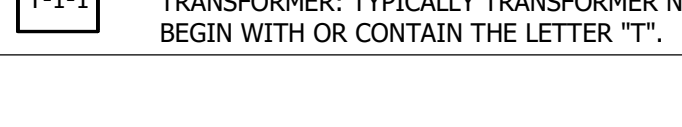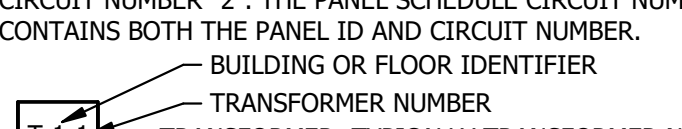
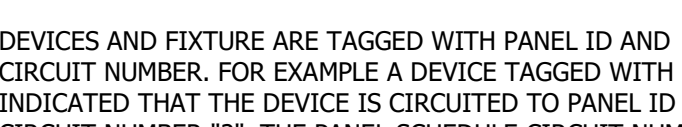
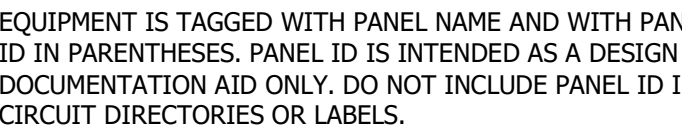
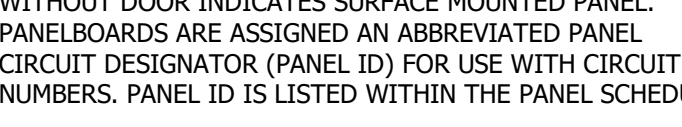
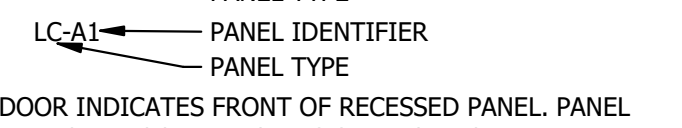
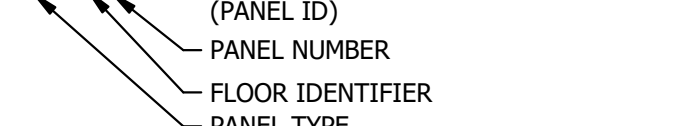
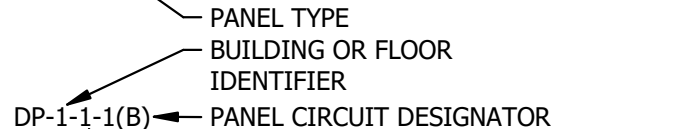
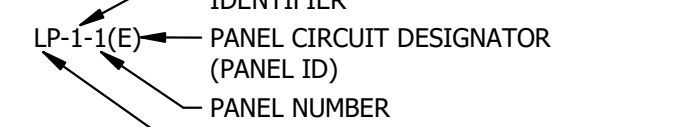
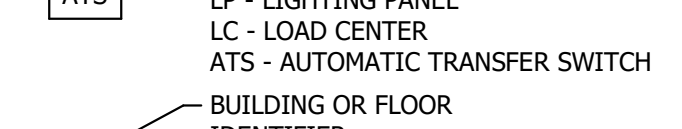
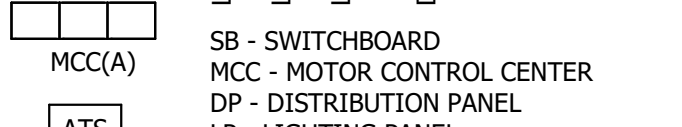
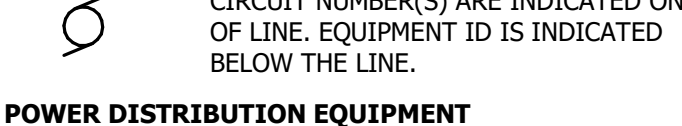
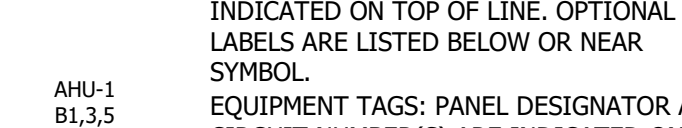
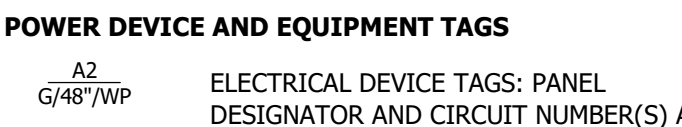
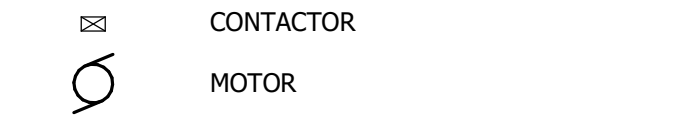
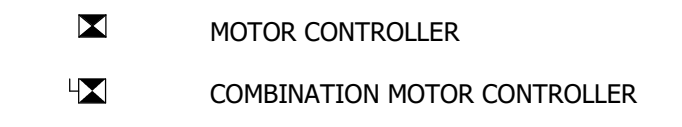
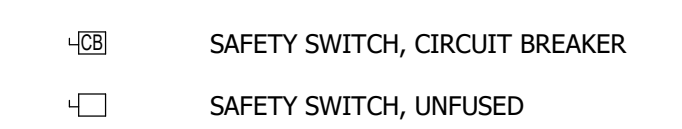
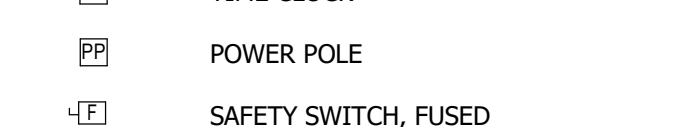
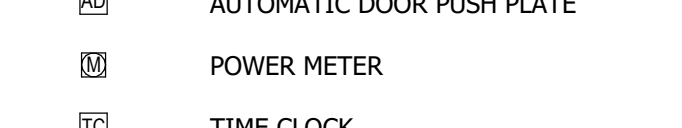
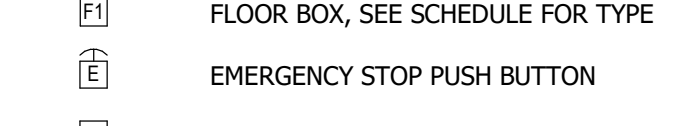
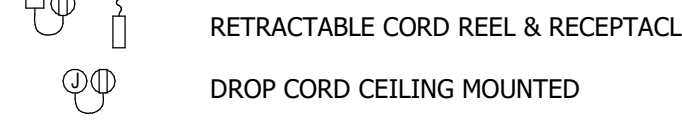
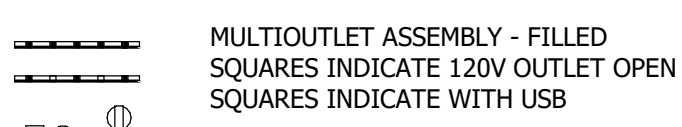
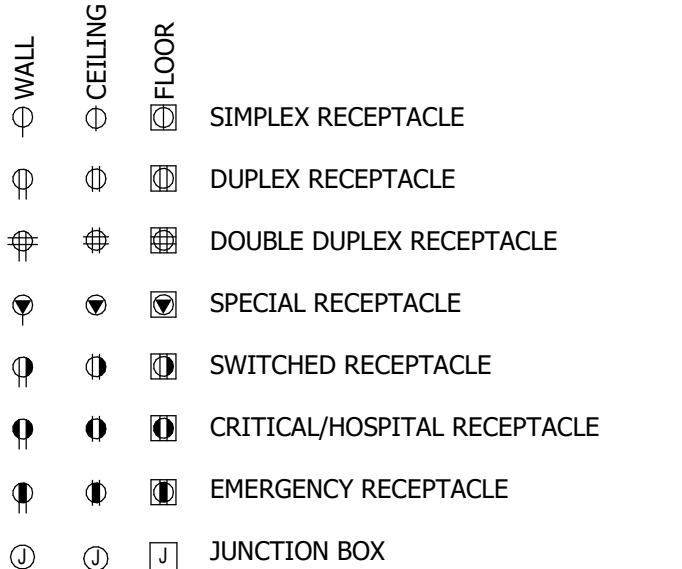


ELECTRICAL SYMBOL LEGEND








TELECOM SYMBOLS

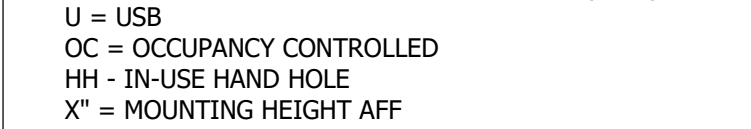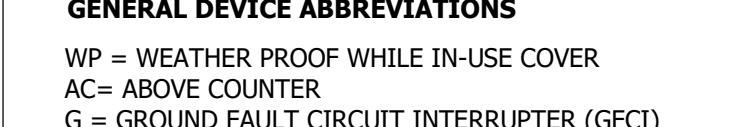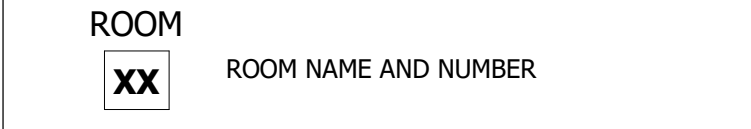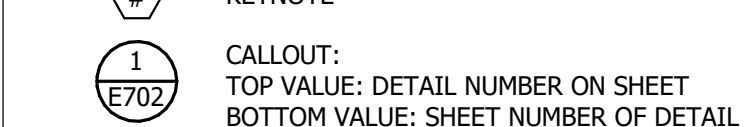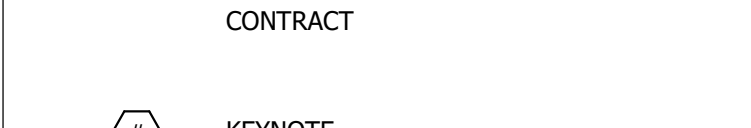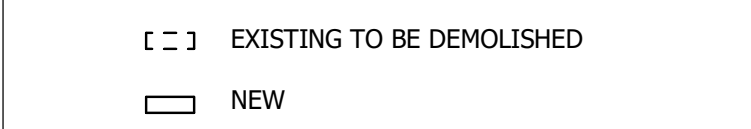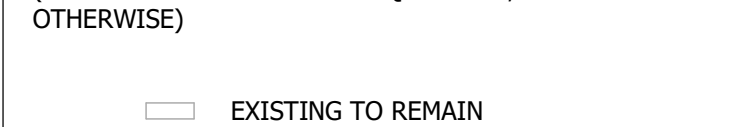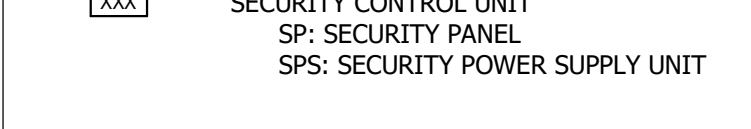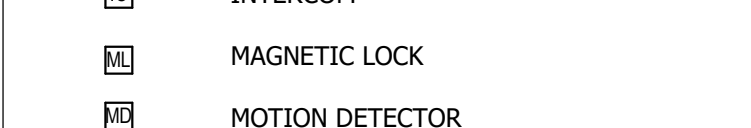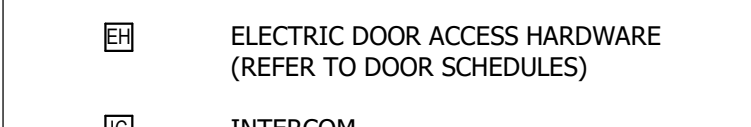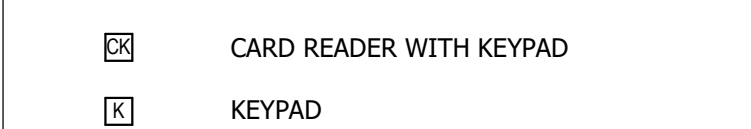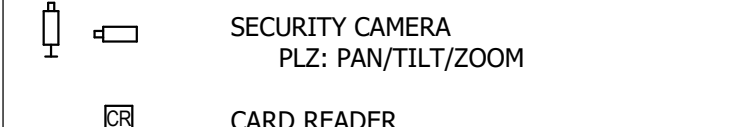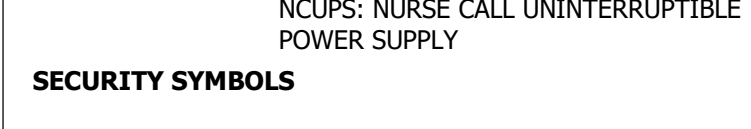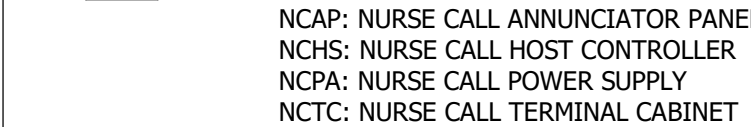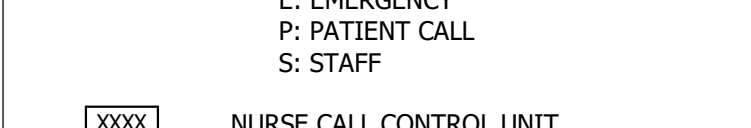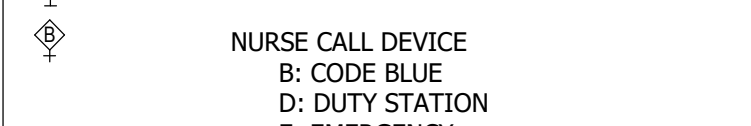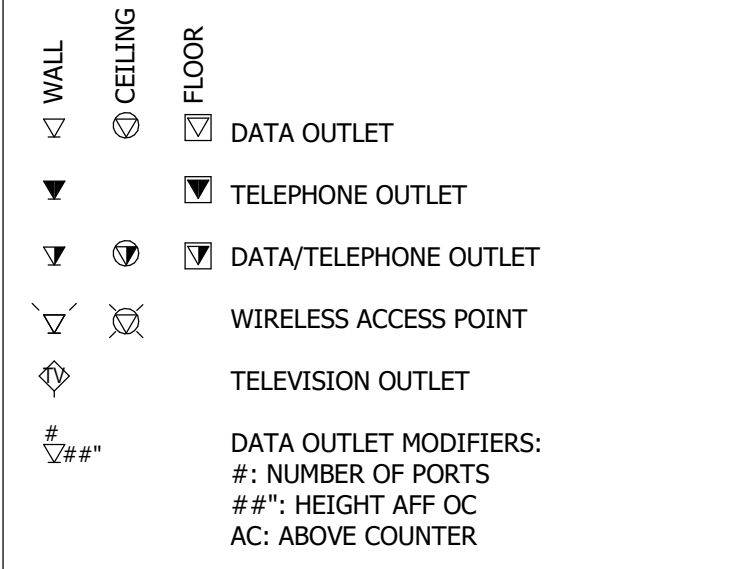


FIRE ALARM SYMBOLS

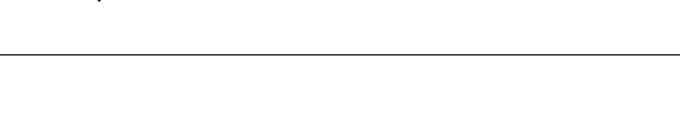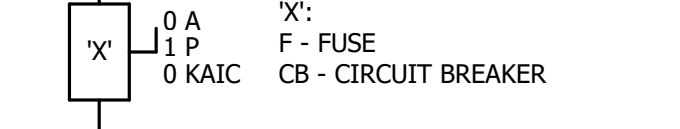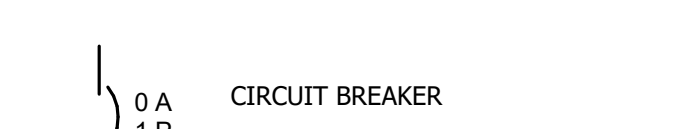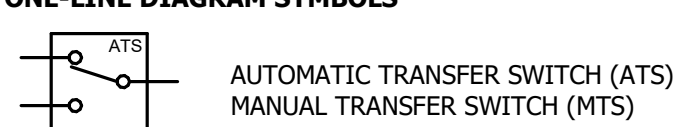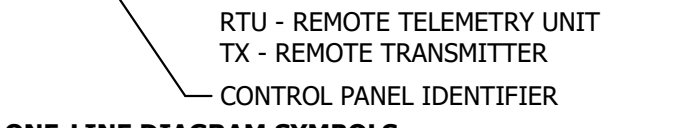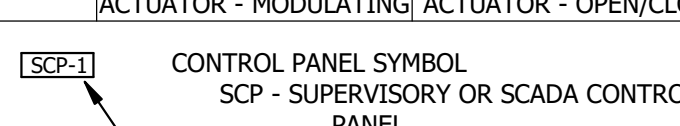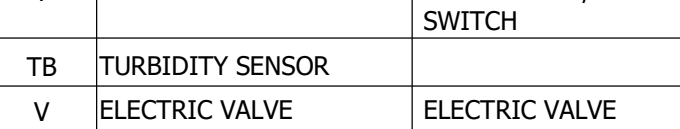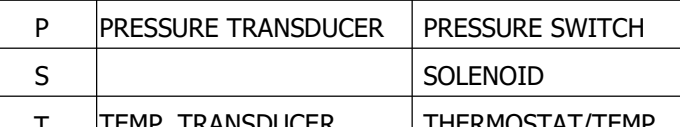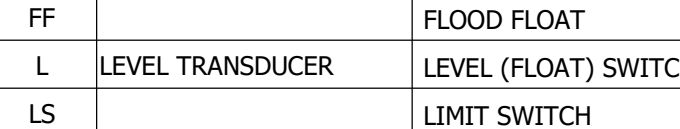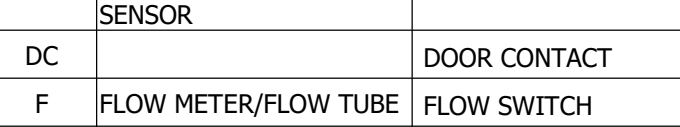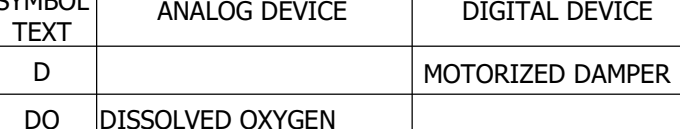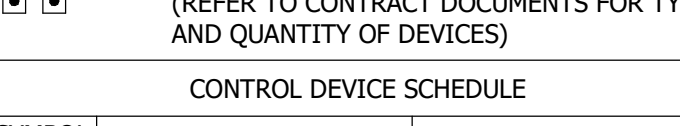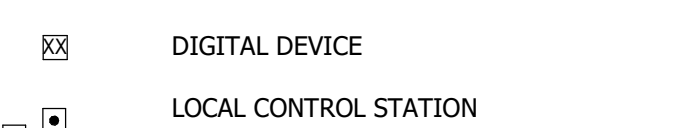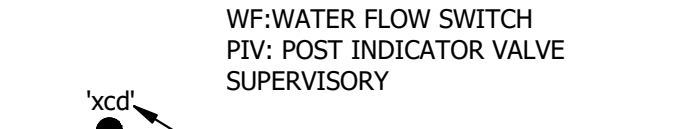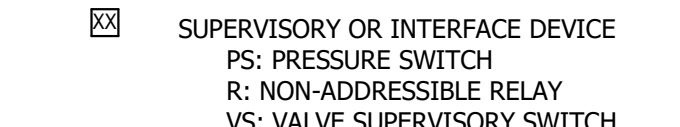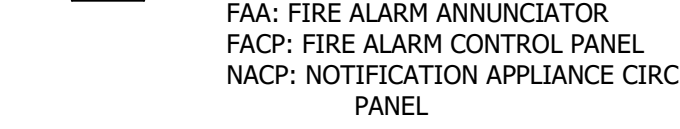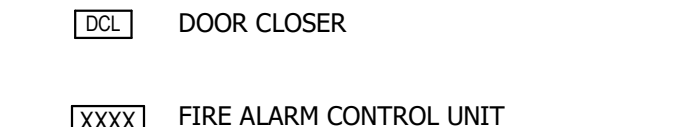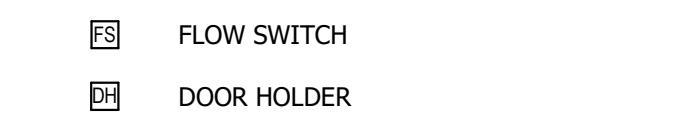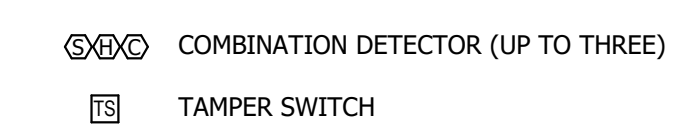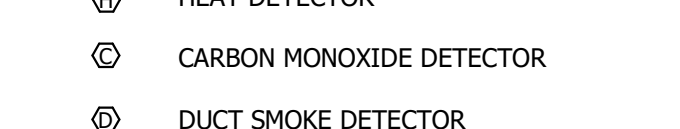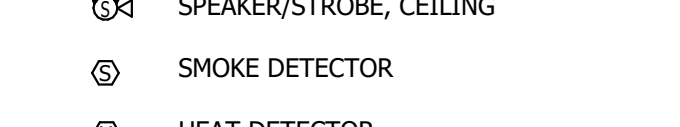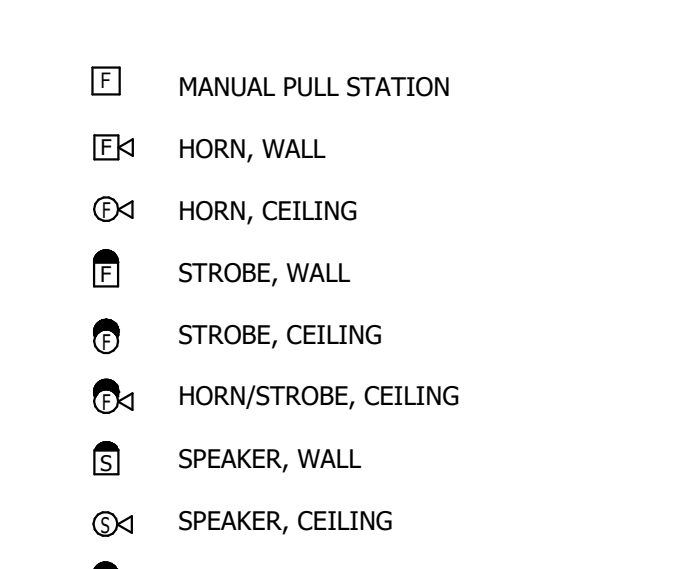

ONE-LINE DIAGRAM SYMBOLS

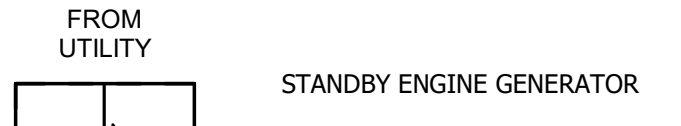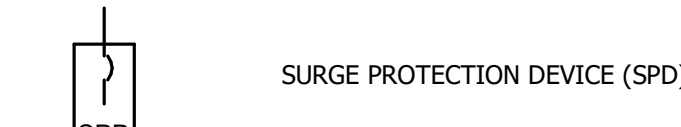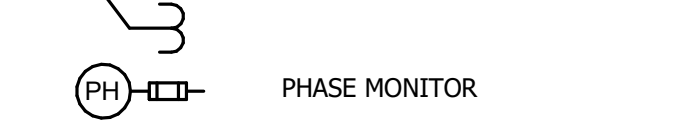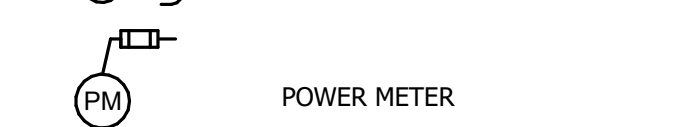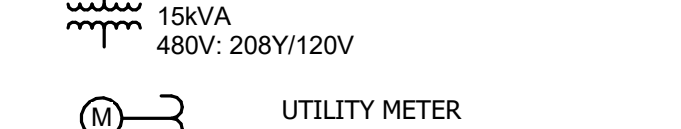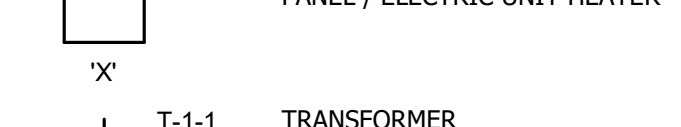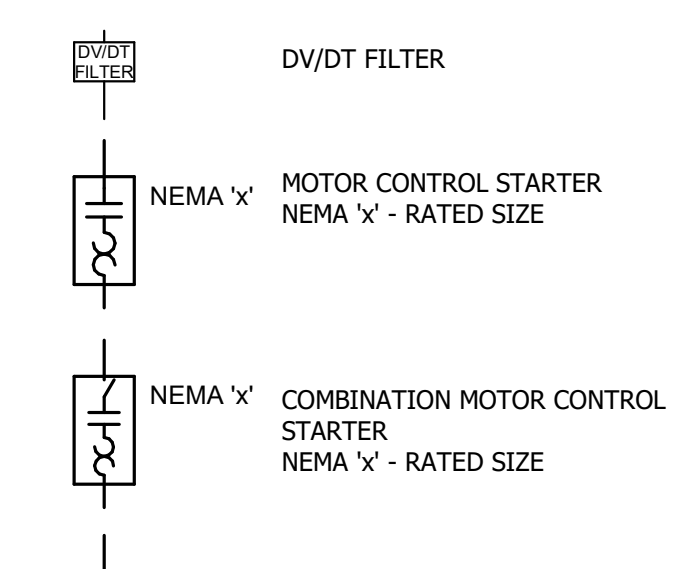

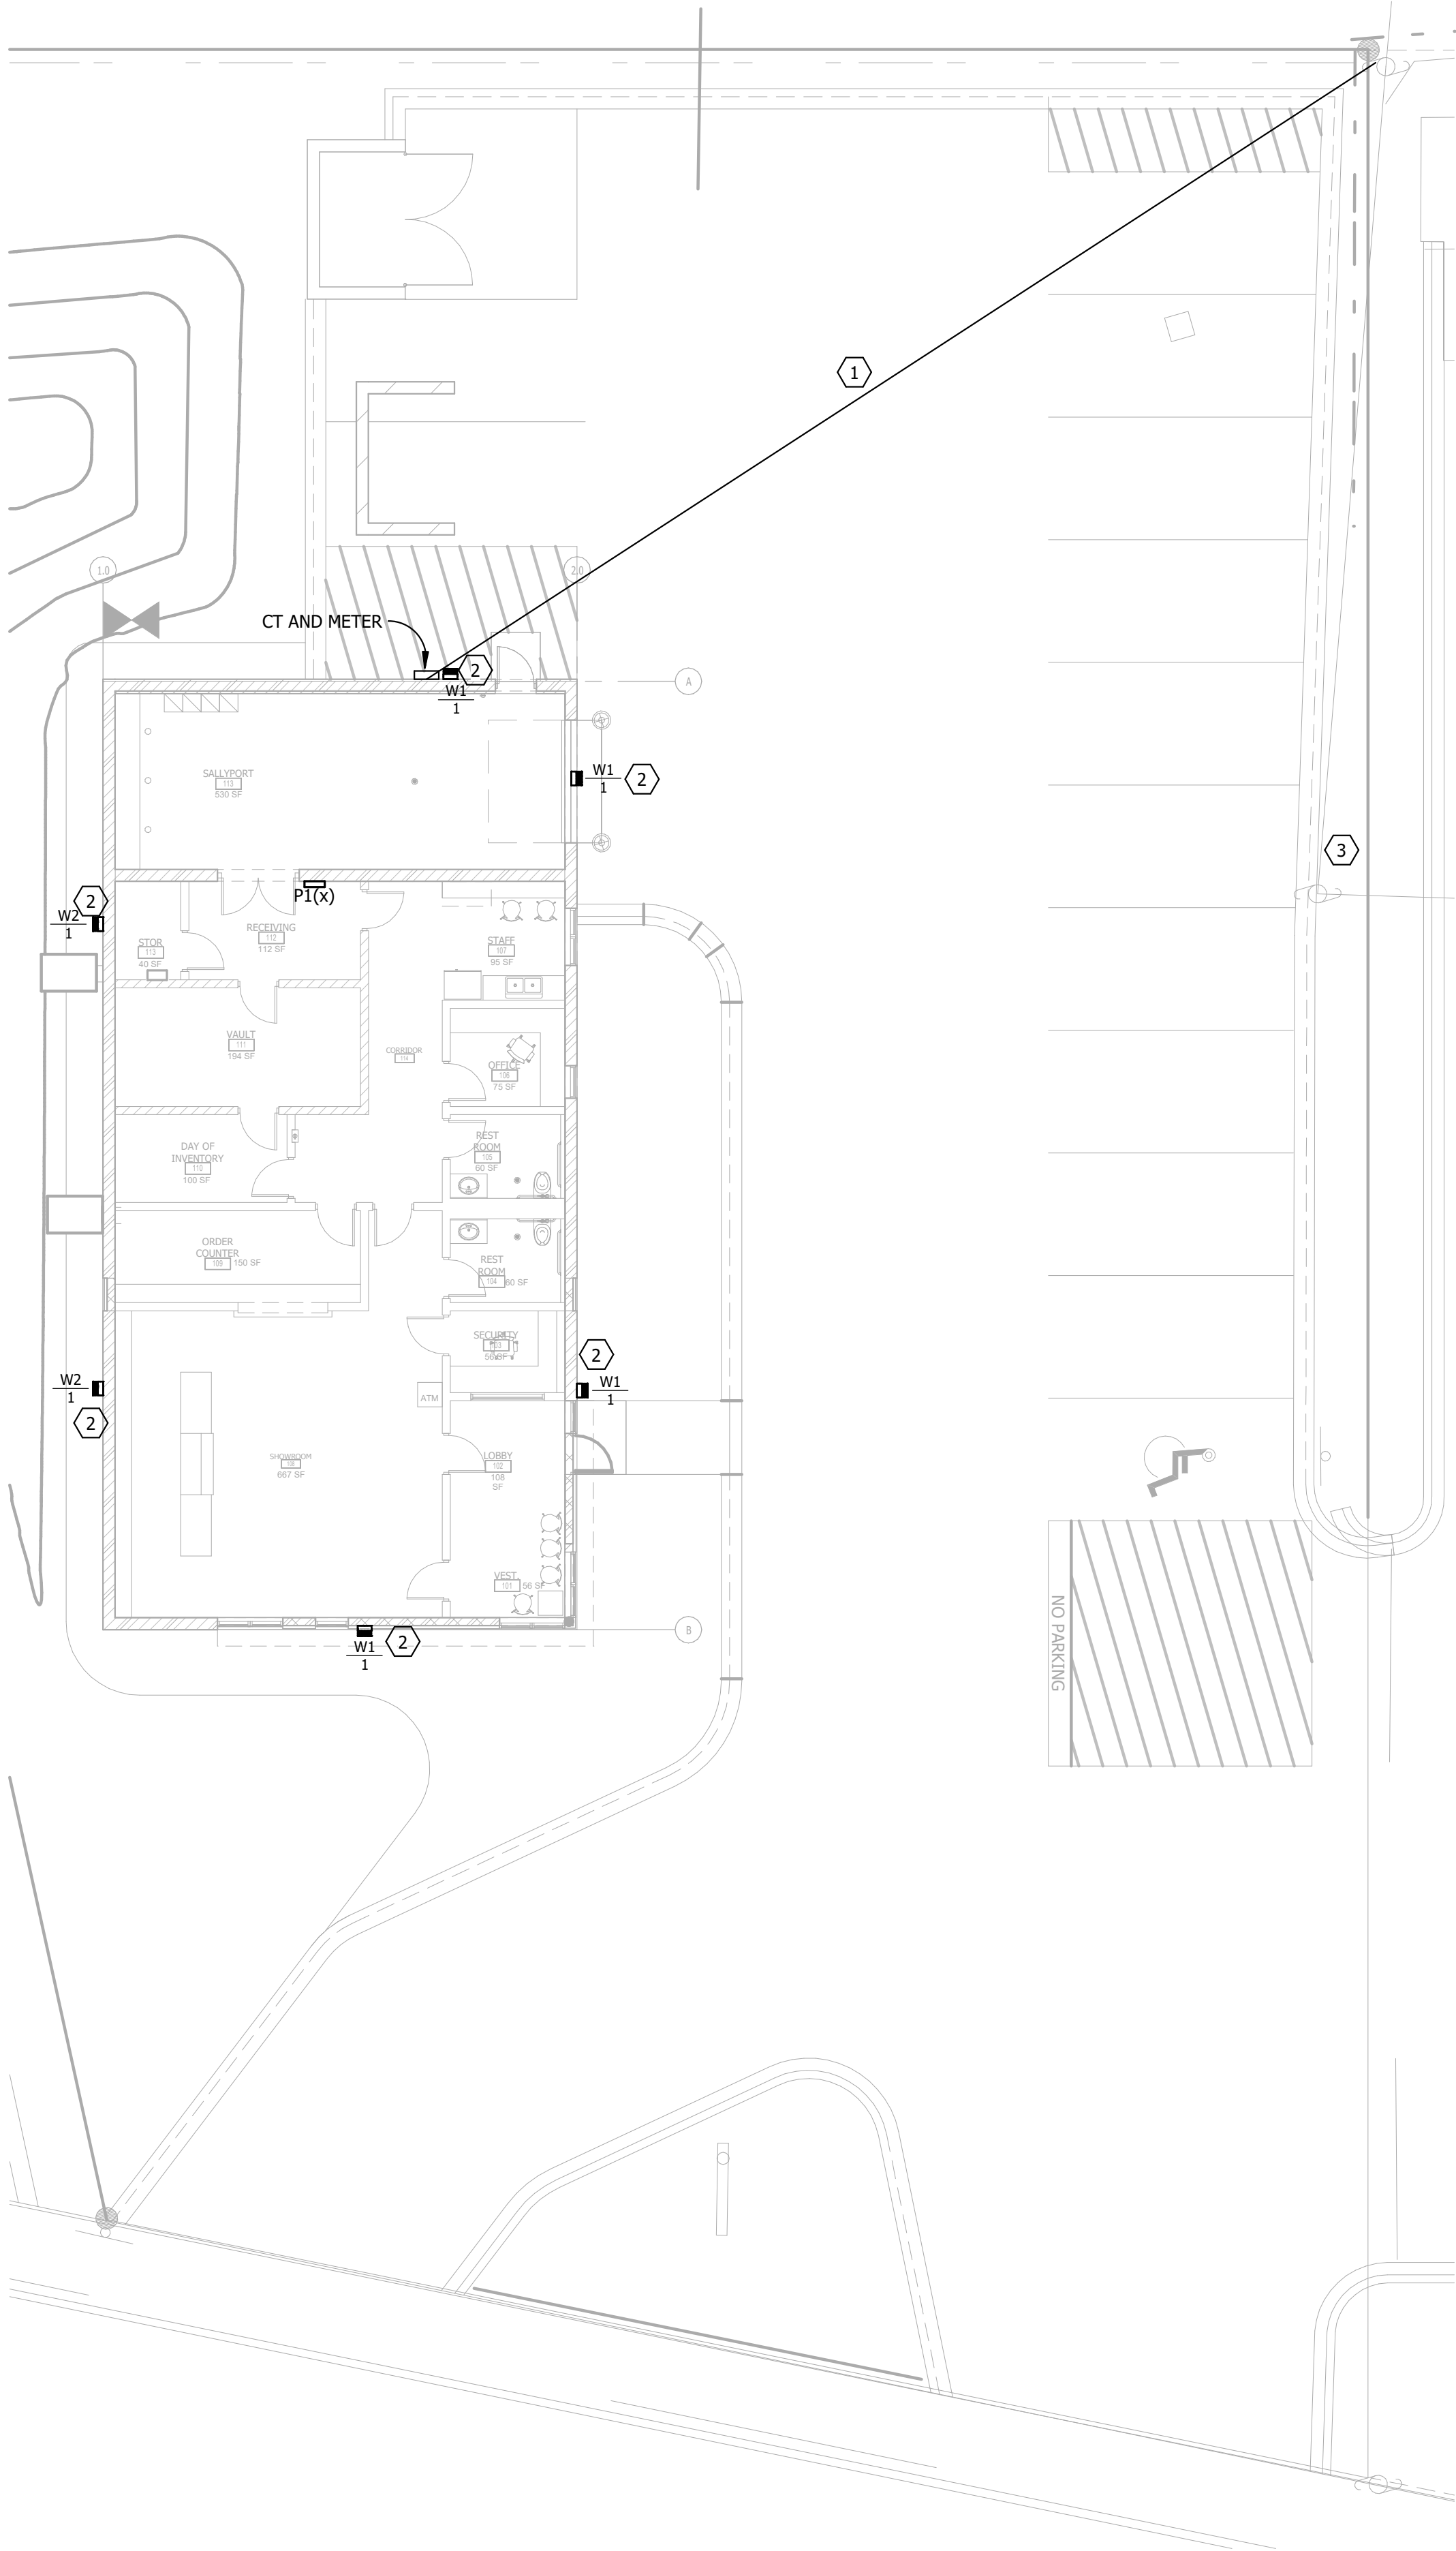

KEYED NOTES:

1. CONDUIT FROM UTILITY POLE MOUNTED TRANSFORMER TO NEW CT AND METER. COORDINATE WITH UTILITY EXACT REQUIREMENTS. REFER TO ONE-LINE DIAGRAM ON SHEET E801.
2. LIGHT FIXTURE TO BE CONTROLLED THROUGH PHOTOCELL AND TIME CLOCK.
3. EXISTING POLE LIGHT.

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Philip Haight

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DATE: 03/31/2025

LICENSE #: 59791

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NO.	DATE	DESCRIPTION

ELECTRICAL SITE
PLAN

DRAWING NO.

E201

Autodesk Docs://19625002-Anoka Dispensary Building_R23/09625002-ADB_MEP_R23.rvt



Calculation Summary					
Label	CalcType	Units	Avg	Max	Min
SITE	Illuminance	Fc	1.51	7.2	0.0

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PHOTOMETRIC
SITE PLAN

DRAWING NO.

E202



A. EXTERIOR LIGHTING TO BE CONTROLLED THROUGH PHOTOCELL AND TIMECLOCK.

1. CIRCUIT FIXTURE TO UNSWITCH LEG.
2. CIRCUIT BATTERY PACK TO UNSWITCH LEG.

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PROJECT NO.:	09625002
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[illegible]

DRAWING NO.

E301

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1

LEVEL 1 POWER PLAN


3/16" = 1'-0"

0

3'

6'

12'

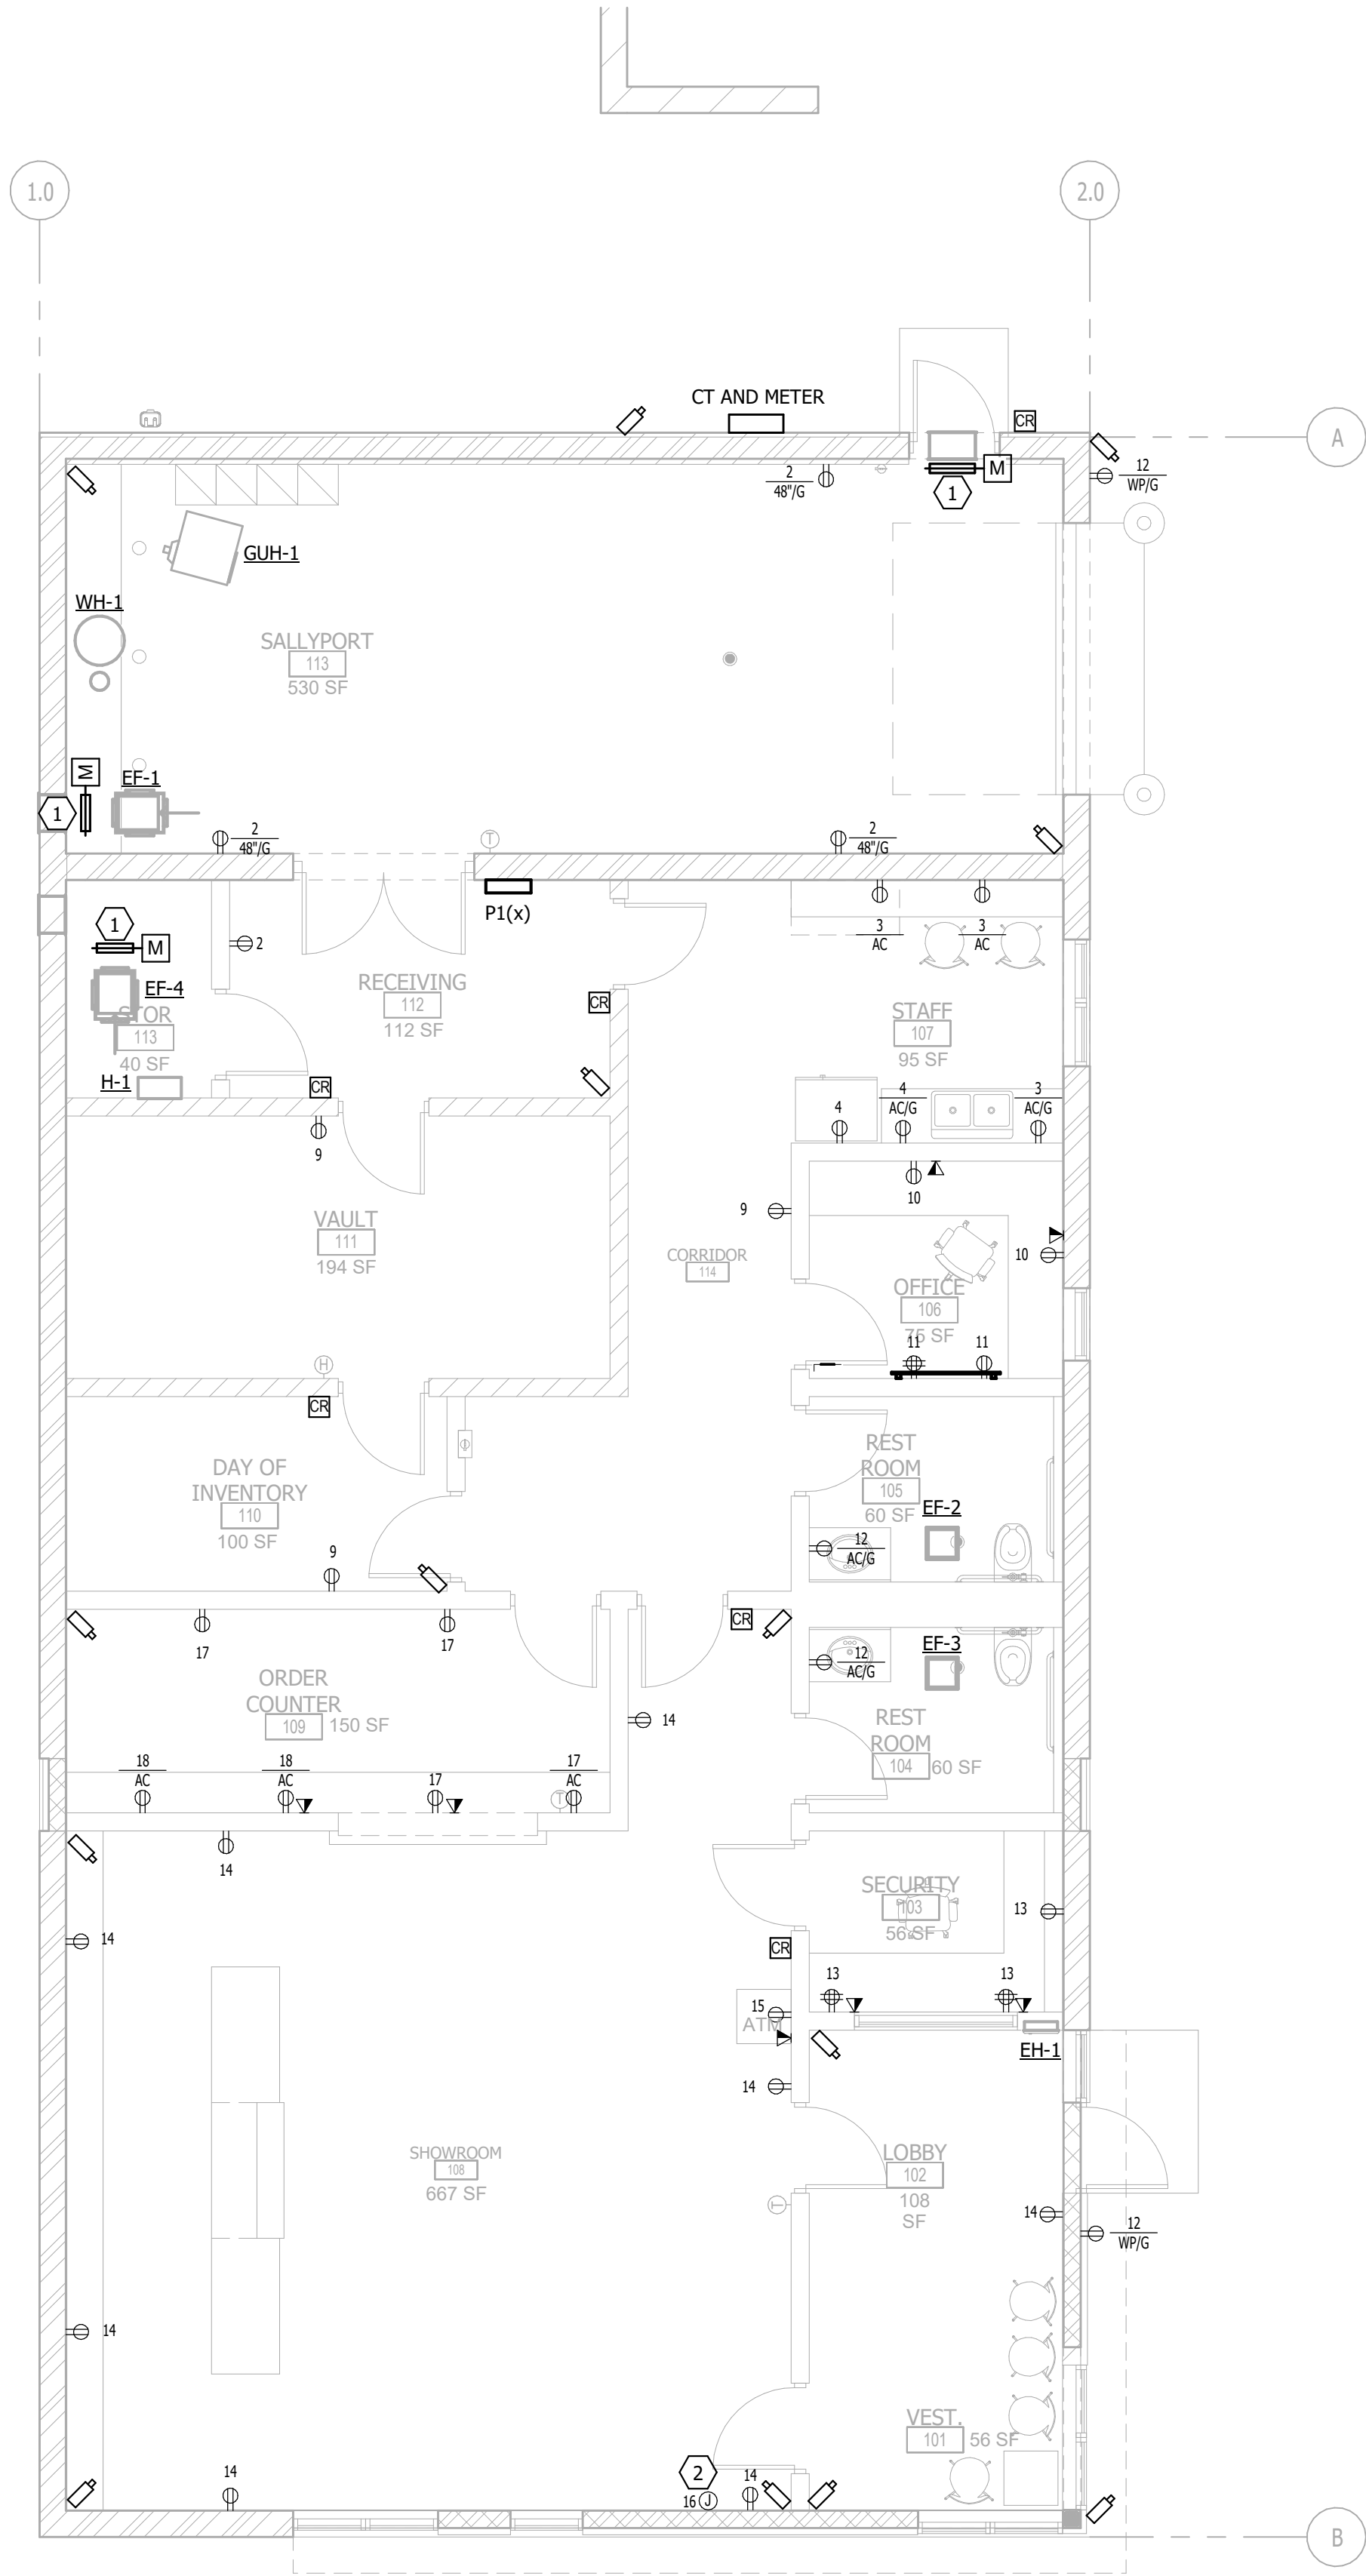

GENERAL NOTES:

A. COORDINATE ALL SECURITY AND CAMERA LOCATIONS WITH OWNER AND SECURITY CONTRACTOR. ELECTRICAL CONTRACTOR TO PROVIDE CONDUIT AND BOXES TO ALL LOCATIONS AS PER MANUFACTURER REQUIREMENTS.

- KEYEDNOTES:
1. PROVIDE 120V CONNECTION FOR MOTORIZED DAMPER. REFER TO MECHANICAL FOR ADDITIONAL INFORMATION.
2. JUNCTION BOX FOR BUILDING SIGNAGE. COORDINATE LOCATION WITH OWNER AND ARCHITECT PRIOR TO ROUGH IN. BUILDING SIGNAGE TO BE CONTROLLED THROUGH TIMECLOCK.

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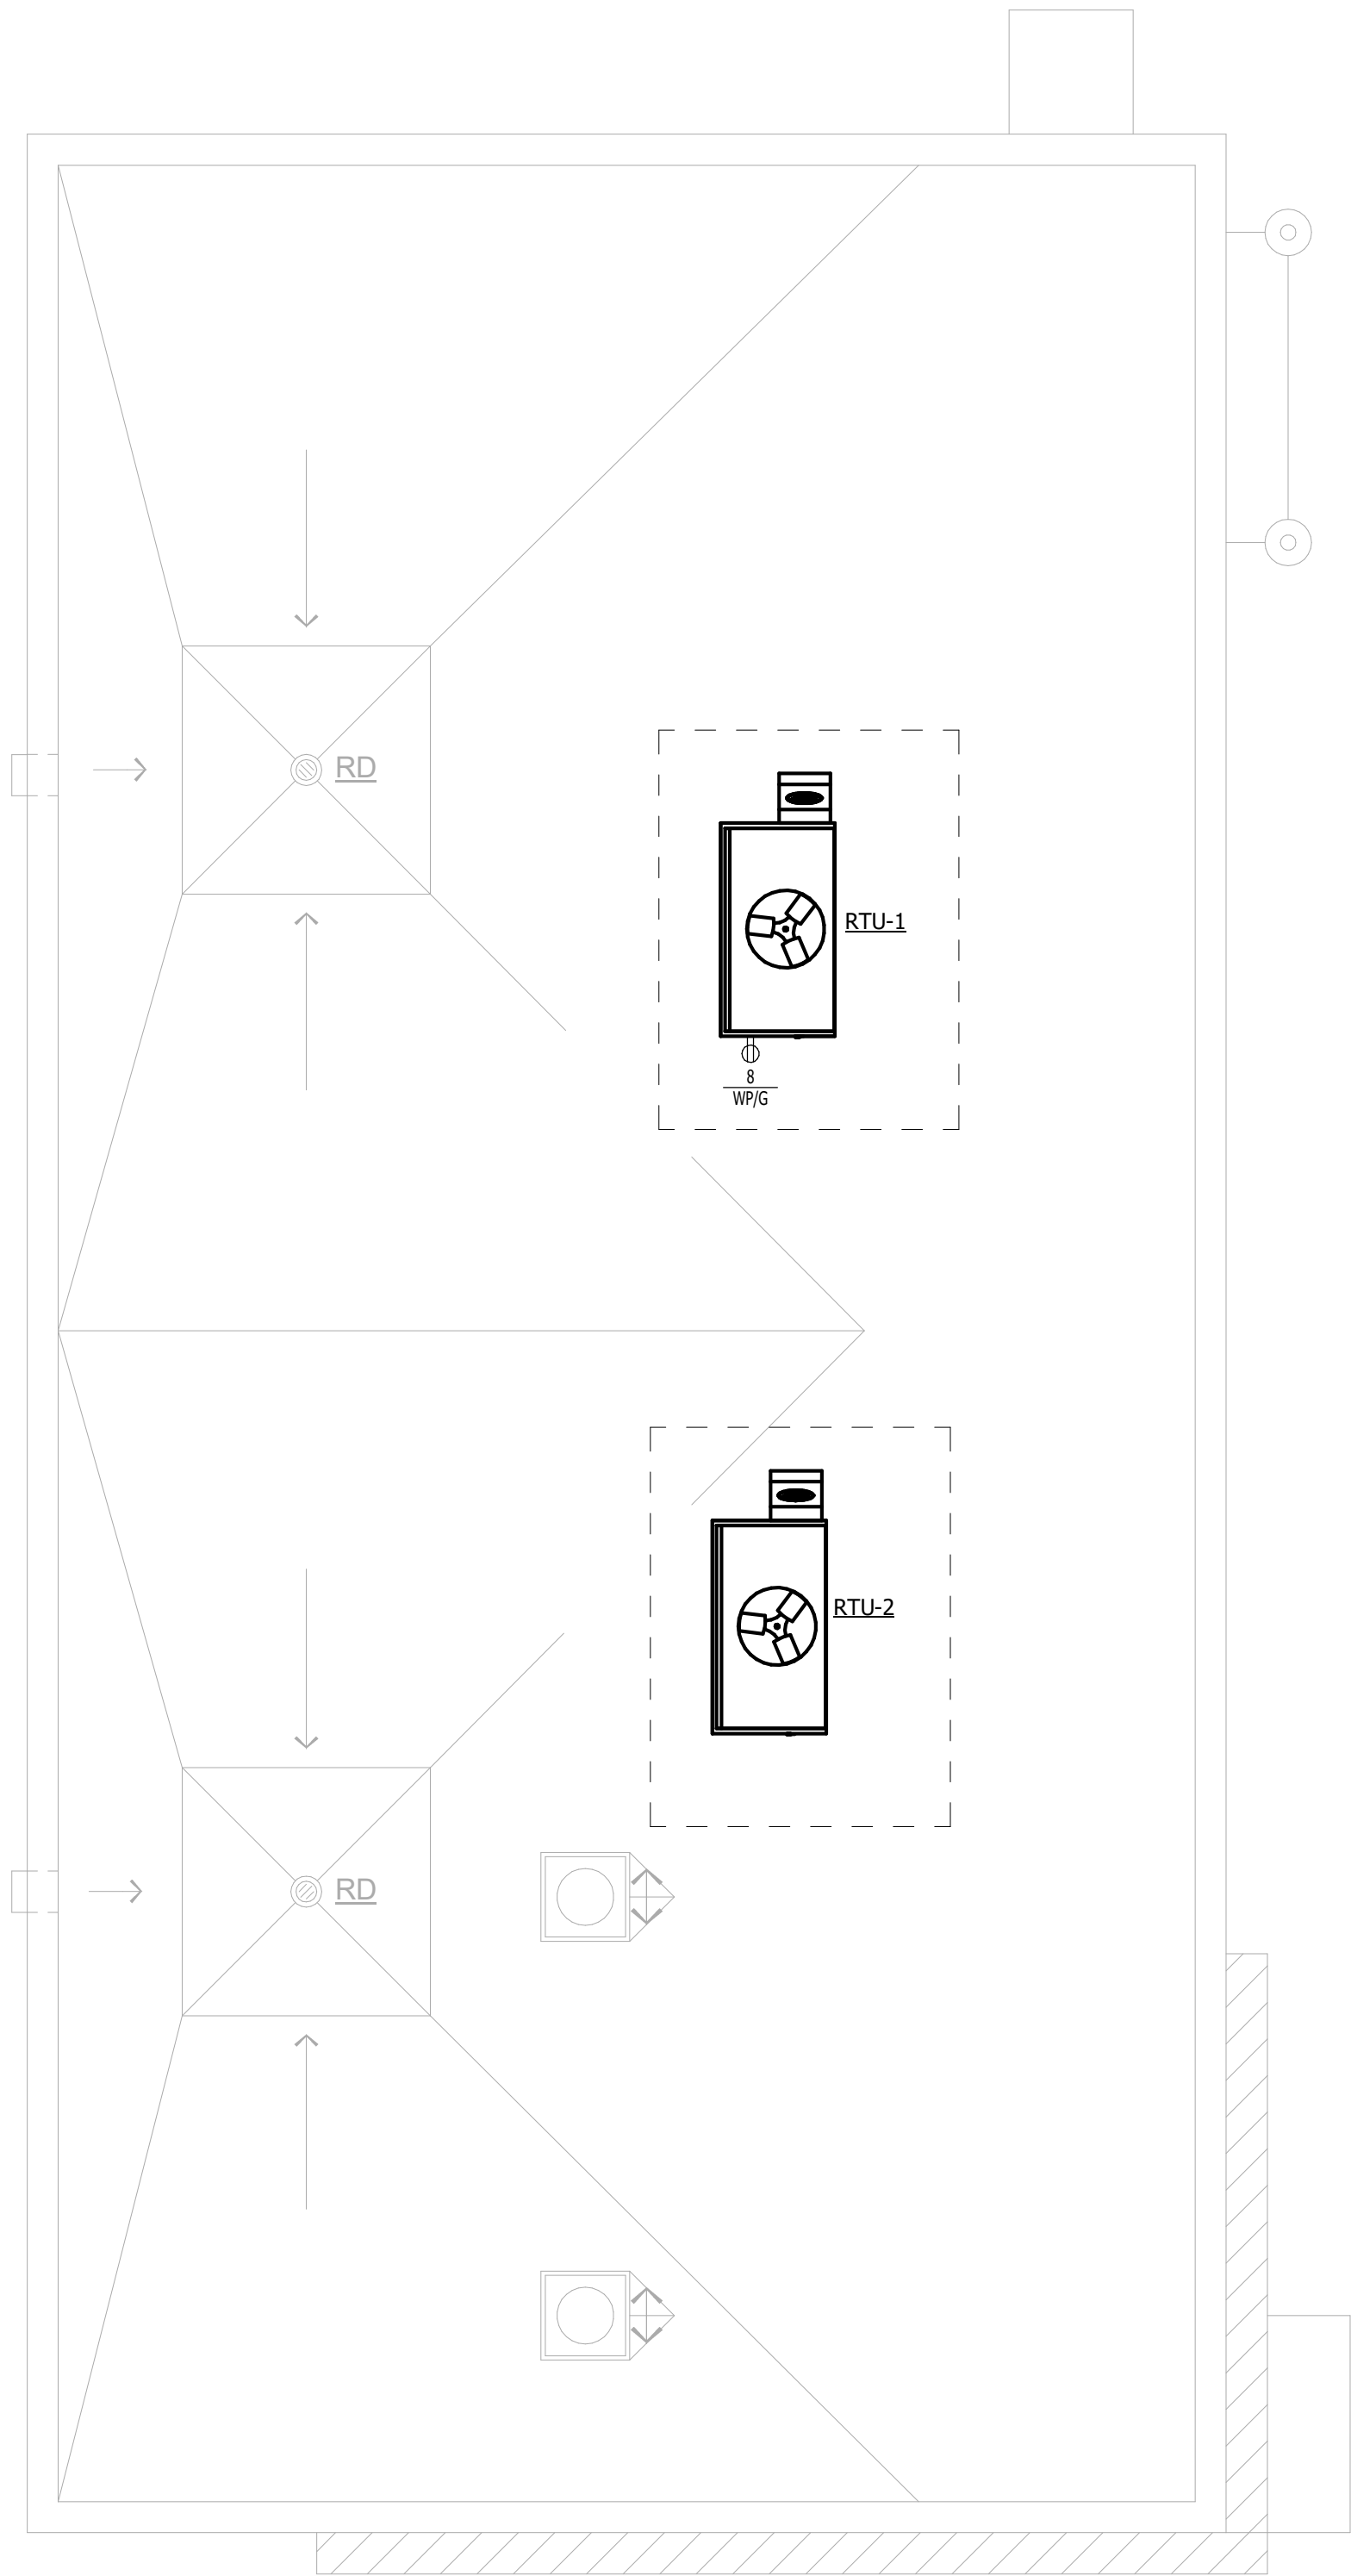
LEVEL 1 POWER &
SYSTEMS PLANS

DRAWING NO.

E401

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1 ELECTRICAL ROOF PLAN
3/16" = 1'-0"



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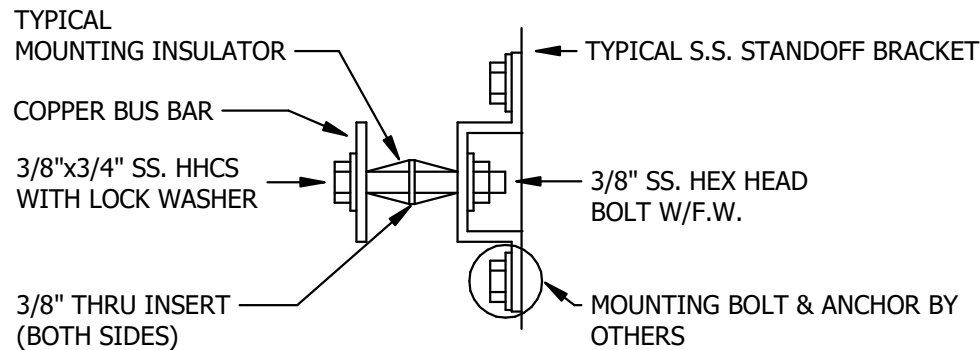
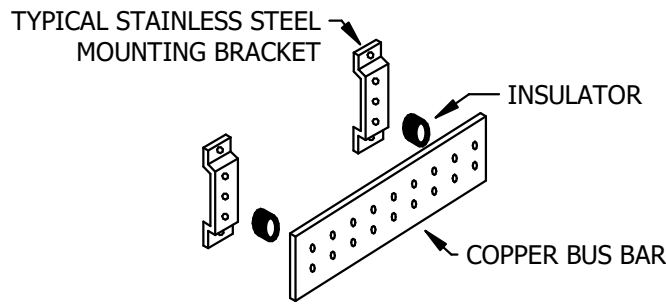
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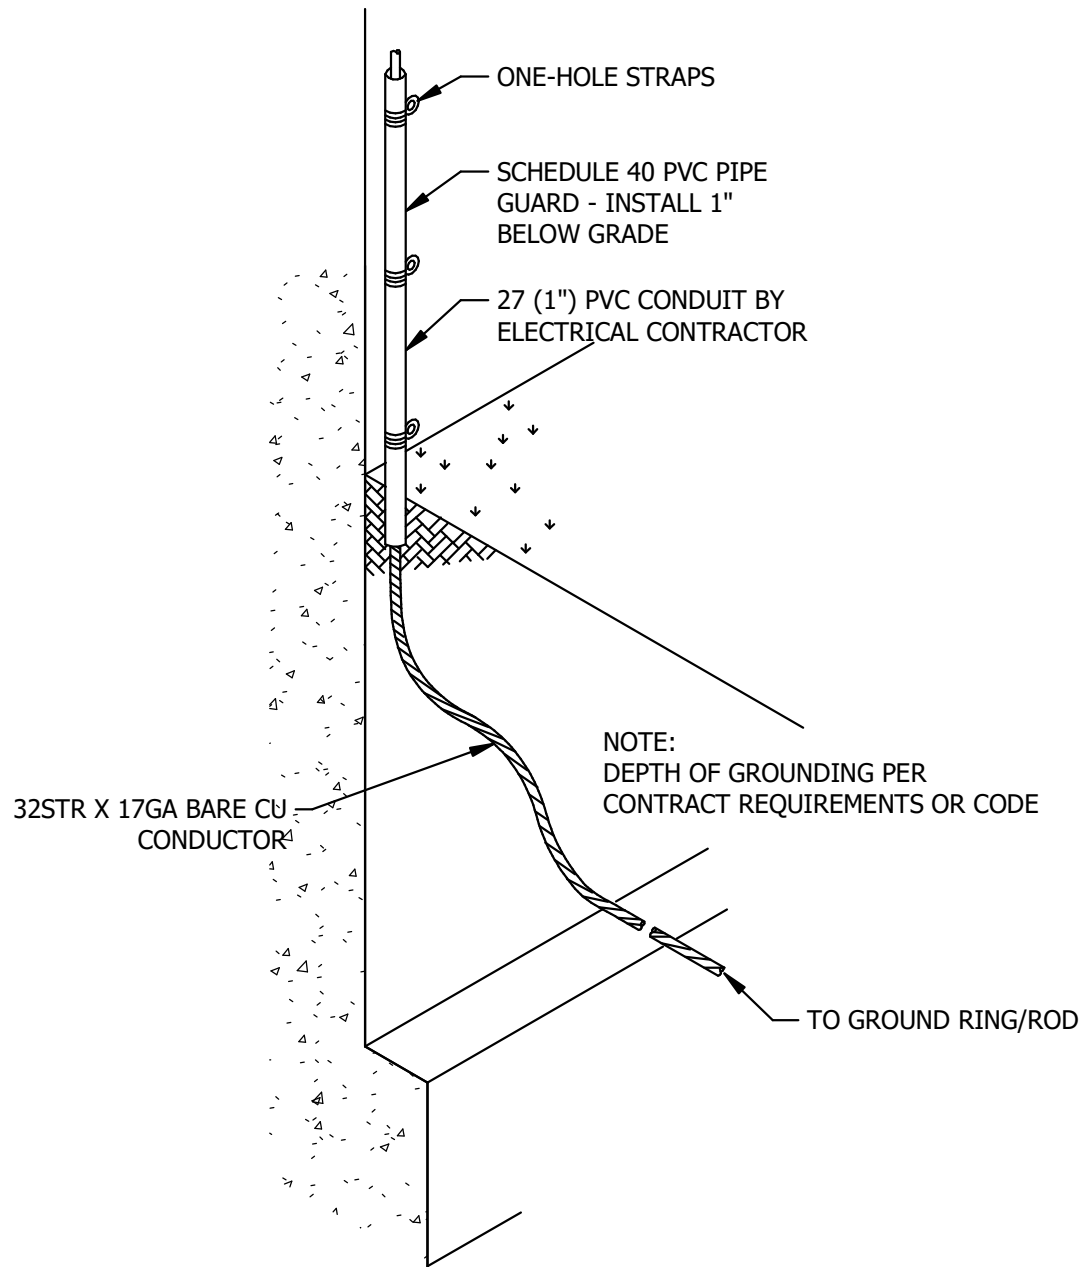
ELECTRICAL ROOF
PLAN

DRAWING NO.


E501



6 TYPICAL GROUNDING BUS BAR DETAIL
NO SCALE




4 GROUND DETAIL
NO SCALE

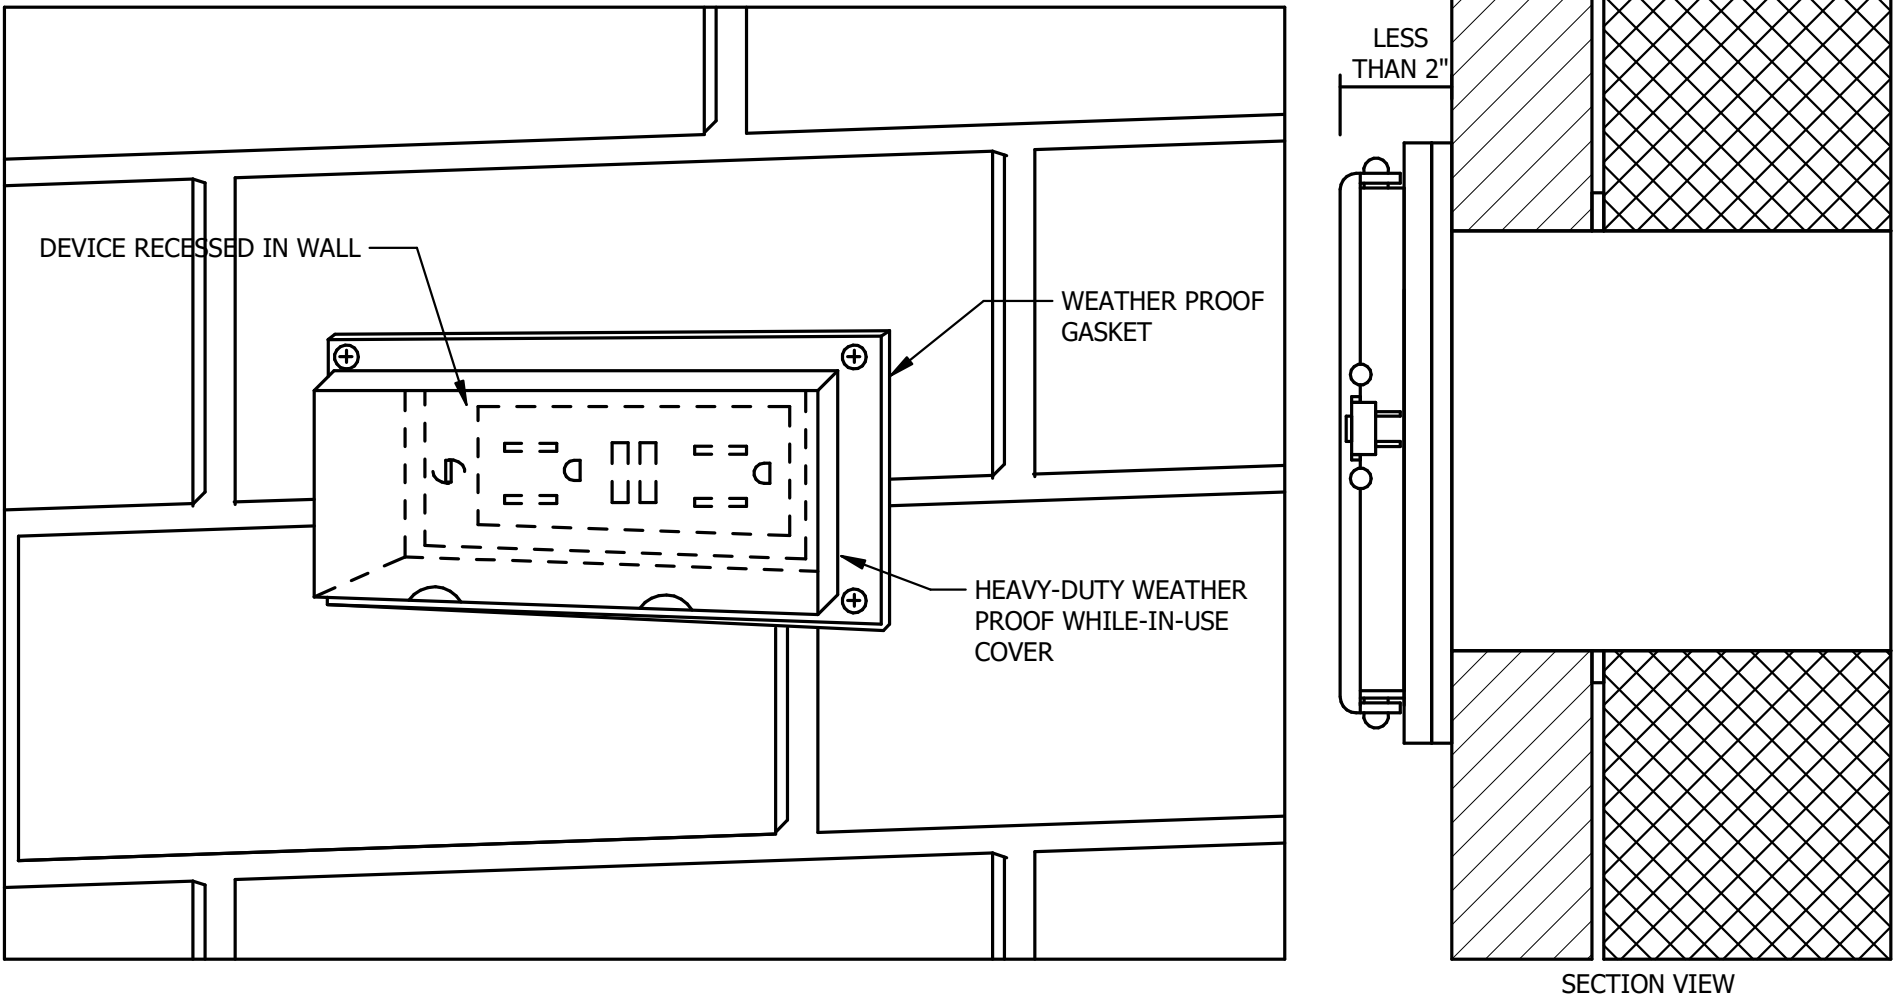


GENERAL NOTES:
1. VERIFY WALL TYPE AND FINISH WITH ARCHITECTURAL DOCUMENTS, PROVIDE MANUFACTURER'S RECOMMENDED BOX AND HARDWARE FOR WALL TYPE(S).


2 OUTDOOR RECESSED OUTLET BOX
NO SCALE

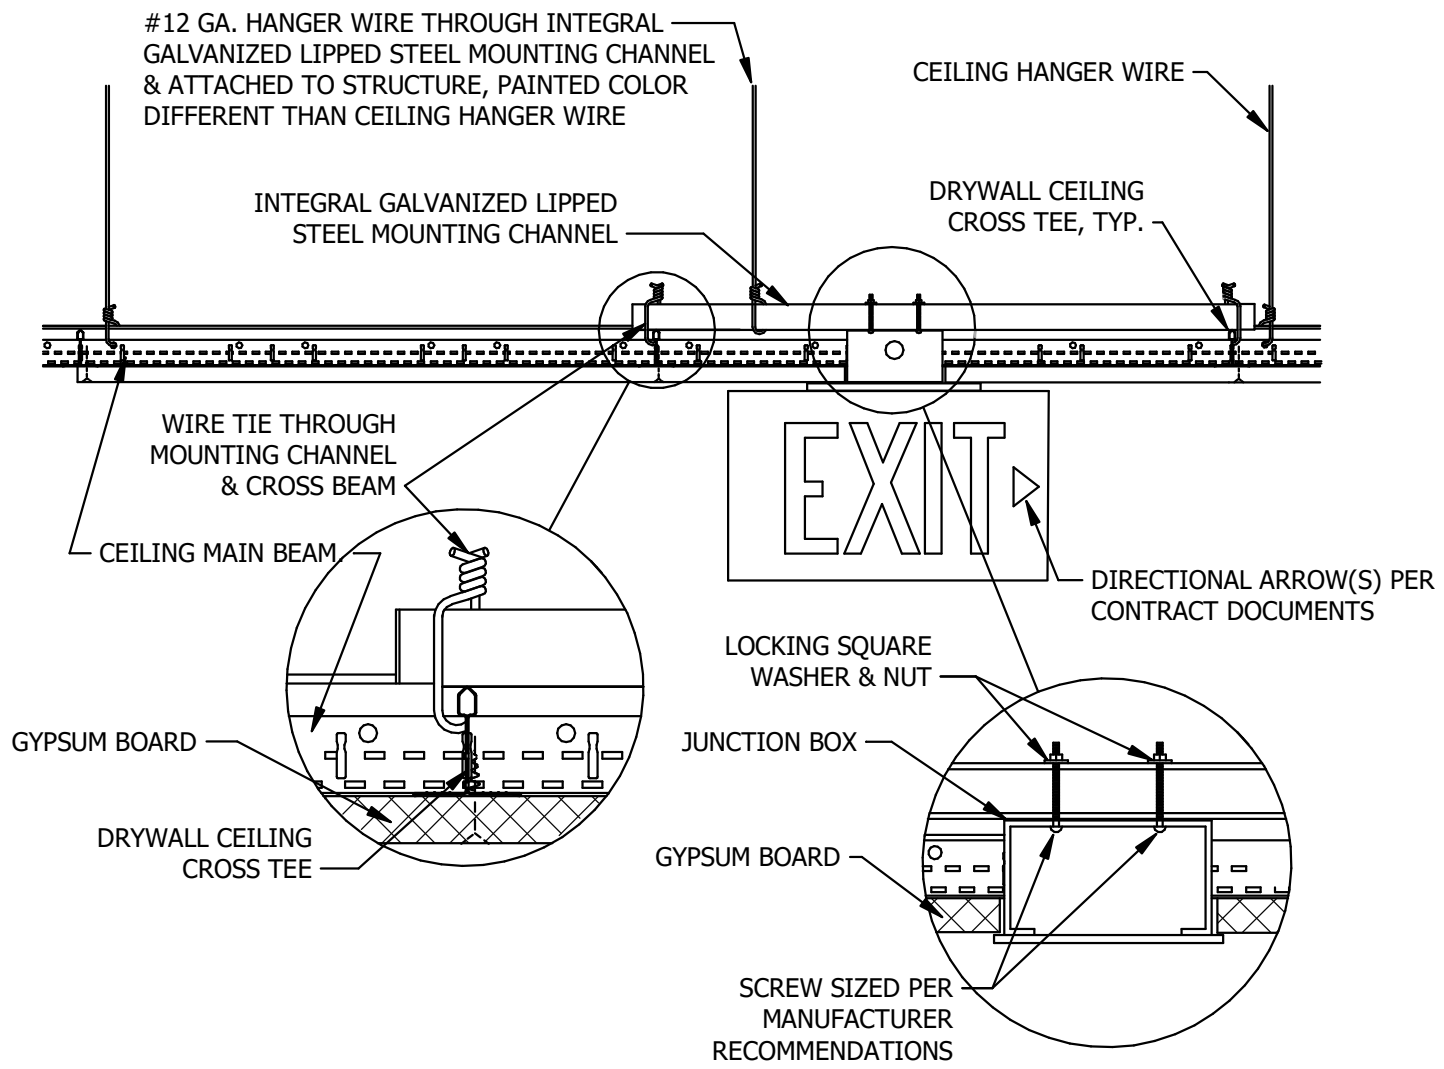

5 EXIT SIGN MOUNTING - GYPBOARD CEILING
NO SCALE

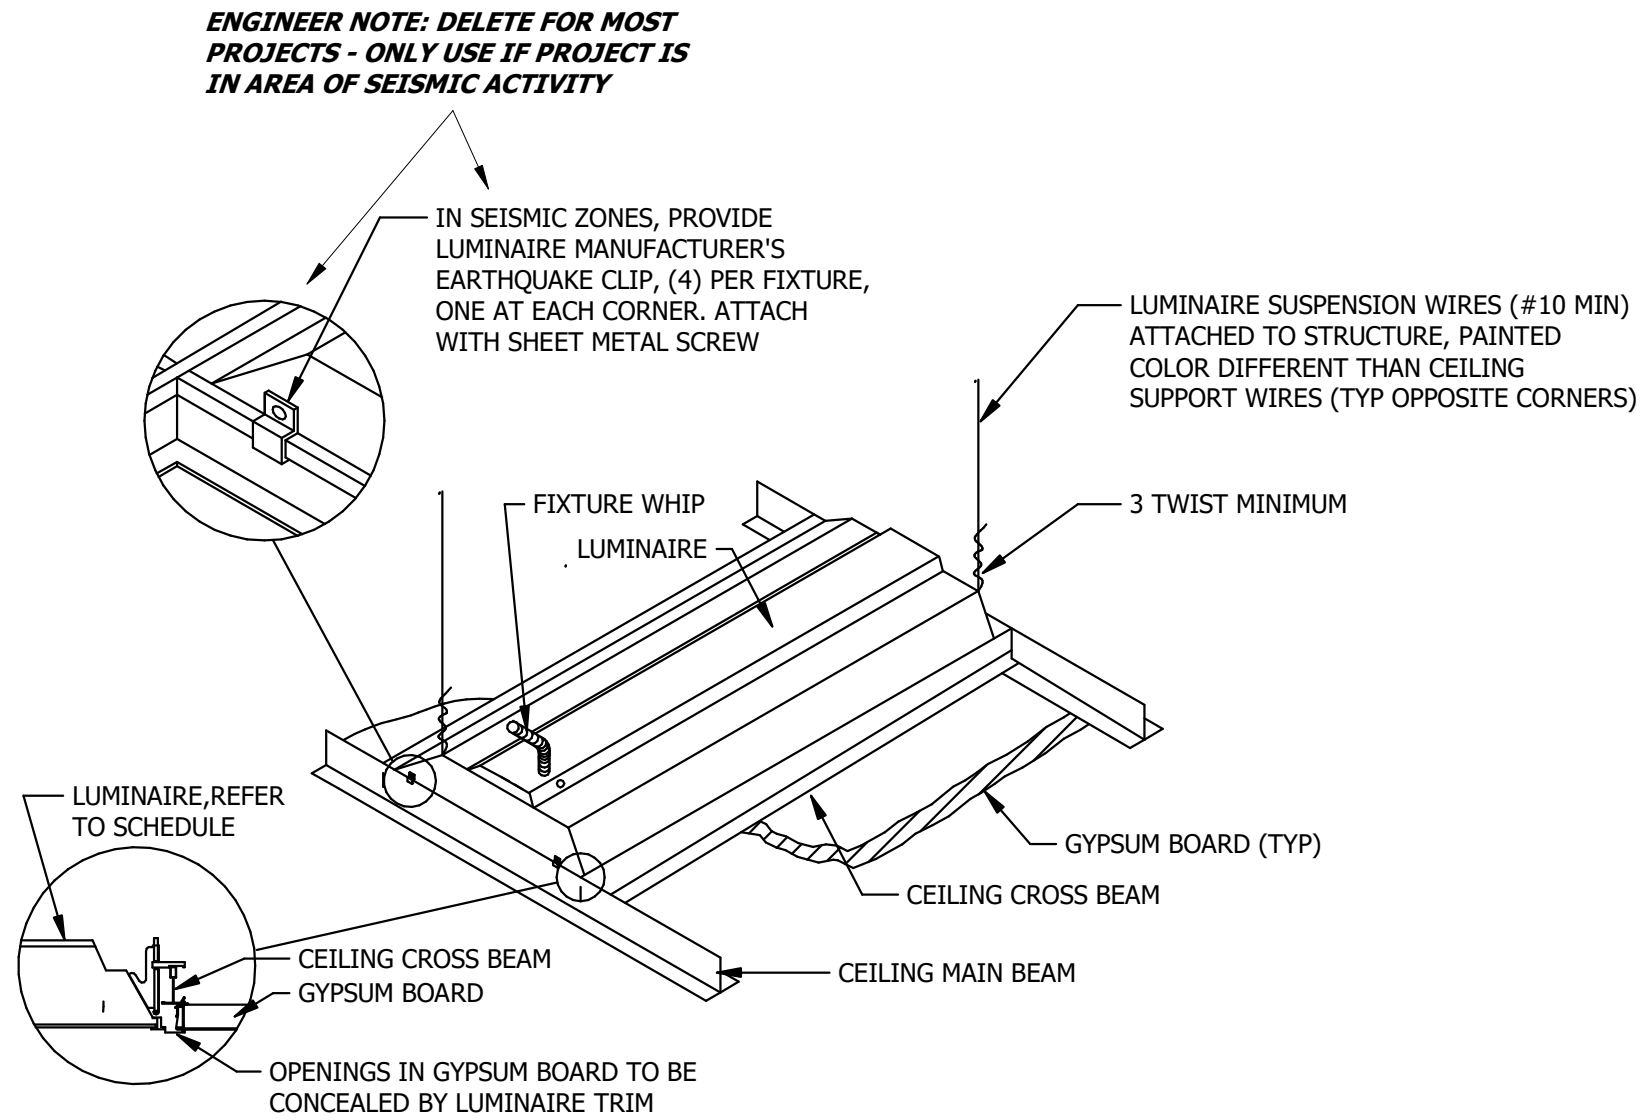

3 LUMINAIRE MOUNTING - GYPBOARD CEILING
NO SCALE

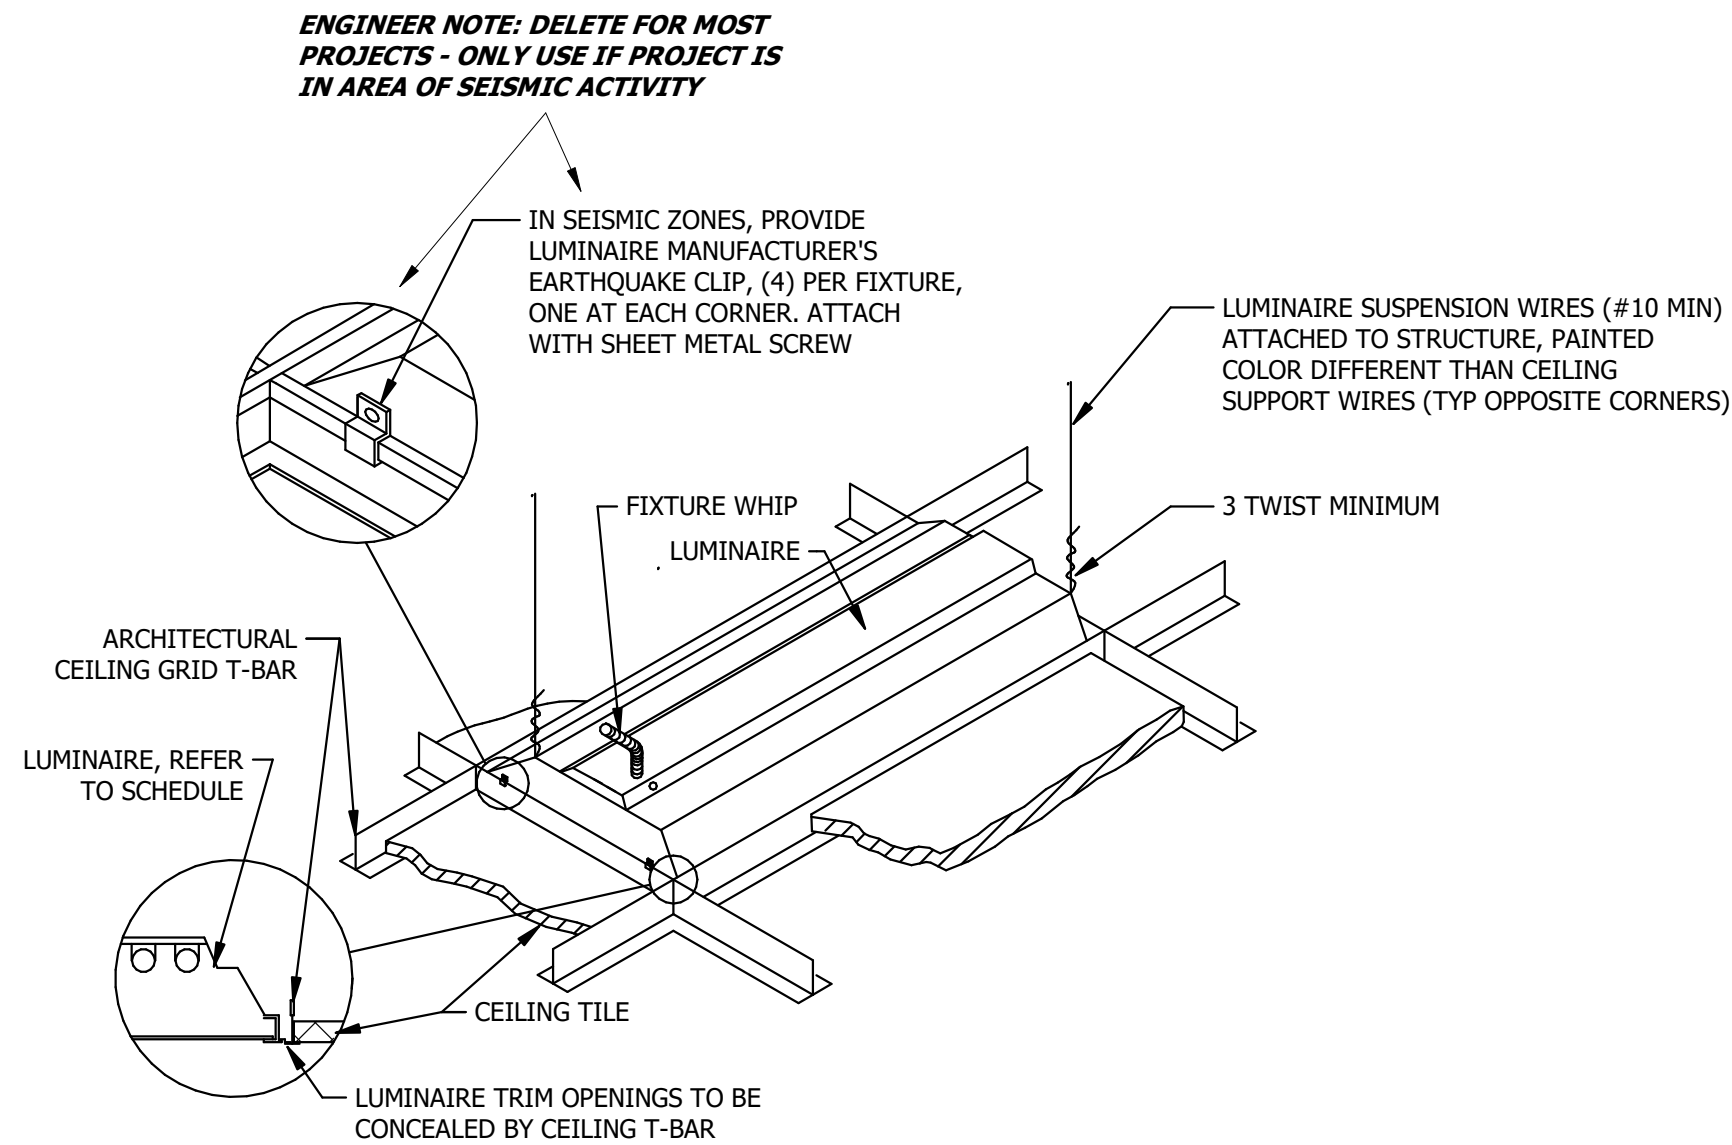

1 LUMINAIRE MOUNTING - ACT CEILING
NO SCALE

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ELECTRICAL
DETAILS

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E701

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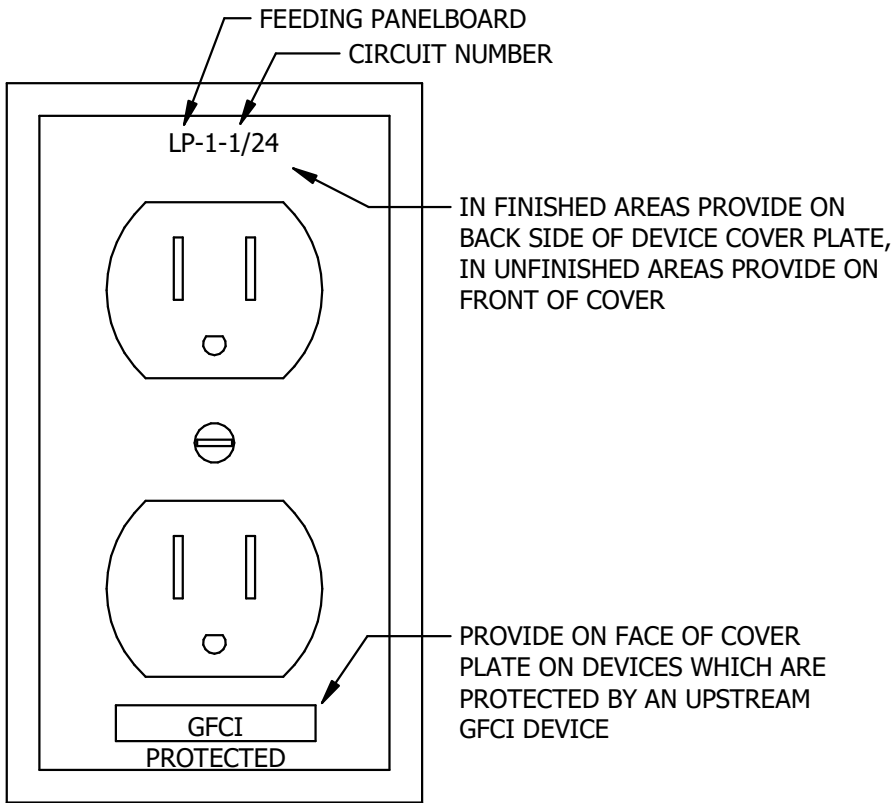
PROJECT NO.: 09625002

NO.	DATE	DESCRIPTION

ELECTRICAL
DETAILS

DRAWING NO.


E702



GENERAL NOTES:

1. LABEL SHALL BE ENGRAVED, PLASTIC LAMINATE OR MACHINE TYPED SELF-ADHESIVE THERMO TAPE. PROVIDE ON EVERY WIRING DEVICE AND JUNCTION BOX COVER, WHICH INCLUDES LIGHT SWITCHES.

3 WIRING DEVICE LABEL DETAIL
NO SCALE

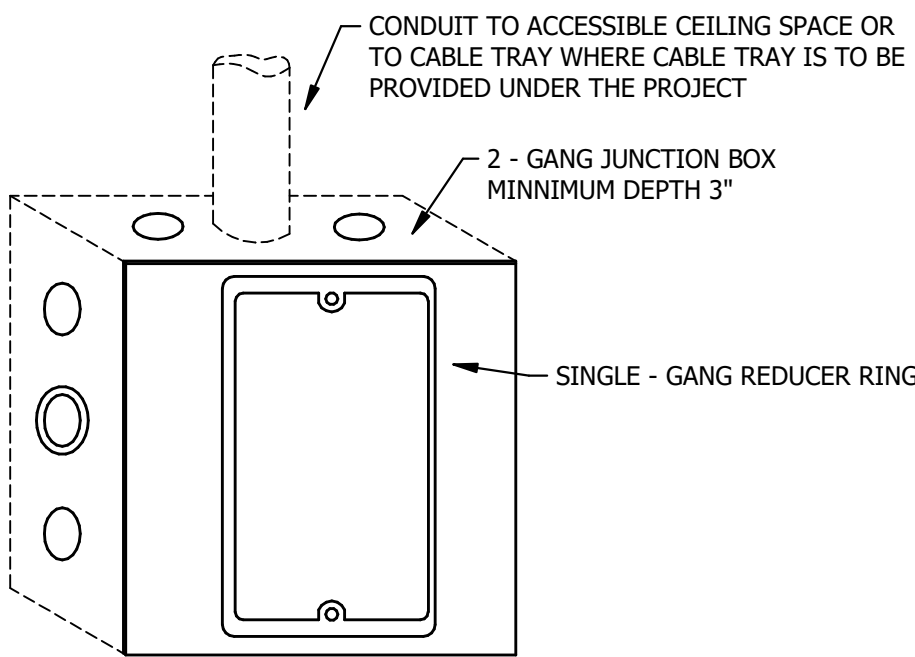


NOTES:

1. INCREASE SIZE OF CONDUIT WHERE SHOWN ON FLOOR PLANS OR WHERE NOTED OTHERWISE.
2. FOR VOICE/DATA AND SECURITY DEVICES PROVIDE CONDUIT SIZE PER DEVICE COUNT AS FOLLOWS: 1-2: 0.75", 3-4: 1.0", 4+: 1.25"
3. FOR TELEVISION AND AUDIO DEVICES PROVIDE CONDUIT SIZE PER DEVICE COUNT AS FOLLOWS: 1-2 : 0.75", ALL ELSE: 1.25"

ENGINEER EDIT NOTE: VERIFY CONDUIT SIZE REVISE DETAIL AS REQUIRED.

2 VOICE/DATA, TV, SECURITY DEVICE OUTLET ROUGH-IN DETAIL
NO SCALE

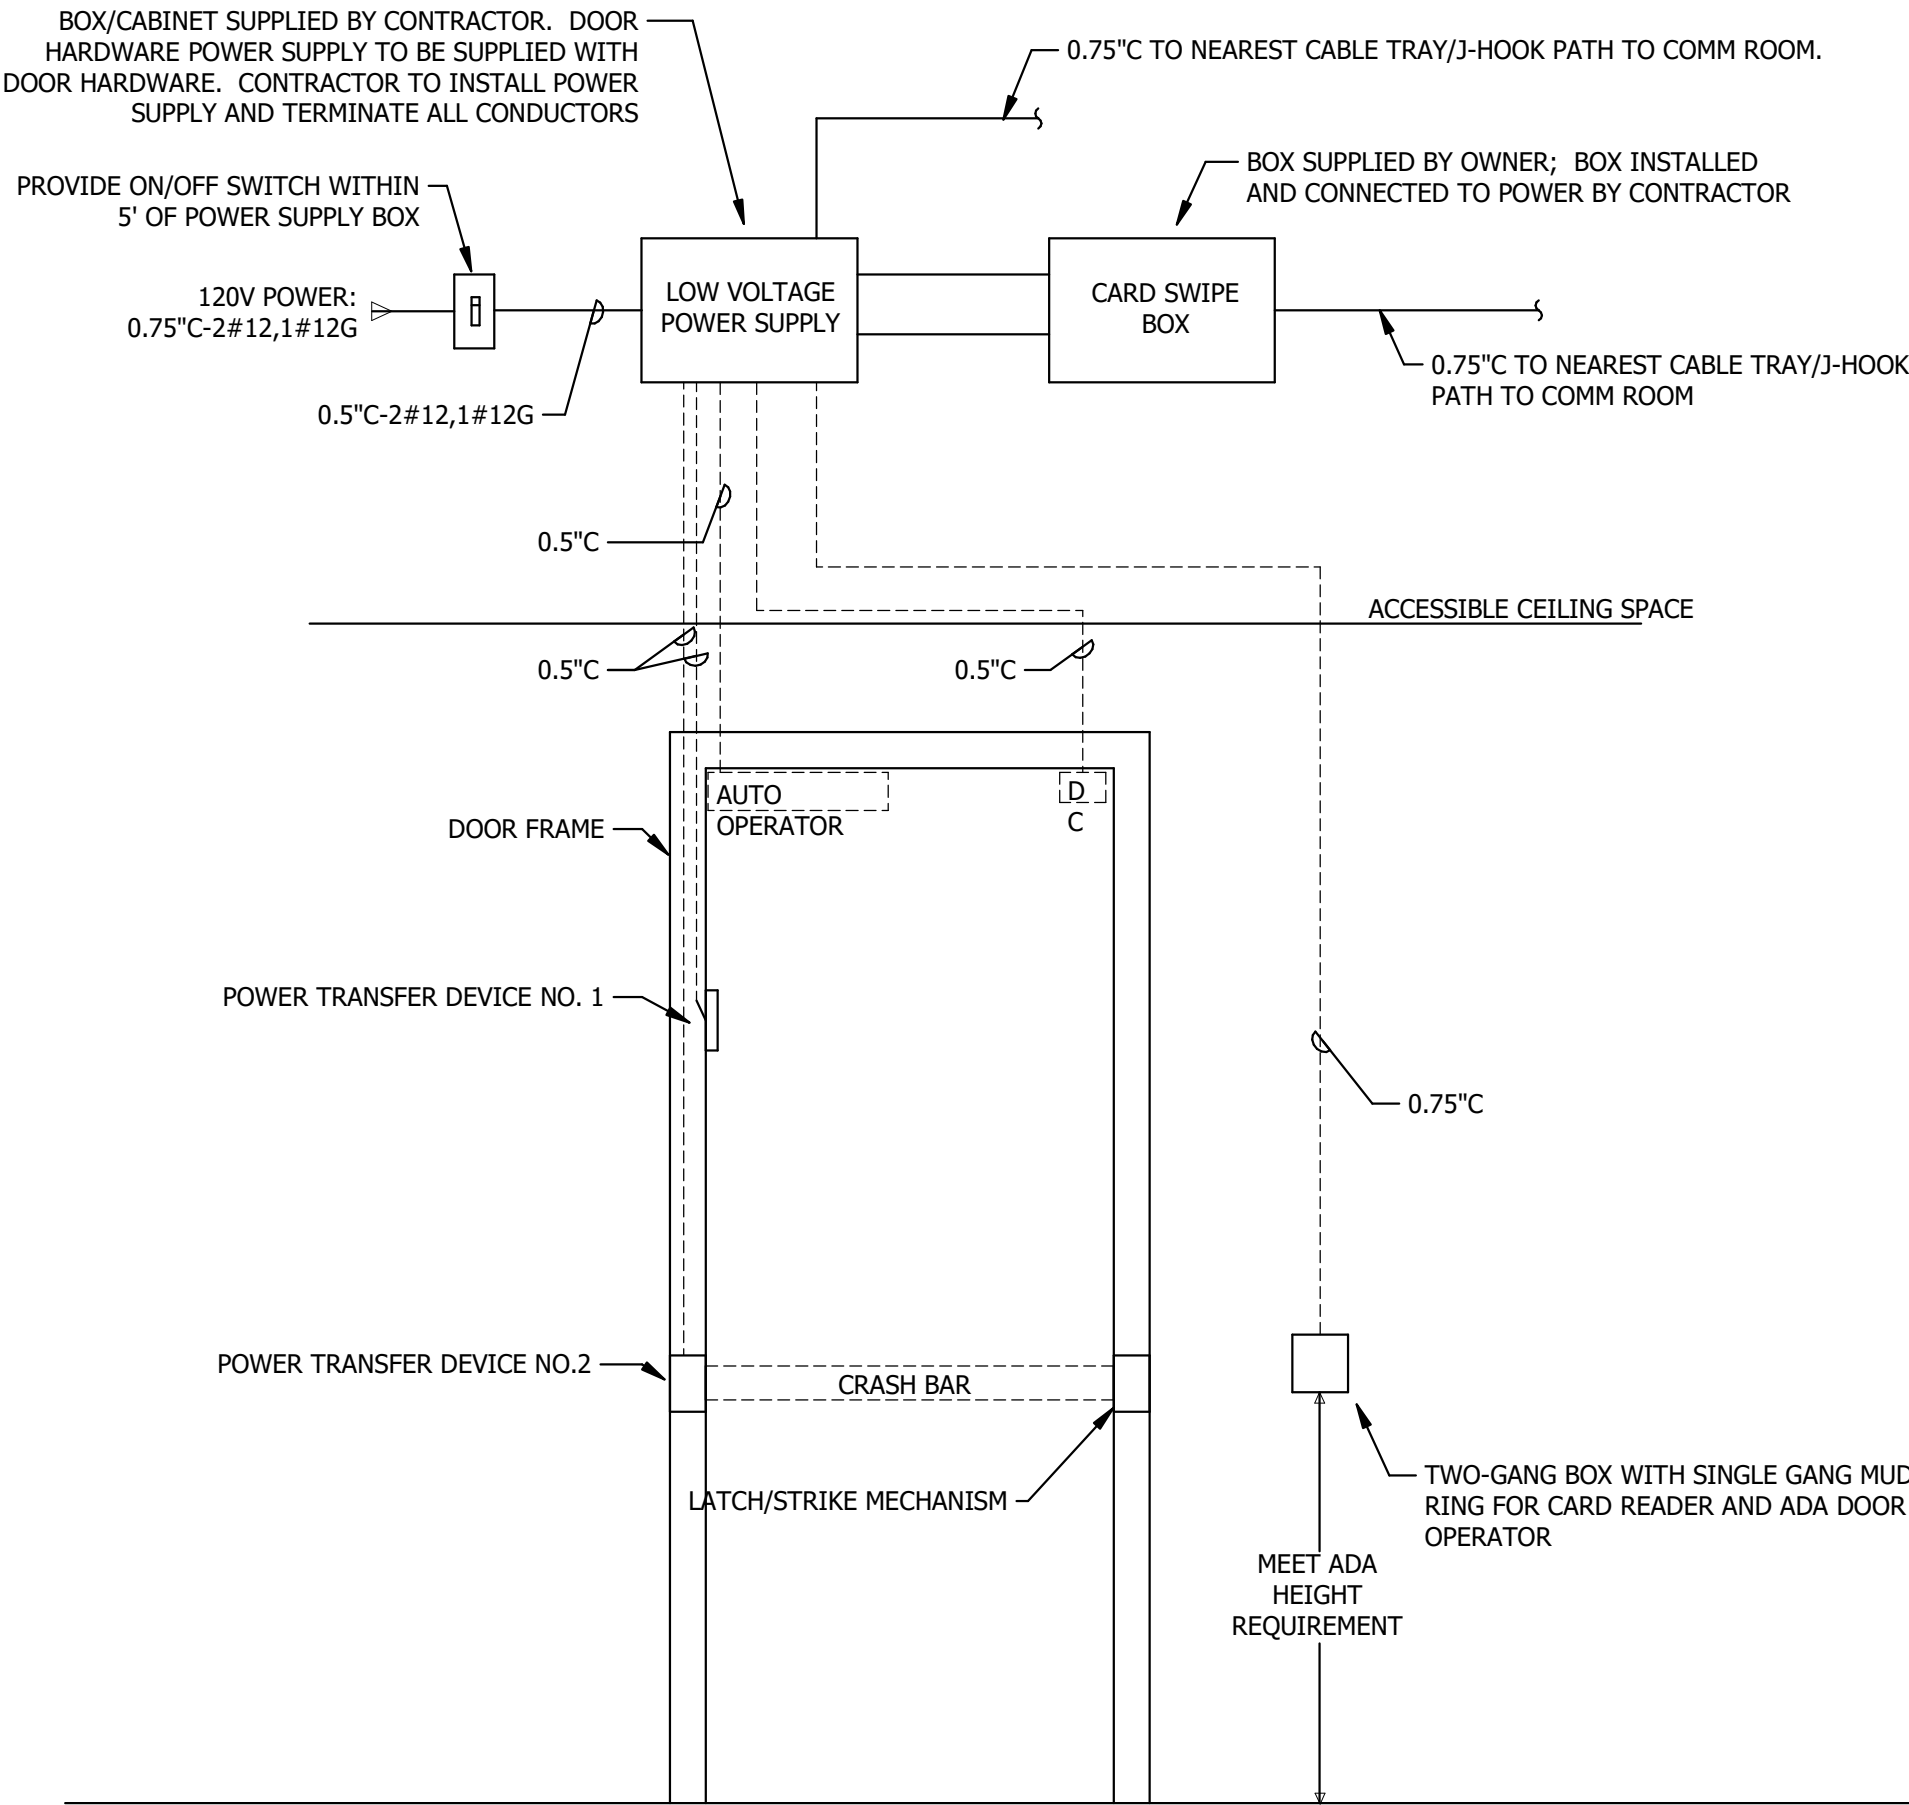

GENERAL NOTES:

1. CONTRACTOR TO COORDINATE DOOR HARDWARE WITH ARCHITECTURAL DOCUMENTS.

1 TYPICAL DOOR ROUGH-IN FOR ACCESS CONTROL
NO SCALE

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PANELBOARD SCHEDULE		NAME: P1		PANEL ID		x		MAIN CIRCUIT BREAKER: 200A				KAIC RATING: 22			
		LOCATION: RECEIVING 112				MAIN LUGS ONLY:				VOLTAGE: 208Y/120					
		MOUNTING: SURFACE						WIRES: 4		PHASE: 3					
CKT	CIRCUIT DESCRIPTION		TRIP	POLES	A		B		C		POLES	TRIP	CIRCUIT DESCRIPTION		CKT
1	L. EXTERIOR		20 A	1	289	1005					1	20 A	*R. RECIEVING SALLYPORT - LOUVERS - GUH-1		2
3	R. STAFF		20 A	1			540	360			1	20 A	R. STAFF REFRIGERATOR		4
5	L. SALLYPORT/VAUL/ORDER - EF-1,4		20 A	1					1172	300	1	20 A	L. RESTROOM/STAFF - EF-2,3		6
7	L. SHOWROOM/LOBBY		20 A	1	561	180					1	20 A	R. ROOF		8
9	R. VAULT/INVENTORY/CORRIDOR - H-1		20 A	1			1260	360			1	20 A	R. OFFICE		10
11	R. TELEPHONE BOARD		20 A	1					360	720	1	20 A	R. RESTROOM/EXTERIOR		12
13	R. SECURITY		20 A	1	540	1440					1	20 A	R. SHOWROOM/LOBBY		14
15	R. ATM		20 A	1			180	360			1	20 A	L. SIGNAGE		16
17	R. ORDER COUNTER		20 A	1					720	360	1	20 A	R. ORDER COUNTER		18
19	EH-1		20 A	1	1500	0					1	20 A	SPARE		20
21	SPARE		20 A	1			0	0			1	20 A	SPARE		22
23	SPARE		20 A	1					0	0	1	20 A	SPARE		24
25	SPARE		20 A	1	0	0					1	20 A	SPARE		26
27	SPARE		20 A	1			0	0			1	20 A	SPARE		28
29	SPARE		20 A	1					0	0	1	20 A	SPARE		30
31	RTU-1		30 A	3	2639	0					1	20 A	SPARE		32
						2639	0			1	20 A	SPARE		34	
								2639	0	1	20 A	SPARE		36	
35	WH-1		60 A	3	5000	2639					3	30 A	RTU-2		38
						5000	2639								40
41									5000	2639					
TOTAL CONNECTED LOAD			43040 VA		TOTAL CALCULATED DEMAND					34432 VA		TOTAL CALCULATED AMPS			96 A
GENERAL NOTES:								KEY NOTES:							
1.								* GFCI RATED BREAKER							
2.								** HACR RATED BREAKER							
3.								*** ISOLATED GROUND CIRCUIT							
4.								L. = LIGHTING							
								R. = RECEPTACLE							

LIGHT FIXTURE SCHEDULE											
FIXTURE ID	FIXTURE TYPE	MOUNTING STYLE	RATED LUMEN OUTPUT	COLOR TEMPERATURE (°K)	VOLTAGE	INPUT WATTS	FIXTURE DESCRIPTION	FINISH COLOR	APPROVED MANUFACTURER	NOTES	
A	2X4 FLAT PANEL LED	RECESSED	4,000-5,000 LUMENS, 80CRI MIN	4000K	120 V	34 W	UV RESISTANT ACRYLIC LENS, HOUSING DEPTH LESS THAN 1", OVERALL DEPTH WITH DRIVER LESS THAN 2", EDGE LIT LED, IC RATED	WHITE	LITHONIA CPX SERIES, OR EQUAL ELITE 24FPL-BL SERIES, OR EQUAL		
B	6" LED DOWNLIGHT	B	1500 LUMENS	4000K	120 V	16 W	6" LED RECESSED DOWNLIGHT	WHITE	PORTER PT-CDL2 , OR EQUAL		
C	LED WALL MOUNT VANITY FIXTURE	C	3000 LUMENS	4000K	120 V	30 W	WALL MOUNT RESTROOM VANITY FIXTURE	WHITE	COLUMBIA WVM, OR EQUAL		
D	8 FOOT PENDANT MOUNT LINEAR LED FIXTURE	PENDANT	6000 LUMENS	4000K	120 V	45 W	LINEAR LED CONTINUOUS PENDANT MOUNT FIXTURE	WHITE	LITE CONTROL 6L-P-ID, OR EQUAL		
D1	4 FOOT PENDANT MOUNT LINEAR LED FIXTURE	PENDANT	6000 LUMENS	4000K	120 V	20 W	LINEAR LED CONTINUOUS PENDANT MOUNT FIXTURE	WHITE	LITE CONTROL 6L-P-ID, OR EQUAL		
EG	LED WALL MOUNT EXTERIOR LIGHT	WALL MOUNT	LED 500 LUMENS	3000K	120 V	55 W	EXTERIOR WALL MOUNT LED AREA LIGHT	DARK BRONZE	LITHONIA AFF SERIES, OR EQUAL		
EX	EXIT SIGN WITH EMERGENCY HEADS	UNIVERSAL	LED		120 V	4 W	THERMOPLASTIC IMPACT RESISTANT, SCRATCH RESISTANT, NICKEL-CADMIUM BATTERY. DUAL-HEAD EXIT SIGN, WITH (1) REMOTE HEAD, SELF DIAGNOSTICS.	WHITE HOUSING, RED LETTERS	LITHONIA LHQM SERIES, OR EQUAL ELITE ELX SERIES, OR EQUAL		
F	4' LENSED LED STRIP LIGHT	SURFACE/CEILING	LED 5,000-5,500 LUMENS, 80CRI MIN	4000K	120 V	32 W	COMPACT LINEAR METAL CHANNEL, FROSTED WRAPPED ROUND DIFFUSE LENS.	WHITE	LITHONIA CLX SERIES, OR EQUAL ELITE 4-OEC SERIES, OR EQUAL		
W1	LED WALL MOUNT EXTERIOR LIGHT	WALL MOUNT	LED 8000 LUMENS	3000K	120 V	55 W	EXTERIOR WALL MOUNT LED AREA LIGHT	DARK BRONZE	LITHONIA TWR LED SERIES, OR EQUAL		
W2	LED WALL MOUNT EXTERIOR LIGHT	WALL MOUNT	LED 2000 LUMENS	3000K	120 V	7 W	EXTERIOR WALL MOUNT LED AREA LIGHT	DARK BRONZE	LITHONIA WDGE1 LED SERIES, OR EQUAL		

EQUIPMENT CONNECTION SCHEDULE																	
MOTOR/ EQUIPMENT ID	LOCATION	HP	ELECTRIC HC KW	FLA	MCA	MOCP	VOLTAGE	PHASE	DISCONNECT INFORMATION			STARTER INFORMATION			FEEDER SIZE	NOTES	
									PROVIDED BY	AMPERAGE	FUSES	LOCATION	PROVIDED BY	TYPE/SIZE			LOCATION
EF-1	113 SALLYPORT	FRAC	---	2.8	3.5	20	120 V	1	MFR	---	---	WITH UNIT	MFR	---	WITH UNIT	0.75"C-2#12+1#12G	5
EF-2	105 REST ROOM	FRAC	---	0.29	0.4	20	120 V	1	MFR	---	---	WITH UNIT	MFR	---	WITH UNIT	0.75"C-2#12+1#12G	4
EF-3	104 REST ROOM	FRAC	---	0.29	0.4	20	120 V	1	MFR	---	---	WITH UNIT	MFR	---	WITH UNIT	0.75"C-2#12+1#12G	4
EF-4	113 STOR	FRAC	---	2.8	3.5	20	120 V	1	MFR	---	---	WITH UNIT	MFR	---	WITH UNIT	0.75"C-2#12+1#12G	4
EH-1	102 LOBBY	---	1.5	---	---	20	120 V	1	MFR	---	---	WITH UNIT	MFR	---	WITH UNIT	0.75"C-2#12+1#12G	2
GUH-1	113 SALLYPORT	FRAC	---	1.9	---	20	120 V	1	MFR	---	---	WITH UNIT	MFR	---	WITH UNIT	0.75"C-2#12+1#12G	
H-1	113 STOR	---	1.2	5.2	6	20	120 V	1	DIV26	30A	NFS	AT UNIT	MFR	---	WITH UNIT	0.75"C-2#12+1#12G	
L-1	113 SALLYPORT	FRAC	---	---	---	20	110 V	1	MFR	---	---	WITH UNIT	DIV23	---	WITH UNIT	0.75"C-2#12+1#12G	3
L-2	113 SALLYPORT	FRAC	---	---	---	20	110 V	1	MFR	---	---	WITH UNIT	DIV23	---	WITH UNIT	0.75"C-2#12+1#12G	3
L-3	113 STOR	FRAC	---	---	---	20	110 V	1	MFR	---	---	WITH UNIT	DIV23	---	WITH UNIT	0.75"C-2#12+1#12G	3
RTU-1	ROOF	1	---	20	22	30	208 V	3	MFR	---	---	WITH UNIT	MFR	---	WITH UNIT	0.75"C-3#10+1#12G	1
RTU-2	ROOF	1	---	20	22	30	208 V	3	MFR	---	---	WITH UNIT	MFR	---	WITH UNIT	0.75"C-3#10+1#12G	1
WH-1	113 SALLYPORT	---	15	41.6	52.1	60	208 V	3	DIV26	60A	NFS	AT UNIT	MFR	---	WITH UNIT	0.75"C-3#6+1#10G	
NOTES: 1. UNIT SHALL HAVE A SINGLE POINT CONNECTION TO UNIT CONTROL PANEL. 2. UNIT FURNISHED BY DIV23 AND INSTALLED BY DIV26. 3. PROVIDE 120V CONNECTION TO MOTORIZED DAMPER PROVIDED BY DIV23. CONTROLS BY DIV23. 4. UNIT SHALL BE INTERCONNECTED TO LIGHTING CIRCUIT AND OCCUPANCY SENSOR/LIGHTING CONTROL DEVICE CONTROLLING SPACE. PROVIDE PILOT LIGHT INDICATOR AS REQUIRED. 5. UNIT SHALL BE INTERCONNECTED TO LIGHTING CIRCUIT AND OCCUPANCY SENSOR CONTROLLING SPACE DEVICE CONTROLLING SPACE. PROVIDE PILOT LIGHT INDICATOR AS REQUIRED. ADDITIONALLY, UNIT SHALL BE ACTIVATED ON CONTACT CLOSURE OF GAS SENSOR. REFER TO MECHANICAL FOR MORE INFORMATION.												MFR = PROVIDED BY MANUFACTURER/FACTORY DIV23 = PROVIDED BY DIVISION 23 OR INSTALLED PER MANUFACTURER RECOMMENDATIONS. DIV26 = PROVIDED BY DIVISION 26. NFS = NON-FUSED SWITCH					

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Philip Haight

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LICENSE #: 59791

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NO.	DATE	DESCRIPTION

ELECTRICAL SCHEDULES

DRAWING NO.

E901