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ELECTRICAL ABBREVIATIONS			
A, AMP	AMPERES	M	METER
ABV	ABOVE	MC	MOMENTARY CONTACT OR MECHANICAL CONTRACTOR
AG	ABOVE GRADE		
AA	AUDIBLE ALARM	MCB	MAIN CIRCUIT BREAKER
AC	ABOVE COUNTER	MCC	MOTOR CONTROL CENTER
ACH	ABOVE COUNTER HEIGHT	MH	MAN HOLE
ADD	ADDENDUM	MLO	MAIN LUG ONLY
AFC	AVAILABLE FAULT CURRENT	MMFO	MULTI MODE FIBER OPTIC
AFCI	ARC FAULT CIRCUIT INTERRUPTER	MRS	MOTOR RATED SWITCH
AFF	ABOVE FINISHED FLOOR	MSB	MAIN SWITCHBOARD
AHU	AIR HANDLING UNIT	MT	EMPTY
AL	ALUMINUM	MTR	MOTOR
ANT	ANTENNA	N	NEUTRAL
ATS	AUTOMATIC TRANSFER SWITCH	NC	NORMALLY CLOSED
AV	AUDIO VISUAL	NEC	NATIONAL ELECTRICAL CODE
AWG	AMERICAN WIRE GUAGE	NIC	NOT IN CONTRACT
BAS	BUILDING AUTOMATION SYSTEM	NO	NORMALLY OPEN
BFC	BELOW FINISHED CEILING	NTS	NOT TO SCALE
BPS	BOLTED PRESSURE SWITCH	OC	ON CENTER
C	CONDUIT OR CONTROLLED RECEPT	PB	PULL BOX OR PUSHBUTTON
CAB	CABINET	PE	PNEUMATIC ELECTRIC
CB	CIRCUIT BREAKER	PF	POWER FACTOR
CCTV	CLOSED CIRCUIT TV	PH	PHASE
CKT	CIRCUIT	PNL	PANEL
CLG	CEILING	PRI	PRIMARY
COMM	COMMUNICATIONS	PT	POTENTIAL TRANSFORMER
CT	CURRENT TRANSFORMER	R	RACEWAY
CTRL	CONTROL	RECEPT	RECEPTACLE
CU	COPPER	REFG	REFRIGERATOR
DAS	DISTRIBUTED ANTENNA SYSTEM	RTU	ROOF TOP UNIT
DED	DEDICATED	SEC	SECONDARY
DN	DOWN	SGB	SERVICE GROUND BAR
EC	ELECTRICAL CONTRACTOR	SMFO	SINGLE MODE FIBER OPTIC
EGB	ELECTRICAL GROUND BAR	SPKR	SPEAKER
ELEC	ELECTRIC OR ELECTRICAL	STP	SHIELDED TWISTED PAIR
EM	EMERGENCY	SUB	SUBSTATION
EMT	ELECTRICAL METALLIC TUBING	SW	SWITCH
ENCL	ENCLOSURE	SWBD	SWITCHBOARD
EP	ELECTRIC PNEUMATIC	TEL	TELEPHONE
EPO	EMERGENCY POWER OFF	TELCOM	TELECOMMUNICATIONS
EW	ELECTRIC WATER COOLER	TGB	TELECOMMUNICATIONS GROUND BAR
F	FUSE OR FUSED	TMGB	TELECOMMUNICATIONS MAIN GROUND BAR
FA	FIRE ALARM	TR	TAMPER RESISTANT
FAAP	FIRE ALARM ANNUNCIATOR PANEL	TSTAT	THERMOSTAT
FACP	FIRE ALARM CONTROL PANEL	TYP	TYPICAL
FB	FLOOR BOX	UC	UNDER COUNTER
FO	FIBER OPTIC	UF	UNDER FLOOR
FSD	FIRE-SMOKE DAMPER	UG	UNDER GROUND
FV	FILM VIEWER	UH	UNIT HEATER
G, GND	GROUND	UNO	UNLESS NOTED OTHERWISE
GC	GENERAL CONTRACTOR	USB	UNIVERSAL SERIAL BUS
GFEP	GROUND FAULT EQUIPMENT PROTECTION	UTP	UNSHIELDED TWISTED PAIR
GFI, GFCI	GROUND FAULT CIRCUIT INTERRUPTER	V	VOLT OR VOLTAGE
HH	HAND HOLE	VA	VOLT-AMP
HOA	HAND OFF AUTO	VAC	VOLTS ALTERNATING CURRENT
IG	ISOLATED GROUND	VDC	VOLTS DIRECT CURRENT
JBOX	JUNCTION BOX	W	WATT, WIRE OR WALL PHONE
KV	KILOVOLT	WAP	WIRELESS ACCESS POINT
KVA	KILOVOLT-AMP	WP	WEATHERPROOF
KW	KILOWATT	X	EXISTING
KWH	KILOWATT-HOUR	XFMR	TRANSFORMER

SYMBOL	DESIGNATIONS	MTG HT
SYMBOL SCHEDULE NOTES		
A. THESE SYMBOLS COMPRISE A STANDARD LIST, NOT ALL SYMBOLS MAY APPEAR ON THESE DRAWINGS.		
B. MOUNTING HEIGHTS INDICATED ARE STANDARD. DIMENSIONAL NUMBERS INDICATED AT DEVICES SHALL OVERRIDE THESE STANDARDS. MOUNTED HEIGHTS ARE TO THE CENTER OF THE DEVICE, UNLESS NOTED OTHERWISE.		
C. MOUNTING HEIGHTS INDICATED ARE FOR STUD WALL CONSTRUCTION. WHEN BLOCK OR BRICK CONSTRUCTION IS USED, ADJUST MOUNTING HEIGHTS TO ALIGN DEVICE PLATES WITH RUNNING JOINT.		
D. REFER TO SPECIFICATIONS FOR FURTHER INFORMATION.		
GENERAL		
	HEAVY DASHED LINE WEIGHT INDICATES EXISTING ITEM TO BE REMOVED.	
	LIGHT SOLID LINE WEIGHT INDICATES EXISTING ITEM TO REMAIN.	
	HEAVY SOLID LINE WEIGHT INDICATES NEW ITEM OR NEW LOCATION.	
R	REMOVE EXISTING ITEM	
RL	REMOVE EXISTING ITEM AND RELOCATE AS INDICATED	
X	EXISTING ITEM TO REMAIN	
NL	NEW LOCATION FOR RELOCATED ITEM	
NOTES & TAGS		
	EQUIPMENT IDENTIFICATION TAG - SEE EQUIPMENT SCHEDULES	
	FEEDER SIZE TAG - SEE POWER RISER SCHEDULE	
	ELEC EQUIP CONNECTION TAG - SEE EQUIP SCHEDULE	
	KEYNOTE	
	MISCELLANEOUS NOTE	
	LIGHTING CONTROL SEQUENCE - SEE SCHEDULE	
X" H X' - X" AFF symbol"/>	CABLE TRAY TAG X" W - WIDTH OF CABLE TRAY X" H - HEIGHT OF CABLE TRAY X' - X" AFF - MOUNTING HEIGHT OF CABLE TRAY (FROM FINISH FLOOR TO BOTTOM OF TRAY)	
RACEWAYS		
	CONDUIT CONCEALED IN CEILING OR WALLS	
	CONDUIT CONCEALED IN THE FLOOR OR BELOW	
	CONDUIT EXPOSED ON THE CEILING OR WALLS	
	CONDUIT BURIED UNDERGROUND (# = DEPTH)	
	CONDUIT WITH BEND DOWN	
	CONDUIT WITH BEND UP	
	CONDUIT WITH BUSHED END	
	CONDUIT WITH BREAK OR CONTINUATION	
	CIRCUIT HOME RUN - L1 INDICATES PANEL - NUMBER	
	PULL BOX, SIZE AS NOTED	
	JUNCTION BOX - WALL/CEILING MOUNT	
	WIREWAY, DUCT BANK, OR FLOOR DUCT AS NOTED	
	CABLE TRAY, TYPE/SIZE AS INDICATED	
LIGHTING		
	LIGHT FIXTURE ID - REFER TO LIGHT FIXTURE SCHEDULE (SCHEDULE OVERRIDES SYMBOL ABBREVIATION) A - INDICATES LIGHT FIXTURE TYPE # - INDICATES CIRCUIT NUMBER b - INDICATES SWITCHING	
	LIGHT FIXTURE CIRCUIT TYPE - NO HATCH INDICATES NORMAL CIRCUIT - ANGLED HATCH INDICATES CRITICAL CIRCUIT - SOLID HATCH INDICATES LIFE SAFETY CIRCUIT	
	TROFFER TYPE LIGHT FIXTURE, SIZE AS INDICATED - CEILING MOUNT	
	CHANNEL OR INDUSTRIAL, LENGTH AS INDICATED	
	CHANNEL OR INDUSTRIAL WALL MOUNT, LENGTH AS INDICATED	
	ROUND DOWNLIGHT, RECESSED OR SURFACE MOUNT	
	CEILING WALL WASH FIXTURE OR TRACK HEAD	
	WALL MOUNT FIXTURE OR SCONCE	VERIFY
	LINEAR SUSPENDED , LENGTH AS INDICATED	VERIFY
	LINEAR RECESSED, LENGTH AS INDICATED	VERIFY
	ROUND OR SQUARE PENDANT	
	TAPE OR ROPE LIGHT	
	VANITY FIXTURE	
	EMERGENCY BATTERY LIGHT - WALL/CEILING MOUNT	
	EXIT LIGHT, FILLED QUADRANT INDICATES FACES - WALL/CEILING MOUNT	VERIFY
	WALL PACK	VERIFY
	FLAG OR FLOOD LIGHT	
	SITE LIGHTING POLE FIXTURE, ROUND/RECTANGLE HEAD - NUMBER OF HEADS INDICATED	
	SITE LIGHTING ROUND OR SQUARE BOLLARD	

SYMBOL	DESIGNATIONS	MTG HT
ONE LINE AND RISER		
	UTILITY SERVICE: EQUIPMENT ID VOLTAGE, PHASE, 3 OR 4 WIRE	
	ENGINE GENERATOR: EQUIPMENT ID KW/KVA RATING OF GENERATOR VOLTAGE, PHASE, 3 OR 4 WIRE, POWER FACTOR	
	600 VOLT MOLDED CASE CIRCUIT BREAKER: AF = AMP FRAME, AT = AMP TRIP XX = OPTIONS TO BE PROVIDED, MAY BE BLANK	
	600 VOLT INSULATED CASE CIRCUIT BREAKER: AF = AMP FRAME, AT = AMP TRIP XX = OPTIONS TO BE PROVIDED, MAY BE BLANK	
	600 VOLT DRAWOUT CIRCUIT BREAKER: AF = AMP FRAME, AT = AMP TRIP XX = OPTIONS TO BE PROVIDED, MAY BE BLANK	
	15,000 VOLT DRAWOUT CIRCUIT BREAKER: AF = AMP FRAME, AT = AMP TRIP XX = OPTIONS TO BE PROVIDED, MAY BE BLANK	
	DISCONNECT SWITCH: AS = AMP SWITCH XX = OPTIONS TO BE PROVIDED, MAY BE BLANK	
	FUSE: AF = AMP FUSE XX = OPTIONS TO BE PROVIDED, MAY BE BLANK	
	FUSED DISCONNECT SWITCH: AS = AMP SWITCH, AF = AMP FUSE XX = OPTIONS TO BE PROVIDED, MAY BE BLANK	
	TRANSFORMER: EQUIPMENT ID KVA RATING OF TRANSFORMER PRIMARY VOLTAGE SECONDARY VOLTAGE	
	TRANSFORMER WITH SPECIAL CORE: EQUIPMENT ID KVA RATING OF TRANSFORMER PRIMARY VOLTAGE SECONDARY VOLTAGE	
	PANELBOARD: EQUIPMENT ID VOLTAGE, PHASE, 3 OR 4 WIRE, AMP RATING MCB OR MLO SPACES AVAILABLE CALCULATED FAULT CURRENT	
	TRANSFER SWITCH: EQUIPMENT ID VOLTAGE, PHASE, 3 OR 4 WIRE, AMP RATING OPEN/CLOSED/DELAYED CALCULATED FAULT CURRENT	
	MOTOR: EQUIPMENT ID HORSEPOWER, PHASE	
	MULTIFUNCTION RELAY: NUMBERS INDICATE ANSI DEVICE NUMBERS	
	FEEDER DESCRIPTION: SEE ELECTRICAL ONE LINE SHEET FOR SCHEDULE	
	STATIC SWITCH	
	LIGHTNING ARRESTER	
	GROUND CONNECTION	
	CONTACTOR - NORMALLY OPEN	
	CONTACTOR - NORMALLY CLOSED	
	KIRK KEY INTERLOCK	
	METER: M = WATT/OUR METER, A = AMMETER, V = VOLT METER	
	15,000 VOLT TEE AND ELBOW	
	LINEWORK:	
	EQUIPMENT ENCLOSURE LINE	
	SWITCHGEAR BUS LINE	
	BUSWAY	
	NEW WORK	
	EXISTING WORK	
	DEMO WORK	
	FUTURE WORK	

SYMBOL	DESIGNATIONS	MTG HT
FIRE ALARM		
	MANUAL PULL STATION	48"
	HEAT DETECTOR (R=FIXED TEMP, R=RATE OF RISE)	
	SMOKE DETECTOR (P=PHOTOELECTRIC, I=IONIZATION)	
	DUCT MOUNTED PHOTOELECTRIC DETECTOR	
	BEAM DET (B-T=TRANSMITTER, B-R=RECEIVER)	VERIFY
	COMBINATION SMOKE DETECTOR AND ALARM	
	REMOTE STATION - WALL/CEILING MOUNT	72"
	REMOTE INDICATOR LAMP - WALL/CEILING MOUNT	72"
	FLOW SWITCH	
	TAMPER SWITCH	
	MONITOR MODULE	
	CONTROL MODULE	
	FIRE/SMOKE DAMPER CONNECTION	
	DOOR HOLD OR DOOR HOLD CONNECTION	VERIFY
	FIREMAN'S STATION - WALL MOUNT	48"
	STROBE - WALL/CEILING MOUNT (# = CANDELA)	82"
	BELL - WALL/CEILING MOUNT	82"
	BELL/STROBE - WALL/CEILING MOUNT (# = CANDELA)	82"
	CHIME - WALL/CEILING MOUNT	82"
	CHIME/STROBE - WALL/CEILING MOUNT (# = CANDELA)	82"
	HORN - WALL/CEILING MOUNT	82"
	HORN/STROBE - WALL/CEILING MOUNT (# = CANDELA)	82"
	SPEAKER - WALL/CEILING MOUNT	82"
	SPEAKER/STROBE - WALL/CEILING MOUNT (# = CANDELA)	82"
	COMBINATION FIRE ALARM/MASS NOTIFICATION: SPEAKER/STROBE - WALL/CEILING MOUNT(# = CANDELA)	82"
	FIRE ALARM CONTROL PANEL - WALL MOUNT	VERIFY
SIGNAL AND COMMUNICATIONS		
	DATA BOX - WALL MOUNT (# = WIRE COUNTS)	18"
	VOICE/DATA BOX - WALL MOUNT/FLOOR BOX (# = WIRE COUNTS)	18"
	VOICE BOX - WALL MOUNT (# = WIRE COUNTS)	18"
	DOUBLE GANG VOICE BOX - HIGH WALL MOUNT	48"
	WIRELESS ACCESS POINT - WALL/CEILING MOUNT	VERIFY
	SPEAKER - WALL/CEILING MOUNT	96"
	HORN SPEAKER - WALL MOUNT	96"
	VOLUME SWITCH - WALL MOUNT	60"
	AUDIO JACK (M=MICROPHONE, A=AUXILIARY)	18"
	WALL INTERCOM STATION (M=MASTER, R=REMOTE)	48"
	BUZZER - WALL/CEILING MOUNT	96"
	BELL - WALL/CEILING MOUNT	96"
	CHIME - WALL/CEILING MOUNT	96"
	CLOCK - WALL/CEILING MOUNT (# = DIAMETER)	96"
	PROJECTOR/VIDEO CAMERA/DOCUMENT CAMERA - WALL/CEILING MOUNT	VERIFY
	TV SYSTEM OUTLET - WALL/CEILING MOUNT	18"
	AUDIO VIDEO SYSTEM OUTLET - WALL/CEILING MOUNT	18"
	A/V SYSTEMS CONTROLLER - WALL MOUNT	18"
	A/V MONITOR - WALL MOUNT	18"
	ANNUNCIATOR PANEL - WALL MOUNT	VERIFY
SECURITY		
	SECURITY - WALL MOUNT - TYPICAL	48"
	CR - CARD READER	EP - EXIT PUSHBUTTON
	KP - KEYPAD	M - MASTER STATION
	KS - KEY SWITCH	
	SECURITY - CEILING MOUNT - TYPICAL	
	RX - REQUEST TO EXIT	DC - DOOR CONTACT
	ES - ELECTRIC STRIKE	ODC - OVERHEAD DOOR CONTACT
	EL - ELECTRIC LOCK	MS - MONITOR STRIKE
	ML - MAGNETIC LOCK	MD - MOTION DETECTOR
	TH - POWER TRANSFER HINGE	GB - GLASS BREAKER DETECTOR
	SECURITY CAMERA - WALL/CEILING MOUNT	VERIFY
	SECURITY PANEL - WALL MOUNT	VERIFY

SYMBOL	DESIGNATIONS	MTG HT
POWER		
	BRANCH CIRCUIT PANEL	VERIFY
	EQUIPMENT CABINET	VERIFY
	TRANSFORMER	VERIFY
	MOTOR OR MOTOR CONNECTION	VERIFY
	MOTOR CONTROLLER, STARTER OR VFD	VERIFY
	COMBINATION STARTER & DISCONNECT SWITCH	VERIFY
	DISCONNECT SWITCH	VERIFY
	MOTOR RATED TOGGLE	VERIFY
	MANUAL MOTOR STARTER SWITCH WITH THERMAL OVERLOAD	VERIFY
	DUPLEX RECEPTACLE - WALL/CEILING MOUNT	18"
	EMERGENCY DUPLEX RECEPTACLE - WALL/CEILING MOUNT	18"
	SPLIT DUPLEX RECEPTACLE - WALL/CEILING MOUNT	18"
	EMERGENCY SPLIT DUPLEX RECEPTACLE - WALL/CEILING MOUNT	18"
	SIMPLEX RECEPTACLE - WALL/CEILING MOUNT	18"
	EMERGENCY SIMPLEX RECEPTACLE - WALL/CEILING MOUNT	18"
	QUADPLEX RECEPTACLE - WALL/CEILING MOUNT	18"
	EMERGENCY QUADPLEX RECEPTACLE - WALL/CEILING MOUNT	18"
	GFI RECEPTACLE, DUPLEX/QUADPLEX - WALL MOUNT	18"
	GFI RECEPTACLE, DUPLEX/QUADPLEX - CEILING MOUNT	
	GFI DEAD FRONT DEVICE, NORMAL/EMERGENCY - WALL MOUNT	18"
	DUPLEX RECEPTACLE - CONTROLLED - WALL/CEILING MOUNT	18"
	SPECIAL PURPOSE RECEPTACLE - WALL/CEILING MOUNT	18"
	EMERGENCY SPECIAL PURPOSE RECEPTACLE - WALL/CEILING MOUNT	18"
	FLOOR BOX - DEVICES AS INDICATED	
	POWER POLE - DEVICES AS INDICATED	VERIFY
	GROUND REFERENCE BUS - AS NOTED - WALL/CEILING MOUNT	VERIFY
SWITCHES AND CONTROLS		
	SINGLE POLE TOGGLE SWITCH	48"
	DOUBLE POLE TOGGLE SWITCH	48"
	THREE WAY TOGGLE SWITCH	48"
	FOUR WAY TOGGLE SWITCH	48"
	TOGGLE SWITCH - "a" INDICATES SWITCHING	48"
	PILOT LIGHT TOGGLE SWITCH	48"
	ILLUMINATED TOGGLE - TOGGLE SWITCH	48"
	KEYED SWITCH	48"
	MOMENTARY CONTACT TOGGLE SWITCH	48"
	TIMER SWITCH	48"
	MULTI SWITCH, MULTI GANG BOX	48"
	DIMMER SWITCH (# = WATTAGE)	48"
	PUSH BUTTON SWITCH	48"
	OCCUPANCY SENSOR - CLG MOUNT	
	OCCUPANCY SENSOR WALL SWITCH	48"
	PHOTO ELECTRIC CELL	VERIFY
	TIME CLOCK	60"
	CONTACTOR	60"
	RELAY	VERIFY
	PUSH BUTTON STATION - BUTTONS AS INDICATED	48"

ELECTRICAL SHEET LIST - OWEF	
SHEET NUMBER	SHEET NAME
E0.0	OWEF - ELECTRICAL TITLE SHEET
ED1.1	OWEF - MAIN & MEZZANINE LEVEL ELECTRICAL DEMOLITION PLAN
ED1.2	OWEF - SECOND LEVEL ELECTRICAL DEMOLITION PLAN
E1.1	OWEF - MAIN & MEZZANINE LEVEL LIGHTING PLAN
E1.2	OWEF - SECOND LEVEL LIGHTING PLAN
E2.1	OWEF - MAIN & MEZZANINE LEVEL POWER PLAN
E2.2	OWEF - SECOND LEVEL POWER PLAN
E3.1	OWEF - MAIN LEVEL SIGNAL PLAN
E3.2	OWEF - SECOND LEVEL SIGNAL PLAN
E4.1	OWEF - ELECTRICAL SCHEDULES
E4.2	OWEF - ELECTRICAL SCHEDULES
E5.1	OWEF - ELECTRICAL DETAILS
E6.1	OWEF - ELECTRICAL RISER
PE1.1	OWEF - PLUMBING AND ELECTRICAL SCHEDULES
ME1.1	OWEF - MECHANICAL AND ELECTRICAL SCHEDULES
SHEET TOTAL: 15	

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I HEREBY CERTIFY THAT THIS PLAN, SPECIFICATION, OR REPORT WAS PREPARED BY ME OR UNDER MY DIRECT SUPERVISION AND THAT I AM A DULY LICENSED ENGINEER UNDER THE LAWS OF THE STATE OF MINNESOTA.

*Dustin D. Mueller*  
Dustin D. Mueller  
52622 12/09/25  
NUMBER DATE

OLMSTED COUNTY WASTE TO ENERGY  
FACILITY OFFICE REMODEL

ROCHESTER, MINNESOTA

25-041 1226016-000-00

DATE 12/09/25

DRAWN BY DDM

CHECKED BY DF

ISSUE/REVISION HISTORY

01	ISSUE FOR BID	12/09/25


OWEF - ELECTRICAL  
TITLE SHEET

E0.0


OF SHEETS

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1 ELECTRICAL DEMOLITION - OFFICE MAIN LEVEL  
1/8" = 1'-0"

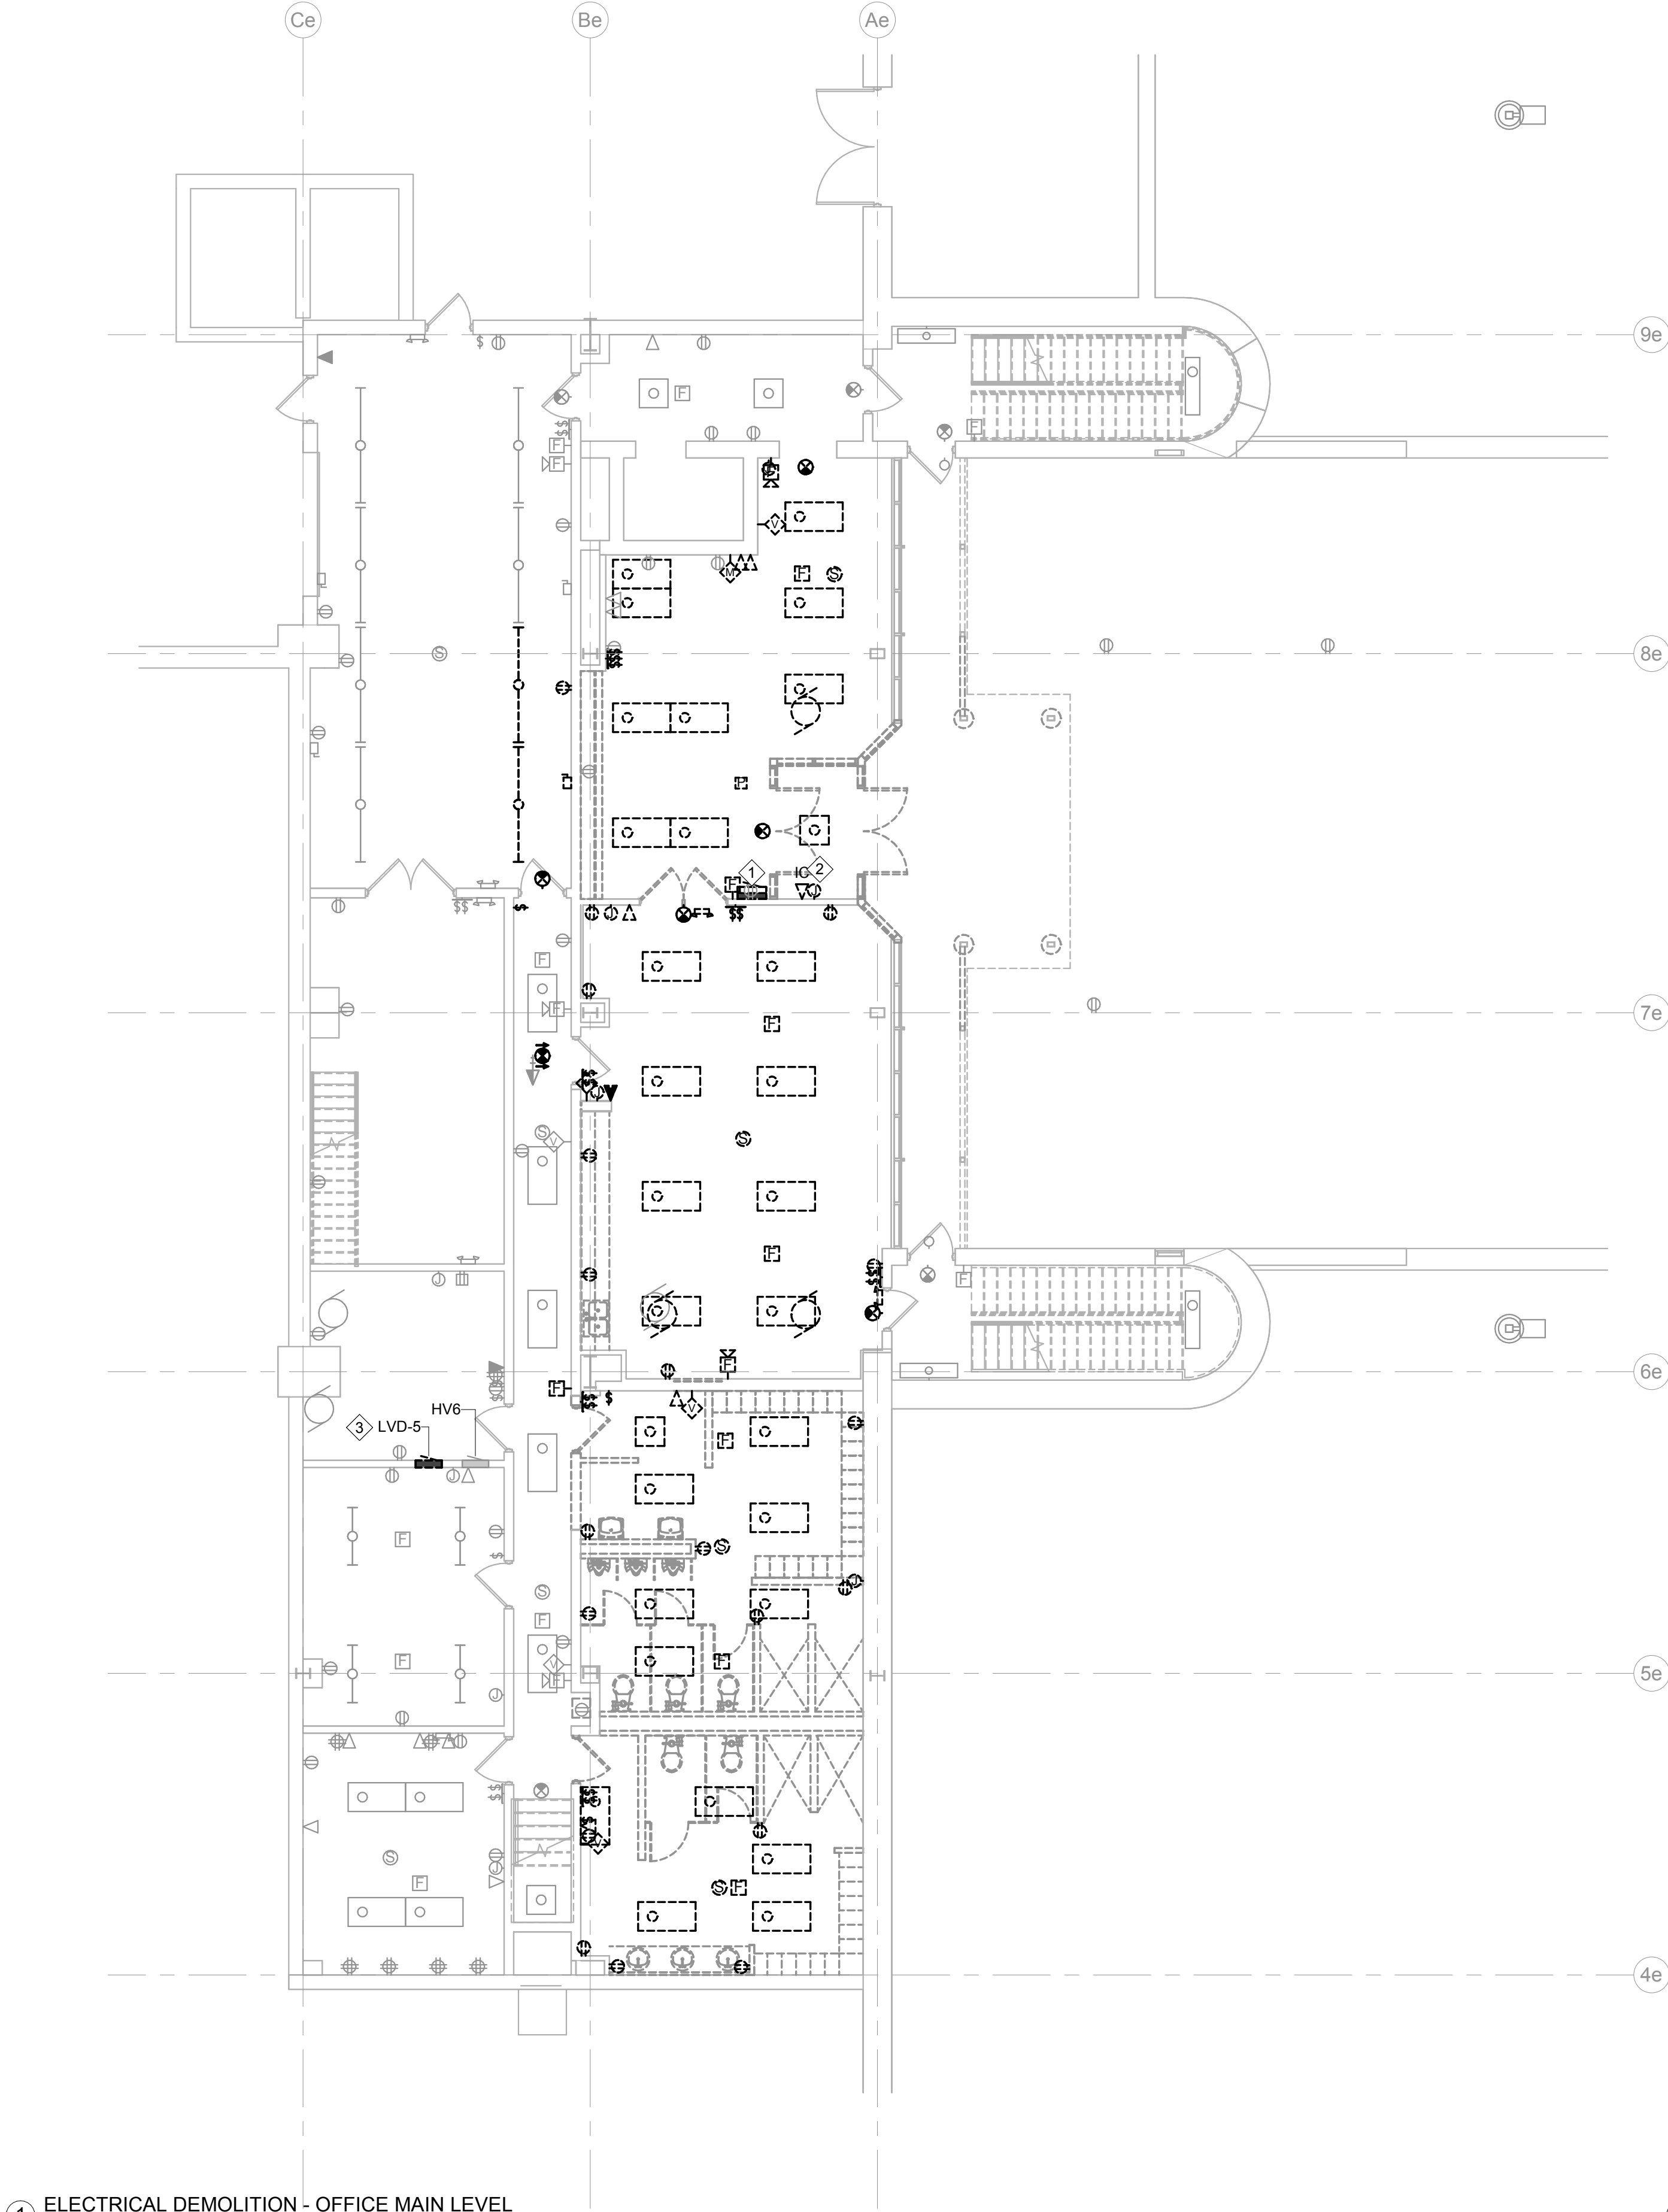


2 ELECTRICAL DEMOLITION - OFFICE MEZZANINE LEVEL  
1/8" = 1'-0"

#### GENERAL NOTES:

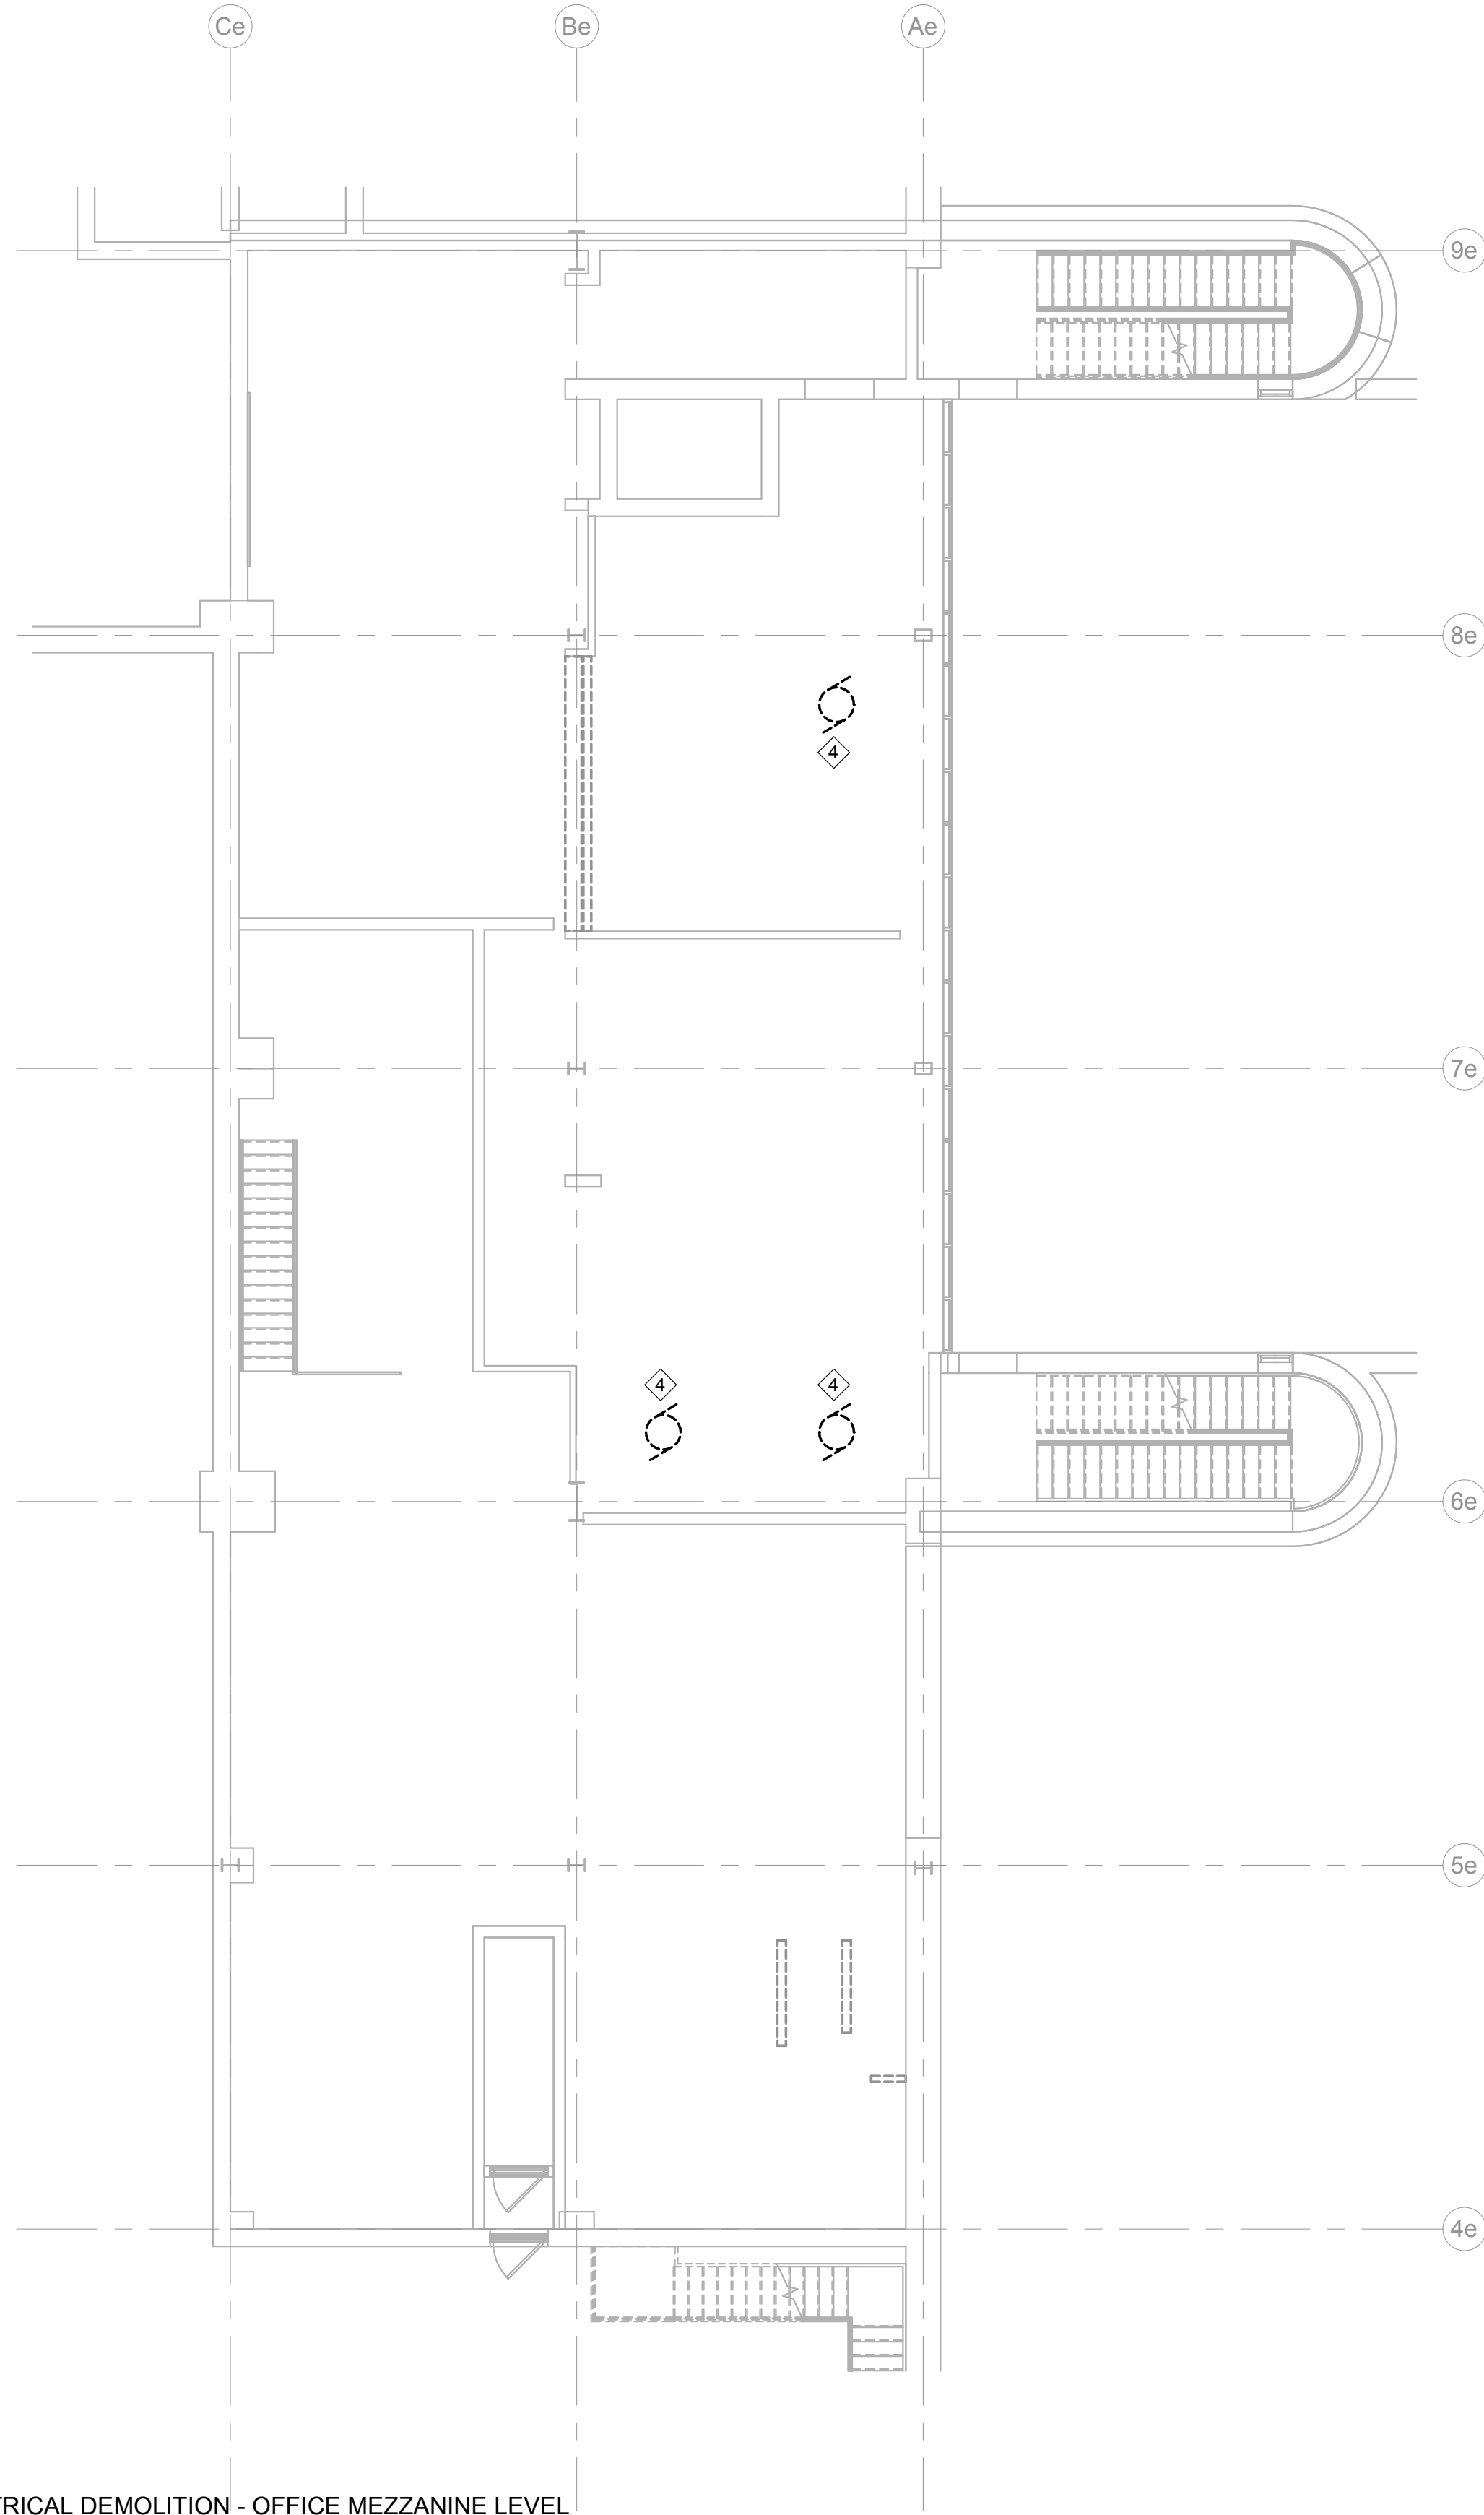- DRAWINGS INDICATE EXISTING CONDITIONS AS THEY WERE PLANNED UNDER PREVIOUS CONSTRUCTION PROJECTS AND ARE INCLUDED FOR REFERENCE. ACTUAL CONDITIONS MAY VARY FROM PLANNED CONDITIONS. EXAMINE THE SITE CONDITIONS PRIOR TO BIDDING AND DETERMINE ACTUAL CONDITIONS. DISCREPANCIES BETWEEN EXISTING CONDITIONS AND ELECTRICAL DEMOLITION DRAWINGS TO BE BROUGHT TO THE ATTENTION OF THE ELECTRICAL ENGINEER AND ARCHITECT PRIOR TO BID SUBMITTAL.
- A FIELD SURVEY WAS CONDUCTED TO VERIFY THE GENERAL ACCURACY OF EXISTING PLANS. NO ATTEMPT HAS BEEN MADE TO FIND CHANGES WHICH OCCUR IN CONCEALED AREAS SUCH AS ABOVE INACCESSIBLE CEILINGS AND IN WALLS. PERFORM MINOR MODIFICATIONS AND ADDITIONS TO CORRECT FOR THESE HIDDEN CONDITIONS TO ALLOW FOR COMPLETION OF WORK WITH NO ADDITIONAL COST TO THE OWNER.
- PROVIDE COORDINATION WALK THROUGH WITH THE OWNER AND OWNER REPRESENTATIVE TO IDENTIFY EQUIPMENT TO BE SALVAGED AND TURNED OVER PRIOR TO START OF DEMOLITION. REMOVE AND STOCK PILE EQUIPMENT FOR THE OWNER TO REMOVE FROM SITE. OTHER EXISTING DEVICES, LIGHT FIXTURES, EQUIPMENT, CONDUIT AND CABLING BEING DEMOLISHED WILL BE THE RESPONSIBILITY OF THE ELECTRICAL CONTRACTOR TO DISPOSE OF IN ACCORDANCE WITH THE LOCAL AND FEDERAL REGULATIONS.
- IDENTIFY DAMAGE TO EXISTING EQUIPMENT BEING REUSED OR RELOCATED PRIOR TO THE START OF DEMOLITION. REMOVE AND STORE DEVICES SHOWN TO BE REUSED OR RELOCATED UNTIL THE TIME OF REINSTALLATION. REPLACE DEVICES DAMAGED DURING CONSTRUCTION.
- DE-ENERGIZE ELECTRICAL EQUIPMENT PRIOR TO DEMOLITION. DISCONNECT POWER TO MECHANICAL EQUIPMENT AND POWERED BUILDING EQUIPMENT NOTED FOR DEMOLITION OR REMOVAL BY OTHERS.
- DEMOLISH ELECTRICAL DEVICES, CONDUIT, WIRE, AND EQUIPMENT IN WALLS, CEILINGS, AND FLOORS. REMOVE CONDUIT AND WIRING BACK TO ELECTRICAL DEVICES THAT REMAIN. BACK TO THE SOURCE OR PROVIDE TEMPORARY SUPPORT FOR REUSE UPON COMPLETION OF DEMOLITION.
- COORDINATE THE DISCONNECTION OF LOW VOLTAGE SYSTEMS CABLES WITH THE OWNER AND REMOVE FROM UTILIZATION POINT TO SOURCE.

#### KEY NOTES:

- REMOVE AND SALVAGE FIRE ALARM REMOTE PANEL FOR RE-USE
- REMOVE AND SALVAGE INTERCOM AND CARD READER FOR RE-USE. DEMOLISH CONDUCTORS BACK TO SOURCE, CONTROLLERS TO REMAIN.
- DEMOLISH ELECTRICAL PANEL. PANEL IS BEING REPLACED, SALVAGE CONDUIT AS APPLICABLE FOR RE-USE.
- DEMOLISH ELECTRICAL CONNECTION TO EQUIPMENT BEING REMOVED BY MECHANICAL CONTRACTOR.

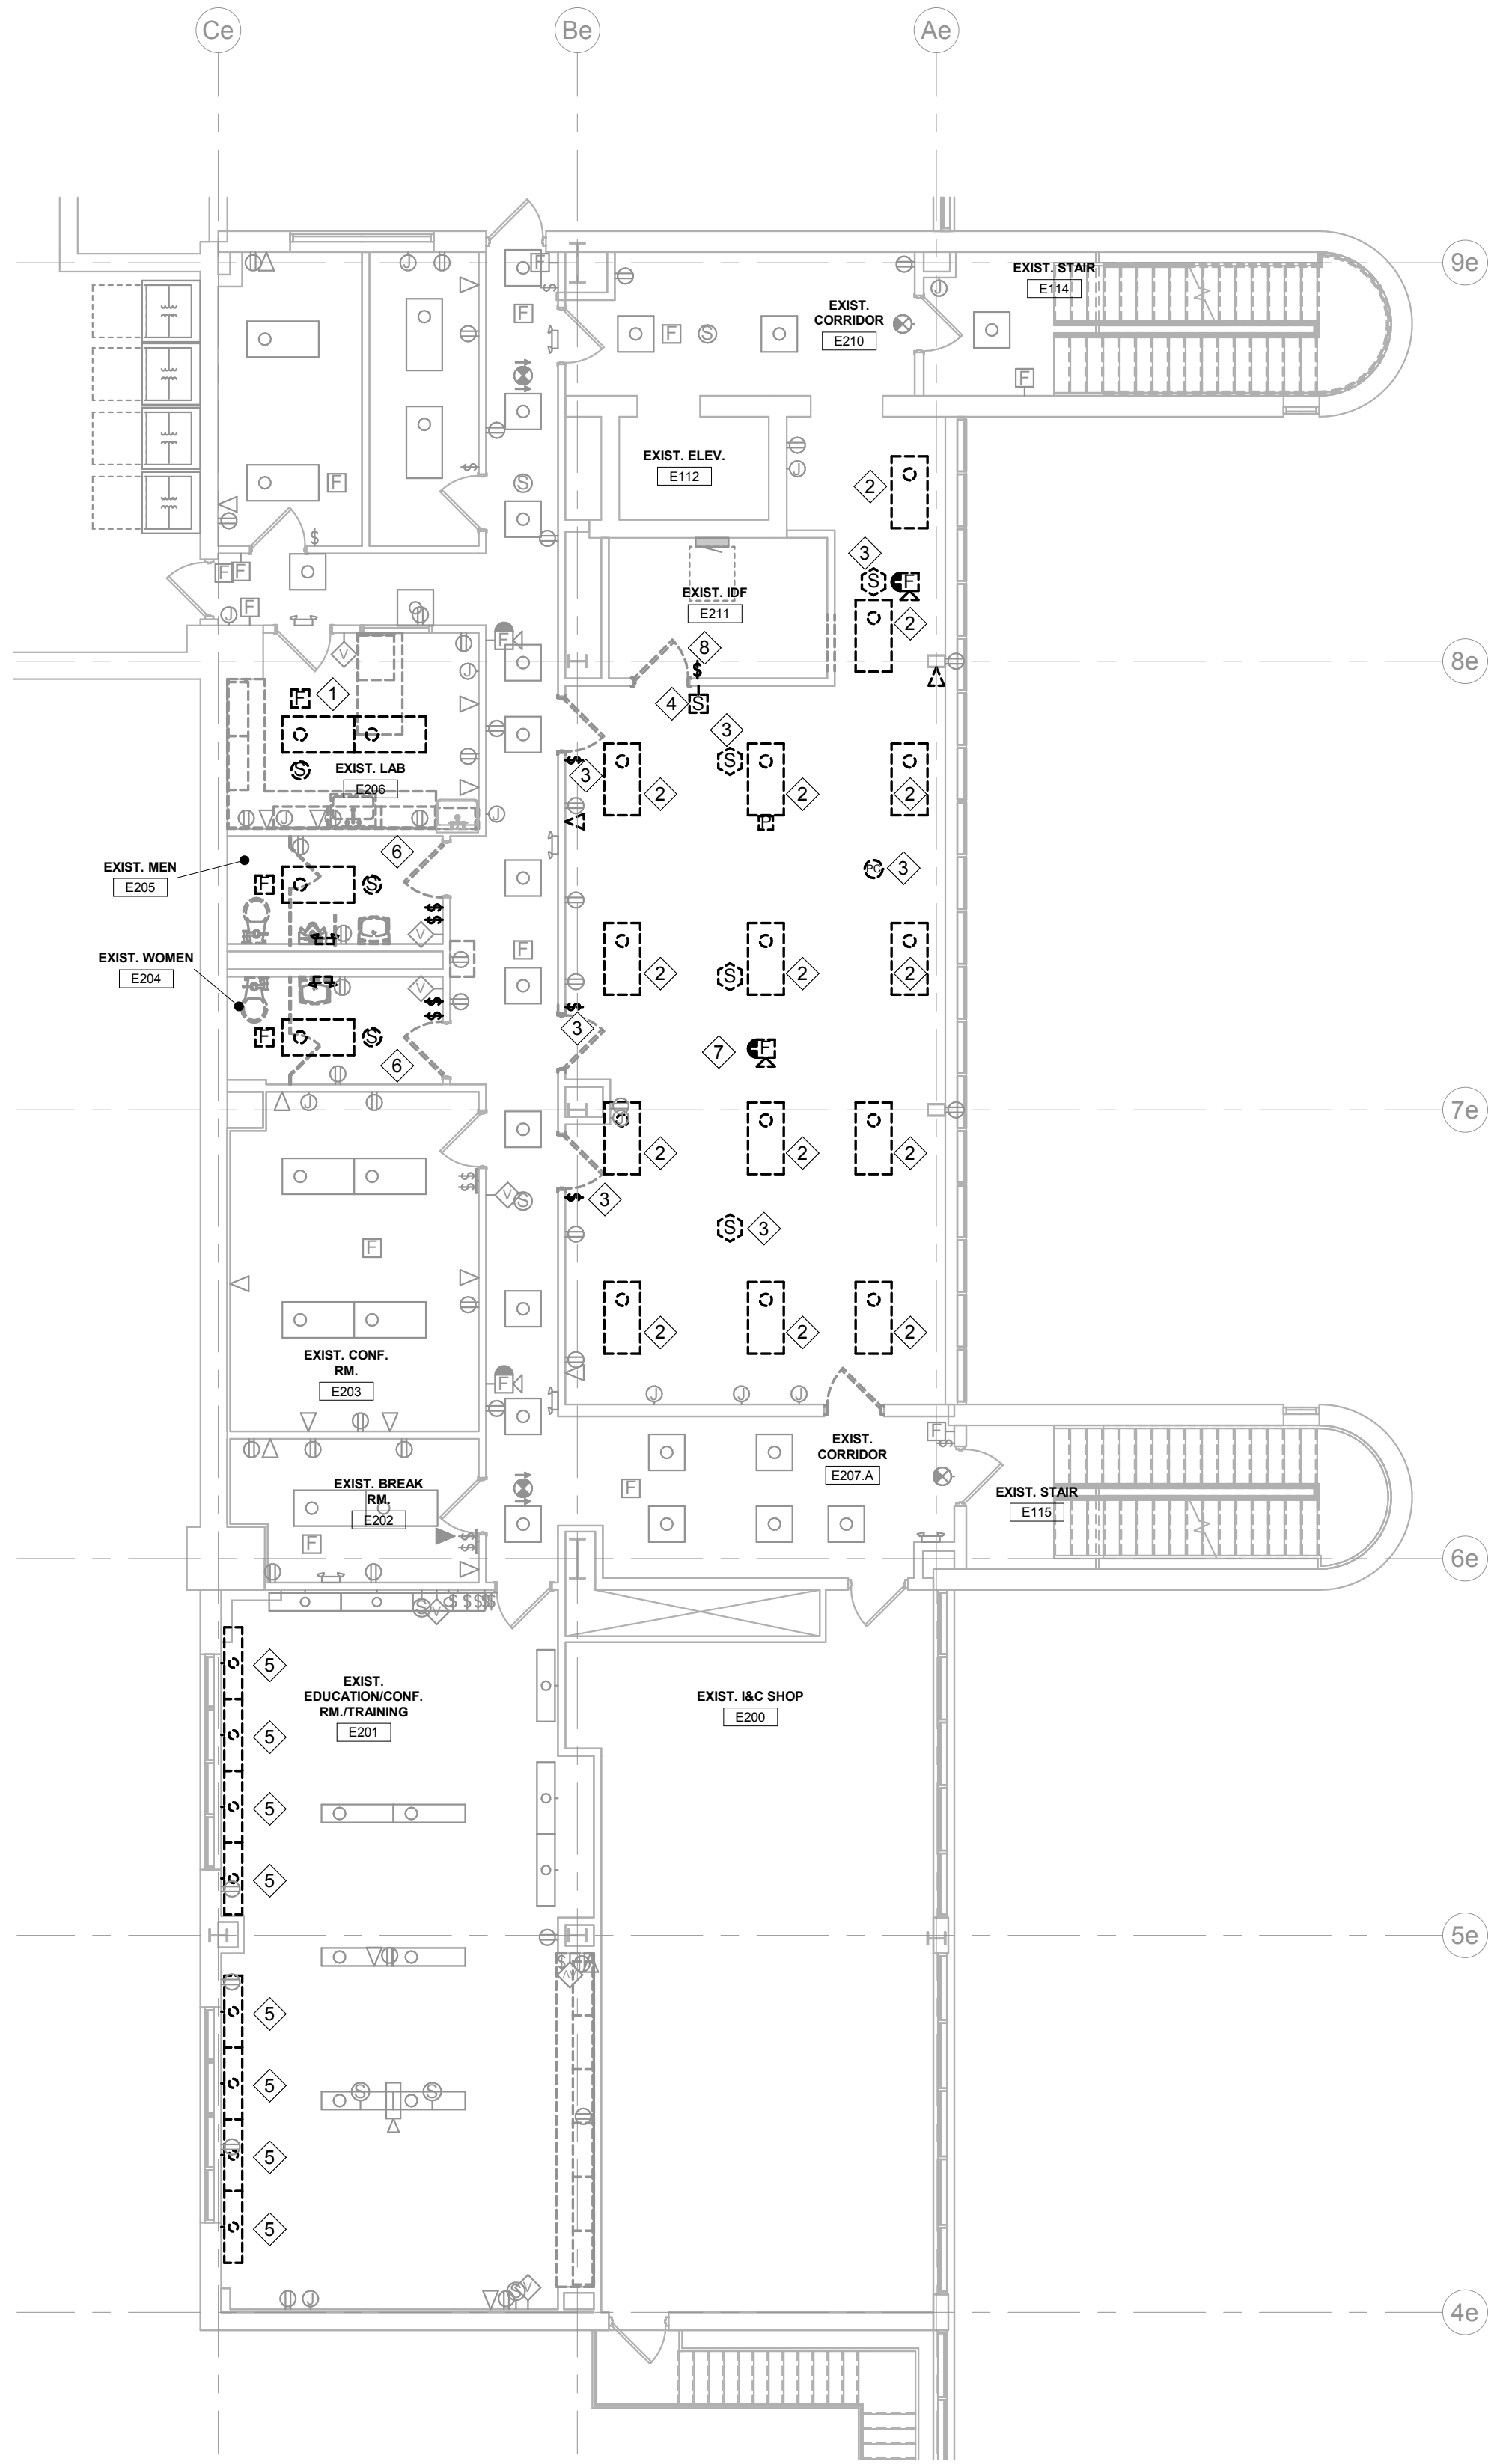

1 ELECTRICAL DEMOLITION - OFFICE SECOND LEVEL  
1/8" = 1'-0"

GENERAL NOTES:

- A. DRAWINGS INDICATE EXISTING CONDITIONS AS THEY WERE PLANNED UNDER PREVIOUS CONSTRUCTION PROJECTS AND ARE INCLUDED FOR REFERENCE. ACTUAL CONDITIONS MAY VARY FROM PLANNED CONDITIONS. EXAMINE THE SITE CONDITIONS PRIOR TO BIDDING AND DETERMINE ACTUAL CONDITIONS. DISCREPANCIES BETWEEN EXISTING CONDITIONS AND ELECTRICAL DEMOLITION DRAWINGS TO BE BROUGHT TO THE ATTENTION OF THE ELECTRICAL ENGINEER AND ARCHITECT PRIOR TO BID SUBMITTAL.
- B. A FIELD SURVEY WAS CONDUCTED TO VERIFY THE GENERAL ACCURACY OF EXISTING PLANS. NO ATTEMPT HAS BEEN MADE TO FIND CHANGES WHICH OCCUR IN CONCEALED AREAS SUCH AS ABOVE INACCESSIBLE CEILINGS AND IN WALLS. PERFORM MINOR MODIFICATIONS AND ADDITIONS TO CORRECT FOR THESE HIDDEN CONDITIONS TO ALLOW FOR COMPLETION OF WORK WITH NO ADDITIONAL COST TO THE OWNER.
- C. PROVIDE COORDINATION WALK THROUGH WITH THE OWNER AND OWNER REPRESENTATIVE TO IDENTIFY EQUIPMENT TO BE SALVAGED AND TURNED OVER PRIOR TO START OF DEMOLITION. REMOVE AND STOCK PILE EQUIPMENT FOR THE OWNER TO REMOVE FROM SITE. OTHER EXISTING DEVICES, LIGHT FIXTURES, EQUIPMENT, CONDUIT AND CABLING BEING DEMOLISHED WILL BE THE RESPONSIBILITY OF THE ELECTRICAL CONTRACTOR TO DISPOSE OF IN ACCORDANCE WITH THE LOCAL AND FEDERAL REGULATIONS.
- D. IDENTIFY DAMAGE TO EXISTING EQUIPMENT BEING REUSED OR RELOCATED PRIOR TO THE START OF DEMOLITION. REMOVE AND STORE DEVICES SHOWN TO BE REUSED OR RELOCATED UNTIL THE TIME OF REINSTALLATION. REPLACE DEVICES DAMAGED DURING CONSTRUCTION.
- E. DE-ENERGIZE ELECTRICAL EQUIPMENT PRIOR TO DEMOLITION. DISCONNECT POWER TO MECHANICAL EQUIPMENT AND POWERED BUILDING EQUIPMENT NOTED FOR DEMOLITION OR REMOVAL BY OTHERS.
- F. DEMOLISH ELECTRICAL DEVICES, CONDUIT, WIRE, AND EQUIPMENT IN WALLS, CEILINGS, AND FLOORS. REMOVE CONDUIT AND WIRING BACK TO ELECTRICAL DEVICES THAT REMAIN. BACK TO THE SOURCE OR PROVIDE TEMPORARY SUPPORT FOR REUSE UPON COMPLETION OF DEMOLITION.
- G. COORDINATE THE DISCONNECTION OF LOW VOLTAGE SYSTEMS CABLES WITH THE OWNER AND REMOVE FROM UTILIZATION POINT TO SOURCE.

KEY NOTES:

- 1 DEMOLITION WORK IN THIS SPACE TO BE PART OF ALTERNATE A-1.
- 2 SALVAGE LIGHTS FOR RE-USE.
- 3 SALVAGE nLIGHT LIGHTING CONTROL FOR RE-USE.
- 4 REMOVE AND SALVAGE CARD READER FOR RE-USE.
- 5 REMOVE AND SALVAGE LIGHTS UNDER ARCHITECTURAL ALTERNATE. CIRCUITS TO REMAIN AND BE RE-USED. SEE E1.2 FOR MORE INFORMATION.
- 6 SALVAGE SMOKE DETECTOR AND SPEAKER FOR RE-INSTALLATION.
- 7 SALVAGE FIRE ALARM DEVICES FOR RE-USE.
- 8 REMOVE LIGHTING CONTROL SWITCH FOR RELOCATIN. SEE E1.2 FOR MORE INFORMATION.






1 UTILIZE EXISTING LIGHTING CIRCUIT FOR NEW LIGHTS.

Justin D. Mueller	
2622	12/09/2011
NUMBER	D.

OF SHEE

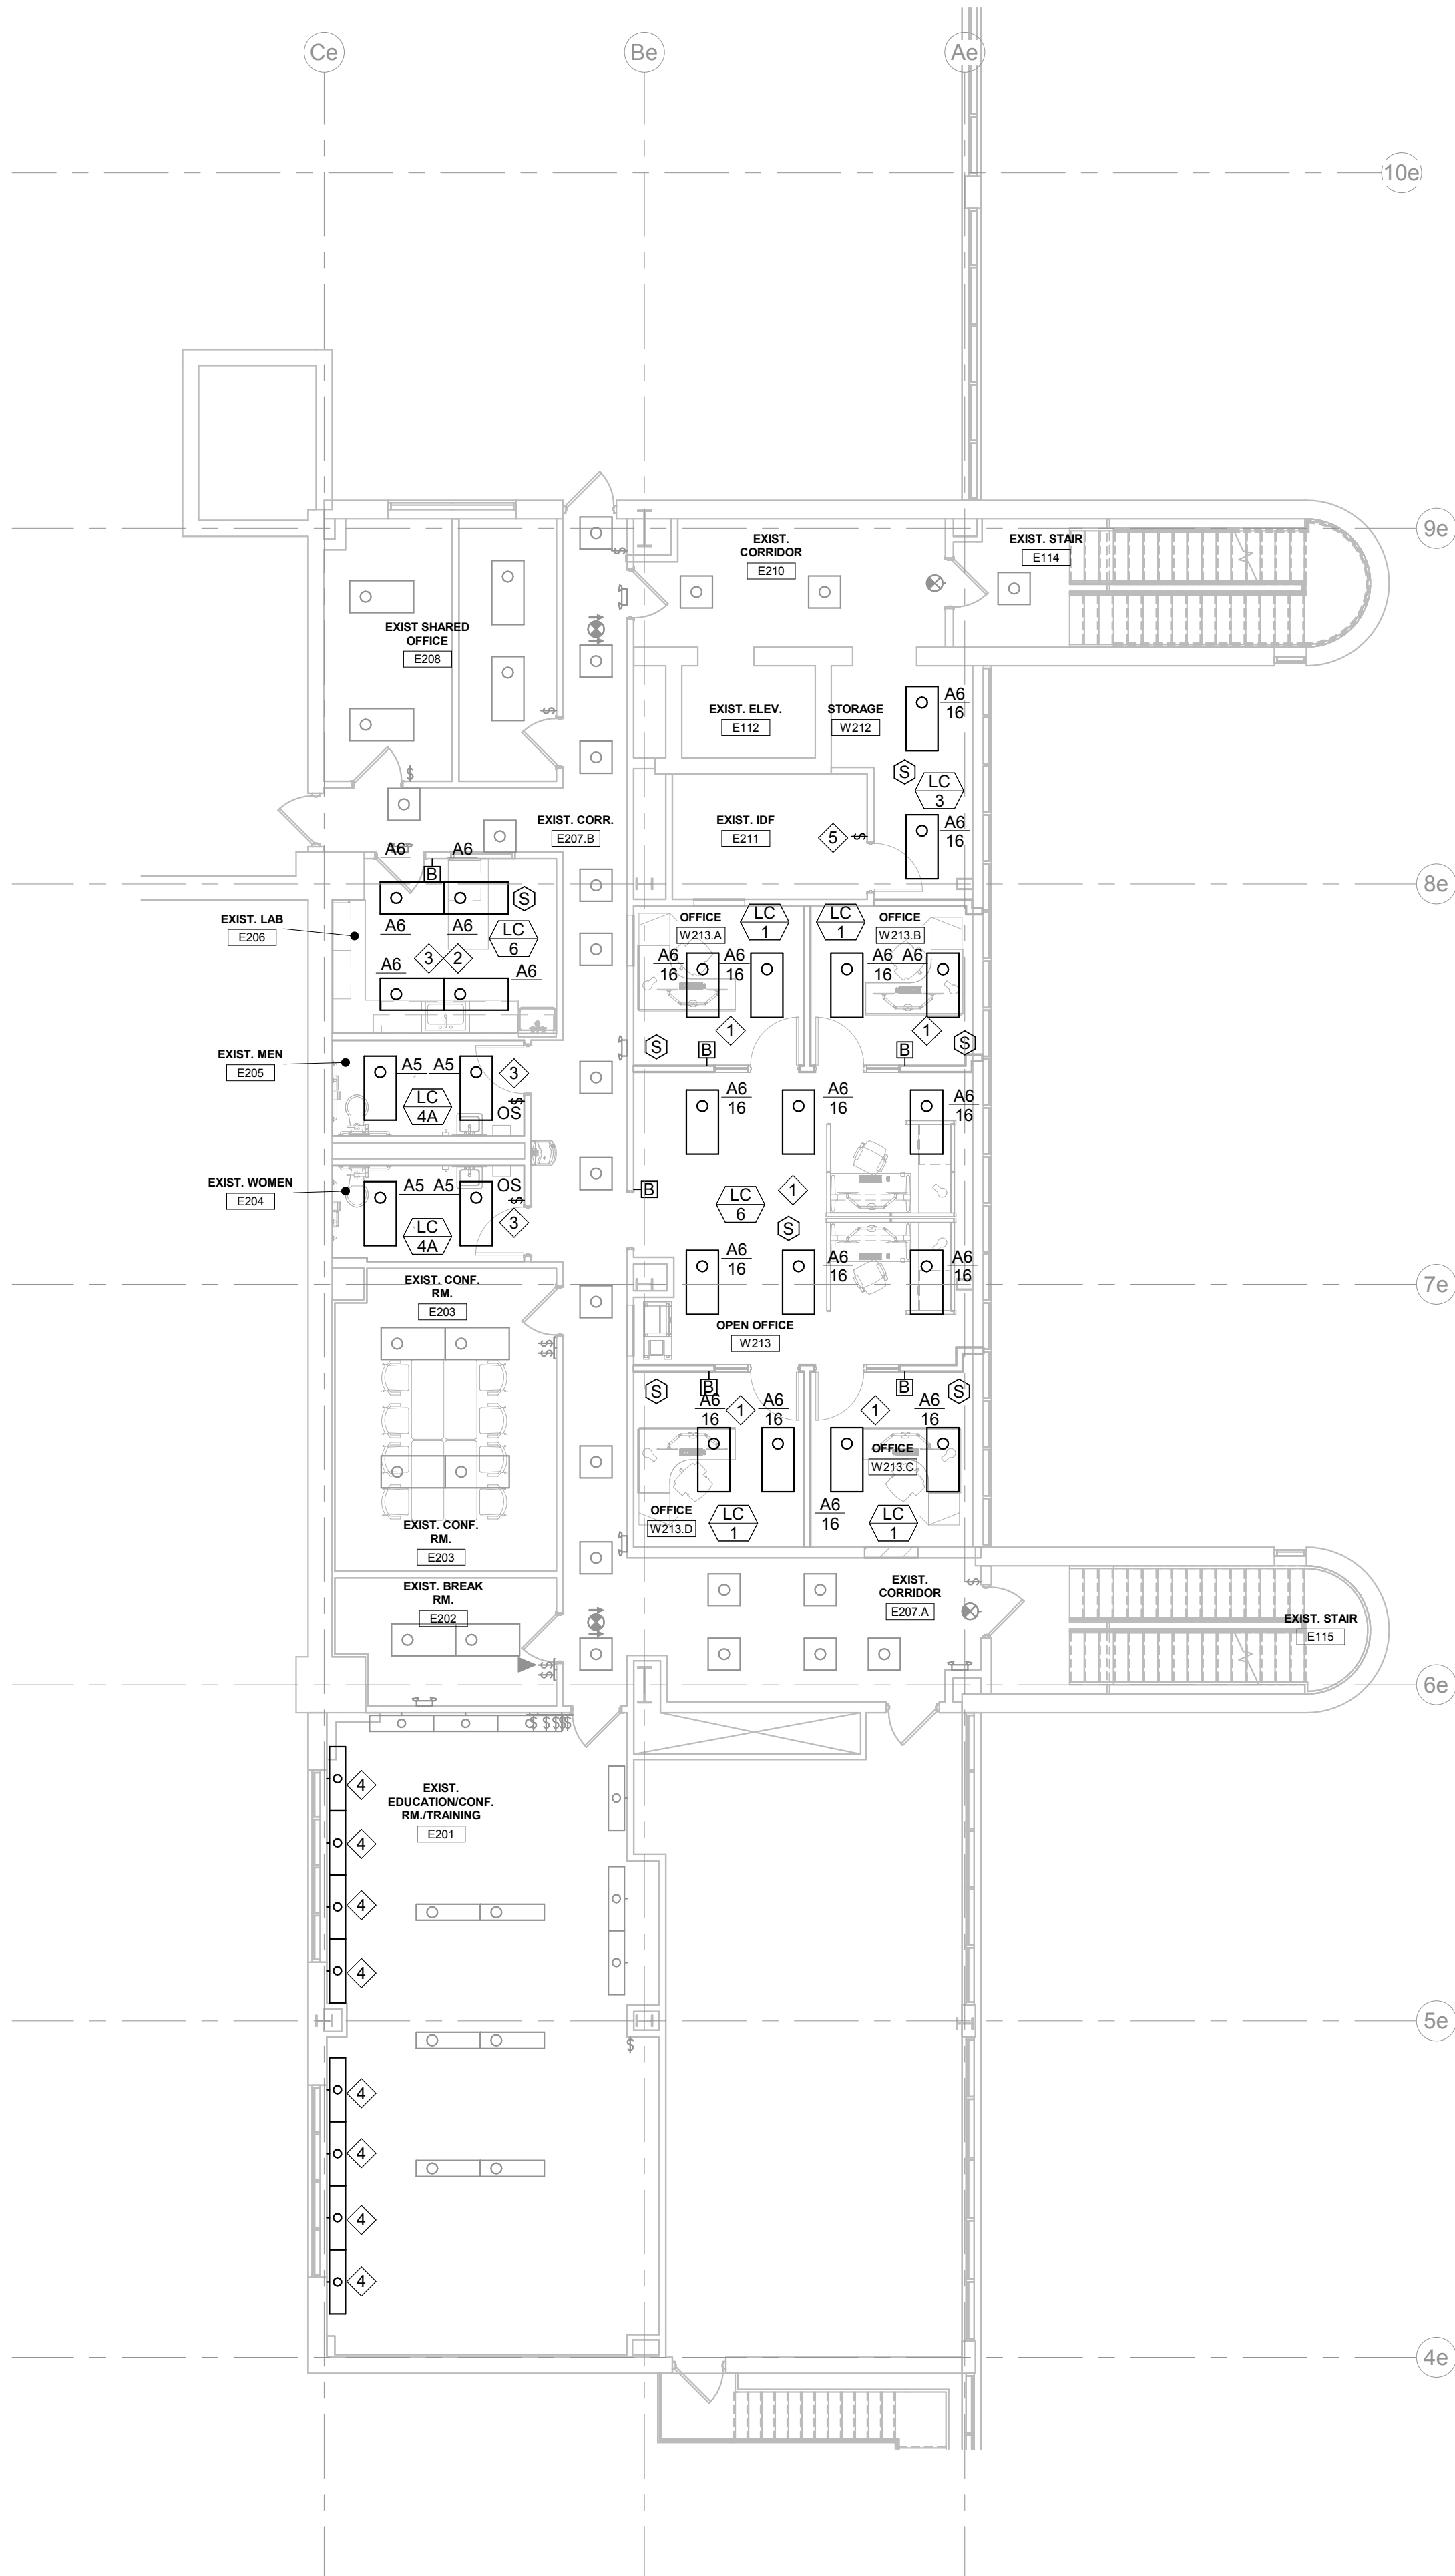

1 SECOND LEVEL LIGHTING - OFFICE ADDITION  
1/8" = 1'-0"

GENERAL NOTES:

- A. ALL LIGHTS, NLIGHT ENABLED UNLESS OTHERWISE NOTED.
- B. SWITCHES ARE NLIGHT nPOD DX UNLESS OTHERWISE NOTED.

KEY NOTES:

- 1 LOCATION FOR LIGHT SALVAGED DURING DEMOLITION. CONNECT TO EXISTING LIGHTING CIRCUIT AND NEW CONTROLS.
- 2 NEW LIGHTING IN THE SPACE PART OF ALTERNATE A-1.
- 3 NEW LIGHTING, CONNECT TO EXISTING CIRCUITING AND NEW CONTROLS.
- 4 RE-INSTALL LIGHTS. SEE ARCHITECTURAL DETAILS FOR MOUNTING. RELAMP WITH TYPE B 3500K LED REPLACEMENT LAMP.
- 5 NEW LOCATION FOR SWITCH REMOVED DURING DEMOLITION.

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*Dustin Mueller*  
Dustin D. Mueller

52622 12/09/25  
NUMBER DATE

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ROCHESTER, MINNESOTA

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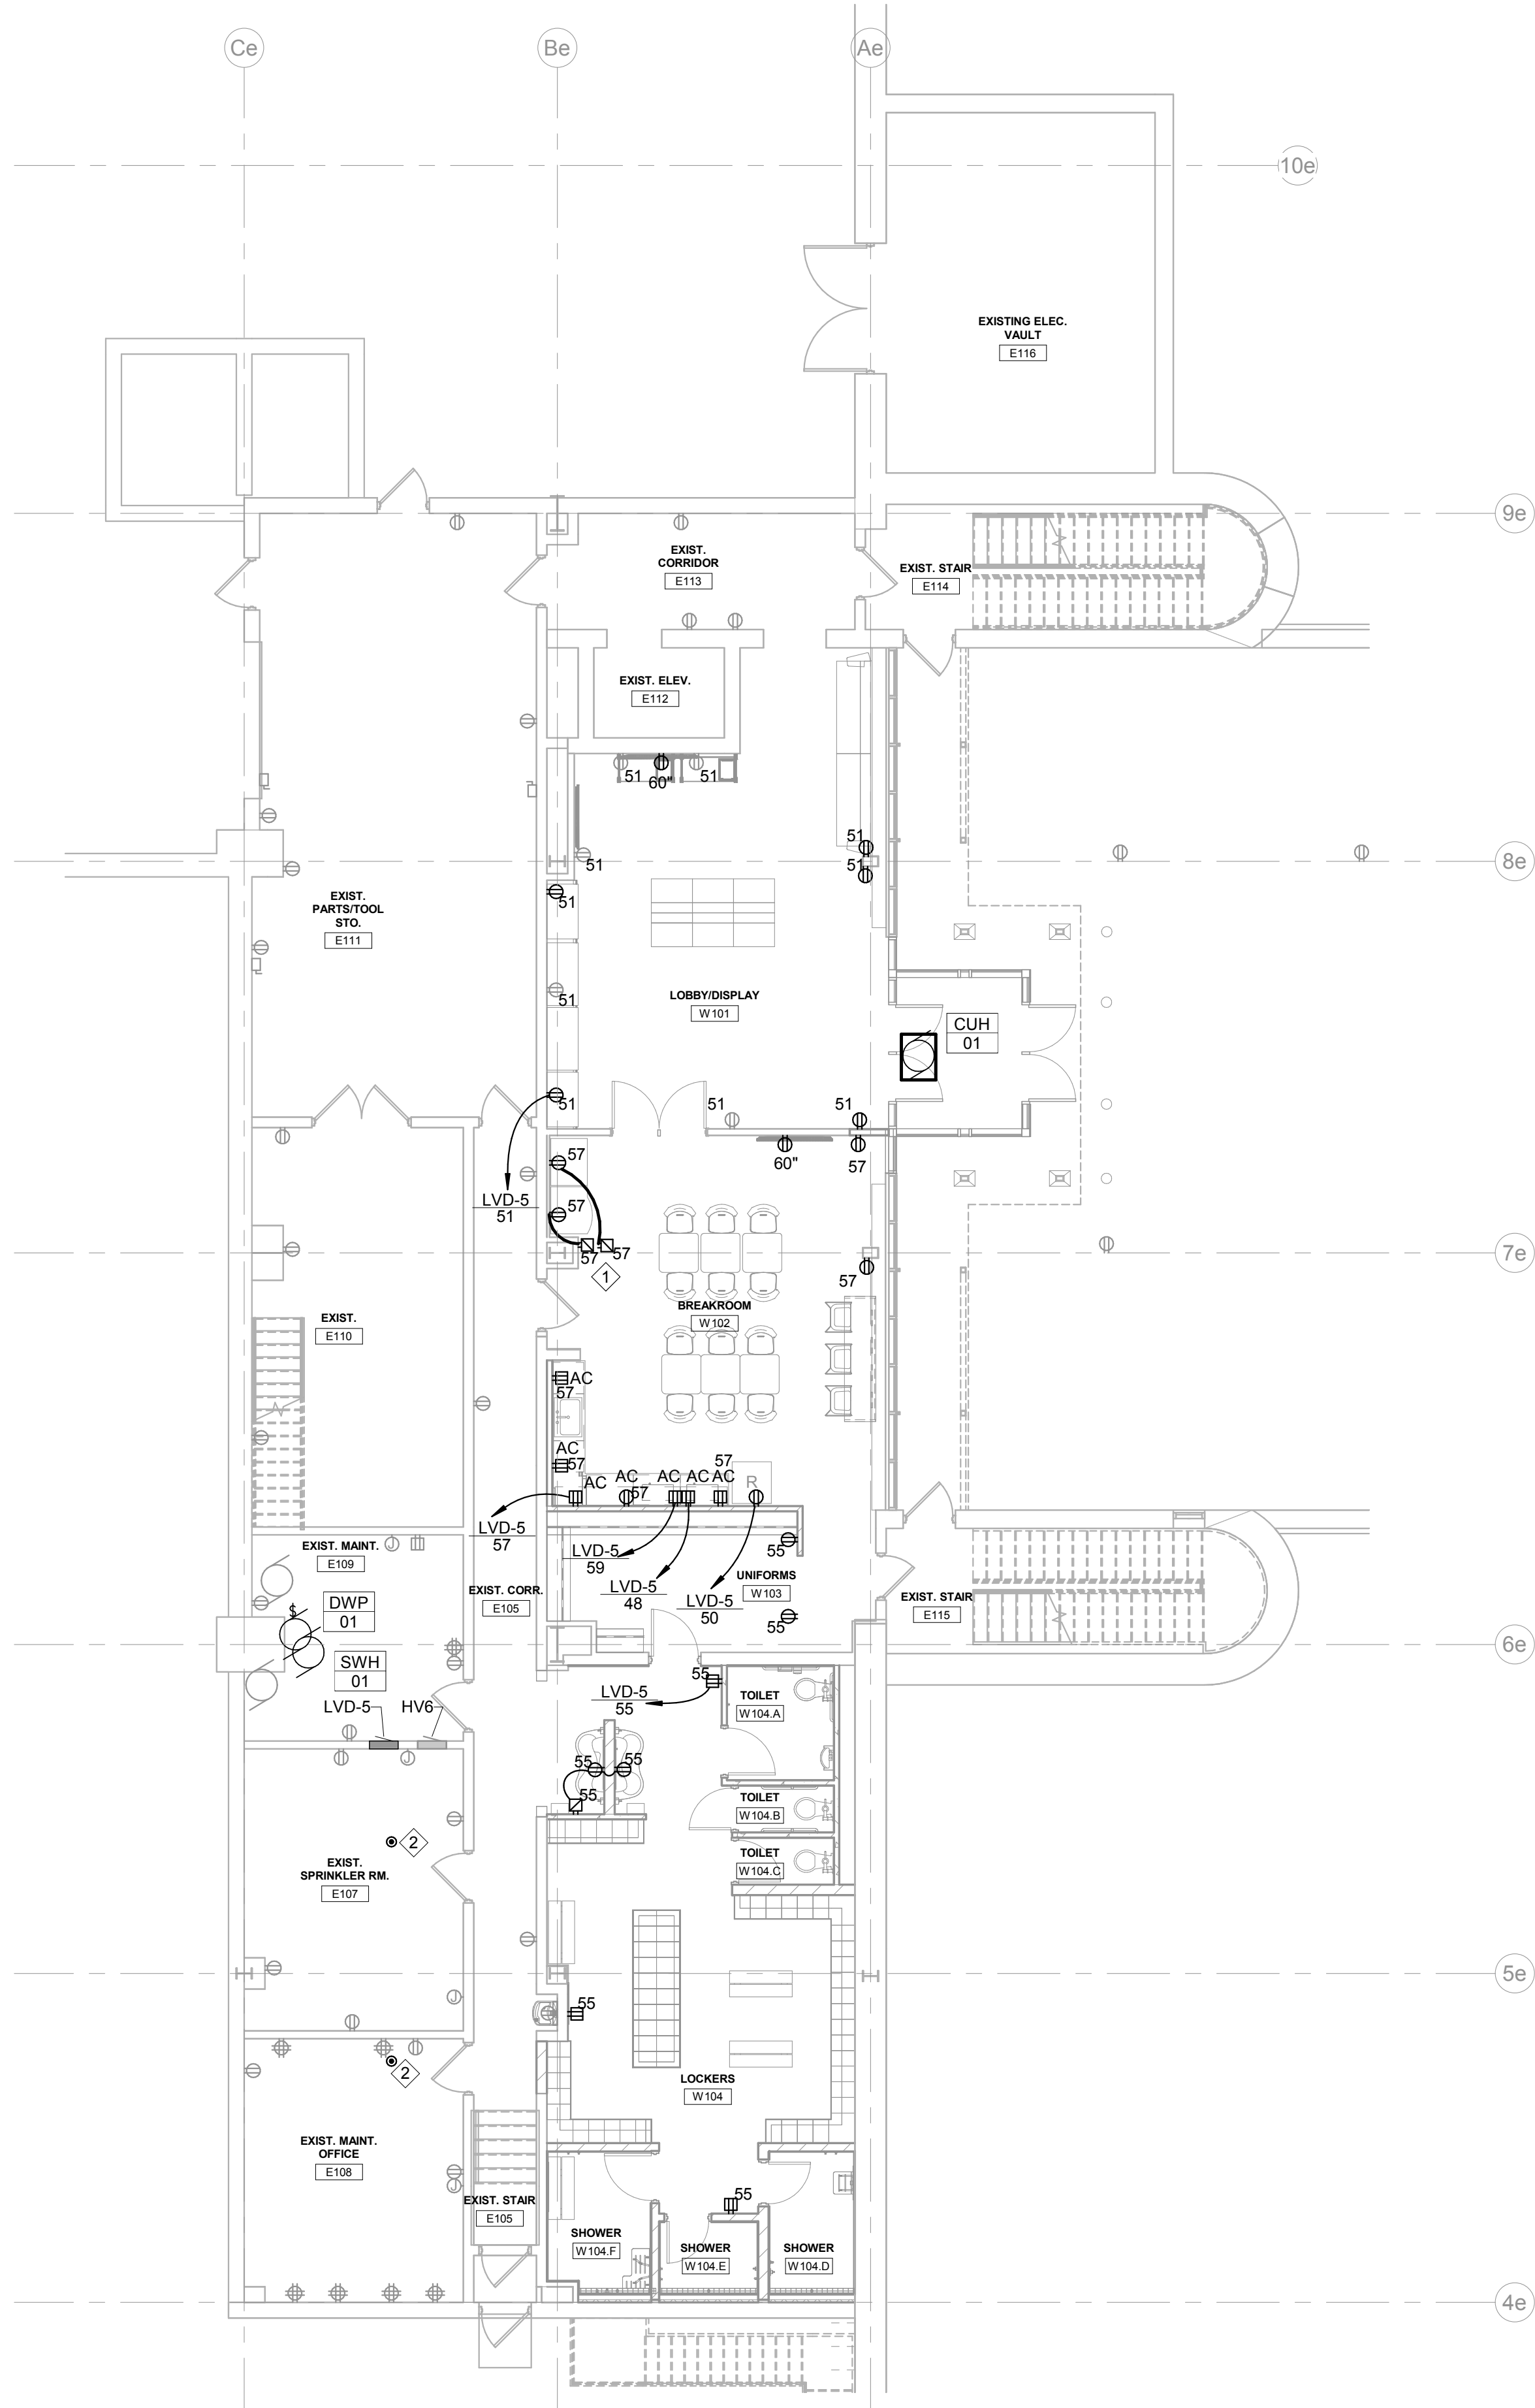
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OWEF - SECOND LEVEL  
LIGHTING PLAN


SHEET NUMBER

E1.2

OF SHEETS



1 MAIN LEVEL POWER - OFFICE ADDITION  
1/8" = 1'-0"

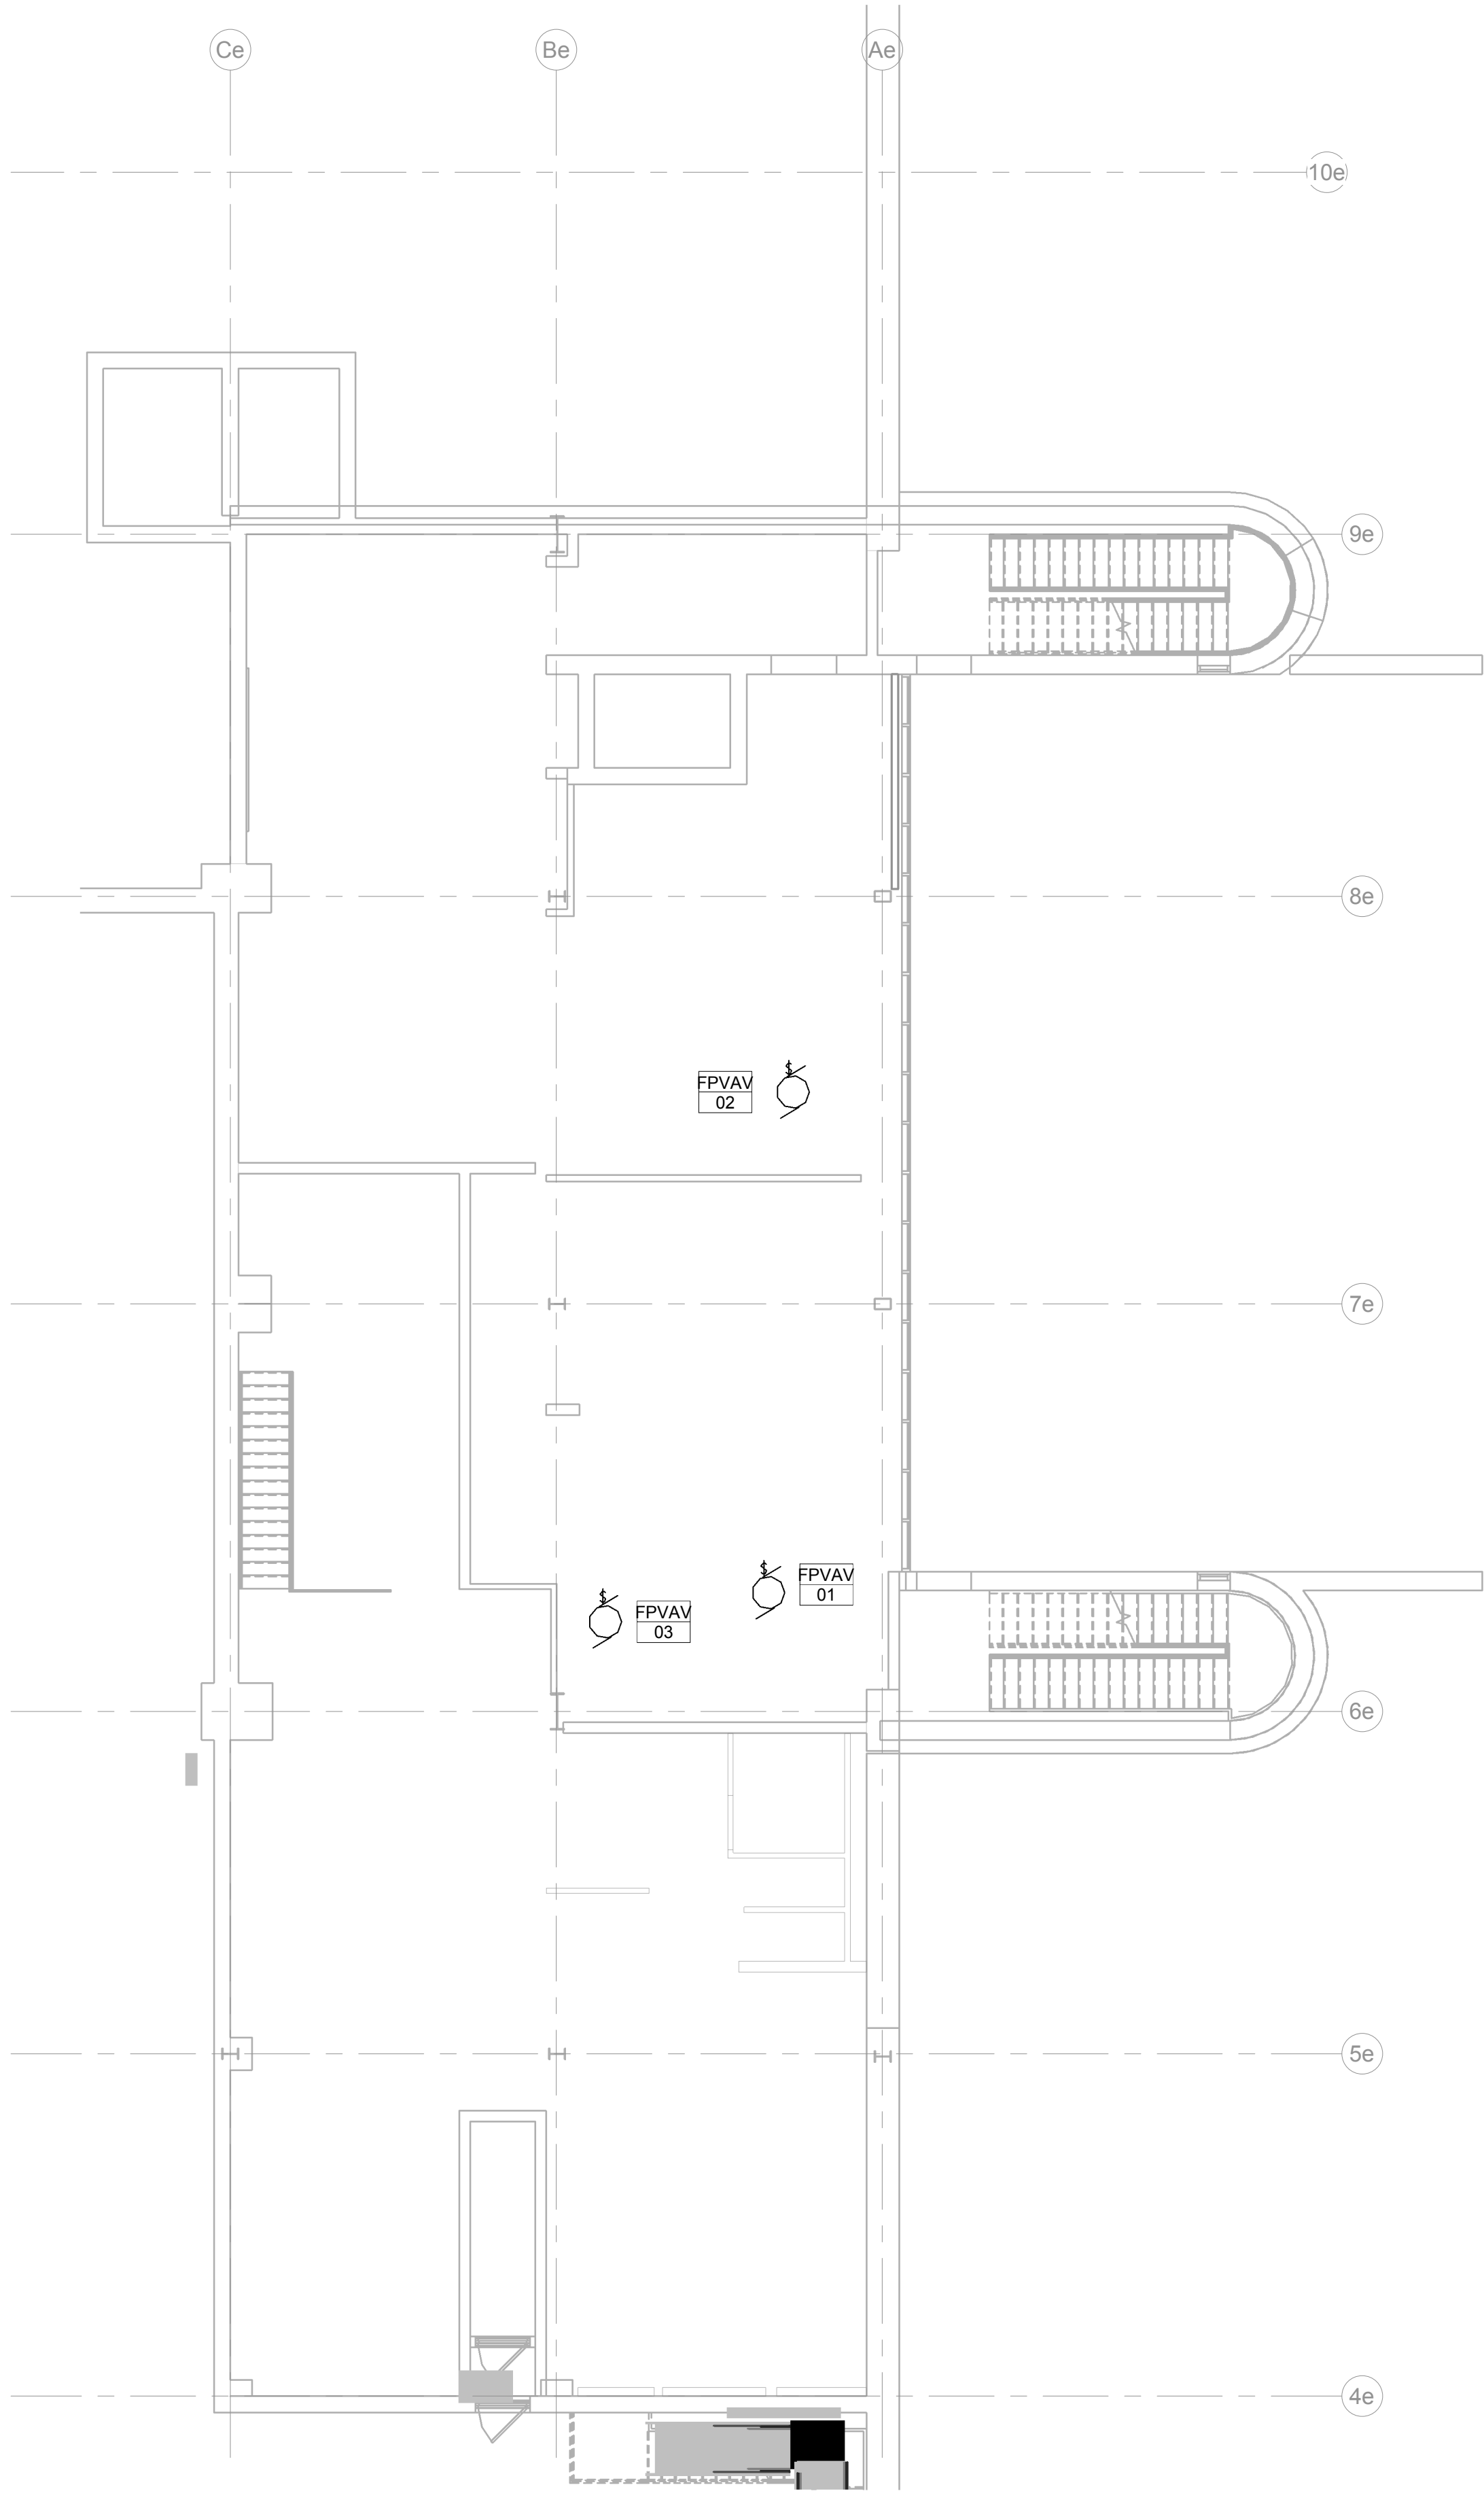

2 OWEF - MEZZANINE LEVEL POWER PLAN  
1/8" = 1'-0"

KEY NOTES:

- 1 PROVIDE DEAD FRONT GFCI FOR VENDING MACHINES.
- 2 LOCATION OF FLOORBOXES ABOVE. ROUTE CONDUITS TO THIS LOCATION TO ROUTE POWER/DATA.

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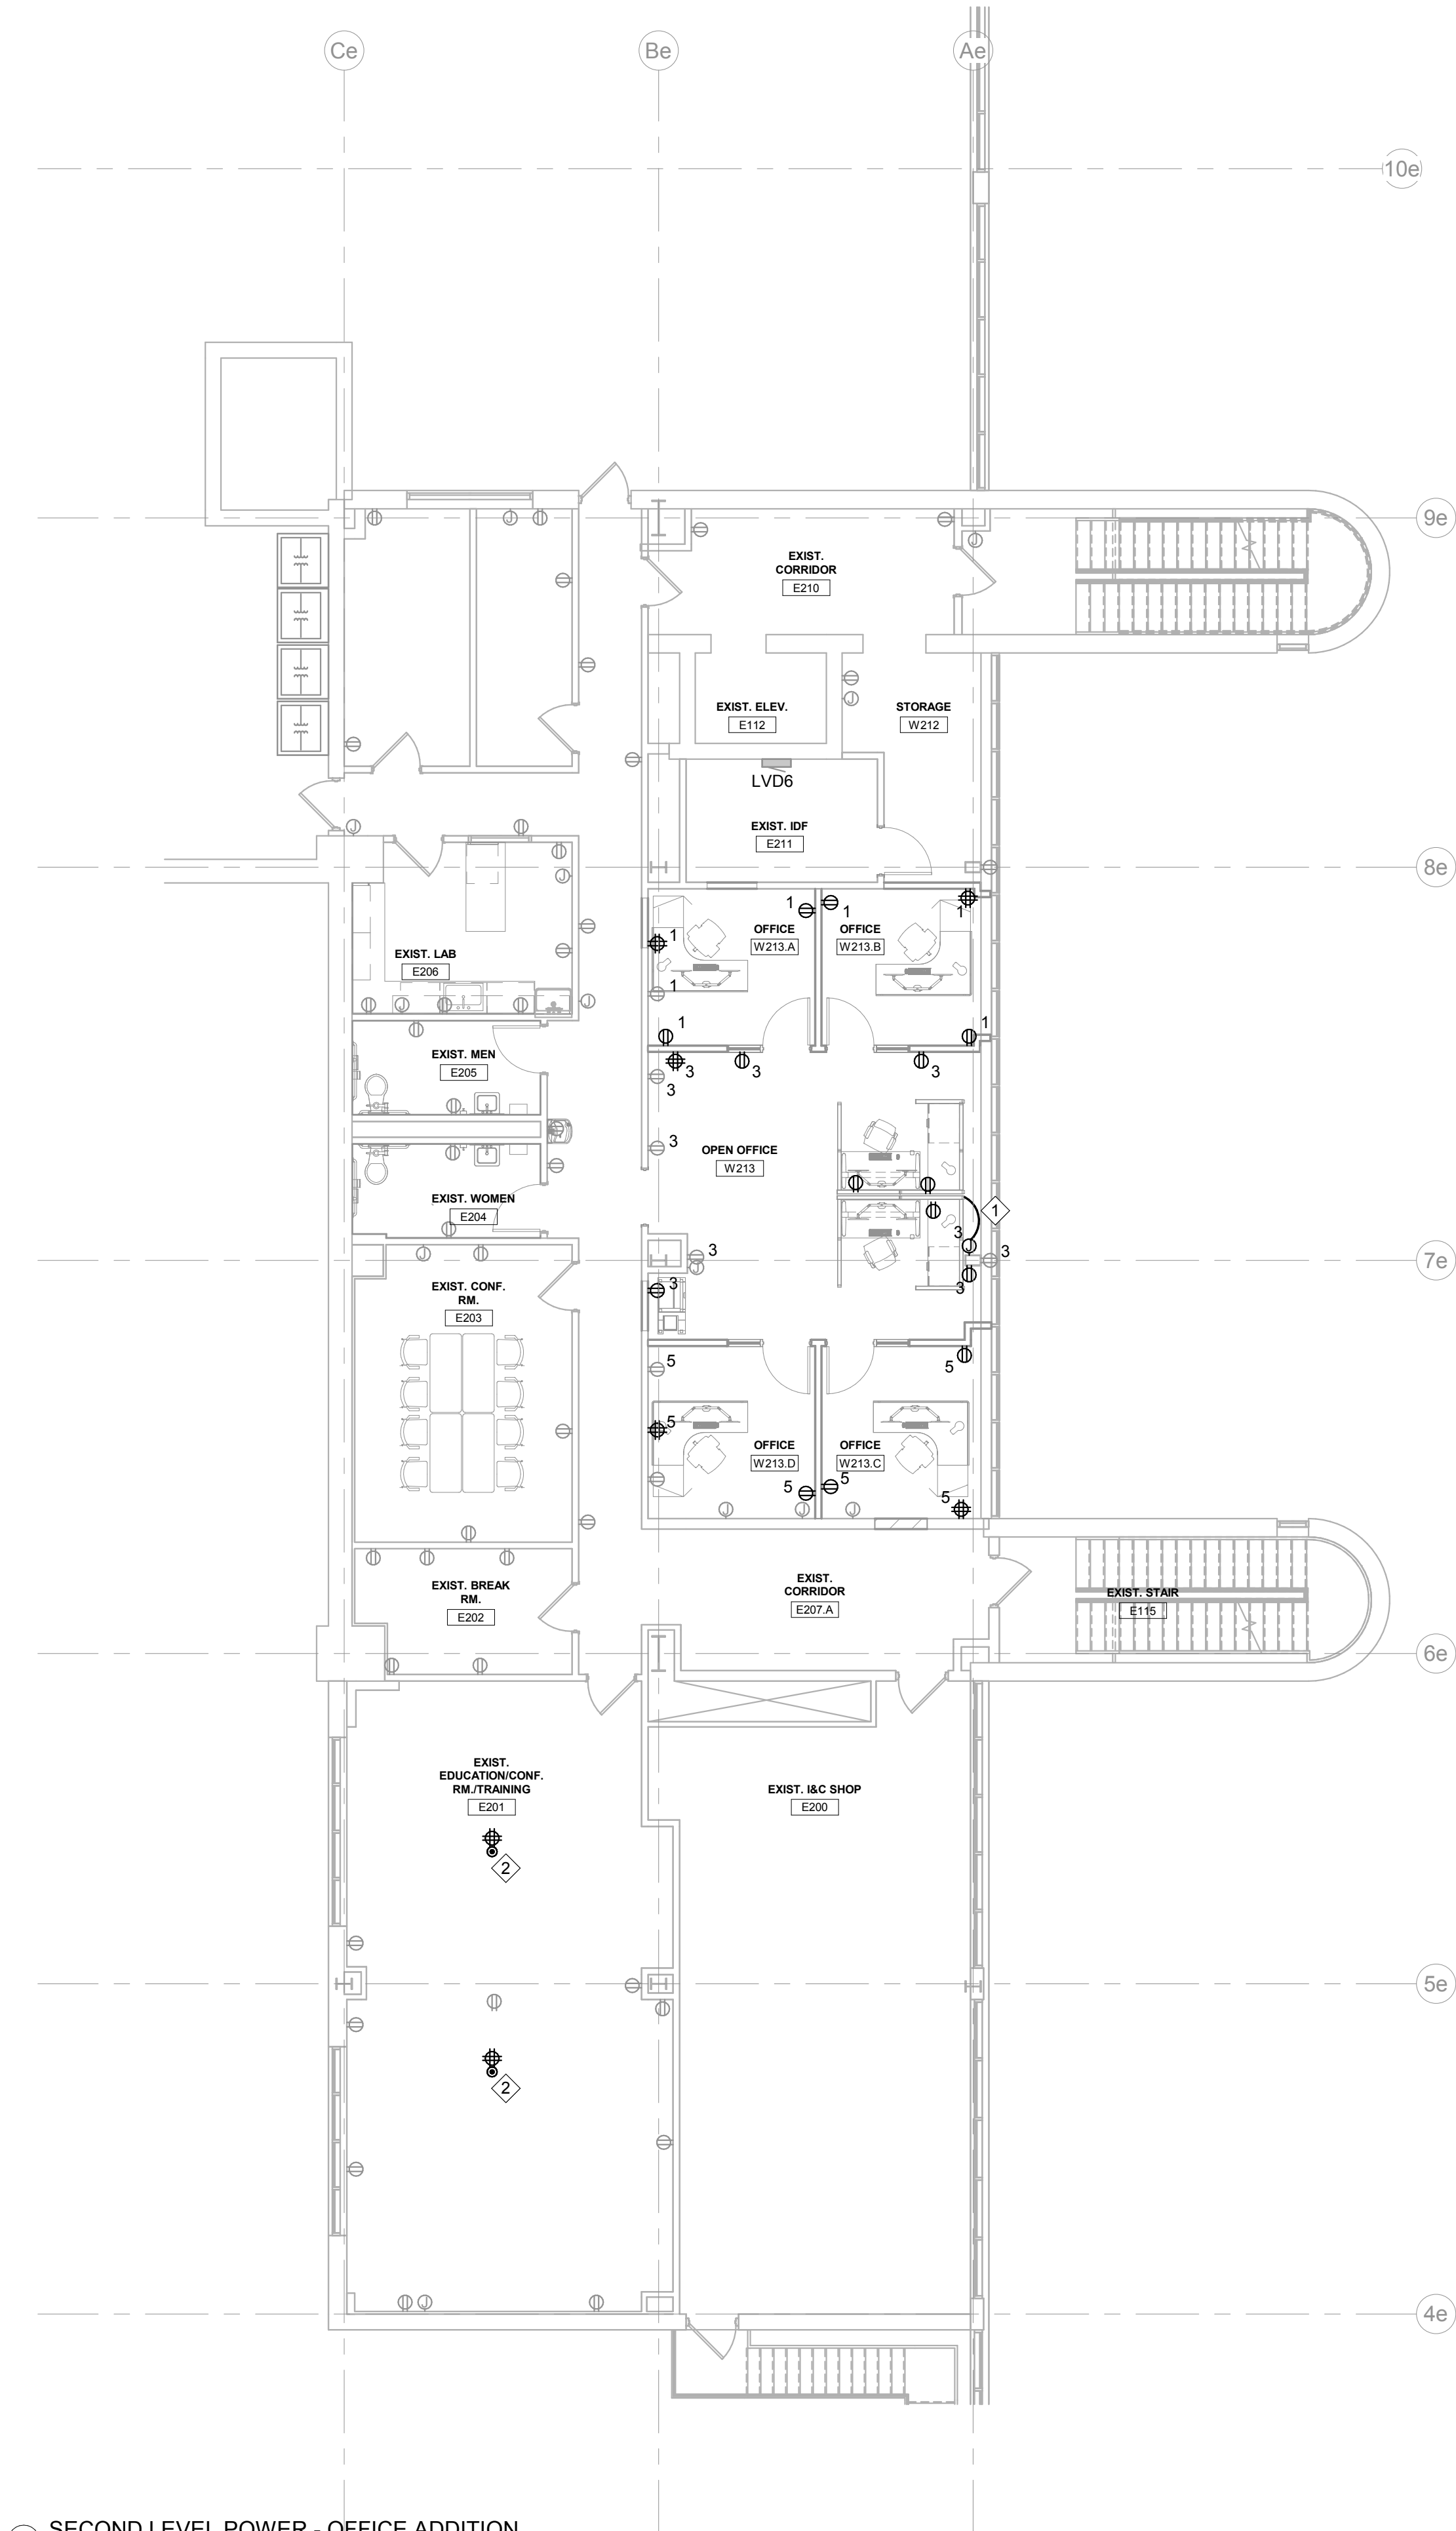
OWEF - MAIN &  
MEZZANINE LEVEL  
POWER PLAN

SHEET NUMBER

E2.1

OF SHEETS





1 SECOND LEVEL POWER - OFFICE ADDITION  
1/8" = 1'-0"

KEY NOTES:

- 1 PROVIDE JUNCTION BOX AND WHIP TO ALLOW CONNECTION MODULAR FURNITURE.
- 2 PROVIDE LEGRAND 6AT SERIES OR SIMILAR FLOOR POKETHROUGH, CIRCUIT TO LOCAL RECEPTACLES.

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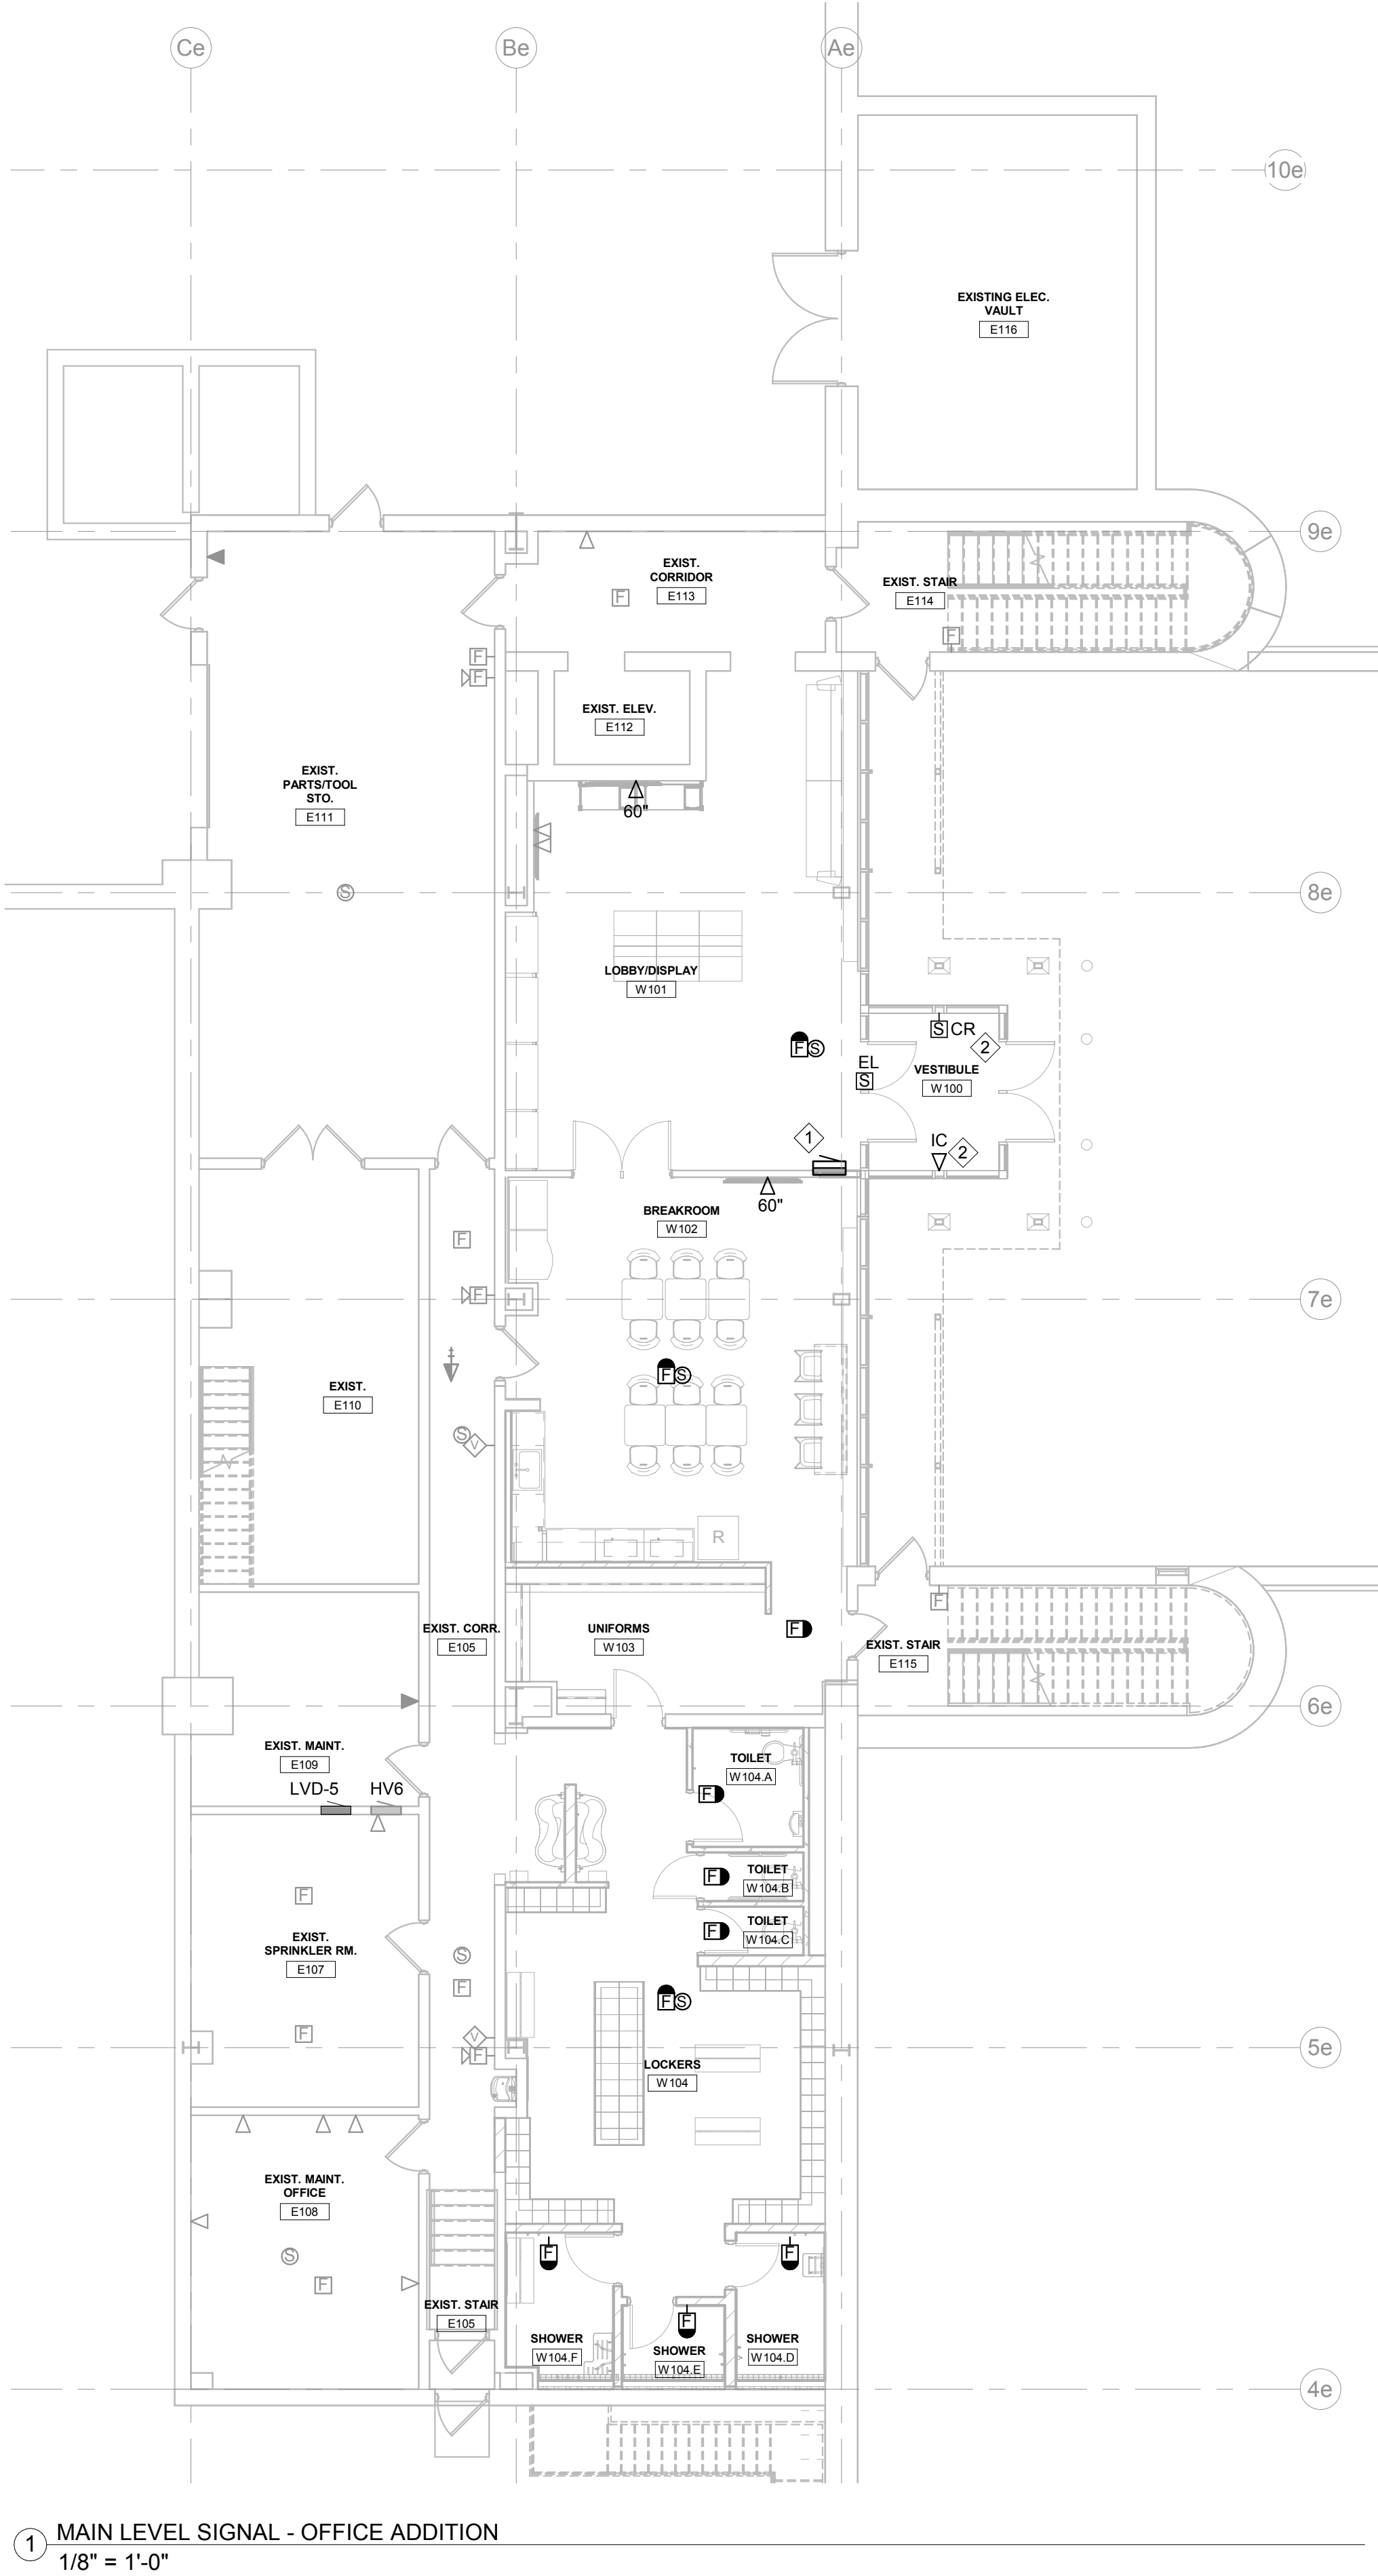
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OWEF - SECOND LEVEL  
POWER PLAN

SHEET NUMBER

E2.2

OF SHEETS



GENERAL NOTES:

- A. ROUTE ALL DATA CABLES TO EXISTING IDF ROOM E211 ON 2ND LEVEL.

KEY NOTES:

- 1 NEW LOCATION FOR FIRE ALARM ANNUNCIATOR PANEL SALVAGED DURING DEMOLITION.
- 2 NEW LOCATION FOR INTERCOM AND CARD READER/DOOR LOCK. PROVIDE NEW CONDUCTORS AS APPLICABLE. COORDINATE WITH EXISTING SYSTEM HEADENED.



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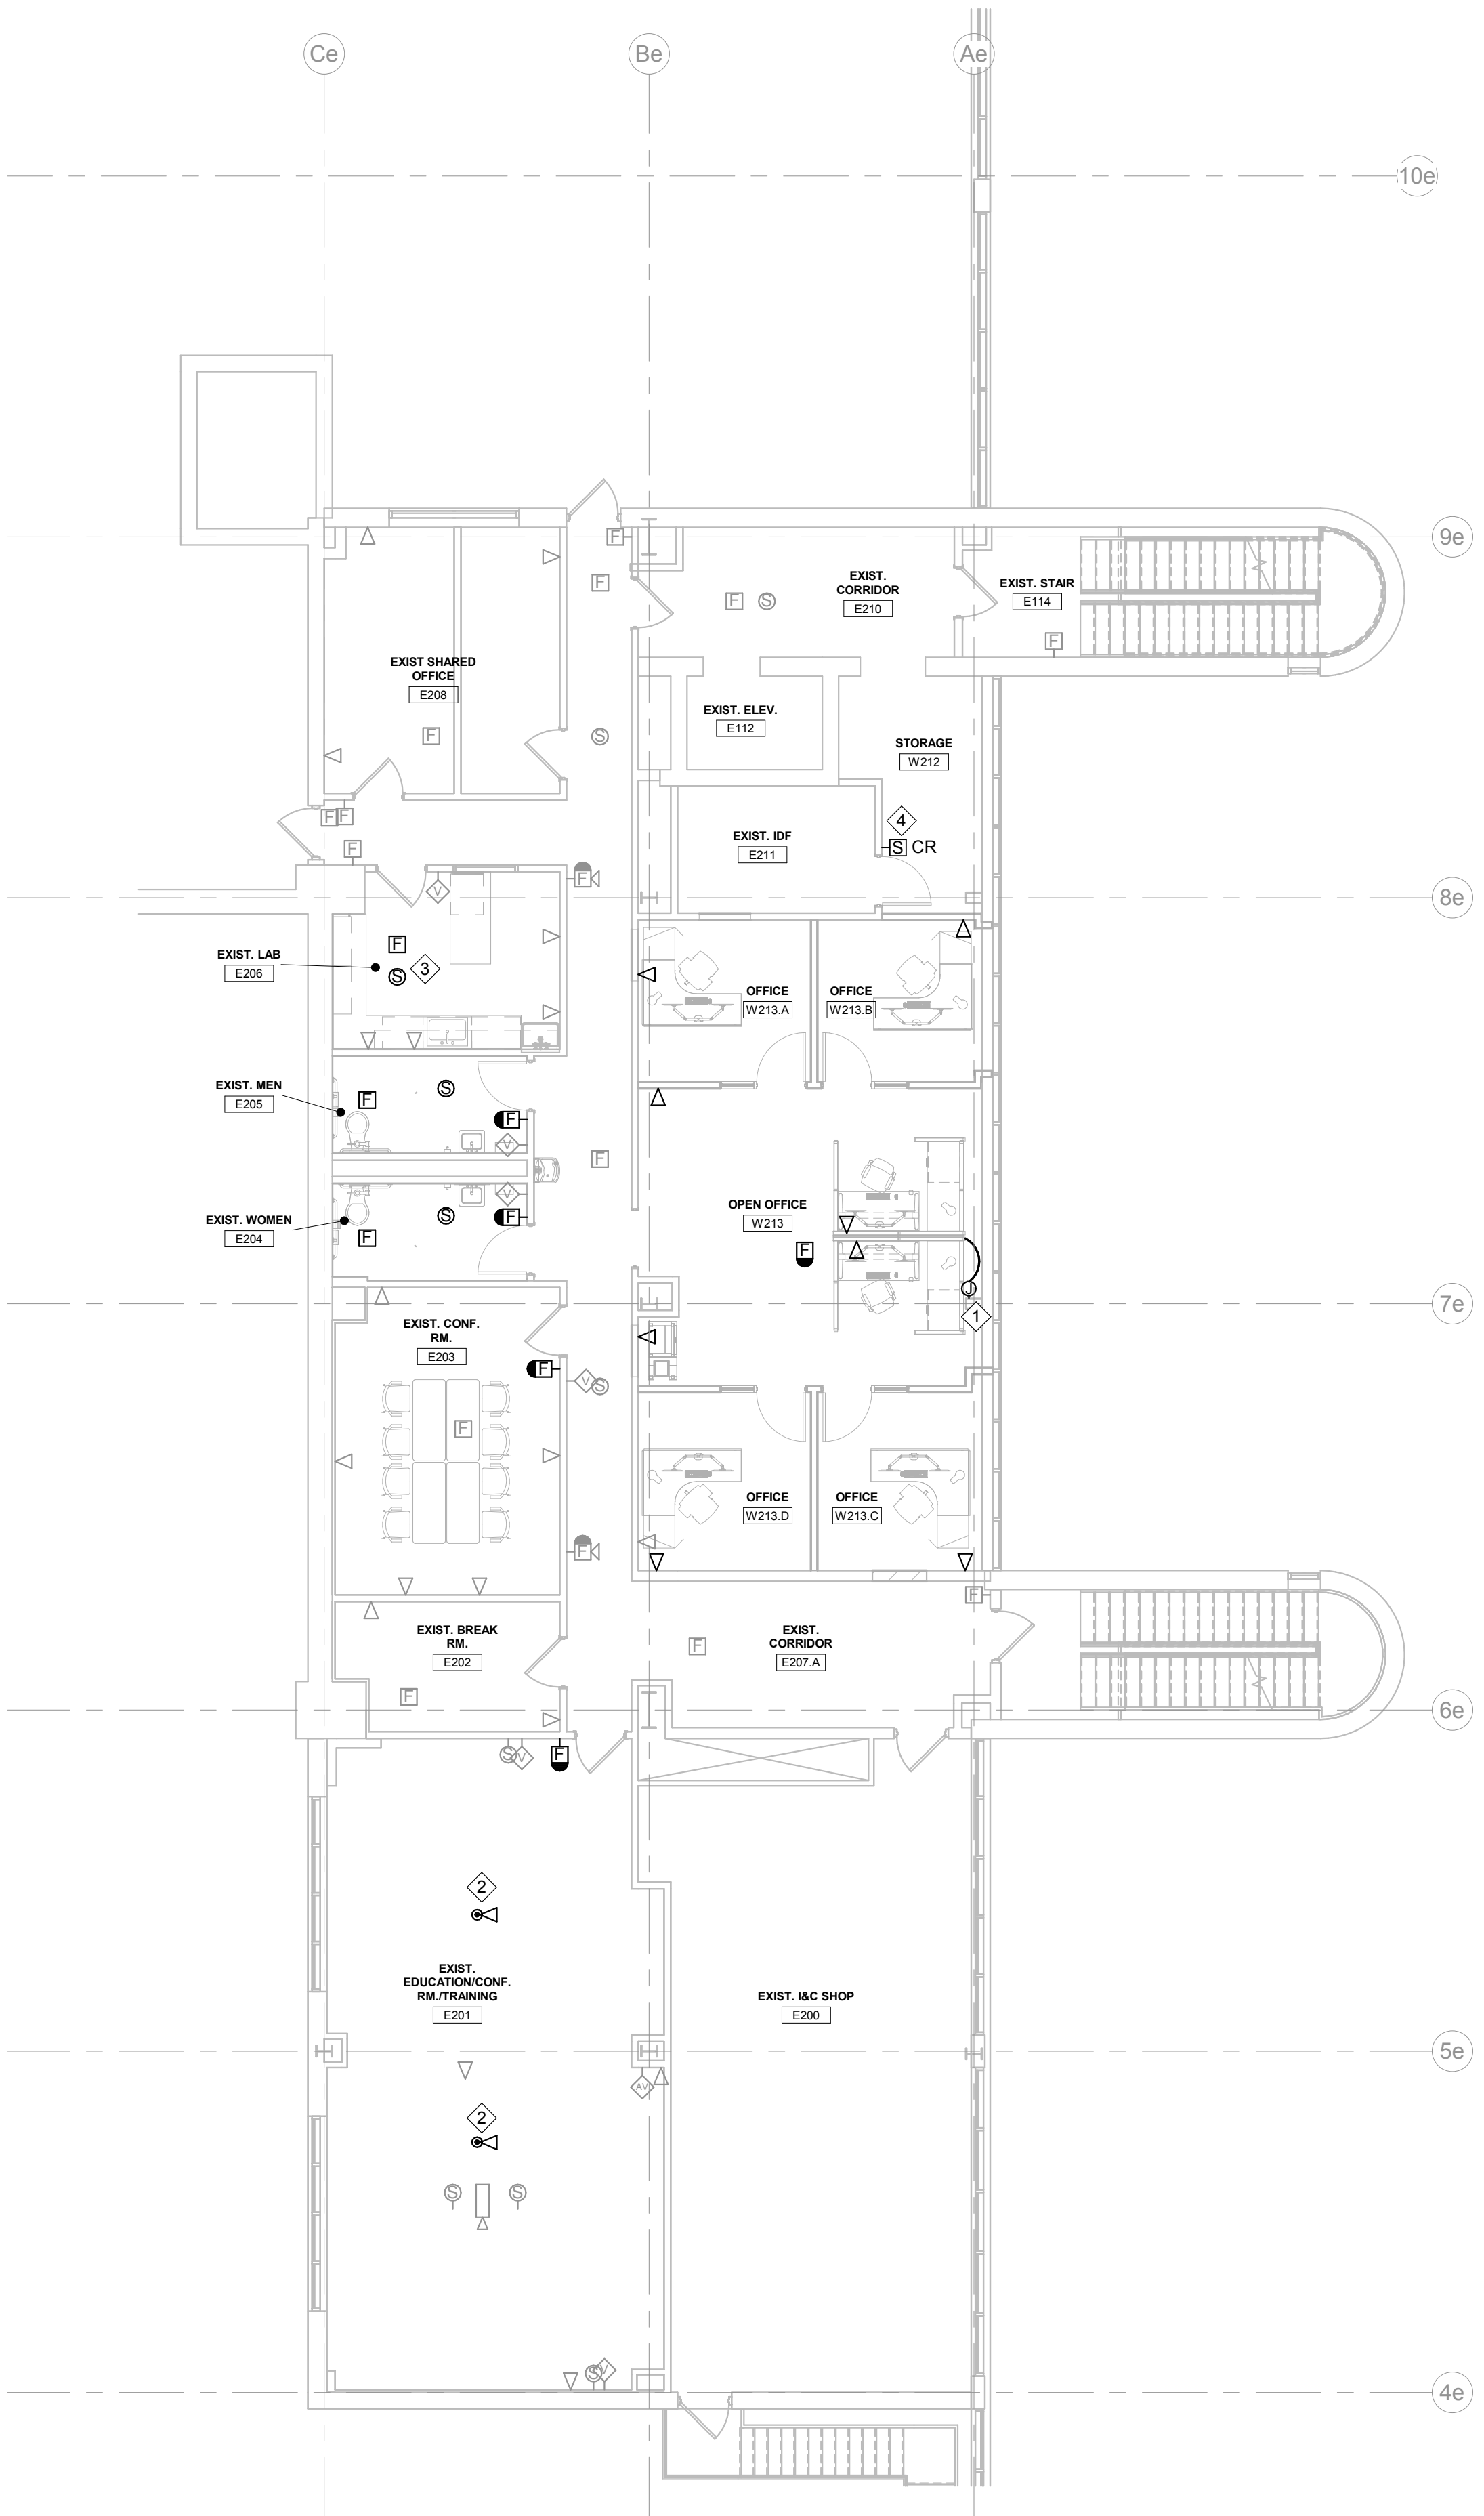
OWEF - MAIN LEVEL  
SIGNAL PLAN

SHEET NUMBER

E3.1

OF SHEETS





1 SECOND LEVEL SIGNAL - OFFICE ADDITION  
1/8" = 1'-0"

GENERAL NOTES:

- A. ROUTE ALL DATA CABLES TO EXISTING IDF ROOM E211 ON 2ND LEVEL.

KEY NOTES:

- 1 PROVIDE JUNCTION BOX AND WHIP CONNECTION FOR MODULAR FURNITURE.  
2 SEE E2.2 FOR FLOOR BOX INFORMATION.  
3 NEW DEVICE LOCATION PART OF ALTERNATE A-1.  
4 NEW LOCATION FOR CARD READER REMOVED DURING DEMOLITION.

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OWEF - SECOND LEVEL  
SIGNAL PLAN

SHEET NUMBER

E3.2

OF SHEETS

LIGHT FIXTURE SCHEDULE											
ELECTRICAL											
FIXTURE LETTER	FIXTURE STYLE	VOLTAGE	MOUNTING	LAMPS		BALLAST/ DRIVER	FIXTURE MAX VA	CONTROL MEDIA (LENS, LOUVER, ETC.)	MANUFACTURER'S SERIES NUMBER	FIXTURE DESCRIPTION	NOTES
				TYPE	COLOR						
A6	2X4 LED VOLUMETRIC TROFFER	120/277	LAY-IN GRID INVERTED TEE	LED 4800 LUM MIN	3500K	DIMMING 0-10V (10%)	44 VA	WHITE ACRYLIC OVERLAY, UPPER REFLECTOR PAINTED WHITE	LITHONIA LIGHTING 2RTL4 48L GZ10 LP850	POST PAINTED STEEL HOUSING	
B1	2X2 LED LENSED TROFFER	120/277	LAY-IN GRID INVERTED TEE	LED 3300 LUM MIN	3500K	DIMMING 0-10V (10%)	32 VA	0.125" MINIMUM ACRYLIC LENS	LITHONIA LIGHTING 2RTL2 33L GZ10 LP850 N100	POST PAINTED STEEL HOUSING	
D6	6" ROUND DOWNLIGHT	120/277	RECESSED GYP-BOARD AND/OR LAY-IN GRID INVERTED TEE	LED 1500 LUM MIN	3500K	DIMMING 0-10V (1%)	18 VA	SEMI-SPECULAR CLEAR SELF FLANGED MEDIUM DISTRIBUTION	LITHONIA LDN5 50/15 L06AR LSS GZ10	PRE-PAINTED WHITE ALUMINUM HOUSING, PRE-WIRED J-BOX, TWO 27" HANGER BARS	
E1	EXIT SIGN, SINGLE FACE, EDGE LIT, AC ONLY	120/277	RECESSED	LED	RED	N/A	4 VA	RED LETTERS	LITHONIA ECRG HO RD M6	BRUSHED ALUMINUM BASE, CLEAR FACE, MIRROR BACK, UNIVERSAL FACEPLATE KIT, MOUNTING PER FLOOR PLAN, AC ONLY UL924	
F4	4" INDUSTRIAL	120/277	SURFACE/ CHAIN HUNG	LED 4000 LUM MIN	3500K	DIMMING 0-10V (10%)	40 VA	SEMI FROSTED ACRYLIC LENS	COOPER-METALUX SNLED SERIES COLUMBIA LCL SERIES LITHONIA CLX SERIES ORACLE OEC-LED SERIES	STEEL CHANNEL, WHITE POWDER COAT	
GENERAL ELECTRICAL NOTES:											
A. REFER TO SPECIFICATION SECTIONS 265100 AND 265600 FOR LIGHT FIXTURE REQUIREMENTS.											
B. BRING CONFLICTS BETWEEN THE MANUFACTURER'S CATALOG NUMBER AND DESCRIPTIONS TO THE ATTENTION OF THE ENGINEER.											
C. LIGHT SOURCE SHALL HAVE COLOR TEMPERATURE 3500K WITH MINIMUM CRI OF 80 UNLESS OTHERWISE NOTED.											
D. UNLESS A SPECIFIC CATALOG NUMBER OR SERIES IS NAMED, THE MANUFACTURER'S NAMED ALTERNATES MUST SUBMIT CATALOG CUT SHEETS AND IES FORMATTED PHOTOMETRIC REPORT TO THE ENGINEER FOR APPROVAL AT LEAST 10 DAYS PRIOR TO BID DATE. THE ENGINEER MAY REQUEST SAMPLE OF LUMINAIRE TO BE SUPPLIED.											
E. MINIMUM LUMENS LISTED FOR LIGHT FIXTURES ARE DELIVERED LUMENS BASED ON PHOTOMETRIC TESTING COMPLETED IN ACCORDANCE WITH IES LM-79 STANDARDS.											
F. SUBSTITUTE LIGHT FIXTURE IS SUBJECT TO ARCHITECT/ENGINEER APPROVAL.											
NOTES:											

LIGHTING CONTROL SEQUENCE SCHEDULE															
<div>LC # LIGHTING CONTROL SEQUENCE SYMBOL FOUND ON LIGHTING PLAN(S).</div>															
LIGHTING CONTROL SEQUENCE	EMS/BAS CAPABILITIES	NETWORK CONTROL SYSTEM	TIME CLOCK	VACANCY SENSOR	OCCUPANCY SENSOR	AUTO OFF TIME (MINUTES)	LIGHT REDUCTION % SWITCHING (MIN 50%)	DIMMING TYPE	DIMMING LEVEL	SIDELIGHT DAYLIGHT HARVEST (AUTOMATIC/ SWITCHED)	TOPLIGHT DAYLIGHT HARVEST (AUTOMATIC/ SWITCHED)	AFTERHOURS OVERRIDE	OVERRIDE DURATION	MANUAL ON/OFF	NOTES
LC 1	X	X	X	DUAL TECH.		20		0-10V	0.01			X	2 HOURS	YES	
LC 2								0-10V	0.01						
LC 3				PASSIVE INFRARED		5								YES	
LC 4					DUAL TECH.	20								NO	
LC 4A					DUAL TECH.	5									
LC 6				DUAL TECH.		20		0-10V	0.01			NOTE 5	2 HOURS		
<div>GENERAL NOTES:</div> <div>A. PROVIDE ALL PARTS AND PIECES NECESSARY TO MAKE A FUNCTIONAL LIGHTING CONTROL SYSTEM WITH ALL CONTROLS AS MARKED ABOVE.</div> <div>B. SUPPLIER TO PROVIDE COMPLETE WIRING DIAGRAM PRIOR TO INSTALLATION.</div> <div>C. IF DIMMING IS CALLED FOR IN SCHEDULE, IT IS THE CONTRACTOR'S RESPONSIBILITY TO VERIFY AND PROVIDE ALL NECESSARY PARTS, BALLASTS, DRIVERS, ETC. TO PROVIDE THE DIMMING FUNCTION.</div> <div>D. CONTRACTOR TO PROVIDE ALL WIRING NECESSARY INCLUDING ANY 0-10V CONTROL WIRING AS REQUIRED.</div> <div>E. CONTRACTOR MUST COMPLY WITH THE CONTROLS INTENT AS INDICATED ON THE DRAWINGS.</div> <div>F. AT MINIMUM, CONTRACTOR SHALL HOLD TWO PRE CONSTRUCTION MEETINGS, PRIOR TO BID, WITH THEIR SELECTED LIGHTING CONTROLS VENDOR OR SUPPLIER.</div> <div>G. THE INTENT OF (2) PRE CONSTRUCTION MEETINGS IS TO DEVELOP AN UNDERSTANDING OF THE CONTROLS SYSTEM TO ACCURATELY ACCOUNT FOR ALL POWER, CONTROLS, CABLING, EQUIPMENT AND CONNECTION REQUIREMENTS.</div> <div>H. CONTRACTOR SHALL PROVIDE ALL NECESSARY COMPONENTS, ACCESSORIES AND ASSOCIATED LABOR FOR THEIR SELECTED LIGHTING CONTROLS SYSTEM.</div>															
<div>ELECTRICAL NOTES:</div>															



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OWEF - ELECTRICAL SCHEDULES

SHEET NUMBER

E4.1  
OF SHEETS



NAME: LVD-5											
ENCLOSURE: NEMA 1				SUPPLY FROM: TLVD-9				VOLTAGE: 120/208			
MOUNTING: SURFACE				FEED THRU LUGS: No				PHASE: 3			
INCOMING FEED: TOP				FTL SUB PANEL: No				WIRE: 4			
								CALCULATED AFC: 4.6k			
CKT	CIRCUIT DESCRIPTION	NOTE	TRIP	POLE		POLE	TRIP	NOTE	CIRCUIT DESCRIPTION		CKT
1	RECEPTACLES 1015 SPRINKLER ROOM	GFCI	20	1		1	20	GFCI	REC 1015 SOUTH LOCKER ROOM & GENIE...		2
3	RECEPTACLES 1015 SPRINKLER ROOM	GFCI	20	1		1	20	GFCI	YELLOW HANING CORD IN MAINTENANCE SHOP		4
5	RECEPTACLES 1015 SPRINKLER ROOM	GFCI	20	1		1	20	GFCI	RECEPTACLES 1015 SOUTH LOCKER ROOM		6
7	RECEPTACLES 1015 UNIFORM STORAGE	GFCI	20	1		1	20	GFCI	RECEPTACLES 1015 HALLWAY		8
9	REC S 1015 UNIFORM STORAGE AND MECHANIC...	GFCI	20	1		1	20	GFCI	REC 1015 NORTH LOCKER ROOM & GENIE...		10
11	REC S 1015 UNIFORM STORAGE AND MECHANIC...	GFCI	20	1		1	20	GFCI	RECEPTACLES 1015 NORTH LOCKER ROOM		12
13	REC S 1015 PARTS ROOM AND MAINTENANCE....	GFCI	20	1		1	20	GFCI	REC S 1015 LUNCH ROOM AND HALLWAY		14
15	REC S 1015 PARTS ROOM AND MAINTENANCE....	GFCI	20	1		1	20	GFCI	RECEPTACLES 1015 LUNCH ROOM		16
17	REC S 1015 PARTS ROOM AND MAINTENANCE....	GFCI	20	1		1	20		REC S 1015 LUNCH ROOM AND HALLWAY		18
19	REC S 1015 PARTS ROOM AND HALLWAY	GFCI	20	1		1	20		REC S 1015 LUNCH ROOM AND RECEPTION AREA		20
21	RECEPTACLES 1015 MAINTENANCE SHOP	GFCI	20	1		1	20		REC S 1015 LUNCH ROOM AND RECEPTION AREA		22
23	RECEPTACLES 1015 MAINTENANCE SHOP	GFCI	20	1		1	20	GFCI	RECEPTACLES 1015 RECEPTION AREA		24
25	REC S 1015 ELEVATOR LOBBY AND RECEPTION...	GFCI	20	1		1	20	GFCI	SPARE (IN USE)		26
27	REC S 1015 ELEVATOR LOBBY FASTENAL...	GFCI	20	1		1	20		CONTROL TRANSFORMER		28
29	SPARE (IN USE)	GFCI	20	1		1	20		SPARE (IN USE)		30
31	SPARE (IN USE)	GFCI	20	1		1	20		SPARE (IN USE)		32
33	RECEPTACLES		15	1		1	20		EXHAUST FAN EF-1		34
35	SPARE (IN USE)		20	1		1	20		SPARE (IN USE)		36
37	SPARE (IN USE)		20	1							38
39	JIB CRANE IN MAINTENANCE SHOP	GFCI	20	1		3	15		1015 MECHANICAL ROOM CONDENSATE PUMPS		40
41	SPARE	GFCI	20	1							42
43	SPARE		20	1		1	20		SPARE		44
45	SPARE		20	1		1	20		RM E102 RECEPTS		46
47	RM E101 QUAD RECEPTS		20	1		1	20		RECEPTACLES - MICROWAVE		48
49	RM E101 DUPLEX RECEPTS		20	1		1	20		RECEPTACLES - REFRIGERATOR		50
51	RECEPTACLES -LOBBY		20	1		1	20		SWH 01 - WATER HEATER, DWP 01 CIRC PUMP		52
53	RECEPTACLES - E109		20	1		1	20		FPVAV 02		54
55	RM W104 RECEPTS		20	1		1	20		FPVAV 03		56
57	RECEPTACLES - BREAKROOM		20	1		1	20		FPVAV 01		58
59	RECEPTACLES - MICROWAVE		20	1		1	20		SPARE		60
GENERAL NOTES:											
A.											
B.											
C.											
NOTES:											
1.											
2.											
3.											
4.											
5.											
6.											

NAME: HV6											
ENCLOSURE: NEMA 1				SUPPLY FROM:				VOLTAGE: 277/480			
MOUNTING: SURFACE				FEED THRU LUGS:				PHASE: 3			
INCOMING FEED:				FTL SUB PANEL:				WIRE: 4			
								CALCULATED AFC:			
CKT	CIRCUIT DESCRIPTION	NOTE	TRIP	POLE		POLE	TRIP	NOTE	CIRCUIT DESCRIPTION		CKT
1	LIGHTS 1015 MAINTENANCE AREA AND PAT		20	1		1	20		LIGHTS 1015 RECEPTION AREA		2
3	LIGHTS 1015 MAINTENANCE AREA AND PAT		20	1		1	20		LIGHTS 1015 HALLWAY, ADMIN AND LUNCH		4
5	LIGHTS 1015 NW ADMIN OFFICE		20	1		1	20		LIGHTS 1015 ADMIN LOCKERS		6
7	LIGHTS 1035 NW ADMIN OFFICE		20	1		1	20		LIGHTS 1015 HALLWAY AND UNFINISHED AREA		8
9	LIGHTS 1035 NW ADMIN OFFICE		20	1		1	20		SPARE (IN USE)		10
11	LIGHTS 1024 MEZZANINE AREA		20	1		1	20	1	LIGHTS W104 LOCKERS		12
13	LIGHTS 1050 CONTROL ROOM		20	1		1	20	1	LIGHTS LOBBY AND BREAKROOM		14
15	LIGHTS 1050 CORRIDOR, COFFEE AND TOILET		20	1		1	20		DA_L		16
17	LIGHTS 1050 CONTROL ROOM		20	1		1	20		SPARE		18
19	CUH 01 - ENTRY HEATER		40	1							20
21	SPARE		20	1					MOTOR TEST BENCH 1015		22
23	SPARE		20	1							24
GENERAL NOTES:											
A.											
B.											
C.											
NOTES:											
1. UTILIZE EXISTING SPARE BREAKER											
2.											
3.											
4.											
5.											
6.											

NAME: LVD6											
ENCLOSURE: NEMA 1				SUPPLY FROM:				VOLTAGE: 120/208			
MOUNTING: SURFACE				FEED THRU LUGS:				PHASE: 3			
INCOMING FEED:				FTL SUB PANEL:				WIRE: 4			
								CALCULATED AFC:			
CKT	CIRCUIT DESCRIPTION	NOTE	TRIP	POLE		POLE	TRIP	NOTE	CIRCUIT DESCRIPTION		CKT
1	RECEPTACLES 1035 CONFERENCE ROOM	GFCI	20	1		1	20	GFCI	RECEPT 1035 WEST WALL I/C SHOP		2
3	RECEPTACLES 1035 CONFERENCE ROOM	GFCI	20	1		1	20	GFCI	RECEPT 1035 WEST WALL I/C SHOP		4
5	RECEPTACLES 1035 CONFERENCE ROOM	GFCI	20	1		1	20	GFCI	RECEPTACLES 1035 EAST OFFICE		6
7	RECEPTACLES 1035 COPY ROOM	GFCI	20	1		1	20		OFFICE CUBICLE		8
9	RECEPTACLES 1035 COPY ROOM	GFCI	20	1		1	20		NE OFFICE BEAM		10
11	RECEPTACLES 1035 COPY ROOM	GFCI	20	1		1	20		SE OFFICE BEAM		12
13	REC S 1035 PLAN MANAGER OFFICE AND...	GFCI	20	1		1	20		RECEPTACLES 1035 EAST OFFICE		14
15	REC S 1035 PLAN MANAGER OFFICE AND...	GFCI	20	1		1	20		RECEPTACLES 1035 EAST OFFICE		16
17	REC S 1035 PLAN MANAGER OFFICE AND...	GFCI	20	1		1	20		RECEPTACLES 1035 EAST OFFICE		18
19	REC S 1035 PLAN MANAGER OFFICE AND...	GFCI	20	1		1	--		SPACE		20
21	RECEPTACLES 1035 LAB	GFCI	20	1		1	20	GFCI	SPARE		22
23	RECEPTACLES 1035 LAB	GFCI	20	1		1	20	GFCI	SPARE		24
25	RECEPTACLES 1035 NORTHWEST OFFICE AND...	GFCI	20	1		1	20	GFCI	1035 RESTROOM AND LAB EXHUAUST FANS		26
27	RECEPTACLES 1035 NORTHWEST OFFICE AND...	GFCI	20	1		1	20	GFCI	RECEPTACLES 1035 ELEVATOR LOBBY		28
29	RECEPTACLES 1035 NORTHWEST OFFICE	GFCI	20	1		1	20	GFCI	SPARE (IN USE)		30
31	1035 CONFERENCE ROOM TRACK LIGHTS		20	1		1	20		DATA ROOM		32
33	1035 CONFERENCE ROOM TRACK LIGHTS		20	1		1	20		DATA ROOM		34
35	RECEPTACLE 1035 DRINKING FOUNTAIN		20	1		1	20		DATA ROOM		36
37	1035 CUBICLE IGHTS REC S NORTH AND CENTER...		20	1		1	20		DATA ROOM		38
39	REC S 1025 EAST OFFICES (SOUTH CUBICLES)		20	1		1	20		DATA ROOM		40
41	RES S 1035 EAST OFFICES (NORTH CUBICLES)		20	1		1	20		DATA ROOM		42
GENERAL NOTES:											
A.											
B.											
C.											
NOTES:											
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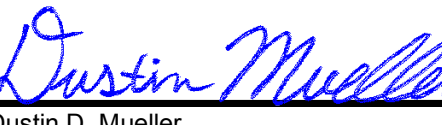
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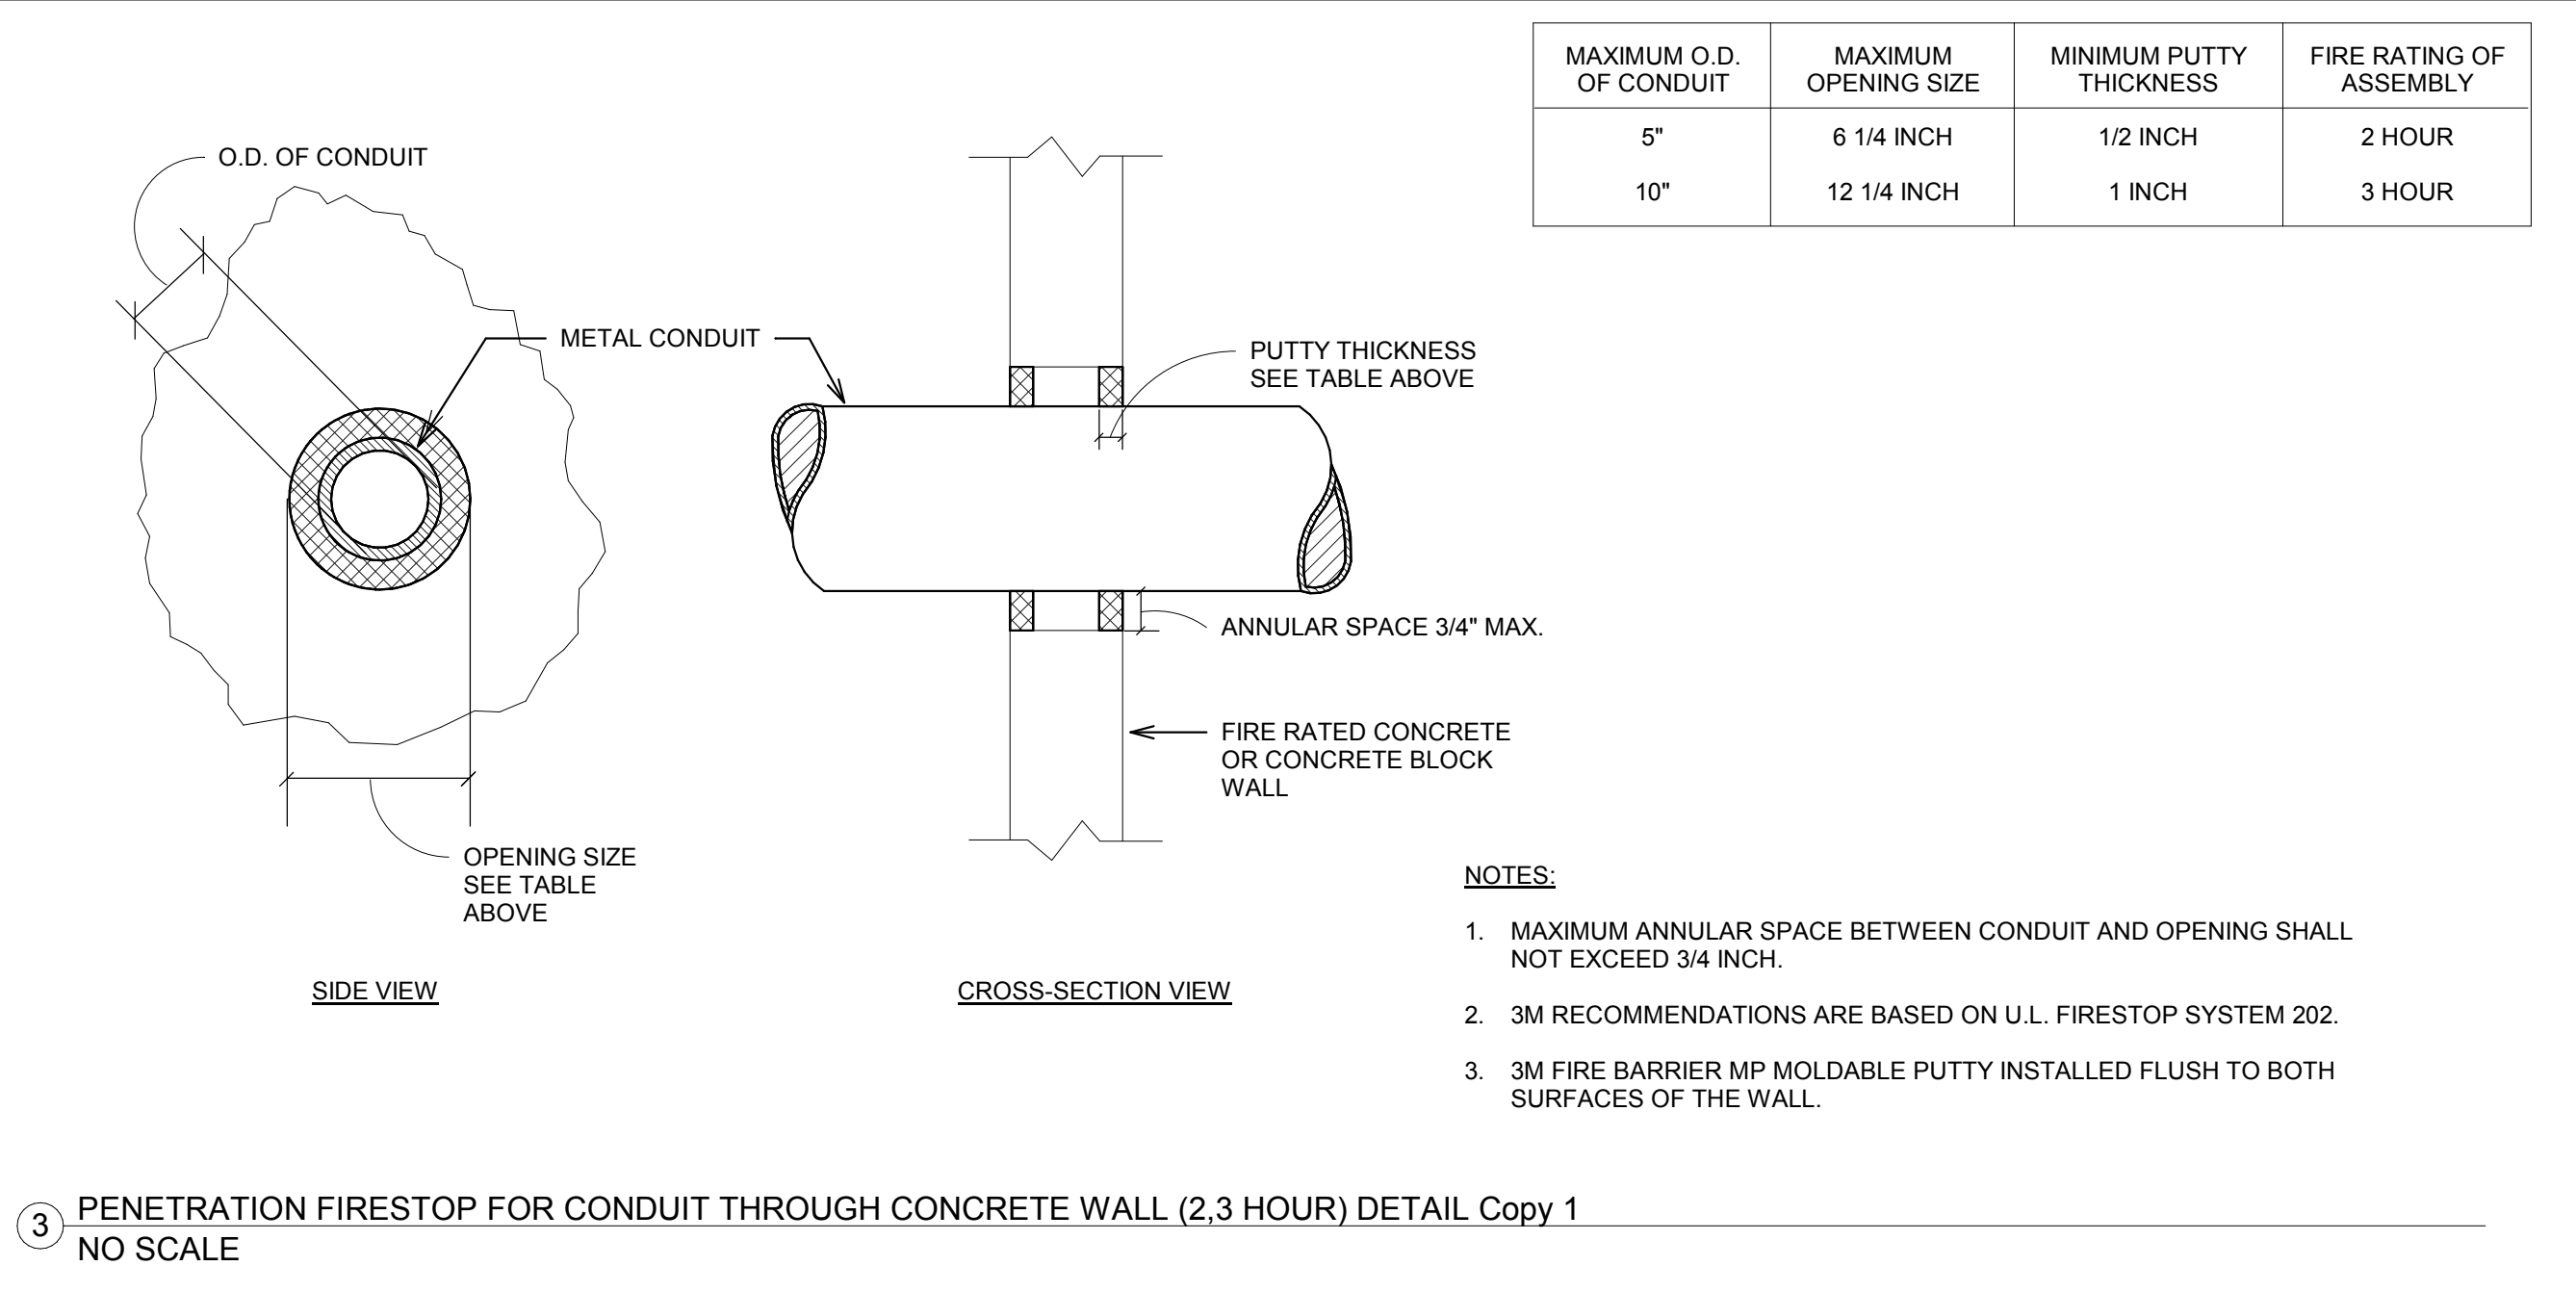
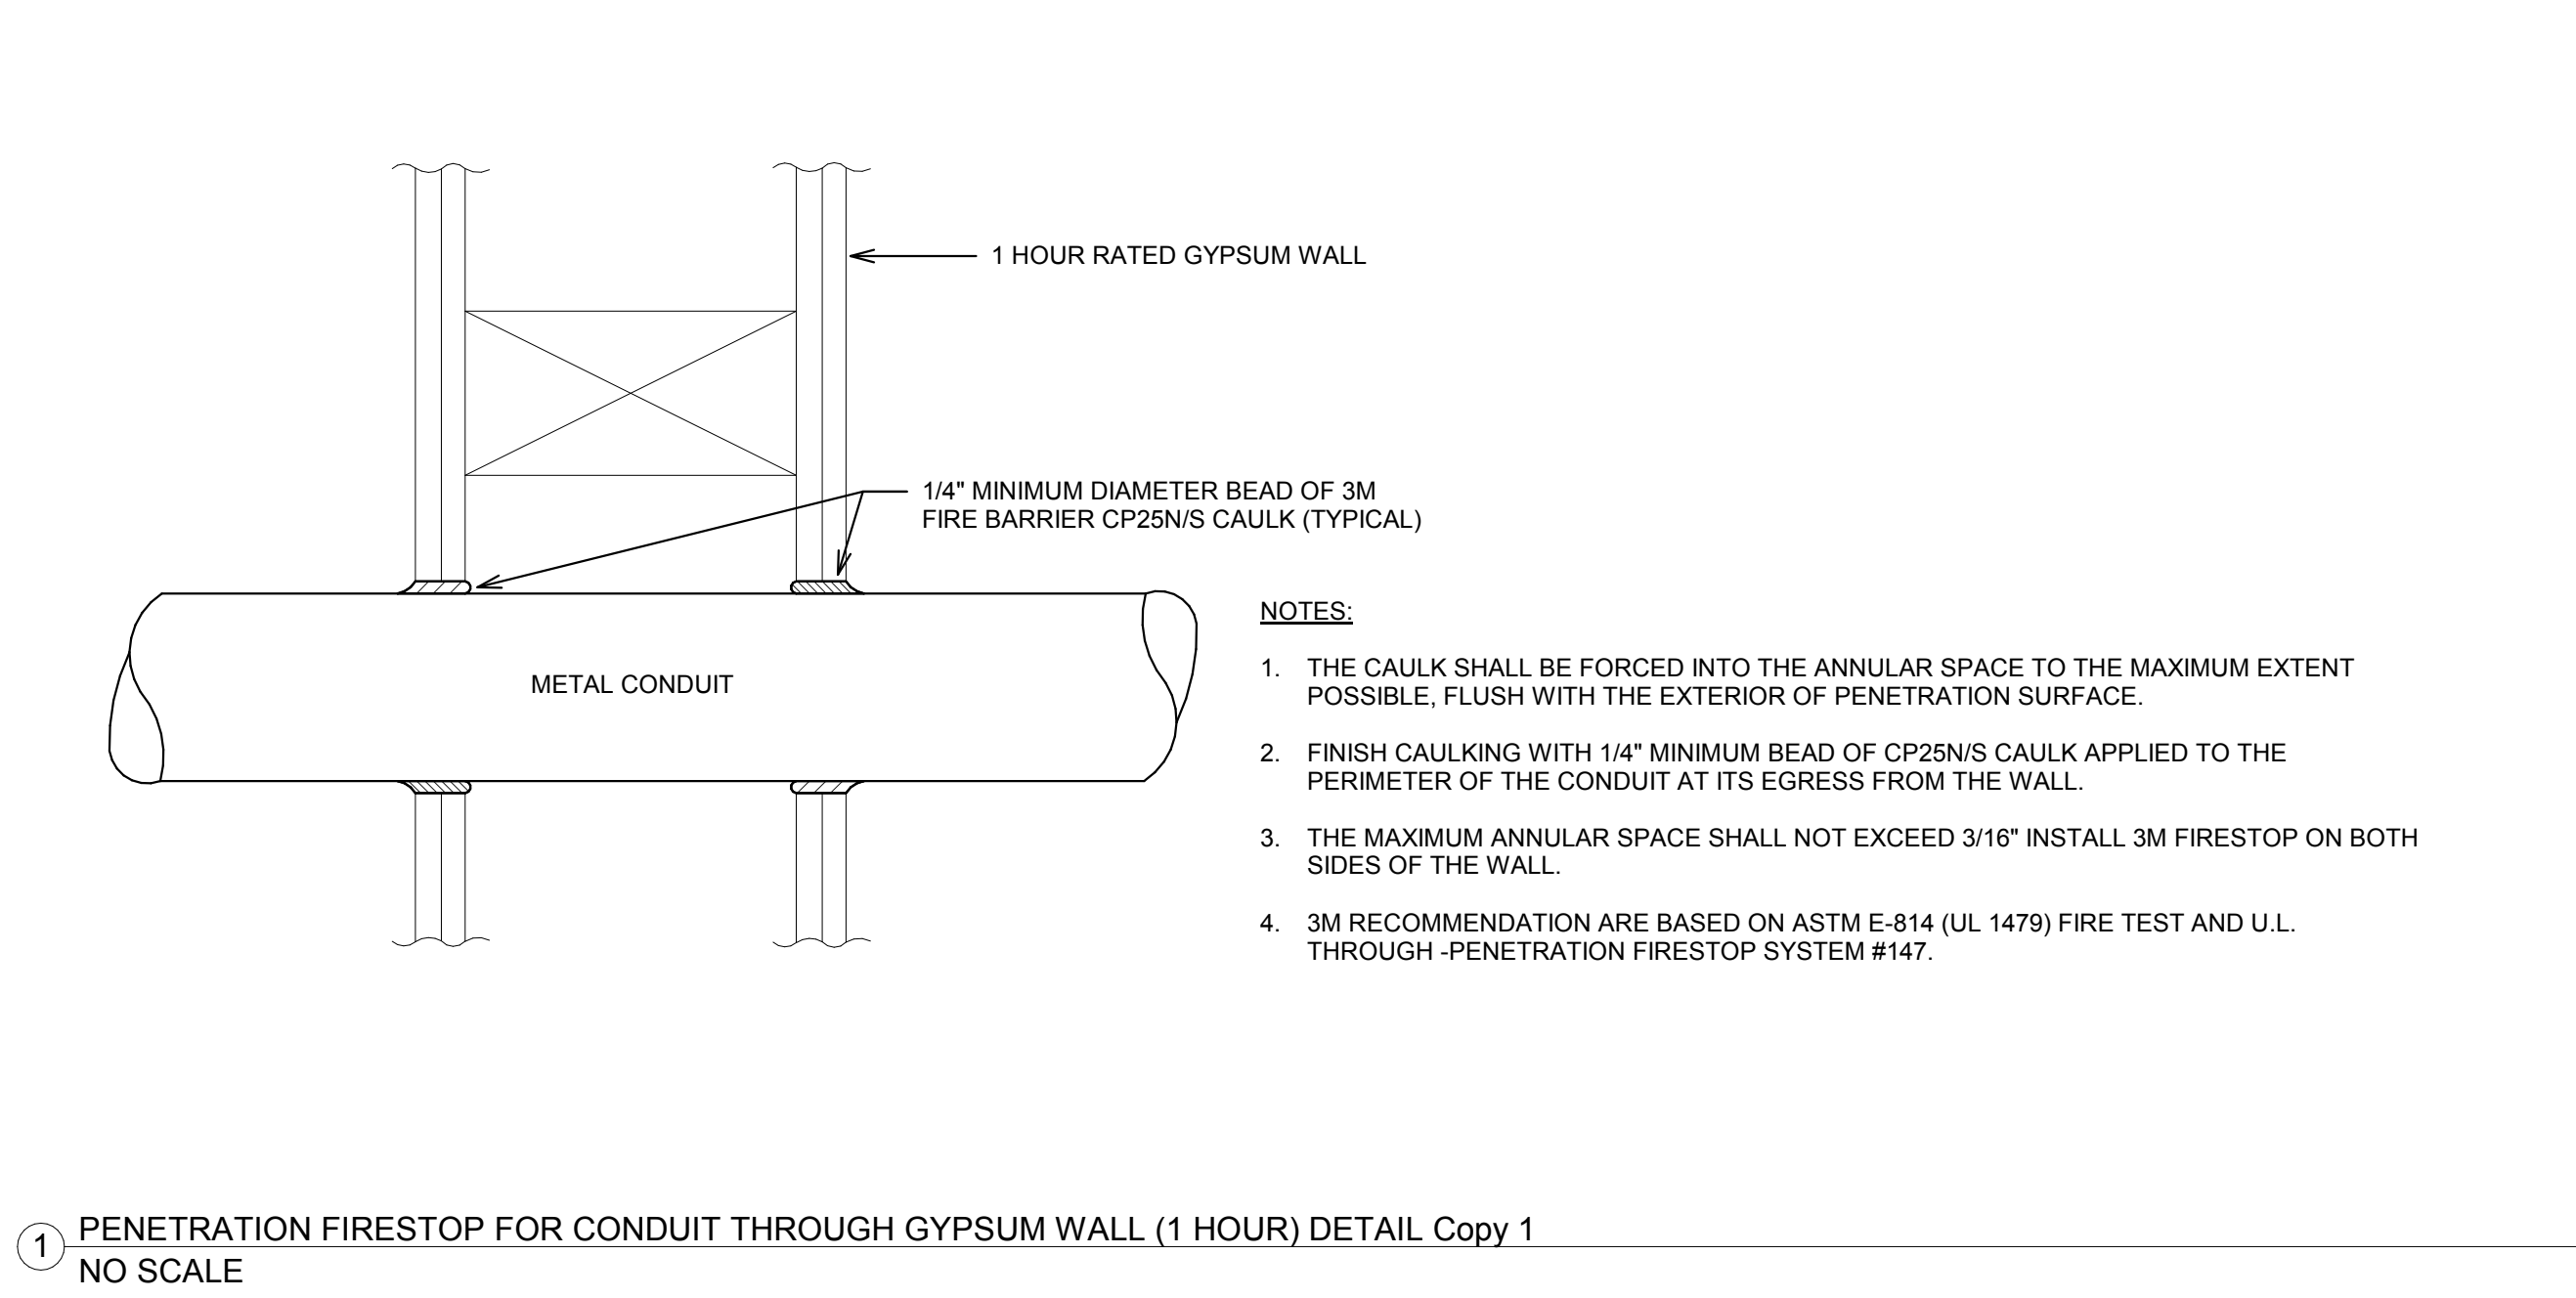
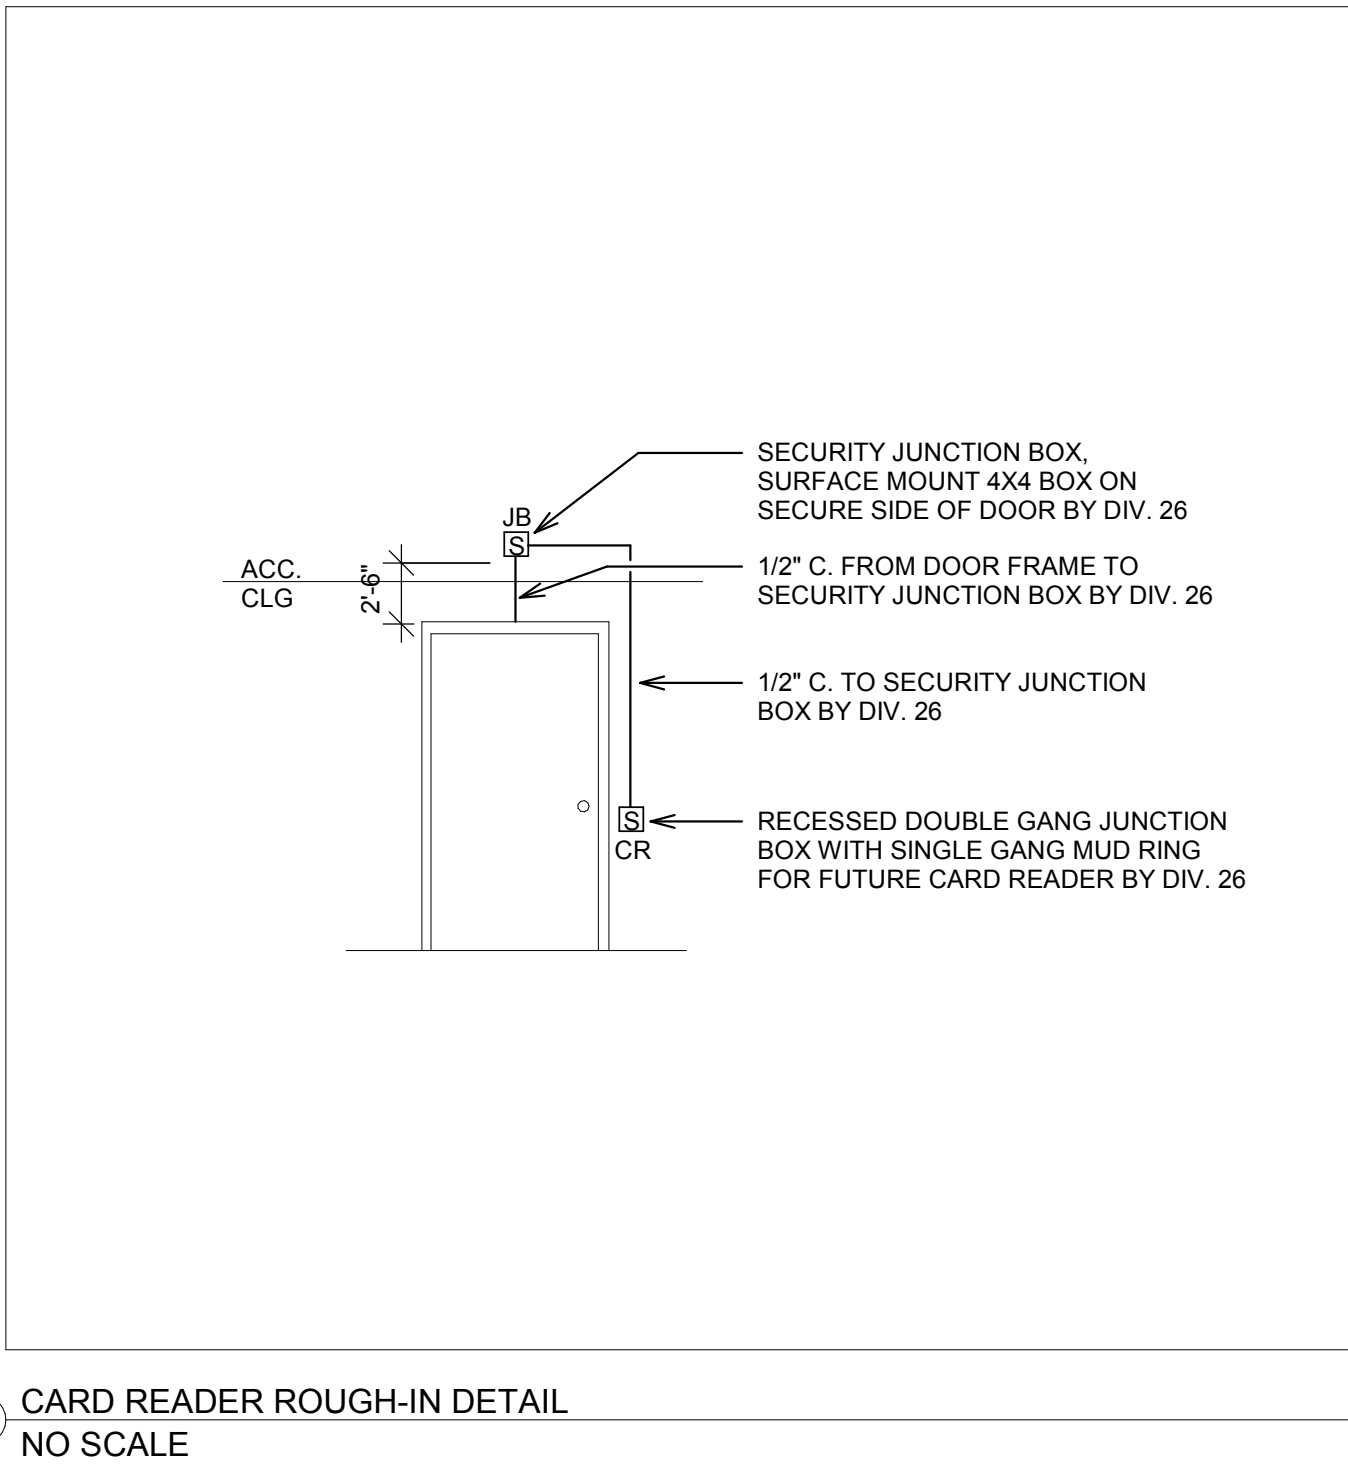
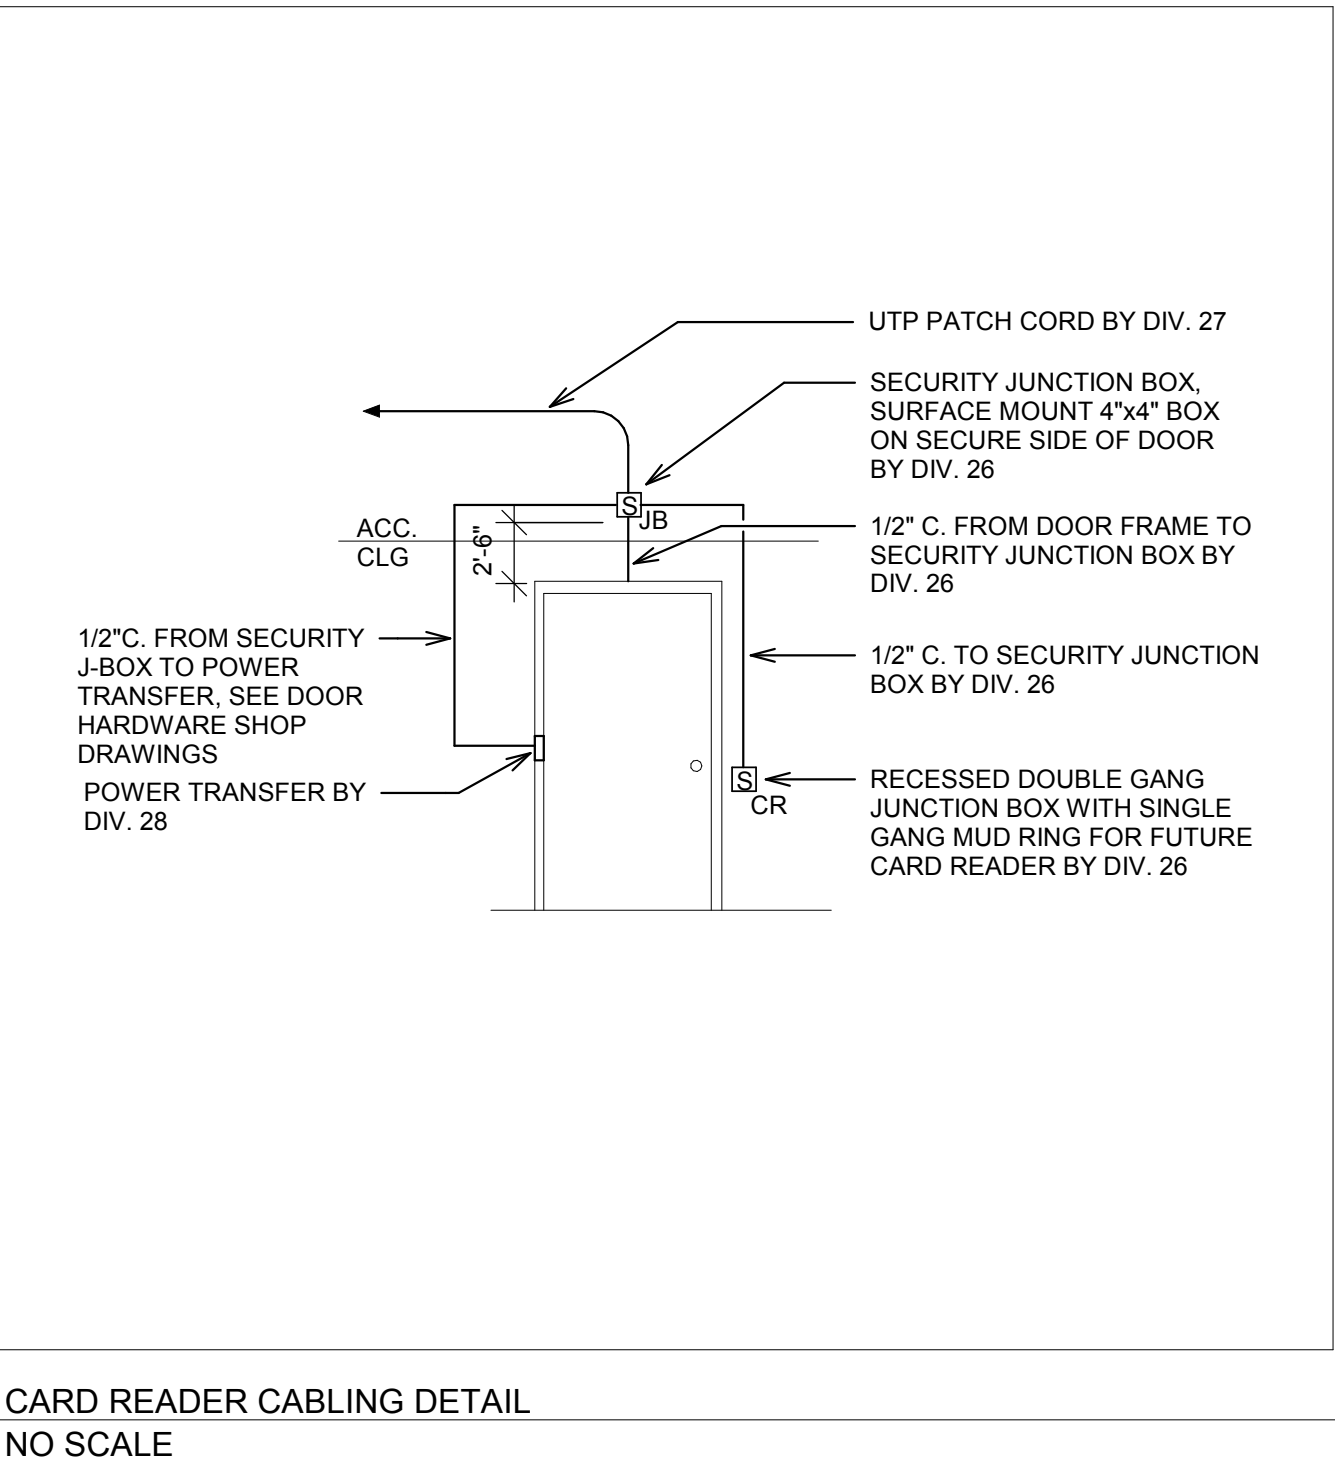
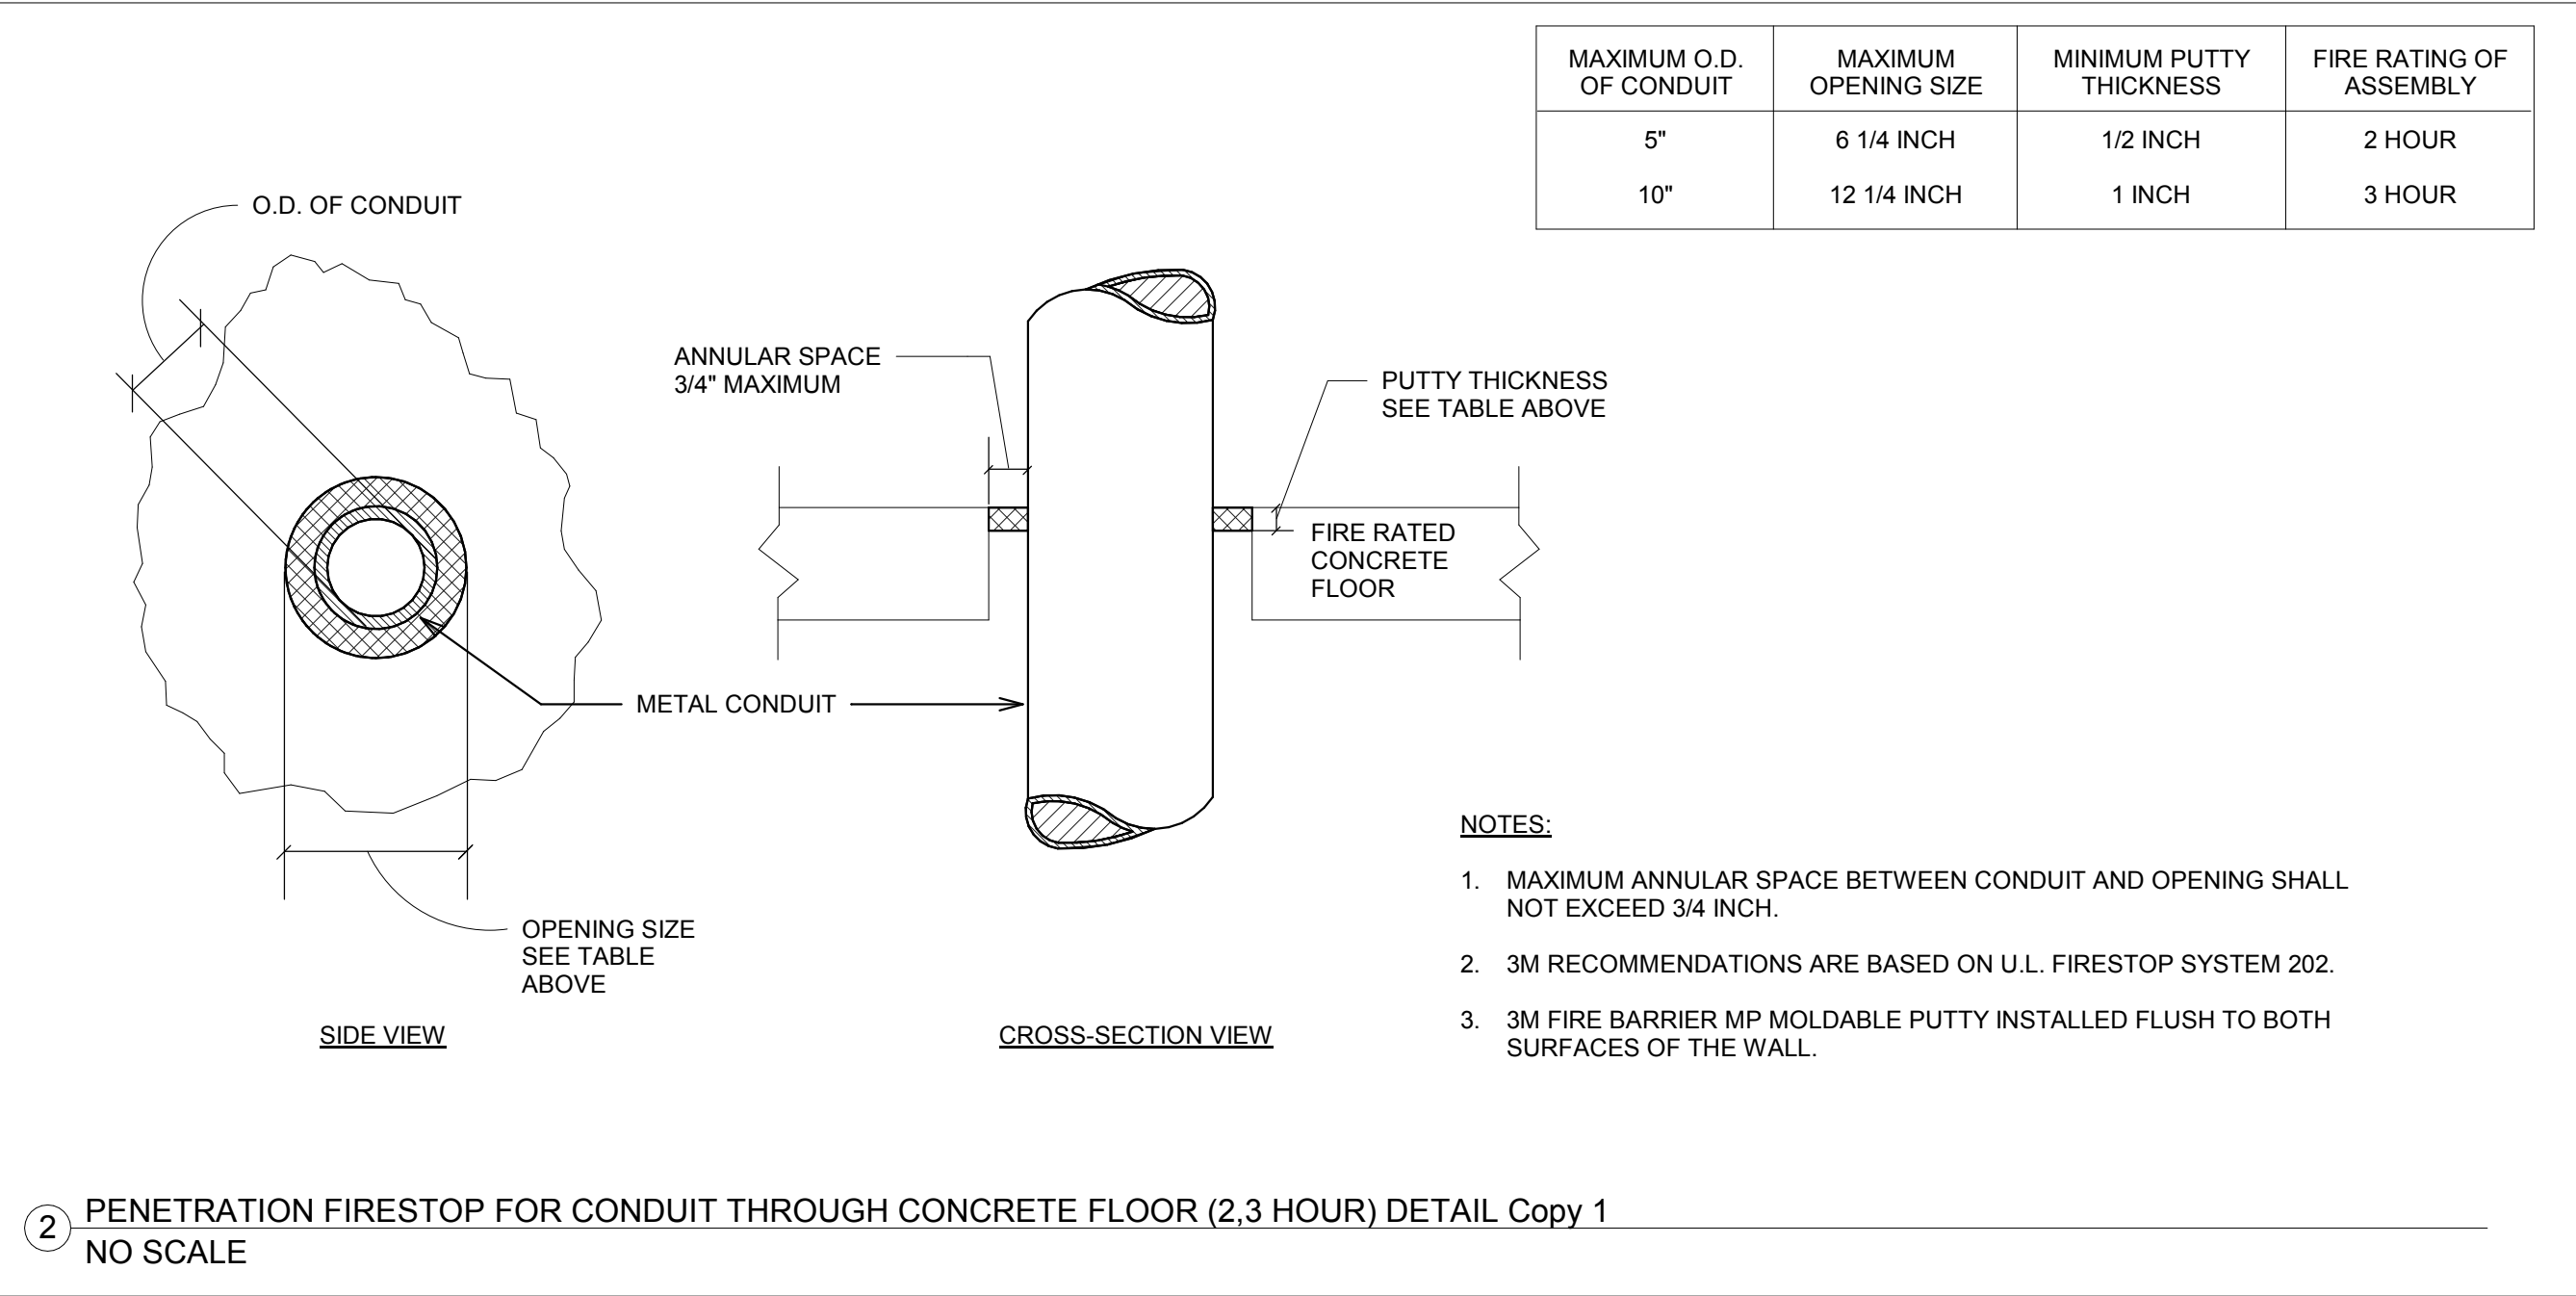
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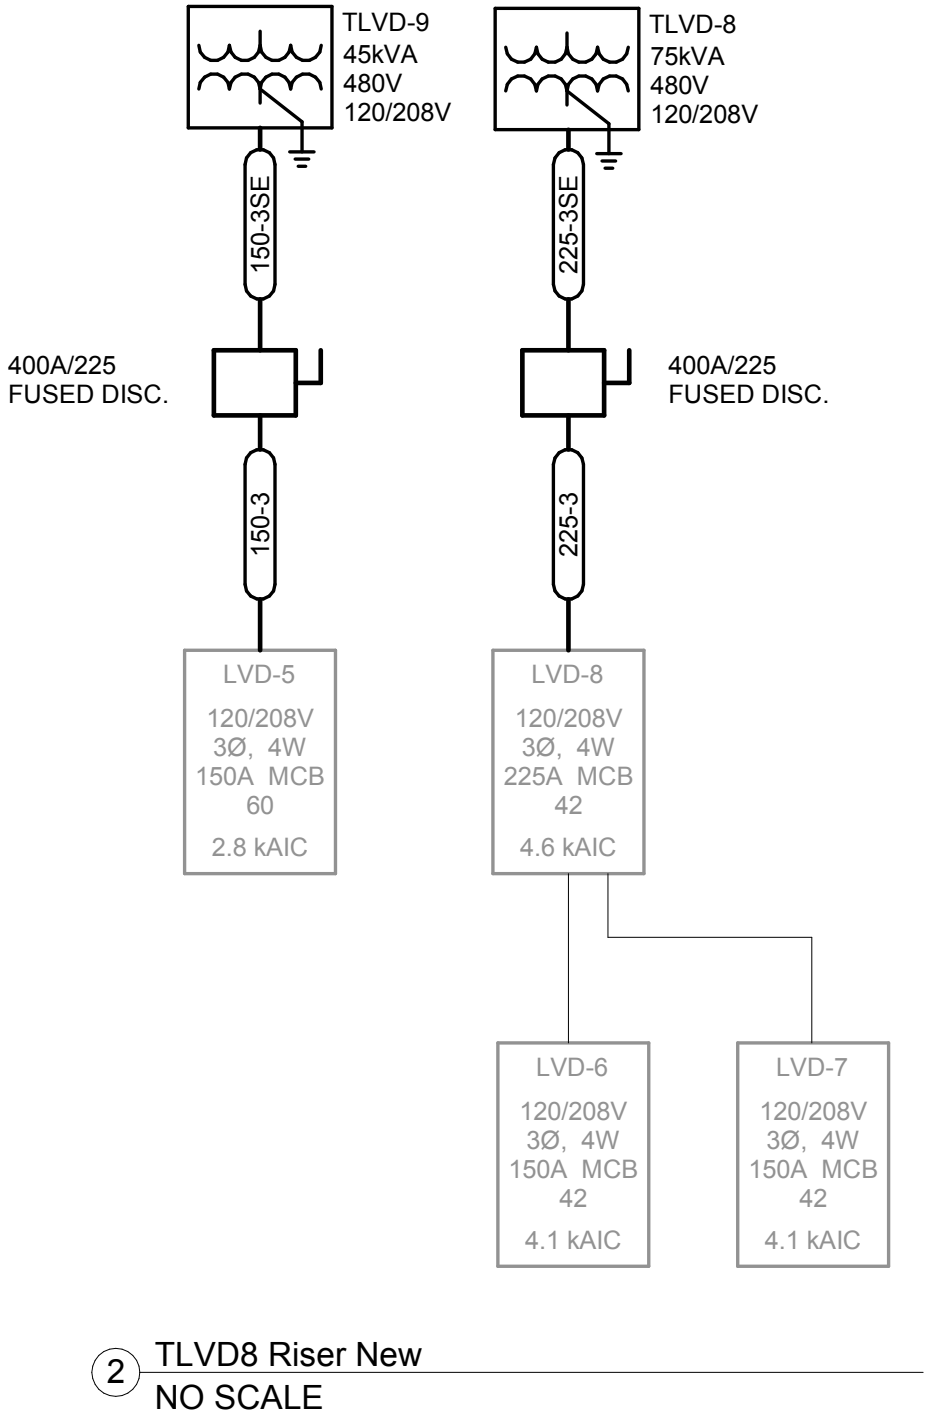
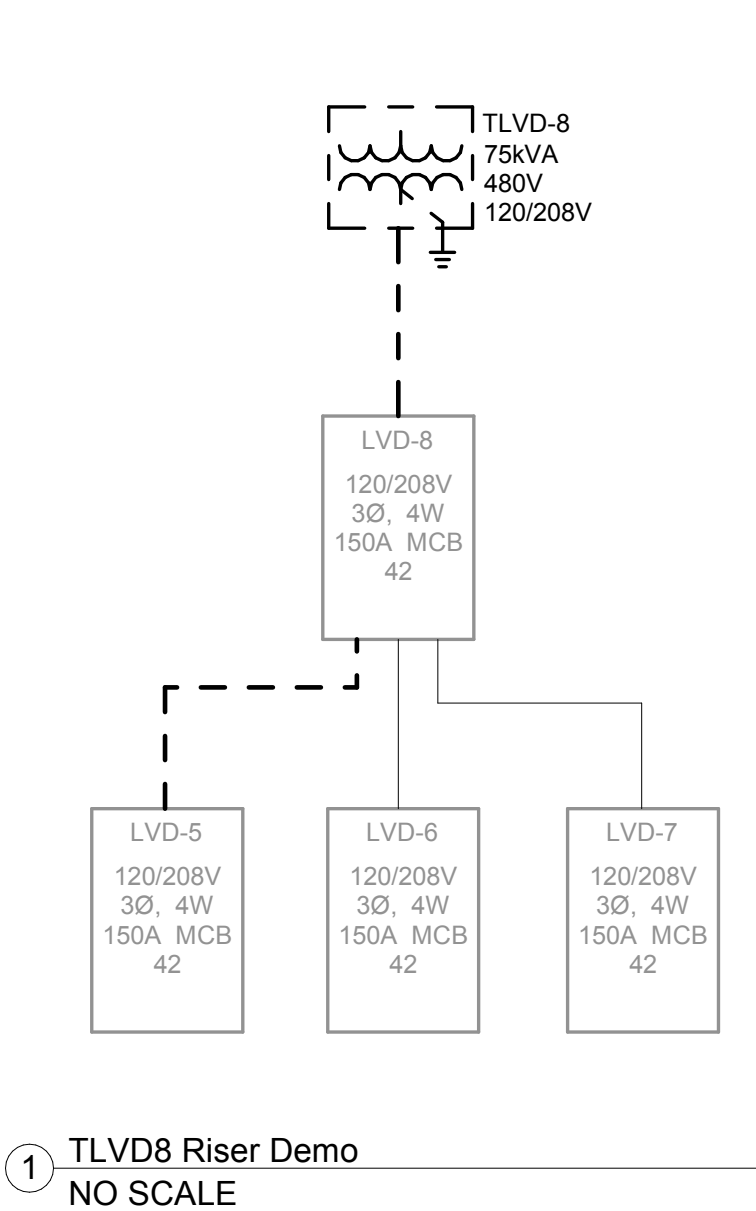
01 ISSUE FOR BID 12/09/25

OWEF - ELECTRICAL SCHEDULES

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TRANSFORMER SCHEDULE					
TRANSFORMER NAME	SIZE	VOLTAGE (PRIMARY/ SECONDARY)	GROUNDING ELECTRODE CONDUCTOR	MOUNTING	NOTES
TLVD-8	75 KVA	480Δ/208Y	#2	FLOOR	
TLVD-9	45 KVA	480Δ/208Y	#4	SUSPENDED	
ELECTRICAL NOTES:					

FEEDER SCHEDULE		
XXXX		
FEEDER	FEEDER DESCRIPTION	CONDUIT
80-3T	1-1/4"C, 3#4 + #8 G	EMT
125-3T	1-1/2"C, 3#1 + #6 G	EMT
150-3	2"C, 4#1/0 + #6 G	EMT
150-3S	2"C, 4#1/0 + #6 G	EMT
150-3SE	1-1/2"C, 4#1/0	EMT
225-3	2-1/2"C, 4#4/0 + #4 G	EMT
225-3S	2-1/2"C, 4#4/0 + #2 G	EMT
225-3SE	2-1/2"C, 4#4/0	EMT
400-3	3-1/2"C, 4#500KCMIL + #3 G	EMT
1200-3	(4) 3"C, 4#350KCMIL + #3/0 G	EMT
1200-3T	(4) 3"C, 3#350KCMIL + #3/0 G	EMT
4000-3SE	(11) 4"C, 4#500KCMIL	EMT
-2	SINGLE PHASE	
-3	THREE PHASE	
SE	SERVICE ENTRANCE	
S	SECONDARY (LV TRANSFORMER)	
D	SIZED FOR VOLTAGE DROP	
P	PVC	
U	UNDERGROUND	
L	ALUMINUM	
NOTES:	ADDED NEUTRAL	
T	THREE WIRE ONLY, NO NEUTRAL	
GENERAL NOTES:		
A. NOMENCLATURE DEFAULTS WITH A SINGLE NEUTRAL AND A GROUND.		



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I HEREBY CERTIFY THAT THIS PLAN, SPECIFICATION, OR REPORT WAS PREPARED BY ME OR UNDER MY DIRECT SUPERVISION AND THAT I AM A DULY LICENSED ENGINEER UNDER THE LAWS OF THE STATE OF MINNESOTA.

*Dustin Mueller*  
Dustin D. Mueller

52622 12/09/25  
NUMBER DATE

OLMSTED COUNTY WASTE TO ENERGY  
FACILITY OFFICE REMODEL  
ROCHESTER, MINNESOTA

25-041	1226016-000-00
DATE	12/09/25
DRAWN BY	DDM
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