


NEW WALL - LOCATION PLAN  
SCALE: 3/16" = 1'-0"

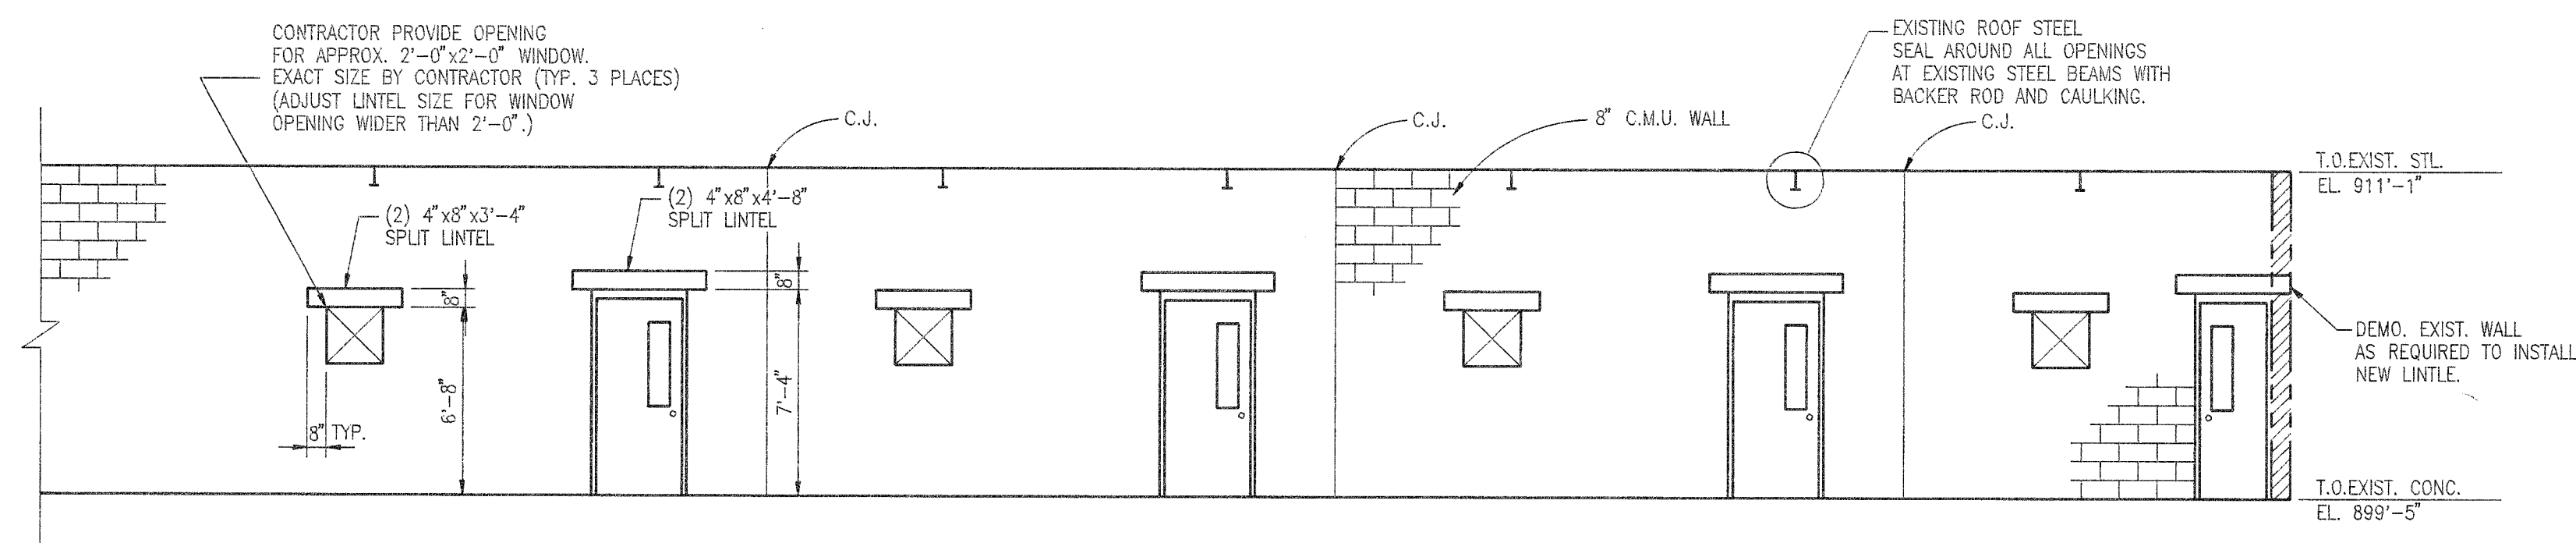


WALL ELEVATION - LOOKING NORTH  
SCALE: 3/16" = 1'-0"

#### GENERAL NOTES:

- DOORS SHALL BE TYPE 1 AS SHOWN ON DRAWING D-3457.
- FOR DOOR DISCRPTION AND GENERAL NOTES SEE DRAWING D-3457.
- ALL LINTELS SHALL BE (2) 4"x8" CONCRETE LINTELS WITH AN 8" BEARING FACE ON EACH END.
- SEE DRAWING D-3457 FOR TYPICAL CONTROL JOINT DETAILS.
- TYPICAL WALL SECTION IS SIMILAR TO SECTION A 3457
- CONTROL JOINTS SHALL BE PLACED AT APPROXIMATELY 20'-0" c/c.
- CAULKING SHALL BE SIKAFLEX 1A OR APPROVED EQUAL.
- CONTRACTOR SHALL ADJUST DOOR LOCATIONS TO SUIT FIELD CONDITIONS.

#### REFERENCE DRAWINGS:

D-3455	SLAB PLAN
D-3458	ARCHITECTURAL PLAN
D-1920	MOTOR ROOM PLAN & DETAILS
D-1903	FOUNDATION DETAILS

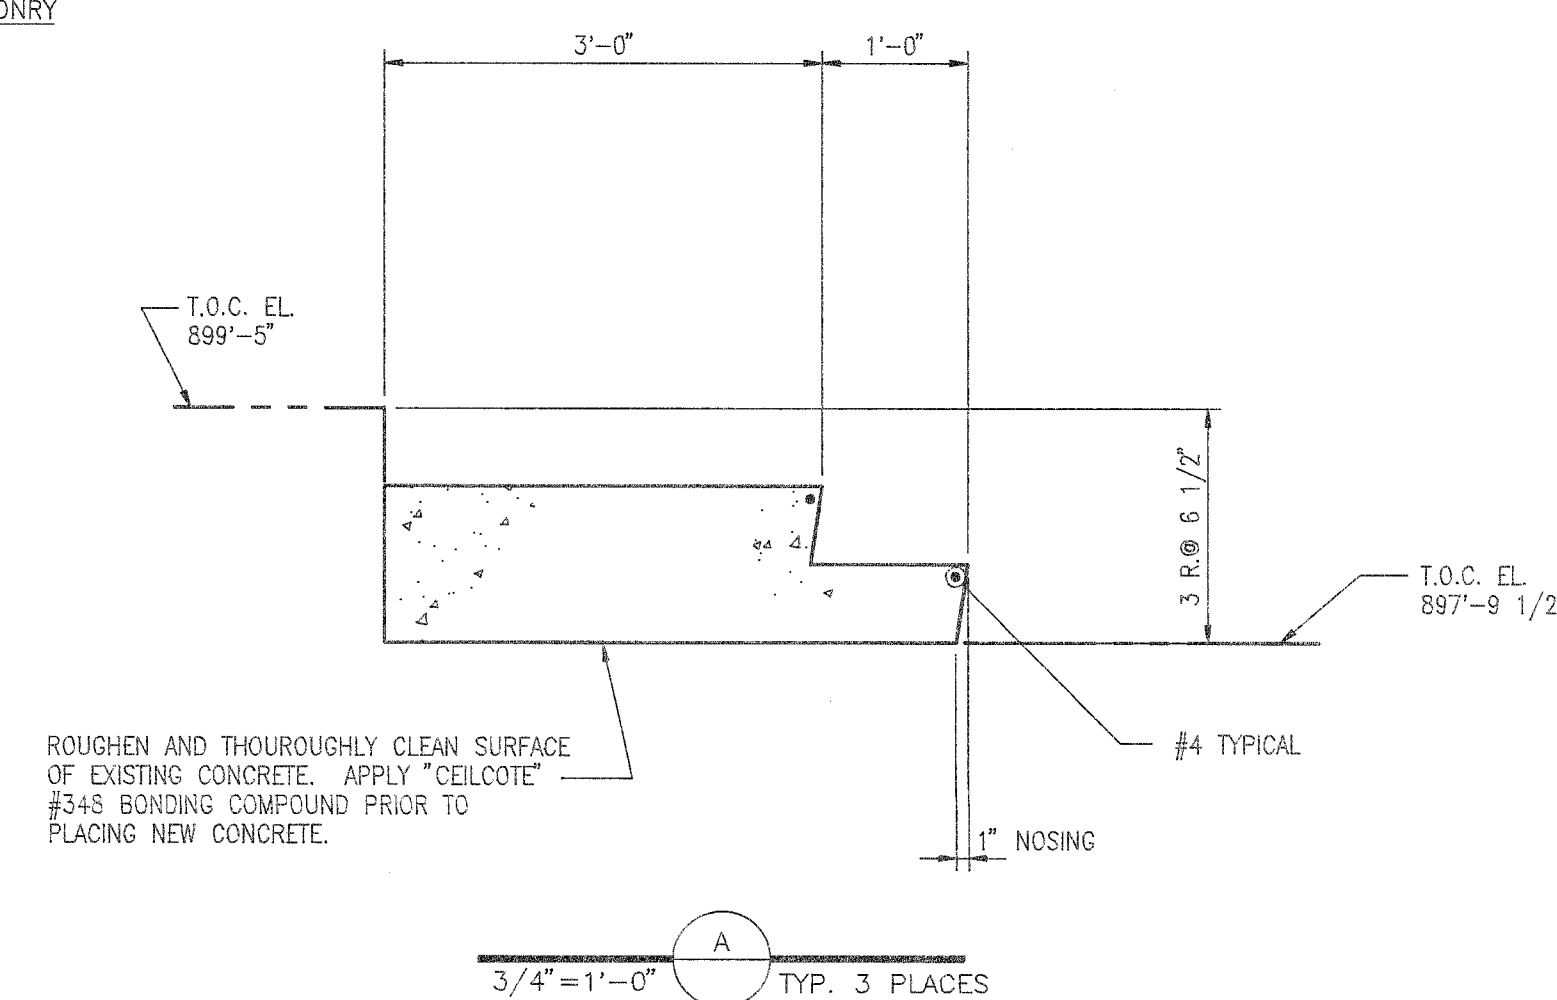

ISSUED FOR  
CONSTRUCTION

REV.	DESCRIPTION	BY	DATE
0	ISSUED FOR CONSTRUCTION	RDL	1/12/94

ARCHITECTURAL  
EXISTING MOTOR / DRIVE ROOM  
WALL PLAN  
& DETAILS

ENGINEERING & CONSTRUCTION <b>JOHN BROWN</b> PROCESS PLANTS JOHN BROWN E & C CHARLESTON, WV	
JOB NUMBER 93729	CAD NAME GU3S0011
 STEEL OF WEST VIRGINIA HUNTINGTON, WEST VIRGINIA	
Scale: 3/16"=1'-0" Date: 1/10/94 Drawn By: RDL Approved By: RDC	Equipment No.: Drawing No.: <b>D-3458</b>