

JASON WADECKI  
TECHNICAL DIRECTOR

THIS DRAWING  
REPRESENTS DESIGN  
INTENT AND CONCEPT

THE DESIGNERS AND ASSISTANT DESIGNERS ARE RESPONSIBLE FOR VISUAL ASPECTS OF THE DESIGN ONLY, AND ALL SPECIFICATIONS PROVIDED RELATE SOLELY TO THE APPEARANCE OF THE DESIGN AND NOT MATTERS OF CONSTRUCTION OR STRUCTURAL SOUNDNESS AND/OR SAFETY. THE IMPLEMENTATION OF THIS DESIGN MUST COMPLY WITH THE MOST STRINGENT APPLICABLE FEDERAL AND LOCAL SAFETY AND FIRE CODES. THE DESIGNERS ARE NOT QUALIFIED TO DETERMINE STRUCTURAL OR ELECTRICAL APPROPRIATENESS OF THE DESIGN, AND WILL ASSUME NO RESPONSIBILITY FOR DAMAGES RESULTING THROUGH IMPROPER ENGINEERING AND/OR IMPLEMENTATION IN THE HANDLING OF THE DESIGN.

THIS DRAWING HAS BEEN PREPARED IN  
ACCORDANCE WITH USITT GRAPHIC RECOMMENDED  
BEST PRACTICES.

[illegible]

PERSPECTIVE VIEW

---

N/A

DATE \_\_\_\_\_  
PLATE \_\_\_\_\_

PLATE  
0  
OF 7



1 PERSPECTIVE VIEW  
0 SCALE: N/A

PLATE #	DRAWING #	DESCRIPTION
0	1	PERSPECTIVE VIEW
1	1	GP
2	1	SEC 1
3	1	SEC 2
4	1	FRONT ELEVATION
5	1	FLAT A – FRONT ELEVATION
5	2	FLAT B – FRONT ELEVATION
5	3	FLAT B – SECTION
5	4	FLAT B – PLAN VIEW
5	5	FLAT B – WINDOW FRAME DETAIL
6	1	FLAT C – FRONT ELEVATION

PLATE #	DRAWING #	DESCRIPTION
6	2	FLAT C – SECTION
6	3	FLAT C – PLAN VIEW
6	4	FLAT C – CASING FRONT ELEVATION
6	5	FLAT C – CASING SECTION
7	1	FLAT D – FRONT ELEVATION
7	2	FLAT E – FRONT ELEVATION
7	3	FLAT D – PLAN VIEW
7	4	FLAT D – SECTION
7	5	TRIM DETAIL – FRONT ELEVATION
7	6	TRIM DETAIL – SECTION



JASON WADECK

ETHAN PERVER

# DRAWING PRESENTS DESIGN

# THIS DRAWING REPRESENTS DESIGN INTENT AND CONCEPT

THIS DRAWING HAS BEEN PREPARED IN  
ACCORDANCE WITH USITT GRAPHIC RECOMMENDED  
BEST PRACTICES.

[illegible]

GP

DRAWING  
NUMBER

" — 1

6/16/2

6/16/2025

1

OF 7







ETHAN PERVERE  
ASSISTANT SCENIC DESIGNER

THE DESIGNERS AND ASSISTANT DESIGNERS ARE RESPONSIBLE FOR VISUAL ASPECTS OF THE DESIGN ONLY, AND ALL SPECIFICATIONS PROVIDED RELATE SOLELY TO THE APPEARANCE OF THE DESIGN, AND NOT MATTERS OF CONSTRUCTION OR STRUCTURAL SOUNDNESS AND/OR SAFETY. THE IMPLEMENTATION OF THIS DESIGN MUST COMPLY WITH THE MOST STRINGENT APPLICABLE FEDERAL AND LOCAL SAFETY AND FIRE CODES. THE DESIGNERS ARE NOT QUALIFIED TO DETERMINE STRUCTURAL OR ELECTRICAL APPROPRIATENESS OF THE DESIGN, AND WILL ASSUME NO RESPONSIBILITY FOR DAMAGES RESULTING THROUGH IMPROPER ENGINEERING AND/OR IMPLEMENTATION IN THE HANDLING OF THE DESIGN.


THIS DRAWING HAS BEEN PREPARED IN  
ACCORDANCE WITH USITT GRAPHIC RECOMMENDED  
BEST PRACTICES.

[illegible]

ETHAN PERVERE  
DRAWN BY

6/16/20

OF 7

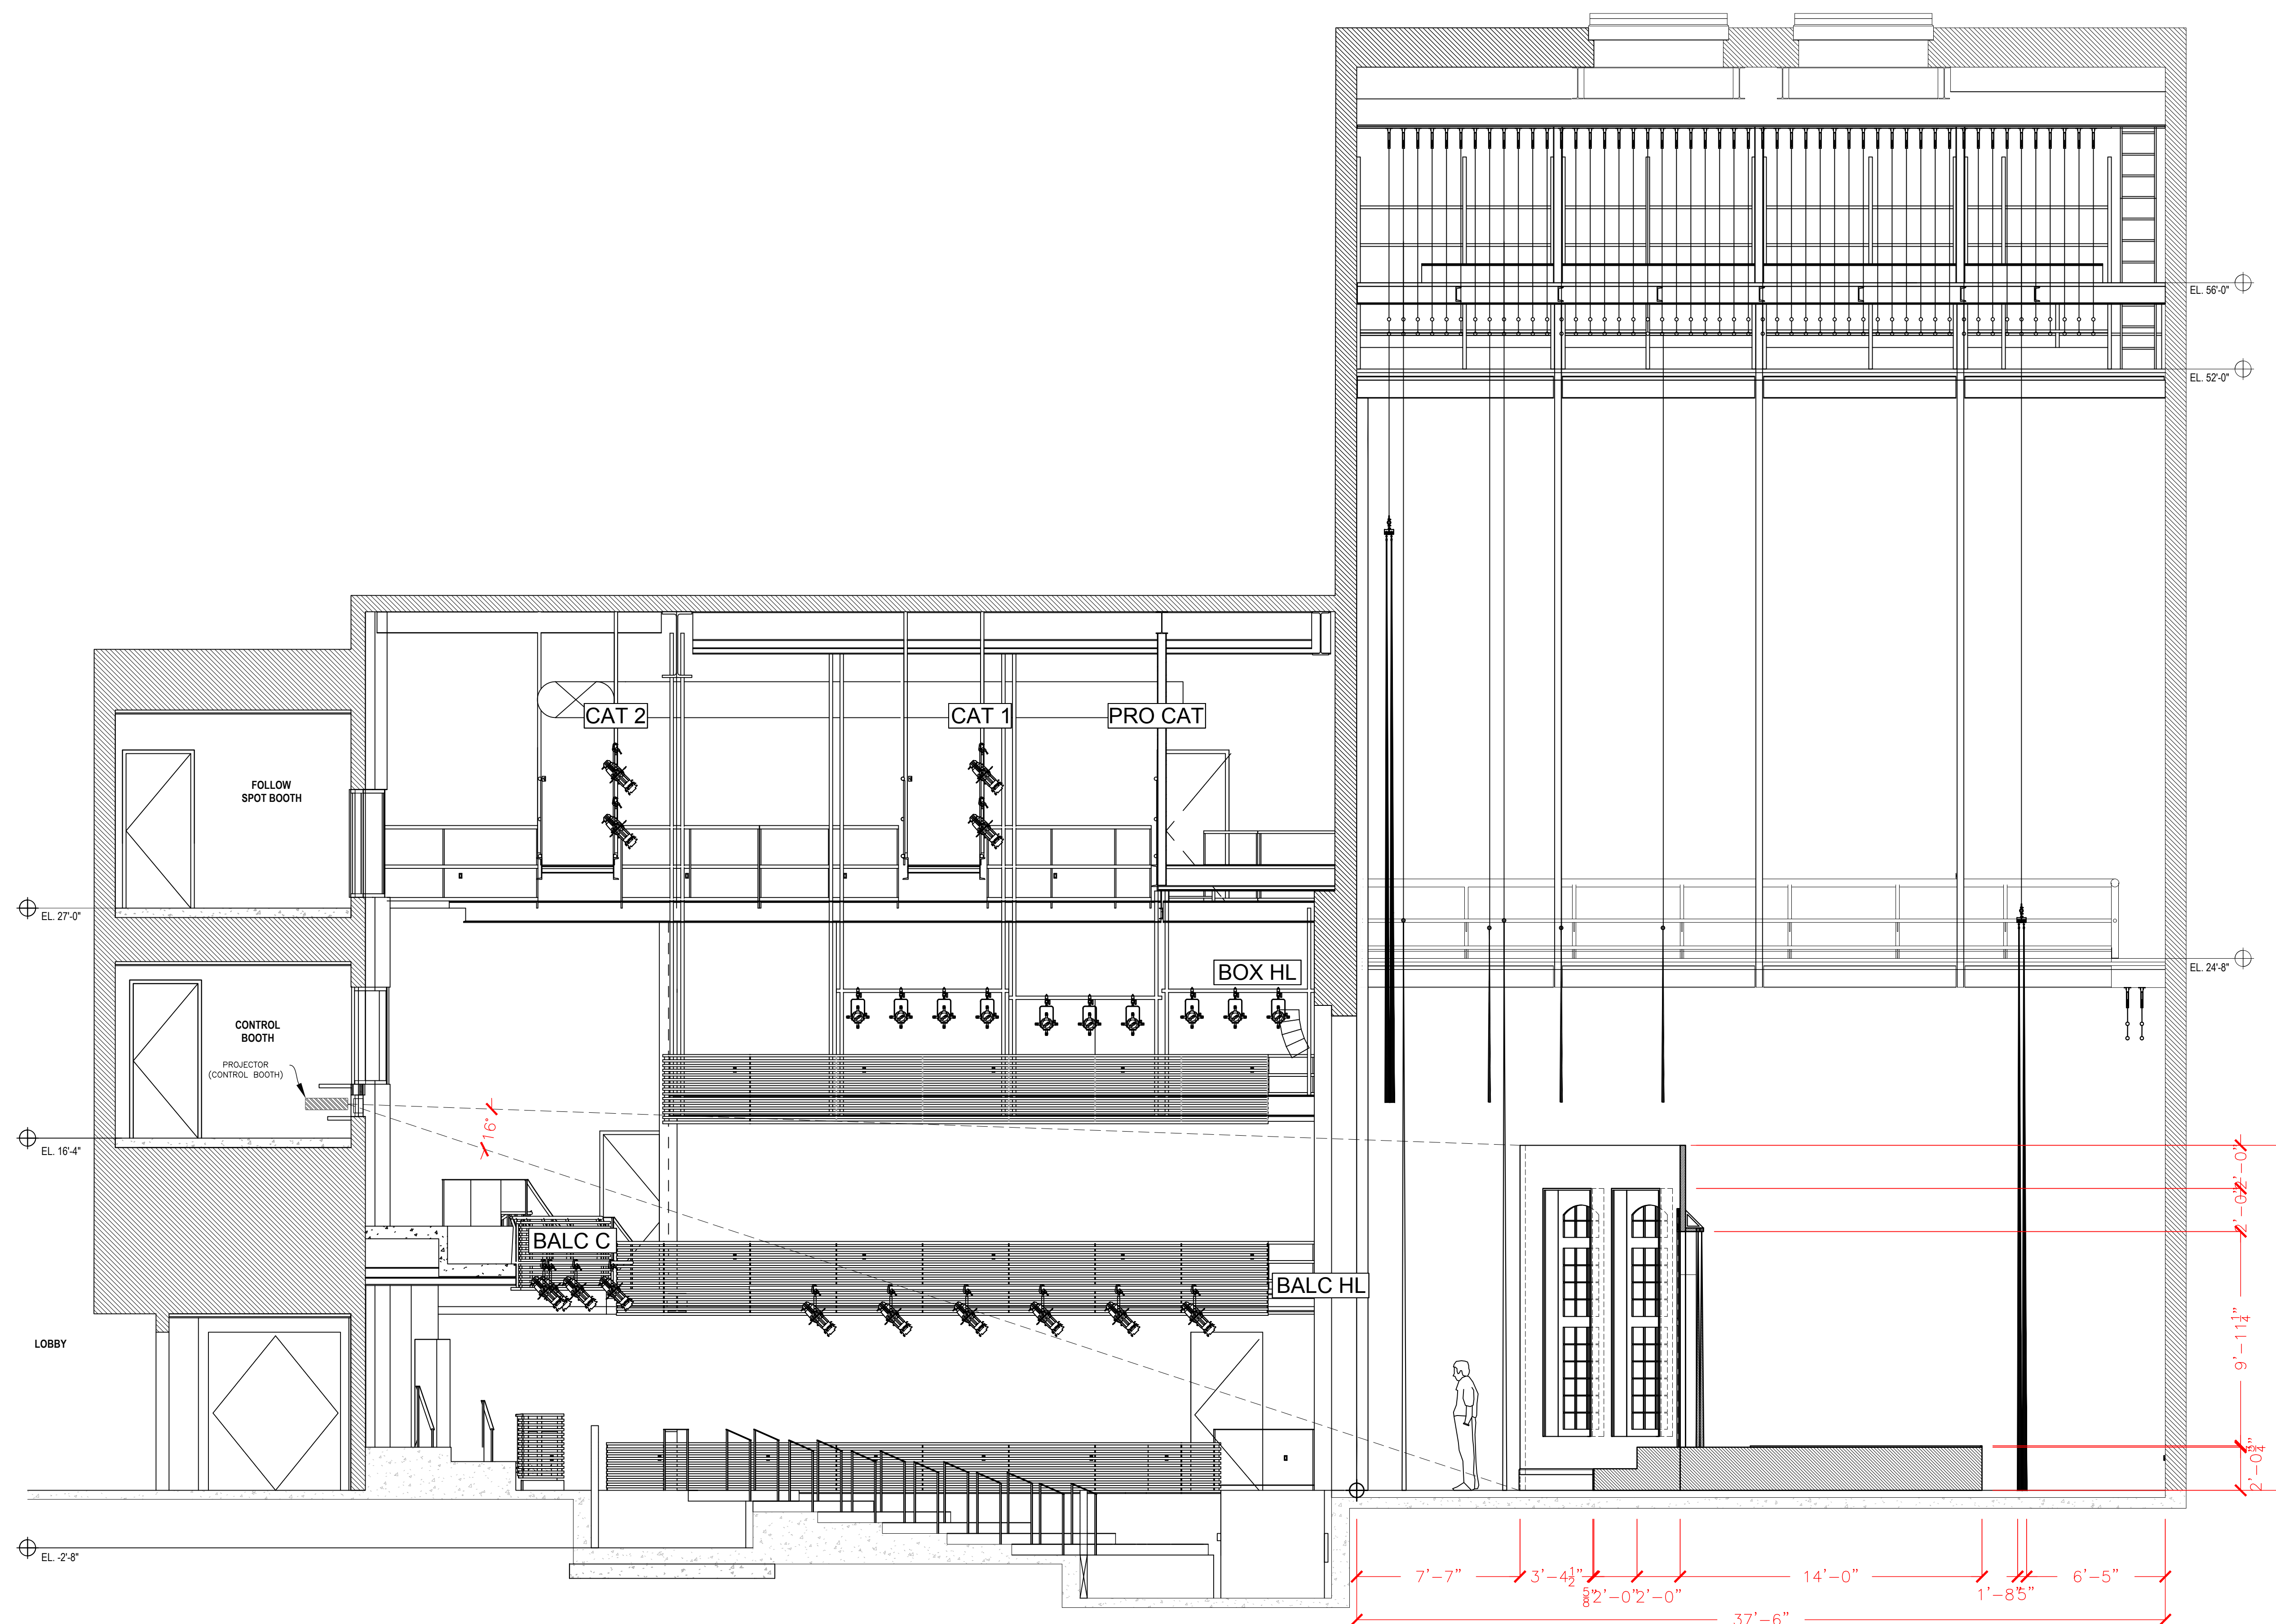

- 1 SEC1  
2 SCALE: 1/4" = 1'-0"



**EASTERN  
CONNECTICUT  
STATE UNIVERSITY**

JASON WADECKI  
TECHNICAL DIRECTOR

THIS DRAWING  
REPRESENTS DESIGN  
INTENT AND CONCEPT


THE DESIGNERS AND ASSISTANT DESIGNERS ARE RESPONSIBLE FOR VISUAL ASPECTS OF THE DESIGN ONLY, AND ALL SPECIFICATIONS PROVIDED RELATE SOLELY TO THE APPEARANCE OF THE DESIGN AND NOT MATTERS OF CONSTRUCTION OR STRUCTURAL SOUNDNESS AND/OR SAFETY. THE IMPLEMENTATION OF THIS DESIGN MUST COMPLY WITH THE MOST STRINGENT APPLICABLE FEDERAL AND LOCAL SAFETY AND FIRE CODES. THE DESIGNERS ARE NOT QUALIFIED TO DETERMINE STRUCTURAL OR ELECTRICAL APPROPRIATENESS OF THE DESIGN, AND WILL NOT ASSUME RESPONSIBILITY FOR DAMAGES RESULTING THROUGH IMPROPER ENGINEERING AND/OR IMPLEMENTATION IN THE HANDLING OF THE

THIS DRAWING HAS BEEN PREPARED IN  
ACCORDANCE WITH USITT GRAPHIC RECOMMENDED  
BEST PRACTICES

[illegible]SEC2  
DRAWING
$$\underline{1/4'' = 1'-0''}$$

DATE \_\_\_\_\_

PLATE  
3  
OF 7

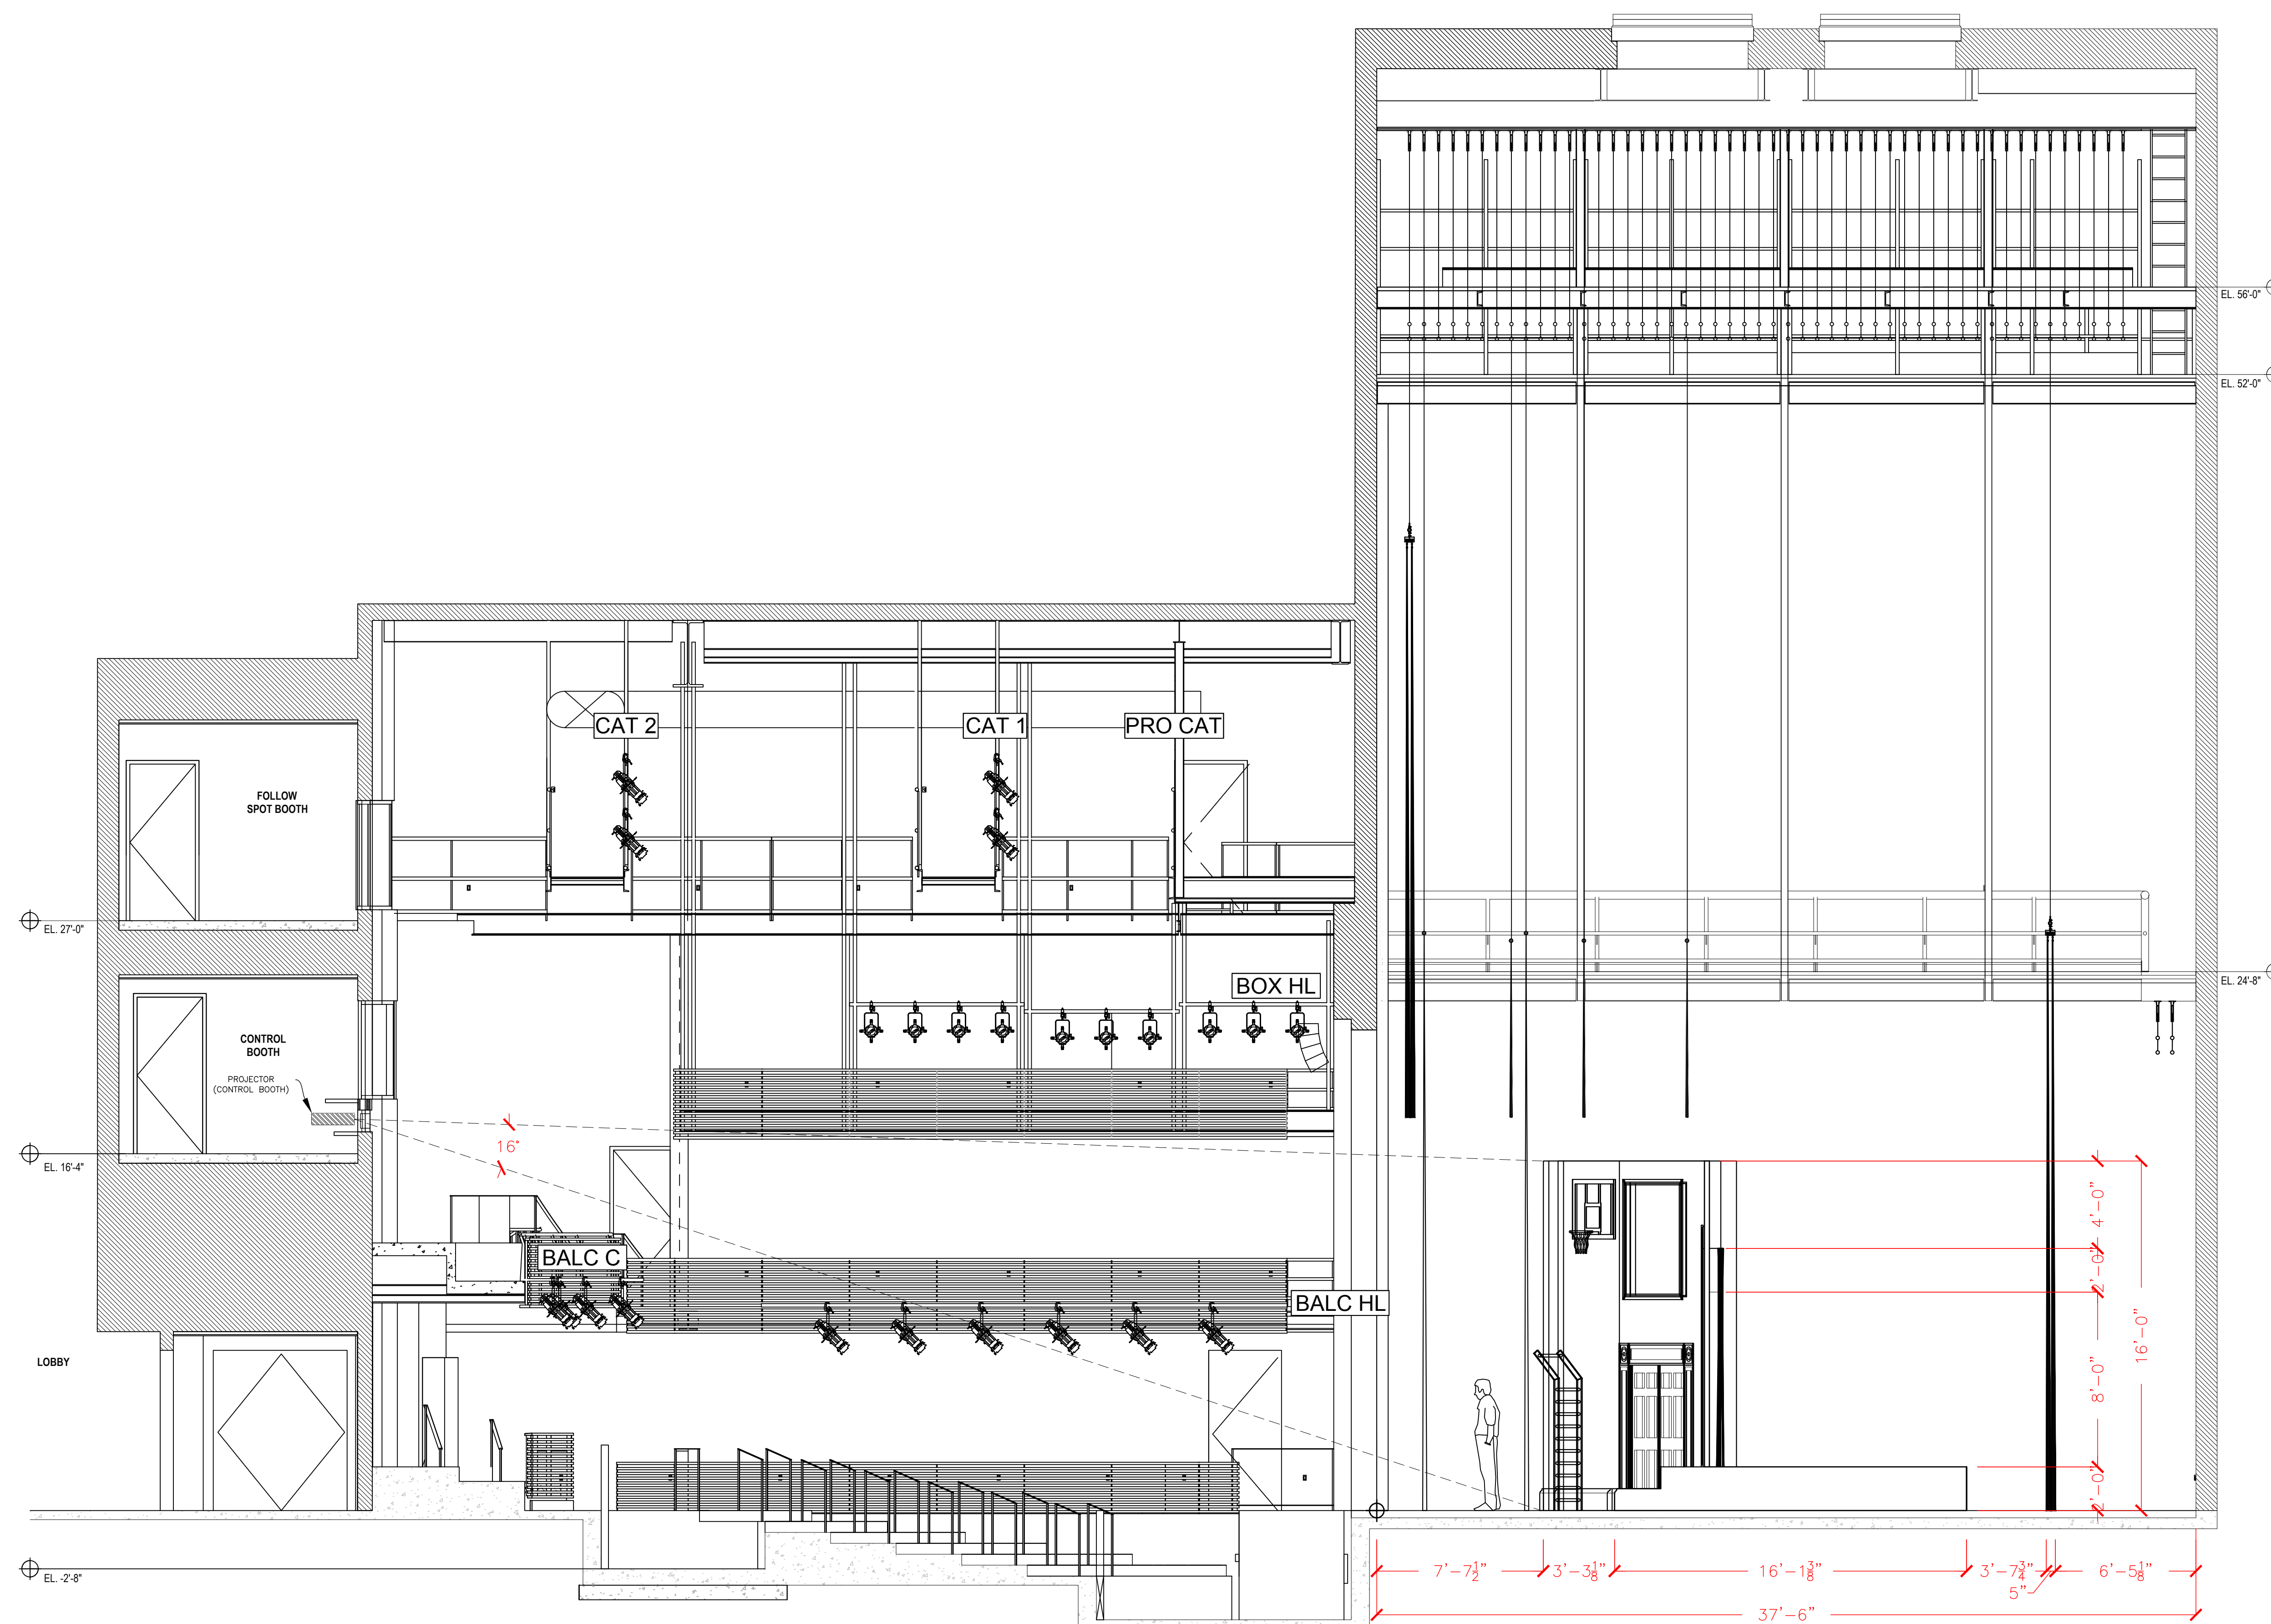

1 SEC2  
3 SCALE: 1/4" = 1'-0"





THIS DRAWING  
REPRESENTS DESIGN  
INTENT AND CONCEPT

THE DESIGNERS AND ASSISTANT DESIGNERS ARE RESPONSIBLE FOR VISUAL ASPECTS OF THE DESIGN AND ALL SPECIFICATIONS PROVIDED RELATE SOLELY TO THE APPEARANCE OF THE DESIGN AND NOT MATTERS OF CONSTRUCTION OR STRUCTURAL SOUNDNESS AND/OR SAFETY. THE IMPLEMENTATION OF THIS DESIGN MUST COMPLY WITH THE MOST STRINGENT APPLICABLE FEDERAL AND LOCAL SAFETY AND FIRE CODES. THE DESIGNERS ARE NOT QUALIFIED TO DETERMINE STRUCTURAL OR ELECTRICAL ADEQUACIES OF THE DESIGN, AND WILL NOT ASSUME RESPONSIBILITY FOR DAMAGES RESULTING THROUGH IMPROPER ENGINEERING AND/OR IMPLEMENTATION IN THE HANDLING OF THE DESIGN.

THIS DRAWING HAS BEEN PREPARED IN  
ACCORDANCE WITH USITT GRAPHIC RECOMMENDED  
BEST PRACTICES.


[illegible]

SCALE

DATE \_\_\_\_\_

4

OF 7

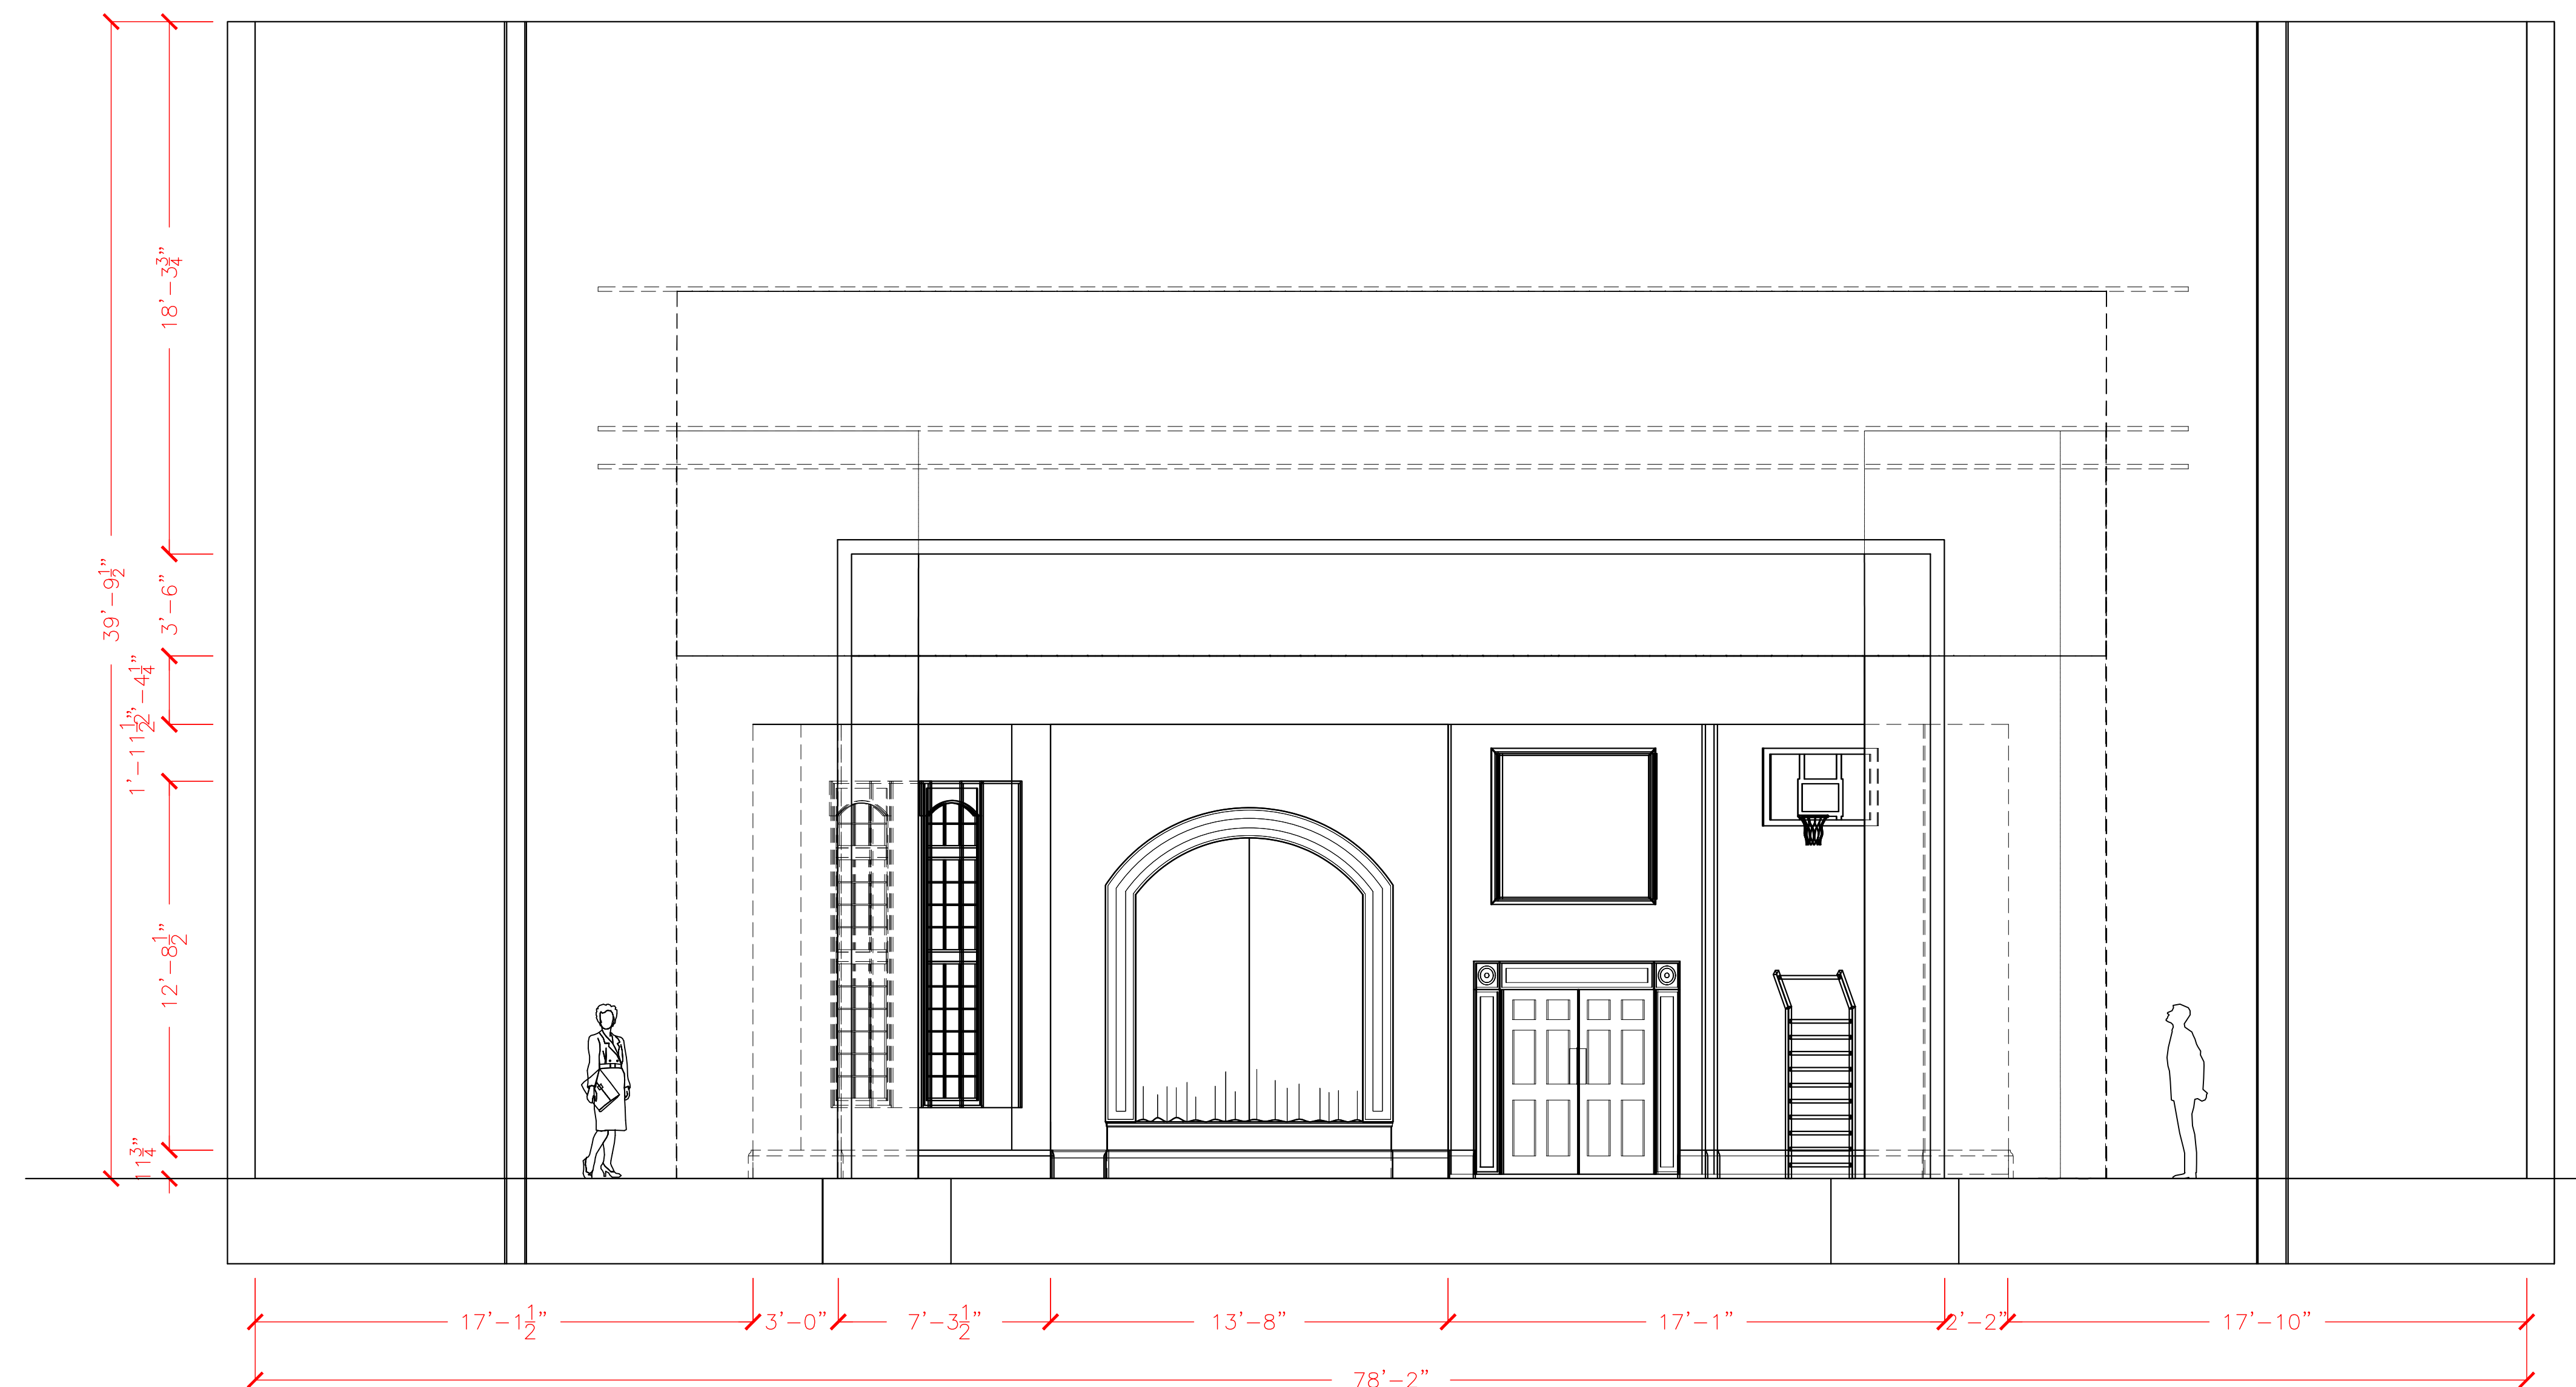

1 FRONT ELEVATION  
4 SCALE: 1/4" = 1'-0"

JASON WADECKI  
TECHNICAL DIRECTOR

THIS DRAWING  
REPRESENTS DESIGN  
INTENT AND CONCEPT

THE DESIGNERS AND ASSISTANT DESIGNERS ARE RESPONSIBLE FOR VISUAL ASPECTS OF THE DESIGN ONLY, AND ALL SPECIFICATIONS PROVIDED RELATE SOLELY TO THE APPEARANCE OF THE DESIGN AND NOT MATTERS OF CONSTRUCTION OR STRUCTURAL SOUNDNESS AND/OR SAFETY. THE IMPLEMENTATION OF THIS DESIGN MUST COMPLY WITH THE MOST STRINGENT APPLICABLE FEDERAL AND LOCAL SAFETY AND FIRE CODES. THE DESIGNERS ARE NOT QUALIFIED TO DETERMINE STRUCTURAL OR ELECTRICAL APPROPRIATENESS OF THE DESIGN, AND WILL ASSUME NO RESPONSIBILITY FOR DAMAGES RESULTING THROUGH IMPROPER ENGINEERING AND/OR IMPLEMENTATION IN THE HANDLING OF THE DESIGN.

THIS DRAWING HAS BEEN PREPARED IN  
ACCORDANCE WITH USITT GRAPHIC RECOMMENDED  
BEST PRACTICES.

[illegible]

FLAT A &amp;

FLAT A &amp;


DRAWN BY

SCALE


DATE \_\_\_\_\_

5

OF 7

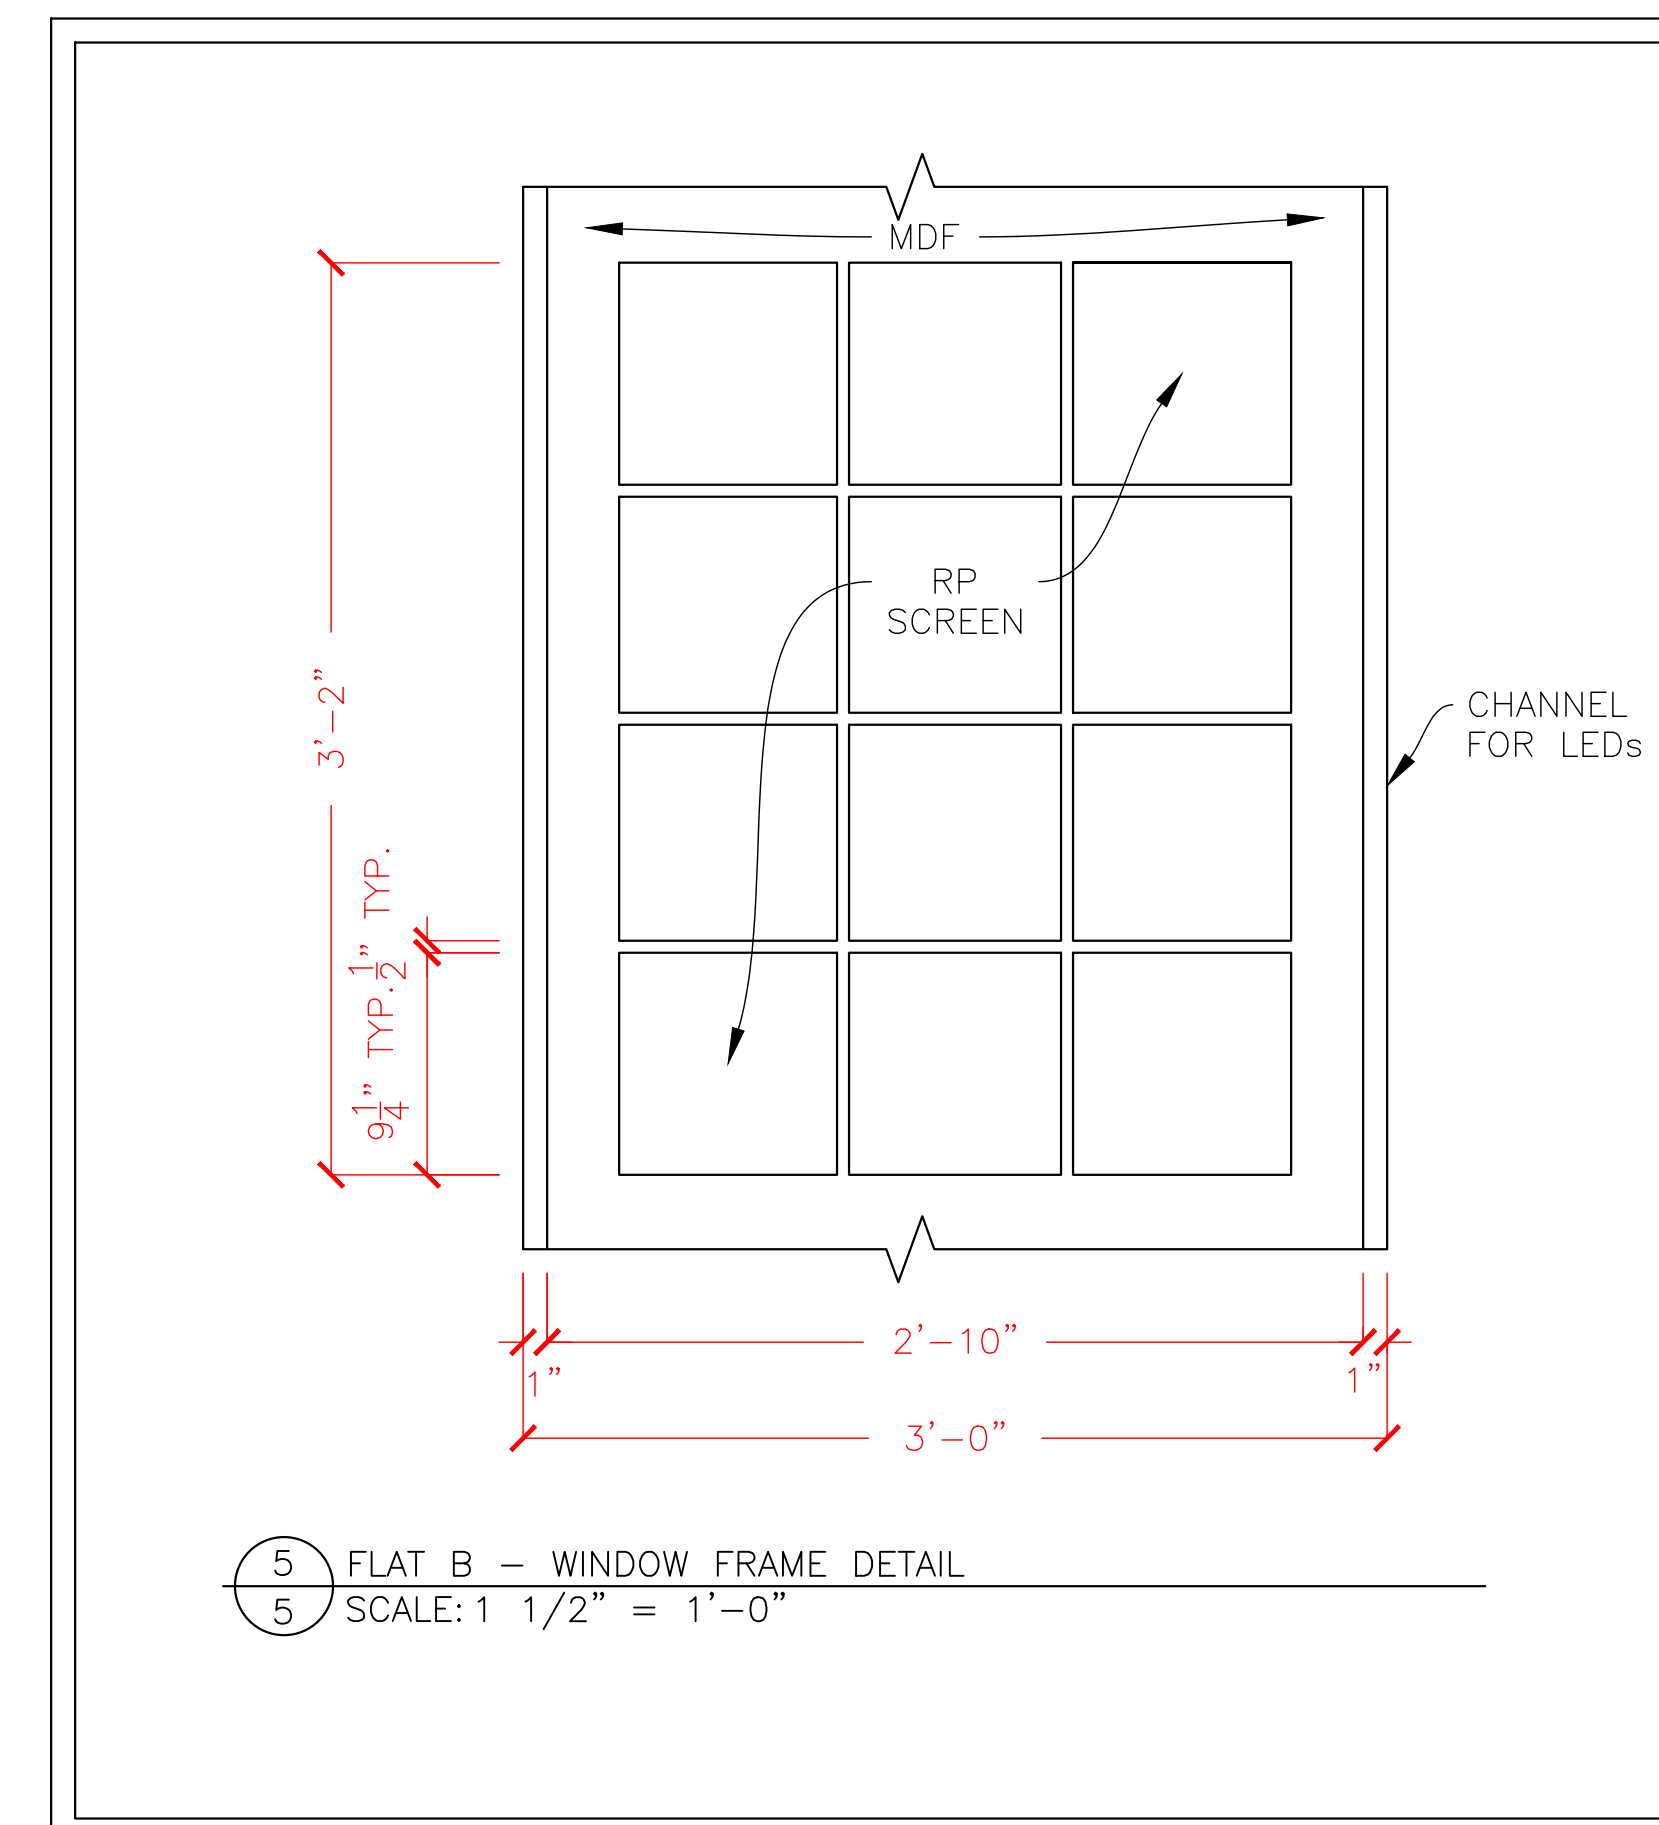


5 FLAT B - WINDOW FRAME DETAIL  
5 SCALE: 1 1/2" = 1'-0"

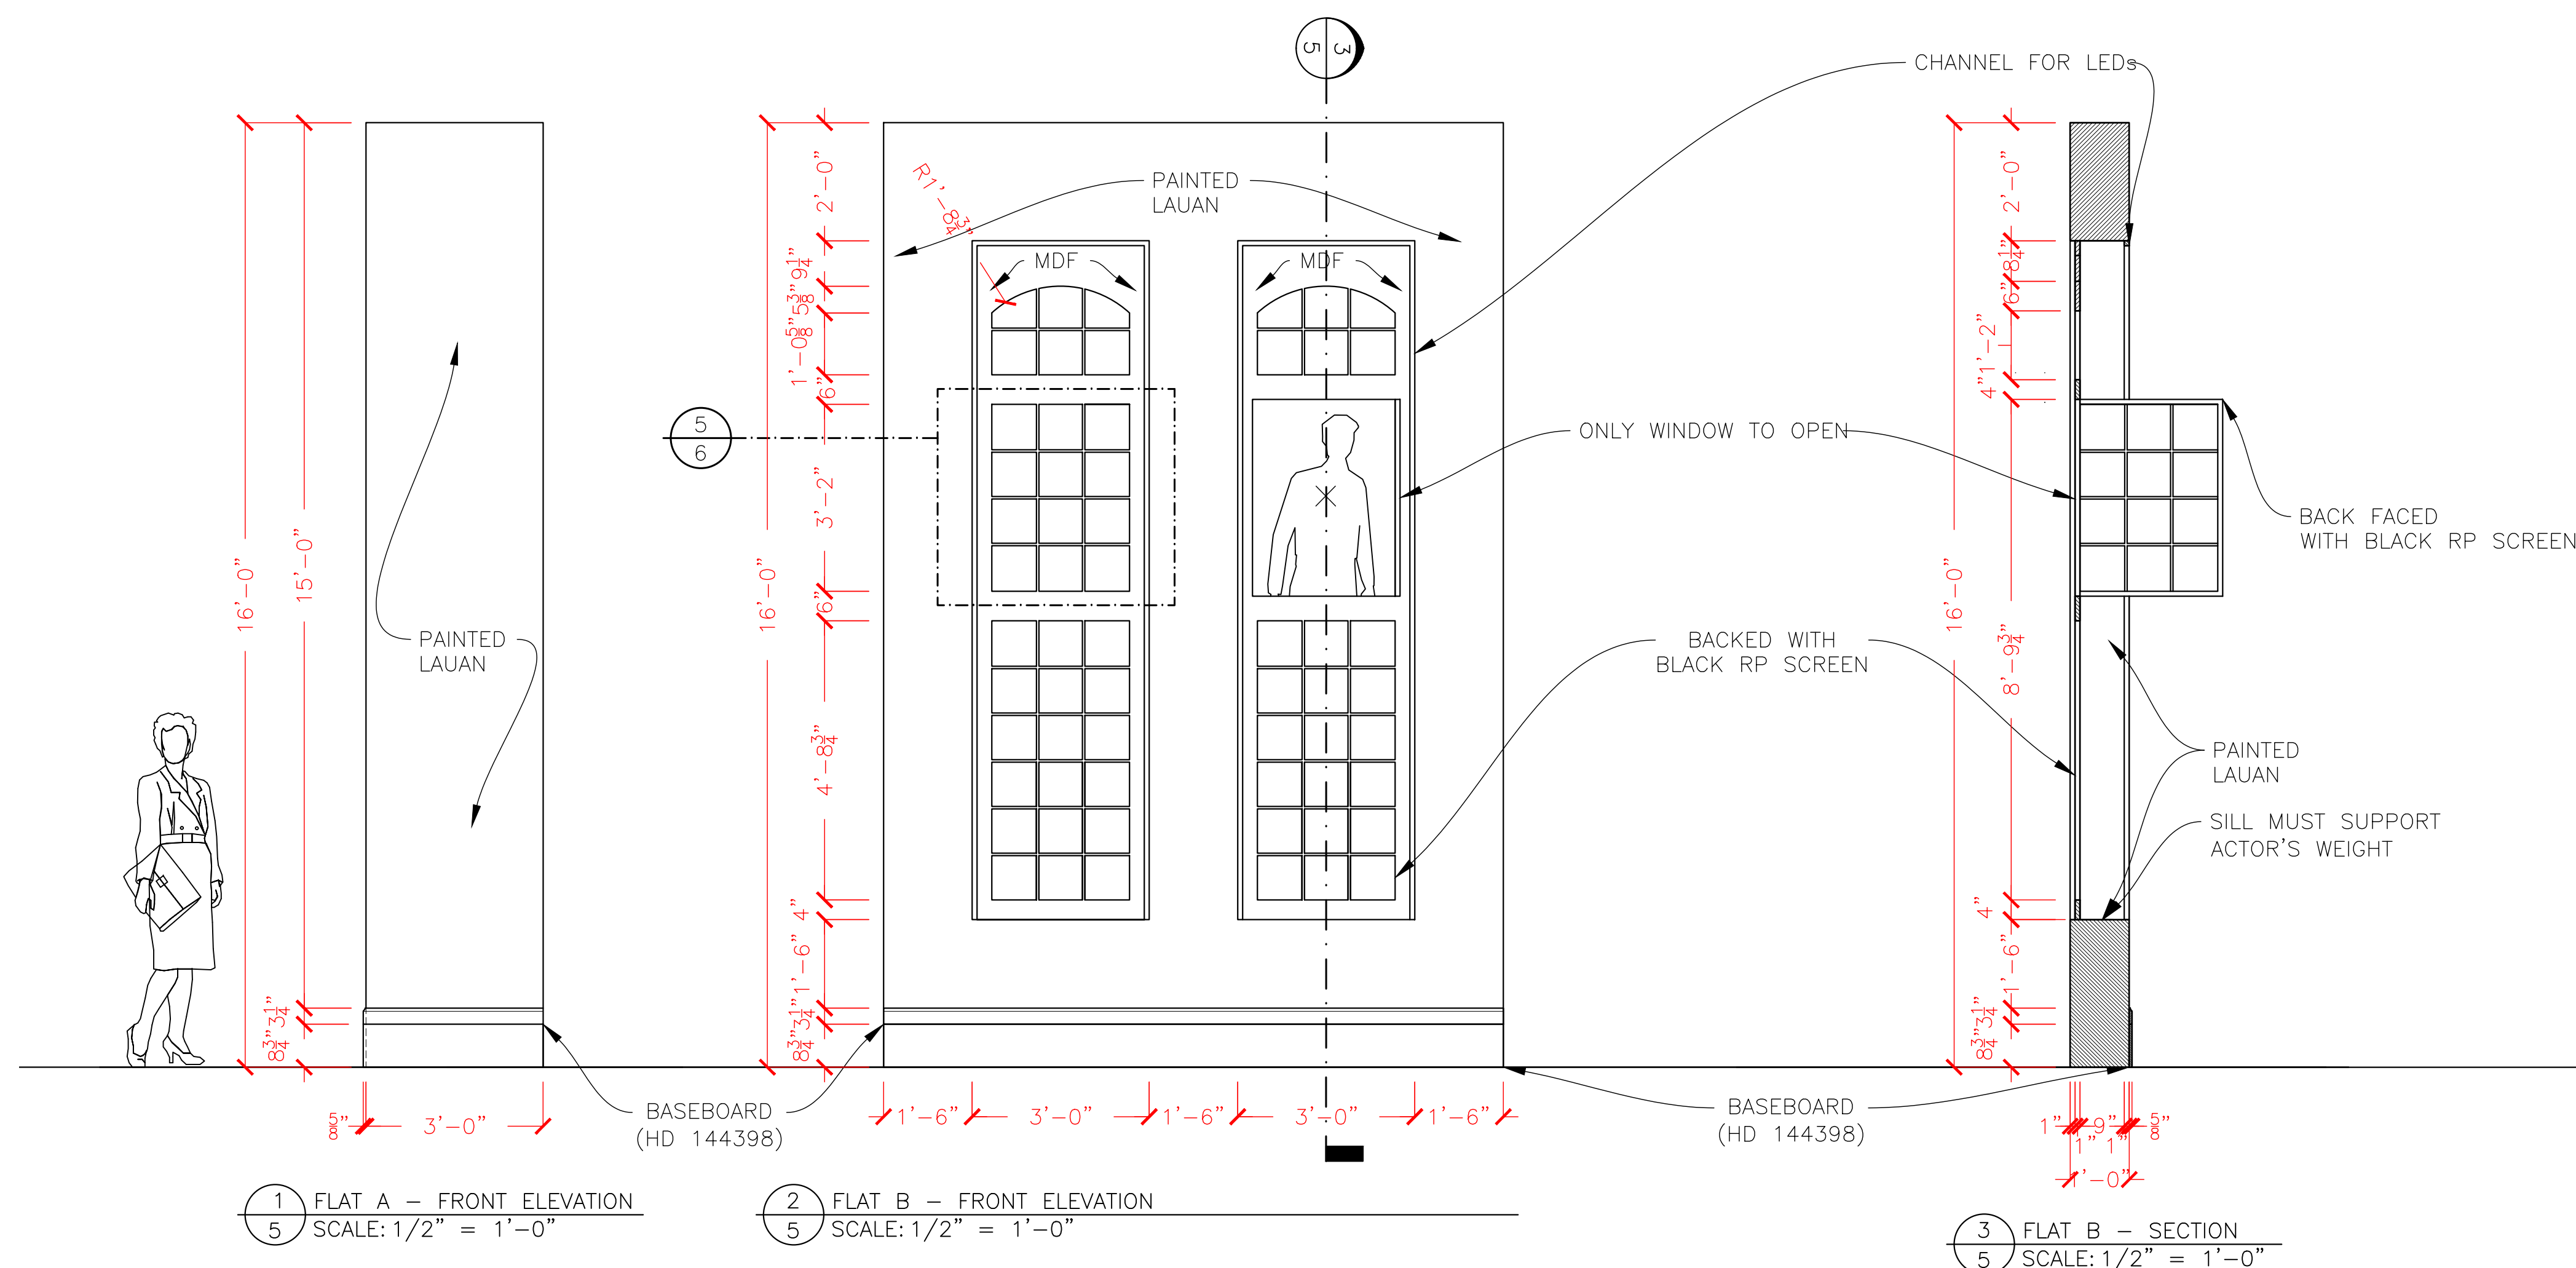

2 FLAT B - FRONT ELEVATION  
5 SCALE: 1/2" = 1'-0"

3 FLAT B - SECTION  
5 SCALE: 1/2" = 1'-0"

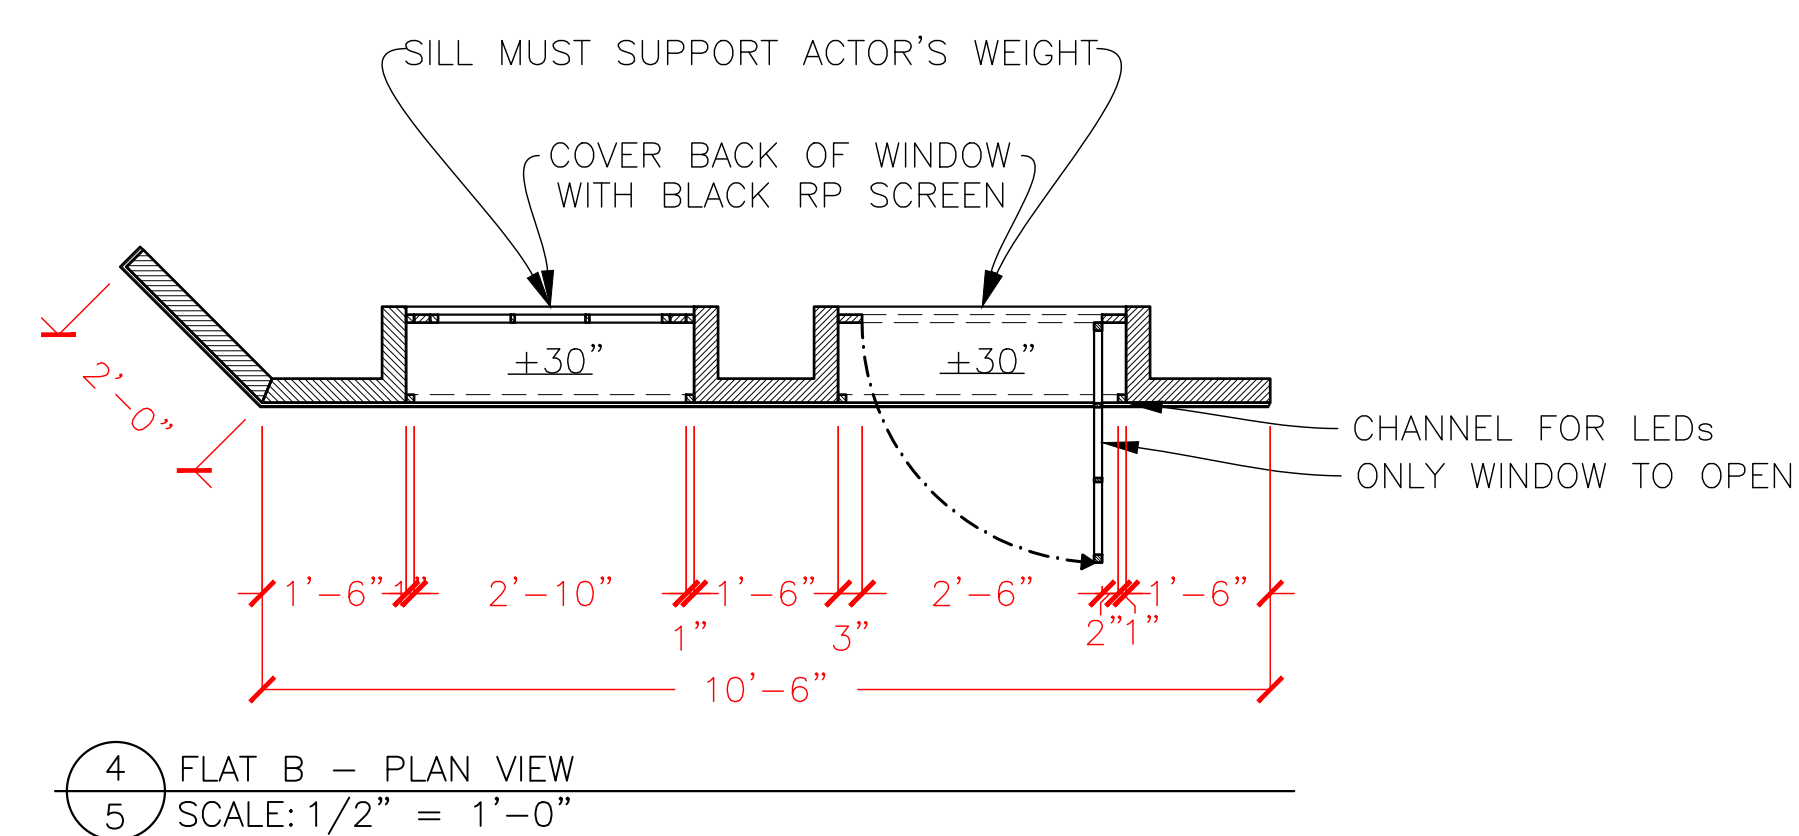

4 FLAT B - PLAN VIEW  
5 SCALE: 1/2" = 1'-0"

JASON WADECKI  
TECHNICAL DIRECTOR

THIS DRAWING  
REPRESENTS DESIGN  
INTENT AND CONCEPT








THE DESIGNERS AND ASSISTANT DESIGNERS ARE RESPONSIBLE FOR VISUAL ASPECTS OF THE DESIGN ONLY, AND ALL SPECIFICATIONS PROVIDED RELATE SOLELY TO THE APPEARANCE OF THE DESIGN AND NOT TO MATTERS OF CONSTRUCTION, STRUCTURAL SOUNDNESS AND/OR SAFETY. THE IMPLEMENTATION OF THIS DESIGN MUST COMPLY WITH THE MOST STRINGENT APPLICABLE FEDERAL AND LOCAL SAFETY AND FIRE CODES. THE DESIGNERS ARE NOT QUALIFIED TO DETERMINE STRUCTURAL OR ELECTRICAL APPROPRIATENESS OF THE DESIGN, AND WILL NOT ASSUME RESPONSIBILITY FOR DAMAGES RESULTING THROUGH IMPROPER ENGINEERING AND/OR IMPLEMENTATION IN THE HANDLING OF THE

THIS DRAWING HAS BEEN PREPARED IN  
ACCORDANCE WITH USITT GRAPHIC RECOMMENDED  
BEST PRACTICES.


[illegible]

DATE \_\_\_\_\_

OF 7

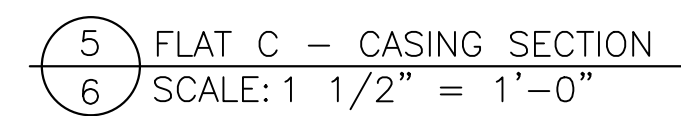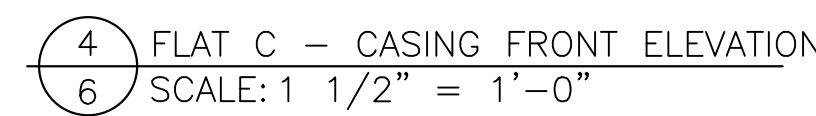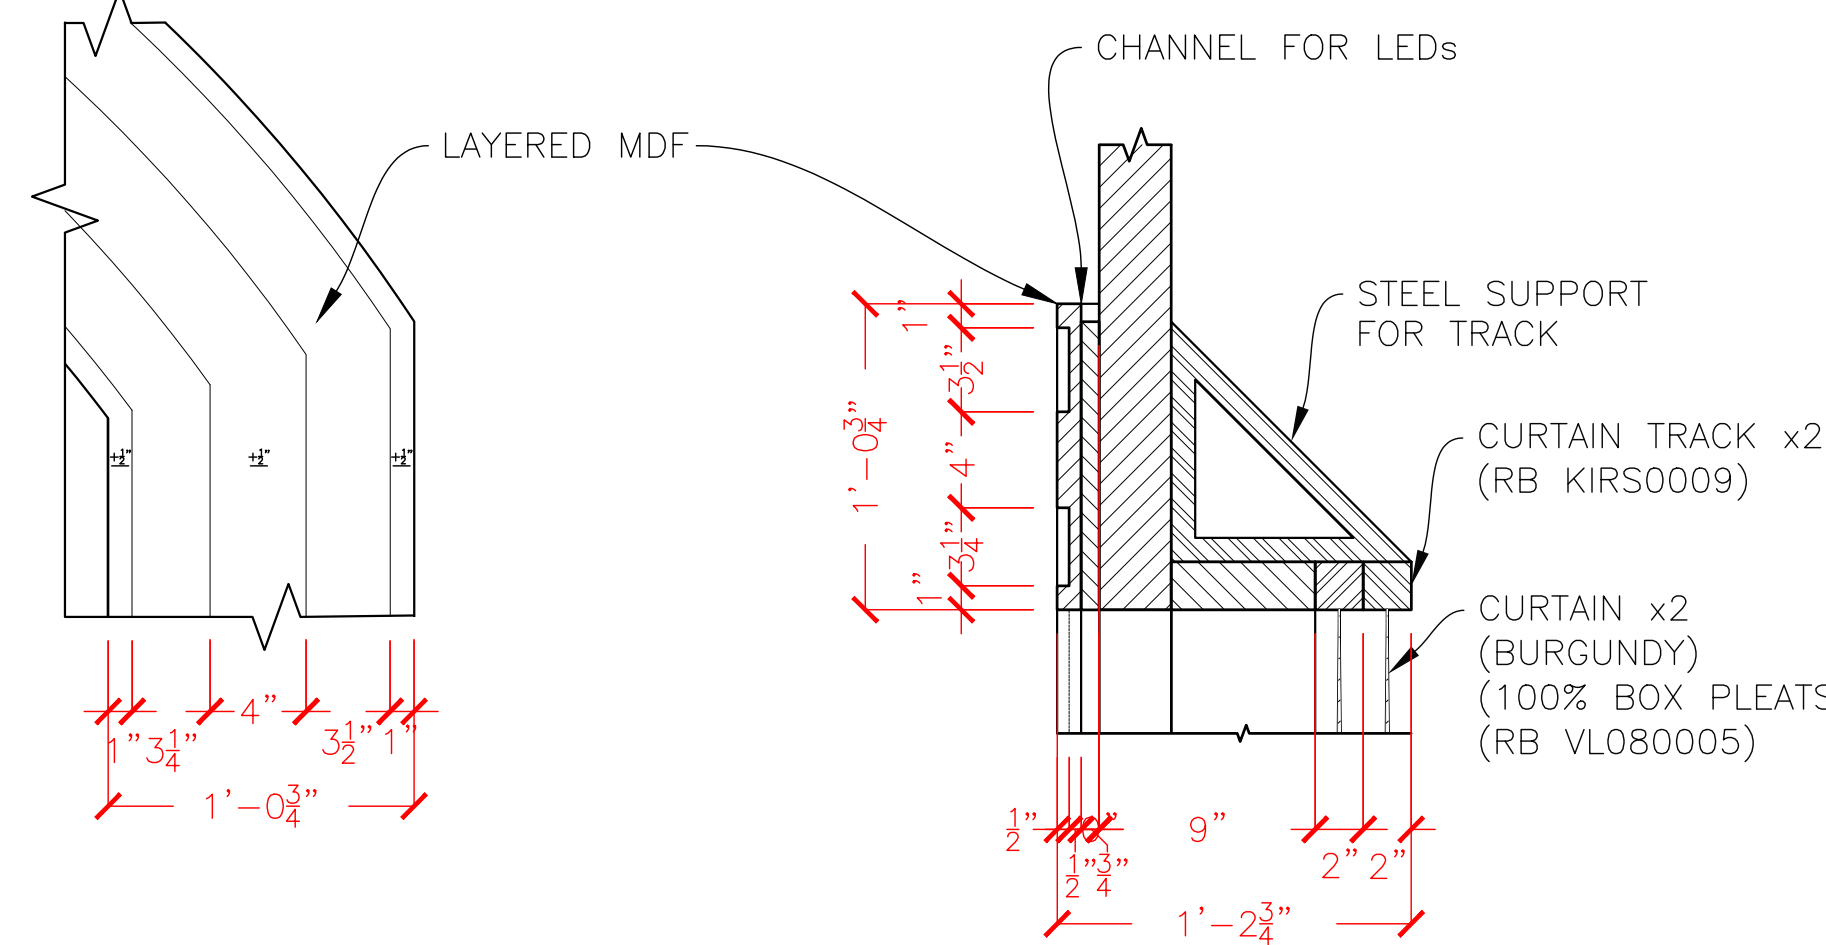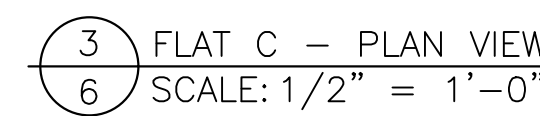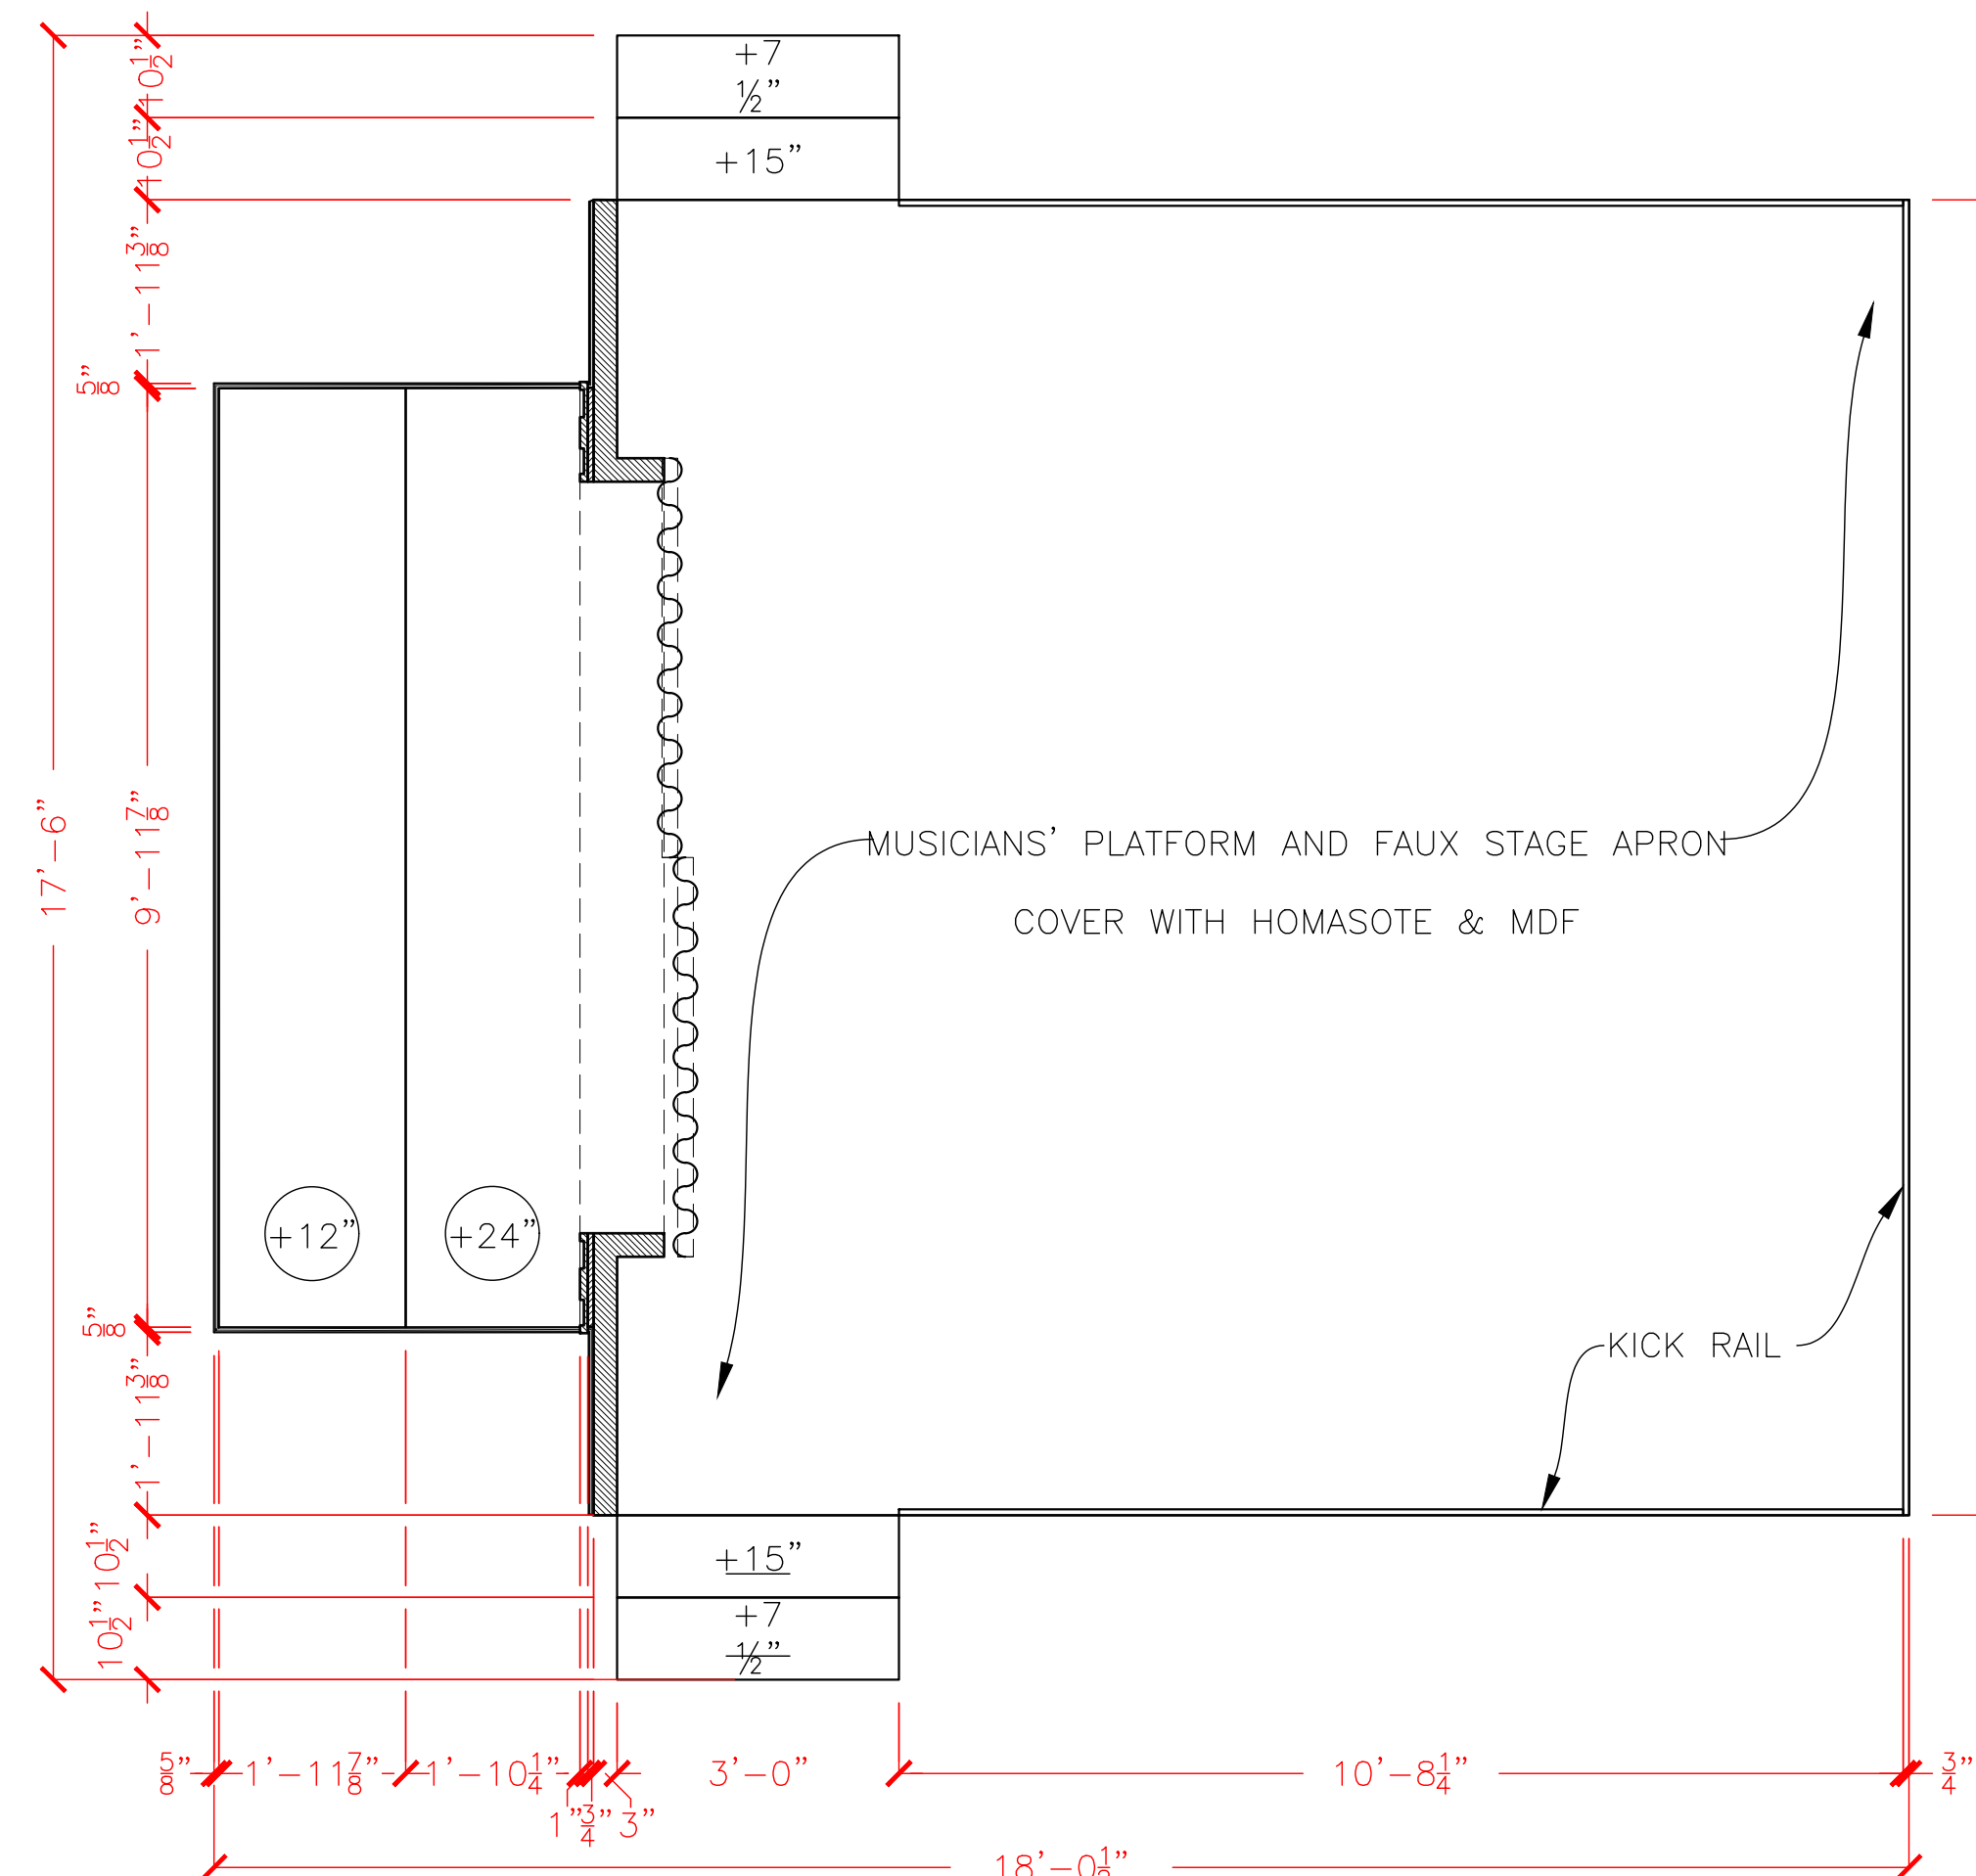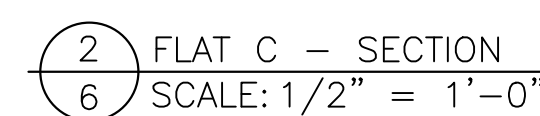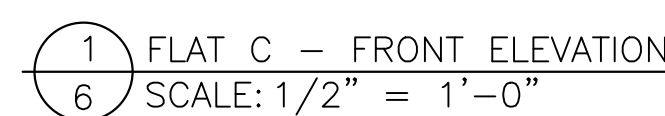



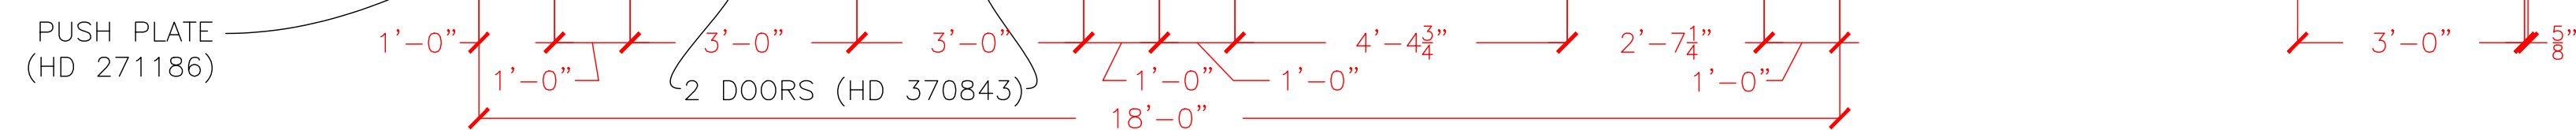

2 FLAT E - FRONT ELEVATION  
7 SCALE: 1/2" = 1'-0"

