




ISSUED Date Remarks  
 1. SEPT. 09, 2014 ISSUED FOR THE CLIENT REVIEW  
 2. SEPT. 09, 2014 ISSUED FOR THE CLIENT REVIEW  
 3. OCT. 09, 2014 ISSUED FOR BUILDING PERMIT  
 4. OCT. 16, 2014 ISSUED FOR CONSTRUCTION  
 5. DEC. 09, 2014 ISSUED FOR CONSTRUCTION  
 6. FEB. 2, 2016 RE-ISSUED FOR CONSTRUCTION

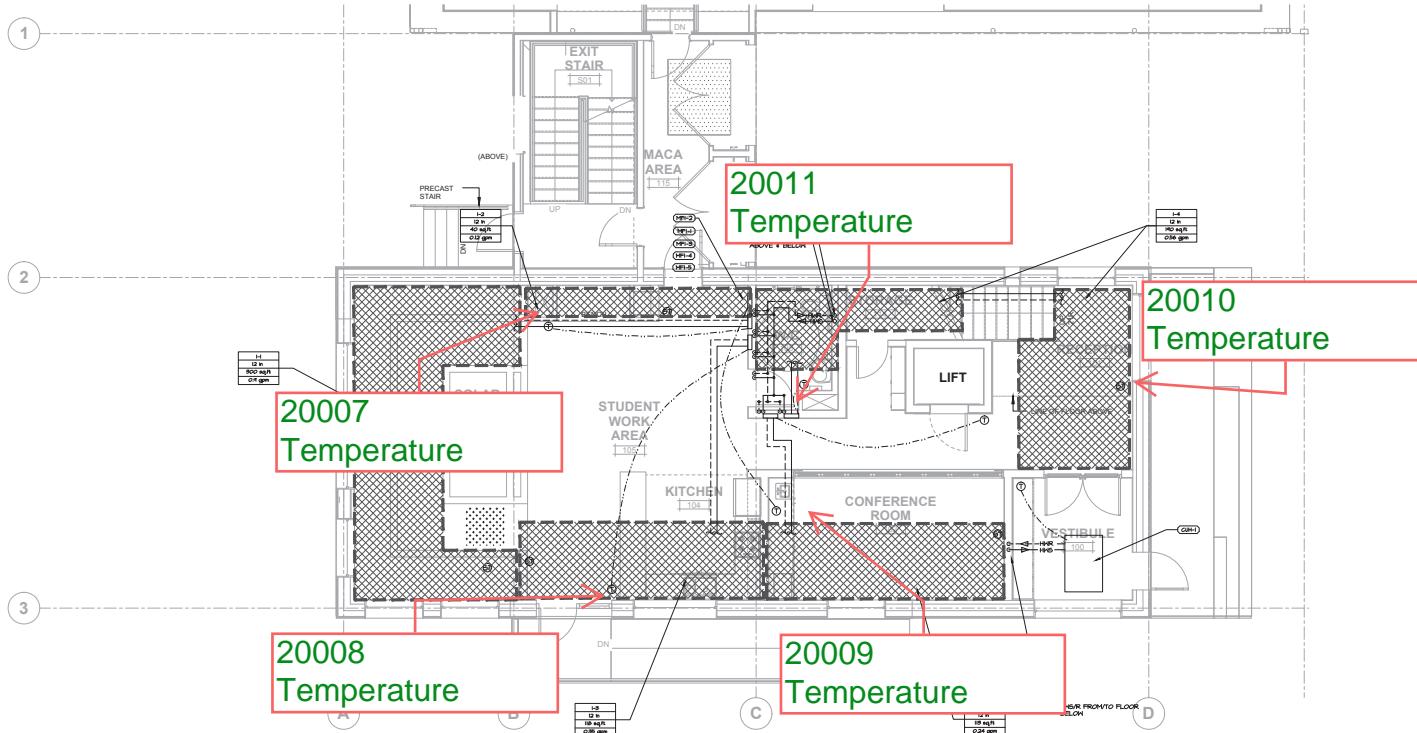


LEVEL I  
IN SLAB HEATING PLAN  
M2.1.2 SCALE: 1/4" = 1'-0"

GENERAL MECHANICAL NOTES:

- HEATED SLAB ZONES SHOWN FOR REFERENCE ONLY. PIPING LAYOUT DESIGN TO BE COMPLETED BY OTHERS AND SUBMITTED BY OMICRON FOR APPROVAL.
- REFER TO PIPING SCHEMATIC ON PAGE M6.0.1 FOR PIPE SIZING AND VALVE ARRANGEMENT.

ISSUED Date Remarks  
 1. SEPT. 06, 2014 ISSUED FOR CLIENT REVIEW  
 2. SEPT. 06, 2014 ISSUED FOR BUILDING PERMIT  
 3. OCT. 06, 2014 ISSUED FOR CONSTRUCTION  
 4. OCT. 06, 2014 ISSUED FOR CONSTRUCTION  
 5. FEB. 2, 2016 RE-ISSUED FOR CONSTRUCTION  
 6. FEB. 2, 2016 RE-ISSUED FOR CONSTRUCTION

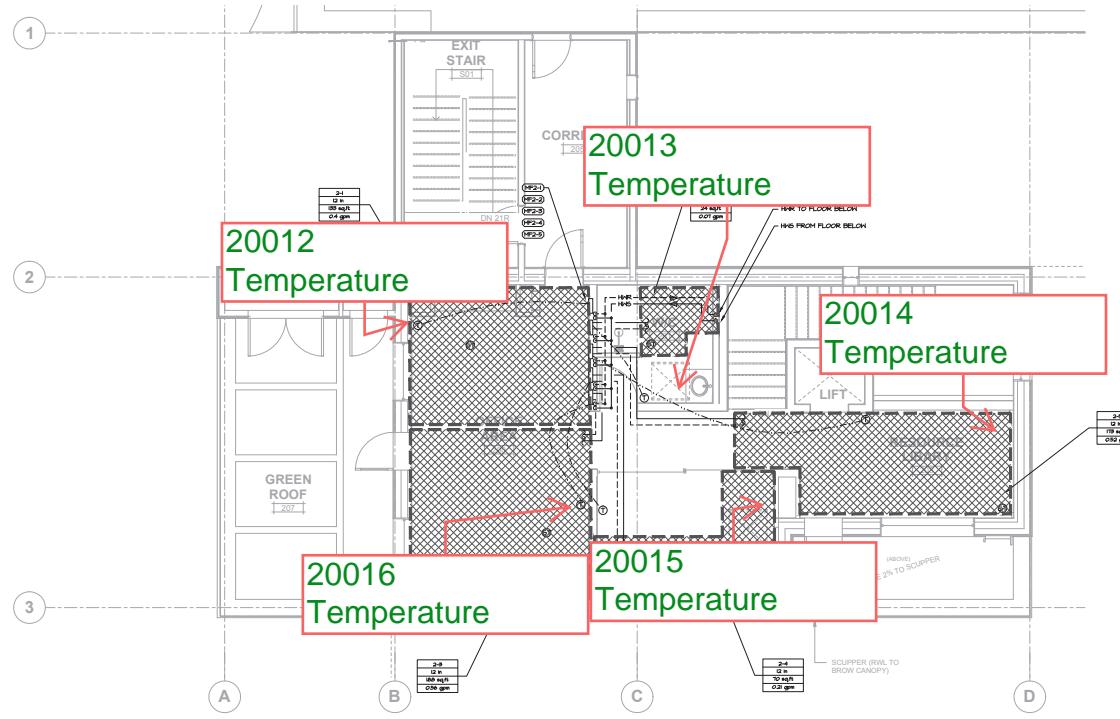

GENERAL MECHANICAL NOTES:  
 1. HEATED SLAB ZONES SHOWN FOR REFERENCE ONLY. PIPING LAYOUT DESIGN TO BE COMPLETED BY OTHERS AND SUBMITTED BY OMICRON FOR REVIEW.  
 2. REFER TO PIPING SCHEMATIC ON PAGE M2.2.2 FOR PIPE SIZES AND VALVE ARRANGEMENT.

LEVEL 2  
IN SLAB HEATING PLAN  
M2.2.2  
SCALE: 1/4" = 1'-0"

## SAIT GBT LAB & DEMONSTRATION CENTRE

Drawn: KP Checked: DS  
 Project Number 11-13-087

LEVEL 2  
IN SLAB HEATING PLAN  
**M2.2.2**