


RCP GENERAL NOTES

- FOR AREAS OF THE PROJECT WHERE CEILING LOADS DO NOT EXCEED 5 POUNDS PER SQUARE FOOT AND WHERE PARTITIONS ARE NOT CONNECTED TO THE CEILING SYSTEM, THE FOLLOWING MAY BE EMPLOYED:
- ALLOW FOR LATERAL MOVEMENT OF THE SYSTEM. ATTACH MAIN RUNNERS AND CROSS RUNNERS AT TWO ADJACENT WALLS; MAINTAIN CLEARANCE BETWEEN THE WALL AND THE RUNNERS AT THE OTHER TWO WALLS.
- PROVIDE VERTICAL SUPPORT AS REQUIRED IN BUILDING CODES. IN ADDITION, VERTICALLY SUPPORT ENDS OF RUNNERS WITHIN 8" OF DISCONTINUITIES SUCH AS MAY OCCUR WHERE THE CEILING IS INTERRUPTED BY A WALL, OR WHERE A "FLOATING" CEILING TERMINATES.
- SUPPORT LIGHT FIXTURES AND AIR DIFFUSERS DIRECTLY BY WIRES TO THE STRUCTURE ABOVE.
- LOCATE REGISTERS AND LIGHTING FIXTURES WITHIN GRID LINES. CENTER SPRINKLER HEADS, SPEAKERS, RECESSED FIXTURES, AND SIMILAR CEILING ELEMENTS IN ACOUSTICAL UNITS, UNLESS OTHERWISE NOTED.
- FINISH HVAC DIFFUSERS, DRAPERY/SHADE POCKETS, SPEAKER GRILLES AND OTHER ITEMS LOCATED IN CEILING TO MATCH ADJACENT FINISH, UNLESS OTHERWISE NOTED.
- CENTER GRID AND TILE IN ROOMS AS SHOWN.
- FOR AREAS OF THE PROJECT WHERE PARTITIONS ARE ATTACHED TO THE CEILING SYSTEM (UNDER-PINNED), OR WHERE CEILING LOADS EXCEED 5LBS PER SQ FT., DESIGN SUSPENDED CEILING FRAMING SYSTEMS TO RESIST A LATERAL FORCE OF 20% OF THE WEIGHT OF THE CEILING ASSEMBLY PLUS ALL LOADS TRIBUTARY TO THE SYSTEM. FOR UNDER-PINNED PARTITIONS, USE A MINIMUM OF 5LBS PER SQ FT UNIFORM LATERAL LOAD ON WALL TO CALCULATE TRIBUTARY LOAD TO CEILING SYSTEMS.

SYMBOL LEGEND

-
- GYP - SAG RESISTANT GYPSUM BOARD 1/2" THICKNESS WITH LONG EDGES TAPERED
-
- PROPOSED SUPPLY, RETURN, AND EXHAUST CLG GRILLS. PROVIDE NUMBERS AND LOCATIONS AS PER MECH DWGS. ALIGN AND CENTER WITH WALL ELEMENTS, CEILING ELEMENTS, WALL OPENINGS, DIMENSIONS, ETC., AS REQUIRED (TYP)
-
- WALL MOUNTED LIGHTS
SEE ELECTRICAL PLAN.
-
- SURFACE MOUNTED LIGHT FIXTURE
SEE ELECTRICAL PLAN.
-
- 22" x 36" x 5/8" PLYWD. ACCESS PANEL
(METAL CLADDED 1 HOUR FIRE RATED W/ LIGHT & PULL DN. CHAIN & DROP DOWN LADDER).
PROVIDE MAXIMUM USABLE AREA AT ATTIC & MIN. VERTICAL CLEARANCE OF 30" AS PER FBC 2020.

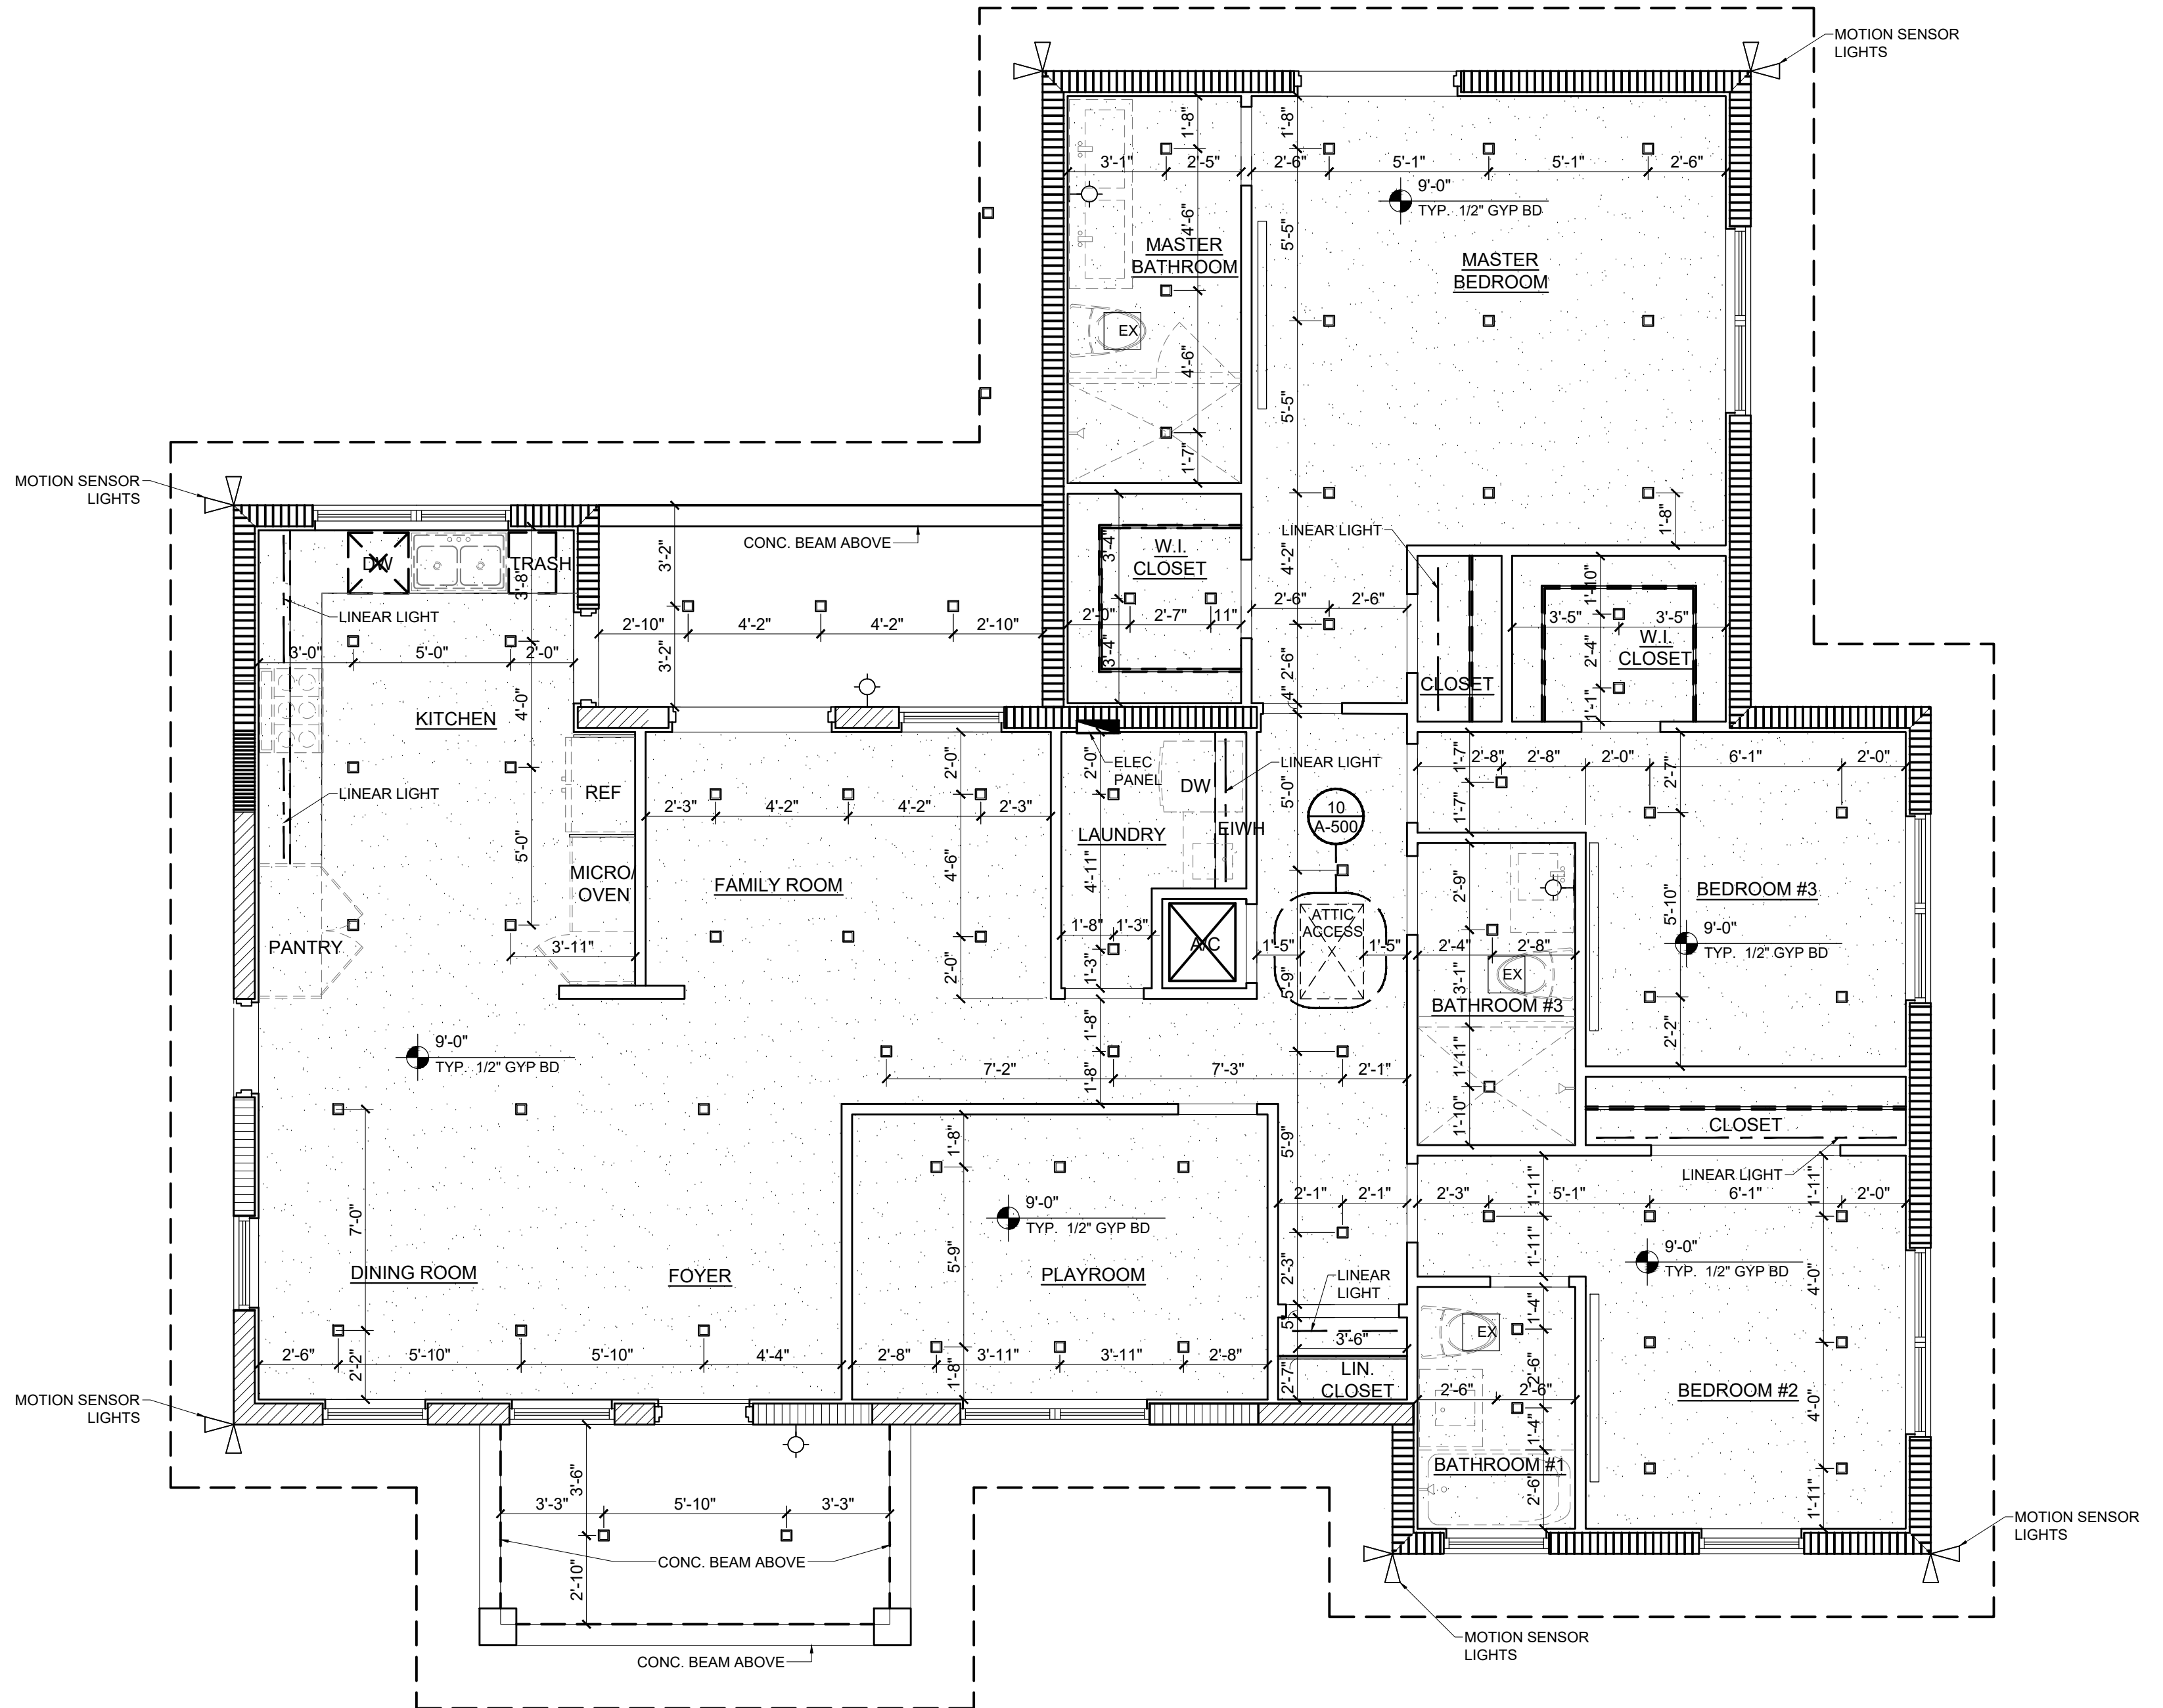

REFLECTED CEILING PLAN

SCALE: 1/4" = 1'-0"

0 5 10 20



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REVISIONS

DATE: 03.16.23

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RAFAEL TAPANES AR 97896

DISCIPLINE / SHEET TITLE:

PROPOSED REFLECTED CEILING PLAN

SCALE: AS SHOWN

SHEET NO:

A-103