


TYPICAL 1st - 9th Floor Plan  
I.10103  
SCALE 1:100

AREA CALCULATION	
PLOT AREA	598M <sup>2</sup>
PLOT COVERAGE	40M <sup>2</sup>
% PLOT COVERAGE	40%
TYPICAL FLOOR AREA	40M <sup>2</sup>
TOTAL FLOOR AREA	400M <sup>2</sup>
GROUND FLOOR AREA	400M <sup>2</sup>

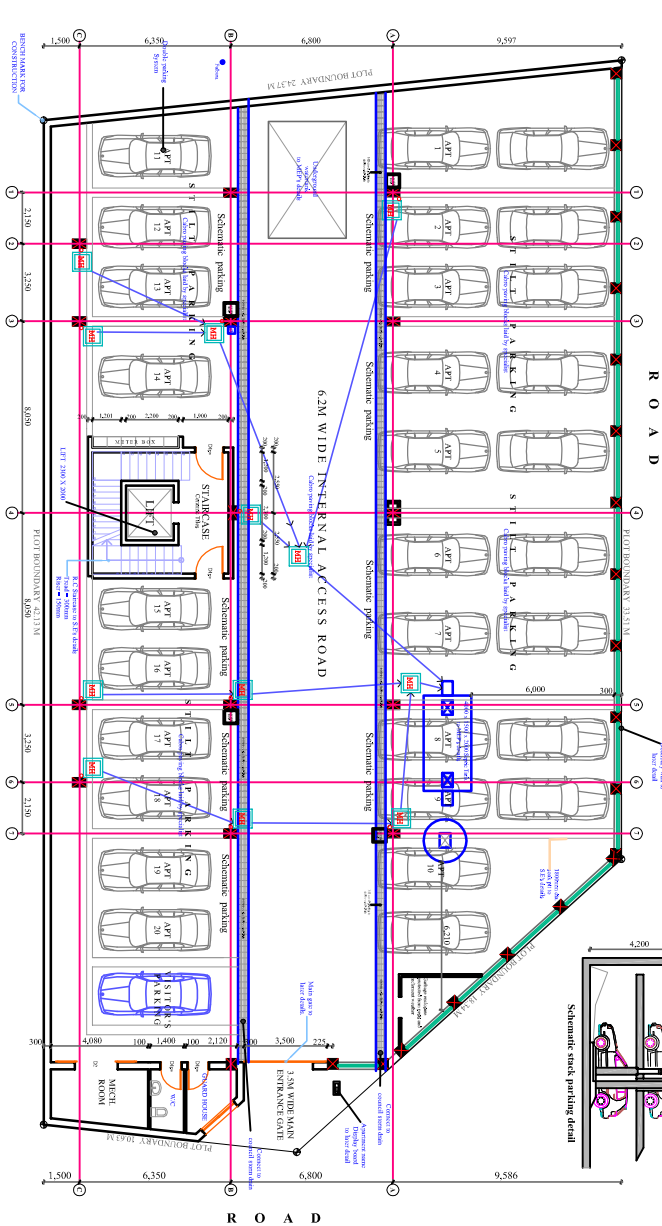

Ground Floor Plan / Parking Layout  
I.10102  
SCALE 1:100

## NOTES

1. This drawing is copyright © O
2. Do not scale off this drawing
3. All work and dimensions to be checked on site before any building work commences.
4. Any discrepancies to be reported to the office of the consultant
5. All work to be strictly in accordance to with the standard specification and notes.
6. This drawing is to be used in conjunction with specification and other relevant drawing
7. Walls below 200mm thick to be reinforced with hoop iron at every alternate course
8. Depth of foundations to be determined on site
9. P.v denotes permanent vent over doors and windows as shown on drawings
10. A single layer of 3 ply bituminous felt to be provided between masonry and Re work
11. Drain pipes passing under terrace driveway building to be encased in 150mm thick concrete surround
12. All reinforced concrete work to meetural Engineers drawing and detail
13. All sanitary works to the entire satisfaction of MOH
14. All roads storm water drainage and fall sewerage to civil engineers detail

## REVISIONS

Doors Schedule	
Code	Door Type
D1.20	1200 x 2400
D1.24	1200 x 2400
D1.26	1200 x 2400

Windows Schedule	
Code	Window Type
W1.20	1200 x 1200
W1.24	1200 x 1200
W1.26	1200 x 1200
W1.28	1200 x 1200
W1.30	1200 x 1200

Plot Title:  
**Proposed Residential Apartments**  
**On Plot No L.R NO 1 / 524**  
**Chania Wood Avenue Nairobi**

Client  
**MIR ALHAD MOHAMED HYDER AND**  
**MRS FATMA ALHAD HYDER**  
**Po Box 10276**  
**Nairobi**

Sheet Title: **Ground Floor / Site Plan**  
**TYPICAL 1st, 2nd and 4th, 5th, 6th, 7th, 8th and 9th Floor Plan**

ARCHITECT:

Draw No. **I.10102**  
**I.10103**

Sheet No. **01**

Date **MAY 2014**  
Scale **1:100**  
CAD TECHNICIAN **ROSA W.**