


# BATTERY PARK CITY AUTHORITY SITE 3 MECHANICAL SYSTEMS UPGRADE 75 BATTERY PLACE NEW YORK, NY

OLA Consulting Engineers

914,747.2800

BATTERY PARK **CITY AUTHORITY BPCPC MAINTENANCE FACILITY** 75 BATTERY PLACE, NY

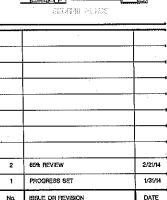

DATE

BPCPC MAINTENANCE FACILITY

**COVER SHEET** 

**PRELIMINARY** NOT FOR CONSTRUCTION

INDEX OF DDVMINGS.

E-103.00

E - 301.00

E-302.00

E = 303.00

E - 501.00

E - 701.00

INDEX C	OF DRAWINGS:
-T-001.0.0	COVER SHEET
EN-001.00	ENERGY CODE ANALYSIS AND LIST OF PROGRESS INSPECTIONS
S-101.00	SECOND FLOOR PARTIAL FRAMING PLAN
M-001.00 M-101.00 M-102.00 M-103.00 M-104.00 M-201.00 M-202.00 M-203.00 M-204.00 M-205.00 M-206.00 M-206.01 M-207.00 M-207.01 M-208.00 M-208.01 M-401.00 M-402.00 M-404.00 M-405.00 M-406.00 M-501.00 M-501.00 M-601.00 M-701.00	MECHANICAL SYMBOLS FIRST FLOOR MECHANICAL DEMOLITION PLAN SECOND FLOOR MECHANICAL DEMOLITION PLAN THIRD FLOOR MECHANICAL DEMOLITION PLAN FOURTH FLOOR MECHANICAL DEMOLITION PLAN FOURTH FLOOR MECHANICAL NEW WORK PLAN — PIPING SECOND FLOOR MECHANICAL NEW WORK PLAN — PIPING THIRD FLOOR MECHANICAL NEW WORK PLAN — PIPING FOURTH FLOOR MECHANICAL NEW WORK PLAN — PIPING FIRST FLOOR MECHANICAL NEW DUCTWORK PLAN SECOND FLOOR MECHANICAL NEW DUCTWORK PLAN SECOND FLOOR MECHANICAL NEW DUCTWORK PLAN THIRD FLOOR MECHANICAL NEW DUCTWORK PLAN THIRD FLOOR MECHANICAL NEW DUCTWORK PLAN FOURTH FLOOR MECHANICAL NEW DUCTWORK PLAN FOURTH FLOOR MECHANICAL NEW DUCTWORK PLAN MECHANICAL BOILER ROOM DEMOLITION AND NEW WORK PARTIAL PLANS 11TH FLOOR FAN ROOM MECHANICAL NEW WORK PLAN SECTION THRU ATRIUM LOOKING EAST SECTION THRU ATRIUM — LOOKING NORTH SECTION LOOKING NORTH THRU HIGH BAY STORAGE MECHANICAL SYSTEMS SCHEMATIC FRESH AIR INTAKE SYSTEM — RISER DIAGRAM MECHANICAL SCHEDULES MECHANICAL DETAILS (IN PROGRESS — NOT ISSUED)
E-001.00 E-101.00 E-102.00	ELECTRICAL SYMBOLS, ABBREVIATIONS AND GENERAL NOTES ELECTRICAL FIRST FLOOR DEMOLITION PLAN ELECTRICAL SECOND FLOOR DEMOLITION PLAN

ELECTRICAL 11TH FLOOR DEMOLITION PART ROOF PLAN


ELECTRICAL SECOND FLOOR NEW WORK PLAN

ELECTRICAL FOURTH FLOOR NEW WORK PLAN


ELECTRICAL THIRD FLOOR NEW WORK PLAN

ELECTRICAL POWER ONE-LINE DIAGRAM

ELECTRICAL DETAILS

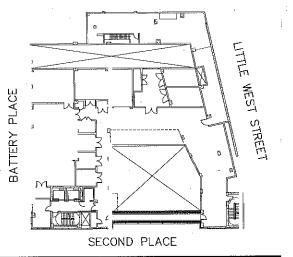

SITE KEY PLAN

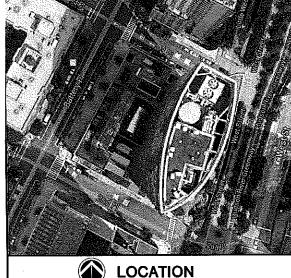

# PROGRESS INSPECTIONS - IIB - MECHANICAL AND SERVICE WATER HEATING

BPCPC MAINTENANCE FACILITY - SITE 3 MECHANICAL SYSTEMS UPGRADE

CLIMATE ZONE 4A
2010 NEW YORK CITY ENERGY CONSERVATION CODE - CHAPTER 6

No.	INSPECTION/TEST	PERIODIC (MINIMUM)	REFERENCE STANDARD (SEE ECC CHAPTER 6) OR OTHER CRITERIA	ECC OR OTHER CITATION
IB2	OUTDOOR AIR INTAKES AND EXHAUST OPENINGS: DAMPERS FOR STAIR AND ELEVATOR SHAFT VENTS AND OTHER OUTDOOR AIR INTAKES AND EXHAUST OPENINGS INTEGRAL TO THE BUILDING ENVELOPE SHALL BE VISUALLY INSPECTED TO VERIFY THAT SUCH DAMPERS, EXCEPT WHERE PERMITTED TO BE GRAVITY DAMPERS, COMPLY WITH APPROVED CONSTRUCTION DRAWINGS. MANUFACTURERS LITERATURE SHALL BE REVIEWED TO VERIFY THAT THE PRODUCT HAS BEEN TESTED AND FOUND TO MEET THE STANDARD.	AS REQUIRED DURING INSTALLATION	APPROVED CONSTRUCTION DOCUMENTS; AMCA 500D	502.4.4; ASHRAE 90.1 - 6.4.3.4
IIB4	IFVAC SYSTEM CONTROLS AND ECONOMIZERS AND SERVICE HOT WATER SYSTEM CONTROLS:  NO LESS THAN 20% OF EACH TYPE OF REQUIRED CONTROLS AND ECONOMIZERS SHALL BE VERHED BY VISUAL INSPECTION AND TESTED FOR FUNCTIONALITY AND PROPER OPERATION. SUCH CONTROLS SHALL INCLUDE, BUT ARE NOT LIMITED TO:  - THERMOSTATIC  - SET POINT OVERLAP RESTRICTION  - OFF-HOUR  - SHUTOFF DAMPER  - SNOW-MELT SYSTEMS  - DUTDOOR HEATING SYSTEMS  - OUTDOOR HEATING SYSTEMS  - ZONES  - ECONOMIZERS  - AIR SYSTEMS  - VARIABLE AIR VOLUME FAN  - HYDRONIC SYSTEMS  - HEAT REJECTION EQUIPMENT FAN SPEED  - COMPLEX MECHANICAL SYSTEMS SERVING MULTIPLE ZONES  - WENTILATION  - ENERGY RECOVERY SYSTEMS  - HOT GAS BYPASS LIMITATION  - TEMPERATURE  - SERVICE WATER HEATING  - HOT WATER SYSTEM  - POOL HEATER AND TIME SWITCHES  - EXHAUST HOODS  - RADIANT HEATING SYSTEMS.  CONTROLS WITH SEASONALLY DEPENDENT FUNCTIONALITY: CONTROLS WHOSE COMPLETE OPERATION CANNOT BE DEMONSTRATED DUE TO PREVAILING WEATHER CONDITIONS TYPICAL OF THE SEASON DURING WHICH PROGRESS INSPECTIONS WILL BE PERFORMED SHALL BE PERMITTED TO BE SIGNED OFF FOR THE PURPOSE OF A TEMPORARY OFFINION HEATER AND SING PERFORMED SHALL BE PERMITTED TO BE SIGNED OFF FOR THE PURPOSE OF A TEMPORARY OFFINION HEATER AND SING PERFORM A SUPPLEMENTAL INSPECTION WHERE THE CONTROLS ARE PERFORM A SUPPLEMENTAL INSPECTION WHERE THE CONTROLS ARE VISUALLY INSPECTED AND TESTED FOR FUNCTIONALITY AND PROPER OPERATION DEPENDENT HIM THE PROGRESS INSPECTOR'S HALL BE PERMITTED TO BE SIGNED OFF FOR THE PURPOSE OF A TEMPORARY OPERATION SHALL PROVIDE FULL ACCESS TO THE PROGRESS INSPECTOR'S REQUEST FOR SUCH ACCESS TO PERFORM THE PROGRESS INSPECTOR'S REQUEST FOR SUCH ACCESS TO PERFORM THE PROGRESS INSPECTOR'S REQUEST FOR SUCH SUPPLEMENTAL INSPECTIONS, THE DEPARTMENT SHALL BNOTIFIED BY THE APPROVED PROGRESS INSPECTION AGENCY OF ANY UNRESOLVED DEPCIMENTAL INSPECTIONS, THE DEPARTMENT SHALL BNOTIFIED BY THE APPROVED PROGRESS INSPECTION AGENCY OF ANY UNRESOLVED DEPCIMENTAL INSPECTIONS, THE DEPARTMENT SHALL BNOTIFIED BY THE APPROVED PROGRESS IN	AFTER INSTALLATION AND PRIOR TO FINAL ELECTRICAL AND CONSTRUCTION INSPECTION, EXCEPT THAT FOR CONTROLS WITH SEASONALLY DEPENDENT FUNCTIONALITY, SUCH TESTING SHALL BE PERFORMED BEFORE SIGN—OFF FOR ISSUANCE OF A FINAL CERT	APPROVED CONSTRUCTION DOCUMENTS, INCLUDING CONTROL SYSTEM NARRATIVES; ASHRAE GUIDELINE 1: THE HVAC COMMISSIONING PROCESS WHERE APPLICABLE	503.2.4, 503.2.5.1, 503.2.11, 503.3, 504.6, 504.6, 504.7; ASHRAE 90.1 6.3, 6.4, 6.5, 6.7.2.4, 7.4.4, 7.4
IIB5	DUCT, PLENUM AND PIPING INSULATION AND SEALING: INSTALLED DUCT AND PIPING INSULATION SHALL BE VISUALLY INSPECTED TO VERIFY PROPER INSULATION PLACEMENT AND VALUES JOINTS, LONGITUDINAL AND TRANSVERSE SEAMS AND CONNECTIONS IN DUCTWORK SHALL BE VISUALLY INSPECTED FOR PROPER SEALING	AFTER INSTALLATION AND PRIOR TO CLOSING SHAFTS, CEILINGS AND WALLS	APPROVED CONSTRUCTION DOCUMENTS; SMACNA DUCT CONSTRUCTION STANDARDS, METAL AND FLEXIBLE	503.2.7, 503.2.8, 504.5; ASHRAE 90.1 – 6.3, 6.4.4.2, 6.8.: 6.8.3; 7.4.3
1186	AIR LEAKAGE TESTING FOR HIGH-PRESSURE DUCT SYSTEMS: FOR DUCT SYSTEMS DESIGNED TO OPERATE AT STATIC PRESSURES IN EXCESS OF 3 INCHES W.G. (746 PA), REPRESENTATIVE SECTIONS, AS DETERMINED BY THE PROGRESS INSPECTOR, TOTALING AT LEAST 25% OF THE DUCT AREA, PER ECC 503.2.7.1.3, SHALL BE TESTED TO VERIFY THAT ACTUAL AIR LEAKAGE IS BELOW ALLOWABLE AMOUNTS.	AFTER INSTALLATION AND SEALING AND PRIOR TO CLOSING SHAFTS, CEILINGS AND WALLS	APPROVED CONSTRUCTION DOCUMENTS; SMACNA HVAC AIR DUCT LEAKAGE TEST MANUAL	503.2.7.1.3; ASHRAE 90.1 6.4.4.2

# PROGRESS INSPECTIONS - IIC - ELECTRICAL POWER AND LIGHTING SYSTEMS

COMMERCIAL

BPCPC MAINTENANCE FACILITY - SITE 3 MECHANICAL SYSTEMS UPGRADE CLIMATE ZONE 4A

2010	NEW YORK CITY ENERGY CONSERVATION CODE - CHAPTI	ER 6		
No.	INSPECTION/TEST	PERIODIC (MINIMUM)	REFERENCE STANDARD (SEE ECC CHAPTER 6) OR OTHER CRITERIA	ECC OR OTHER CITATION
1105	LICHTING CONTROLS: EACH TYPE OF REQUIRED LIGHTING CONTROLS, INCLUDING: - OCCUPANT SENSORS - MANUAL INTERIOR LIGHTING CONTROLS - LIGHT-REDUCTION CONTROLS - AUTOMATIC LIGHTING SHUT-OFF - DAYLIGHT ZONE CONTROLS - SLEEPING UNIT CONTROLS - EXTERIOR LIGHTING CONTROLS - STALL BE VERIFIED BY MSUAL INSPECTION AND TESTED FOR FUNCTIONALITY AND PROPER OPERATION.		APPROVED CONSTRUCTION DOCUMENTS, INCLUDING CONTROL SYSTEM NARRATIVES	505.2, 505.2.2.2; ASHRAE 90.1 – 9.4.1, 9.4.1.2 (AS MODIFIED BY SECTION ECC A102)
IIC9	ELECTRIC MOTORS (INCLUDING BUT NOT LIMITED TO FAN MOTORS): WHERE REQUIRED BY THE CONSTRUCTION DOCUMENTS FOR ENERGY CODE COMPLIANCE, MOTOR LISTING OR LABELS SHALL BE VISUALLY INSPECTED TO VERIFY THAT THEY COMPLY WITH THE RESPECTIVE ENERGY REQUIREMENTS IN THE CONSTRUCTION DOCUMENTS.	PRIOR TO FINAL ELECTRICAL AND CONSTRUCTION INSPECTION	APPROVED CONSTRUCTION DOCUMENTS	503.2.10; ASHRAE 90.1 10.4

# PROGRESS INSPECTIONS - IID - OTHER

COMMERCIAL

BPCPC MAINTENANCE FACILITY - SITE 3 MECHANICAL SYSTEMS UPGRADE

CLIMATE ZONE 4A
2010 NEW YORK CITY ENERGY CONSERVATION CODE - CHAPTER 5

ļ	No.	INSPECTION/TEST	PERIODIC (MINIMUM)	REFERENCE STANDARD (SEE ECC CHAPTER 6) OR OTHER CRITERIA	ECC OR OTHER CITATION
	IID1	MAINTENANCE INFORMATION: MAINTENANCE MANUALS FOR MECHANICAL, SERVICE HOT WATER AND ELECTRICAL EQUIPMENT AND SYSTEMS REQUIRING PREVENTIVE MAINTENANCE SHALL BE REVIEWED FOR APPLICABILITY TO INSTALLED EQUIPMENT AND SYSTEMS BEFORE SUCH MANUALS ARE PROVIDED TO THE OWNER. LABELS REQUIRED FOR SUCH EQUIPMENT OR SYSTEMS SHALL BE INSPECTED FOR ACCURACY AND COMPLETENESS.	PRIOR TO SIGN-OFF OR	APPROVED CONSTRUCTION DOCUMENTS, INCLUDING ELECTRICAL DRAWMOS WHERE APPLICABLE; ASHRAE GUIDELINE 4: PREPARATION OF OPERATING AND MAINTENANCE DOCUMENTATION FOR BUILDING SYSTEMS	303.3, 503.2.9.3; ASHRAE 90.1 – 4.2.2.3, 6.7.2.2, 8.7.2

ITEM DESCRIPTION	SY CONSERVATION CODE - CHAPTER 6 PROPOSED DESIGN VALUE	CODE PRESCRIPTIVE VALUE AND CITATION
NEW INTERIOR SUPPLY AND RETURN AIR DUCTWORK	DUCT INSULATION THICKNESS = 1.5°, K = 0.27, R = 5.6	MINIMUM R-5 INSULATION  (SECTION 503.2.7)
NEW HOT WATER PIPING	FOR PIPE DIAMETER ≤ 1.5", INSULATION THICKNESS == 1.5", K=0.23 FOR PIPE DIAMETER > 1.5", INSULATION THICKNESS == 2.0", K=0.23	FOR PIPE DIAMETER \$ 1.5", MINIMUM INSULATION THICKNESS = 1.5", K=0.27  FOR PIPE DIAMETER > 1.5", MINIMUM INSULATION THICKNESS = 2.0", K=0.27  (TABLE 503.2.8)
NEW REFRIGERANT PIPING	FOR PIPE DIAMETER ≤ 1.5", INSULATION THICKNESS = 1.5", K=0.27 FOR PIPE DIAMETER > 1.5", INSULATION THICKNESS = 1.5", K=0.27	FOR PIPE DIAMETER \$ 1.5", MINIMUM INSULATION THICKNESS = 1.5", K=0.27  FOR PIPE DIAMETER > 1.5", MINIMUM INSULATION THICKNESS = 1.5", K=0.27  (TABLE 503.2.8)
NEW GAS-FIRED HOT WATER CONDENSING BOILER <u>B-2</u> .	INPUT CAPACITY = 500,000 BTU/H THERMAL EFFICIENCY = 93.3%	300,000 BTU/H ≤ INPUT CAPACITY ≤ 2,500,000 BTU/H MINIMUM COMBUSTION EFFICIENCY = 80% MINIMUM THERMAL EFFICIENCY = 75%  (TABLE 503.2.3(5))
AIR COOLED PACKAGED CHILLER		

NEW YORK CITY BUILDINGS		
LIST OF REQUIRE	ED SPECIAL INSP	ECHONS
INSPECTION/TEST	PERIODIC (MINIMUM)	CODE/SECTION

LIST OF REQUIRED SPECIAL INSPECTIONS					
INSPECTION/TEST	PERIODIC (MINIMUM)	CODE/SECTION			
MECHANICAL SYSTEMS	AS REQUIRED DURING INSTALLATION	BC 1704.15			
HEATING SYSTEMS	AS REQUIRED DURING INSTALLATION	BC 1704.23			
FIRESTOP, DRAFTSTOP, AND FIREBLOCK SYSTEMS	AS REQUIRED DURING INSTALLATION	BC 1704.25			

NEW YORK CITY DEPARTMENT OF
BUILDINGS
LIST OF REQUIRED PROGRESS INSPECTIONS


INSPECTION/TEST	PERIODIC (MINIMUM)	CODE/SECTION
ENERGY CODE COMPLIANCE INSPECTIONS	AS REQUIRED DURING INSTALLATION	BC 109.3.5
FINAL INSPECTION	PRIOR TO CERTIFICATE OF OCCUPANCY OR LETTER OF OCCUPANCY	28-116.2.4.2 BC 109.5 DIRECTIVE 14 OF 1975 1 RCNY 101-10




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914.747.2800

BATTERY PARK CITY AUTHORITY BPCPC MAINTENANCE FACILITY 75 BATTERY PLACE, NY




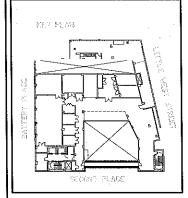

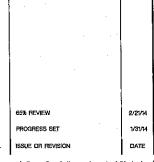
PROJECT TITLE

BPCPC MAINTENANCE FACILITY SITE 3 MECHANICAL SYSTEMS UPGRADE

ENERGY CODE ANALYSIS AND LIST OF PROGRESS INSPECTIONS

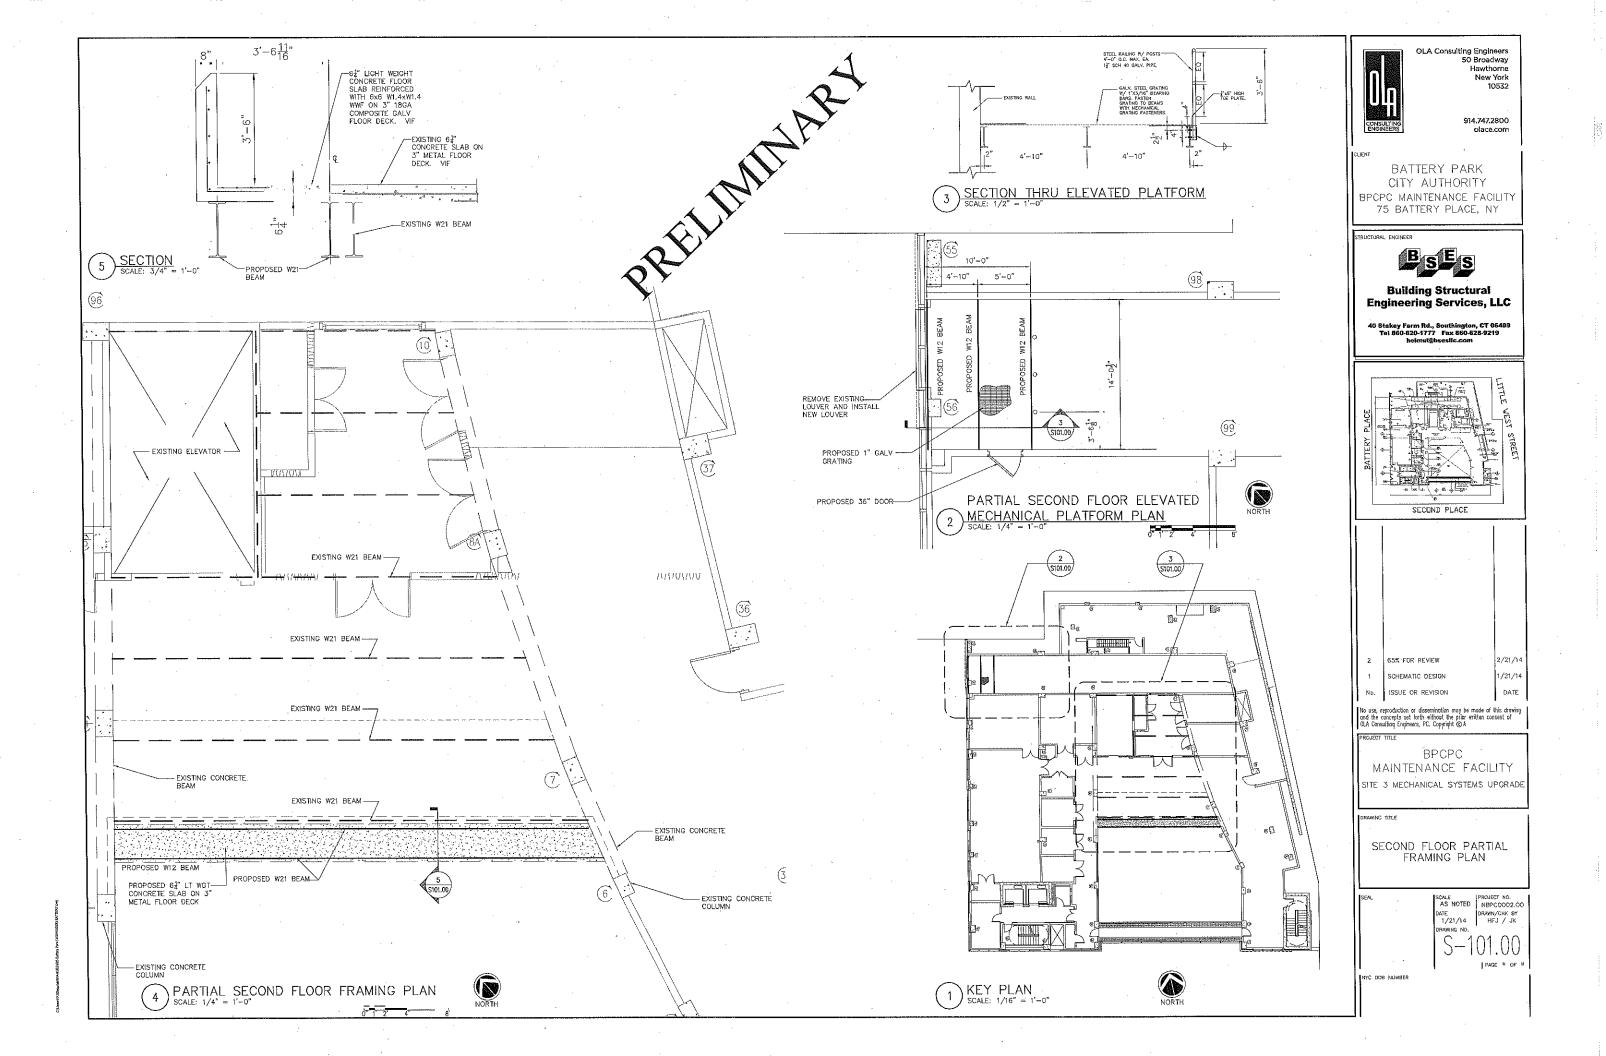


)L	, ABBREVIATION	DESCRIPTION	SYMBOL A	ABBREVIATION	DESCRIPTION .	SYMBOL	ABBREVIATION	DESCRIPTION	SYMBOL	ABBREVIATIO	DESCRIPTION			Broadwa; Iawthorn
	AC-	AIR CONDITIONING UNIT	*		J-WAY VALVE	DS —	_	DIESEL SUPPLY			DUCT RISE			New Yor 1053
	ACC-	AIR COOLED CONDENSING UNIT		-	FLEXIBLE CONNECTION	— DR —		DIESEL RETURN		<u> </u>	DUCT DROP	' <b>  </b>   Î		1000
			& I			— GLS —		GLYCOL SUPPLY		_	DUCT TRANSITION			
	AD ·	ACCESS DOOR		<del></del>	2-WAY VALVE			GLYCOL RETURN	<del></del>	- <del></del>	ALUMINUM DUCT	CONSULTER	1G 914	1,747,280 olace.cor
	AFF	ABOVE FINISHED FLOOR	4		PLUG VALVE	GLR		<u> </u>		AL	ACOUSTIC LINING			
	AHC	ABOVE HUNG CEILING	%		LOCK SHIELD VALVE	— HPS		HIGH PRESSURE STEAM SUPPLY				CLIENT		
	AHU-	AIR HANDLING UNIT	W.	·	GATE VALVE	HPR		HIGH PRESSURE STEAM RETURN		FD/AD	FIRE DAMPER W/ ACCESS DOOR	H .		
* ***	AP	ACCESS PANEL	₩	-	GLOBE VALVE	— MPS —	_	MEDIUM PRESSURE STEAM SUPPLY	<u>'</u>	SD/AD	SMOKE DAMPER W/ ACCESS DOOR COMBINATION FIRE/SMOKE DAMPER	II.		
	BDD	BACKDRAFT DAMPER		-	TEE DOWN	MPR	-	MEDIUM PRESSURE STEAM RETURN	掛	CFSD.	W/ ACCESS DOOR	1		
	BHP	BRAKE HORSEPOWER	<b>@</b>		ELBOW DOWN	— LPS —	-	LOW PRESSURE STEAM SUPPLY		. VD	VOLUME DAMPER	I I	BATTERY PARI	
	BTU	BRITISH THERMAL UNIT	-0-		TEE UP	LPR	-	LOW PRESSURE STEAM RETURN		AL	ACOUSTIC LINING		ITY AUTHORIT	
	CFM	CUBIC FEET PER MINUTE	<b>О</b> —	_	ELBOW UP	— нws —	_	HOT WATER SUPPLY	<u>&gt; 6x8</u> >	· ·	DUCT SIZE — 1ST FIGURE IS SIDE SHOWN		MAINTENANCE F	
	, CH-	CABINET HEATER	N .	- !	CONCENTRIC REDUCER	HWR	***	HOT WATER RETURN	<u> </u>	FC	FLEXIBLE CONNECTION	15	BATTERY PLACE	, 141
		CENTERLINE	H	_	ECCENTRIC REDUCER	— PD ——		PUMP DISCHARGE, CONDENSATE	****	-	ALUMINUM DUCT	l <b>I</b>		
	. CP-	CONDENSATE PUMP	內		OS&Y GATE VALVE		_	REFRIGERANT LIQUID				11		
-					PIPE GUIDE	RS		REFRIGERANT SUCTION	SECTA SECTA		SECTION CALLOUT	11		
	DB	DRY BULB TEMPERATURE	× ×			нд — нд ——		REFRIGERANT HOT CAS	<del>                                     </del>			<u> </u>		
		DIAMETER			PIPE ANCHOR	110		RETRIBUTATION OF STATE OF STAT	(AC)	<del></del>	AIR CONDITIONING UNIT			
	INX	DIRECT EXPANSION			STRAINER		<b> </b>		Acci		AIR COOLED CONDENER(ING) UNIT	11 65V	PS, A89-	
	EA	EXHAUST AIR	U	_	BASKET STRAINER							11	Marine Contraction of the contra	<u></u>
	EAT	ENTERING AIR TEMPERATURE	<b>A</b>	-	PRESSURE REDUCING		<u> </u>		AHU		' AIR HANDLING UNIT	11		À
	EF	EXHAUST FAN	<del></del>	1	FLOW ARROW	<b>D</b>	<u> </u>	THERMOSTAT	CH CH		CABINET HEATER	11		p1
	EL	ELEVATION	φī	<u>-</u> ,	BUTTERFLY	Θ	<u> </u>	HUMIDISTAT	GUH)		CABINET UNIT HEATER	11. 🐰	I ES	/ Ø_
	ER ·	EXHAUST REGISTER	IQI	_	BALANCING VALVE	M		MOTORIZED DAMPER	<b>₹</b>		CEILING DIFFUSER		wed La	$I \mathrel{\sqsubset}$
	, ESP	EXTERNAL STATIC PRESSURE	H		MANUAL AIR VENT	(S)		SMOKE DETECTOR			CHILLER	11 ^- 9E	12	B
	EWT	, ENTERING WATER TEMPERATURE	†	_	AUTO AIR VENT	Ψ	_	DOOR UNDER CUT	(P)		CONDENSATE PUMP	II B	<u> -3</u>	6 0
	FCU	, FAN COIL UNIT	©	_	SOLENOID VALVE	±	_	DOOR LOUVER	(SV-A)		CONSTANT VOLUME BOX	11 🙏		١,
					MOTORIZED VALVE	+	<del>-</del>	AIR INTO REGISTER	T (F)		EXHAUST FAN	11 🗒	TJ / \	J
	FPM	FEET PER MINUTE	<b>1 1 1 1 1 1</b>	<del>-</del>	ANGLE GLOBE VALVE	<del></del>	<del></del>	SPEED CONTROLLER	· 💮		EXHAUST REGISTER	11 <u> </u>		<u> </u>
	FPS	FEET PER SECOND	<u> </u>	<u> </u>	·			POINT OF CONNECTION DISCONNECTION	1 (6)		FAN COIL UNIT	11	SECOND PLACE	
	FTR	FINNED TUBE RADIATION	<u> </u>	ļ	ANGLE GATE VALVE	<u> </u>	<del>-</del>					1		<del></del> [
	· GPM	GALLONS PER MINUTE	J	-	T&P RELIEF VALVE	<u> </u>	TR	TOP REGISTER SUPPLY			FIN TUBE RADIATION	11		
	HP HP	HORSE POWER		_	FILTER DRYER	*- <u></u>	TR	TOP REGISTER RETURN	(x)		GENERAL EXHAUST FAN	1		
	HV-	HEATING AND VENTILATING UNIT		-	FILTER		UH	UNIT HEATER	1		HEATING & VENTILATING UNIT HEATING VENTILATING & AIR CONDITIONING	11		
	HVAC-	HEATING, VENTILATING AND AIR CONDITIONING UNIT	8		FLOAT AND THERMOSTATIC TRAP		CUH	CABINET UNIT HEATER	, (1)	-	UNIT UNIT	-11		
	KX-	KITCHEN EXHAUST		_	FLOAT TRAP	<b>D</b>	P-1	PUMP	HX 1		HEAT EXCHANGER	-1.		
	. LAT	LEAVING AIR TEMPERATURE		· -	BALL VALVE		SR	SUPPLY REGISTER	, (sx)	<u> </u>	KITCHEN EXHAUST FAN			
-	LF	LINEAR FEET	· \$		PRESSURE GAGE		CD	1-WAY	(1)		LOUVER	11		
	LWT	, LEAVING WATER TEMPERATURE	ļ	· -	THERMOMETER		CD.	2-WAY	(FTAC)	_	PACKAGED TERMINAL AIR CONDITIONING UNIT	71		
		, 1000 BRITISH THERMAL UNITS PER HOUR	<u> </u>	·	CHECK VALVE		CD	2-WAY	<del>-1 (<u>ě</u>)</del>	<u> </u>	PUMP	7   2   6	S% REVIEW	
-	. МВН		ļ. , , , , , , , , , , , , , , , , , , ,	1	UNION	. 🗷	I CD	3-WAY	RF		RETURN FAN	<b>7!</b> ───	ROGRESS SET	
	MER	MECHANICAL EQUIPMENT ROOM	<u> </u>	<del> </del>					- (RE)		REHEAT COIL	┑┝		
-	NC NC	NORMALLY CLOSED	]	<del> </del>	<u> </u>		CD	4-WAY	1 (%)			No. IS	SUE OF REVISION	
	NIC	NOT IN CONTRACT	ļ	+	<u> </u>	<u> </u>	- CD	1-WAY			RETURN REGISTER	and the conce	luction or dissemination may be n pts set forth without the prior wr	ritten con
-	NO	NORMALLY OPEN	ļ	<b>_</b>	1		CD	2-WAY	(Sa)		SUPPLY REGISTER	OLA Consulting	Engineers, PC. Copyright © 2014	
	OAI	OUTSIDE AIR INTAKE		1		M	CD	2-WAY	TX	-	TOILET EXHAUST FAN	PROJECT TITL		
-	PSI	POUNDS PER SQUARE INCH	1				CD	3WAY	<b>S</b>	<u> </u>	TOP REGISTER	 	BPCPC	
-	ŔĀ	RETURN AIR	1	i i			CD	4-WAY	UIH Ā	-	UNIT HEATER	U MAI BEES	NTENANCE FA MECHANICAL SYSTEM	ان. باد دا⊳
	RF-	RETURN FAN	1	1		<u> </u>	CD	ROUND CEILING DIFFUSER	. **	=	UNIT VENTILATOR	11 MIL 3		
	RPM	REVOLUTIONS PER MINUTE	······································	EX.	EXISTING TO REMAIN		, LD	LINEAR DIFFUSER			VARIABLE AIR VOLUME BOX			
	RTU-	, ROOFTOP UNIT		REL,	REMOVE AND RELOCATE	. \	RR/RG	RETURN REGISTER/GRILLE	-	_		JRAWING TITL	E	
			l	, NEW	NEW WORK		VAV	VAV BOX	<del>-1</del> -	_		<b>-1</b> 1		
	SA	SUPPLY AIR		DEM.	EXISTING TO BE REMOVED		VAV	VAV BOX WITH REHEAT			_	ŢI MI	ECHANICAL SYN	ИВО
	SP	STATIC PRESSURE		UEM.						1 _			ND ABBREVIAT	
-	TD	TRANSFER DUCT	ca	1	COMPRESSED AIR		CV	CONSTANT VOLUME BOX	<del>-</del>	-   .		٦١		
	TDH	TOTAL DYNAMIC HEAD	CHWS		CHILLED WATER SUPPLY			SUPPLY DUCT UP	<del></del>	<del>-</del>		1	Taxa-	lees:
<u> </u>	TF	TRANSFER FAN	CHWR		CHILLED WATER RETURN			SUPPLY DUCT DOWN	-			3EAL	SCALE AS NOTED	
-	TSP .	TOTAL STATIC PRESSURE	— cws —	_	CONDENSER WATER SUPPLY		· –	RETURN DUCT UP	-			 ⊣u	DATE 1/31/14	DRAWN
_	TYP	TYPICAL	CWR	_	CONDENSER WATER RETURN		<u> -</u>	RETURN DUCT DOWN			<u>'</u> –		DRAWING NO.	1
_	U.O.N.	UNLESS OTHERWISE NOTED	D	-	DRAIN			TRANSITION FROM SQUARE TO ROUND DUCT			<u> </u>		M-00	<b>)1</b> ()
	UV-	UNIT VENTILATOR	v <u></u>		VACUUM LINE			TRANSITION	_		_	H		PAG
	WB	WET BULB TEMPERATURE	— FOS —		FUEL OIL SUPPLY	F   D-+   1	<del> </del> _	DUCT DROP	_		-	NYC DOB N	MBER	
_		INCHES OF WATER GAUGE	FOR —	+	FUEL OIL RETURN		-	DUCT RISE			_	71		
	, WG													

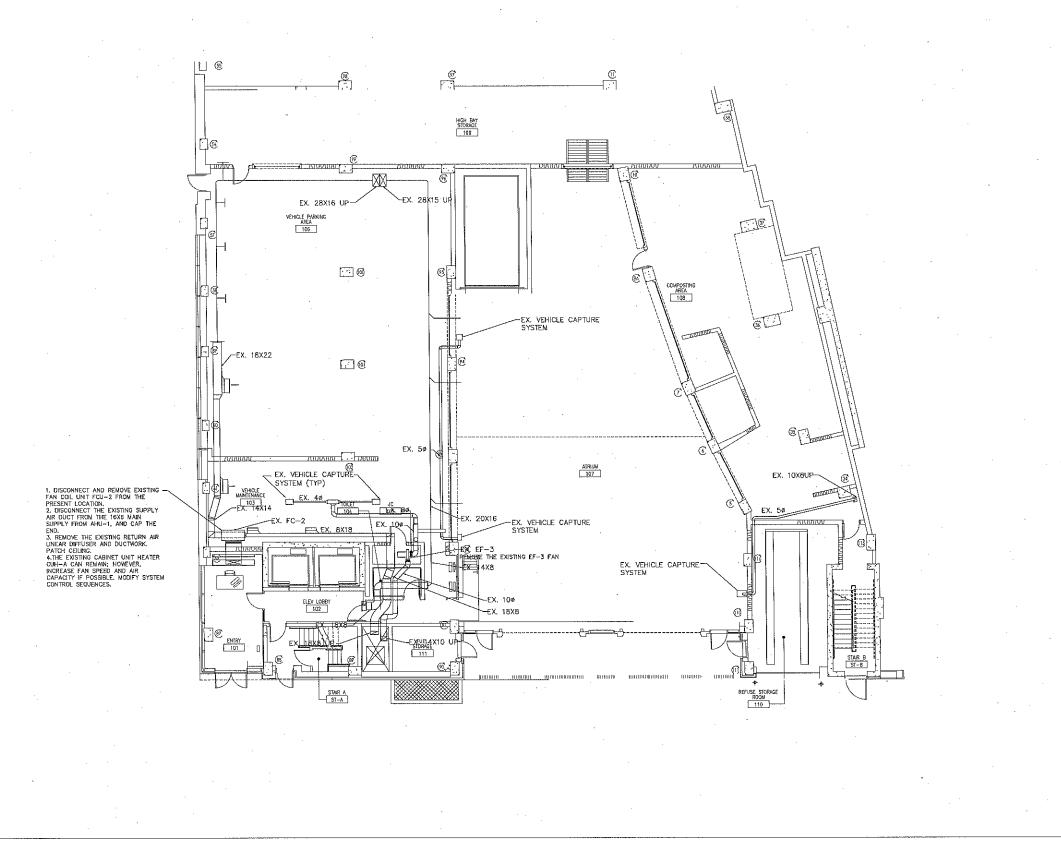




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BPCPC MAINTENANCE FACILITY SITE 3 MECHANICAL SYSTEMS UPGRADE

DRAWING TITLE

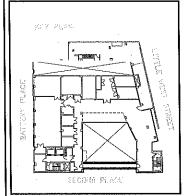FIRST FLOOR MECHANICAL DEMOLITION PLAN
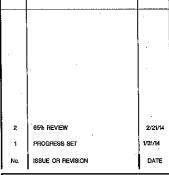
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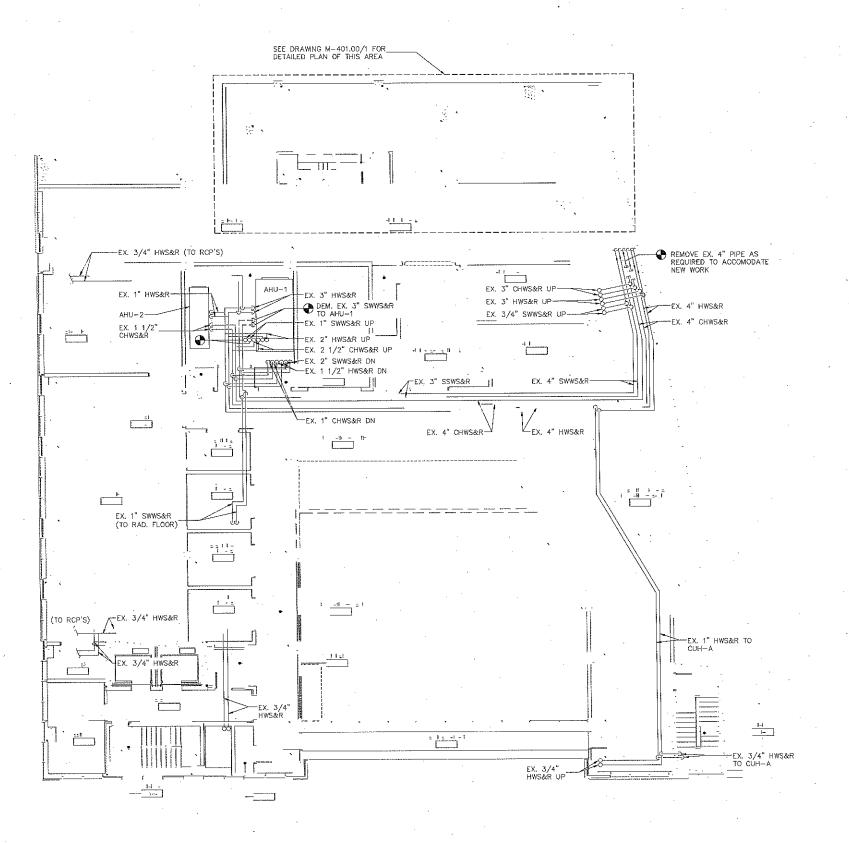
SCALE PROJECT NO.
AS NOTED NBPC0002,00
DATE DRAWN-/CHK BY
1/31/14 KS/JK

M-101.00

NYC DOB NUMBER

AVCON Engineering PC

1ST FLOOR MECHANICAL DEMOLITION PLAN SCALE: 1/8" = 1'-0"








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1 PROGRESS SET 1/31/4
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SECOND FLOOR MECHANICAL DEMOLITION PLAN

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1/31/14
DRAWING NO.

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DRYING RM 303 PREP/ART SUPPLY JON JON ST-A REC STORAGE VEROM EX. EF-3
TO EX EF-2 CIRCULATION—WEST THIRD FLOOR MECHANICAL DEMOLITION PLAN CIRCULATION - NORTH STORACE/ CIRCULATION
320 AMCOM Engineering Pc BATTERY PLACE KEY PLAN 86% FIEWEW

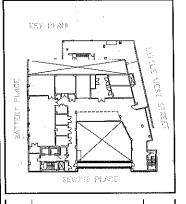
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AS NOTED NBPC000200
DATE DRAWN/CHK BY
1/31/14 KS/JK M-103.00

THIRD FLOOR MECHANICAL DEMOLITION PLAN

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SITE 3 MECHANICAL SYSTEMS UPGRADE

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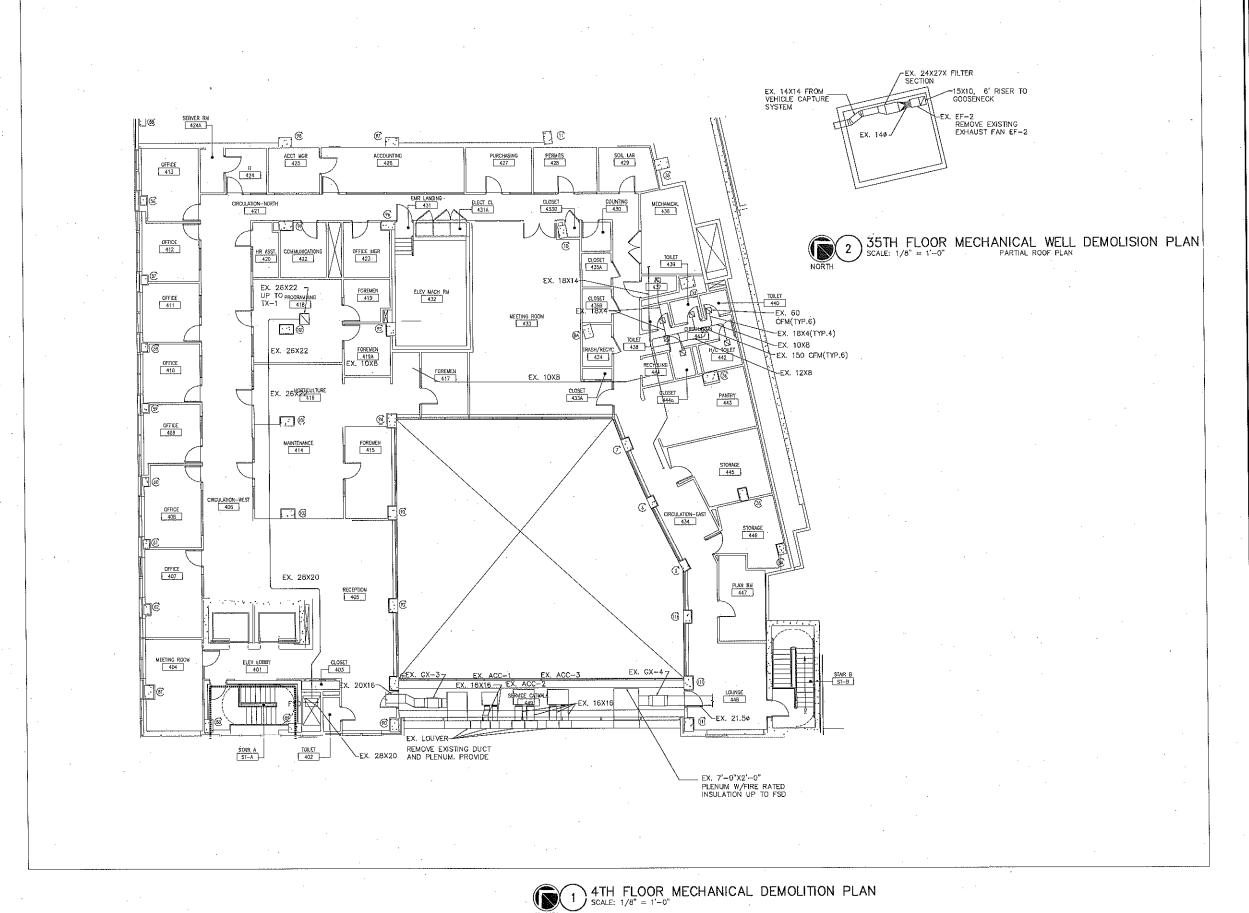
ISSUE OR REVISION PROGRESS SET DATE 1/31/14 2/21/14

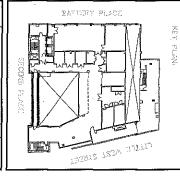

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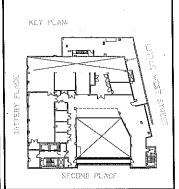
OLA Consulting Engineers 50 Broadway Hawthorne New York 10532 914,747,2800 olace.com






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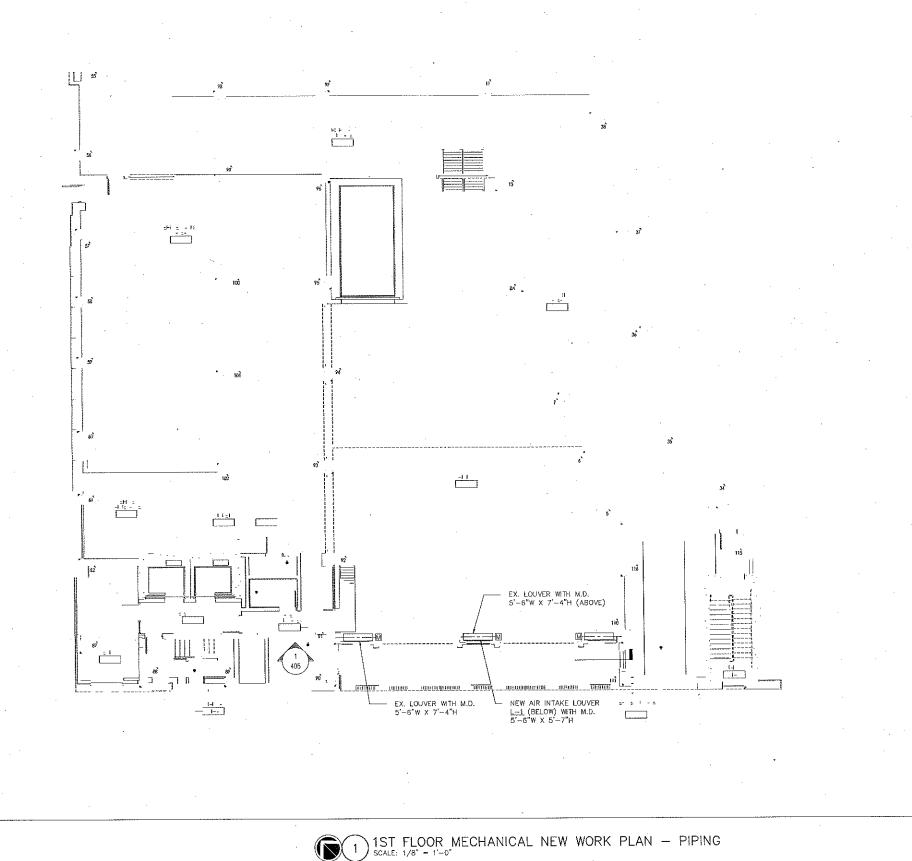


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FOURTH FLOOR MECHANICAL DEMOLITION PLAN

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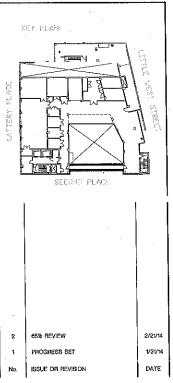
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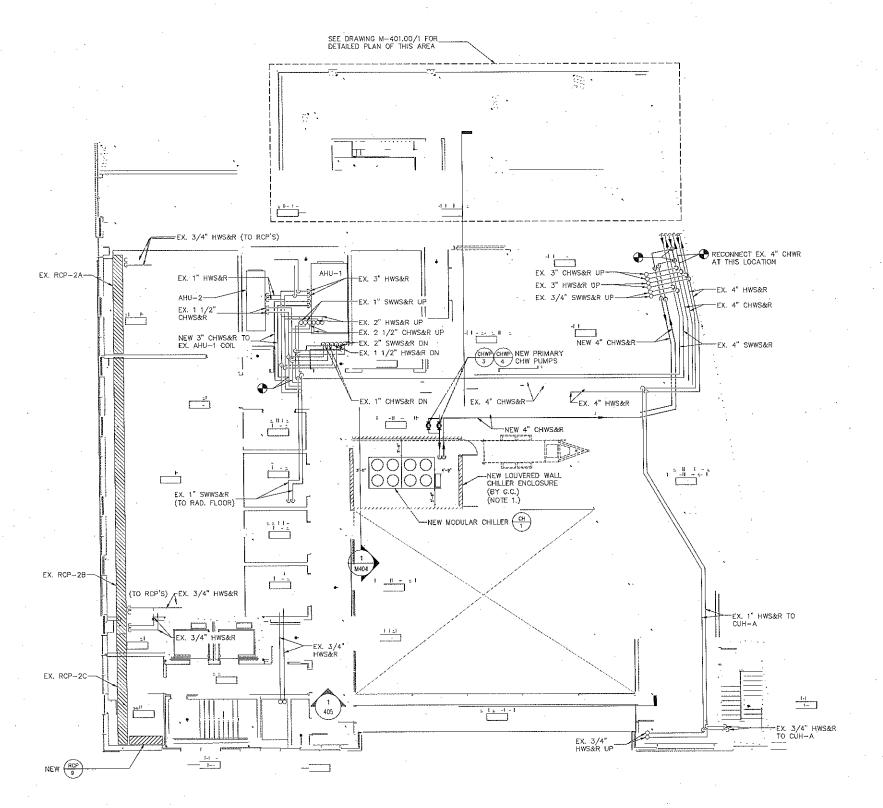
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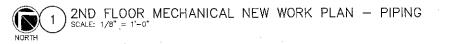
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DATE DRAWN/CHK BY KS/JK
DRAWING NO.
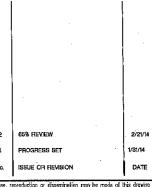
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| PAGE 9 OF 3







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SECOND FLOOR MECHANICAL NEW WORK PLAN PIPING

SEAL.


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AS NOTED NBPC000200
DATE V31/14
DRAWN/CHK BY
KS/JK

M-202.00

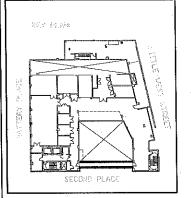PAC

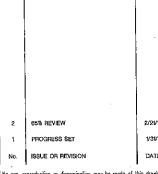NOTES:

1. THE ACOUSTICAL ENCLOSURE SHALL BE DESIGNED WITH PANELS THAT CAN YIELD A MINIMUM STC 35 RATING, SUCH AS THE TYPE H/P 38 QUIETMOP PANELS BY NOISE BARRIERS, LLC. DOORS AND VENTILATION OPENINGS SHALL BE DESIGNED WITH THE APPROPRIATE NOISE CONTROL MEASURES SO AS TO MAINTAIN THE ACOUSTICAL PERFORMANCE OF THE ENCLOSURE

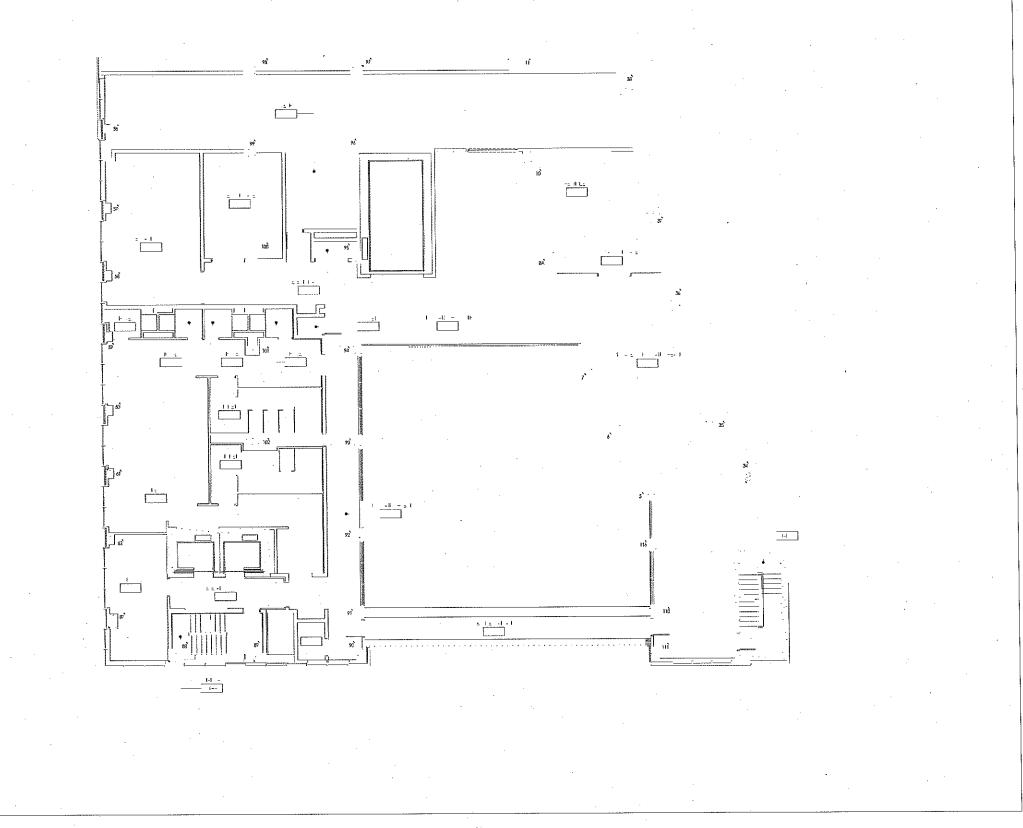





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DRAWING TITL

THIRD FLOOR MECHANICAL NEW WORK PLAN


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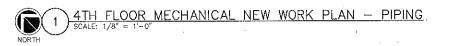
SCALE PROJECT NO.
AS NOTED NBPC0002.00
DATE DRAWN/CHK BY
KS/JK

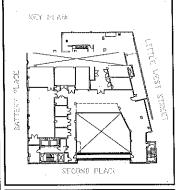M-203.00

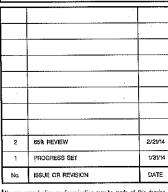DOB NUMBER

3RD FLOOR MECHANICAL NEW WORK PLAN - PIPING




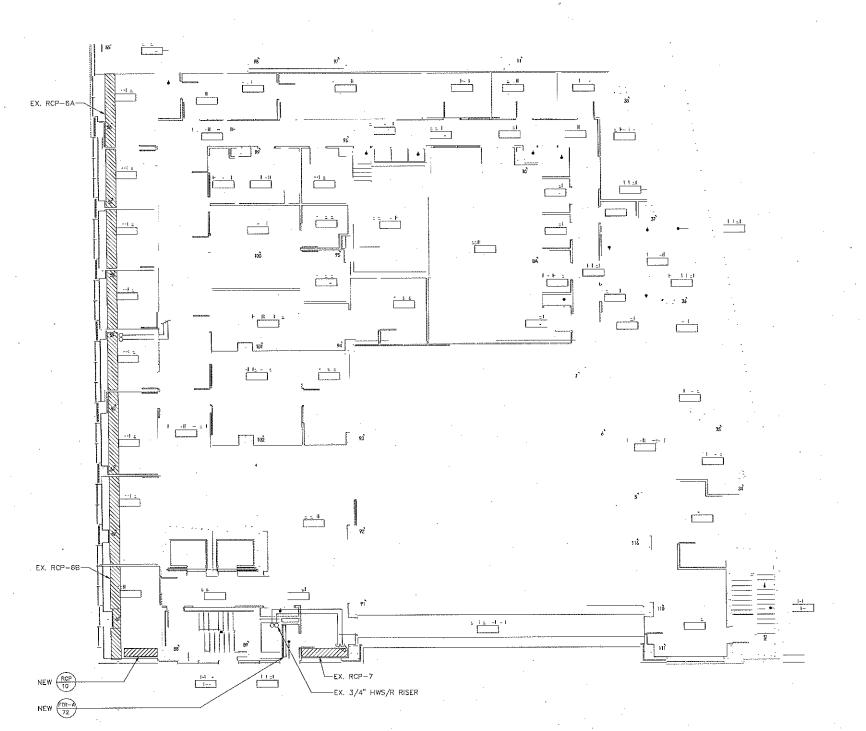



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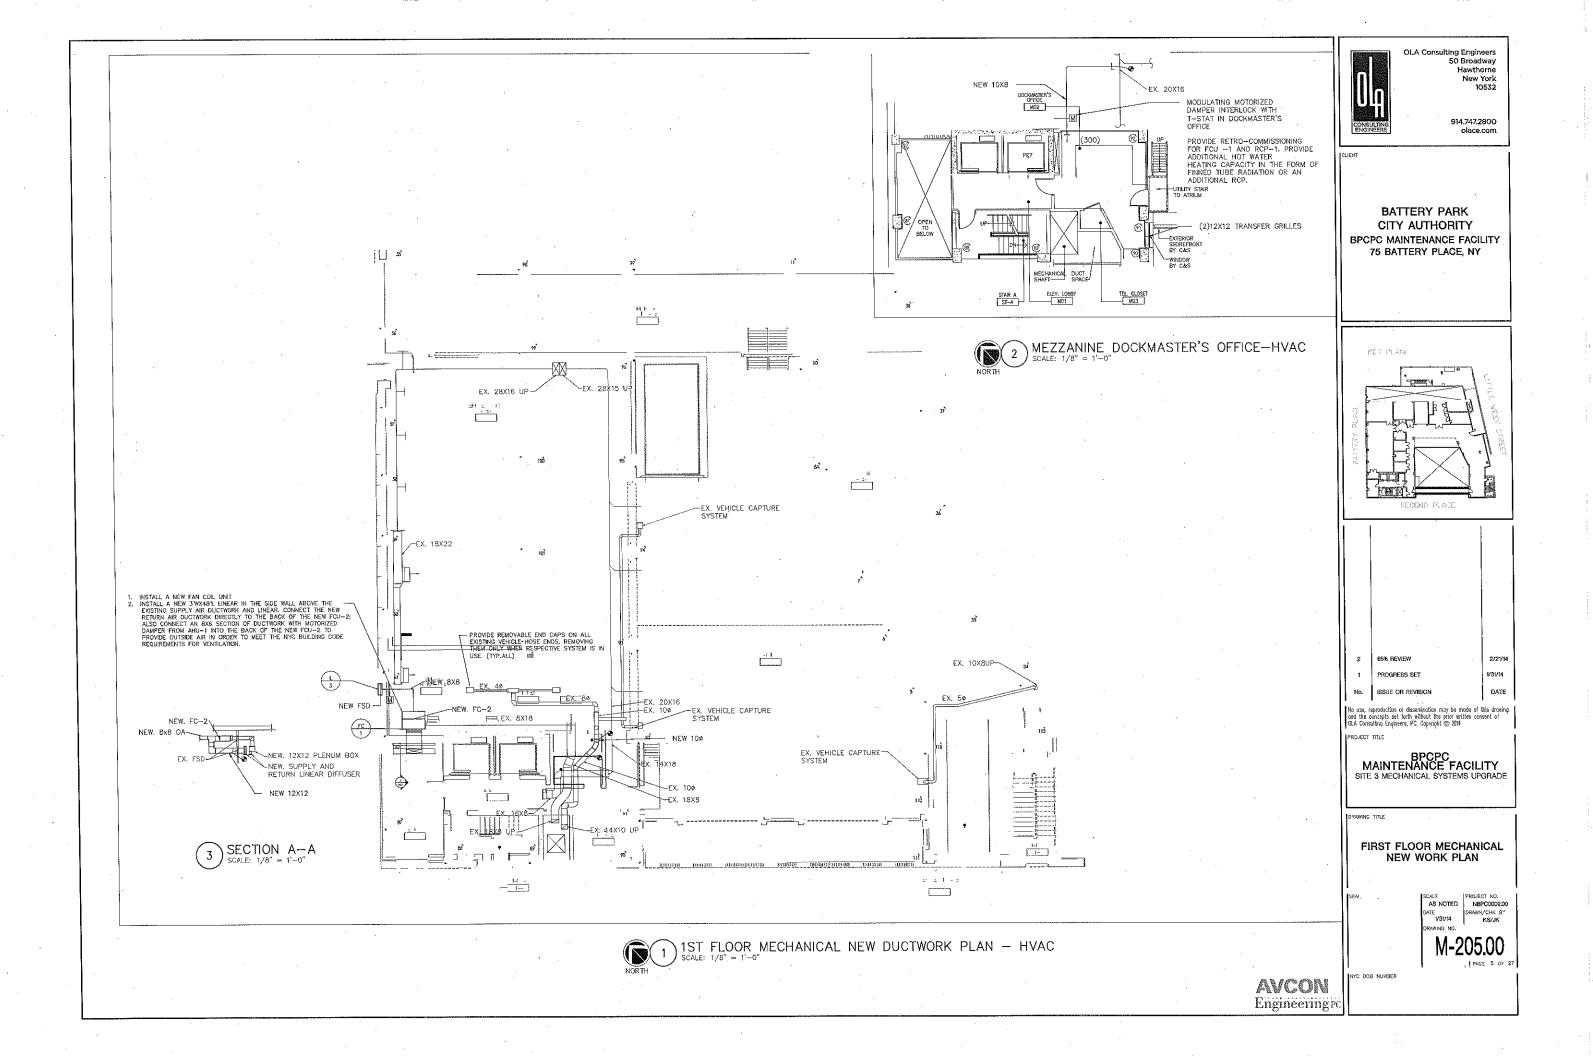
PROJECT 1


BPCPC MAINTENANCE FACILITY SITE 3 MECHANICAL SYSTEMS UPGRADE

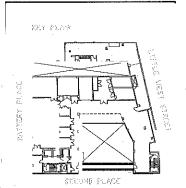DRAWING TIT

FOURTH FLOOR MECHANICAL NEW WORK PLAN

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	DATE 1/31/14 DRAWING NO.	DRAWN/CHK BY K8/JK
SEAL	AS NOTED	PROJECT NO. NBPC0002.00



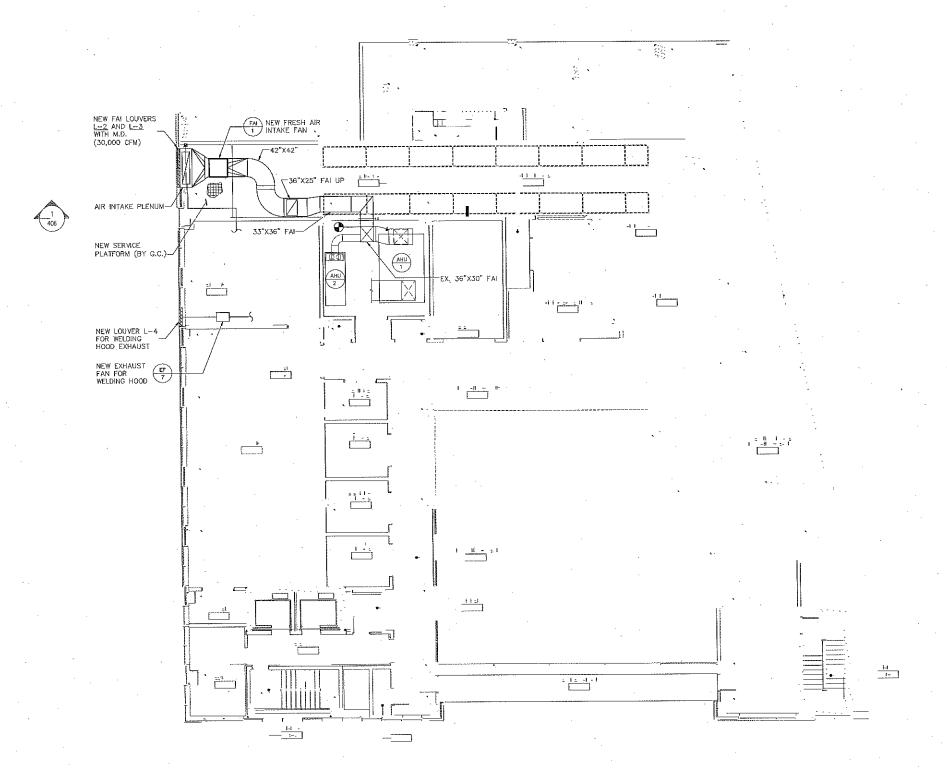



1. REFER TO M-206.01 FOR ADDITIONAL WORK ON THIS FLOOR

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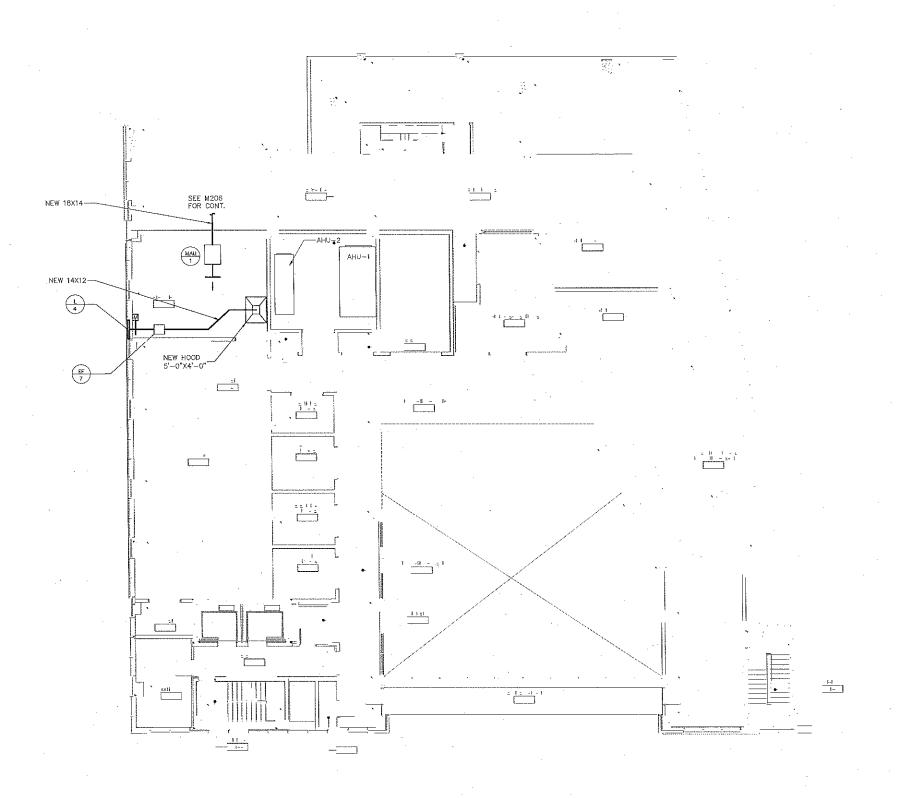
BPCPC MAINTENANCE FACILITY SITE 3 MECHANICAL SYSTEMS UPGRADE

SECOND FLOOR MECHANICAL NEW DUCTWORK PLAN

SCALE PROJECT NO.
AS NOTED NBPC0002.00 DATE 1/31/14 DRAWING NO.

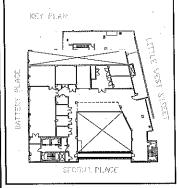M-206.00

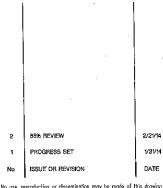2ND FLOOR MECHANICAL NEW DUCTWORK PLAN SCALE: 1/8" = 1'-0"



2ND FLOOR MECHANICAL NEW DUCTWORK PLAN - HVAC




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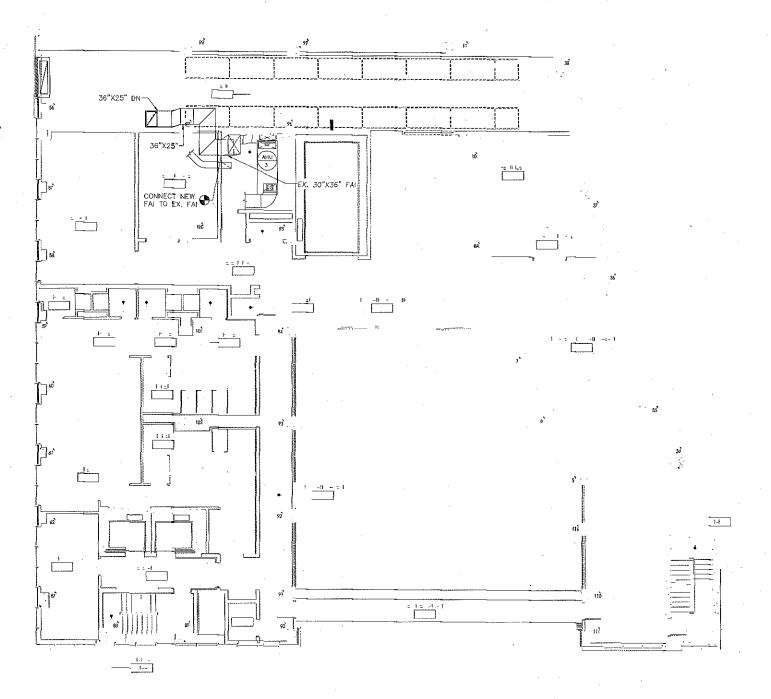
SECOND FLOOR MECHANICAL NEW WORK PLAN PIPING

SCALE
AS NOTED
DATE
1/31/14
PROJECT NO.
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DRAWN/CHK BY
KS/JK

M-206.01

NYC DOB NUMBER

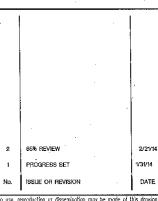AVCON Engineering to



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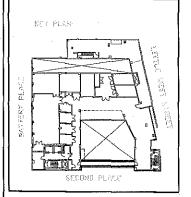
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THIRD FLOOR MECHANICAL NEW DUCTWORK PLAN


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DATE 1/31/14 RS/JK
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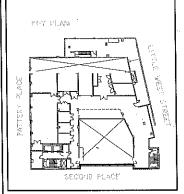
3RD FLOOR MECHANICAL NEW DUCTWORK PLAN





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THIRD FLOOR MECHANICAL NEW WORK PLAN

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AS NOTED NBPC0002.00
DATE PROJECT NO.
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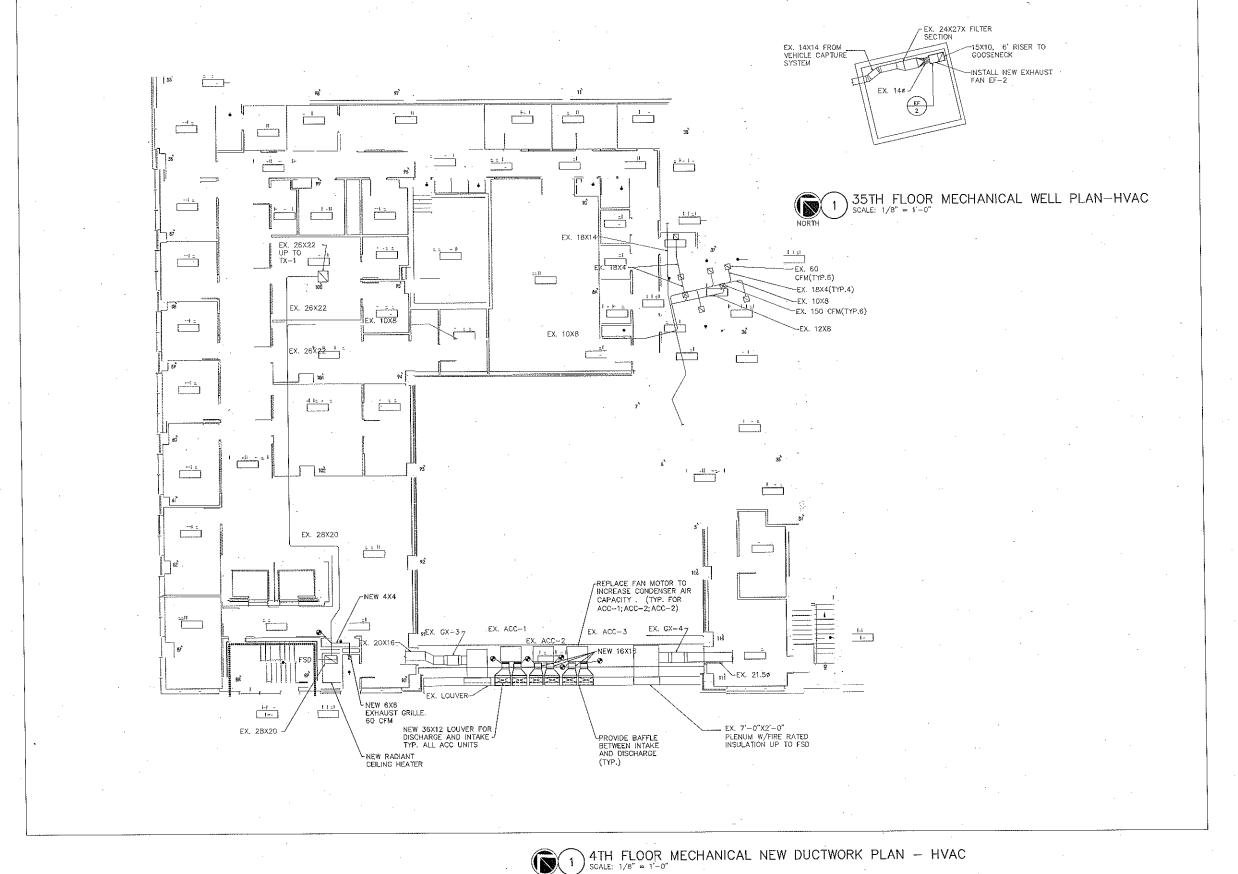
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βs. \_\_\_\_<u>;</u> --1) 4TH FLOOR MECHANICAL NEW DUCTWORK PLAN NORTH 1. REFER TO M-208.01 FOR ADDITIONAL WORK ON THIS FLOOR BATTERY PARK
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BPCPC MAINTENANCE FACILITY
75 BATTERY PLACE, NY FOURTH FLOOR MECHANICAL NEW DUCTWORK PLAN BPCPC
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SITE 3 MECHANICAL SYSTEMS UPGRADE MEINEH 1698 PROGRESS SET SOLLE PROJECT NO.
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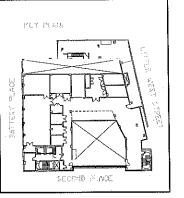
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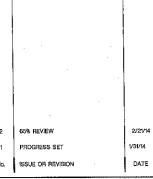


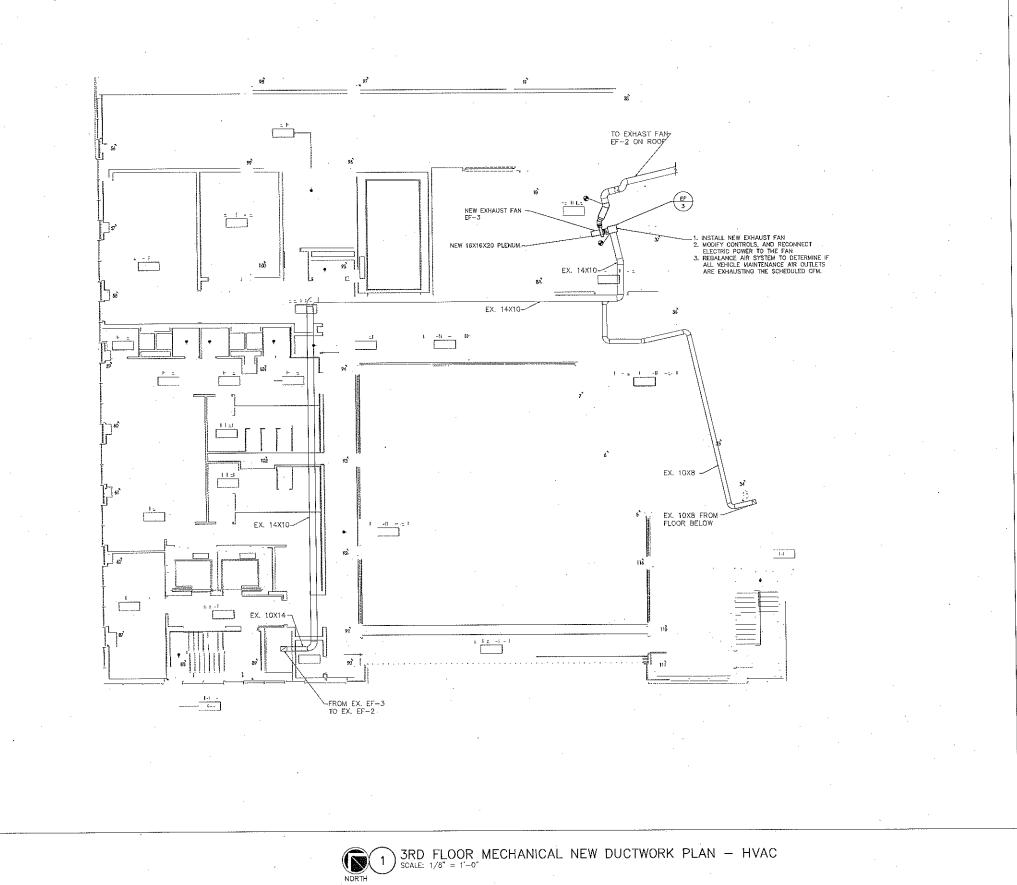

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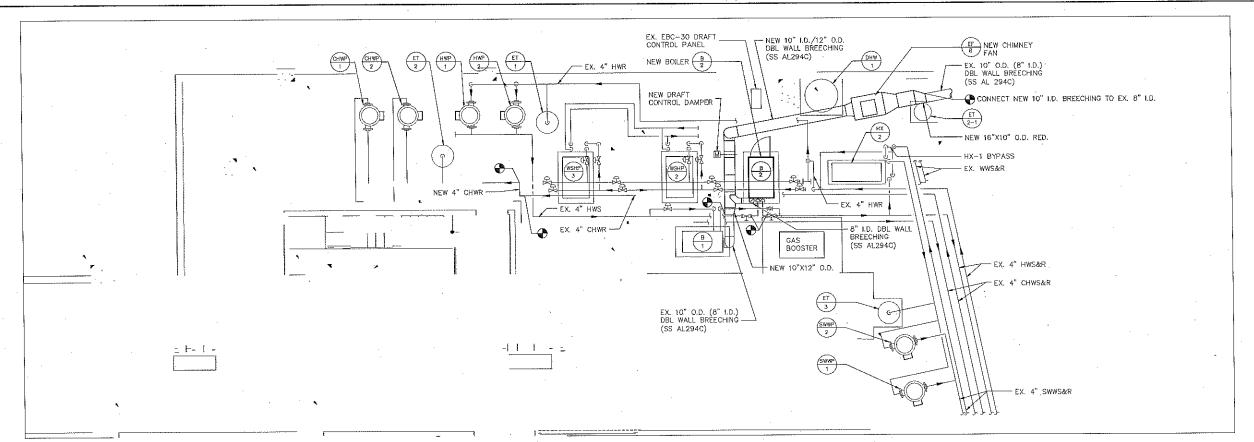
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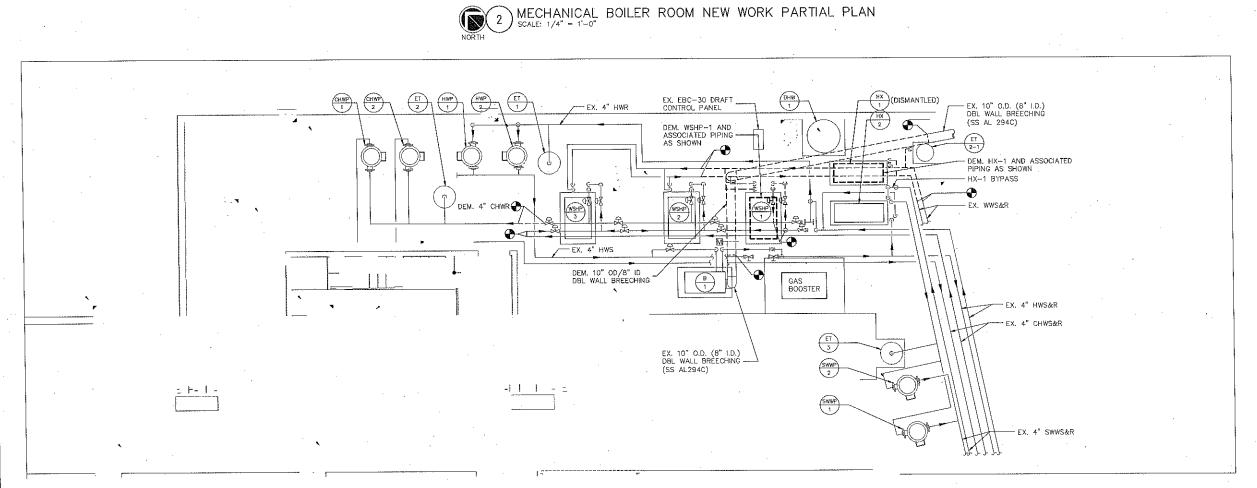
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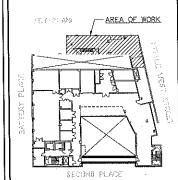


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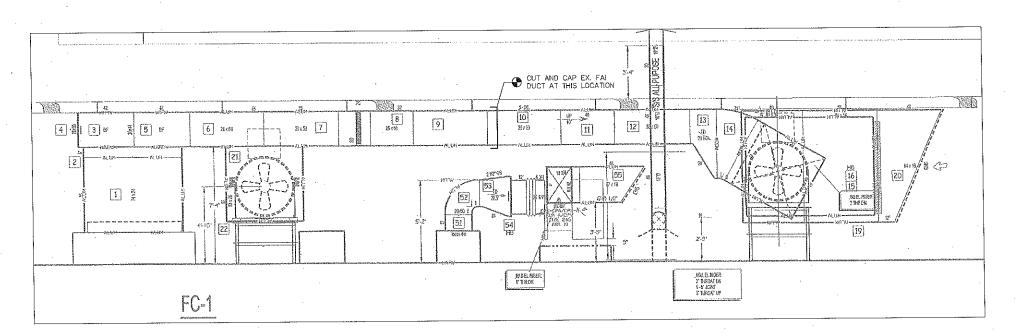
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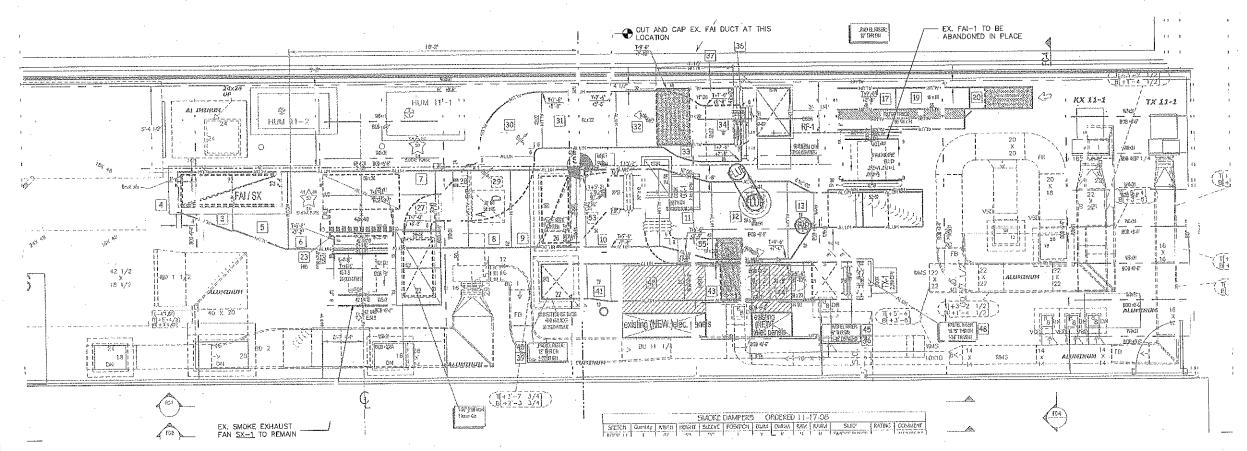
MECHANICAL BOILER ROOM DEMOLITION AND NEW WORK PARTIAL PLANS

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MECHANICAL BOILER ROOM DEMOLITION PARTIAL PLAN








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MAINTENANCE FACILITY


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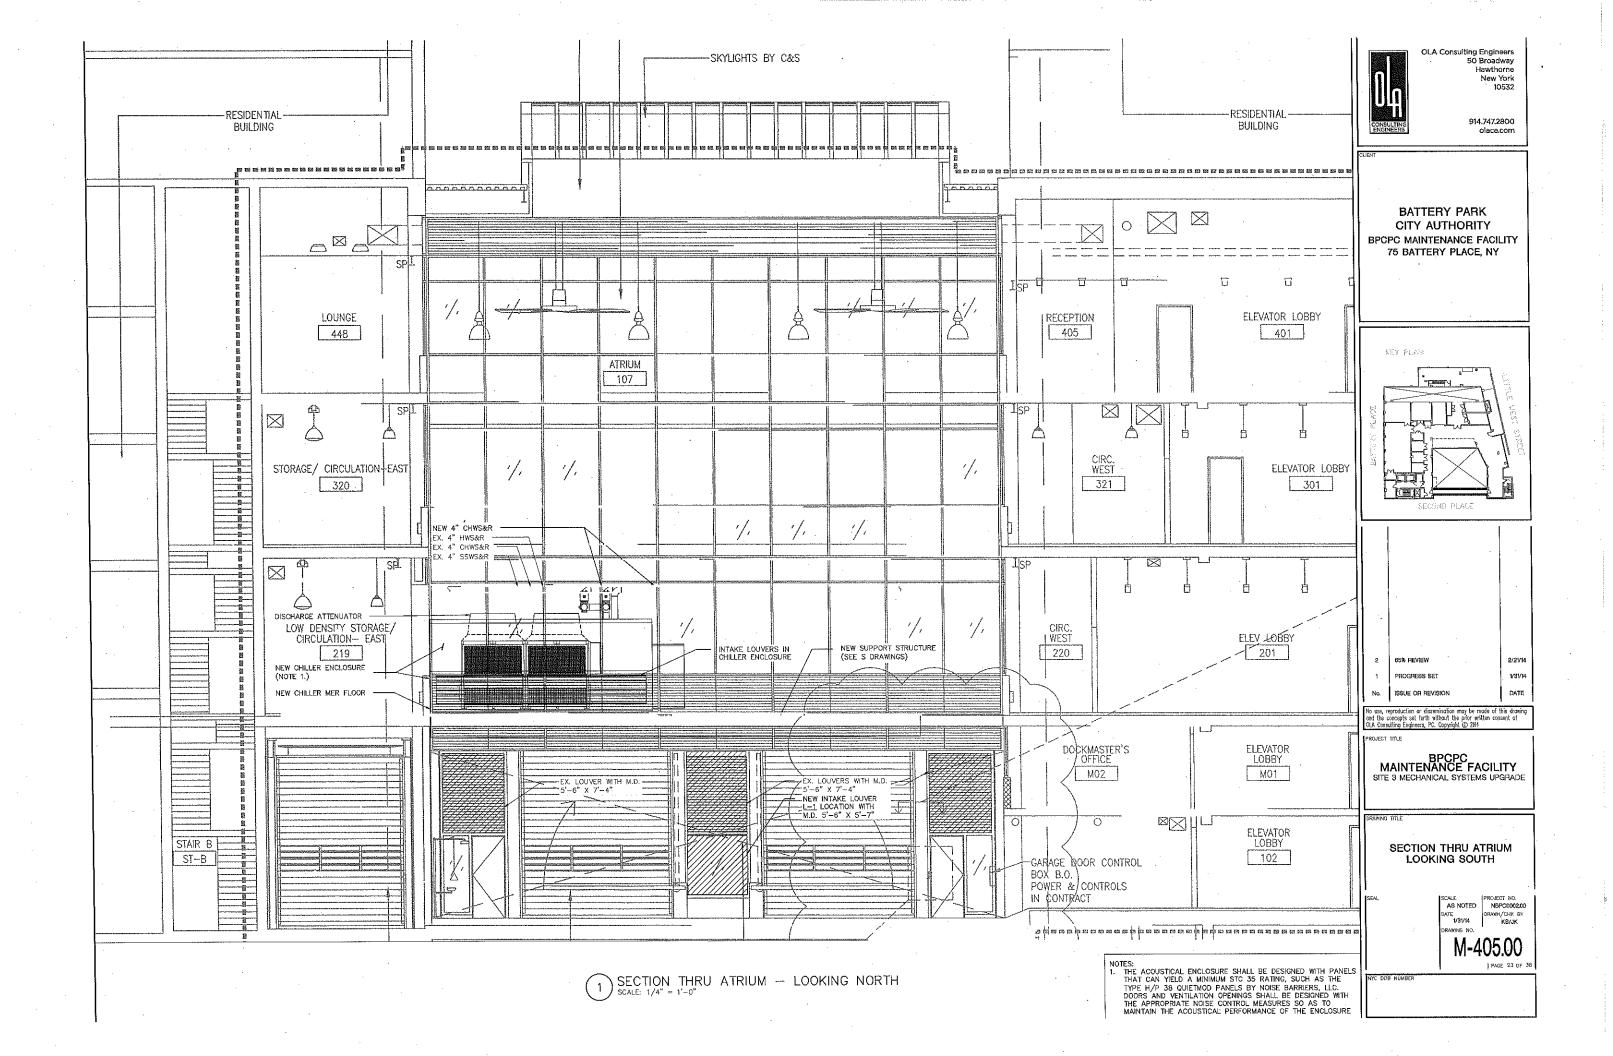
11TH FLOOR FAN ROOM MECHANICAL NEW WORK PLAN


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		PROJECT NO.

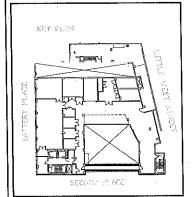
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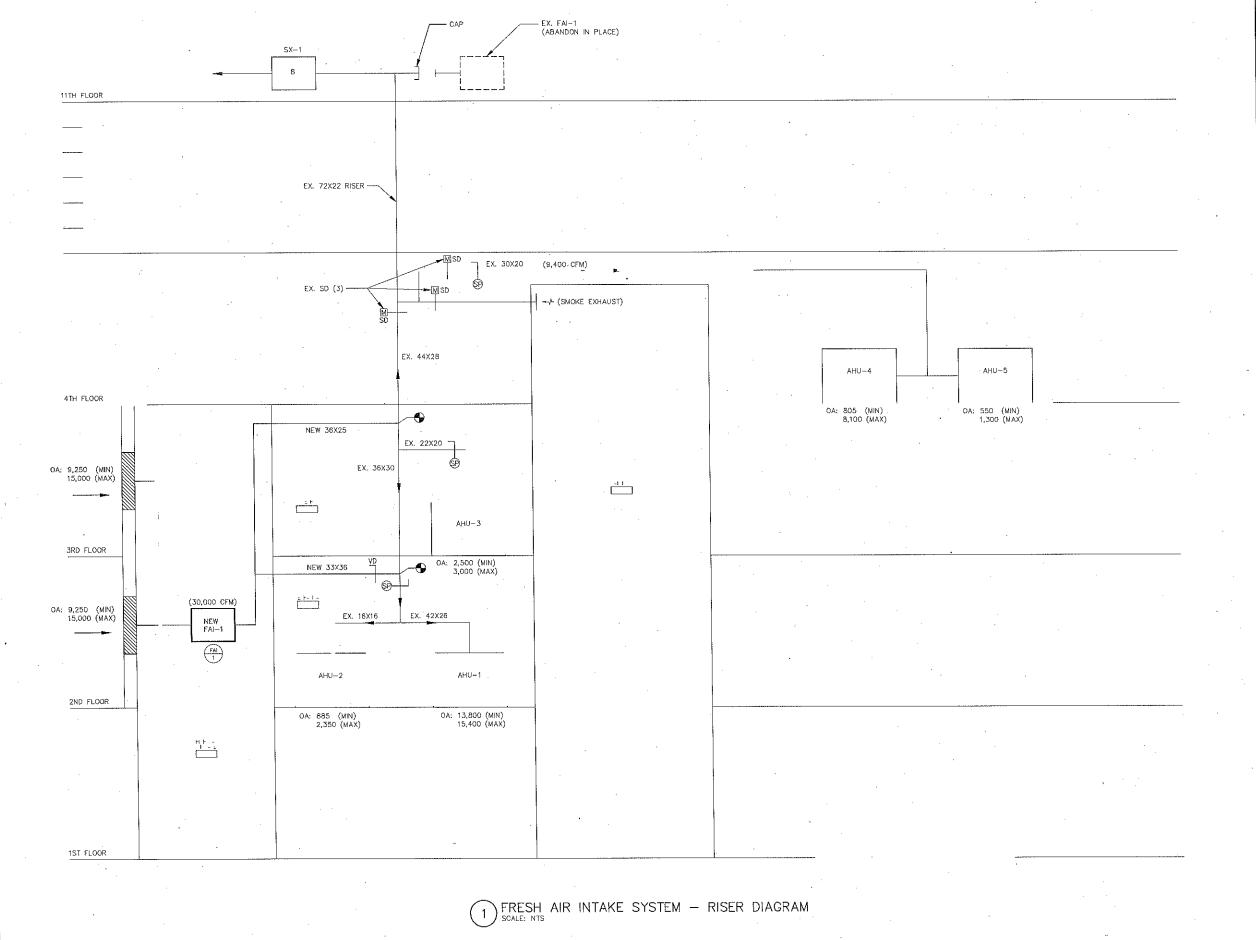
11TH FLOOR FAN ROOM MECHANICAL NEW WORK PLAN





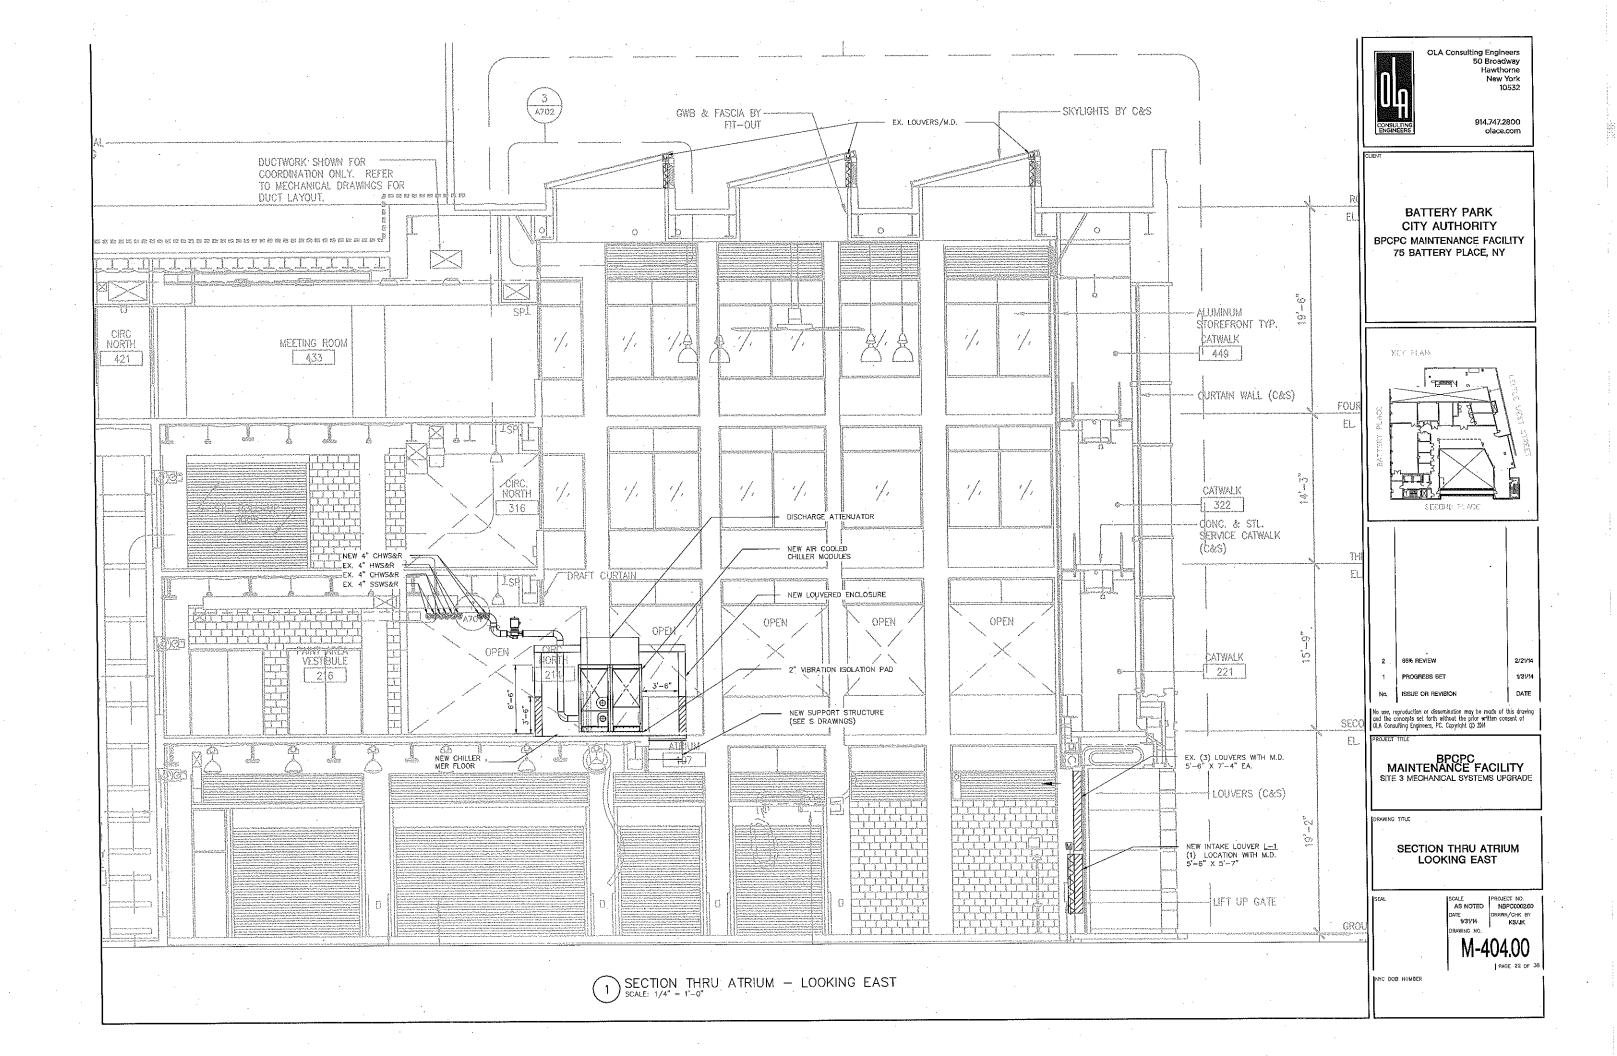

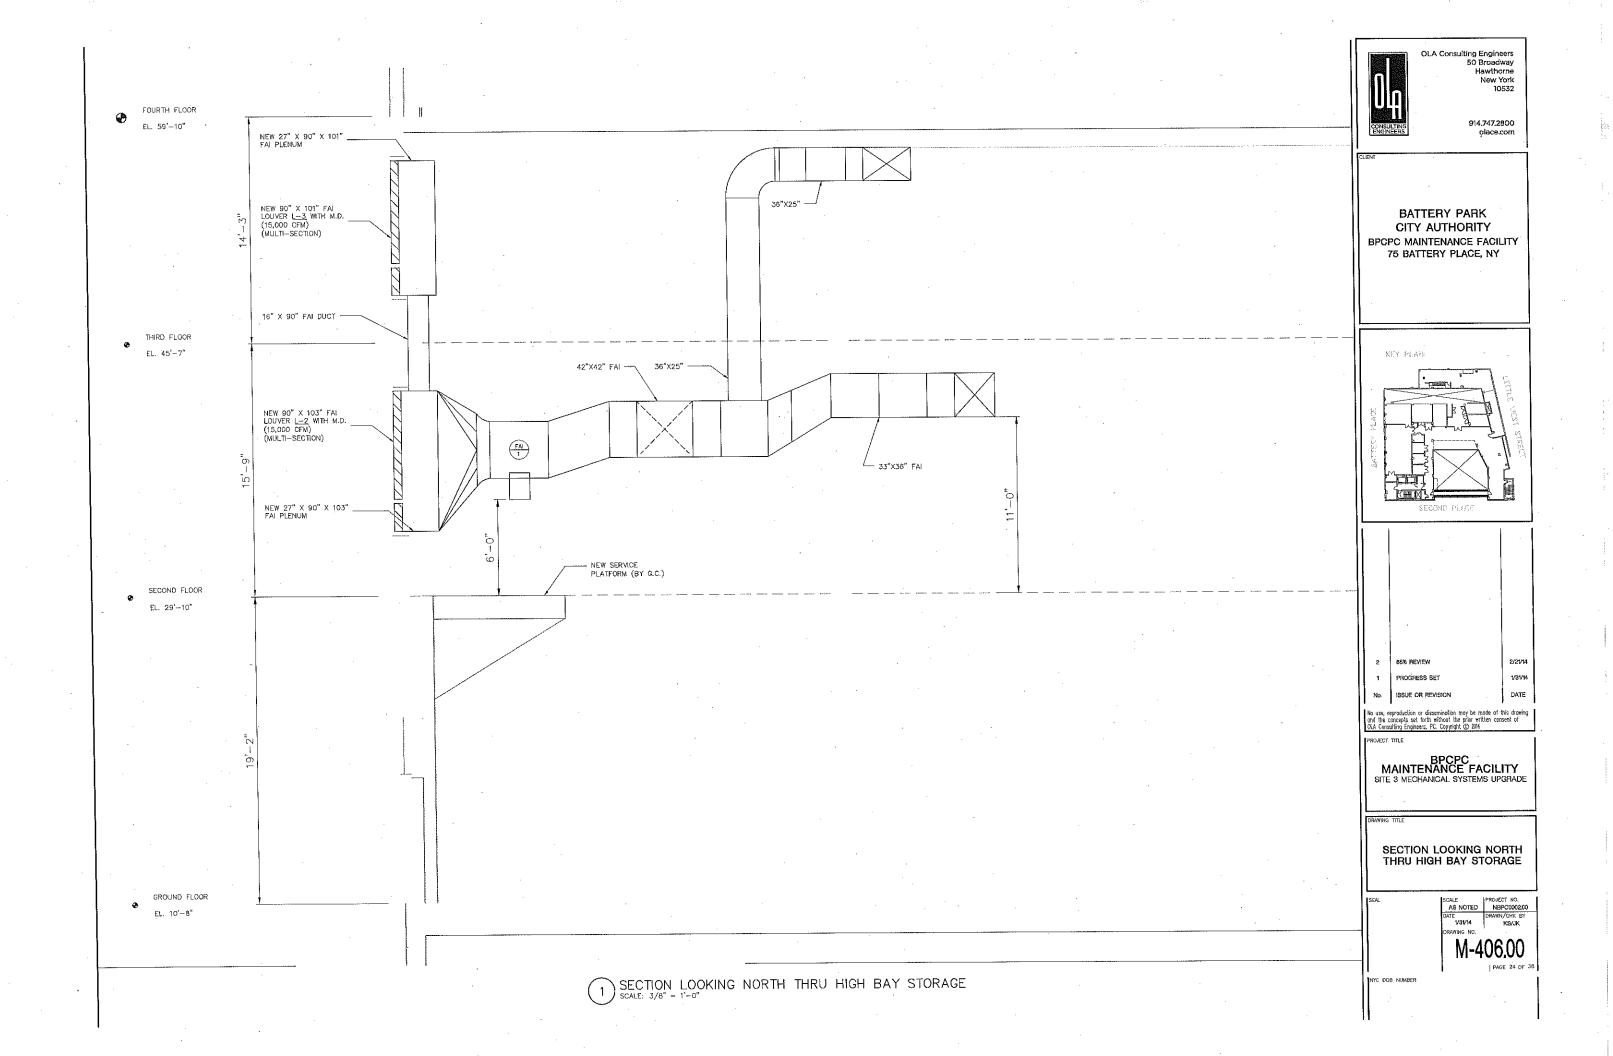


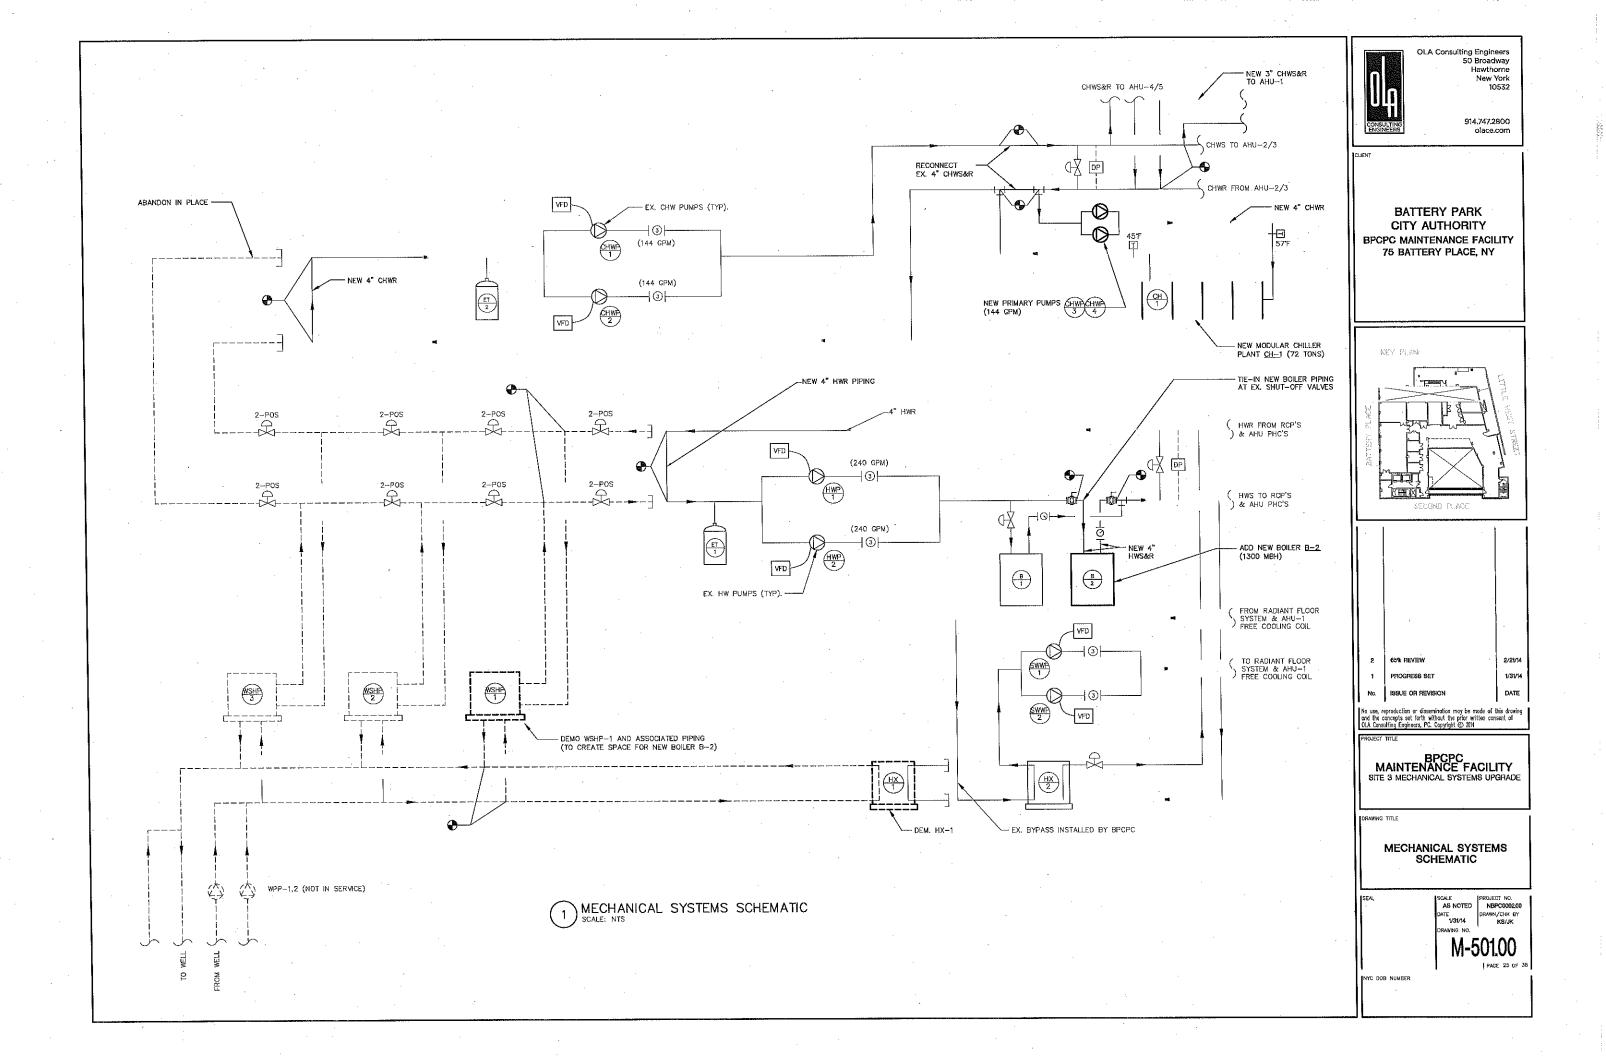



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2/21/14

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FRESH AIR INTAKE SYSTEM RISER DIAGRAM

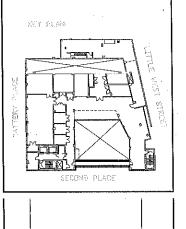	DRAWING NO.	02.00
	DATÉ 1/31/14	DRAWN/CHK BY KS/JK
SEAL,	SCALE AS NOTED	PROJECT NO. NBPC0002.00

# AIR COOLED PACKAGED CHILLER SCHEDULE

Office Lit 0	OI ILDULL
DESIGNATION	CH−1
LOCATION	2ND FL
NOMINAL CAP. (TONS)	71.7
MODEL	(4) ASP020X
TYPE	MODULAR SCROLL
NO. OF MODULES	4
EER .	8.3
NPLV (KW/TON)	0.845
REFRIGERANT TYPE	R-410A
REFRIGERANT CHARGE (LBS)	100 PER MODULE
LXWXH(IN)	144 X 72 X 77.32
DRY/OPERATING WEIGHT (LBS)	6800/7300
EVAPORATOR:	
GPM	144
E.W.T./L.W.T. (*F)	57/45
W.P.D. (FT H₂O)	4.15
MINIMUM FLOW	144
COMPRESSOR:	
QUANTITY	2 PER MODULE (8 TOTAL)
NOMINAL TONS (EA.)	10
TYPE	SCROLL
COMPRESSOR RLA (PER COMPRESSOR)	. 35
COMPRESSOR LRA. (PER COMPRESSOR)	
CONDENSER:	
COIL TYPE	AL/CU
DESIGN OUTDOOR AIR TEMP T	105
No. OF CIRCUITS	
FANS:	
QUANTITY	2 PER MODULE
H.P. (EA.)	2
VOLTS/ø/Hz	208/3/60
MCA	348
MAX FUSE AMPS	400

- 1. UNITS BASED ON MULTISTACK.
  2. FURNISH AND INSTALL VIBRATION ISOLATORS AS PER THE SPECIFICATION FOR EACH CHILLER AS FURNISHED BY THE MANUFACTURER.
  3. CHILLERS SHALL BE EQUIPPED WITH THE FOLLOWING.

NOTES:

- CHILLERS SHALL BE EQUIPPED WITH
  THE FOLLOWING:

   CHILLED WATER RESET

   LOSE OF CHILLED WATER FLOW
  SENSOR

   GAUGES

   MULTISTACK MICROPROCESSOR
  CONTROLS

	BOILED.			
HOT WATER BOILER				
SCHEDU				
DESIGNATION	B-1			
LOCATION	2ND FL MER			
MODEL	BMK			
UNIT SIZE	1500			
OUTPUT (MBH)	1305-1425			
MAX GAS PRESSURE	14"			
MIN GAS PRESSURE	4"			
MAX ALLOWED WORKING PRESSURE	160 PSIG			
WATER CONNECTIONS (FLANGED)	4"			
MIN WATER FLOW (GPM)	25			
MAX WATER FLOW (GPM)	250			
W.P.D.	3.0 PSIG @ 170 GPM			
EWT/LWT ('F)	-/160			
LXWXH(IN)	28 X 43.6 X 78			
DRY/OPERATING WEIGHT (LBS)	27/32			
GAS BURNER:	•			
MAX INPUT (MBH)	1500			
EFFICIENCY (%)	87-99			
NPT	1.5"			
ELECTRICAL DATA:				
VOLTS/ø/Hz	120/1/60			
FLA	16A			
NOTES:				

PUMP SCHEDULE					
CHW-3	CHW-4				
2ND: FL	2ND FL				
CH-1 CHW	CH-1 CHW				
80	80				
3X3X7B	3X3X78				
144	144				
WATER	WATER				
57	57				
25	25				
1750	1750				
4.5	4.5				
1.41/2.00	1.41/2.00				
208/3/60	.208/3/60				
VFD	VFD				
2ND FL	2ND FL				
ED ON BELL AI UMP SPECIFICA TRUCTION AND TS. SHALL BE PF	ATIONS FOR ADDITIONAL				
	CHW-3 2ND-FL CH-1 CHW 80 3X3X78 144 WATER 57 25 1750 4.5  1.41/2.00 208/3/60  VFD 2ND FL CD ON BELL AL DIMP SPECIFIC/RUCTION AND TS.				

STARTER/DISCONNECT SWITCH OR VFD PER THE SPECIFICATIONS.

NO LES:					
	SED ON AERCO.				
	DILERS WITH 100 PS				
	LVES, 3-1/4" PRES	SSURE			
	ERATURE GAUGES,	.	•		
	C RESET HIGH LIMIT				
	, MANUAL RESET H ASTAT. LOW WATER				
	AQUASTAT FOR SUF				
	MPERATURE CONTRE				
III/ILIŞ ILI	MI LIVITONE CONTIN				
		FAN SCH	IEDIN E		•
		FAIT OUR	IEDULE		
DESIGNATION	FAI−1	FAI−2	EF-7	RAF4	EF-3
	2ND/3RD FL	2ND/3RD FL	2ND FL	(THE HER	700 E
LOCATION	HIGH BAY AREA	HIGH BAY AREA	METALSHOP	4TH FL MER	3RD FL
		i .		l	

		FAN SCH	EDULE		
DESIGNATION	ĖAI−1	FAI−2	EF-7	RAF-4	EF-3
LOCATION	2ND/3RD FL HIGH BAY AREA	2ND/3RD FL HIGH BAY AREA	2ND FL METALSHOP	4TH FL MER	3RD FL
AREA SERVED	FAL SYSTEM		METAL SHOP		
MODEL.	VAB42F17-l-20		BDF9010		
CFM	30000	4000	1800	8000	
BHP	_		0.82		
HP	20	2	1	2	10
RPM	1261				
SP (IN H <sub>2</sub> O)	2.0		1.2		
VOLTS/Ø/Hz	208/3/60	208/3/60	208/3/60	208/3/60	208/3/60
STARTER TYPE	VFD	HOA	HOA	VFD	HOA
INTERLOCK			MAU-1		

- 1. FANS BASED ON GREENHECK.
  2. ALL MOTORS SHALL BE PREMIUM EFFICIENCY
  3. FURNISH MOTOR STARTIERS AND DISCONNECT SWITCHES FOR EACH FAN
  4. FURNISH MOTOR AND BELT GUARD FOR ALL EXTERNAL MOTOR DRIVES
  5. FURNISH RUBBER IN SHEAR OR SPRING VIBRATION ISOLATORS AS PER THE SPECIFICATION

LOUVER SCHEDULE					
DESIGNATION	L1	L2	L-3	L-4	L-5
LOCATION	1ST FL	2ND FL HIGH BAY AREA	3RD FL HIGH BAY AREA	METAL SHOP 211	1ST FL
AREA/SYSTEM SERVED	ATRIUM	FAL	FAI	WELDING EXHAUST	FCU-2
MODEL	(TBD)	(TBD)	(TBD)	ELF375D	ELF375D
DIMENSIONS	5'-6" X 5'-7"	7'-6" X 8'-7"	7'-6" X 8'-5"	2'-8" X 1'-4"	1'-0" X 1'-0"
FINISH			Ü		
COLOR					
1. h on behalf do					

FIELD CONDITIONS.

5. PROVIDE 16 GUAGE METAL ENCLOSURES
OPTION.

6. PROVIDE CIRCUIT SETTERS SIZED FOR FLOW
AND NOT LINE SIZE.

7. BTU/LF BASED ON 70F EAT, 30% PG, AND
MIN. FLOW RATE OF 0.25 FPS

- 1. LOUVERS BASED ON GREENHECK.
  2. COORDINATE EXACT LOUVER SIZE WITH ARCHITECTURAL PLANS AND WITH WALL OPENINGS IN THE FIELD.
  3. CUSTOM COLORED LOUVERS SHALL BE SELECTED BY OWNER. SUBMIT COLOR CHART FOR
- 5. OUSTIMM COLORED COVERS SHALL BE SELECTED BY OWNER. SOBWIT COLOR GRAFT FOR REVIEW.

  4. FURNISH 1/2" GALVANIZED BIRD SCREEN FOR ALL LOUVERS.

  5. BLANK OFF UNUSED SECTIONS OF LOUVERS WITH SHEET METAL PANELS. PAINT PANELS TO MATCH LOUVER AND INSULATE WITH 1" RIDGED BOARD INSULATION.

### RADIANT CEILING PANEL FINNED TUBE RADIATION SCHEDULE **COMEDITIE**

SCHEDUL	_E	SCHEL	JULE
DESIGNATION	FTR-A	DESIGNATION	RCP-9
MODEL .		PERFORMANCE DATA:	
NOMINAL TUBE SIZE		ROOM AIR (T) DB	
FIN SIZE		OUTPUT (BTU/HR/SF)	
FIN THICKNESS		LENGTH (FT-IN)	
FINS PER L.F.		' '	
TUBE/FIN MATERIAL		MEAN TEMP (F)	
No. OF ROWS		WATER GPM	
FLUID (% PG)		WP.D. (FT H₂O)	
AVG WATER TEMP (F)		CONSTRUCTION DATA:	
BTUH PER L.F. (NOTE 7)		TUBE MATERIAL	
STYLE		TUBE DIAM (IN.)	
ENCLOSURE HT. (IN)		PANEL MATERIAL	
MOUNTING HT. (IN)		PANEL SIZE (IN.)	
NOTES:		PANEL THICKNESS (IN.)	
FINNED TUBE RADATION BA     FURNISH ALL REQUIRED PIR		TYPE	
ENCLOSURE SUPPORTS, BR.	ACKET FASTENERS,	NOTES:	
ETC. FURNISH VALVE ACCE			
"KNOCK OUTS" FOR ELECTIFICATION OF THE STAND CAPS AND C			
ENCLOSURES CONTINUOUS		· ·	
FINISH SHALL BE BAKED EI			
3. SUBMIT COLOR CHART FOR	REVIEW AND	i	
APPROVAL BY OWNER.  4. COORDINATE ALL MOUNTING	G HEIGHTS WITH		
FIELD CONDITIONS.			

# **COMBUSTION EXHAUST** AIR FAN SCHEDULE

DESIGNATION	EF-8
LOCATION	2ND FL
AREA SERVED	
MODEL	IPVB 350
CFM	
BHP	
HP	1
RPM	1740
SP (IN H₂O)	1
VOLTS/ø/Hz	208/3/60
INTERLOCK	
NOTES:	

NOTES:

1. FAN BASED ON ENERVEX.

2. PROVIDE THE FOLLOWING:

•EXHAUSTO EBC--14 PRESSURE
CONTROL


RCP-10

•GE/FUJI MODEL AF-300 MS II VARIABLE FREQUENCY DRIVE, 3HP •LOCAL DISCONNECT SWITCH

OLA Consulting Engineers 50 Broadway Hawthorne New York 10532

> 914,747,2800 olace,com

**BATTERY PARK** CITY AUTHORITY BPCPC MAINTENANCE FACILITY 75 BATTERY PLACE, NY

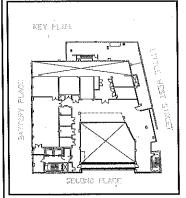

2/21/14 65% REVIEW 1/31/14 PROGRESS SET

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BPCPC MAINTENANCE FACILITY

MECHANICAL SCHEDULES

SCALE PROJECT NO.
AS NOTED NBPC00024 NBPC0002.00 1/31/14 RAWING NO. M-601.00

PAGE 27 OF 38

FAN COIL SCHE	DULE
DESIGNATION	FCU-2
LOCATION	1ST FLOOR
AREA SERVED	LOBBY
MODEL	42CKB10
TYPE	HORIZONTAL
CFM	645
8HP	0.25
WATT	300
RPM ·	1516
SP (IN H₂O)	0.8
VOLTS/ø/Hz	120/1/60
HEAT TYPE	HOT WATER COIL
COOLING CAPACITY, TOTAL/SENSIBLE	31.0 MBH/23.0 MBH
COOLING COIL ROWS	4
CHILLER WATER FLUID FLOW	6.2 GPM
HOT WATER PRESSURE DROP	9.24
CHILLER WATER EWT/LWT F	45F/50F
HEATING CAPACITY	59,5 MBH
HEATING COIL ROWS	2
HOT WATER FLUID FLOW	4.0 GPM
HOT WATER EWT/LWT 'F	130F/110F
CHILLER WATER PRESSURE DR.	1.6
WEIGHT	227 LBS
INTERLOCK	TEMP. SENSOR
FILTER	10X62

LOCATION	2ND FL METAL SHOP	
AREA SERVED	METAL SHOP	
MODEL	LFC-30-FC-15	
TYPE	HORIZONTAL.	
CFM	1600	
BHP	1.04	_
HP	1-1/2	
RPM	1516	
SP (IN H <sub>2</sub> O)	0.8	
VOLTS/ø/Hz	208/3/60	
HEAT TYPE	HOT WATER COIL	
COIL MODEL	HW12C02H10-15X31	
HEATING CAPACITY	104.7 MBH	
EAT	50 F	
LAT	109 F	
ROWS/FINS	2/10	
FACE VELOCITY	509 FPM	
FLUID TYPE	WATER	
FLUID FLOW	10.7 GPM	
WEIGHT	329 LBS	
INTERLOCK	HEF-1	
	16X16 & 16X20	

- S. 1. FAN COIL BASED ON CARRIER
  2. FURNISH2.SPRING VIBRATION ISOLATORS
  AS PER THE SPECIFICATION;
  3. PROVIDE FLEX DUCT CONNECTION;
  4. PROVIDE WITH FACTORY INSTALLED
  MOTORIZED INLET DAMPER FOR FAI
  INTERLOCKED WITH FAN COIL;
  5. PROVIDE TEMPERATURE SENSOR AND
  CONNECT TO BUILDING CONTROL;
  6. DISCONNECT SWITCH BY ELECTRICAL
  CONTRACTOR.
  7. PROVIDE FILTERS PER MANUFACTURE
  REQUIRMENTS

MAKE-UP	UNIT SCHED	ULE		
DESIGNATION	MAU-1			
LOCATION	2ND FL METAL SHOP			
AREA SERVED	METAL SHOP			
MODEL	LFC-30-FC-15			
TYPE	HORIZONTAL.			
CFM	1600			
BHP	1.04	_		
HP	1-1/2			
RPM	1516			
SP (IN H2O)	0.8			
VOLTS/Ø/Hz	208/3/60			
HEAT TYPE	HOT WATER COIL			
COIL MODEL	HW12C02H10-15X31			
HEATING CAPACITY	104.7 MBH			
EAT	50 F			
LAT	109 F			
ROWS/FINS	2/10			
FACE VELOCITY	509 FPM			
FLUID TYPE	WATER			
FLUID FLOW	10.7 GPM			
WEIGHT	329 LBS			
INTERLOCK	HEF-1			
FILTER	16X16 & 16X20			
2. FURNISH AS PER 3. MAKEUF BE FURI CONTRA 4. PROVID MOTORIZ WITH MA 5. FURNISI	S BASED ON GREENHECK.  NISH SPRING VIBRATION ISOLATORS PER THE SPECIFICATION REUP UNIT AND ACCESSORIES SHAL FURNISHED AND INSTALLED BY HVA TRACTOR. JUDE WITH FACTORY INSTALLED ORIZED INLET DAMPER INTERLOCKE! 4 MAKEUP AUF AFAN; RISH UNIT WITH DISCHARGE AIR OSERATURE CONTROLLER AND CHIEVE			
THERMO TEMPER OUTDOO HEAT WI ABOVE TEMPER 6. DISCON CONTRA	TEMPERATURE CONTROLLER AND OUTDOC THERMOSTAT, SET LEAVING AIR TEMPERATURE THERMOSTAT AT 50°F. SET OUTDOOR THERMOSTAT TO LOCK OUT HEAT WHEN AMBIENT TEMPERATURE IS ABOVE 50°F. UNIT SIZED TO PROVIDE 61 TEMPERATURE RISE. DISCONNECT SWITCH BY ELECTRICAL CONTRACTOR. PROVIDE WALL MOUNTED SWITCH.			


LOCATION ZND FL METAL SHOP  AREA SERVED METAL SHOP	35TH FLOOR	1ST FLOOR	
AGEA SERVED METAL SHOP			
AREA SERVED WE THE STICK	VEHICLE CAPTURE SYSTEM	VEHICLE CAPTURE SYSTEM	
MODEL BDF-90-10			
CFM 1800		2200	
BHP 0.82	-		
HP 1		-	
RPM .			
SP (IN H <sub>z</sub> O) 1.2		-	
VOLTS/ø/Hz 208/3/60	208/3/60	208/3/60	
STARTER TYPE HOA	HOA	HOA	
INTERLOCK MUA-1			

LOUVER SCHEDULE			
DESIGNATION	L-3	L4	
LOCATION	2ND FL	1ST FL	<del>-</del> .
AREA/SYSTEM SERVED	EXHAUST	FAI	_
MODEL	ELF375D	ELF3750	_
DIMENSIONS	32"X16"	12"X12"	_
FINISH			
COLOR			
	·		



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BATTERY PARK CITY AUTHORITY BPCPC MAINTENANCE FACILITY 75 BATTERY PLACE, NY

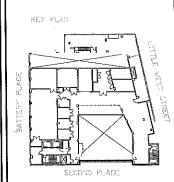

2/21/14 65% REVIEW 1/31/14 DATE

BPCPC MAINTENANCE FACILITY SITE 3 MECHANICAL SYSTEMS UPGRADE


RAYING TITLE

MECHANICAL SCHEDULES

AS NOTED PROJECT NO. NBPC0002.00 DATE 1/37/14 DRAWIN/CHK BY KS/JK

M-602,00

AVCON Engineeringro

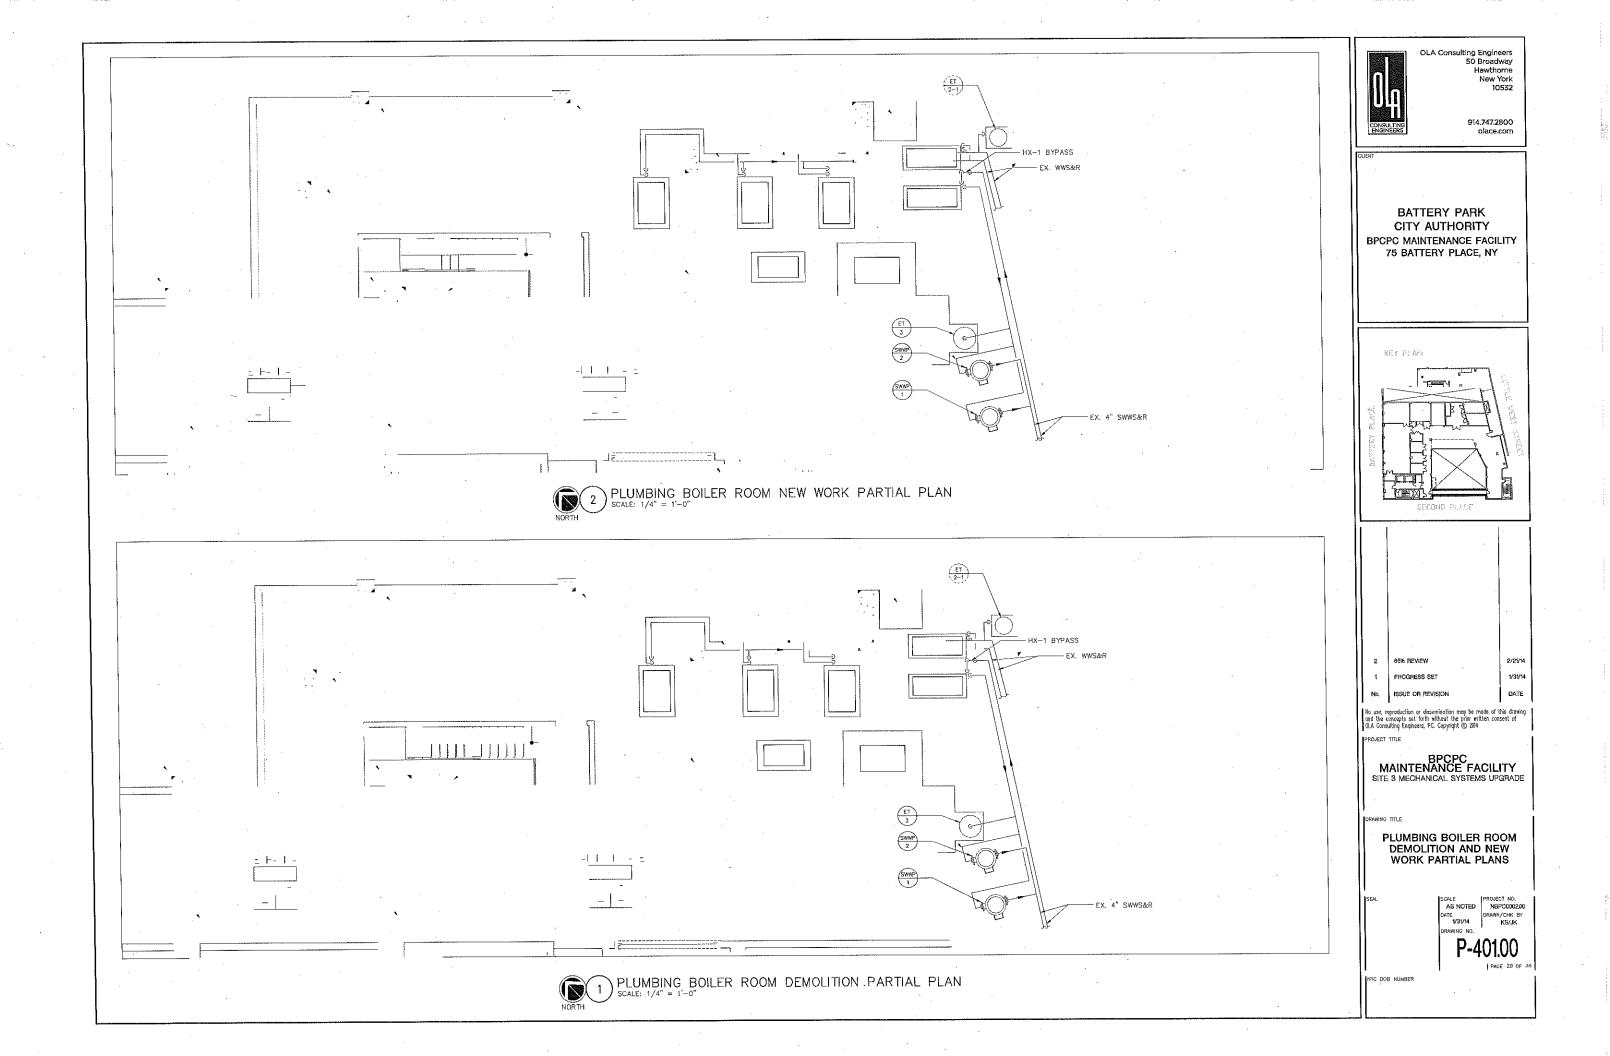

SYMBOL	ABBREVIATION	DESCRIPTION	SYMBOL	ABBREVIATION	DESCRIPTION	SYMBOL	ABBREVIATION	DESCRIPTION
	1. 1	CONDUIT AND -WIRING	• 1.11.50 <sub>4</sub>	A	AMPERE(S)	1	SCH	SCHEDULE
		CONDUIT & WRING TO BE REMOVED UON		AC AC	AIR CONDITIONER	1	SPD	SURGE PROTECTION DEVICE
		HOMERUN TO PANEL, ARROWS INDICATE # 1P	· · · · · · · · · · · · · · · · · · ·	ACC	AIR CONDITIONER CONDENSER	<del>-1</del>	SW	SWITCH(ES)
1	1			AFF			TELCO	TELEPHONE COMPANY
<del></del>	<del>-</del> 1	MULTI-POLE HOMERUN			ABOVE FINISHED FLOOR	1		
		ELECTRICAL EQUIPMENT AS INDICATED		AF	AMPERAGE OF FUSE	<u>i</u>	TYP	TYPICAL
		ELECTRICAL EQUIPMENT TO BE REMOVED UON		AGL	ABOVE GRADE LEVEL		UG	UNDERGROUND
W		ELECTRIC METER		. AHU	AIR HANDLING UNIT	·	VON	UNLESS OTHERWISE NOTED
J		JUNCTION BOX		AL	ALUMINIUM		. VIF	VERIFY IN FIELD
Z		FUSED DISCONNECT SWITCH		ARC	ARC FAULT INTERRUPTER		V	VOLT(S)
	·-	UNFUSED DISCONNECT SWITCH		AS	AMPERAGE OF SWITCH		VSD	VARIABLE SPEED DRIVE
$\boxtimes$	-	COMBINATION MOTOR STARTER/FUSED DISC.		ATS	AUTOMATIC TRANSFER SWITCH		W	WIRE
$\boxtimes$	_	MOTOR STARTER		AWG	AMERICAN WIRE GAUGE	-1	WG	WIRE GUARD
70/		MOTOR .		BCW	BARE COPPER WIRE		WH	WATER HEATER
S <sub>x</sub>		SINGLE POLE SWITCH		BLDG	. BUILDING	-	WP	WEATHERPROOF
∪ <sub>x</sub>		(x - INDICATES FIXTURE BEING CONTROLLED) -		EMS	BUILDING MANAGEMENT SYSTEM			
C3		TIPEE WAY CUSTON			1	NOTES.		
$S_x^3$		! THREE WAY SWITCH ! (x — INDICATES FIXTURÉ BEING CONTROLLED)		C	CONDUIT			S MAY NOT BE APPLICABLE FOR THIS
C4	1	1		CD	CANDELA	- <del>                                     </del>		FOR LIGHT FIXTURE SYMBOLS.
S <sub>x</sub> ⁴	-	FOUR WAY SWITCH  (x - INDICATES FIXTURE BEING CONTROLLED)	· · · ·	CKT	CIRCUIT	GENERAL N	OTES	
				CLG	CEILING		N IS NEW UNLES	SS OTHERWISE NOTED (UON) EXISTING
$S_x^{DIM}$	· -	DIMMER SWITCH  (x - INDICATES FIXTURE BEING CONTROLLED)		COL	COLUMN	REMAIN (EX.).		
<u>.                                    </u>		(V MADIOVIES LIVIOUS DEIMS COMINOTIES)		cn	COPPER			SIDERED SCHEMATIC ONLY AND DO NOT CATIONS AND DETAILS OF THE WORK TO
S <sub>M</sub>		MOTOR RATED TOGGLE SWITCH		CUH	CABINET UNIT HEATER	INSTALLED.		
. S <sub>k</sub>	_	KEY OPERATED SINGLE POLE SWITCH		DEM.	DEMOLISH AND REMOVE	3.) THE ELECTRICAL	CONTRACTOR S	SHALL BE RESPONSIBLE FOR OBTAINING
S <sub>v</sub>		SPEED CONTROLLER (FBO)		DISC	DISCONNECT	INCLUDING FILING WI	TH THE UTILITY	ALL FEES ASSOCIATED WITH THIS WORK COMPANY (AS REQUIRED), AND WITH L
<u></u>	-	DUPLEX RECEPTACLE		DIM	DIMMER	AUTHORITY HAVING		
<del></del>		DOUBLE DUPLEX RECEPTACLE		DWG	DRAWING	4.) ELECTRICAL CON ELECTRICAL INSPECT	ITRACTOR SHALL TON AGENCY TO	BE RESPONSIBLE TO HIRE A THIRD P PROVIDE UL INSPECTIONS AND SUBMI
<del></del>		SPECIAL RECEPTACLE		ELEV	LEEVATOR			TO FINAL REQUEST FOR PAYMENT.
	<del> }</del>				-		LVING THE ELECT	TRIC SERVICE SHALL BE COORDINATED
<u> </u>		PUSHBUTTON		EMT <sub>.</sub>	ELECTRICAL METALLIC TUBING	<b>→</b> .		
EPO	EPO	EMERGENCY POWER OFF SWITCH		EM	EMERGENCY	<del></del> 1		PPER UON "ON DRAWINGS".
	CB	CIRCUIT BREAKER		EX.	EXISTING TO REMAIN	→ PROTECTION DRAWIN	IGS ARE AVAILA	HANICAL, ELECTRICAL, PLUMBING AND F BLE TO THE CONTRACTOR VIA COMPAC
	_	ENCLOSED CIRCUIT BREAKER		F .	FLOOR	THE ENGINEER MAY  DERIVATIVE WORK O	GRANT THE COI F THE DATABAS	NTRACTOR A LIMITED LICENSE TO MAKE SE FOR THE PURPOSE OF SHOP DRAWN
/ 200AS [] 150AF	_	FUSED SWITCH		FB0	FURNISHED BY OTHERS	SUBMITTALS AND AS	S-BUILT DRAWIN	IGS. UPON REQUEST, THE ENGINEER S UST BE SIGNED AND RETURNED BY THE
©	GEN	GENERATOR	·	FC	FAN COIL UNIT	CONTRACTOR ALONG	WITH A LUMP	SUM FEE OF TWO HUNDRED AND FIFTY ASE OF THE ELECTRONIC FILES. THIS
d]	_	GENERATOR RECEPTACLE		GEN	GENERATOR	FOR TIME AND MATI  REQUESTED DATA.	ERIAL COSTS IN	CURRED IN PREPARING AND TRANSMITT
Ţœ, L	GND	GROUND AS PER LOCAL CODE		GFl .	GROUND FAULT INTERRUPTER		ne and den ""	CONTRACTOR OF THE CONTRACTOR O
TT		GROUND BAR		HP	HORSEPOWER	→ 8.) CIRCUIT NUMBER NUMBERS SHALL BE	so are for inf Determined in	ORMATION PURPOSES ONLY, ACTUAL C 1 THE FIELD.
OR ①	-	GROUND ROD		HVAC	HEATING VENTILATION AIR CONDITIONING	9.) CORE DRILLING	OR TRENCHING	THROUGH AN EXISTING FLOOR SLAB, W
13		TRANSFER SWITCH		IG	ISOLATED GROUND	RÉQUIRED, SHALL B RADAR SCANNED PI	E COORDINATED RIOR TO CORE D	WITH THE OWNER. FLOOR SLABS SHADRILLING OR TRENCHING. ALL WORK, INC
	XFMR	TRANSFORMER		1MC	INTERMEDIATE METAL CONDUIT	CORE DRILLING, RAI	DAR SCAN, INST.	ALLATION OF FIRE STOPPING, & LL BE PERFORMED DURING NON-BUSINI
mm or T				1		HOURS AND INCLUD	ED IN BASE BID	DURING NON-BOSIN DE EXTREME CAUTION DURING ANY MAGE TO EXISTING EQUIPMENT/SYSTEMS
<u> </u>	CT	CURRENT TRANSFORMER		KVA	KILO-VOLT-AMPERE	— ITEMS DAMAGED AS	A RESULT OF	CORE DRILLING SHALL BE REPAIRED AT
B	_	BOILER BREAK GLASS STATION		KW	KILO-WATT .			SHALL BE FIRE SEALED.
<del>}l'</del>	NC NC	NORMALLY CLOSED CONTACTS		MAX	MAXIMUM	10.) WHERE GFI RECEPTACLES, THE	CEPTACLES ARE GFI RECEPTACLI	CIRCUITED WITH GENERAL CONVENIENC E SHALL BE THE LAST DEVICE ON THE
	NO .	NORMALLY OPEN CONTACTS		MCB	MAIN CIRCUIT BREAKER	11.) INSTALL CONDI	JIT EXPANSION F	FITTINGS AT ALL LOCATIONS WHERE CO
M	MD	MOTORIZED DAMPER		MCC	MOTOR CONTROL CENTER	CROSS BUILDING OF		
	SD OR CFSD	SMOKE DAMPER .		MIN	MINIMUM	12.) UNLESS OTHER	RWISE NOTED, DI	SCONNECT SWITCHES, STARTERS, HOAS OR MECHANICAL PUMPS, CABINET AND
FACP	FACP	FIRE ALARM CONTROL PANEL		MLO	MAIN LUG ONLY	HEATERS, RETURN	FANS, ROOF FAI	NS, VAV BOXES, COMPRESSORS, FAN C
				MTS	MANUAL TRANSFER SWITCH	MECHANICAL CONTR	RACTOR AND INS	NSERS SHALL BE FURNISHED BY THE STALLED BY THE ELECTRICAL CONTRACT
-		-		NIC	NOT IN CONTRACT			MECHANICAL CONTRACTOR.
				NL.	NIGHT LIGHT	SUPPLIED BY MECH	IANICAL CONTRA	OTORIZED DAMPERS, CFSD/SD AND VA CTOR AND INSTALLED AND WIRED BY
				NTS	NOT TO SCALE			S NOT SHOWN ON PLANS.
						→ 14.) ALL ELECTRICA USE IN NEW YORK		LIGHT FIXTURES, ETC. SHALL BE APPRO
		1		OH	OVERHEAD	<del></del> 1		
	-	ļ		PH,#	PHASE	BATTERY BACKUP,	U.O.N. PROVIDE	TO BE 120V, MULTI STATION HEADS WIRING AS REQUIRED BETWEEN HEADS
	1			P	POLE	HEADS WITHIN BUİL →	DING SHALL BE	CONNECTED TOGETHER.
				P80	PROVIDED BY OTHERS			CEPTACLE SHALL BE LABELED WITH THE ANUMERICS TO BE 1/8" HIGH AND BLA
	1			PNL	PANEL	CLEAR BACKGROUN	ID. LABELS SHA	ALL BE SELF ADHESIVE. IDENTIFY ASS
				PVC	POLY VINYL CHLORIDE	→ PANEL AND CIRCUI	I NOWBER!	
·	· · · · · · · · · · · · · · · · · · ·			REL. :	REMOVE AND RELOCATE			
		-1			<b>+</b>	<b>—</b>		
				RGS	RIGID GALVANIZED STEEL			

### DEFINITION OF TERMS

- 1.) WHEREVER IN THE CONTRACT DOCUMENTS THE WORD "CLIENT" IS USED, IT MUST BE UNDERSTOOD THAT "BATTERY PARK CITY AUTHORITY" IS INTENDED.
- 2.) WHEREVER IN THE CONTRACT DOCUMENTS THE WORD "ENGINEER" IS USED, IT MUST BE UNDERSTOOD THAT "OLA CONSULTING ENGINEERS" IS INTENDED.
- 5.) "WORK" MUST BE DEEMED TO CONSIST OF ALL LABOR AND OPERATIONS, TRANSPORTATION, HOISTING, MATERIALS, TOOLS, EQUIPMENT, SERVICES, INSPECTIONS, INVESTIGATIONS, COORDINATION AND SUPERVISION REQUIRED AND / OR REASONABLY NECESSARY TO PRODUCE THE CONSTRUCTION REQUIRED BY THE CONTRACT
- 4.) "FURNISH" MEANS THE DESIGN, FABRICATION, PURCHASE AND DELIVERY TO THE
- 5.) "INSTALL OR INSTALLATION" MEANS THE ACT OF PHYSICALLY PLACING, APPLYING, SETTING, ERECTING, ANCHORING, SECURING, ETC., CONSTRUCTION MATERIALS, EQUIPMENT, FURNISHINGS, APPLIANCES, AND SIMILAR ITEMS SPECIFIED AND FURNISHED AT THE JOB SITE. INSTALLATION OF SPECIFIED ITEMS MUST BE COMPLETE IN ALL
- 6.) "PROVIDE" MEANS TO FURNISH AND INSTALL CONSTRUCTION MATERIAL, EQUIPMENT, ETC. AS DEFINED ABOVE.
- 7.) THE FOLLOWING ARE DEFINITIONS OF SHOP DRAWING STAMP ACTIONS:
- A.) "NO EXCEPTIONS TAKEN" MEANS THAT THE SHOP DRAWING IS CORRECT AS TO PERFORMANCE, CAPACITY, ETC. AND SUBSTANTIAL CONFORMANCE TO THE CONTRACT DRAWINGS AND SPECIFICATIONS. FABRICATION AND/OR PURCHASE MAY COMMENCE.
- B.) "MAKE CORRECTIONS NOTED" MEANS THAT THE SHOP DRAWING IS CORRECT AS TO PERFORMANCE, CAPACITY, ETC. AND SUBSTANTIAL CONFORMANCE TO THE CONTRACT DRAWINGS AND/OR SPECIFICATIONS, SUBJECT TO AND IN COMPLIANCE WITH THE ANNOTATIONS AND/OR CORRECTIONS INDICATED ON THE SHOP DRAWING. FABRICATION AND/OR PURCHASE MAY COMMENCE.
- C.) "AMEND AND RESUBMIT" MEANS THAT THE COMMENTS AND/OR CORRECTION ARE COMMENTS AND IMPORTANT THAT THE REMEMBER SHAPES TO SEE HOW THE COMMENTS AND/OR CORRECTIONS ARE RESOLVED PRIOR TO RELEASE FOR FABRICATION AND/OR PURCHASE, FABRICATIONS AND/OR PURCHASE MAY NOT
- D.) "REJECTED" MEANS THAT THE SHOP DRAWING DOES NOT COMPLY OR CONFORM TO THE CONTRACT DRAWINGS AND/OR SPECIFICATIONS. FABRICATION AND/OR PURCHASE MAY NOT COMMENCE.

TYPICAL BRANCH CIRCUIT WIRING LEGEND

1.) EACH 120V AND 277V CIRCUIT SHALL HAVE A DEDICATED NEUTRAL CONDUCTOR. SHARED NEUTRAL HOMERUNS ARE NOT PERMITTED.
2.) CONDUCTORS SHALL BE INCREASED FOR VOLTAGE DROP AND DERATING AS PER APPLICABLE ELECTRICAL CODE. FOR CIRCUITS THAT ARE BETWEEN 100' AND 150' IN LENGTH, PHASE AND NEUTRAL CONDUCTORS SHALL BE #10 AWG. FOR

CIRCUITS THAT ARE BETWEEN 150' AND 225' IN LENGTH, PHASE AND NEUTRAL CONDUCTORS SHALL BE #8 AWG. FOR LENGTHS GREATER THAN 225' IN LENGTH, VERIFY CONDUCTOR SIZES WITH ENGINEER.

--- LIGHT FIXTURE TYPE

SWITCH CONTROL

---LIGHT FIXTURE ----CIRCUIT #

-- 2-#12 & 1-#12 GND (1-1P-20A OR 1-1P-15A CB) → 3-#12 & 1-#12 GND (3P-20A OR 3P-15A CB)

P-CIRCUIT #

-RECEPTACLE

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MALIN V.SS



2 65% REVIEW 2/21/14 1/31/14 PROGRESS SET No ISSUE OR REVISION DATE


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BPCPC
MAINTENANCE FACILITY

DRAWING TITLE

SYMBOLS, ABBREVIATIONS AND GENERAL NOTES

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		PAGE 30 OF 3

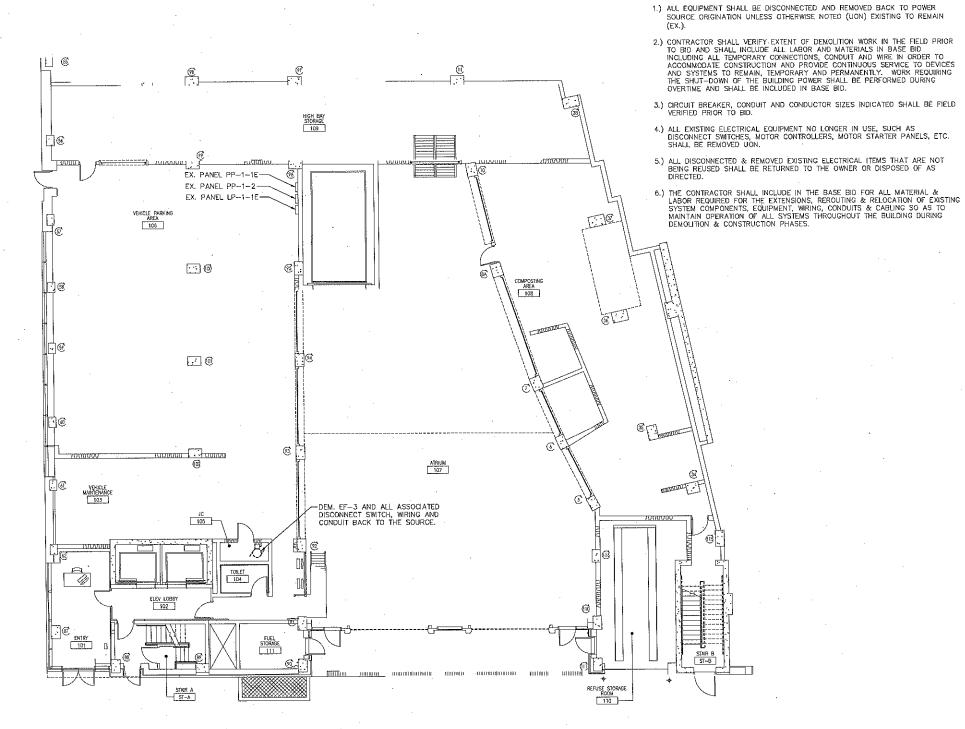

# NOTE:

DEMOLITION NOTES


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PROJECT TITLE

BPCPC MAINTENANCE FACILITY SITE 3 MECHANICAL SYSTEMS UPGRADE

DRAWING TITLE


ELECTRICAL FIRST FLOOR DEMOLITION PLAN

SEAL	SCALE AS NOTED	PROJECT NO. NBPC000200
	DATE.	DRAWN/CHK BY WP/JF
	DRAWING NO.	
	E-	101.00
1		I PAGE 31 OF 38

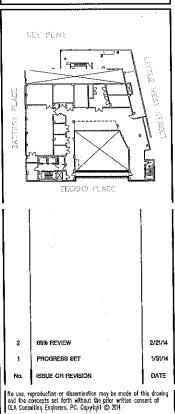NYC DOB NUMBER

ELECTRICAL FIRST FLOOR DEMOLITION PLAN

SCALE: 1/8" = 1'-0"

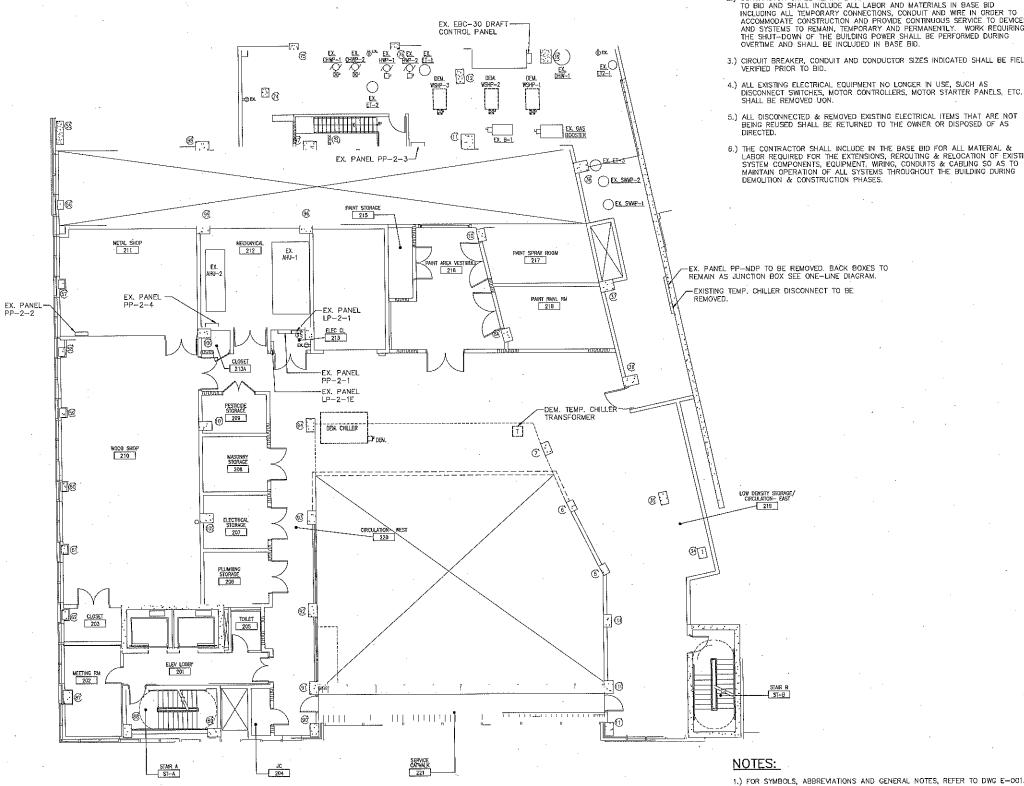



- 1.) ALL EQUIPMENT SHALL BE DISCONNECTED AND REMOVED BACK TO POWER SOURCE ORIGINATION UNLESS OTHERWISE NOTED (UON) EXISTING TO REMAIN
- 2.) CONTRACTOR SHALL VERIFY EXTENT OF DEMOLITION WORK IN THE FIELD PRIOR TO BID AND SHALL INCLUDE ALL LABOR AND MATERIALS IN BASE BID INCLUDING ALL TEMPORARY CONNECTIONS, CONDUIT AND WIRE IN ORDER TO ACCOMMODATE CONSTRUCTION AND PROVIDE CONTINUOUS SERVICE TO DEVICES AND SYSTEMS TO REMAIN, TEMPORARY AND PERMANENTLY. WORK REQUIRING THE SHUT-DOWN OF THE BUILDING POWER SHALL BE PERFORMED DURING OVERTIME AND SHALL BE INCLUDED IN BASE BID.
- 3.) CIRCUIT BREAKER, CONDUIT AND CONDUCTOR SIZES INDICATED SHALL BE FIELD VERIFIED PRIOR TO BID.
- 4.) ALL EXISTING ELECTRICAL EQUIPMENT NO LONGER IN USE, SUCH AS DISCONNECT SWITCHES, MOTOR CONTROLLERS, MOTOR STARTER PANELS, ETC. SHALL BE REMOVED UON.
- 5.) ALL DISCONNECTED & REMOVED EXISTING ELECTRICAL ITEMS THAT ARE NOT BEING REUSED SHALL BE RETURNED TO THE OWNER OR DISPOSED OF AS DIRECTED.
- 6.) THE CONTRACTOR SHALL INCLUDE IN THE BASE BID FOR ALL MATERIAL & LABOR REQUIRED FOR THE EXTENSIONS, REROUTING & RELOCATION OF EXISTING SYSTEM COMPONENTS, EQUIPMENT, WIRING, CONDUITS & CABLING SO AS TO MAINTAIN OPERATION OF ALL SYSTEMS THROUGHOUT THE BUILDING DURING DEMOLITION & CONSTRUCTION PHASES.

KEY PLAN

86% REVIEW 2/21/14 1/31/14 PROGRESS SET

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BPCPC MAINTENANCE FACILITY

ELECTRICAL SECOND FLOOR **DEMOLITION PLAN** 

AS NOTED NEPC0002.00 1/31/14 RAWING NO. E-102.00

NYC DOE NUMBER

ELECTRICAL SECOND FLOOR DEMOLITION PLAN

# **DEMOLITION NOTES**

- ALL EQUIPMENT SHALL BE DISCONNECTED AND REMOVED BACK TO POWER SOURCE ORIGINATION UNLESS OTHERWISE NOTED (UON) EXISTING TO REMAIN (FX.)
- 2.) CONTRACTOR SHALL VERIFY EXTENT OF DEMOLITION WORK IN THE FIELD PRIOR TO BID AND SHALL INCLUDE ALL LABOR AND MATERIALS IN BASE BID INCLUDING ALL TEMPORARY CONNECTIONS, CONDUIT AND WRE IN ORDER TO ACCOMMODATE CONSTRUCTION AND PROVIDE CONTINUOUS SERVICE TO DEVICES AND SYSTEMS TO REMAIN, TEMPORARY AND PERMANENTLY. WORK REQUIRING THE SHUT-DOWN OF THE BUILDING POWER SHALL BE PERFORMED DURING OVERTIME AND SHALL BE INCLUDED IN BASE BID.
- 3.) CIRCUIT BREAKER, CONDUIT AND CONDUCTOR SIZES INDICATED SHALL BE FIELD VERIFIED PRIOR TO BID.
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- 5.) ALL DISCONNECTED & REMOVED EXISTING ELECTRICAL ITEMS THAT ARE NOT BEING REUSED SHALL BE RETURNED TO THE OWNER OR DISPOSED OF AS DIRECTED.
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MECHANICAL EQUIPMENT RM

DEM. FA-1 AND ALL ASSOCIATED
DISCONNECT SWITCH, WERED AND
CONQUIT BACK TO THE SOURCE.

ELECTRICAL 11TH FLOOR DEMOLITION PART ROOF PLAN

# NOTE:

1.) FOR SYMBOLS, ABBREVIATIONS AND GENERAL NOTES, REFER TO DWG E-001.




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PROJECT

BPCPC MAINTENANCE FACILITY SITE 3 MECHANICAL SYSTEMS UPGRADE

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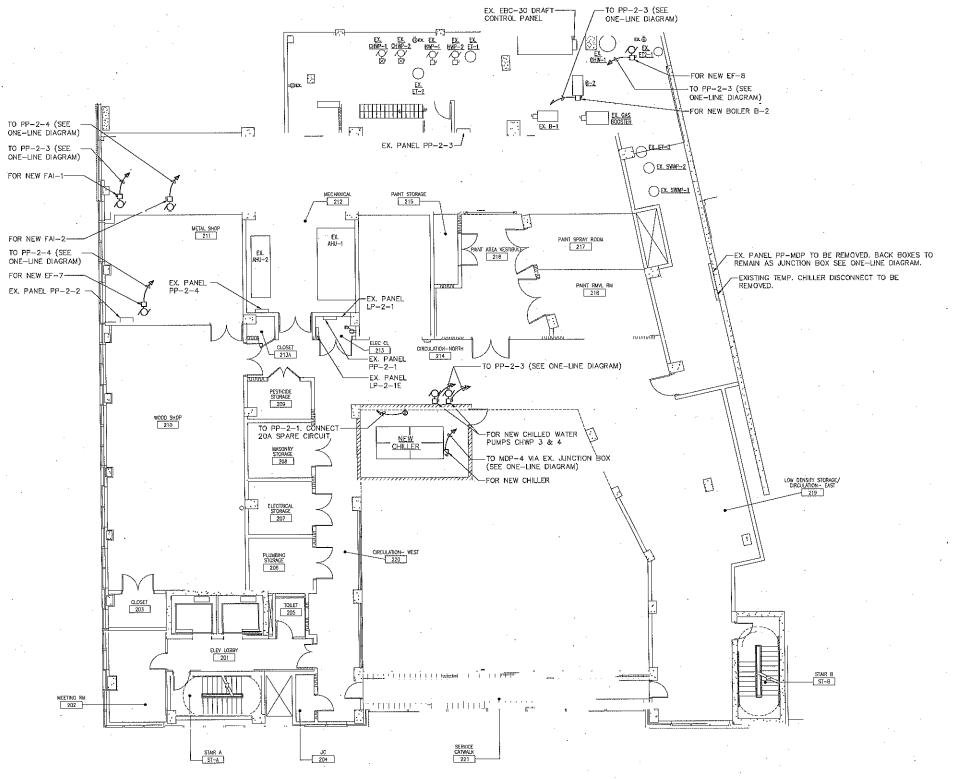
ELECTRICAL 11TH FLOOR DEMOLITION PART ROOF PLAN

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AS NOTED NBPC0002.00
DATE DRAWN/CHK BY
1/31/14
DRAWING NO.

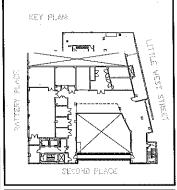
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PAGE 33 OF



# NOTE:

1.) FOR SYMBOLS, ABBREVIATIONS AND GENERAL NOTES, REFER TO DWG E-001.




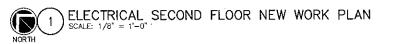


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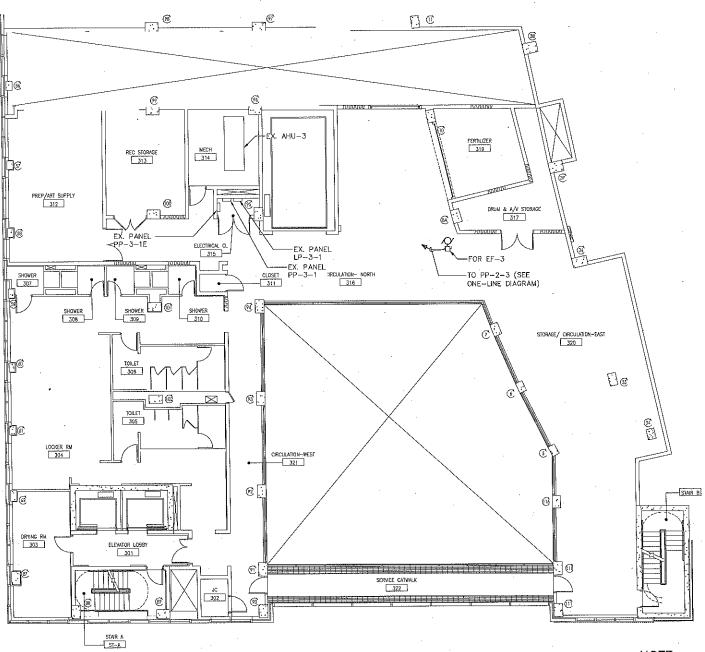
PROJECT

BPCPC
MAINTENANCE FACILITY
SITE 3 MECHANICAL SYSTEMS UPGRADE

DRAWING TITL

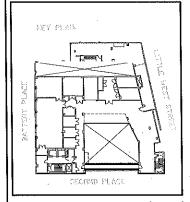
ELECTRICAL SECOND FLOOR NEW WORK PLAN
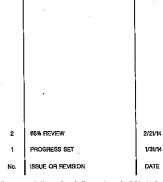
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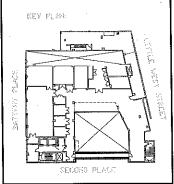



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PROJECT 1

BPCPC MAINTENANCE FACILITY SITE 3 MECHANICAL SYSTEMS UPGRADE

ORAWING TITLE

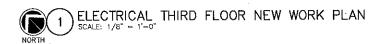ELECTRICAL THIRD FLOOR NEW WORK PLAN

SCAL

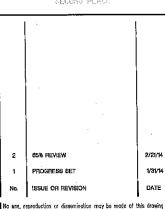SCALE
AS NOTED
NBPC000200

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| PAGE 35 OF 38

(8) (8) (8) (R) 404 OFFICE 407 OFFICE OFFICE 412 OFFICE 409 OFFICE 410 OFFICE 413 AGB 408 SERVER RM 424A CIRCULATION-WEST STAIR A 424 ELEY LOBBY HR ASST. TOILET 402 HORFICULTURE PROGRAMMING 418 [] ® MAINTENANCE 414 : (0) ACCT MGR 425 :: (2) RECEPTION 405 CLOSET 403 OFFICE MOR FOREMEN 419 FOREMEN 415 ACCOUNTING 432 RH EMR LANDING FOREMEN 417 ELECTRICAL FOURTH FLOOR NEW WORK PLAN -EX. MD-4 (MAIN SWITCH SECTION 1) -EX. MD-4 (SECTION 2) -EX. MD-4 (SECTION 3) FLECT OL PURCHASING 427 MEETING ROOM SERVICE CATWALK PERMITS 428 100 CLOSE) cLOSE( CLOSET 435A SOIL LAB (a) CIRCULATION—EAST PANTRY 443 ٦ STORAGE 445 LOUNGE 448 TO PP-4-1 (SECTION 2)
(SEE ONE-LINE DIAGRAM) PLAX RM STORAGE 446 NOTE: 1.) FOR SYMBOLS, ABBREVIATIONS AND GENERAL NOTES, REFER TO DWG E-001. SJECHANICAL 436 -EX. PANEL PP-4-1E -EX. PANEL PP-4-1 SECTION 1 & 2 H/C TOILET CLOSET

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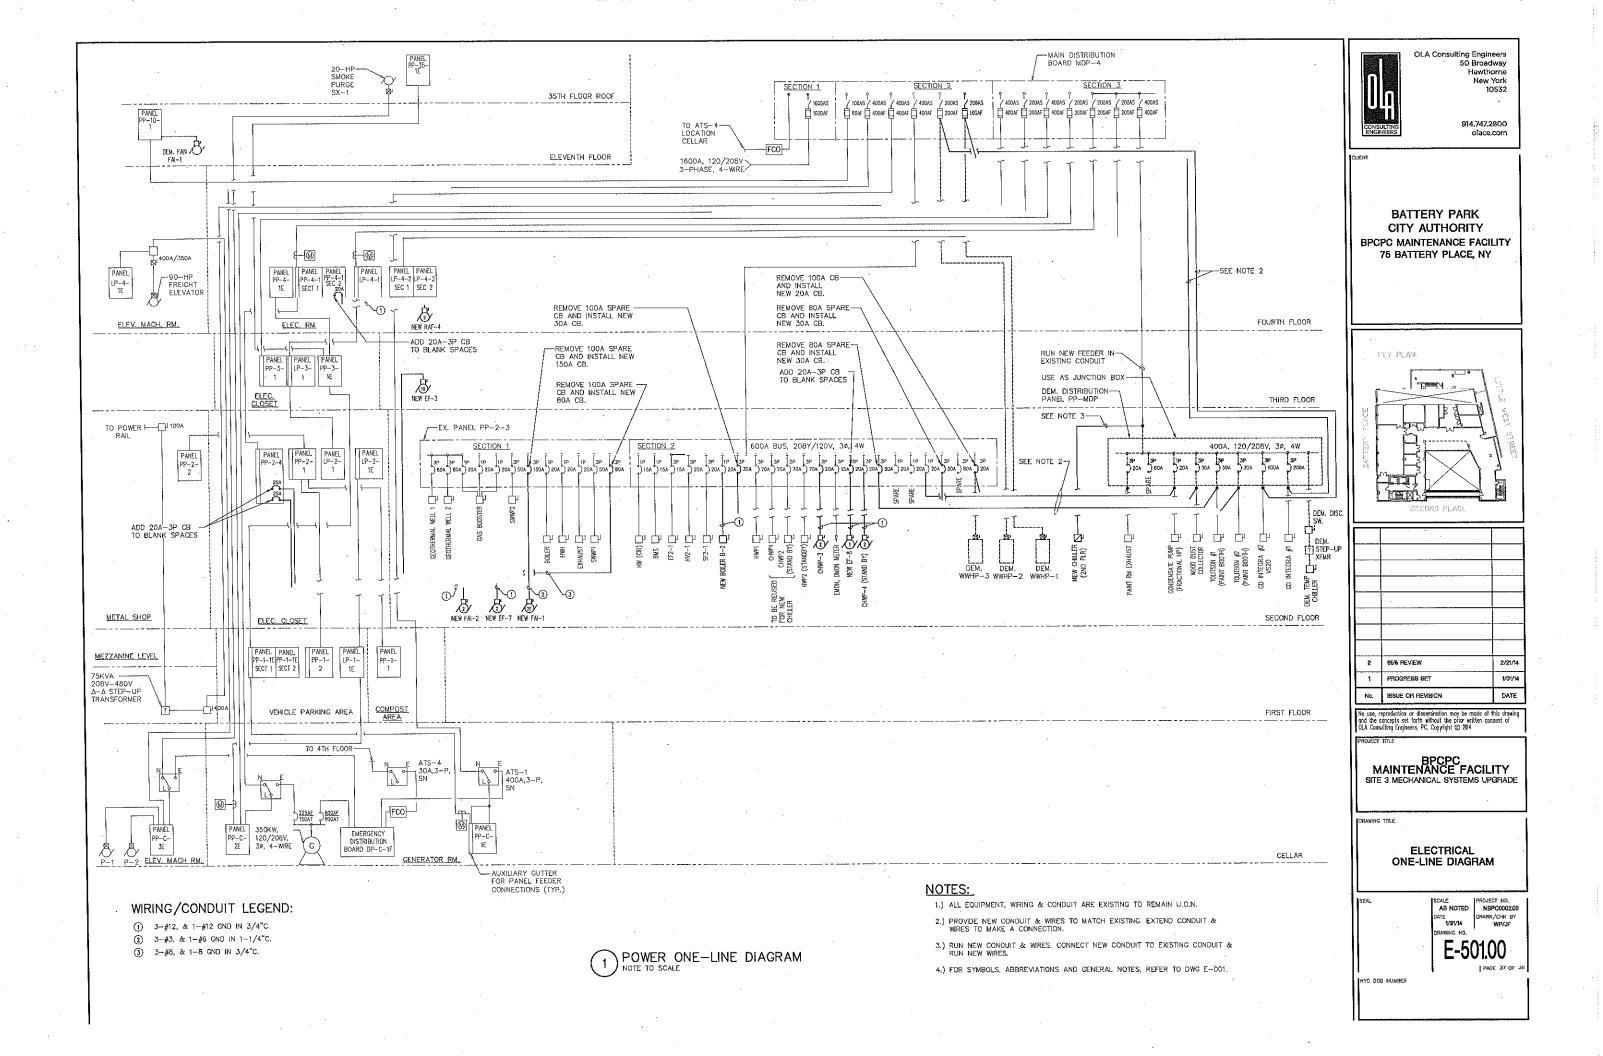
RATTERY PLACE


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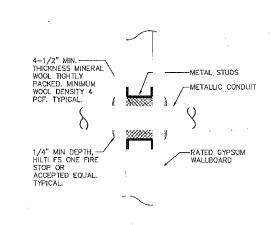
SECURE FLAT

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TYPICAL CONDUIT GYPSUM WALL PENETRATION DETAIL




4-1/2" MIN.
THICKNESS MINERAL
WOOL TIGHTLY
PACKED. MINIMUM

WOOL DENSITY 4 PCF. TYPICAL.

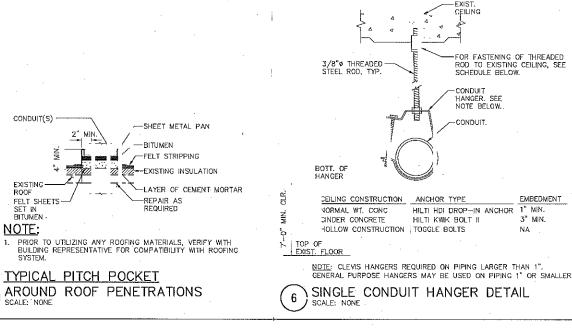1/4" MIN DEPTH, ---HILTI FS ONE FIRE STOP OR


ACCEPTED EQUAL.

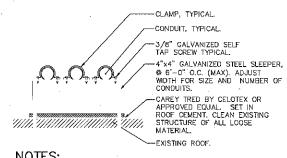

# NOTES:

FOR NUMBER OF

- PRIOR TO UTILIZING ANY ROOFING MATERIALS, VERIFY WITH BUILDING REPRESENTATIVE FOR COMPATIBILITY WITH ROOFING
- 2. TYPICAL FOR ANY NUMBER OF CONDUITS,

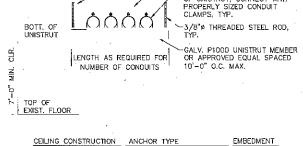

FOR FASTENING OF THREADED ROD TO EXISTING CEILING, SEE SCHEDULE BELOW.

-CONDUITS SUPPORTED ON TOP OF UNISTRUT, CONNECT WITH

NORMAL WT. CONC HILTI HDI DROP-IN ANCHOR CINDER CONCRETE HILTI KWIK BOLT II 3" MIN. HOLLOW CONSTRUCTION TOGGLE BOLTS

> TYPICAL CONDUIT INTERIOR MASONRY WALL PENETRATION DETAIL

-METALLIC CONDUIT


-INTERIOR WALL

-LINK-SEAL MODULAR ELASTOMERIC SEAL ELEMENT. SEE NOTE #1.

-PRESSURE PLATE,

-METALLIC CONDUIT

-BOLT

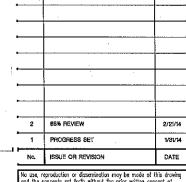

THE N


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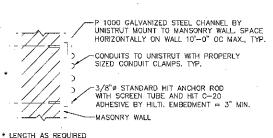
**ELECTRICAL** DETAILS

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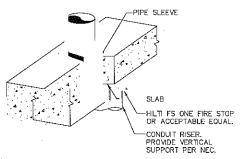
TYPICAL CONDUIT ON ROOF SUPPORT DETAIL TRAPEZE SUPPORT DETAIL



CONDUIT SUPPORTED FROM STRUCTURAL STEEL

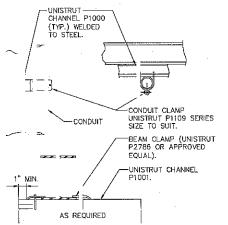

TYPICAL CONDUIT SUPPORT ON MASONRY



VERTICAL CONDUIT PENETRATION 4 DETAIL
SCALE: NONE

EXTERIOR MASONRY WALL PENETRATION DETAIL

THICKNESS IS GREATER THAN 12".

3. PROVIDE SCHEDULE 80 WALL SLEEVE FOR NEW WALL CONSTRUCTION PER MANUFACTURER'S REQUIREMENTS. TYPICAL BELOW GRADE CONDUIT

SEAL ASSEMBLY BASED ON THUNDERLINE MODEL "C" LINK-SEAL MODULAR SEAL, WITH EPDM SEAL ELEMENT, COMPOSITE PRESSURE PLATES, STEEL WITH 2-PART ZINC DICHROMATE & ORGANIC COATING NUTS AND BOLTS AND

WITH A OPERATING TEMPERATURE RANGE OF -40°F TO +250°F.

2. PROVIDE AND INSTALL TWO SEALS WHEN PENETRATED WALL

EXTERIOR

NOTES: