


- NOTES:
- DO NOT SCALE. USE FIGURED DIMENSIONS ONLY.
  - THIS DRAWING IS TO BE READ IN CONJUNCTION WITH ALL OTHER RELEVANT ARCHITECTURAL AND ENGINEERING DRAWINGS.

LEGEND

- FB1  
CL 7.160m  
IL 5.150m  
1:50mm @ 1:150
- INDICATES PROPOSED FOUL WATER SEWER, MANHOLE, PIPE SIZE COVER AND INVERT LEVELS.
- F1  
CL 7.16  
IL 5.15  
150mm @ 1:200
- PROPOSED uPVC FOUL WATER SEWER WITH PIPE SIZE, GRADE, MANHOLE REF. AND INVERT LEVEL
- G
- INDICATES PROPOSED GULLY AND CONNECTION
- INDICATES PROPOSED RISING MAIN
- BASEMENT BOUNDARY

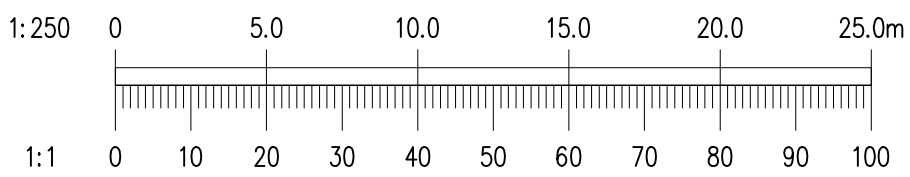

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REV. DATE AMENDMENT DRN APPD

STATUS **FOR PLANNING ONLY  
NOT FOR CONSTRUCTION**

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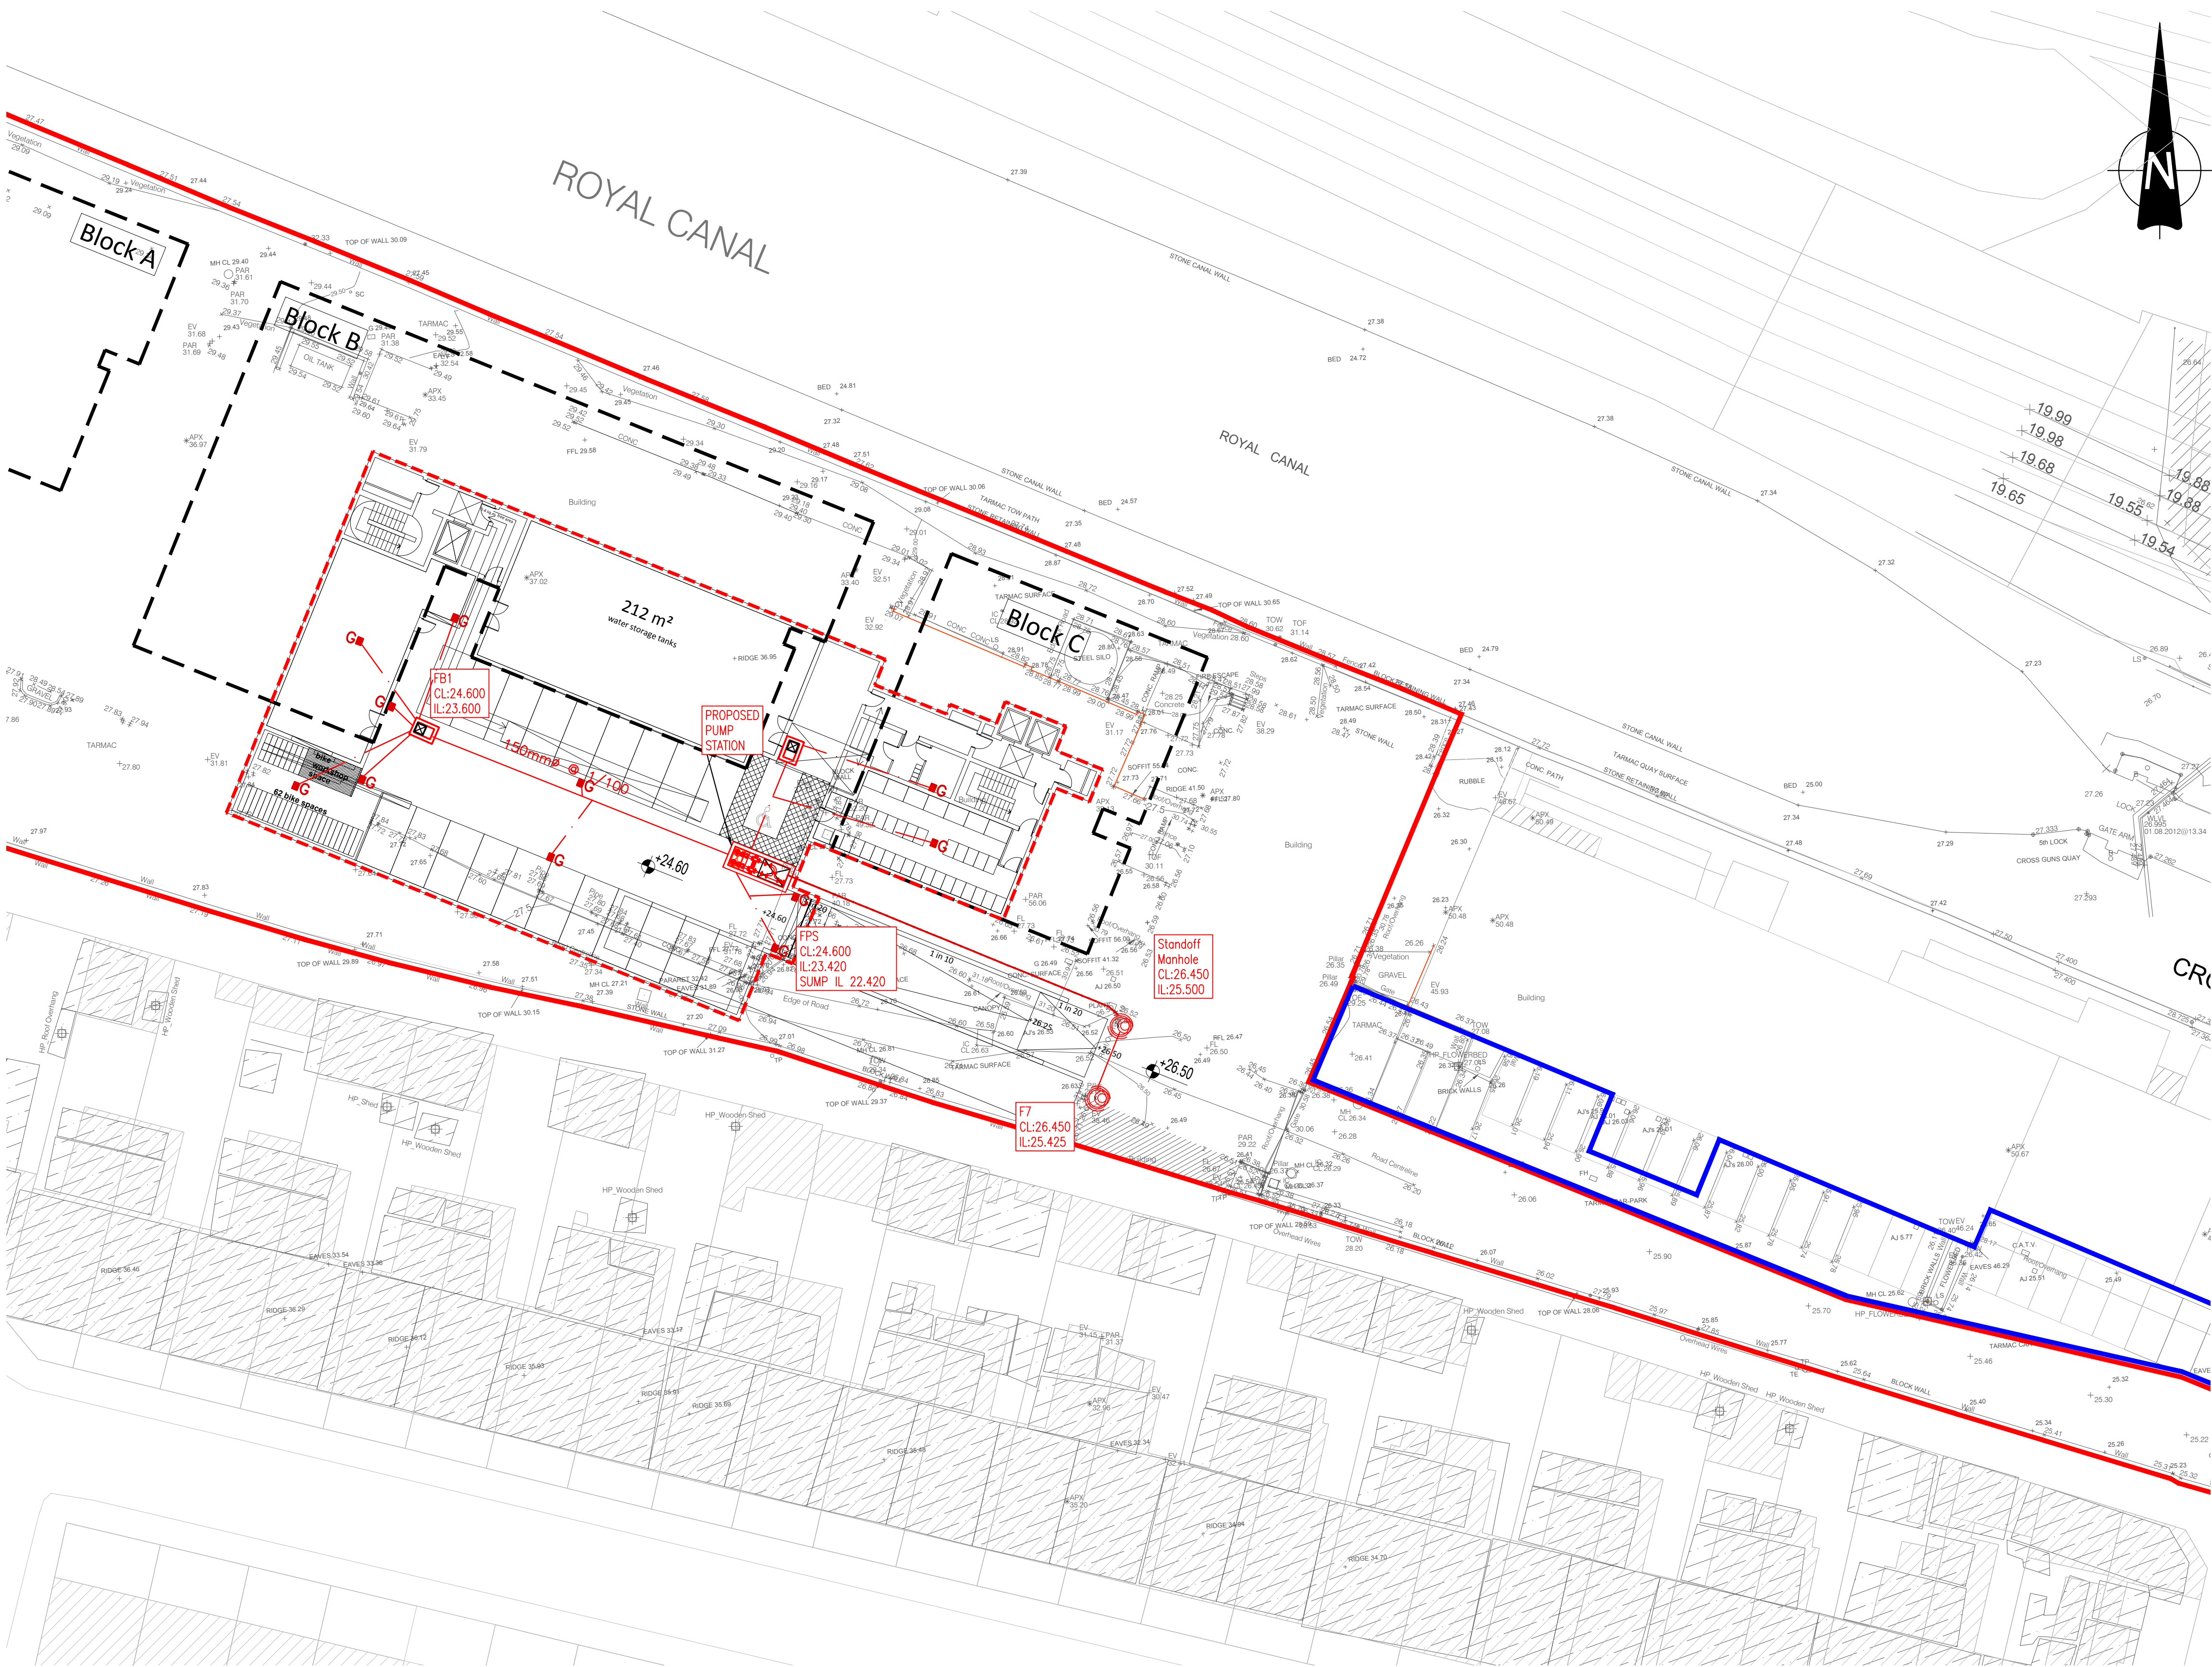
ARCHITECT **O MAHONY PIKE ARCHITECTS**

PROJECT **CROSS GUN'S BRIDGE,  
PHIBSBOROUGH,  
DUBLIN 7.**

TITLE **PROPOSED BASEMENT DRAINAGE LAYOUT**

DRAWN SJ	DESIGNED BG	APPROVED JG	DATE JAN. 2021
SCALE 1:250 @A1	JOB NO. 20-011	DRG. NO. P201	REVISION

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PROPOSED BASEMENT DRAINAGE LAYOUT  
SCALE 1:250 @ A1