

GENERAL KEY SPECIFICATIONS


- NOTES:
- NO DIMENSIONS ARE TO BE SCALED FROM THIS DRAWING.
 - ALL DIMENSIONS ARE IN METERS UNLESS OTHERWISE STATED.
 - CONTRACTOR TO CHECK ALL DIMENSIONS AT SITE PRIOR TO CONSTRUCTION, ASSEMBLY OR FABRICATION OF ALL WORKS.
 - ALL ITEMS OF WORK ARE TO BE CARRIED OUT AT Q.C.S AND OTHER RELEVANT CODES OF CONSTRUCTIONS.
 - BEFORE INITIATING THE WORK, THE CONTRACTOR MUST CHECK AND SUPERSEDE ALL PROJECT DRAWINGS (ARCH, STR, MECH, ELEC,ETC.) AND IN CASE OF ANY DISCREPANCIES OR MISTAKES IN DRAWINGS OR DETAILS, THE CONTRACTOR MUST REFER TO THE DESIGNER FOR CLARIFICATION BEFORE STARTING ANY CONSTRUCTION WORK .

SCHEDULE OF DOORS

TYPE	SIZE	HEIGHT	ALL LEVELS	DESCRIPTION
D1	2.00	2.04	-	PANELLED DOOR WITH MARBINE FRAME
D2	1.50	2.04	-	SLIDING DOOR WITH MARBINE FRAME
D3	1.00	2.04	-	SLIDING DOOR WITH MARBINE FRAME
D4	0.80	2.04	-	PANELLED DOOR WITH MARBINE FRAME
D5	1.00	2.04	-	PANELLED DOOR WITH MARBINE FRAME


SCHEDULE OF WINDOWS

W1	2.00	1.20	1:1	HINGED WINDOWS WITH ALUMINUM FRAME
W2	1.20	1.50	1:0	HINGED WINDOWS WITH ALUMINUM FRAME
W3	1.20	1.00	1:20	HINGED WINDOWS WITH ALUMINUM FRAME
W4	2.00	1.50	1:0	HINGED WINDOWS WITH ALUMINUM FRAME
W5	0.80	1.00	1:5	HINGED WINDOWS WITH ALUMINUM FRAME

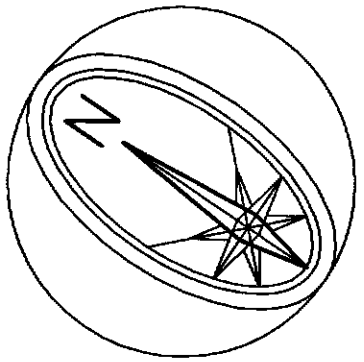

U.D.D. STAMP		MUNICIPALITY STAMP	
Require No. :		Application No. :	
CONSULTANT REG. No. :	Issue : A	CONSULTANT REG. No. :	Issue : A
CONSULTANT STAMP & SIGNATURE :		SUB-CONSULTANT STAMP & SIGNATURE :	
TECHNICAL MANAGER :		TECHNICAL MANAGER :	
REGISTRATION No. :		REGISTRATION No. :	
PROJECT الأقصى للإنشاء والمهندسة AGRI GREEN Engineering Consultancy (Q.E.C)			
LOCATION FACTORY(S), OFFICE(G+1), STORE AND DINING ROOM			
CLIENT ENG. ADNAN FAHAD AL NAIMI			
DATE OCTOBER, 2012			
TITLE GROUND FLOOR PLAN			
DRAWING NO. A-02		SCALE 1:100	
DRAWN BY ABDULLAH ELBARRY		CHECKED BY ARCH. KHALED MONKAR	
CADDLE		REGISTRATION No. :	
REVISION		SIGNATURE	

HANDRAIL SHALL BE PROVIDED
HEIGHT IS 1000mm

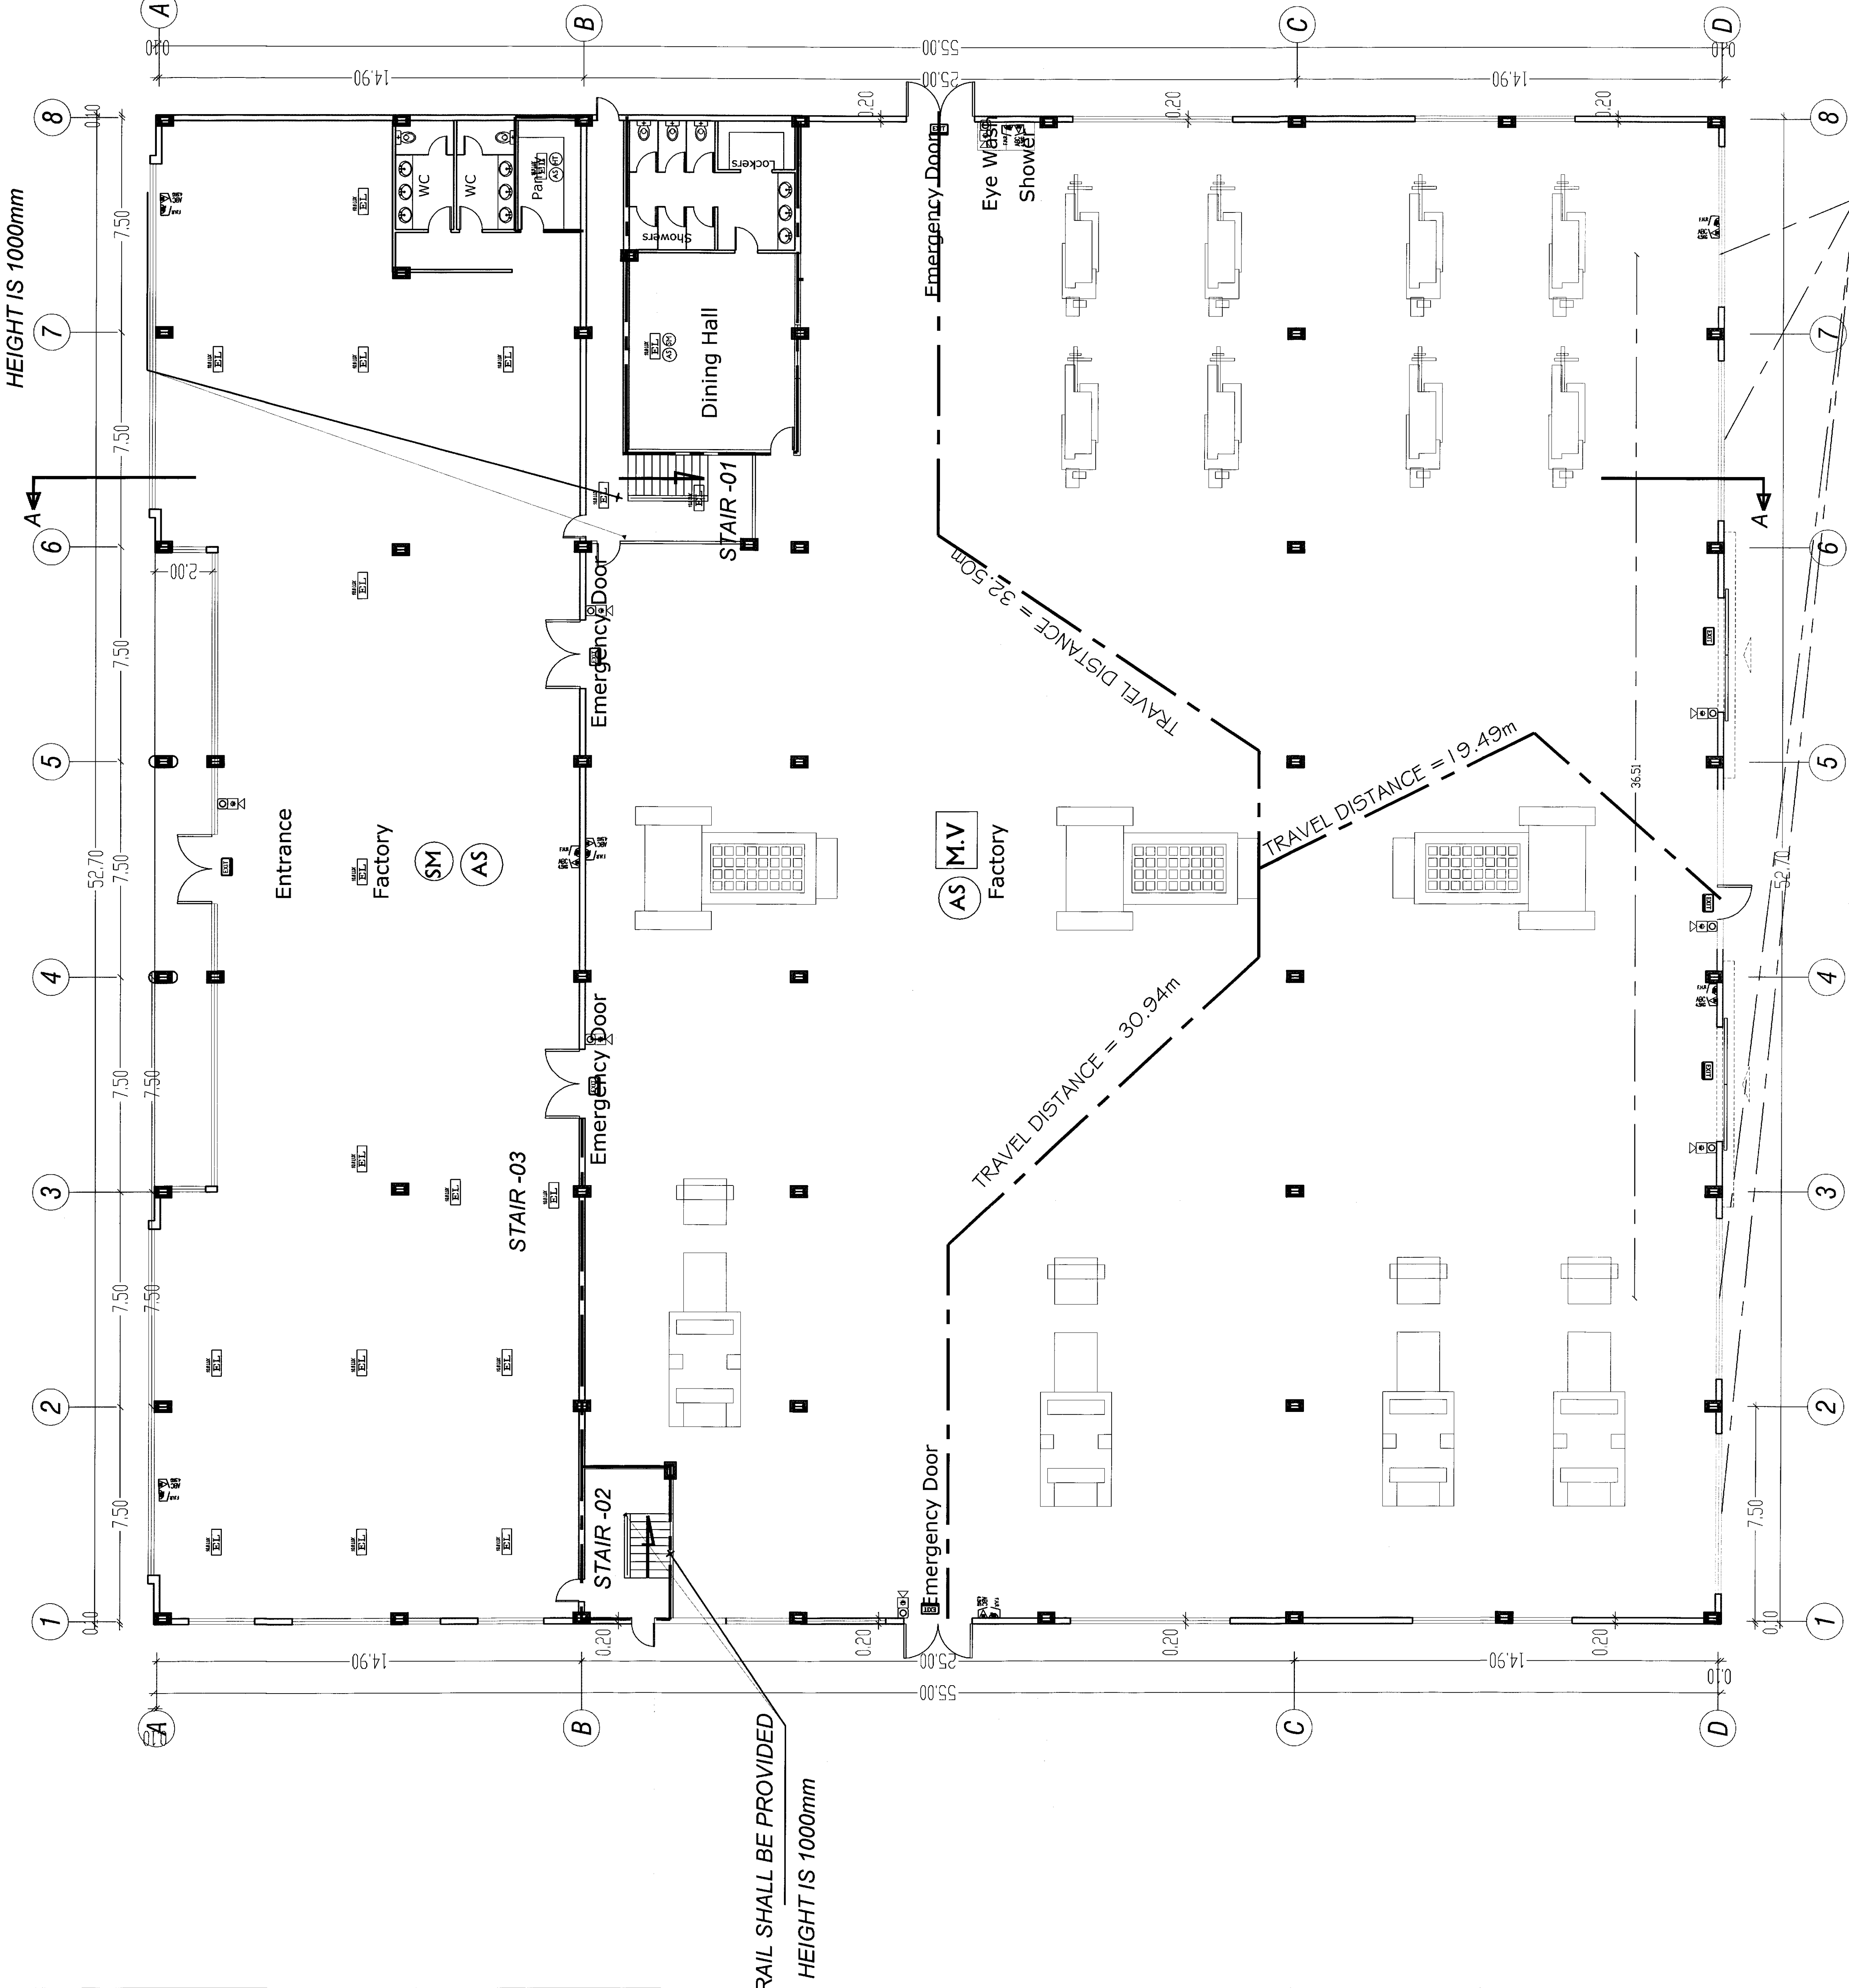

- PROCEDURE PRODUCT
- 1-AIR PASS THROUGH CONDENSER TO PRODUCE WATER
 - 2-SALAR ENGAGE WILL BE CONCENTRATED ON THE OUTLET DRY FROM CONCENTRATE TO MAKE A SUPER
 - 3-SUPERHEATED AIR WILL BE USED TO ROTATE A TURBINE TO PRODUCE ELECTRIC ENERGY

