

LIET, REVISION

A REDUCED HEIGHT, MOVED CONTROL PANEL

B X

C X

D X

E X

F X

AREAS PROTECTED BY SAFETY LANYARD OPENINGS ARE LEFT TO UNLOAD/LOAD
PALLETS

EQUIPMENT SPECIFICATIONS:
MATERIAL OF CONSTRUCTION:
PRODUCT CONTACT SURFACES 304 STAINLESS STEEL WITH 2B SURFACE FINISH
NON PRODUCT SURFACES CARBON STEEL PAINTED WITH STEEL-IT EPOXY
GASKETS AND SEALS: EPDM ELASTOMER AND WHITE BUNA-N (NITRILE) RUBBER

WELD SPECIFICATIONS: PRODUCT CONTACT WELDS ARE CONTINUOUS AND GROUND SMOOTH TO 80 GRIT NON PRODUCT WELDS ARE STITCHED OR CONTINUOUS DEPENDING ON STRENGTH REQUIREMENTS

CONTROL ENCLOSURES ARE NEMA 4X, STAINLESS STEEL. MAIN CONTROL PANEL IS MOUNTED ON MACHINE FRAME. OPERATOR CONTROL STATION IS PEDESTAL MOUNTED. CONTROL IS WITH AN ALLEN BRADLEY MICROLOGIX 1200 PROCESSOR AND A TOUCH SCREEN INTERFACE. SCALE CONTROLLER IS MOUNTED INSIDE THE MAIN CONTROL PANEL.

CONVEYOR MOUNTED ELECTRICAL SENSORS ARE WIRED TO JUNCTION BOXES MOUNTED ON THE CONVEYOR CONVEYOR MOTORS ARE WIRED TO LOCAL DISCONNECTS ON EACH CONVEYOR.

CARRIAGE HEIGHT ADJUSTMENT RANGE IS 763MM (30 INCHES). THE CARRIAGE IS MOVED USING A SINGLE HYDRAULIC CYLINDER MOUNTED IN THE FRAME OFTHE MACHINE. HYDRAULIC POWER IS PROVIDED FROM A 3HP ((2.24KW) MOTOR DELIVERING 4 GALLON PER MINUTE TO A 2 1/2 INCH BORE HYDRAULIC CYLINDER.

THE CARRIAGE INCLUDES TRAVERSING FILL HEAD AND BAG HOOKS. THE FILL HEAD AND HOOKS MOVE TOWARDS THE OPERATOR REDUCING THE REACH REQUIRED TO SPOUT AND HANG A BAG. THE FILL HEAD FEATURES A BAG INFLATION PORT FOR EXPANDING THE BAG PRIOR TO BEGINNING THE FILL PROCESS AND AN EXHAUST PORT FOR EXHAUSTING THE DISPLACED AIR AS THE BAG IS FILLED.

AN INFLATABLE EPDM SEAL, AROUND THE FILL HEAD, AND AN AIR OPERATED FILL TUBE CLAMP COMBINE TO RETAIN THE BAG SEAL PREVENTING EXPOSURE TO MATERIAL BEING TRANSFERED INTO THE BAG.

AN INLET VALVE MOUNTED ON TOP OF THE MACHINE FRAME CONTROLS THE FLOW OF MATERIAL BEING TRANSFERED INTO THE BAG. THIS VALVE IS CONTROLLED BY THE SCALE SYSTEM AND PROVIDES A FAST AND SLOW FEED FOR ACCURATE BAG FILLING.

THE SCALE SYSTEM CONSISTS OF FOUR REVERE LOAD CELLS, MOUNTED UNDER THE CONVEYOR SECTION ON THE MACHINE BASE, AND A GSE SCALE SIGNAL INSTRUMENT MOUNTED IN THE MAIN CONTROL PANEL. THE SCALE SYSTEM PROVIDES AN ACCURACY OF PLUS OR MINUS 1/2 PERCENT OF THE PREDETERMINED BAG WEIGHT

THE CONVEYOR SUPPORTED BY THE LOAD CELLS HAS POWERED ROLLERS WITH A 1/2 HP DRIVE. THIS CONVEYOR IS USED TO MOVE FULL BAGS FROM AND EMPTY BAGS TO THE FILL STATION.

BELOW THE CONVEYOR IS A PAIR OF COUNTER ROTATING ELECTRIC VIBRATORS THAT PROVIDE A VERTICAL VIBRATION TO COMPACT THE MATERIAL BEING INTRODUCED TO THE BAG.

THE SYSTEM INCLUDES SECTIONS OF POWERED INFEED CONVEYOR AND POWERED EXIT CONVEYOR. IN ADDITION TO THE POWERED EXIT CONVEYOR, THERE IS A SECTION OF NON POWERED CONVEYOR WITH A PALLET STOP TO RECEIVE THE FULL BAGS OF MATERIAL.

YANAACOCHA GOLD MILL PROJECT PROJECT NUMBER 53235200 PURCHASE ORDER 53235200-49-6047 TAG NUMBERS 3420-PK-12001 AND 3420-WS-12001

MATERIAL HANDLED: COPPER SULFIDE PRECIPITATE
MATERIAL DENSITY: 20 POUNDS PER CUBIC FOOT DRY
60 POUNDS PER CUBIC FOOT WET
PARTICLE SIZE: 90 TO 95 PERCENT IS LESS THAN 200 MESH
ANGLE OF REPOSE: 60 DEGREES OR GREATER
MOISTURE CONTENT: 65 PERCENT
PROCESS RATE: 2 TO 3 BAGS PER HOUR
BAG SIZE: 1220MM (48 INCH) SQUARE BY 1220MM (48 INCHES) TALL
INLET SPOUT 356MM (14 INCH) DIAMETER X 457MM (18 INCHES) LONG
PALLET SIZE: 1118MM (44 INCHES) SQUARE BY 127MM (5 INCHES) TALL

BULK BAG FILLER

CONNECTED MOTORS:
INFLATION FAN 1 HP 460VAC 3PH
VIBRATORS TWO AT 1 1/2 HP 460VAC 3PH
HYDRAULIC SYSTEM 2 HP 460VAC 3PH
FILLER CONVEYOR 1/2 HP 460VAC 3PH
IN FEED CONVEYOR 1/2 HP 460VAC 3PH
EXIT CONVEYOR 1/2 HP 460VAC 3PH

-CONVEYOR DRIVE

UTILITY REQUIREMENTS
ELECTRICITY: 30 AMP 460VAC 3PH
COMPRESSED AIR: 5SCFM AT 90 PSIG
WATER: NONE
GAS: NONE

FLUOR CHILE S.A.
REYES LAVALLE # 3340
LAS CONDES
SANTIAGO CHILE
CSO E400740004
PO 53235200-49-6047
c/o YANACOCHA GOLD MILL, PERU

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WITH PRODUCTION

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APPROVAL PRINT

NAME DATE

TJB 07/27/07

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National Bulk Equipment

12838 STAINLESS DR., HOLLAND, MICHIGAN 49424
PHONE: (616) 399-2220 FAX: (616) 399-7369

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WEIGHT 7592.054 LBS

SCALE: 1:24 DRAWN BY: CFA DATE: 03/27/07 MODEL CREATOR: NAME DATE

ASSEMBLY BAG FILLER WITH CONVEYORS

DE TOLERANCE UNLESS OTHERWISE SPECIFIED 1 OF 2

±.03 ON BEND AND SHEAR LINES
±.03 ON HOLE LOCATIONS


TOLERANCE UNLESS OTHERWISE SPECIFIED 1 OF 2

Sheet1

LOAD CELL

BAG FILLER SEQUENCE OF OPERATION OPERATOR PREPARES NEW BAG ON PALLET ON INFEED CONVEYOR OPERATOR CYCLES CONVEYOR TO MOVE PALLET WITH EMPTH BAG INTO FILL POSITION.THEN: ATTACHES BAG TO BAG LOOP HOOKS PULLS BAG SPOUT UP AROUND INFLATABLE SEAL CLOSES BAG CLAMP AROUND SEAL BAG CLAMP LOCKS CLOSED BAG SEAL INFLATES BAG INFLATION BLOWER STARTS BAG EXHAUST VALVE CLOSES FILL HEAD RETRACTS TO BAG FILL POSITION **BAG HOOKS RETRACT CARRIAGE RISES** INFLATION BLOWER STOPS (AFTER PREDETERMINED TIME) EXHAUST VALVE OPENS VENTING AIR FROM BAG FILL HEAD LOWERS TO FILL (INTERMEDIATE) POSITION SCALE TARES BAG DEFLATED PRODUCT VALVE OPENS BEGINNING FILL CARRIAGE LOWERS TO DENSIFICATION (INTERMEDIATE) POSITION (AFTER PREDETERMINED TIME) DENSIFICATION SYSTEM RISES (LIFTS BAG OFF OF SCALE CONVEYOR) VIBRATORS RUN (FOR PREDETERMINED TIME) DENSIFICATION SYSTEM LOWERS (LOWERS BAG ONTO SCALE CONVEYOR) CARRIAGE RISES TO FILL POSITION BAG WEIGHT INCREASES TO NEAR FULL CONDITION FILL VALVE MOVES FROM FULL OPEN TO NEAR CLOSED (SLOW FEED POSITION) BAG WEIGHT REACHES PREDETERMINED SETTING SCALE SYSTEM SHUTS OFF FILL VALVE CARRIAGE LOWERS TO BAG RELEASE (INTERMEDIATE) POSITION


CONVEYOR INDEXES FULL BAG FROM FILL POSITION (IF NO BAG IS ON THE EXIT CONVEYOR)

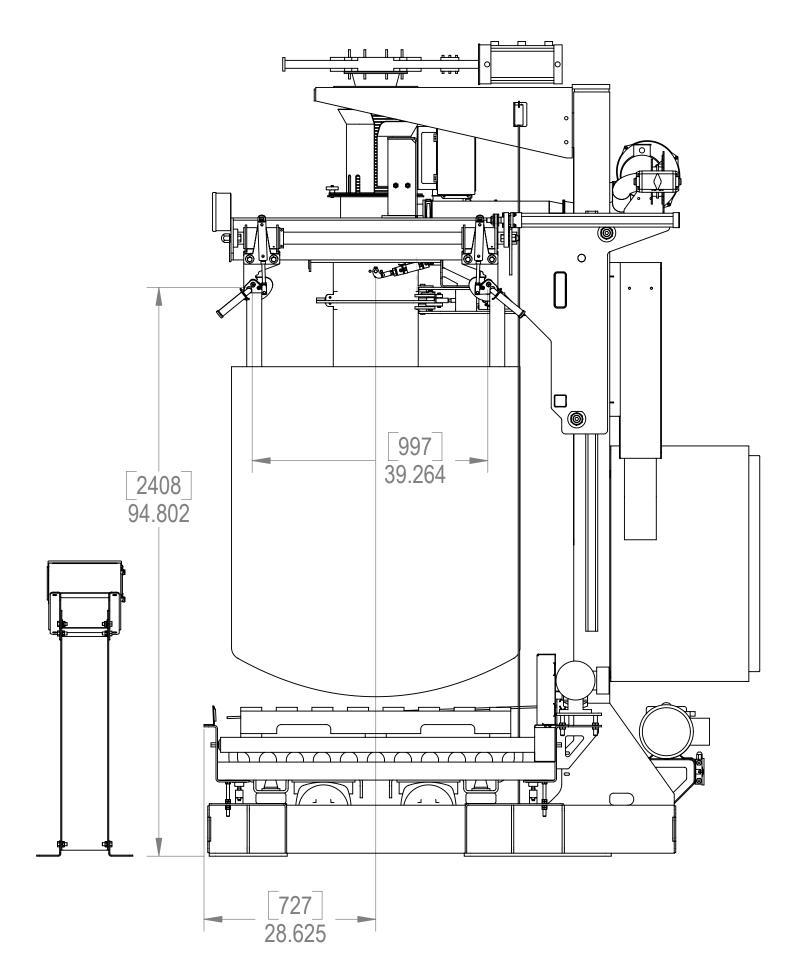


PALLET WITH EMPTY BAG INDEXES INTO FILL POSITION

BAGSEAL DEFLATES BAG CLAMP OPENS **BAG HOOKS RELEASE CARRIAGE RISES**

FILLER WITH CARRIAGE IN RAISED POSITION WITH FILL HEAD AND BAG HOOKS RETRACTED FOR FILLING BAG

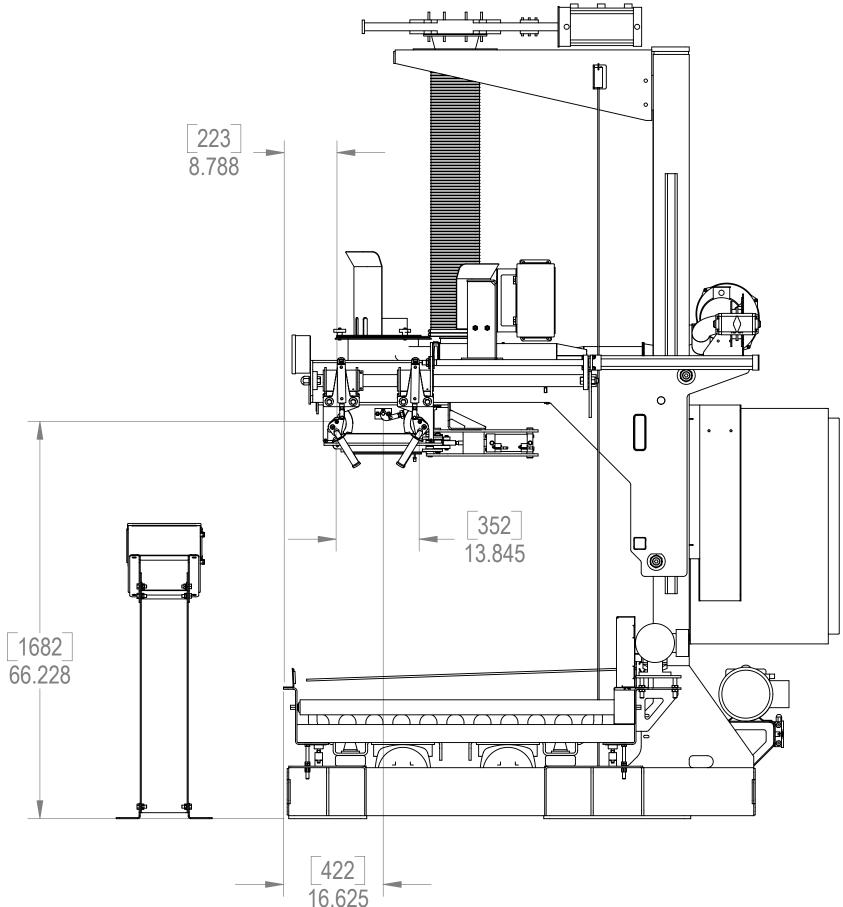

FILLER WITH CARRIAGE IN LOWERED POSITION WITH FILL HEAD AND BAG HOOKS FORWARD FOR ATTACHING BAG

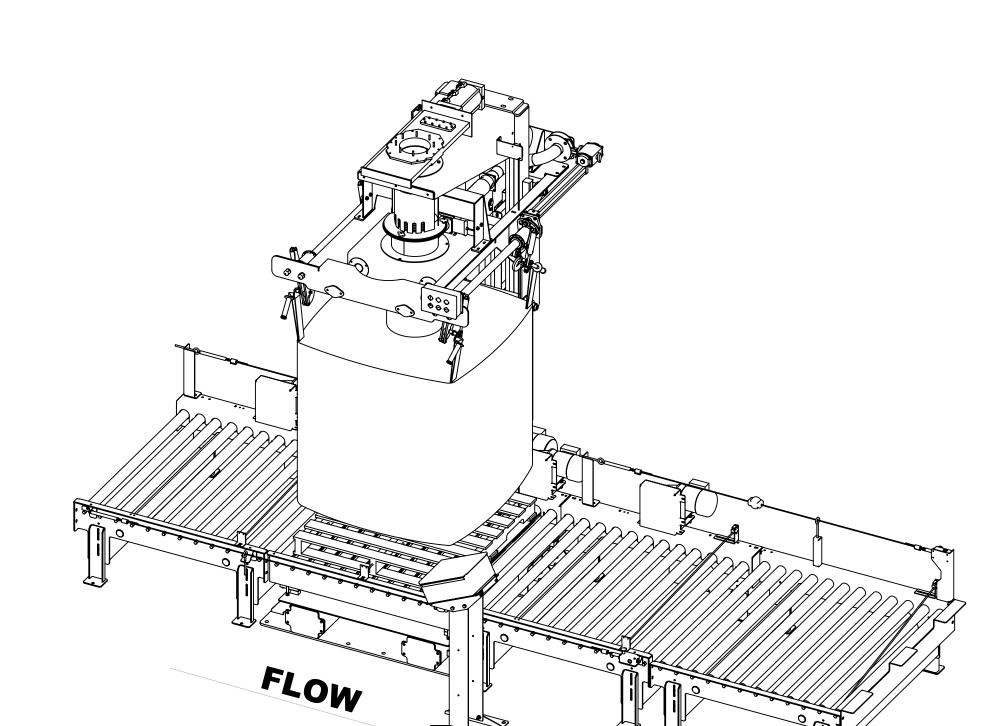

LET. REVISION

REDUCED HEIGHT, MOVED CONTROL PANEL

YANAACOCHA GOLD MILL PROJECT PROJECT NUMBER 53235200 PURCHASE ORDER 53235200-49-6047 TAG NUMBERS 3420-PK-12001 AND 3420-WS-12001

FLUOR CHILE S.A. REYES LAVALLE # 3340 LAS CONDES SANTIAGO CHILE CSO E400740004 PO 53235200-49-6047 c/o YANACOCHA GOLD MILL, PERU

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SCALE: 1:16 DRAWN BY: CFA DATE: 03/27/07 MODEL CREATOR: NAME DATE ASSEMBLY BAG FILLER WITH CONVEYORS

DRAWING NUMBER 2 OF 2 TOLERANCE UNLESS OTHERWISE SPECIFIED A53535 ±.03 ON BEND AND SHEAR LINES Sheet2 ±.03 ON HOLE LOCATIONS